


ARCHITECTURAL

CIVIL

PLUMBING, MECHANICAL & ELECTRICAL

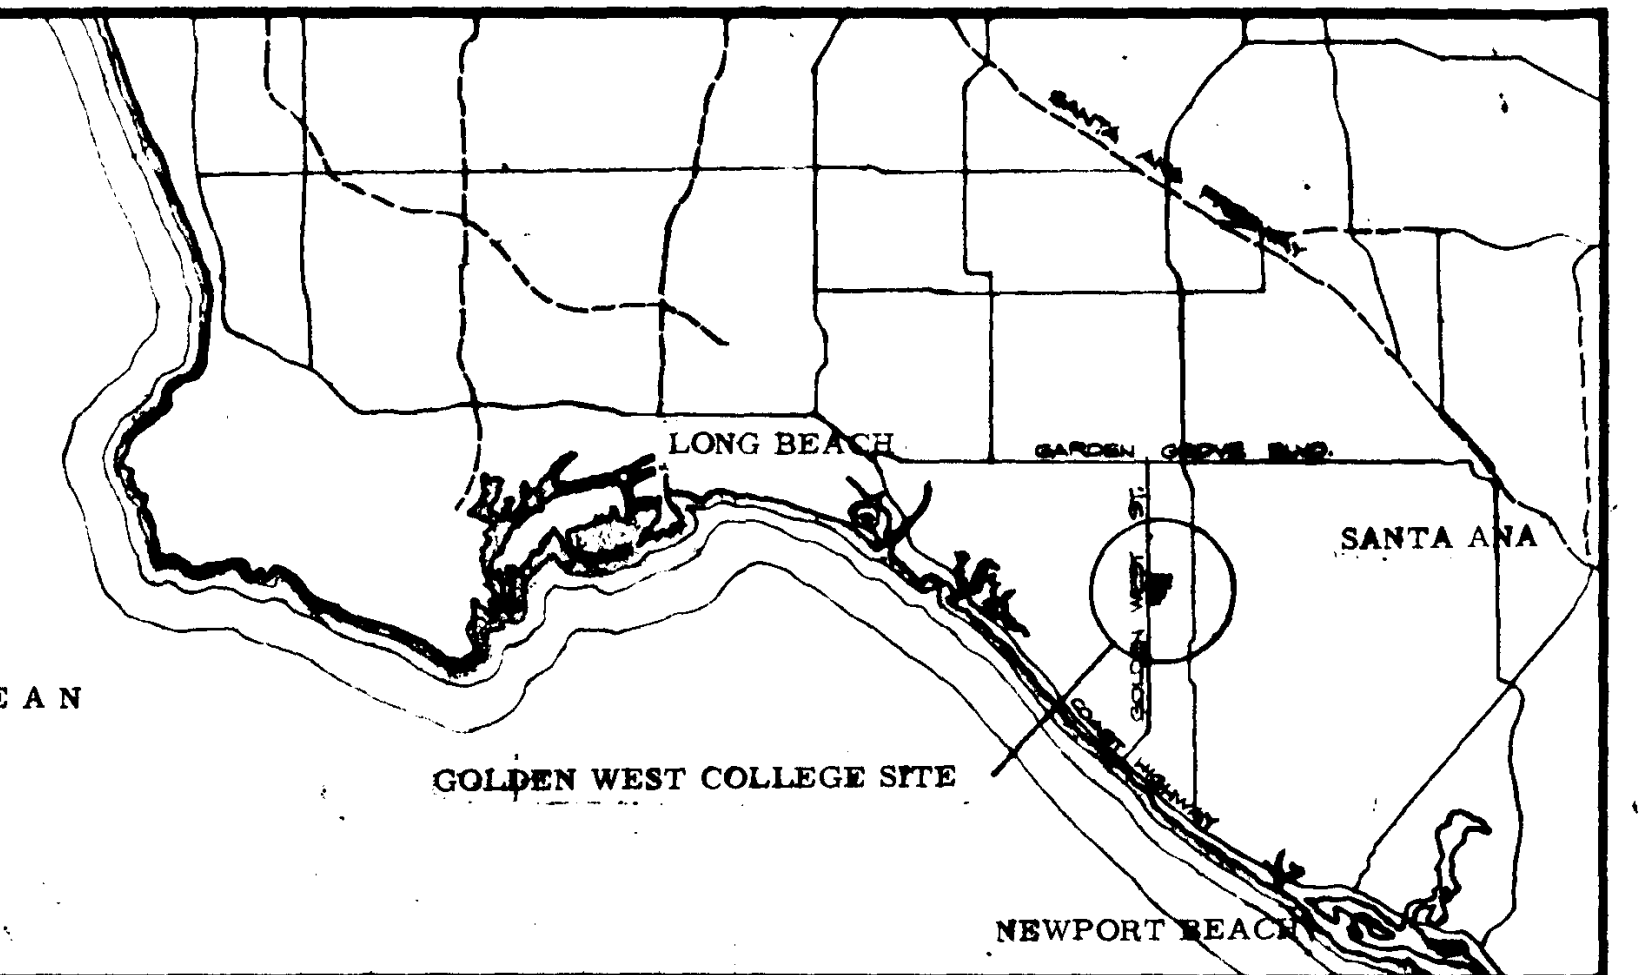

VICINITY MAP

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GRID LINE REFERENCE	Grid Number or Letter
MATCH LINE REFERENCE	Target indicates where plan is broken
DETAIL REFERENCE	Detail Number Sheet Number on which detail is shown on drawings.
DETAIL REFERENCE	Detail Number Sheet Number on which detail is shown on drawings.
WALL SECTION REFERENCE	Section Number Sheet Number on which section is shown on drawings.
BUILDING SECTION REFERENCE	Section Number Sheet Number on which section is shown on drawings.
ROOM REFERENCE AND INTERIOR ELEVATION REF.	Room Number Interior Elevation Sheet Number
DOOR REFERENCE	Door Number - See schedule Frame conditions - See schedule
REVISION REFERENCE	Revision Number - See brief in title block
CASEWORK REFERENCE	Lab Equip. Type and Dimensions Sheet number in Lab. Equip. detail Section 15, on which detail 15.14 is shown for utility references see detail sheet 15.1


REFERENCE SYMBOLS

CONCRETE WALL
METAL STUD AND PLASTER PARTITION - 4" TYPICAL, OTHER SIZES AS NOTED OR DETAILED
METAL STUD AND PLASTER PARTITION - ON CONCRETE CURB
METAL STUD AND PLASTER PARTITION - 2 1/2" STAGGERED, WITH INSULATION
WINDOW WALL OR GLAZED PARTITION
WIRE MESH PARTITION
REFLECTED CEILING PLAN, METAL STUD AND PLASTER PARTITION, PLASTER BOTH SIDES TO BOTTOM OF CONCRETE JOINT
REFLECTED CEILING PLAN, METAL STUD AND PLASTER PARTITION, NO PLASTER ABOVE CEILING
NOTE: ALL BUILDINGS TYPE II CONSTRUCTION


DRAWING INDEX

DRAWING LEGEND

STRUCTURAL ENGINEERS & ARCHITECTS RANDOLPH & JOHNSON J. A. MARTIN & ASSOCIATES MECHANICAL ENGINEERS RALPH E. PHILLIPS, INC. ELECTRICAL ENGINEERS RALPH E. PHILLIPS, INC. CIVIL ENGINEERS G. SHURMAN & ASSOCIATES MOFFATT & RICHOL		DESIGNED J. A. MARTIN DRAWN BY J. A. MARTIN CHECKED BY J. A. MARTIN APPROVED J. A. MARTIN	ASSOCIATED ARCHITECTS: WILLIAM L. FERREIRA & ASSOCIATES A. QUINCY JONES-FREDERICK E. EMMONS & ASSOCIATES BL
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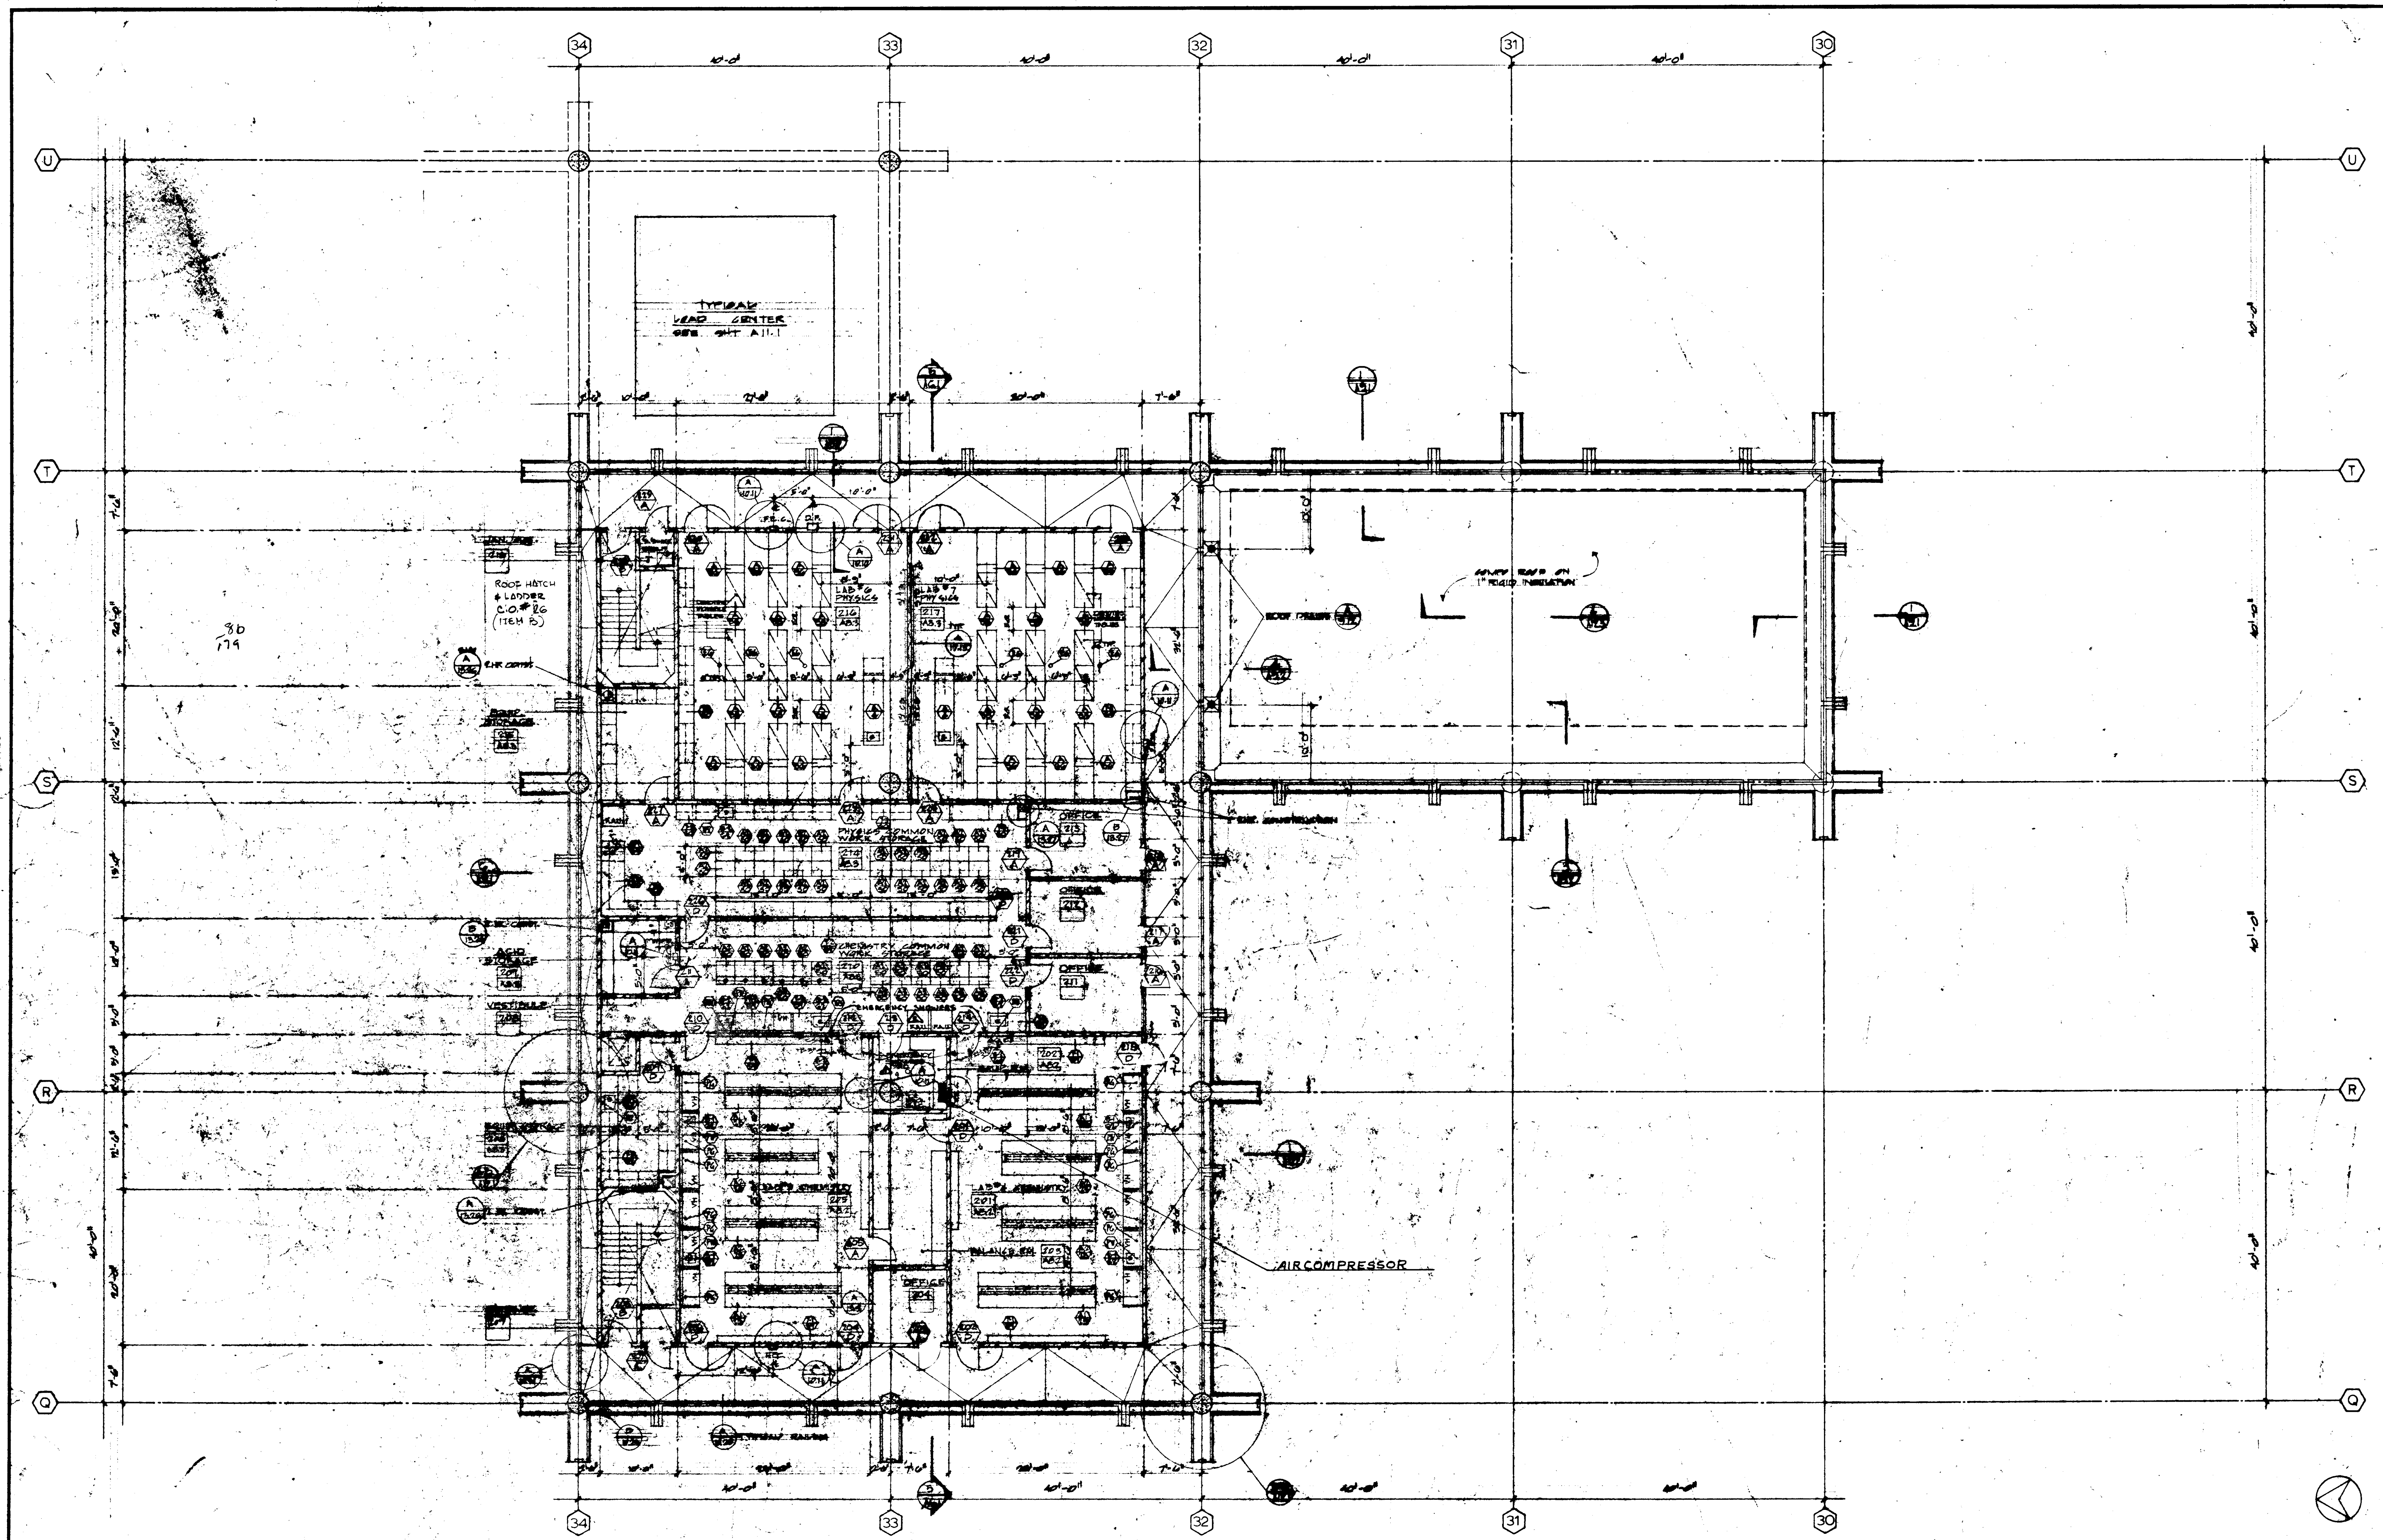


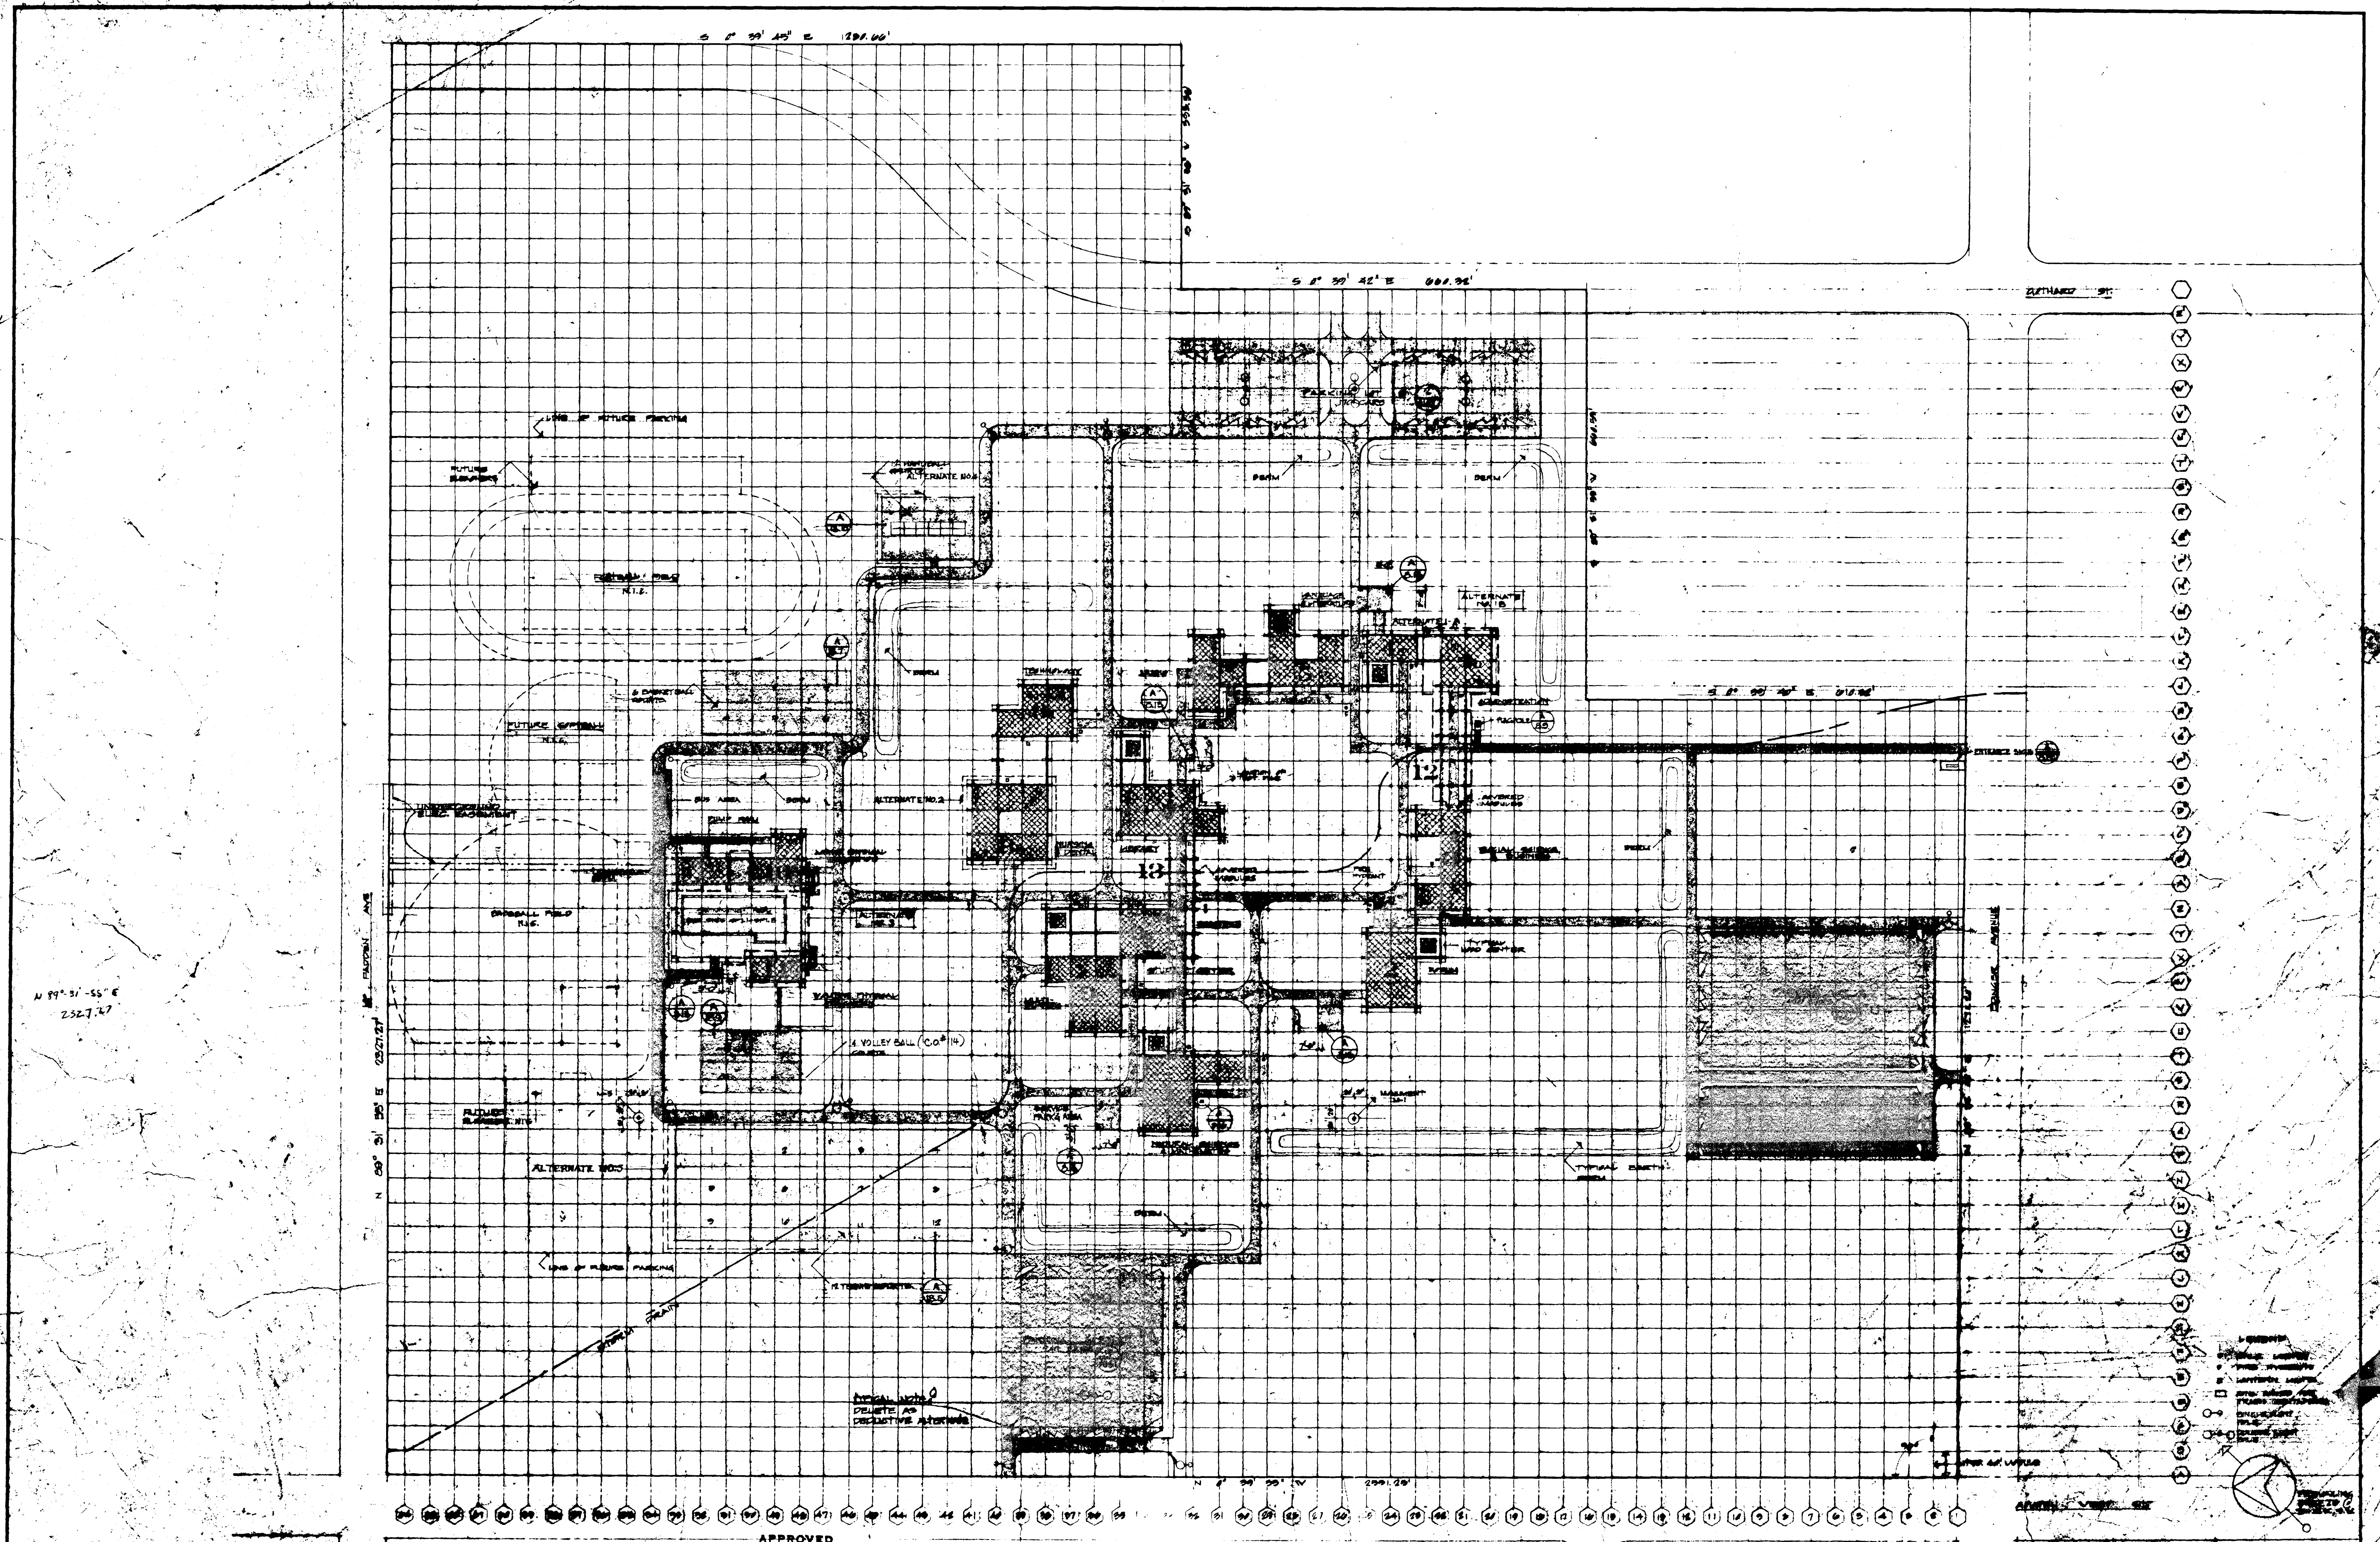STRUCTURAL ENGINEER RANDOLPH & JOHNSON J.A. MARTIN & ASSOCIATES ARCHITECTS RALPH E. PHILLIPS, INC. RALPH E. PHILLIPS, INC. G. SHEDMAN & ASSOCIATES HOFFMAN & SIOGAARD		DESIGNED J.W. G.W.J. DRAWN BY V.B. CHECKED BY S.	ARCHITECT WILLIAM L. PEREIRA & ASSOCIATES A. QUINCY JONES-FREDERICK E. EMMONS & ASSOCIATES BLUROCK ELLERBROEK & ASSOCIATES URBANUS SQUARE MACARTHUR BOULEVARD AT FORD ROAD CORONA DEL MAR, CALIFORNIA TELEPHONE 714/475-2840	APPROVED STATE FIRE MARSHAL STATE OF CALIFORNIA DATE: JUN 21 1965 25874 APPROVED MAY 5 - 1965	SITE PLAN GOLDEN WEST COLLEGE HUNTINGTON BEACH, CALIFORNIA ORANGE COAST JUNIOR COLLEGE DISTRICT	SHEET 104 15 JUN 1965 A21
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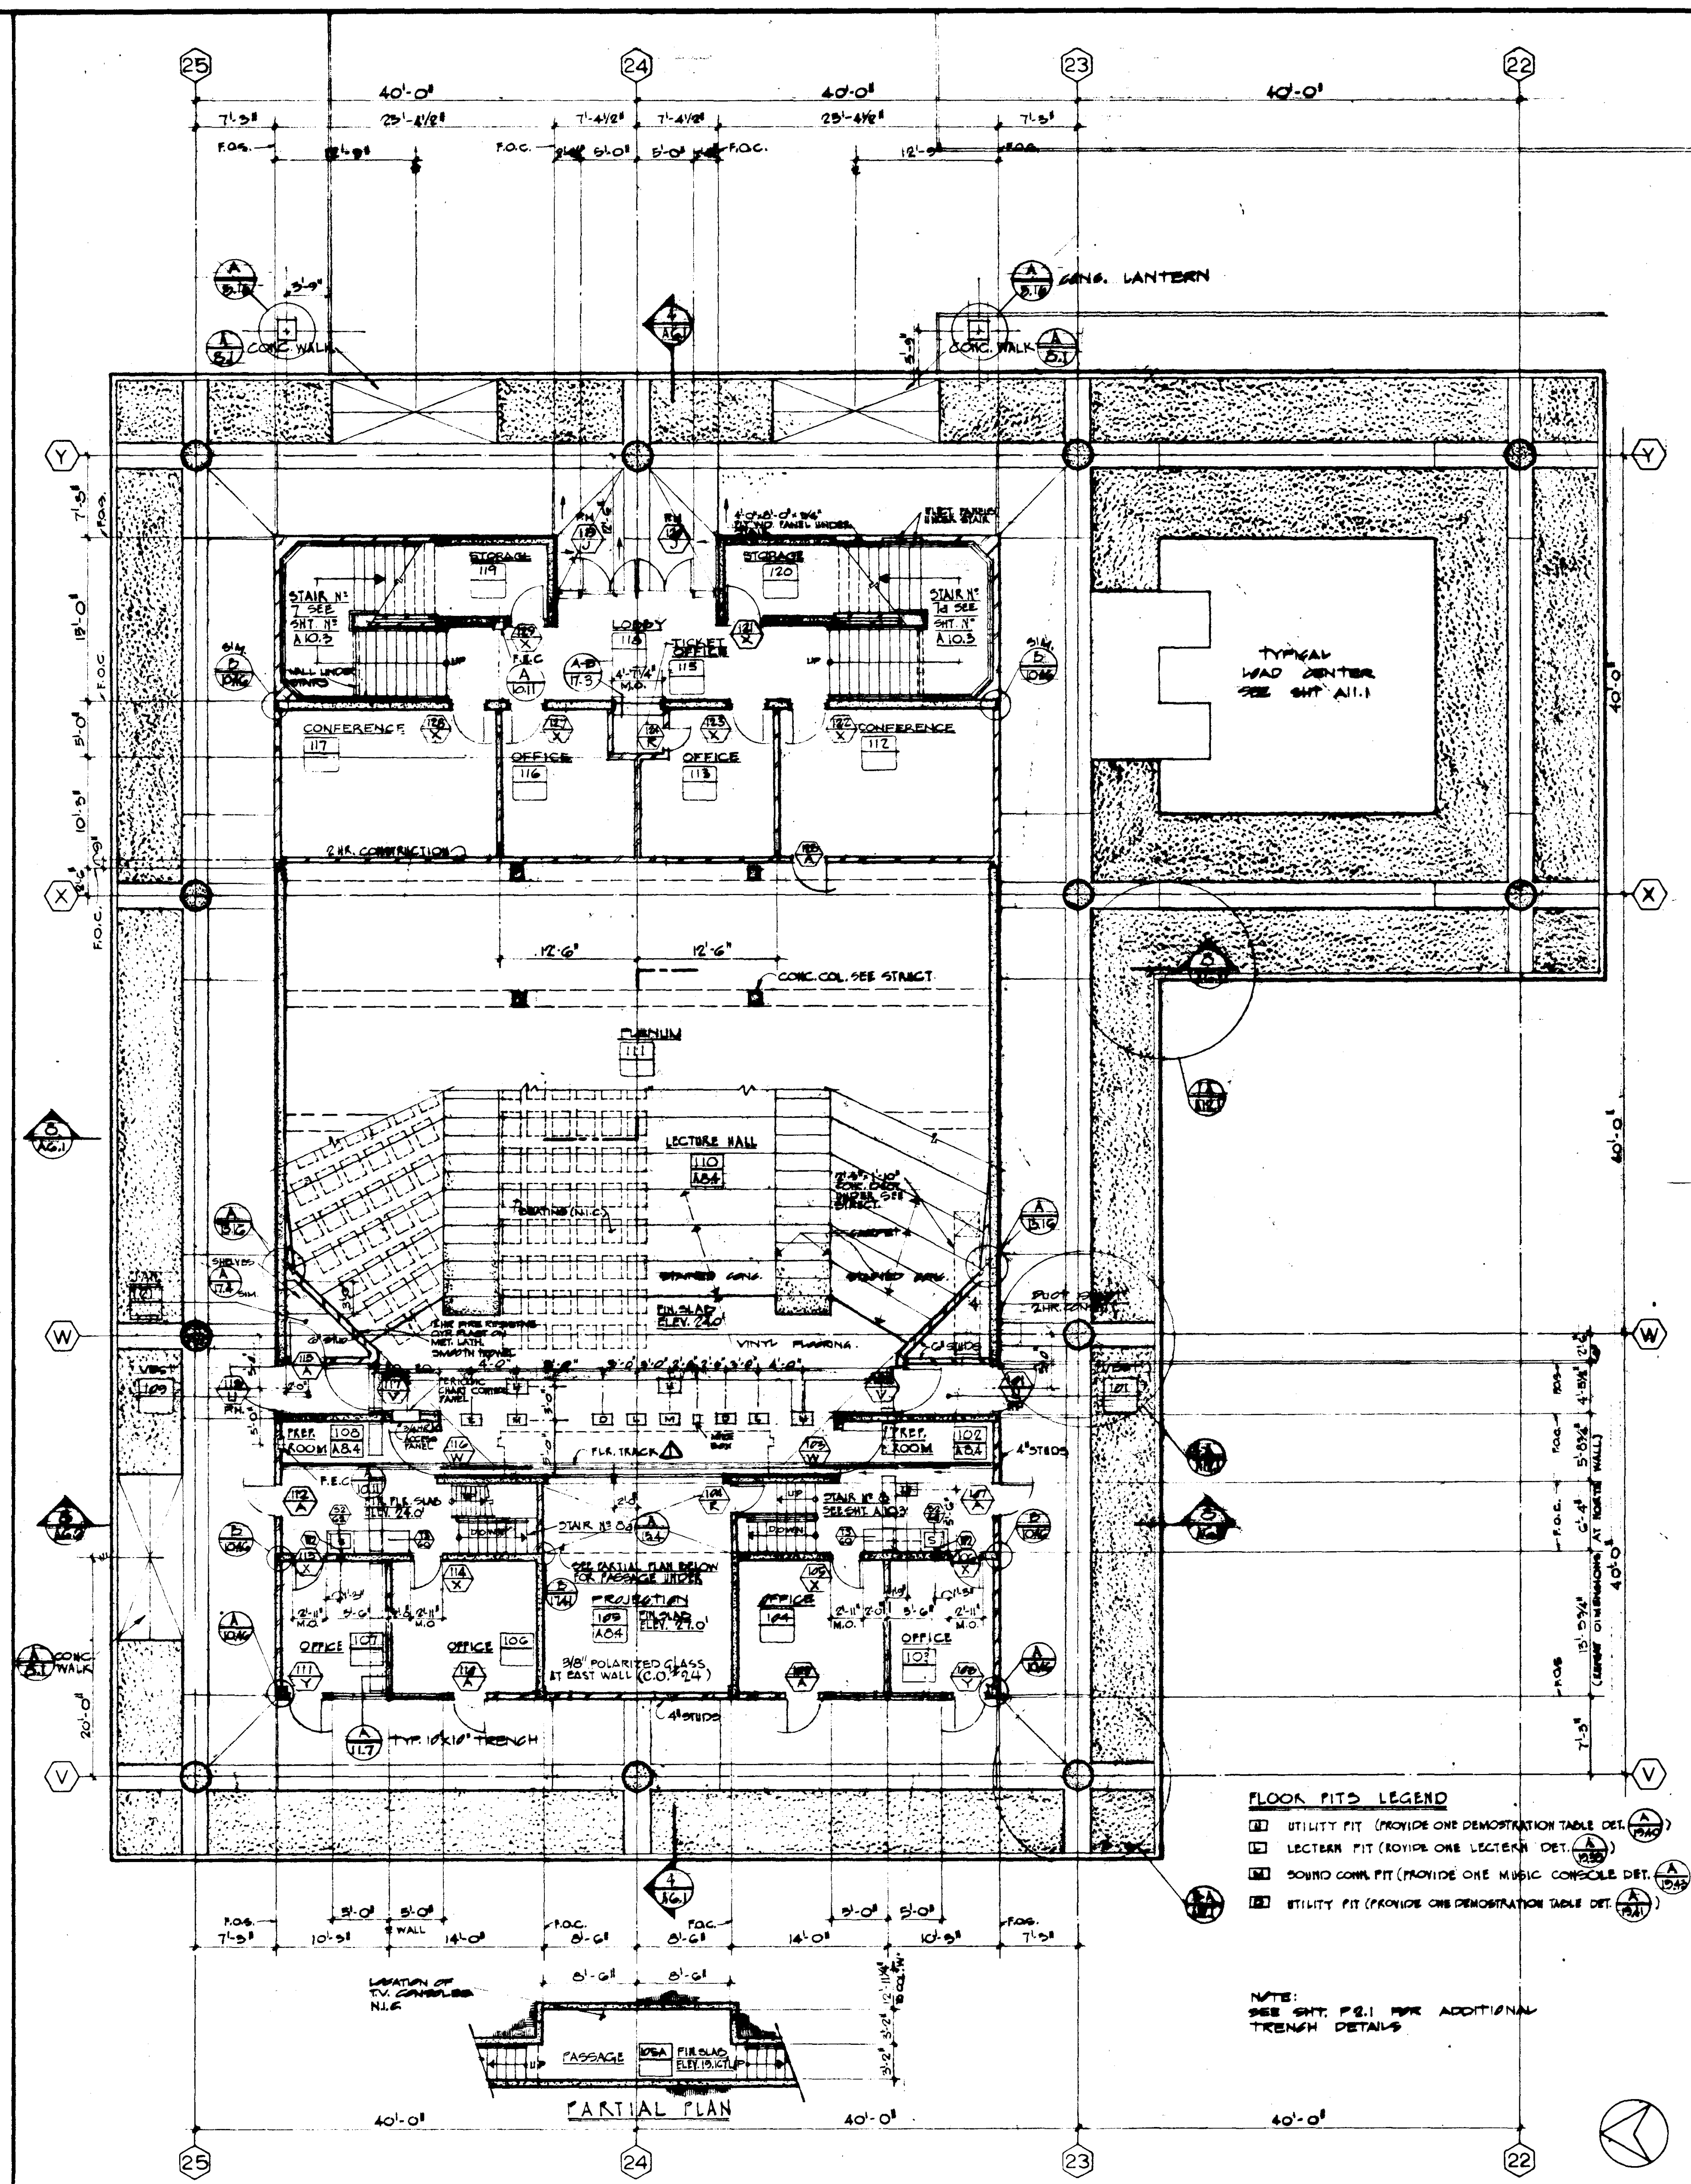
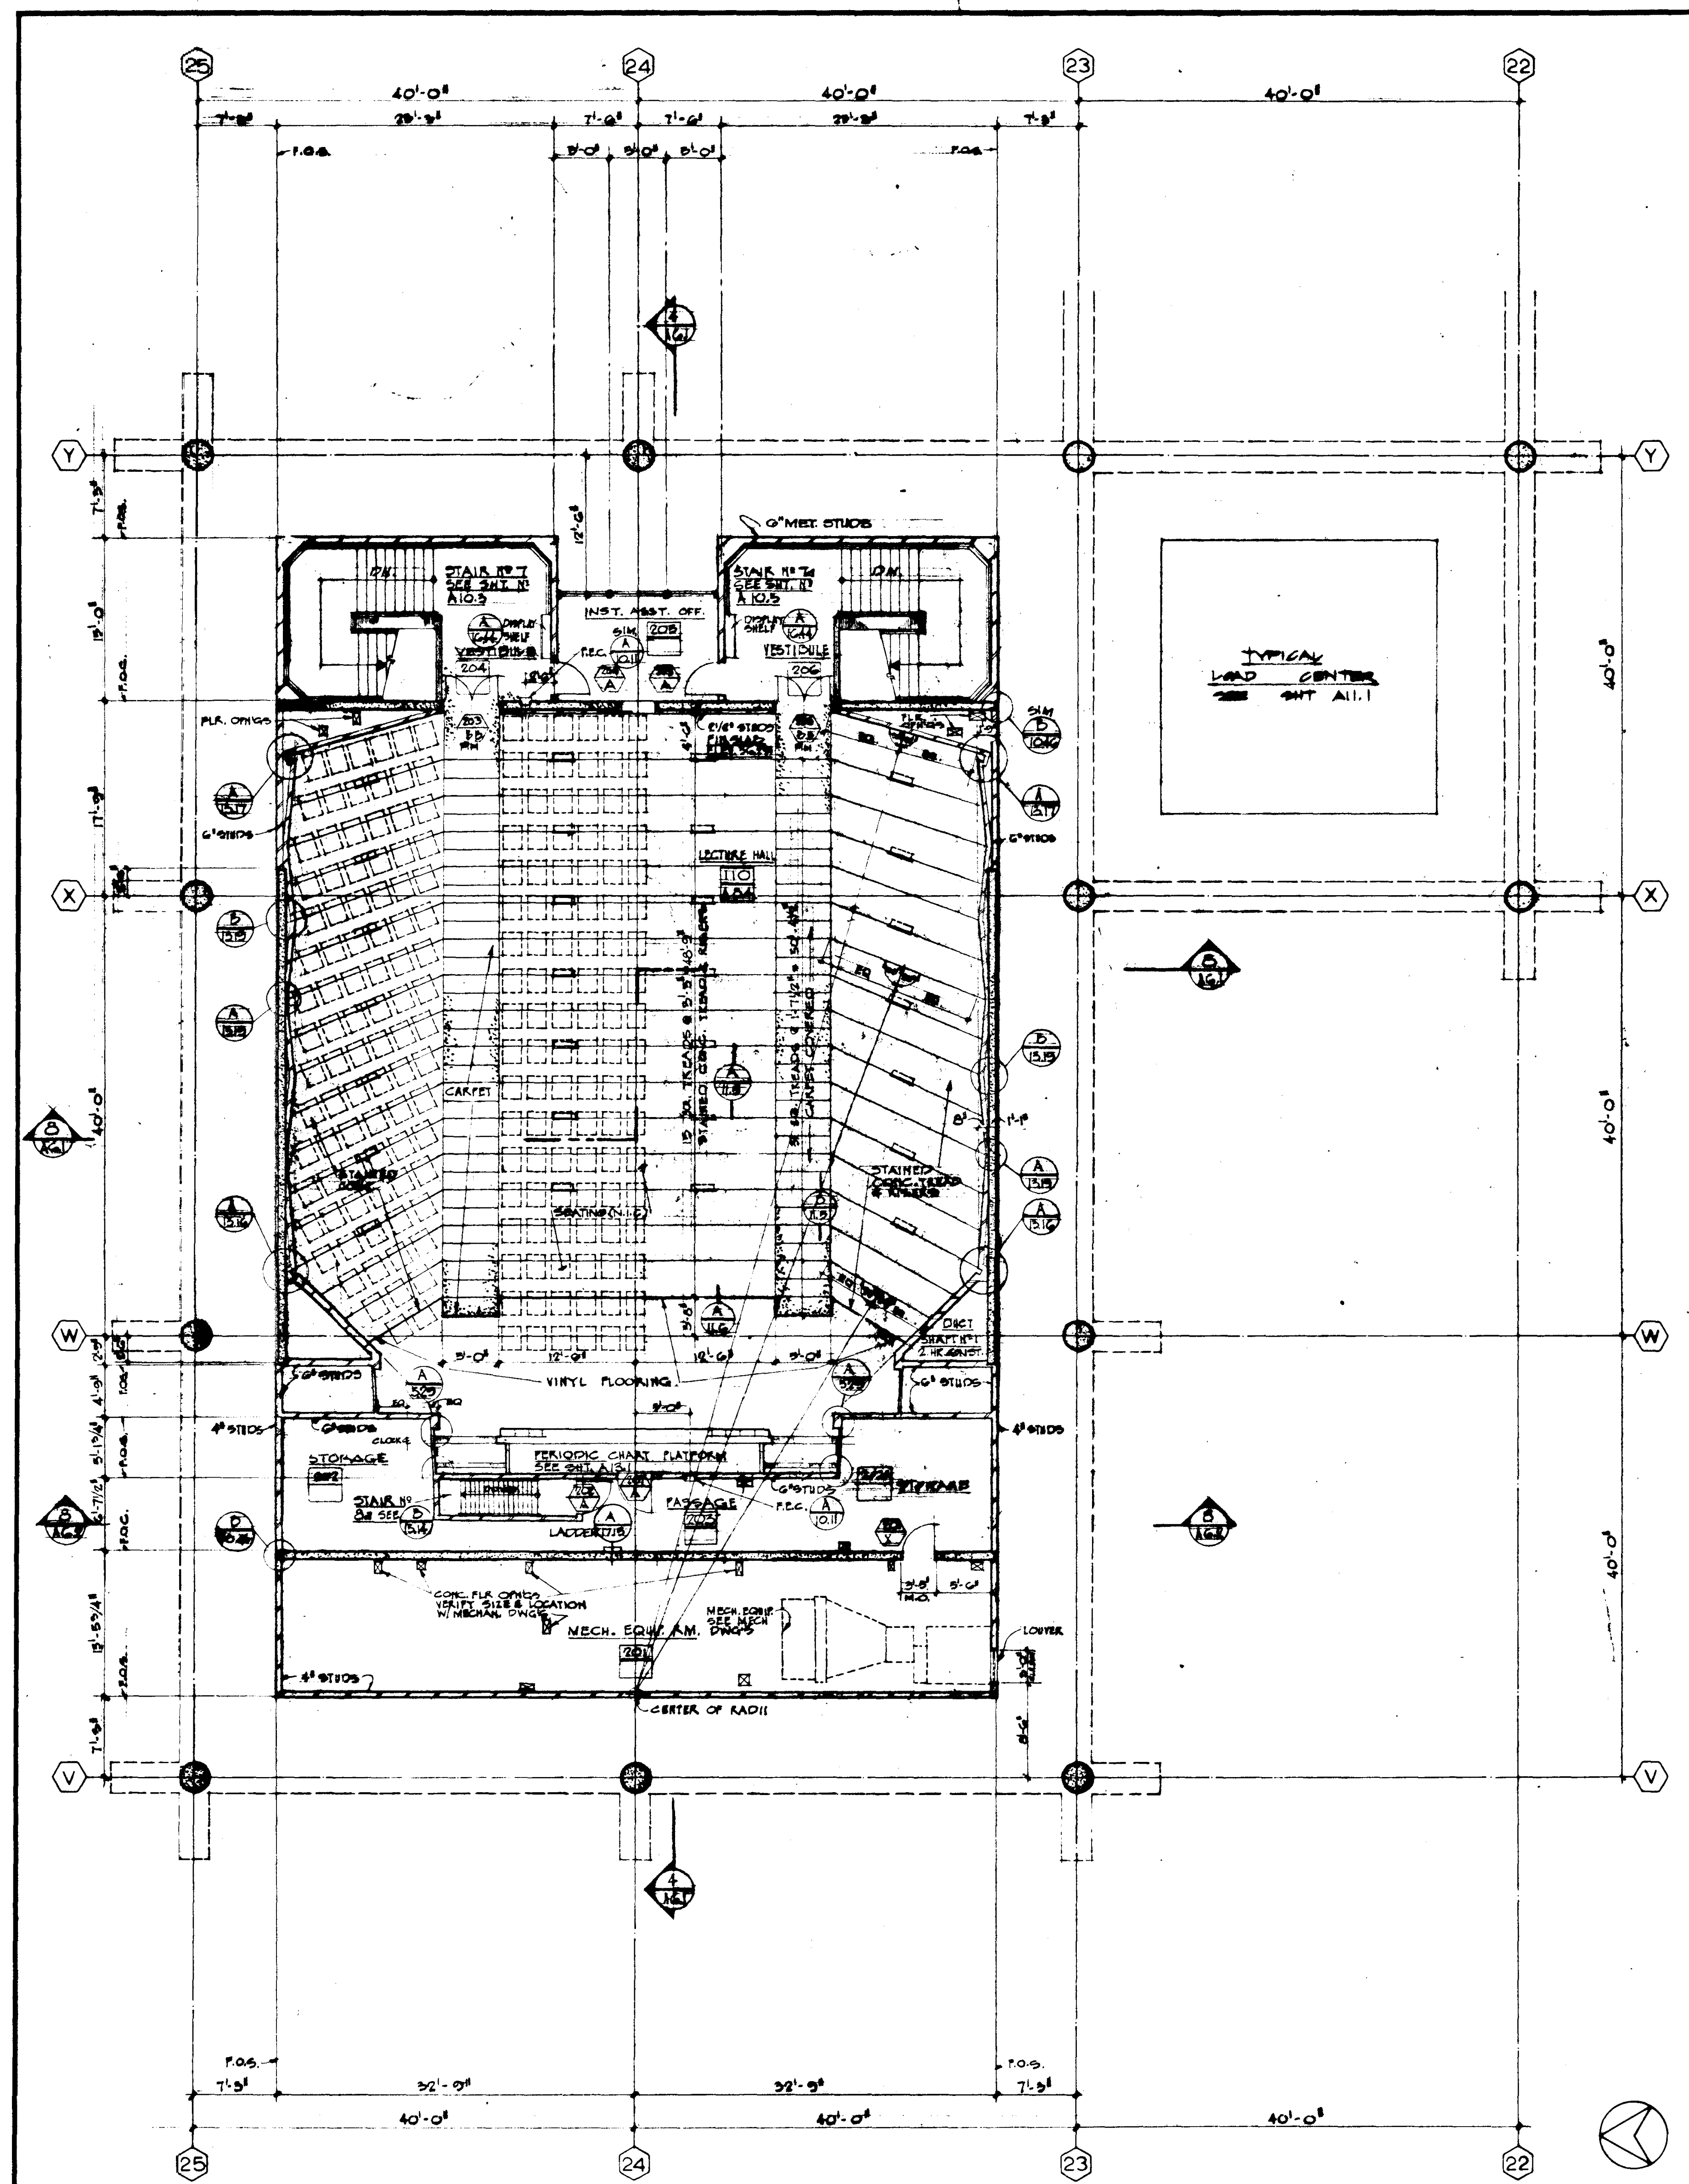


FIRST FLOOR

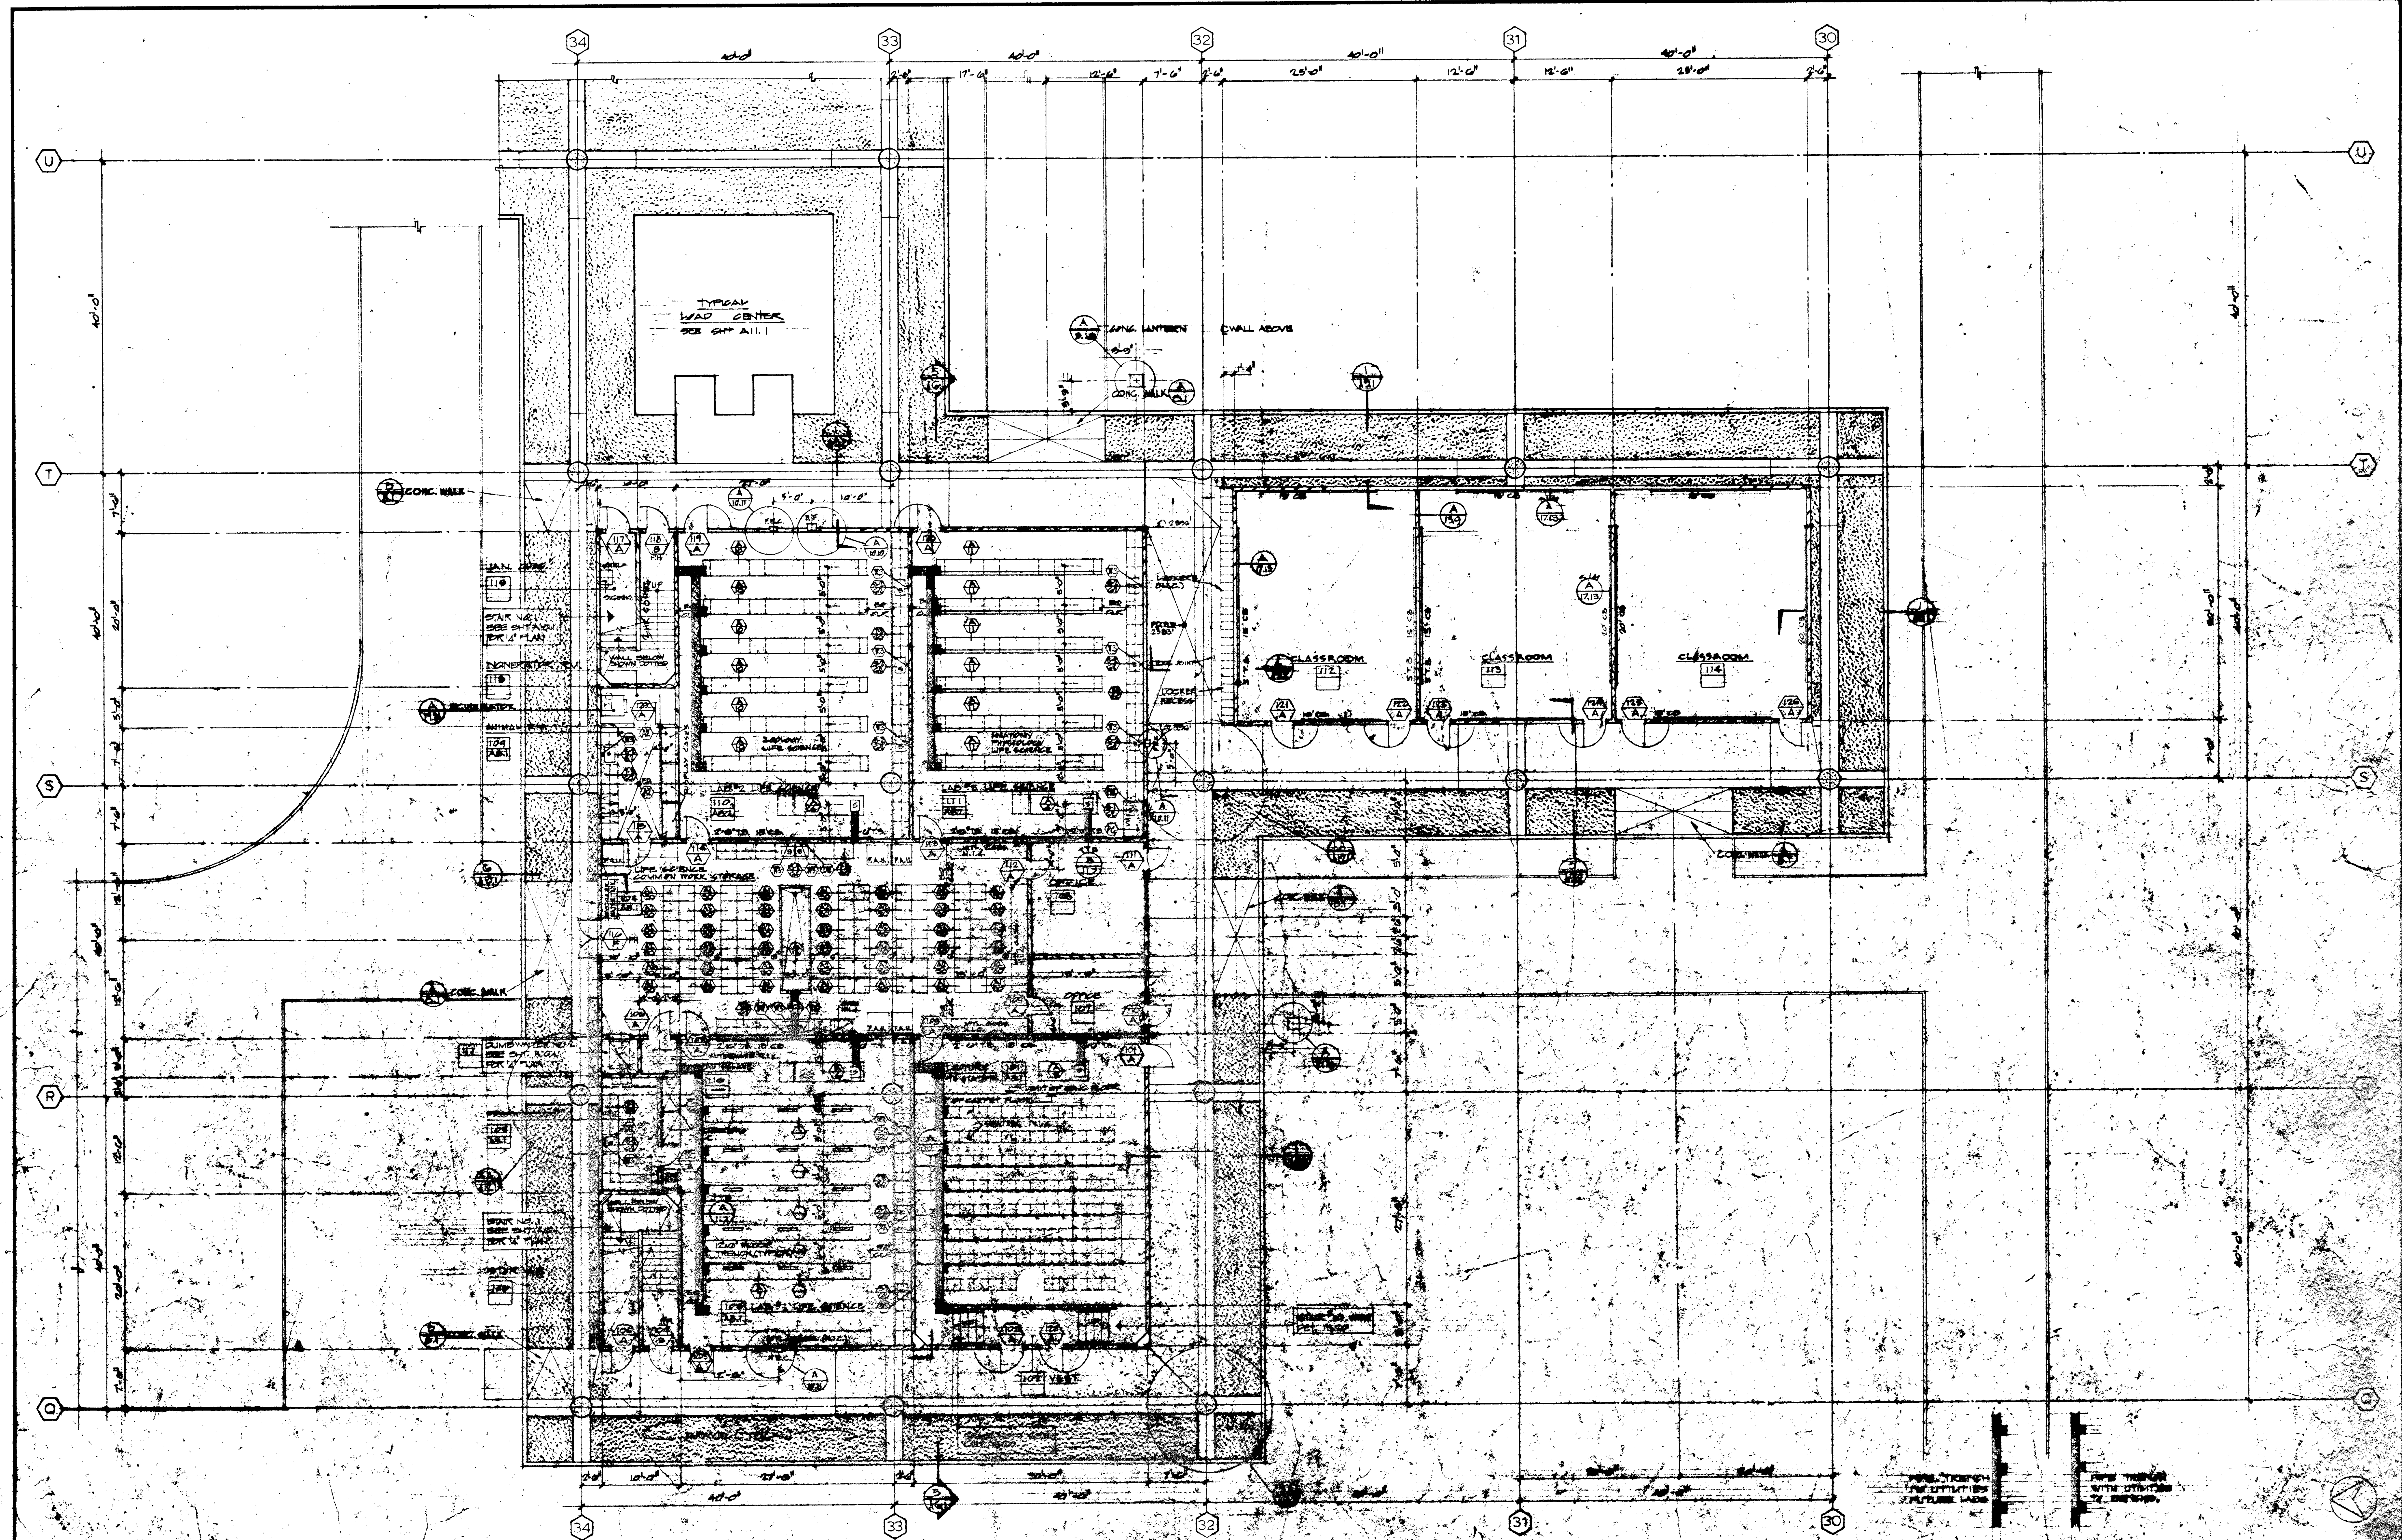STRUCTURE ENGINEER RANDOW & JOHNSON J. A. RANDOW & ASSOCIATES		DESIGNED JWL R.S.	ARCHITECT WILLIAM L. FERREIRA & ASSOCIATES A. QUINCY JONES-FREDERICK & ASSOCIATES BLUROCK ELLERBROCK & ASSOCIATES	APPROVED STATE FIRE MARSHAL STATE OF CALIFORNIA DATE JUN 21 1962 125874 APPROVED JUN 21 1962	ASSOCIATED ARCHITECTS: WILLIAM L. FERREIRA & ASSOCIATES A. QUINCY JONES-FREDERICK & ASSOCIATES BLUROCK ELLERBROCK & ASSOCIATES URBANUS SQUARE MACARTHUR BOULEVARD AT FORD ROAD TELEPHONE: 714/675-2649 CORONA DEL MAR, CALIFORNIA	GOLDEN WEST COLLEGE HUNTINGTON BEACH, CALIFORNIA ORANGE COAST JUNIOR COLLEGE DISTRICT	UNIT I NO UNDERGROUND FLOOR PLAN	SCALE 1/8" = 1'-0" DATE 12-1-62
MECHANICAL ENGINEER RALPH E. PHILLIPS, INC.		CHECKED BY K.B.	ENGINEER RALPH E. PHILLIPS, INC.	REVISIONS				
ELECTRICAL ENGINEER RALPH E. PHILLIPS, INC.								
CIVIL ENGINEER O. SHURMAN & ASSOCIATES MOFFATT & NICHOL								




<p>REVISIONS</p> <table border="1"> <tr> <th>NO.</th> <th>DATE</th> <th>DESCRIPTION</th> </tr> <tr> <td>1</td> <td></td> <td></td> </tr> <tr> <td>2</td> <td></td> <td></td> </tr> <tr> <td>3</td> <td></td> <td></td> </tr> <tr> <td>4</td> <td></td> <td></td> </tr> <tr> <td>5</td> <td></td> <td></td> </tr> <tr> <td>6</td> <td></td> <td></td> </tr> <tr> <td>7</td> <td></td> <td></td> </tr> <tr> <td>8</td> <td></td> <td></td> </tr> <tr> <td>9</td> <td></td> <td></td> </tr> <tr> <td>10</td> <td></td> <td></td> </tr> </table>										NO.	DATE	DESCRIPTION	1			2			3			4			5			6			7			8			9			10			<p>STRUCTURAL ENGINEERS BRANDOW & JOHNSON J.A. MARTIN & ASSOCIATES</p> <p>MECHANICAL ENGINEERS RALPH E. PHILLIPS, INC.</p> <p>ELECTRICAL ENGINEERS RALPH E. PHILLIPS, INC.</p> <p>CIVIL ENGINEERS O. SHUTMAN & ASSOCIATES MOFFATT & NICKOL</p>										<p>DESIGNED JML 12/1</p> <p>DRAWN BY K.B.</p> <p>CHECKED BY K.B.</p>										<p>ARCHITECT WILLIAM L. PEREIRA</p> <p>ENGINEER</p> <p>COLLEGE</p>										<p>APPROVED STATE FIRE MARSHAL STATE OF CALIFORNIA DATE JUN 21 1965</p> <p>25874 APPROVED JUN 21 1965</p>										<p>ASSOCIATED ARCHITECTS: WILLIAM L. PEREIRA & ASSOCIATES A. QUINCY JONES-FREDERICK E. EMMONS & ASSOCIATES BLUROCK ELLERBROCK & ASSOCIATES</p> <p>URBANUS SQUARE • MACARTHUR BOULEVARD AT FIRD ROAD TELEPHONE 714/675-2640 • CORONA DEL MAR, CALIFORNIA</p>										<p>GOLDEN WEST COLLEGE HUNTINGTON BEACH, CALIFORNIA ORANGE COAST JUNIOR COLLEGE DISTRICT</p>										<p>SECOND FLOOR</p>										<p>UNIT 1</p>										<p>FLOOR PLAN</p>										<p>SCALE 1/8" = 1'</p>										<p>JOB NO. 100-1</p>										<p>DATE 15 JUN 1965</p>										<p>SHEET NO. A 3.2</p>									
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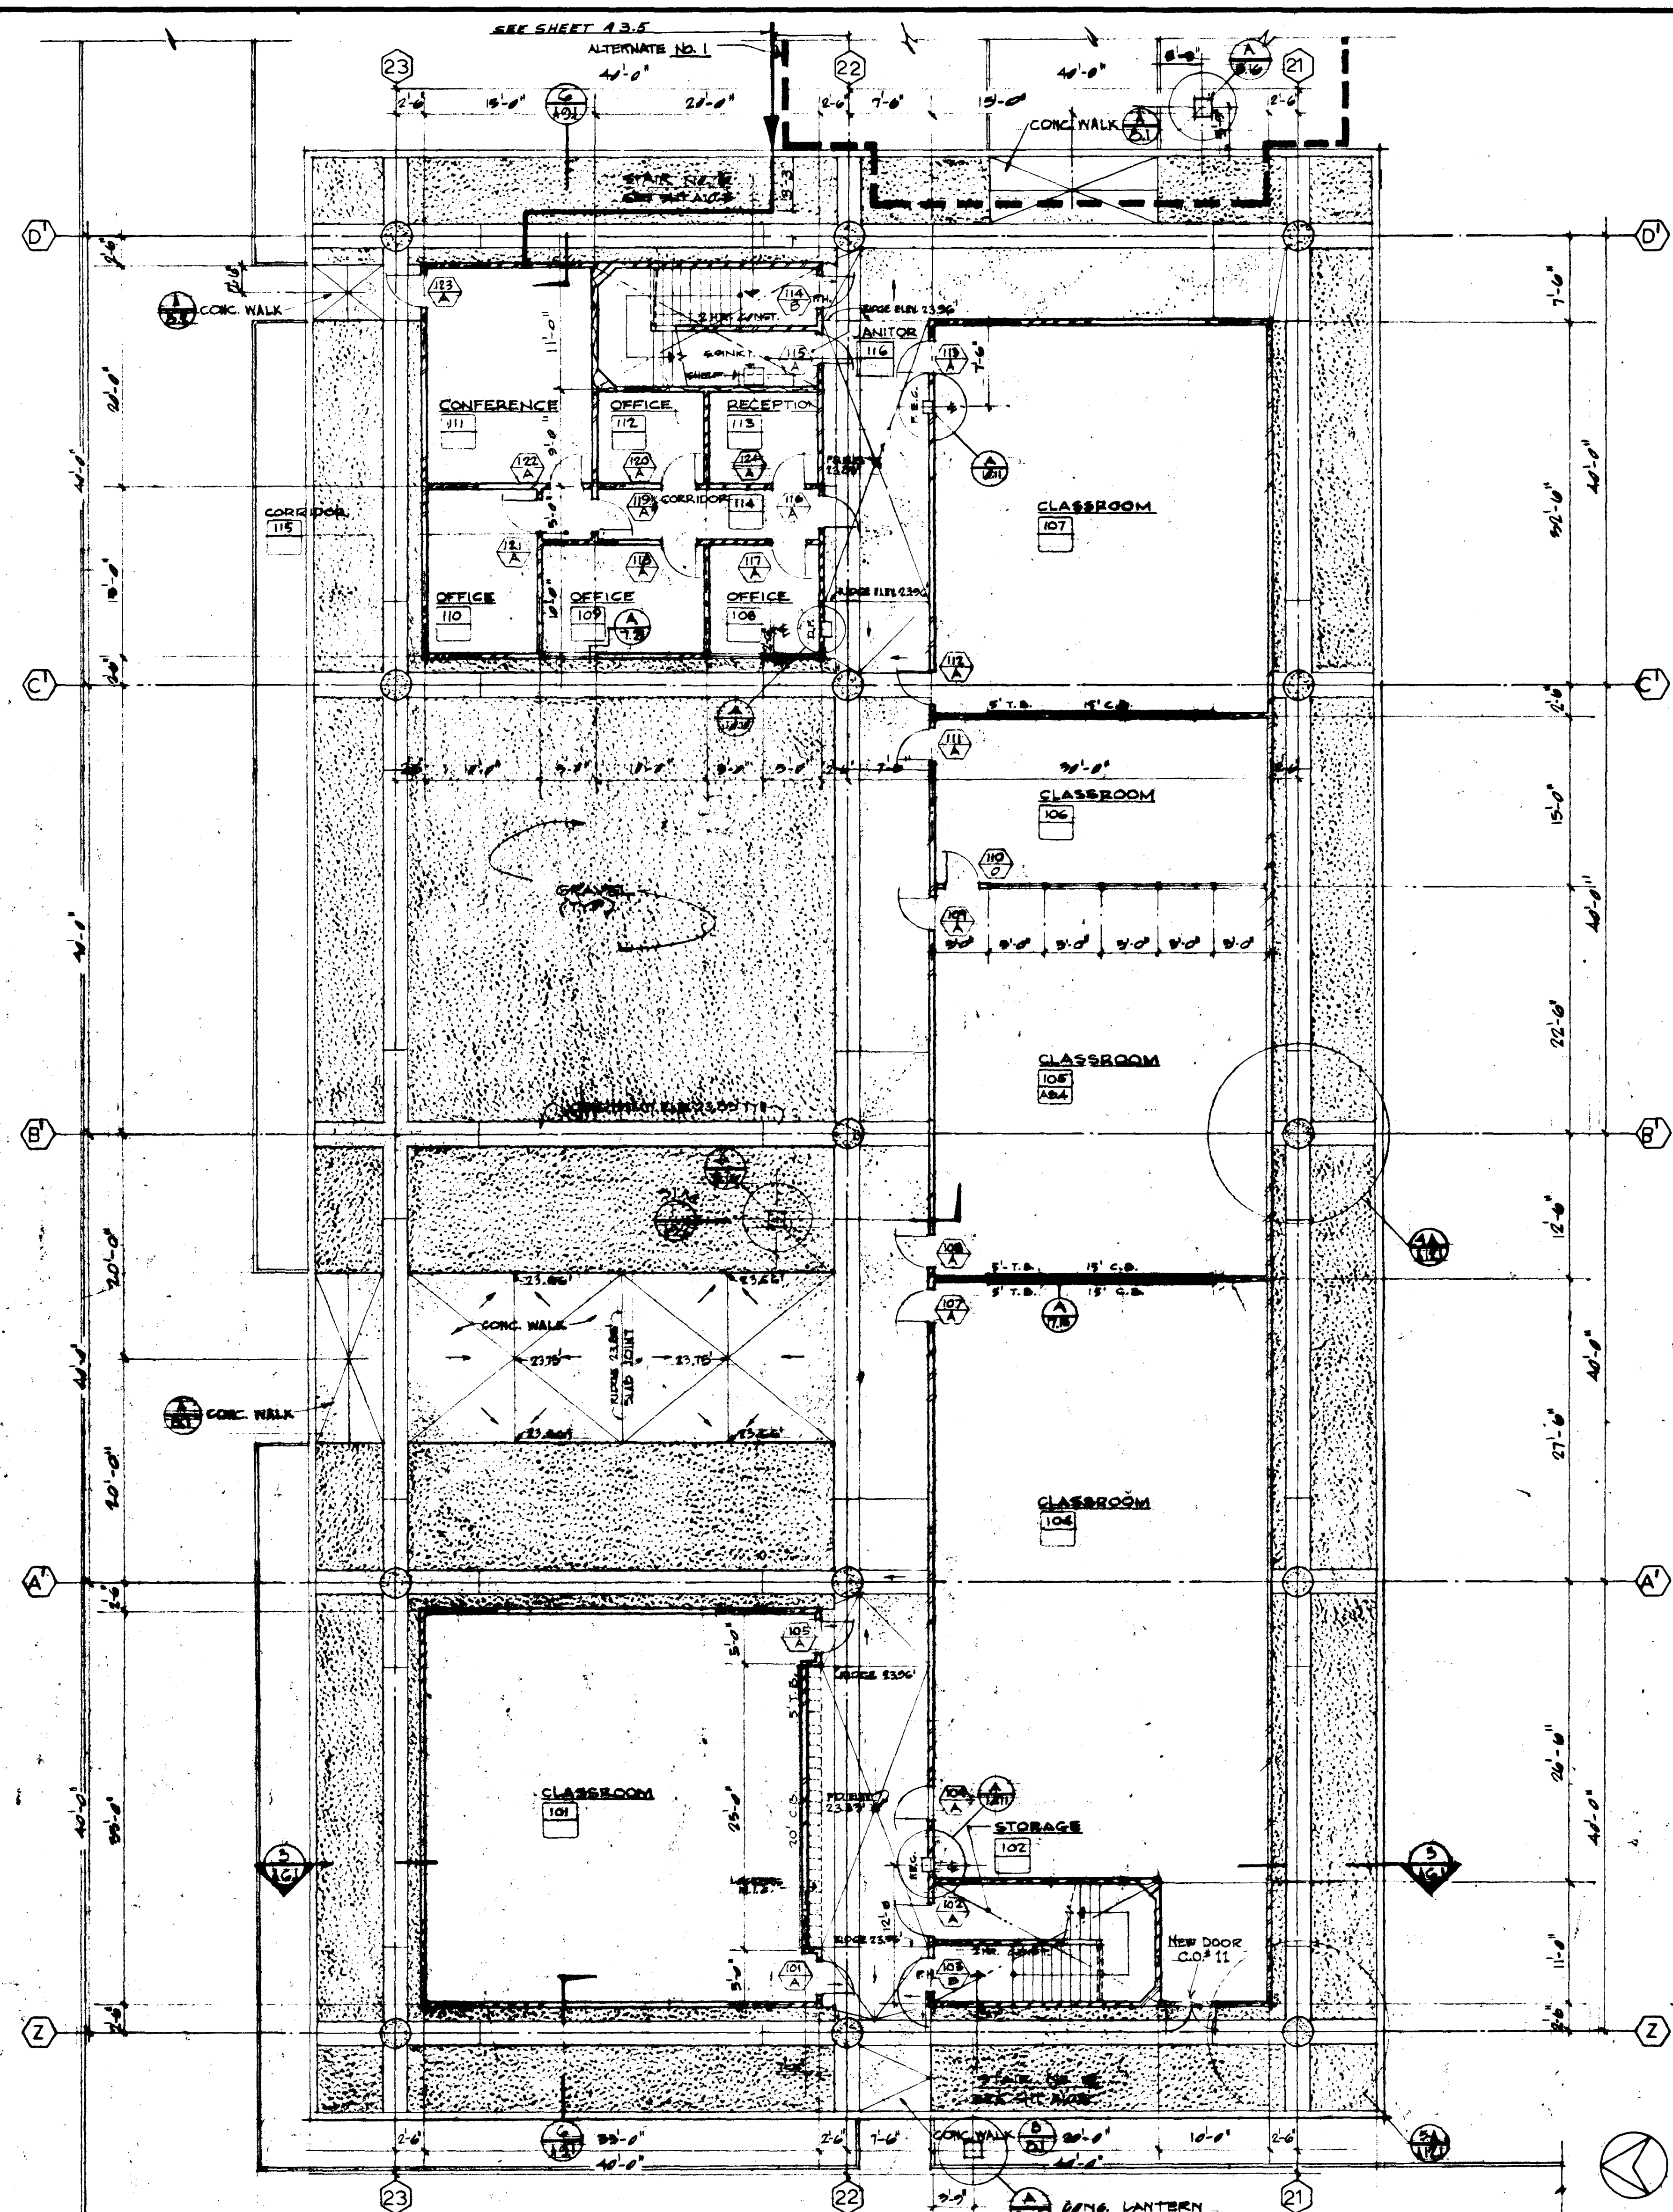
- FLOOR FITS LEGEND**
- 1. UTILITY FIT (PROVIDE ONE DEMONSTRATION TABLE DET. 1/24)
 - 2. LECTURE FIT (PROVIDE ONE LECTURE DET. 1/24)
 - 3. SOUND COM. FIT (PROVIDE ONE MUSIC CONSOLE DET. 1/24)
 - 4. UTILITY FIT (PROVIDE ONE DEMONSTRATION TABLE DET. 1/24)

NOTE: SEE SHIT P.2.1 FOR ADDITIONAL TRENCH DETAILS

SECOND FLOOR				FIRST FLOOR			
STRUCTURAL ENGINEERS BRANDOW & JOHNSTON J.A. MARTIN & ASSOCIATES		DESIGNED JUL RJ	ARCHITECT WILLIAM L. FERREIRA & ASSOCIATES	APPROVED STATE FIRE MARSHAL STATE OF CALIFORNIA DATE: JUN 21 1965		UNIT 2 NO UNDERGROUND FLOOR PLANS	
MECHANICAL ENGINEERS RALPH E. PHILLIPS, INC.		DRAWN BY W. PAKGALSKAS	ENGINEER	ASSOCIATED ARCHITECTS: WILLIAM L. FERREIRA & ASSOCIATES A. QUINCY JONES-FREDERICK E. EMMONS & ASSOCIATES BLUROCK ELLERBROEK & ASSOCIATES		JOB NO. 100-1	
ELECTRICAL ENGINEERS RALPH E. PHILLIPS, INC.		CHECKED BY RM	COLLEGE	URBANUS SQUARE • MACARTHUR BOULEVARD AT FORD ROAD TELEPHONE 714/675-2640 • CORONA DEL MAR, CALIFORNIA		DATE JUN 1965 SHEET NO. A 3.3	
CIVIL ENGINEERS G. SHUKMAN & ASSOCIATES MOFFATT & NICHOL		REVISIONS					



SECOND FLOOR

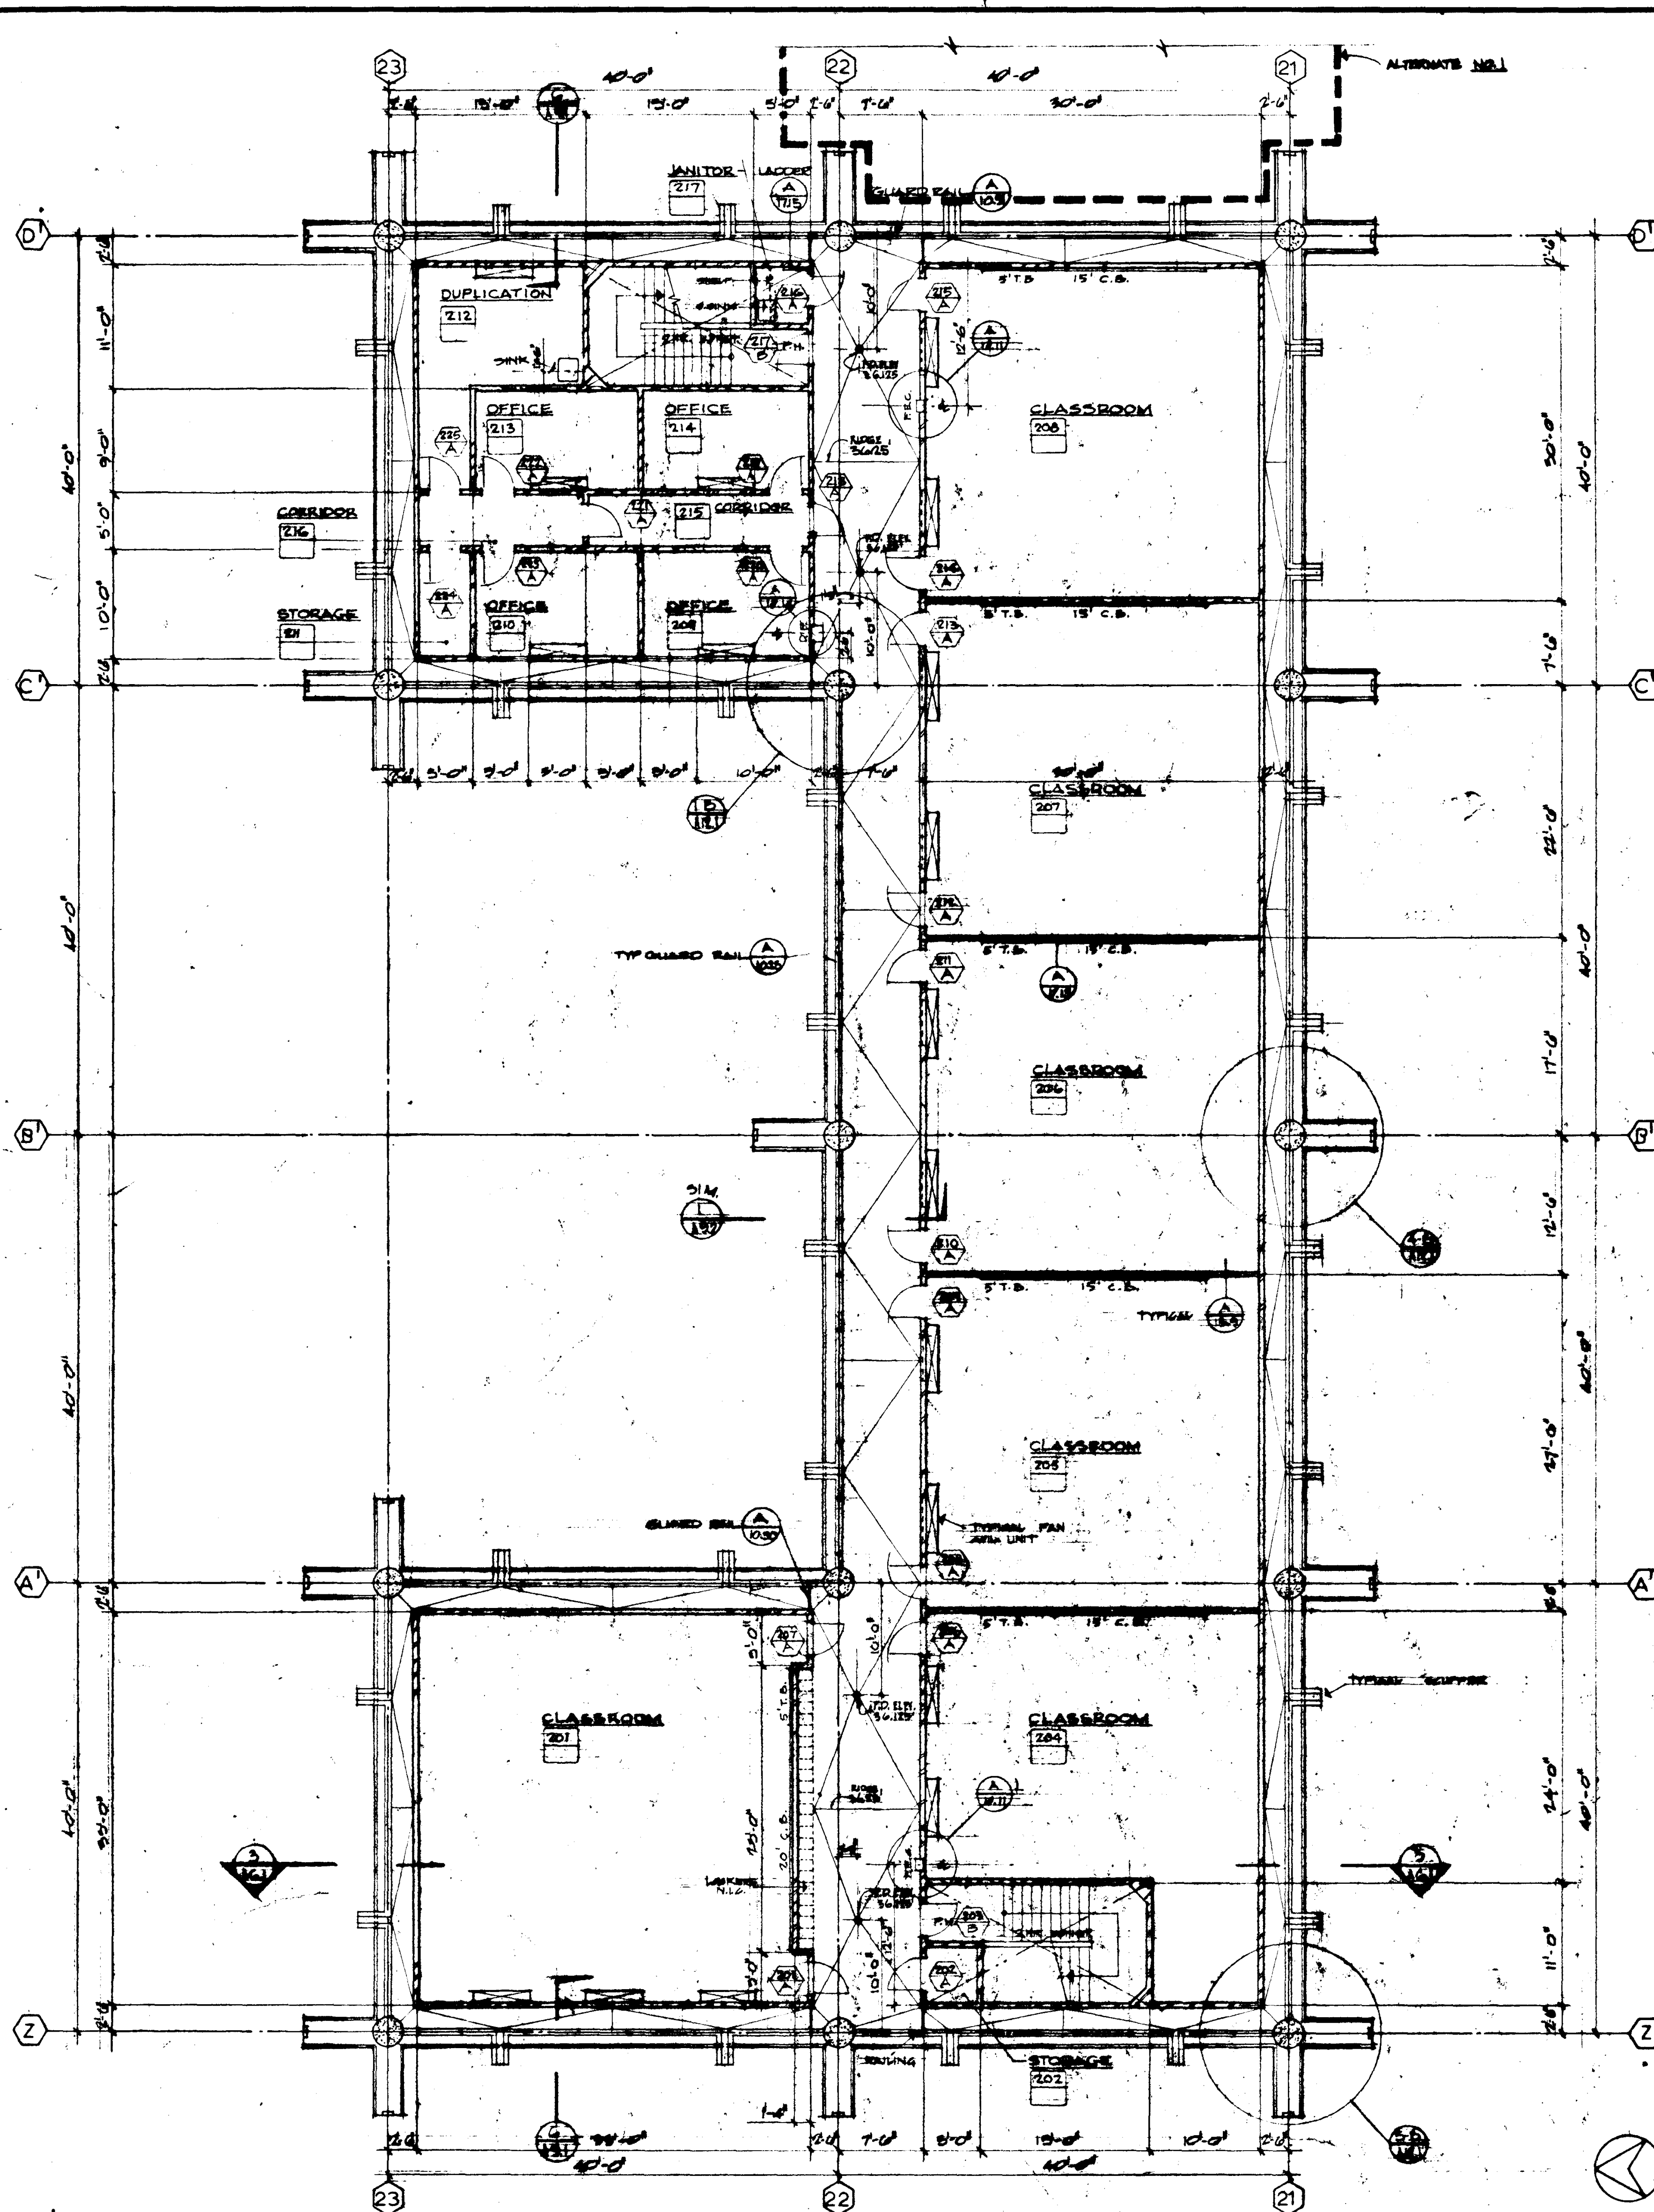

FIRST FLOOR UNDERGROUND AIR PIPING

NO.	REVISIONS
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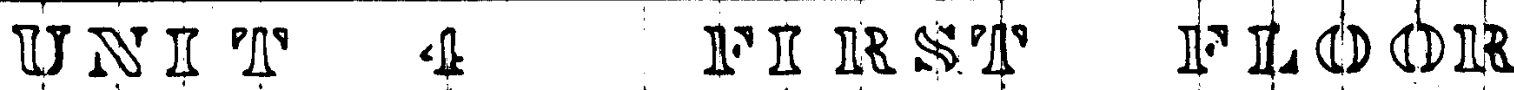
DESIGNED JUL R.J.	ARCHITECT WILLIAM L. PEREIRA
DRAWN BY W. PADGALSKAS	ENGINEER COLLEGE
CHECKED BY P.M.	

APPROVED
STATE FIRE MARSHAL
STATE OF CALIFORNIA
DATE JUN 21 1965
25874 APPROVED JUN 21 1965


ASSOCIATED ARCHITECTS:
WILLIAM L. PEREIRA & ASSOCIATES
A. QUINCY JONES-FREDERICK R. ENMONS & ASSOCIATES
BLUROCK MILLERBROOK & ASSOCIATES
URBANUS SQUARE • MACARTHUR BOULEVARD AT FORD ROAD
TELEPHONE 714/678-2640 • CORONA DEL MAR, CALIFORNIA

GOLDEN WEST COLLEGE
HUNTINGTON BEACH, CALIFORNIA
ORANGE COAST JUNIOR COLLEGE DISTRICT


UNIT 3	SCALE 1/8" = 1'
FLOOR PLANS	JUN 1965
	SHEET NO. A 3.4



GOLDEN WEST COLLEGE
HUNTINGTON BEACH, CALIFORNIA
ORANGE COAST JUNIOR COLLEGE DISTRICT

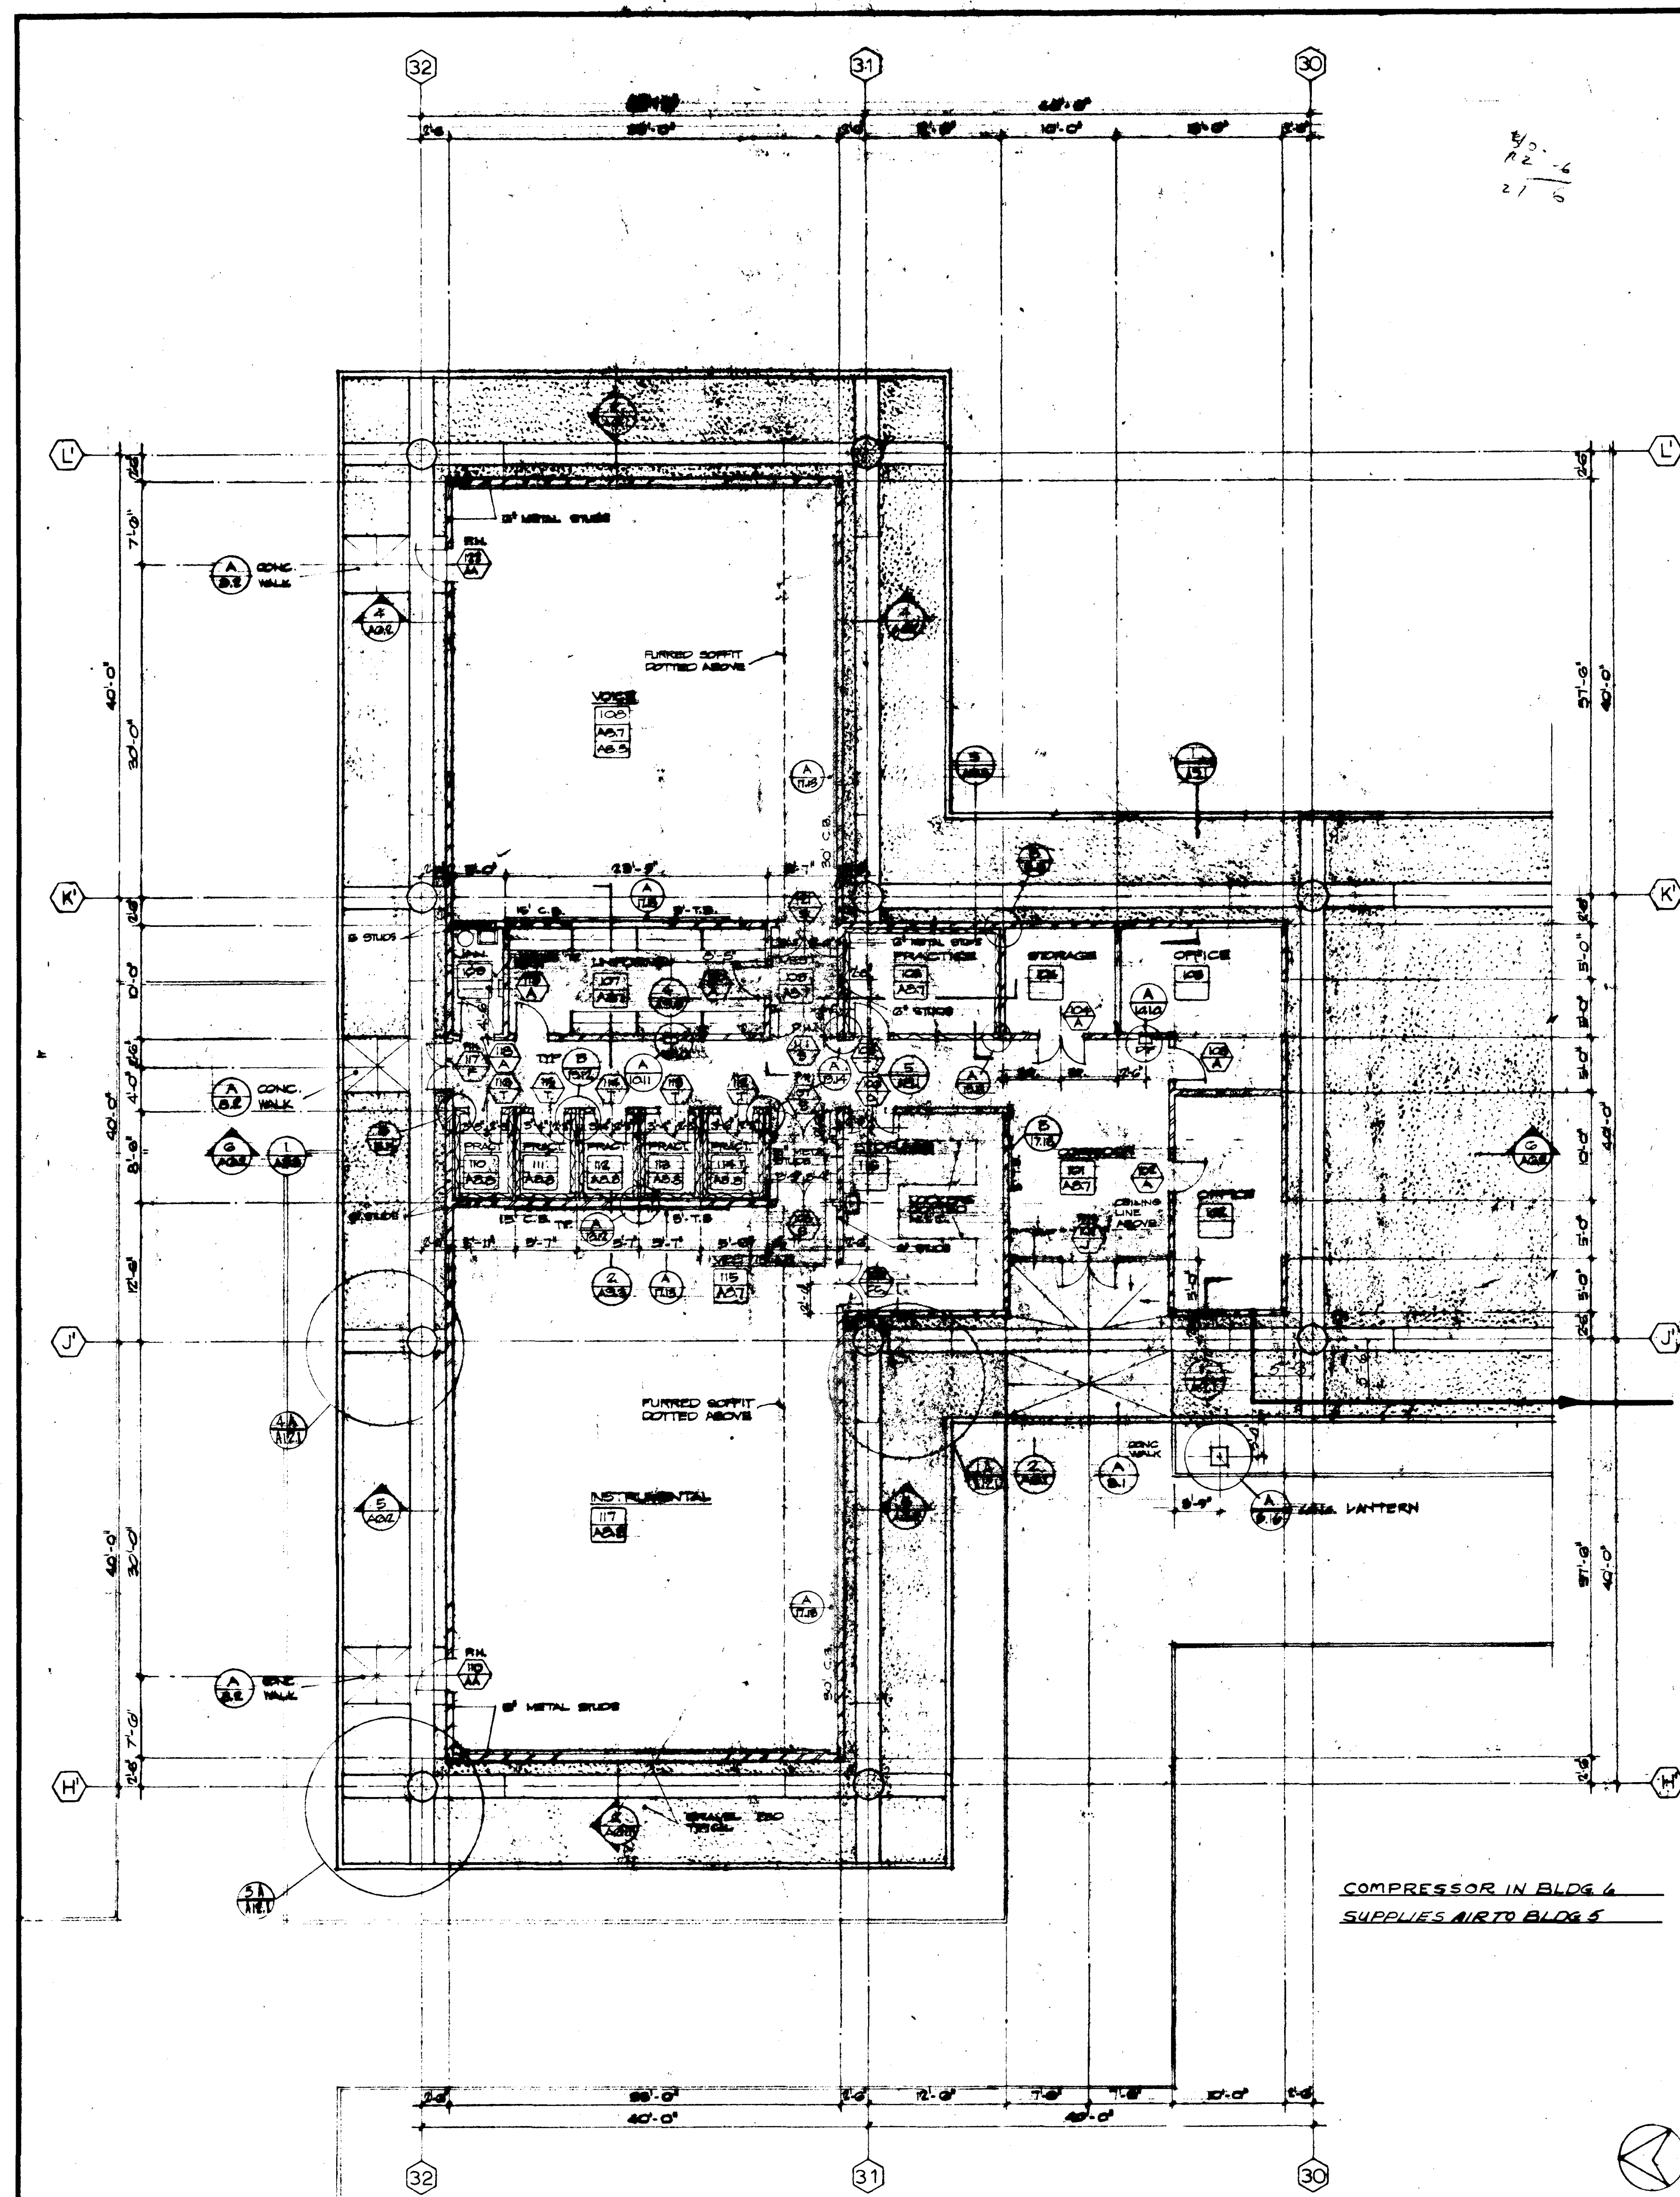


UNIT G FIRST FLOOR

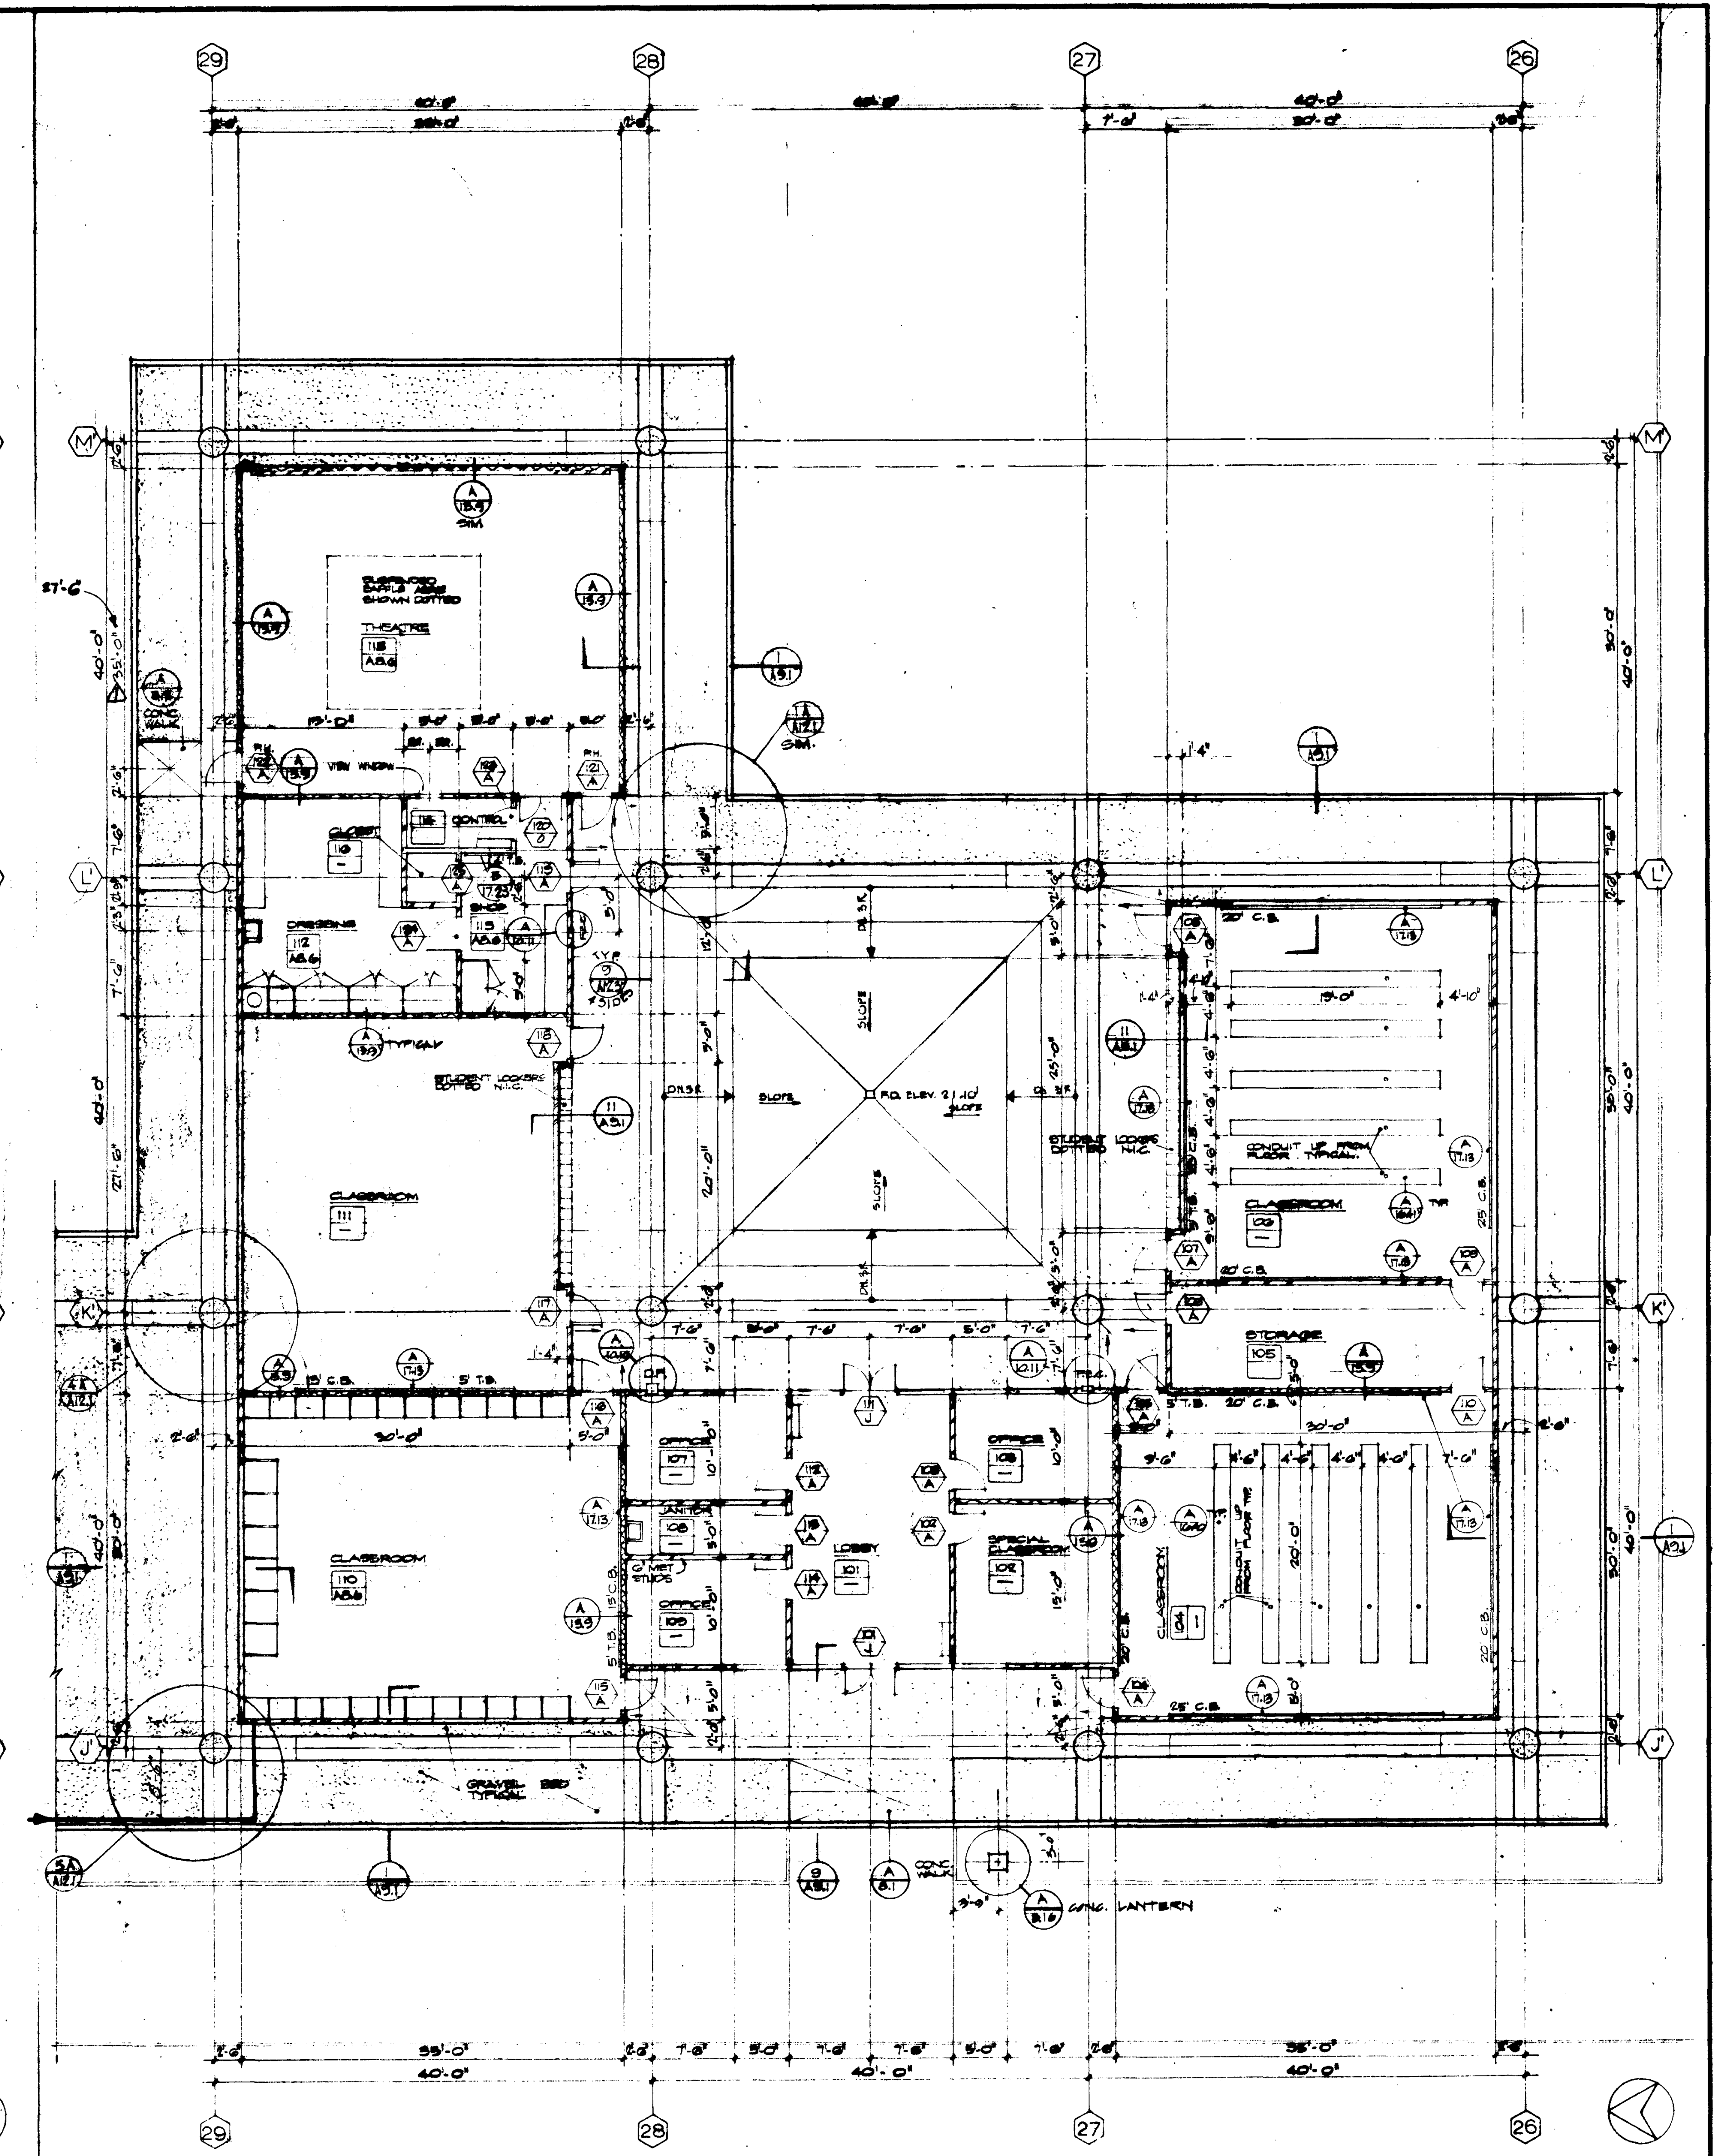


UNIT 5 FIRST FLOOR

REVISIONS 1. CORRECTED 2. CORRECTED 3. CORRECTED 4. CORRECTED 5. CORRECTED 6. CORRECTED 7. CORRECTED 8. CORRECTED 9. CORRECTED 10. CORRECTED				STRUCTURAL ENGINEERS BRADY & JOHNSON J.A. MARTIN & ASSOCIATES MECHANICAL ENGINEERS RALPH E. PHILLIPS, INC. ELECTRICAL ENGINEERS RALPH E. PHILLIPS, INC. CIVIL ENGINEERS G. SHURMAN & ASSOCIATES MOFFATT & NICHOL				DESIGNED JUL 22 53 DRAWN BY K.S. M.M. CHECKED BY [Signature] DATE JUN 21 1955				APPROVED STATE FIRE MARSHAL STATE OF CALIFORNIA JUN 21 1955 25874 APPROVED JUN 21 1955				ASSOCIATED ARCHITECTS: WILLIAM L. PEREIRA & ASSOCIATES A. QUINCY JONES-FREDERICK H. EMMONS & ASSOCIATES BLUROCK ELLERBROCK & ASSOCIATES URBANUS SQUARE • MACARTHUR BOULEVARD AT FORD ROAD TELEPHONE 714/675-2640 • CORONA DEL MAR, CALIFORNIA				GOLDEN WEST COLLEGE HUNTINGTON BEACH, CALIFORNIA ORANGE COAST JUNIOR COLLEGE DISTRICT				UNIT 5 - G FLOOR PLANS SCALE 1/8" = 1'-0" JOB NO. 10-1 DATE JUN 1955 SHEET NO. A-35			
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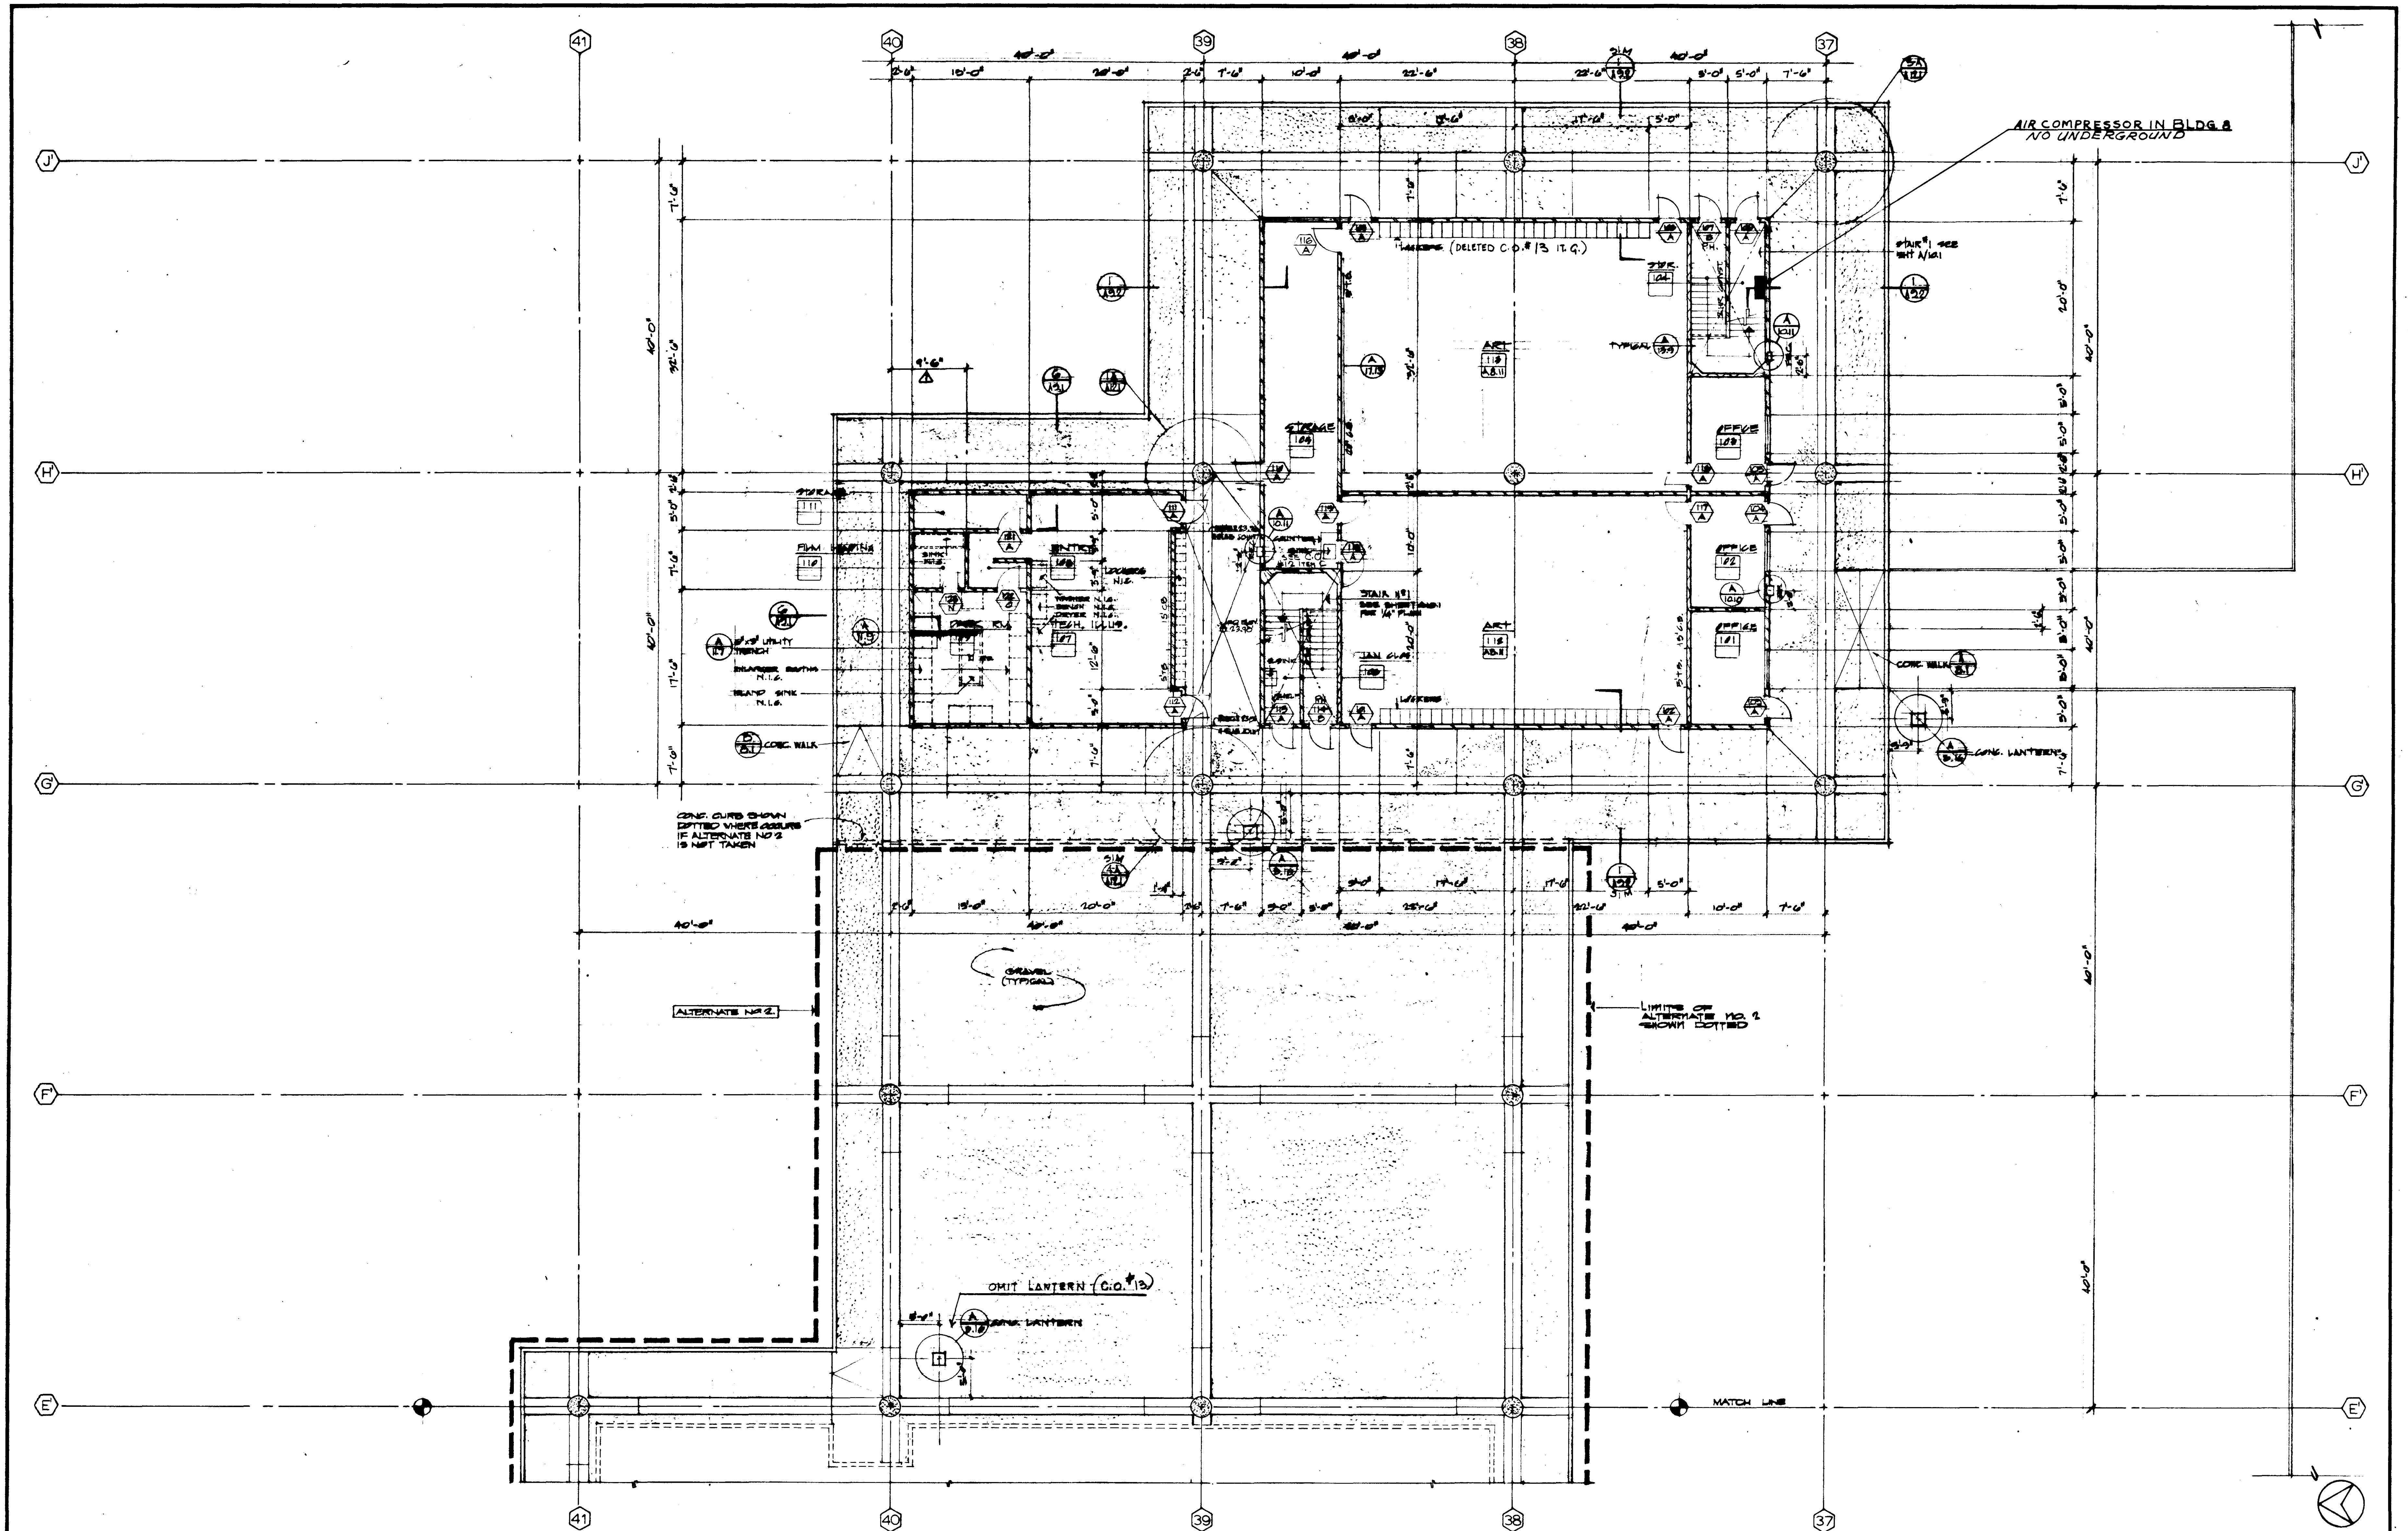


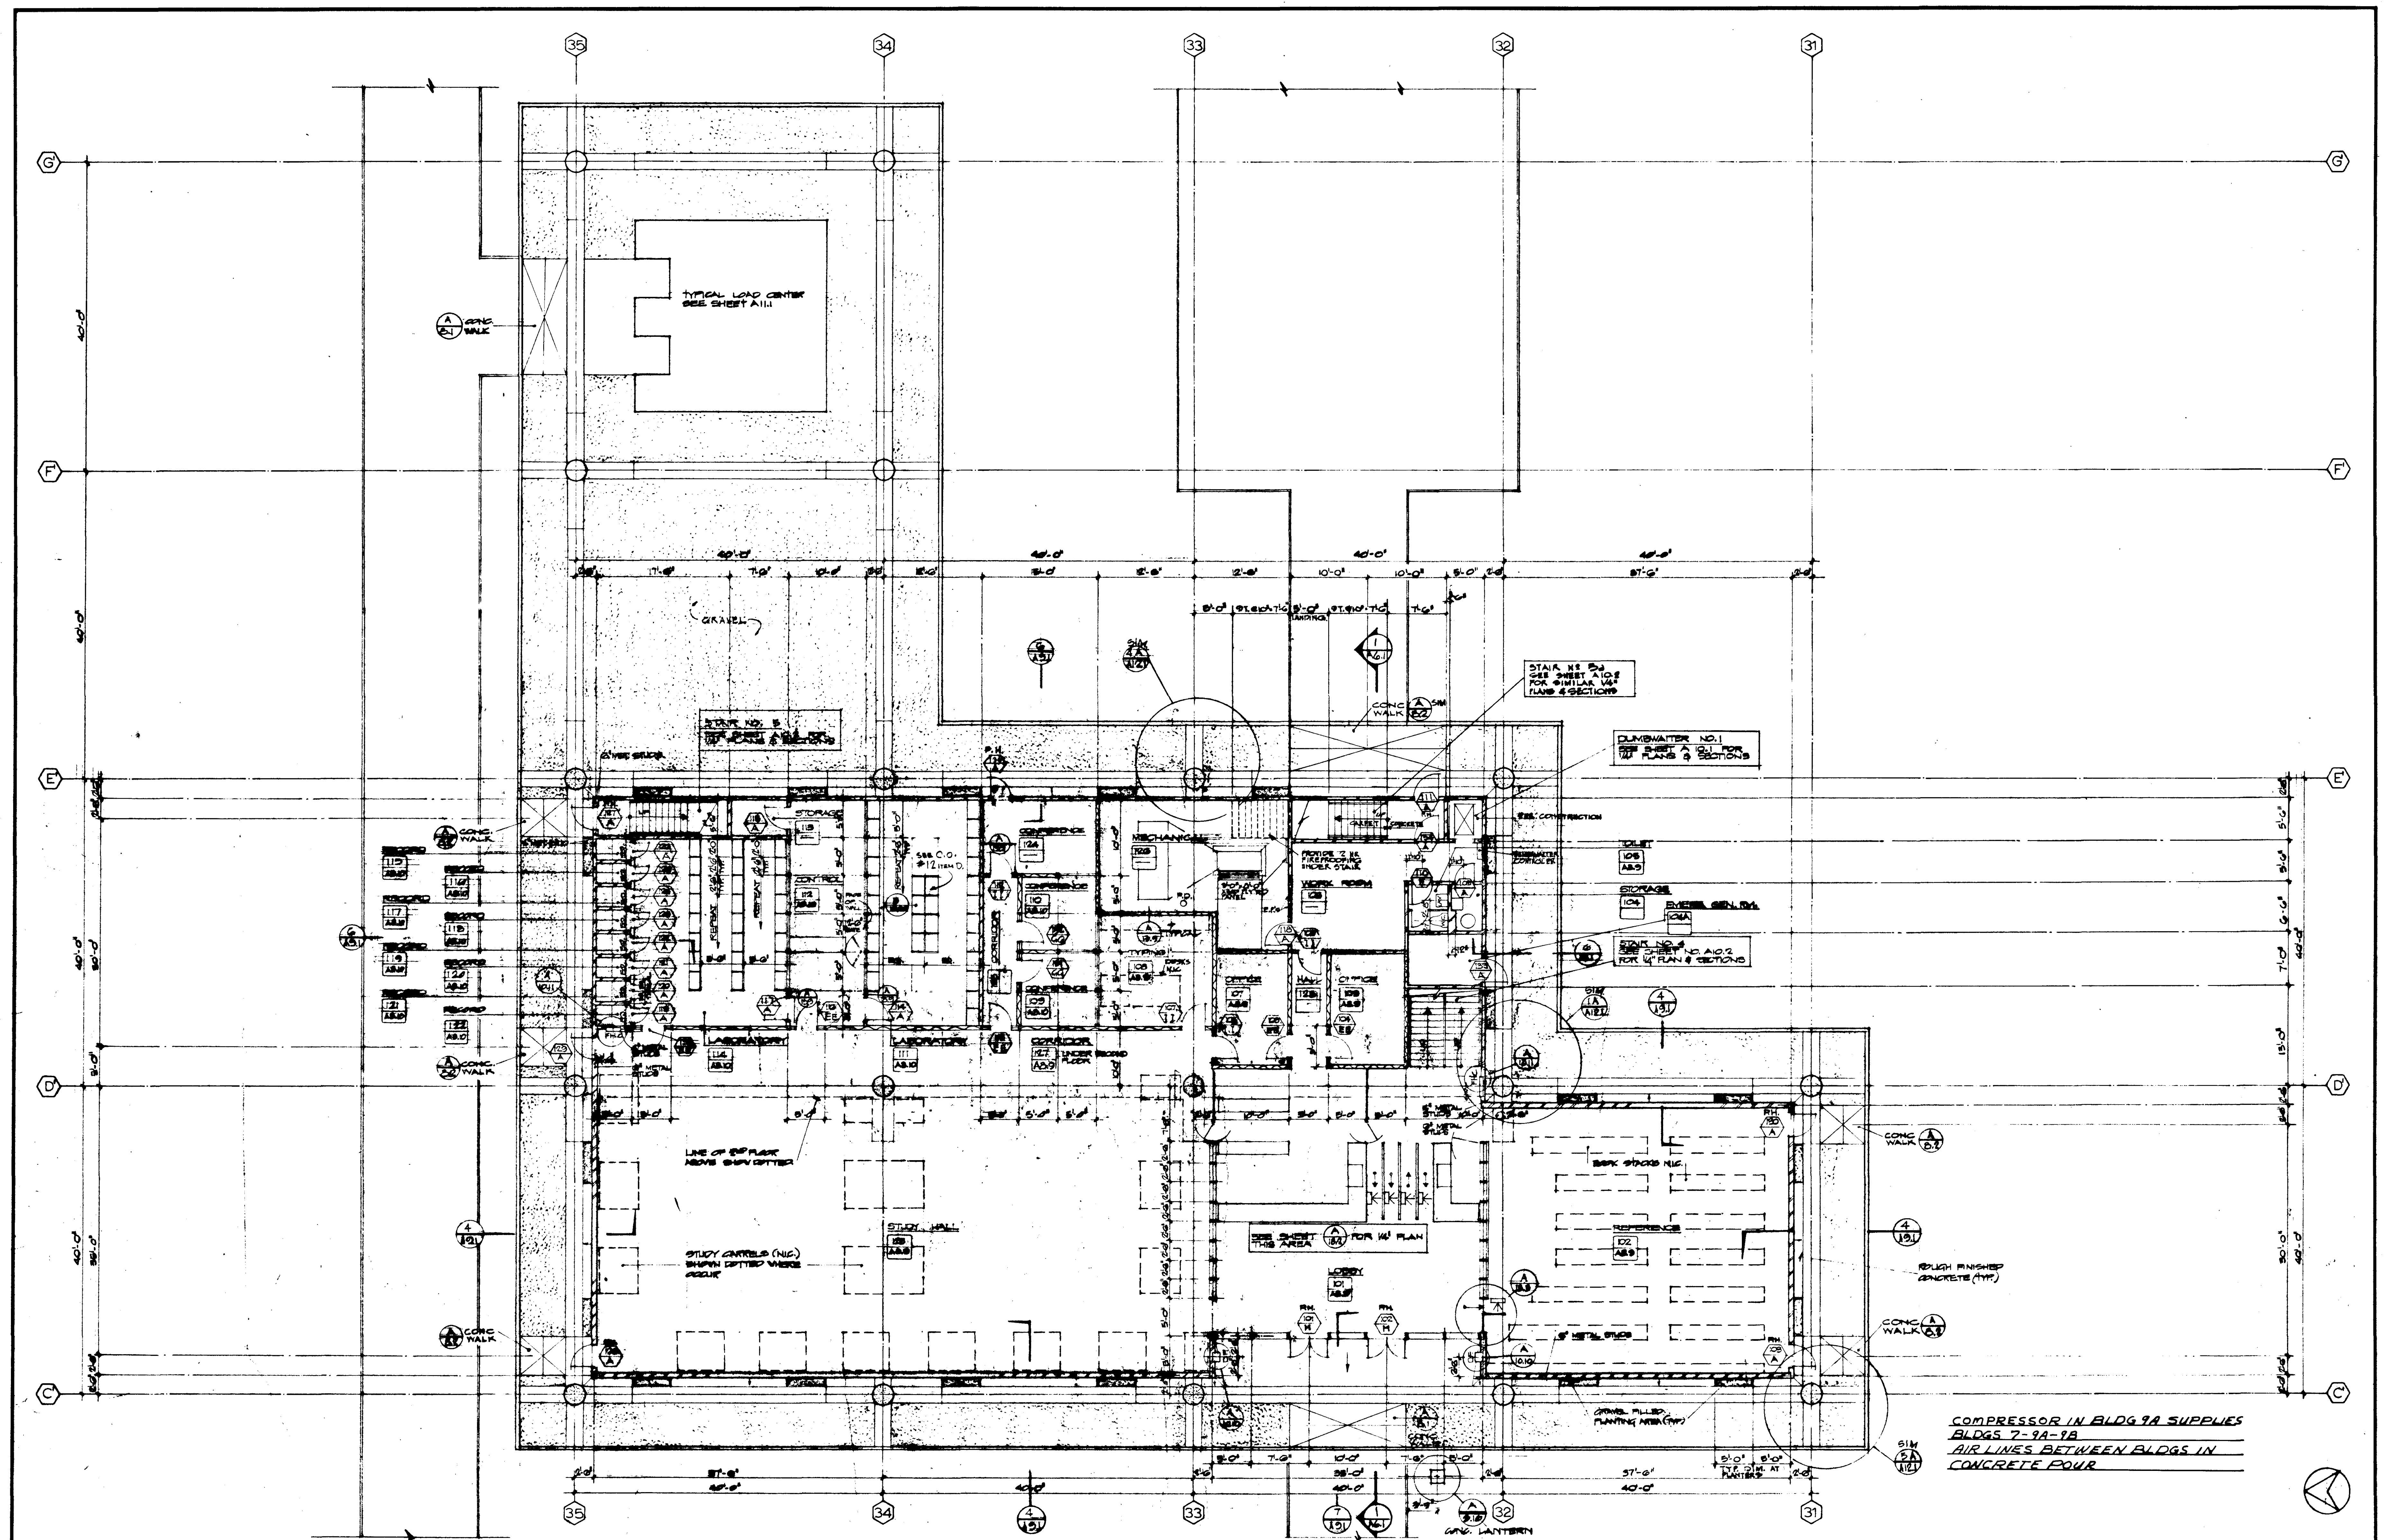1. FIRST 2. L. COOK

[illegible]

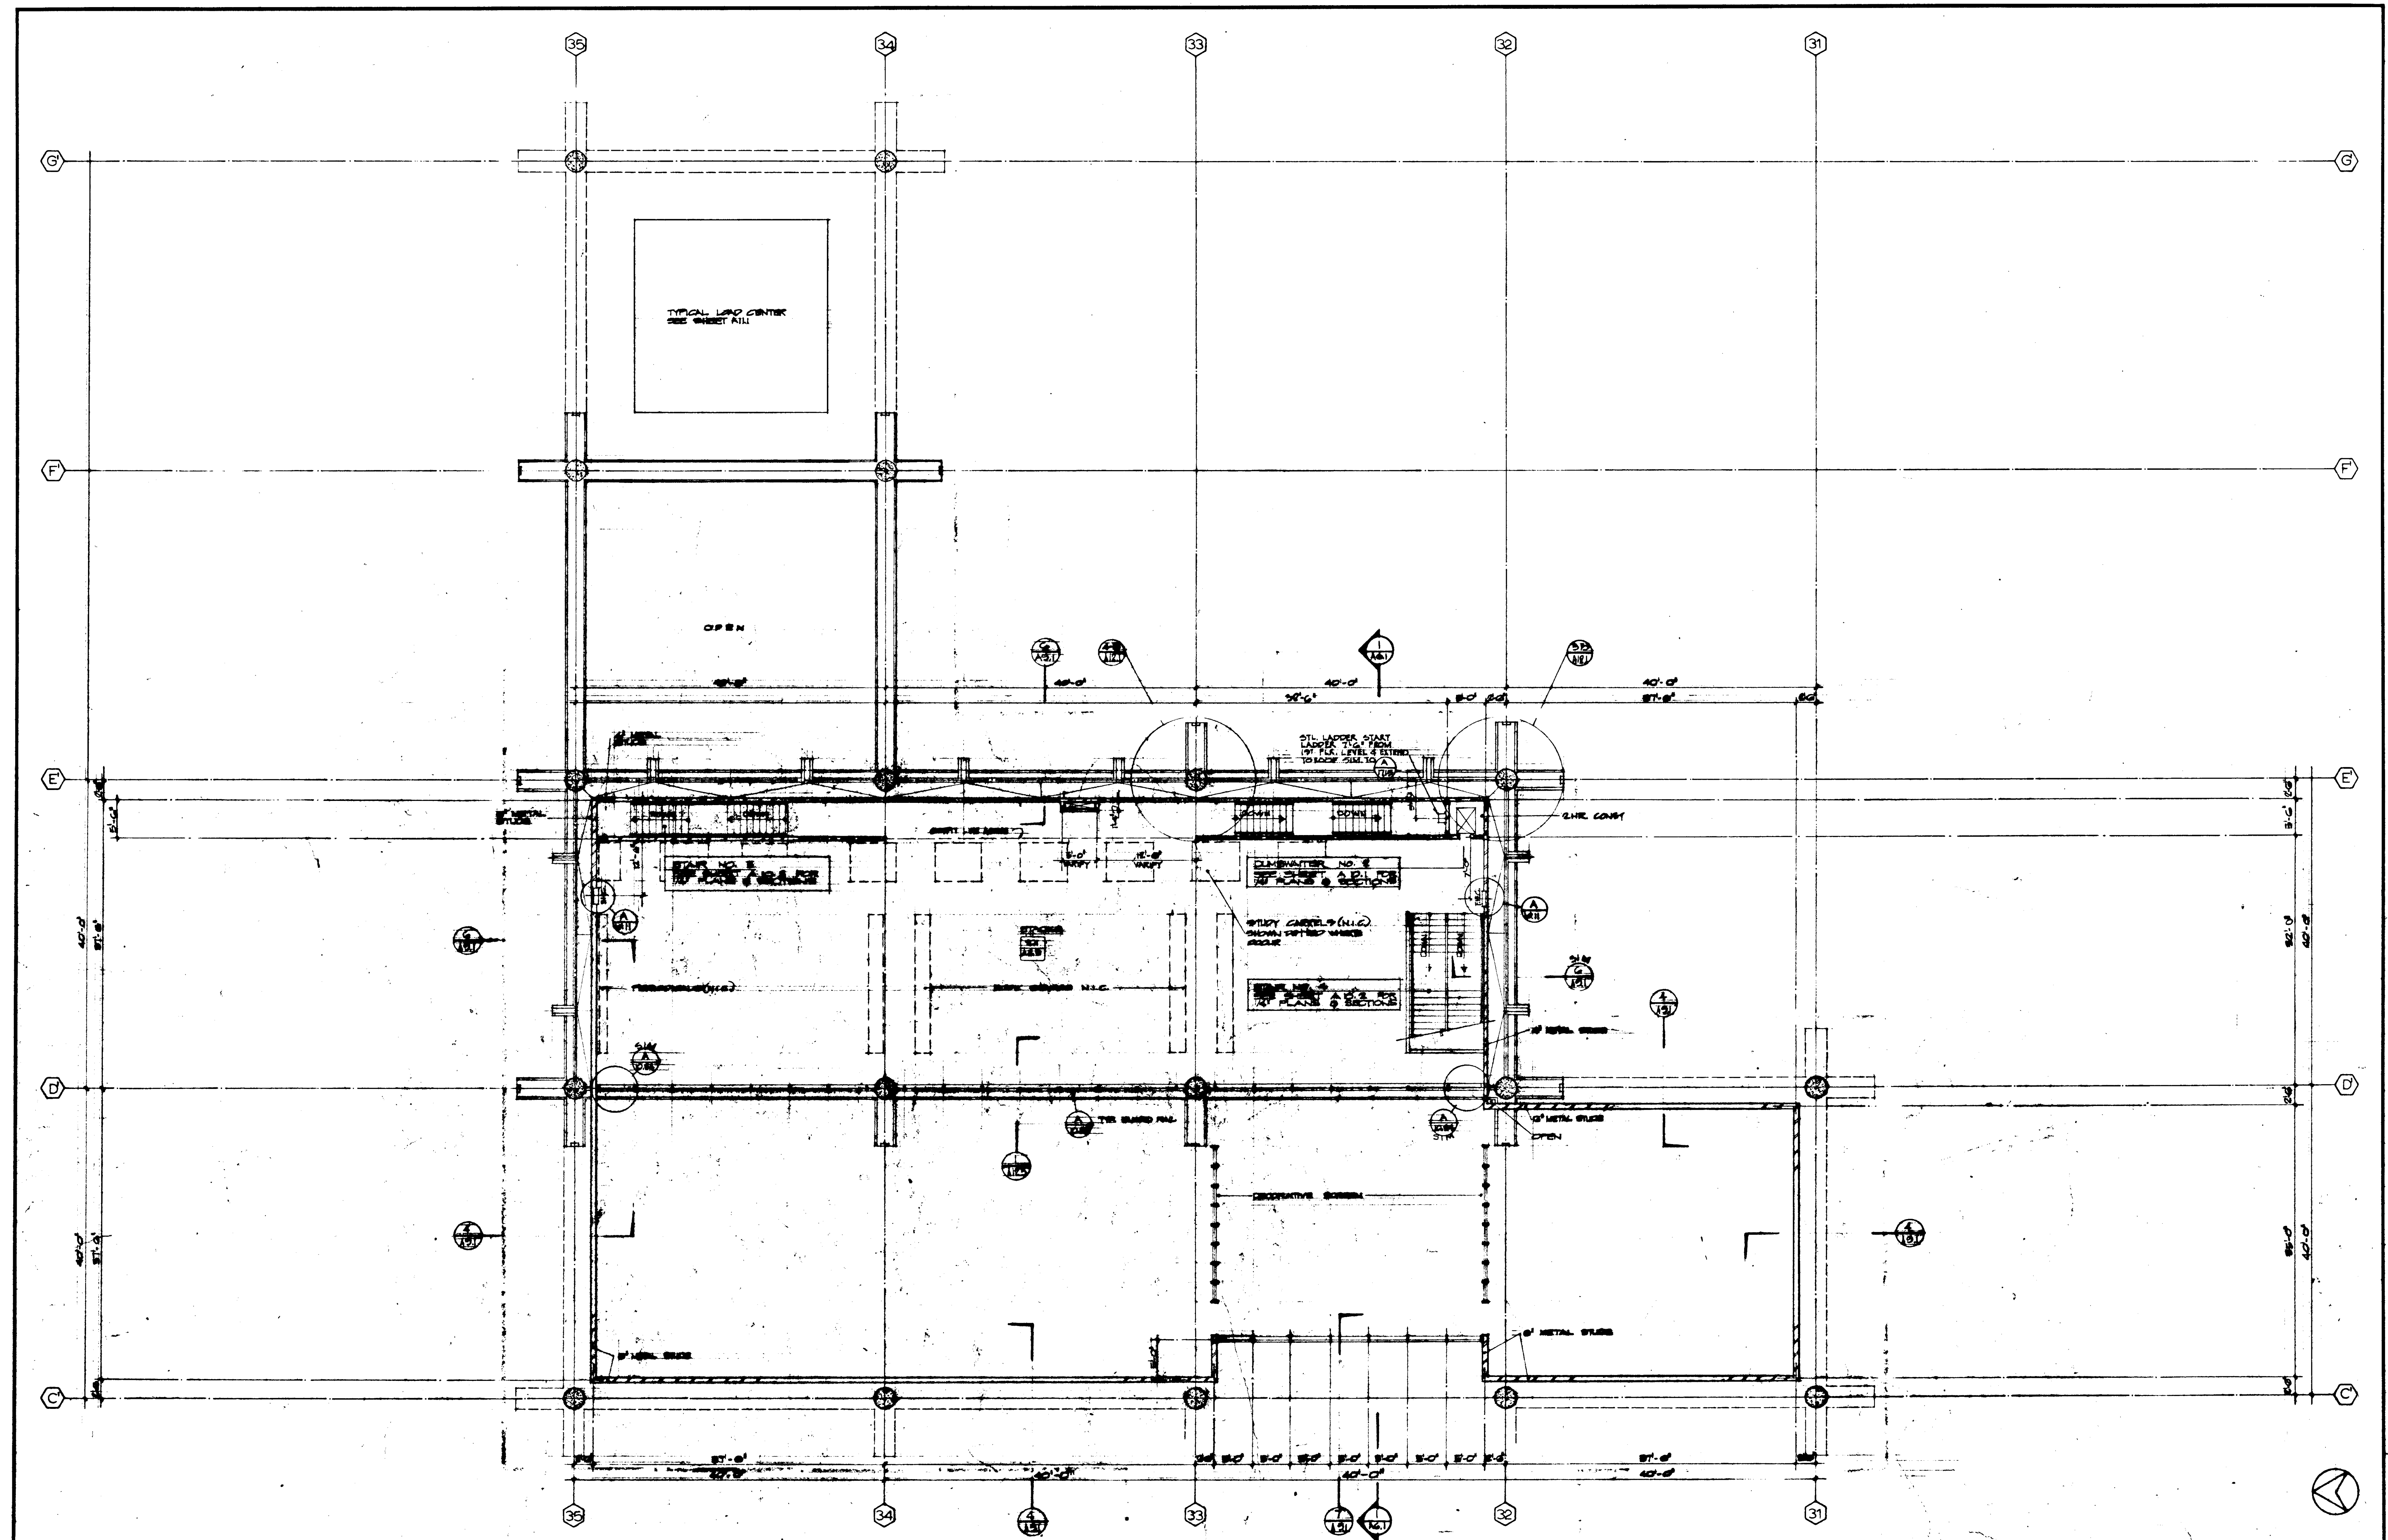


SECOND FLOOR										SCALE	1
UNIT 7										JOB NO.	MM-1
FLOOR										DATE	15 JUN 1965
PLAN										SHEET NO.	A 325
<div> <div> <div>STRUCTURAL ENGINEERS BRADY & JOHNSON J.A. MARTIN & ASSOCIATES</div> <div>DESIGNED JUL RS</div> <div>ARCHITECT WILLIAM L. PEREIRA</div> <div>APPROVED STATE FIRE MARSHAL STATE OF CALIFORNIA JUN 21 1965</div> </div> <div> <div>MECHANICAL ENGINEERS RALPH E. PHILLIPS, INC.</div> <div>DRAWN BY F. J. R. F.</div> <div>ENGINEER</div> <div>COLLEGE</div> </div> <div> <div>ELECTRICAL ENGINEERS RALPH E. PHILLIPS, INC.</div> <div>CHECKED BY R. J.</div> <div>CIVIL ENGINEERS O. BRIDGMAN & ASSOCIATES MOTTAC & NICHOLS</div> </div> </div>										<div> <div>ASSOCIATED ARCHITECTS: WILLIAM L. PEREIRA & ASSOCIATES A. QUINCY JONES, FREDERICK E. EMMONS & ASSOCIATES BLUROCK ELLERBROCK & ASSOCIATES</div> <div>URBANUS SQUARE • MACARTHUR BOULEVARD AT FORD ROAD TELEPHONE 714/675-2640 • CORONA DEL MAR, CALIFORNIA</div> </div>	



FIRST FLOOR


1

<p>REVISIONS</p>	<p>STRUCTURAL ENGINEERS BRANDOW & JOHNSON 2 A. MARTIN & ASSOCIATES</p> <p>MECHANICAL ENGINEERS RALPH E. PHILLIPS, INC.</p> <p>ELECTRICAL ENGINEERS RALPH E. PHILLIPS, INC.</p> <p>CIVIL ENGINEERS G. SHURMAN & ASSOCIATES MOFFATT & NICHOL</p>	<p>DESIGNED J.H.L. R.J.</p> <p>DRAWN BY M.M.</p> <p>CHECKED BY J.S.</p>	<p>ARCHITECT WILLIAM L. PEREIRA & ASSOCIATES</p> <p>ENGINEER</p> <p>COLLEGE</p>	<p>APPROVED STATE FIRE MARSHAL STATE OF CALIFORNIA JUN 15 1965</p> <p>25874 APPROVED JUN 21 1965</p> <p>ASSOCIATED ARCHITECTS: WILLIAM L. PEREIRA & ASSOCIATES A. QUINCY JONES-FREDERICK E. EMMONS & ASSOCIATES BLUROCK ELLERBROEK & ASSOCIATES</p> <p>URBANUS SQUARE • MACARTHUR BOULEVARD AT FORD ROAD TELEPHONE 714/675-2640 • CORONA DEL MAR, CALIFORNIA</p>	<p>GOLDEN WEST COLLEGE HUNTINGTON BEACH, CALIFORNIA ORANGE COAST JUNIOR COLLEGE DISTRICT</p>	<p>UNIT 83 a</p> <p>FLOOR</p> <p>PLAN</p>	<p>JOB NO. 100-1</p> <p>DATE 15 JUN 1965</p> <p>SHEET NO. A 3.10</p>
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UNIT 88 FIRST FLOOR

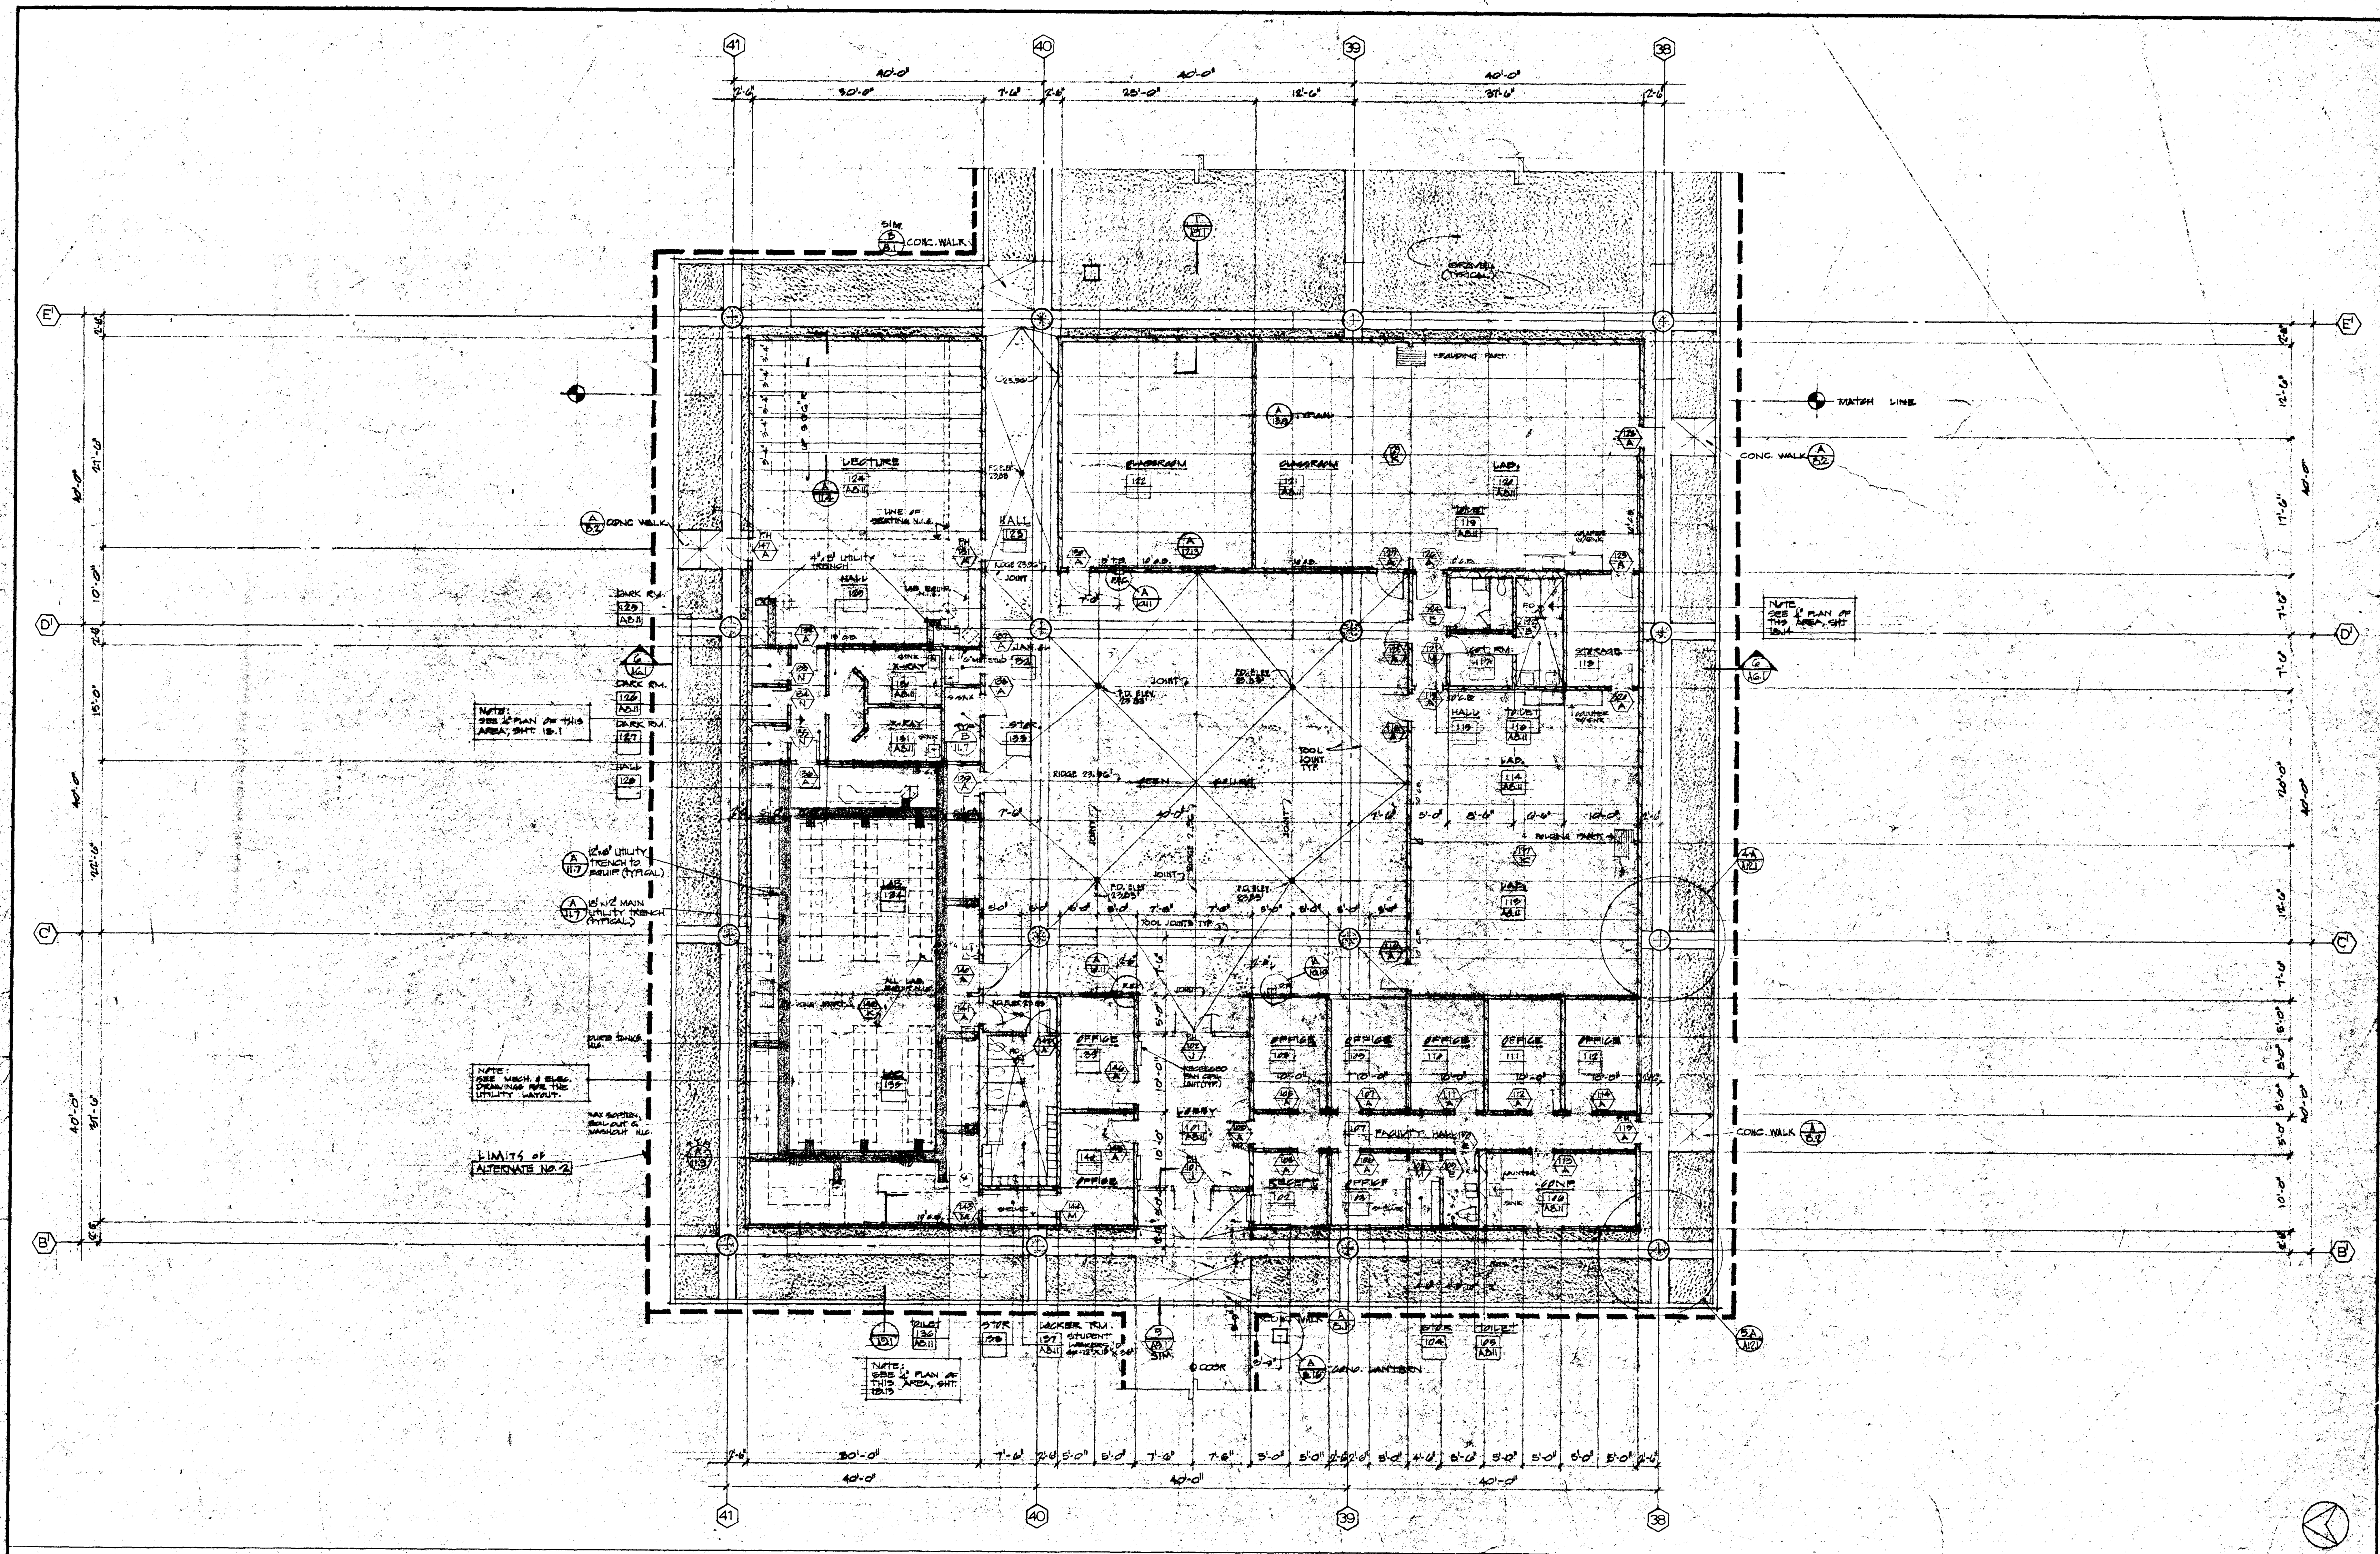STRUCTURAL ENGINEERS BRANDOW & JOHNSTON J.A. MARTIN & ASSOCIATES		DESIGNED J.H. R.J.	ARCHITECT WILLIAM L. PEREIRA	APPROVED WILLIAM L. PEREIRA	ASSOCIATED ARCHITECTS: WILLIAM L. PEREIRA & ASSOCIATES A. QUINCY JONES, FREDERICK E. EMMONS & ASSOCIATES BLUROCK ELLERBROEK & ASSOCIATES URBANUS SQUARE • MACARTHUR BOULEVARD AT FORD ROAD TELEPHONE 714/675-2640 • CORONA DEL MAR, CALIFORNIA	GOLDEN WEST COLLEGE HUNTINGTON BEACH, CALIFORNIA ORANGE COAST JUNIOR COLLEGE DISTRICT	UNIT 88b ALTERNATE NO. 2	JOB NO. 1004
MECHANICAL ENGINEERS RALPH E. PHILLIPS, INC.		DRAWN BY M.M.	ENGINEER COLLEGE	DATE 15 JUN 1965			FLOOR	SHEET NO. A 312
ELECTRICAL ENGINEERS RALPH E. PHILLIPS, INC.		CHECKED BY J.M.					PLAN	
CIVIL ENGINEERS G. SHURMAN & ASSOCIATES MOFFATT & NICOL								
DATE DRAWN REVISIONS								



REVISIONS 1. 10-1-65 2. 10-1-65 3. 10-1-65 4. 10-1-65 5. 10-1-65 6. 10-1-65 7. 10-1-65 8. 10-1-65 9. 10-1-65 10. 10-1-65 11. 10-1-65 12. 10-1-65 13. 10-1-65 14. 10-1-65 15. 10-1-65 16. 10-1-65 17. 10-1-65 18. 10-1-65 19. 10-1-65 20. 10-1-65 21. 10-1-65 22. 10-1-65 23. 10-1-65 24. 10-1-65 25. 10-1-65 26. 10-1-65 27. 10-1-65 28. 10-1-65 29. 10-1-65 30. 10-1-65 31. 10-1-65 32. 10-1-65 33. 10-1-65 34. 10-1-65 35. 10-1-65 36. 10-1-65 37. 10-1-65 38. 10-1-65 39. 10-1-65 40. 10-1-65 41. 10-1-65 42. 10-1-65 43. 10-1-65 44. 10-1-65 45. 10-1-65 46. 10-1-65 47. 10-1-65 48. 10-1-65 49. 10-1-65 50. 10-1-65 51. 10-1-65 52. 10-1-65 53. 10-1-65 54. 10-1-65 55. 10-1-65 56. 10-1-65 57. 10-1-65 58. 10-1-65 59. 10-1-65 60. 10-1-65 61. 10-1-65 62. 10-1-65 63. 10-1-65 64. 10-1-65 65. 10-1-65 66. 10-1-65 67. 10-1-65 68. 10-1-65 69. 10-1-65 70. 10-1-65 71. 10-1-65 72. 10-1-65 73. 10-1-65 74. 10-1-65 75. 10-1-65 76. 10-1-65 77. 10-1-65 78. 10-1-65 79. 10-1-65 80. 10-1-65 81. 10-1-65 82. 10-1-65 83. 10-1-65 84. 10-1-65 85. 10-1-65 86. 10-1-65 87. 10-1-65 88. 10-1-65 89. 10-1-65 90. 10-1-65 91. 10-1-65 92. 10-1-65 93. 10-1-65 94. 10-1-65 95. 10-1-65 96. 10-1-65 97. 10-1-65 98. 10-1-65 99. 10-1-65 100. 10-1-65 101. 10-1-65 102. 10-1-65 103. 10-1-65 104. 10-1-65 105. 10-1-65 106. 10-1-65 107. 10-1-65 108. 10-1-65 109. 10-1-65 110. 10-1-65 111. 10-1-65 112. 10-1-65 113. 10-1-65 114. 10-1-65 115. 10-1-65 116. 10-1-65 117. 10-1-65 118. 10-1-65 119. 10-1-65 120. 10-1-65 121. 10-1-65 122. 10-1-65 123. 10-1-65 124. 10-1-65 125. 10-1-65 126. 10-1-65 127. 10-1-65 128. 10-1-65 129. 10-1-65 130. 10-1-65 131. 10-1-65 132. 10-1-65 133. 10-1-65 134. 10-1-65 135. 10-1-65 136. 10-1-65 137. 10-1-65 138. 10-1-65 139. 10-1-65 140. 10-1-65 141. 10-1-65 142. 10-1-65 143. 10-1-65 144. 10-1-65 145. 10-1-65 146. 10-1-65 147. 10-1-65 148. 10-1-65 149. 10-1-65 150. 10-1-65 151. 10-1-65 152. 10-1-65 153. 10-1-65 154. 10-1-65 155. 10-1-65 156. 10-1-65 157. 10-1-65 158. 10-1-65 159. 10-1-65 160. 10-1-65 161. 10-1-65 162. 10-1-65 163. 10-1-65 164. 10-1-65 165. 10-1-65 166. 10-1-65 167. 10-1-65 168. 10-1-65 169. 10-1-65 170. 10-1-65 171. 10-1-65 172. 10-1-65 173. 10-1-65 174. 10-1-65 175. 10-1-65 176. 10-1-65 177. 10-1-65 178. 10-1-65 179. 10-1-65 180. 10-1-65 181. 10-1-65 182. 10-1-65 183. 10-1-65 184. 10-1-65 185. 10-1-65 186. 10-1-65 187. 10-1-65 188. 10-1-65 189. 10-1-65 190. 10-1-65 191. 10-1-65 192. 10-1-65 193. 10-1-65 194. 10-1-65 195. 10-1-65 196. 10-1-65 197. 10-1-65 198. 10-1-65 199. 10-1-65 200. 10-1-65				STRUCTURAL ENGINEERS BRADY & JOHNSON J.A. MARTIN & ASSOCIATES DESIGNED JAL - P.C. DRAWN BY J.C. CHECKED BY J.C. APPROVED J.C. STATE FIRE MARSHAL STATE OF CALIFORNIA DATE JUN 2 1965 25874 APPROVED JUN 21 1965				ASSOCIATED ARCHITECTS: WILLIAM L. FERREIRA & ASSOCIATES A. QUINCY JONES, FREDERICK E. EDMONS & ASSOCIATES BLUROCK ELLERBROEK & ASSOCIATES URBANUS SQUARE • MACARTHUR BOULEVARD AT FORD ROAD TELEPHONE 714/675-2640 • CORONA DEL MAR, CALIFORNIA				GOLDEN WEST COLLEGE HUNTINGTON BEACH, CALIFORNIA ORANGE COAST JUNIOR COLLEGE DISTRICT				UNIT 9b FLOOR PLAN DATE 5 JUN 1965 SHEET NO. A3.1.1				FIRST FLOOR SCALE 1/8" = 1'-0"			
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GWC - WATER SYSTEM
DANIEL BOYLE ENG. INC.

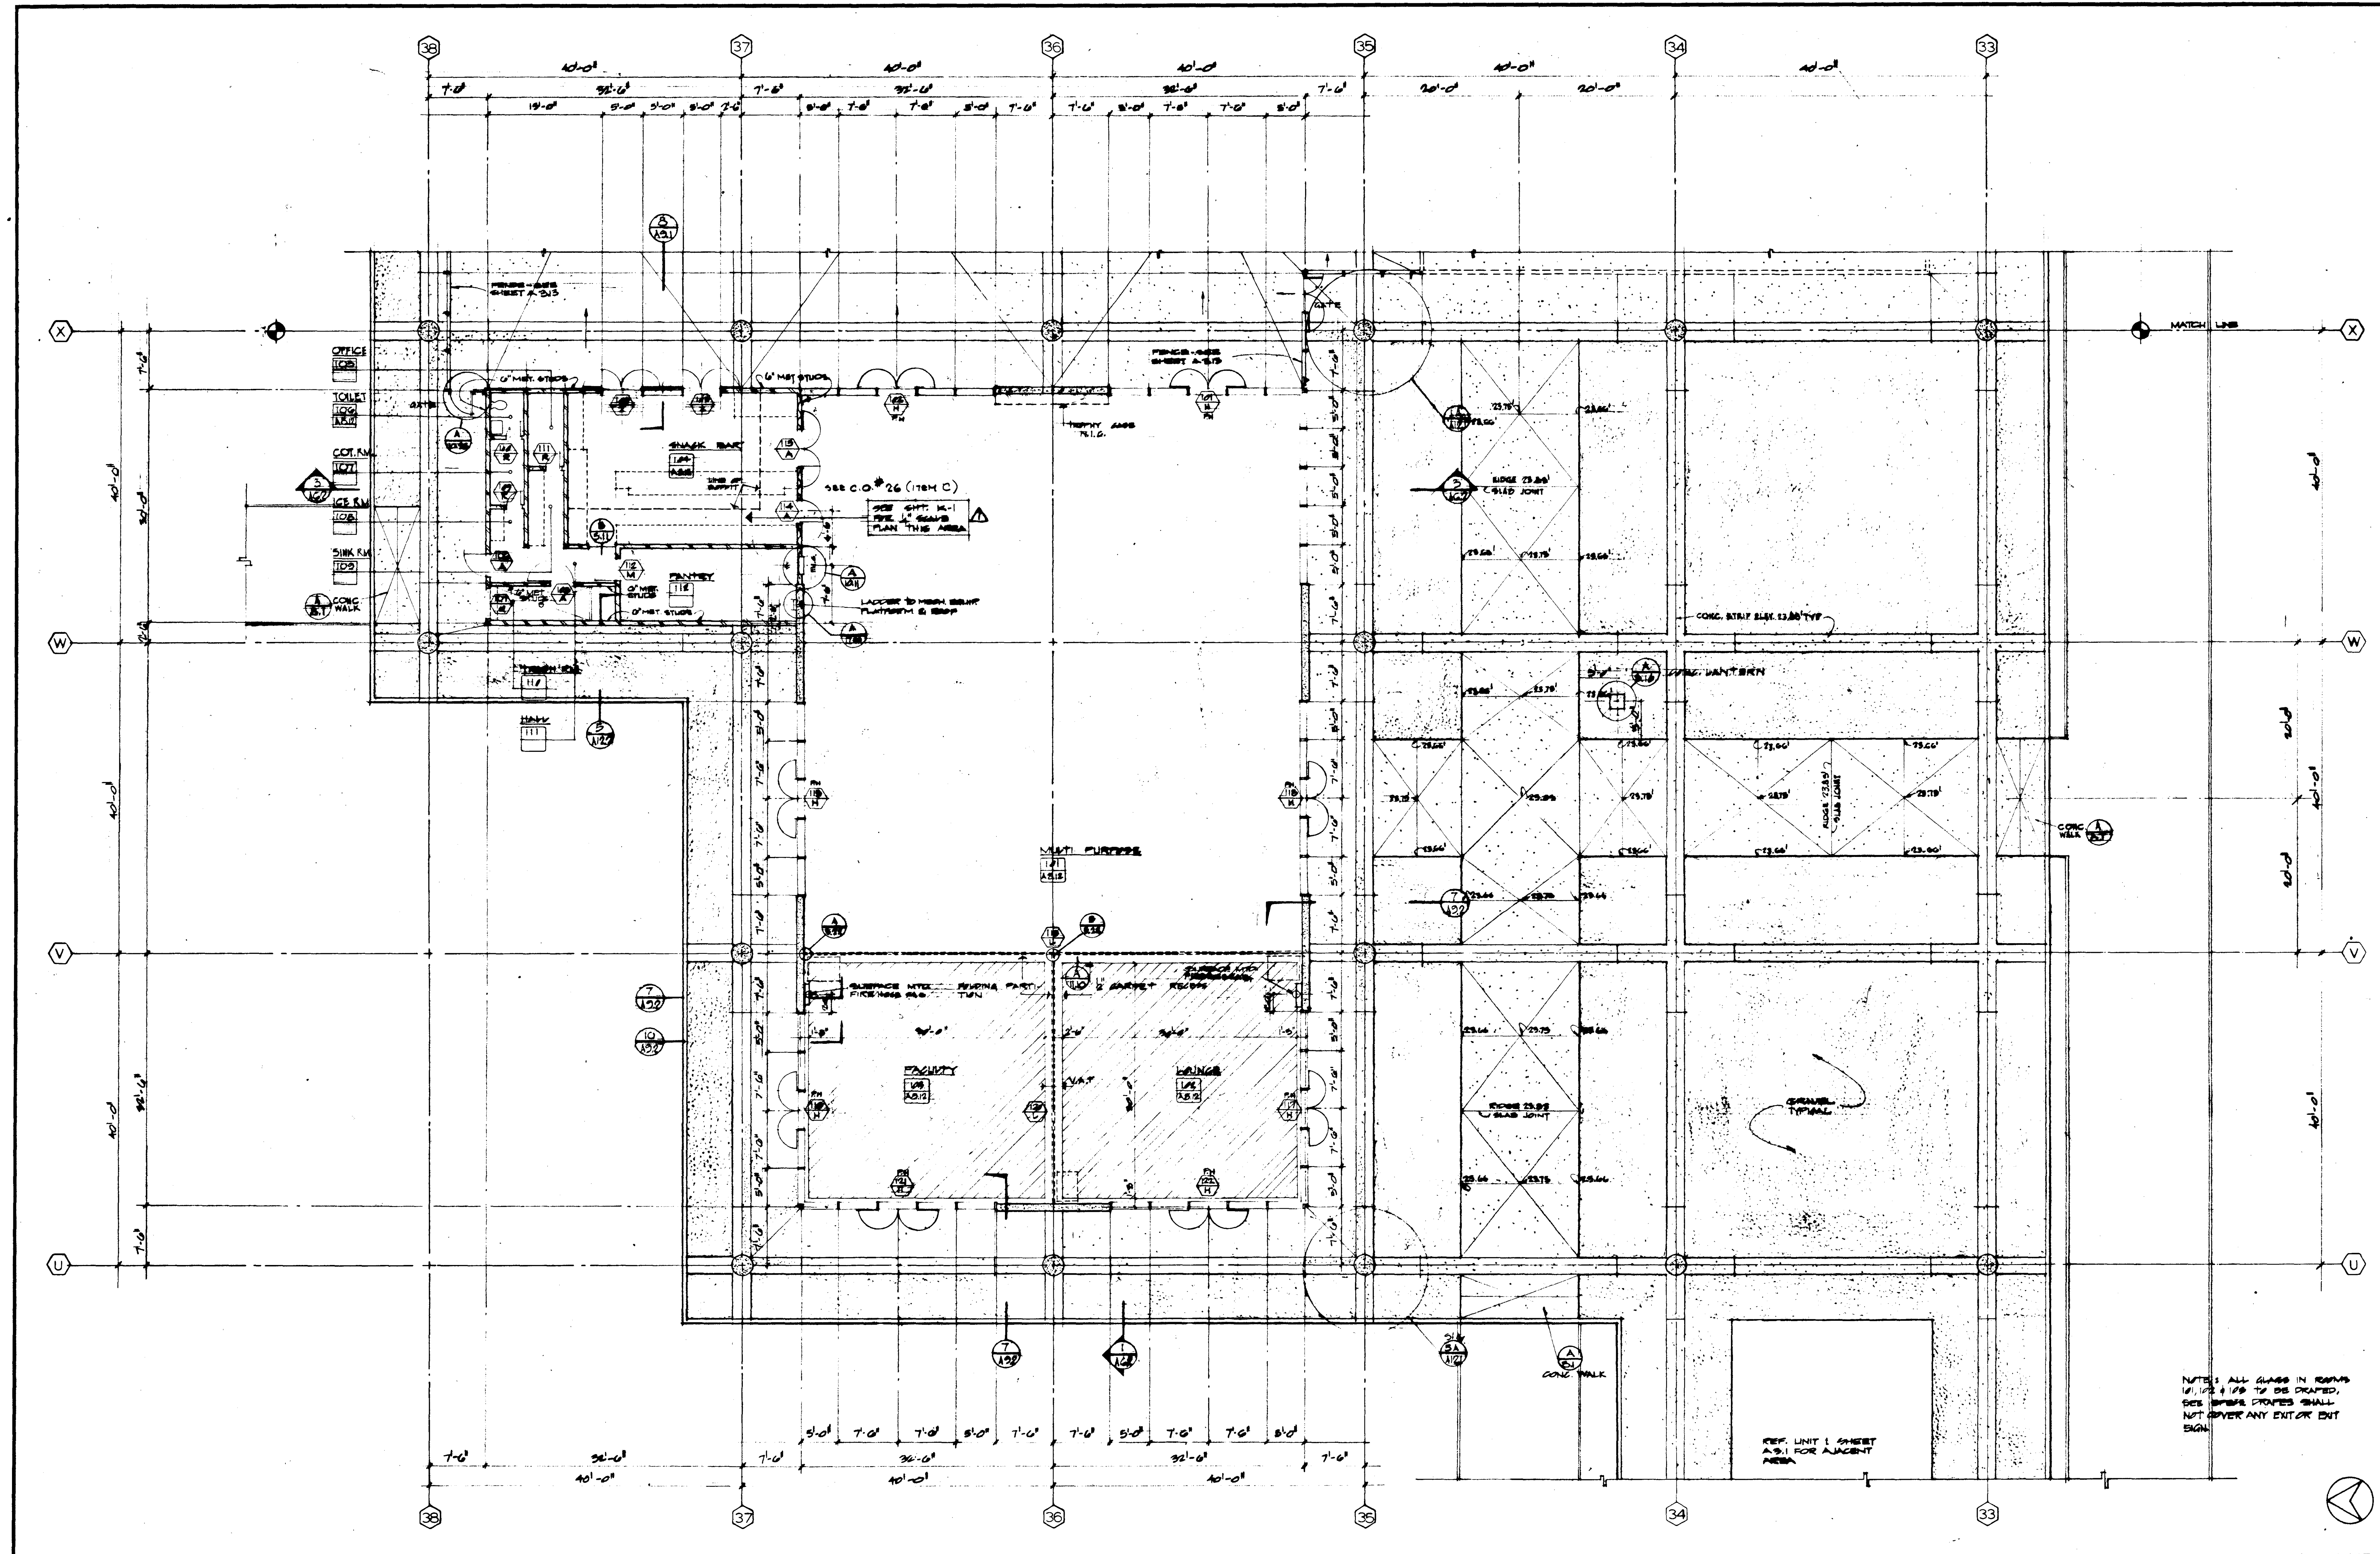AIR COMPRESSOR
BLDG. 70477

UNIT 10 FIRST FLOOR

UNIT 11 FIRST FLOOR

REVISIONS	DATE	BY	REVISION
1			
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9			
10			


STRUCTURAL ENGINEERS	DESIGNED	ARCHITECT
BRADY & JOHNSON J.A. MARTIN & ASSOCIATES	JUL. RJ	WILLIAM L. PEREIRA
MECHANICAL ENGINEERS	DRAWN BY	ENGINEER
RALPH E. PHILLIPS, INC.	F.I.	
ELECTRICAL ENGINEERS	CHECKED BY	COLLEGE
RALPH E. PHILLIPS, INC.	SM	
CIVIL ENGINEERS		
G. SHURMAN & ASSOCIATES MOFFATT & NICHOL		

APPROVED	25874	APPROVED JUN 21 1965
STATE FIRE MARSHAL		
STATE OF CALIFORNIA		
DATE JUN 21 1965		

ASSOCIATED ARCHITECTS:
WILLIAM L. PEREIRA & ASSOCIATES
A. QUINCY JONES-FREDERICK E. EMMONS & ASSOCIATES
BLUNCK ELLERBROCK & ASSOCIATES
URBANUS SQUARE • MACARTHUR BOULEVARD AT FORD ROAD
TELEPHONE 714/675-2640 • CORONA DEL MAR, CALIFORNIA


GOLDEN WEST COLLEGE
HUNTINGTON BEACH, CALIFORNIA
ORANGE COAST JUNIOR COLLEGE DISTRICT

UNIT 10 - 11	JOB NO. 10-1
FLOOR PLANS	DATE JUN 1965
	SHEET NO. A 315

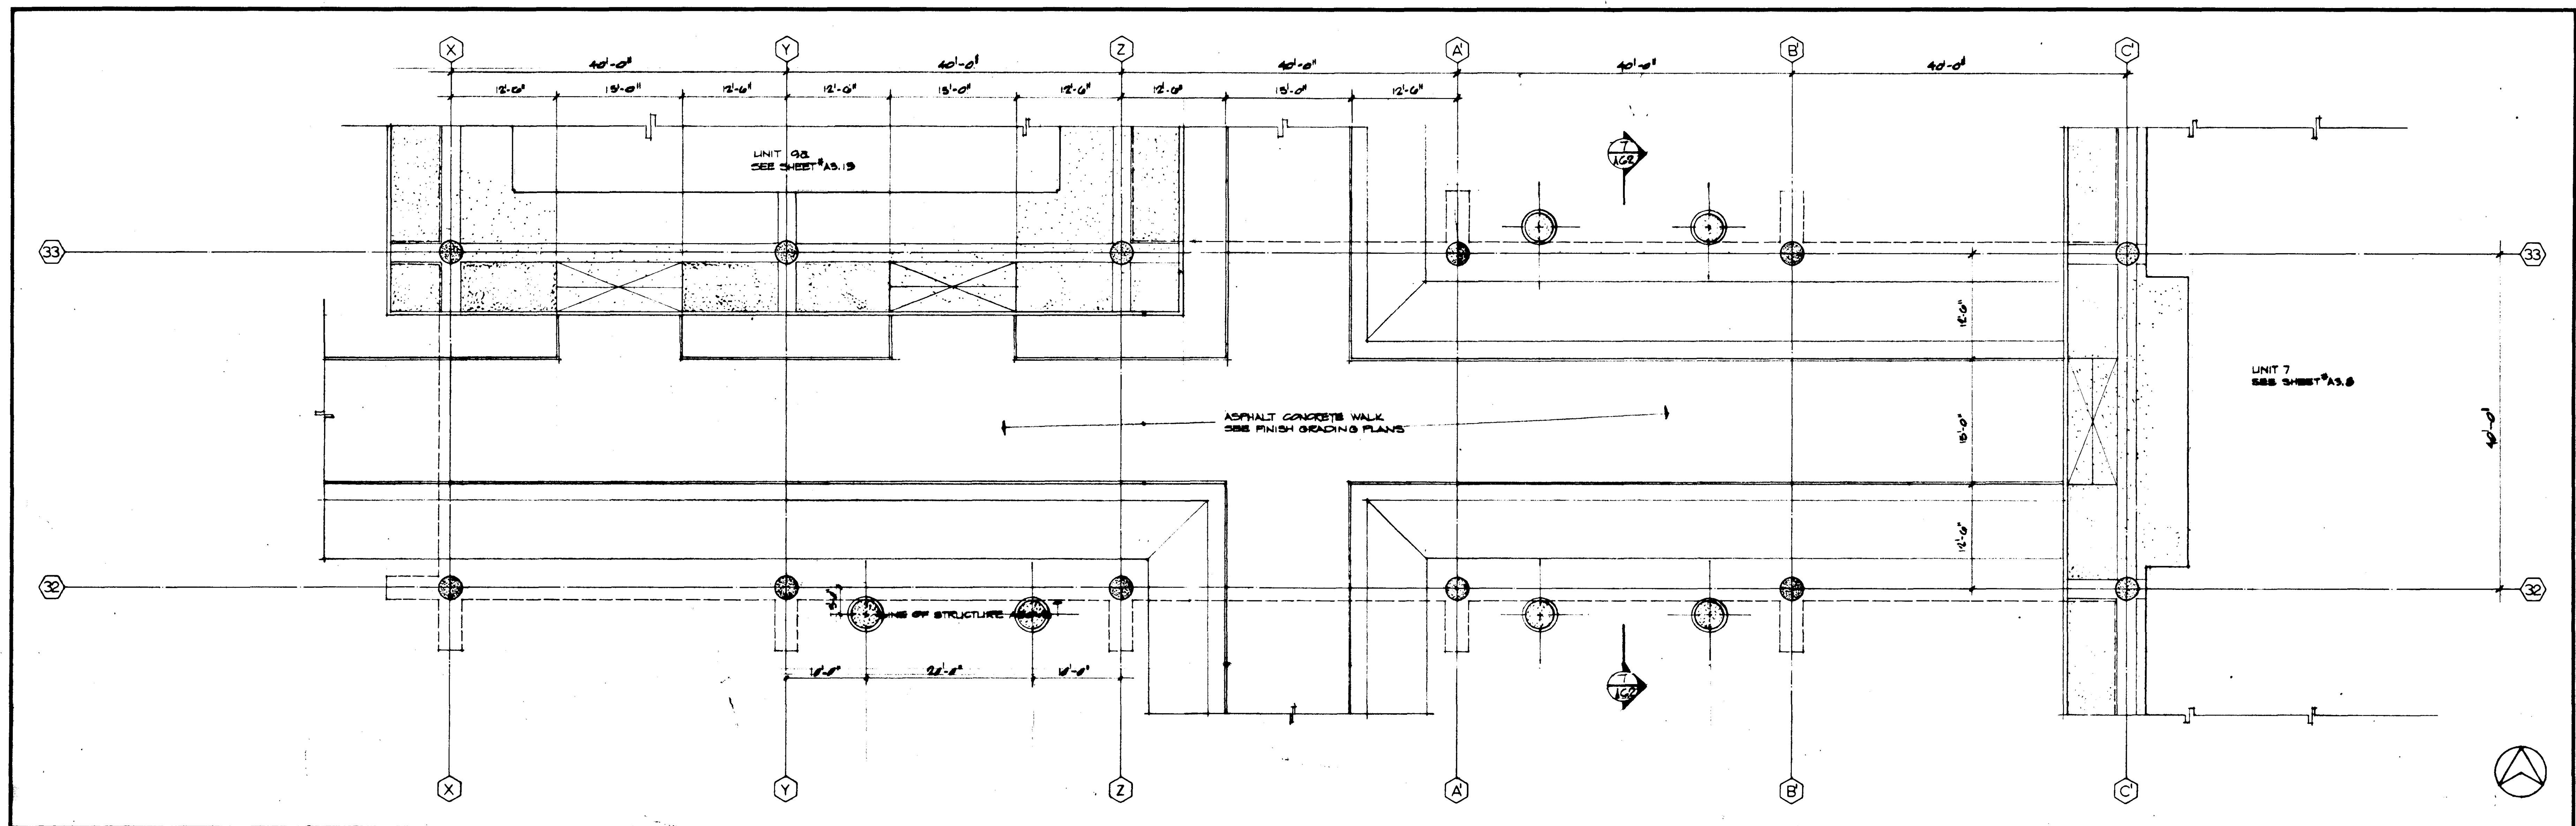

UNIT 13 FIRST FLOOR


SCALE 1/8" = 1'-0"

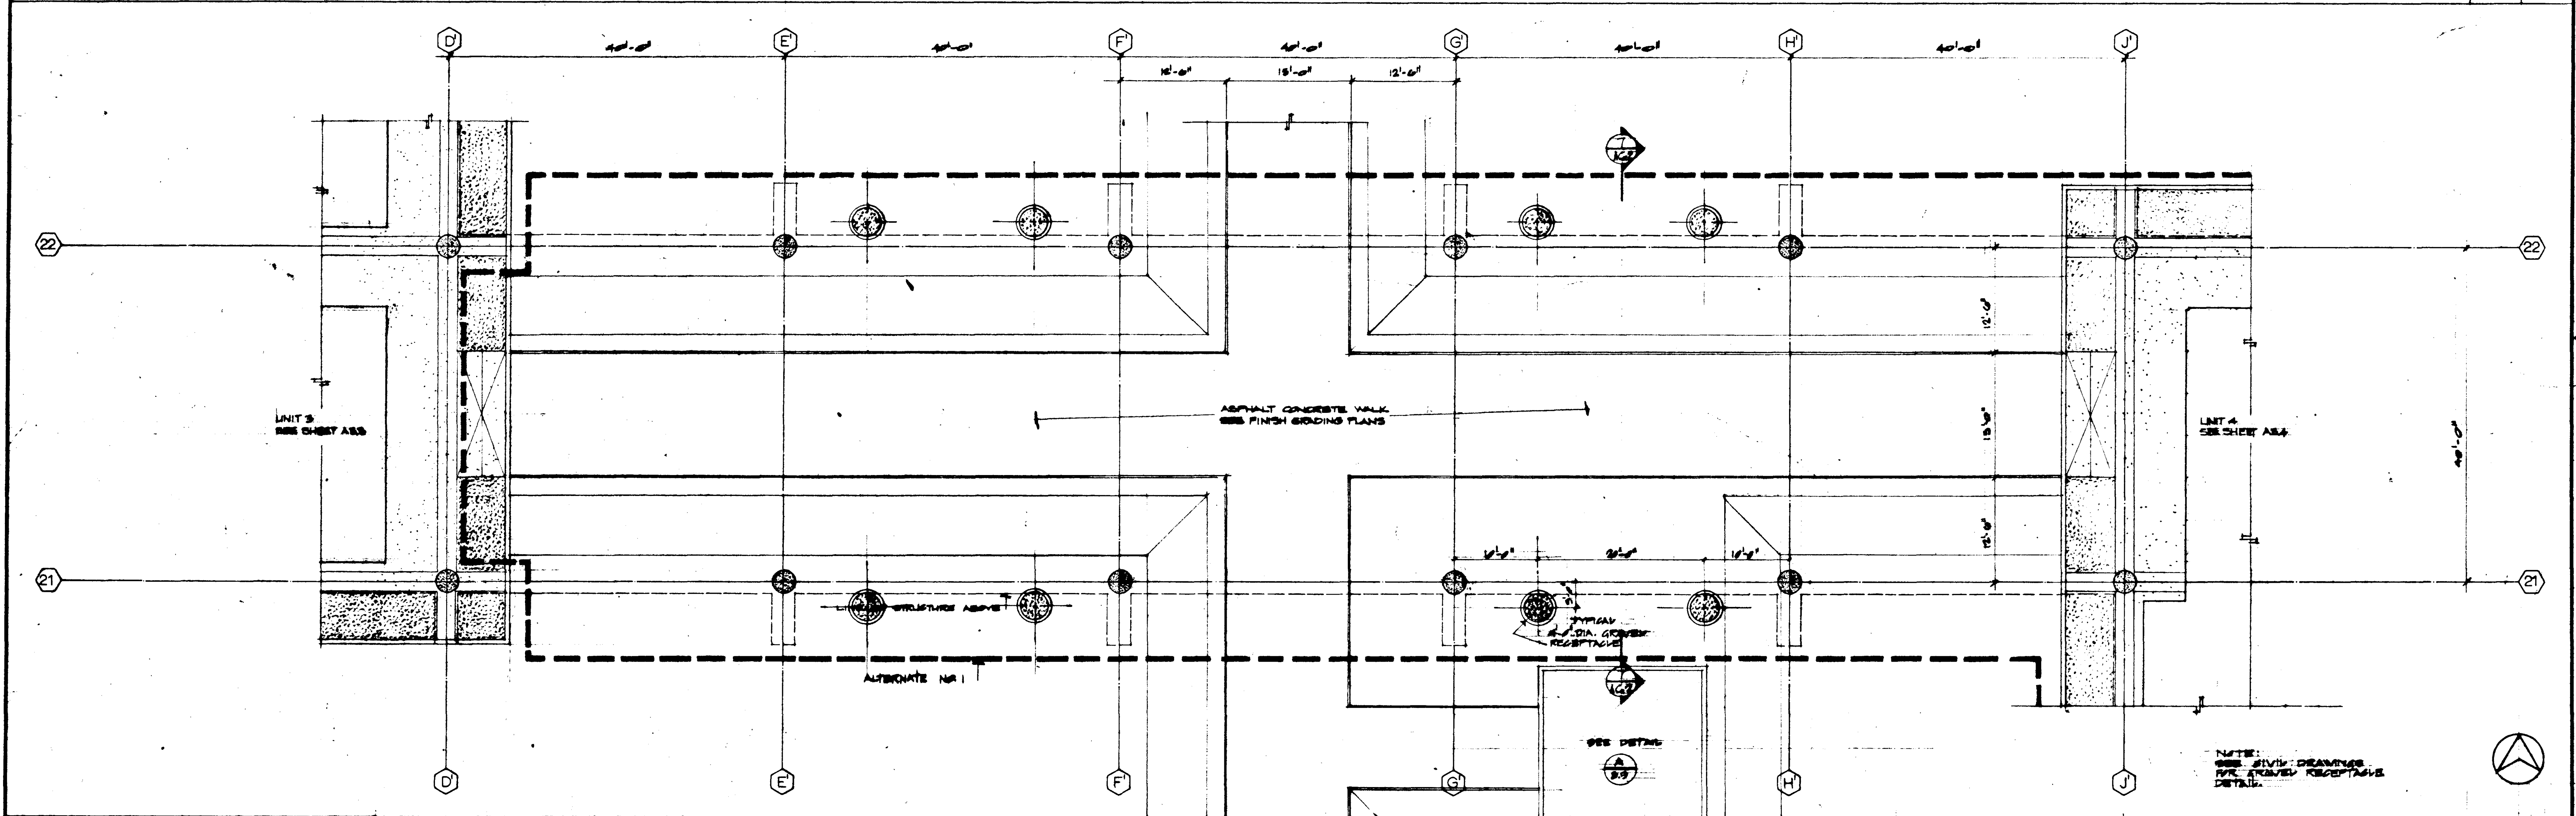

UNIT 12 FIRST FLOOR


SCALE 1/8" = 1'-0"

<p>REVISIONS</p>	<p>STRUCTURAL ENGINEERS BRANDOW & JOHNSON 1001 W. 10TH ST. LOS ANGELES, CALIF. 90057</p> <p>MECHANICAL ENGINEERS RALPH E. PHILLIPS, INC. 1001 W. 10TH ST. LOS ANGELES, CALIF. 90057</p> <p>ELECTRICAL ENGINEERS RALPH E. PHILLIPS, INC. 1001 W. 10TH ST. LOS ANGELES, CALIF. 90057</p> <p>CIVIL ENGINEERS G. SHUTEMAN & ASSOCIATES MOFFATT & NICHOLS</p>	<p>DESIGNED J.M. Z.J.</p> <p>DRAWN BY M.M.</p> <p>CHECKED BY M.M.</p>	<p>APPROVED STATE FIRE MARSHAL STATE OF CALIFORNIA DATE JUN 15 1965</p> <p>25874 APPROVED JUN 21 1965</p>	<p>ASSOCIATED ARCHITECTS: WILLIAM L. PEREIRA & ASSOCIATES A. QUINCY JONES-FREDERICK E. EMMONS & ASSOCIATES BLUROCK ELLERBROCK & ASSOCIATES</p> <p>URBANUS SQUARE • MACARTHUR BOULEVARD AT FORD ROAD TELEPHONE 714/675-2640 • CORONA DEL MAR, CALIFORNIA</p>	<p>GOLDEN WEST COLLEGE HUNTINGTON BEACH, CALIFORNIA ORANGE COAST JUNIOR COLLEGE DISTRICT</p>	<p>UNIT 12 & 13 FLOOR PLANS</p> <p>DATE 15 JUN 1965</p> <p>SHEET NO. A 310</p>
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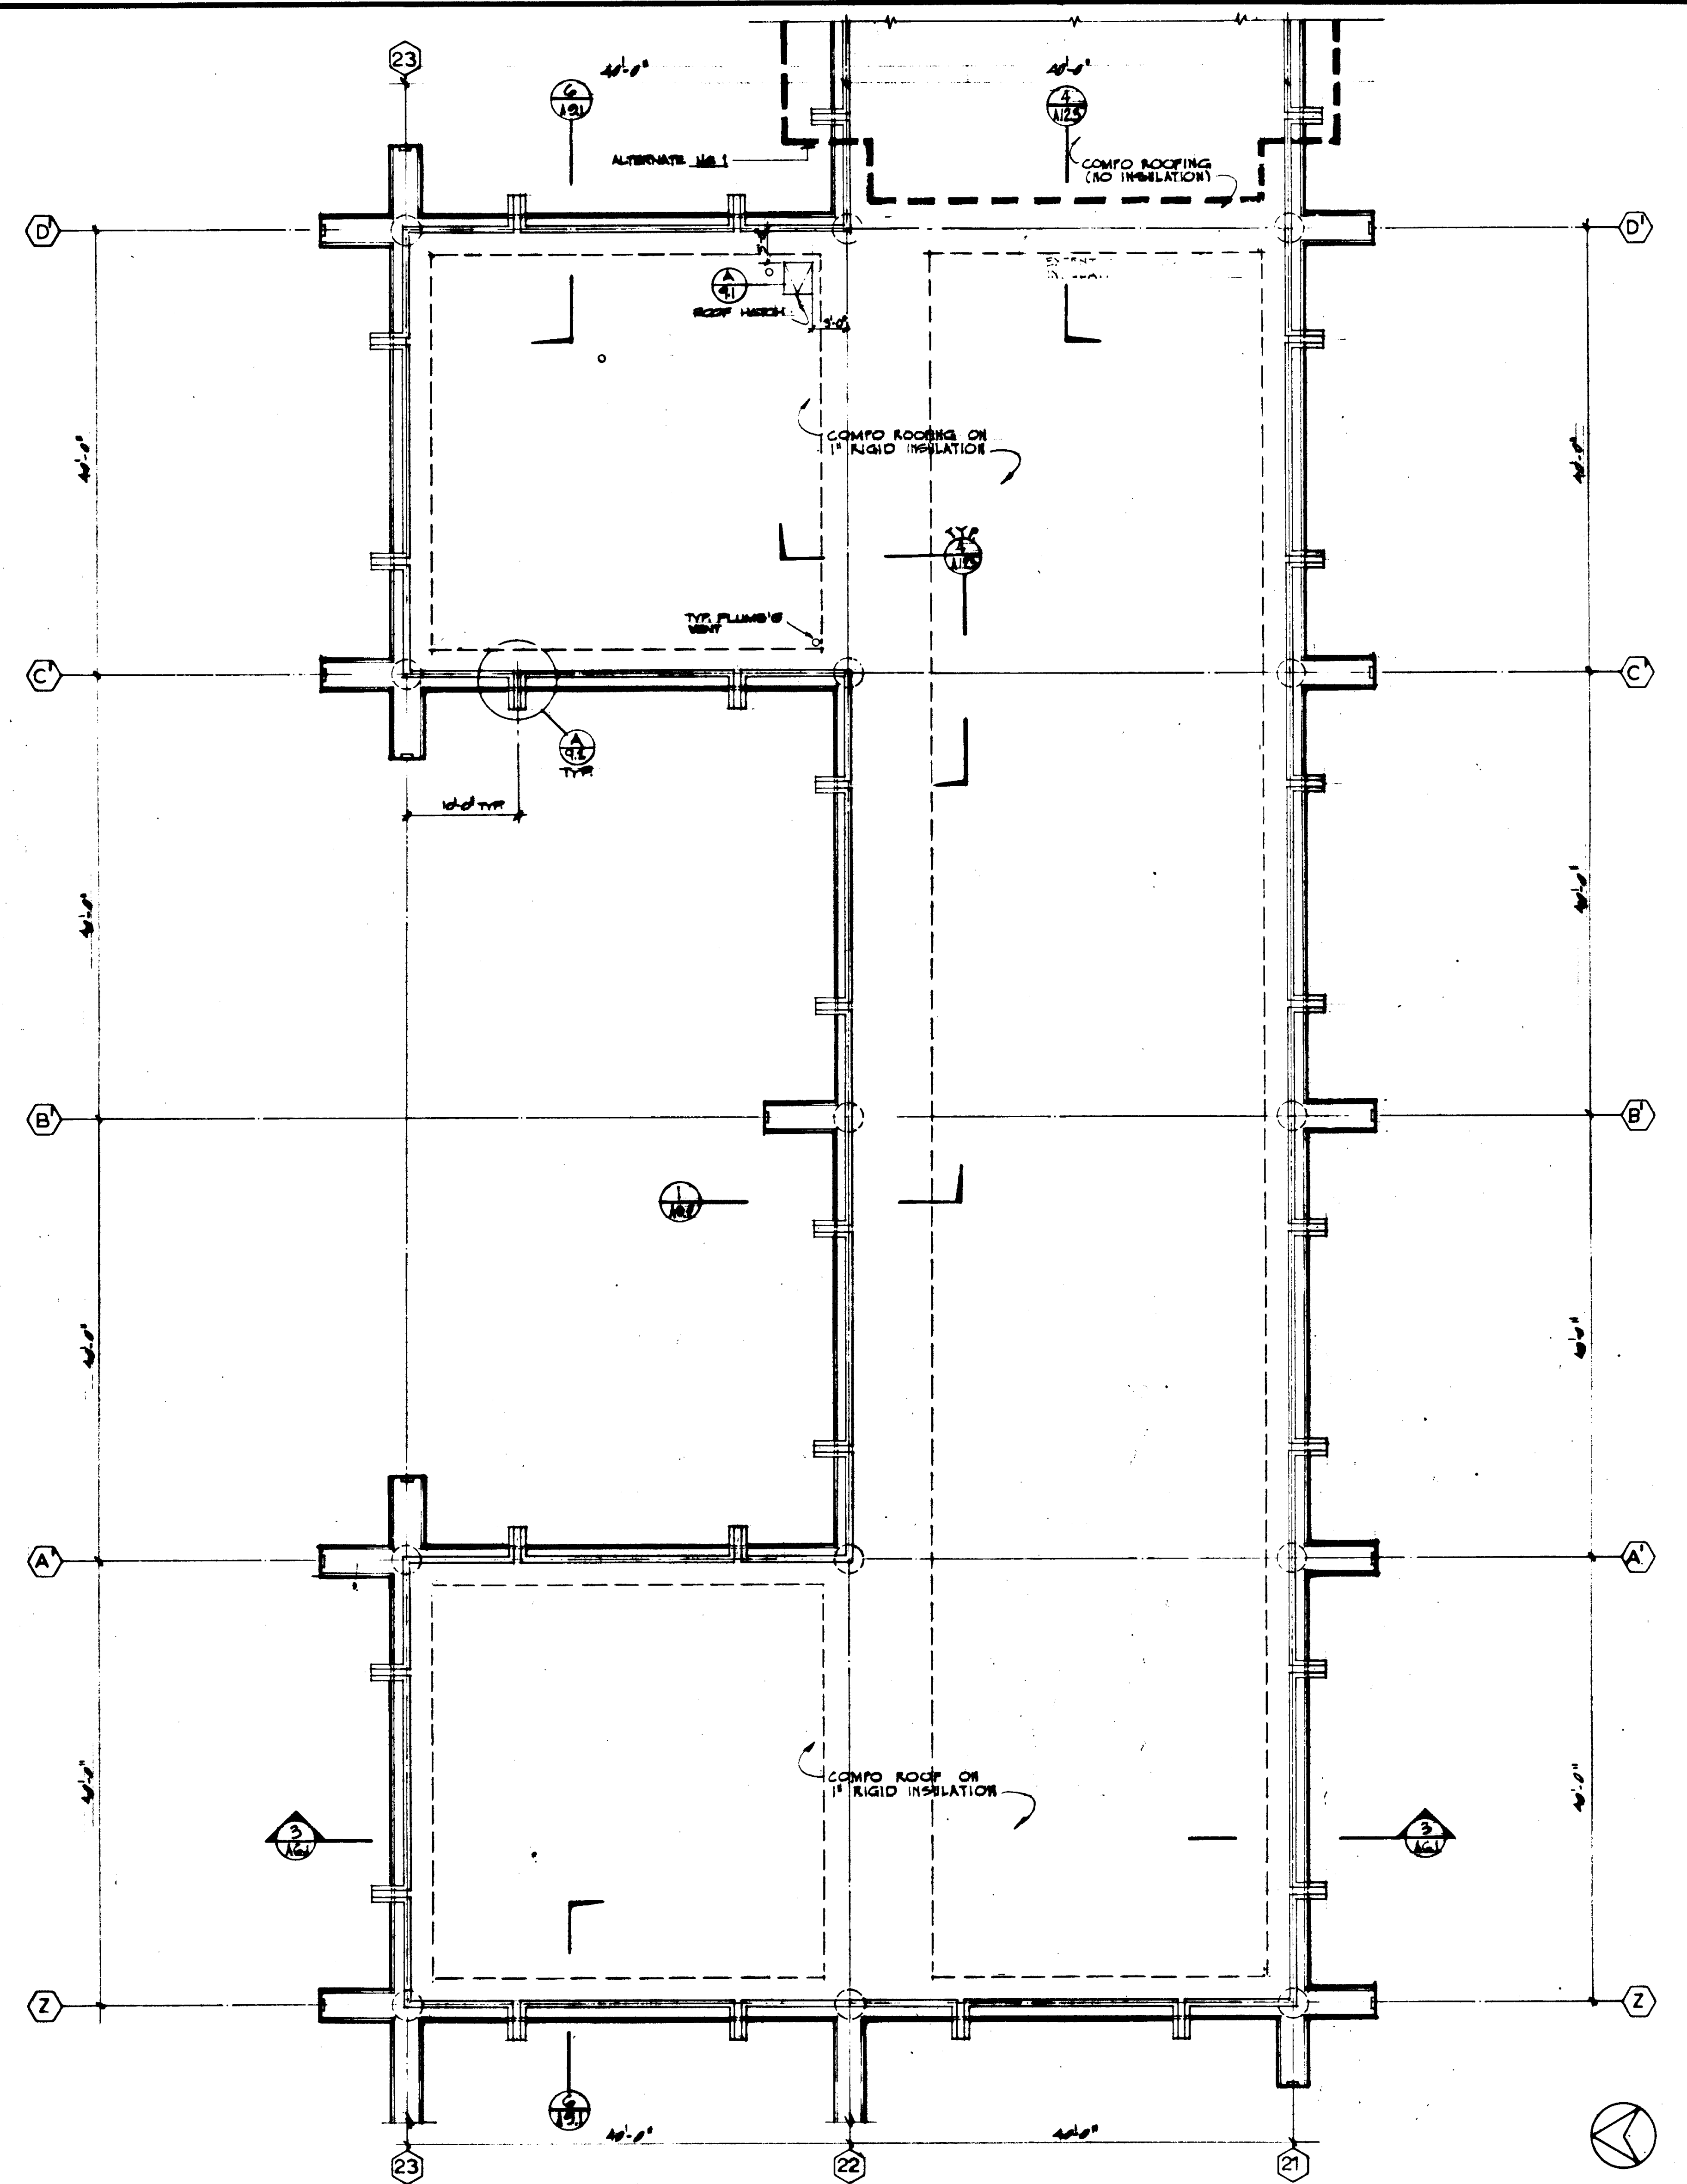

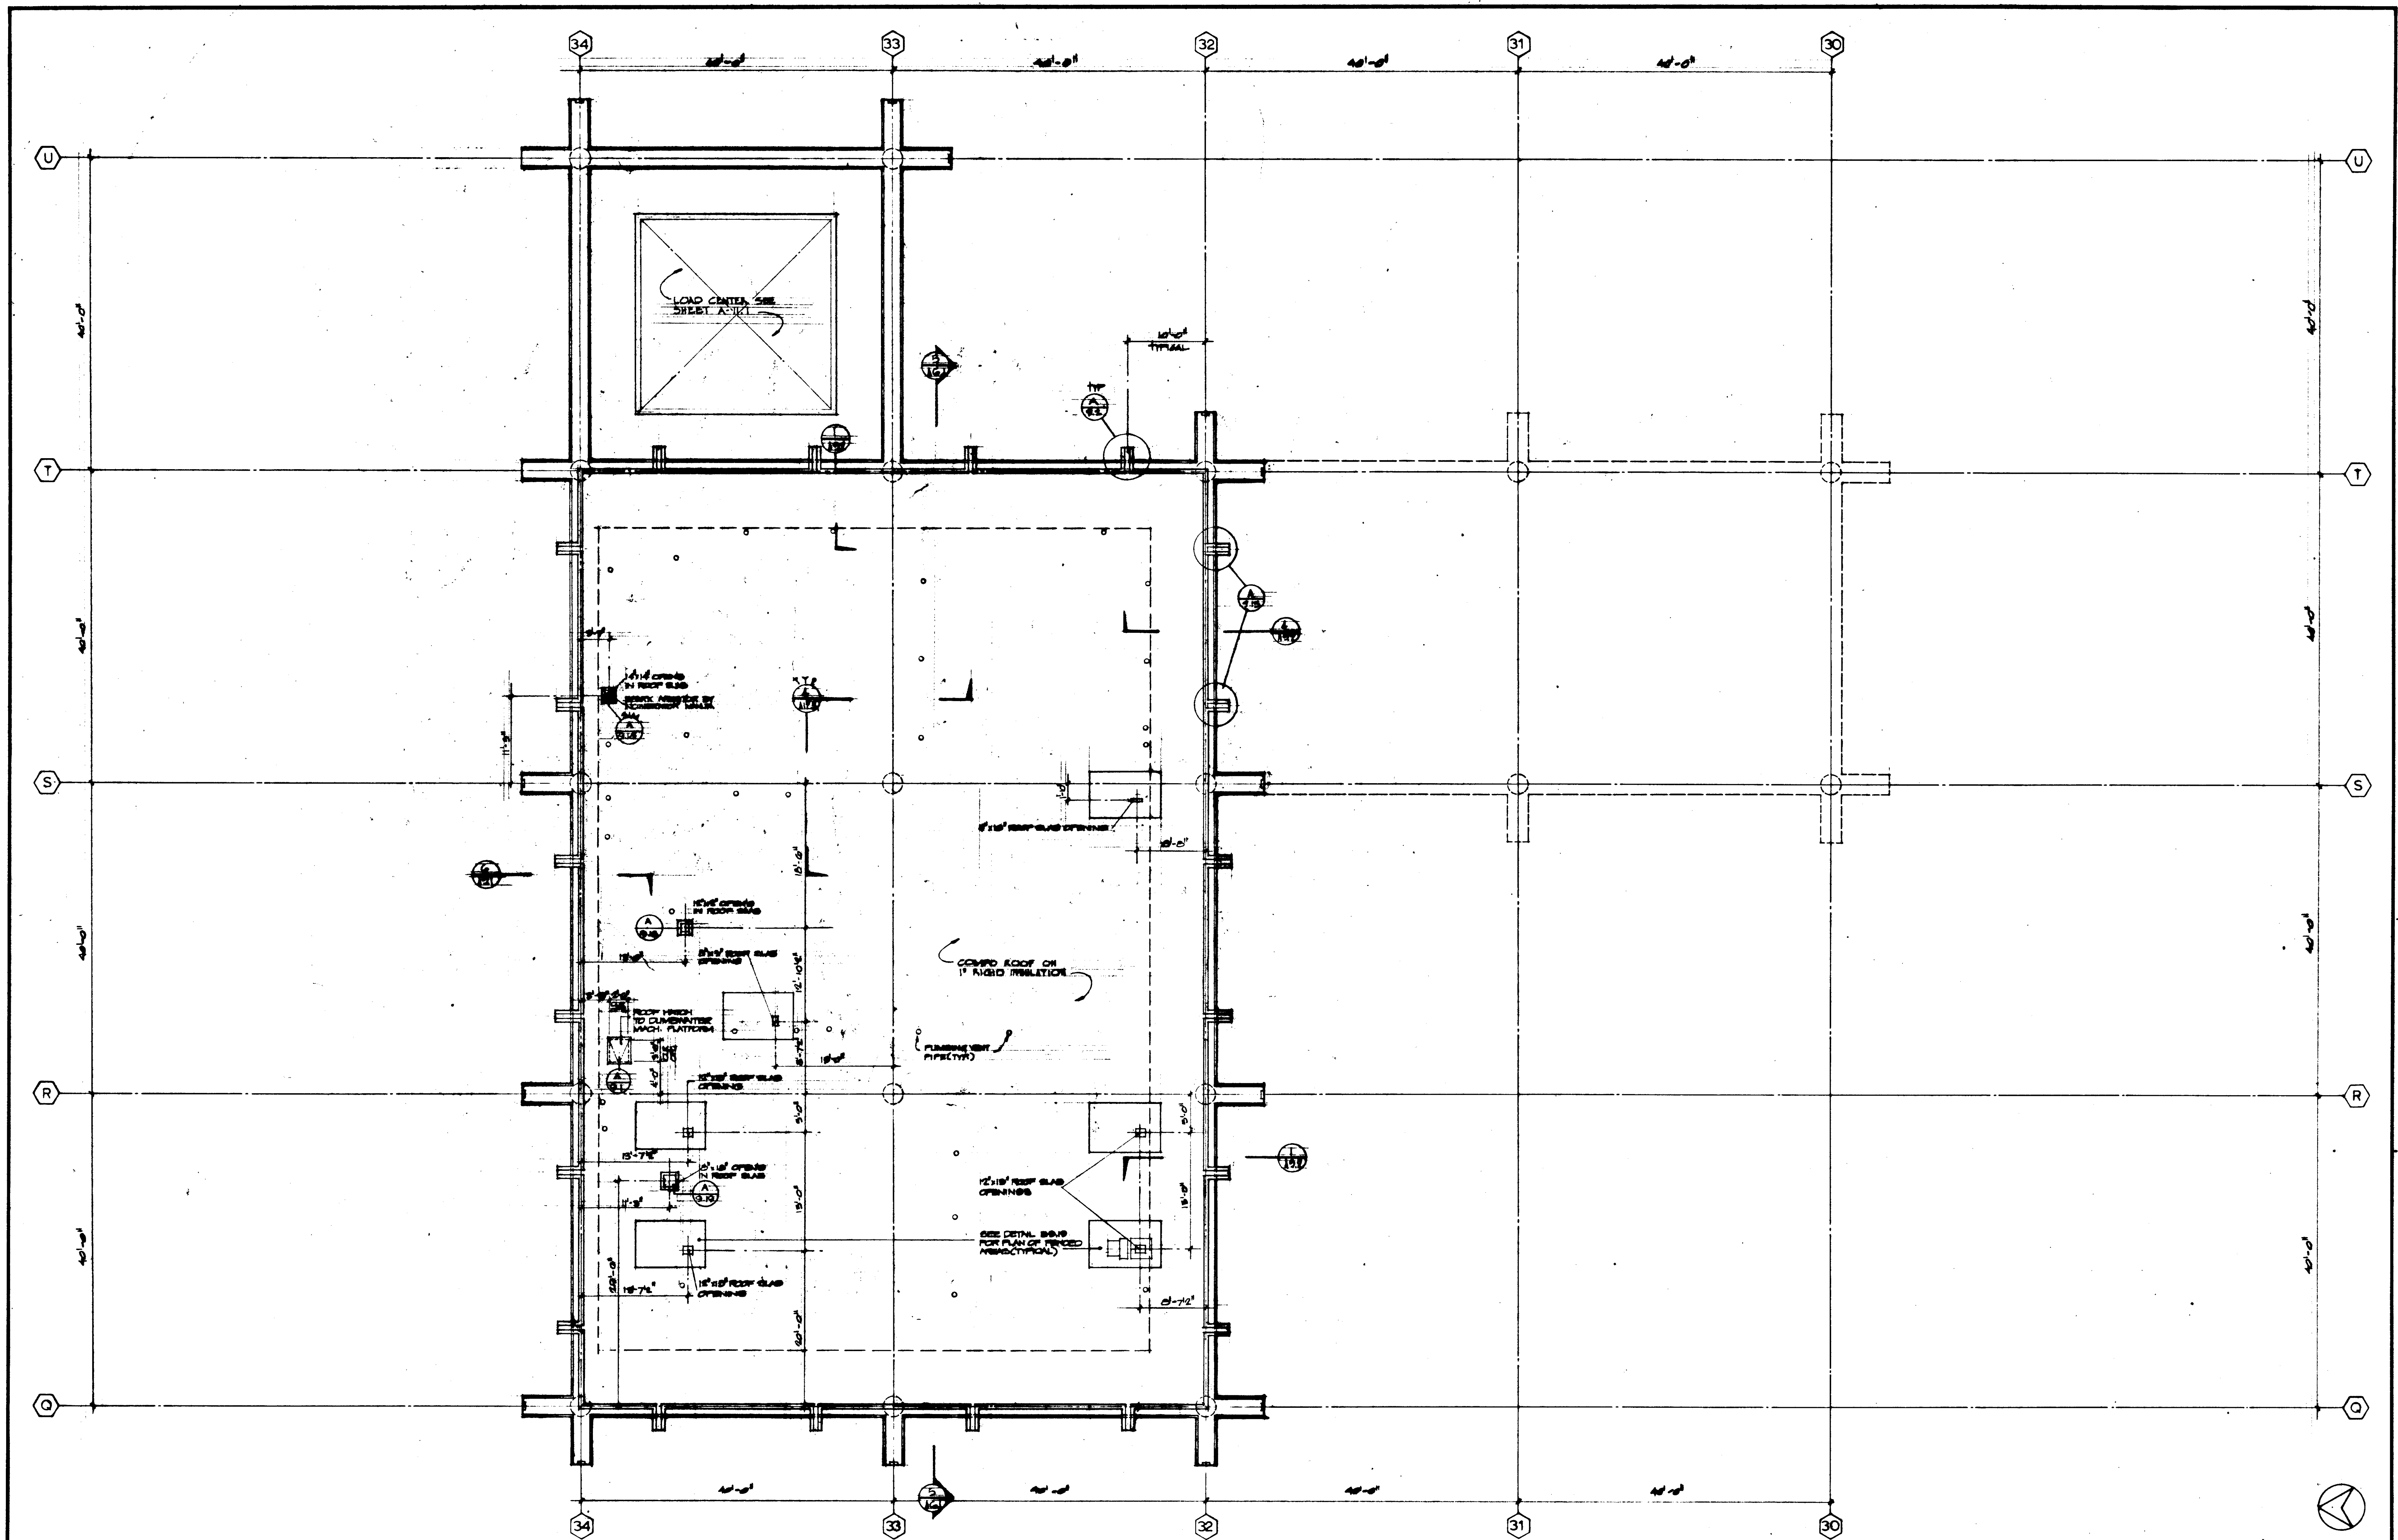
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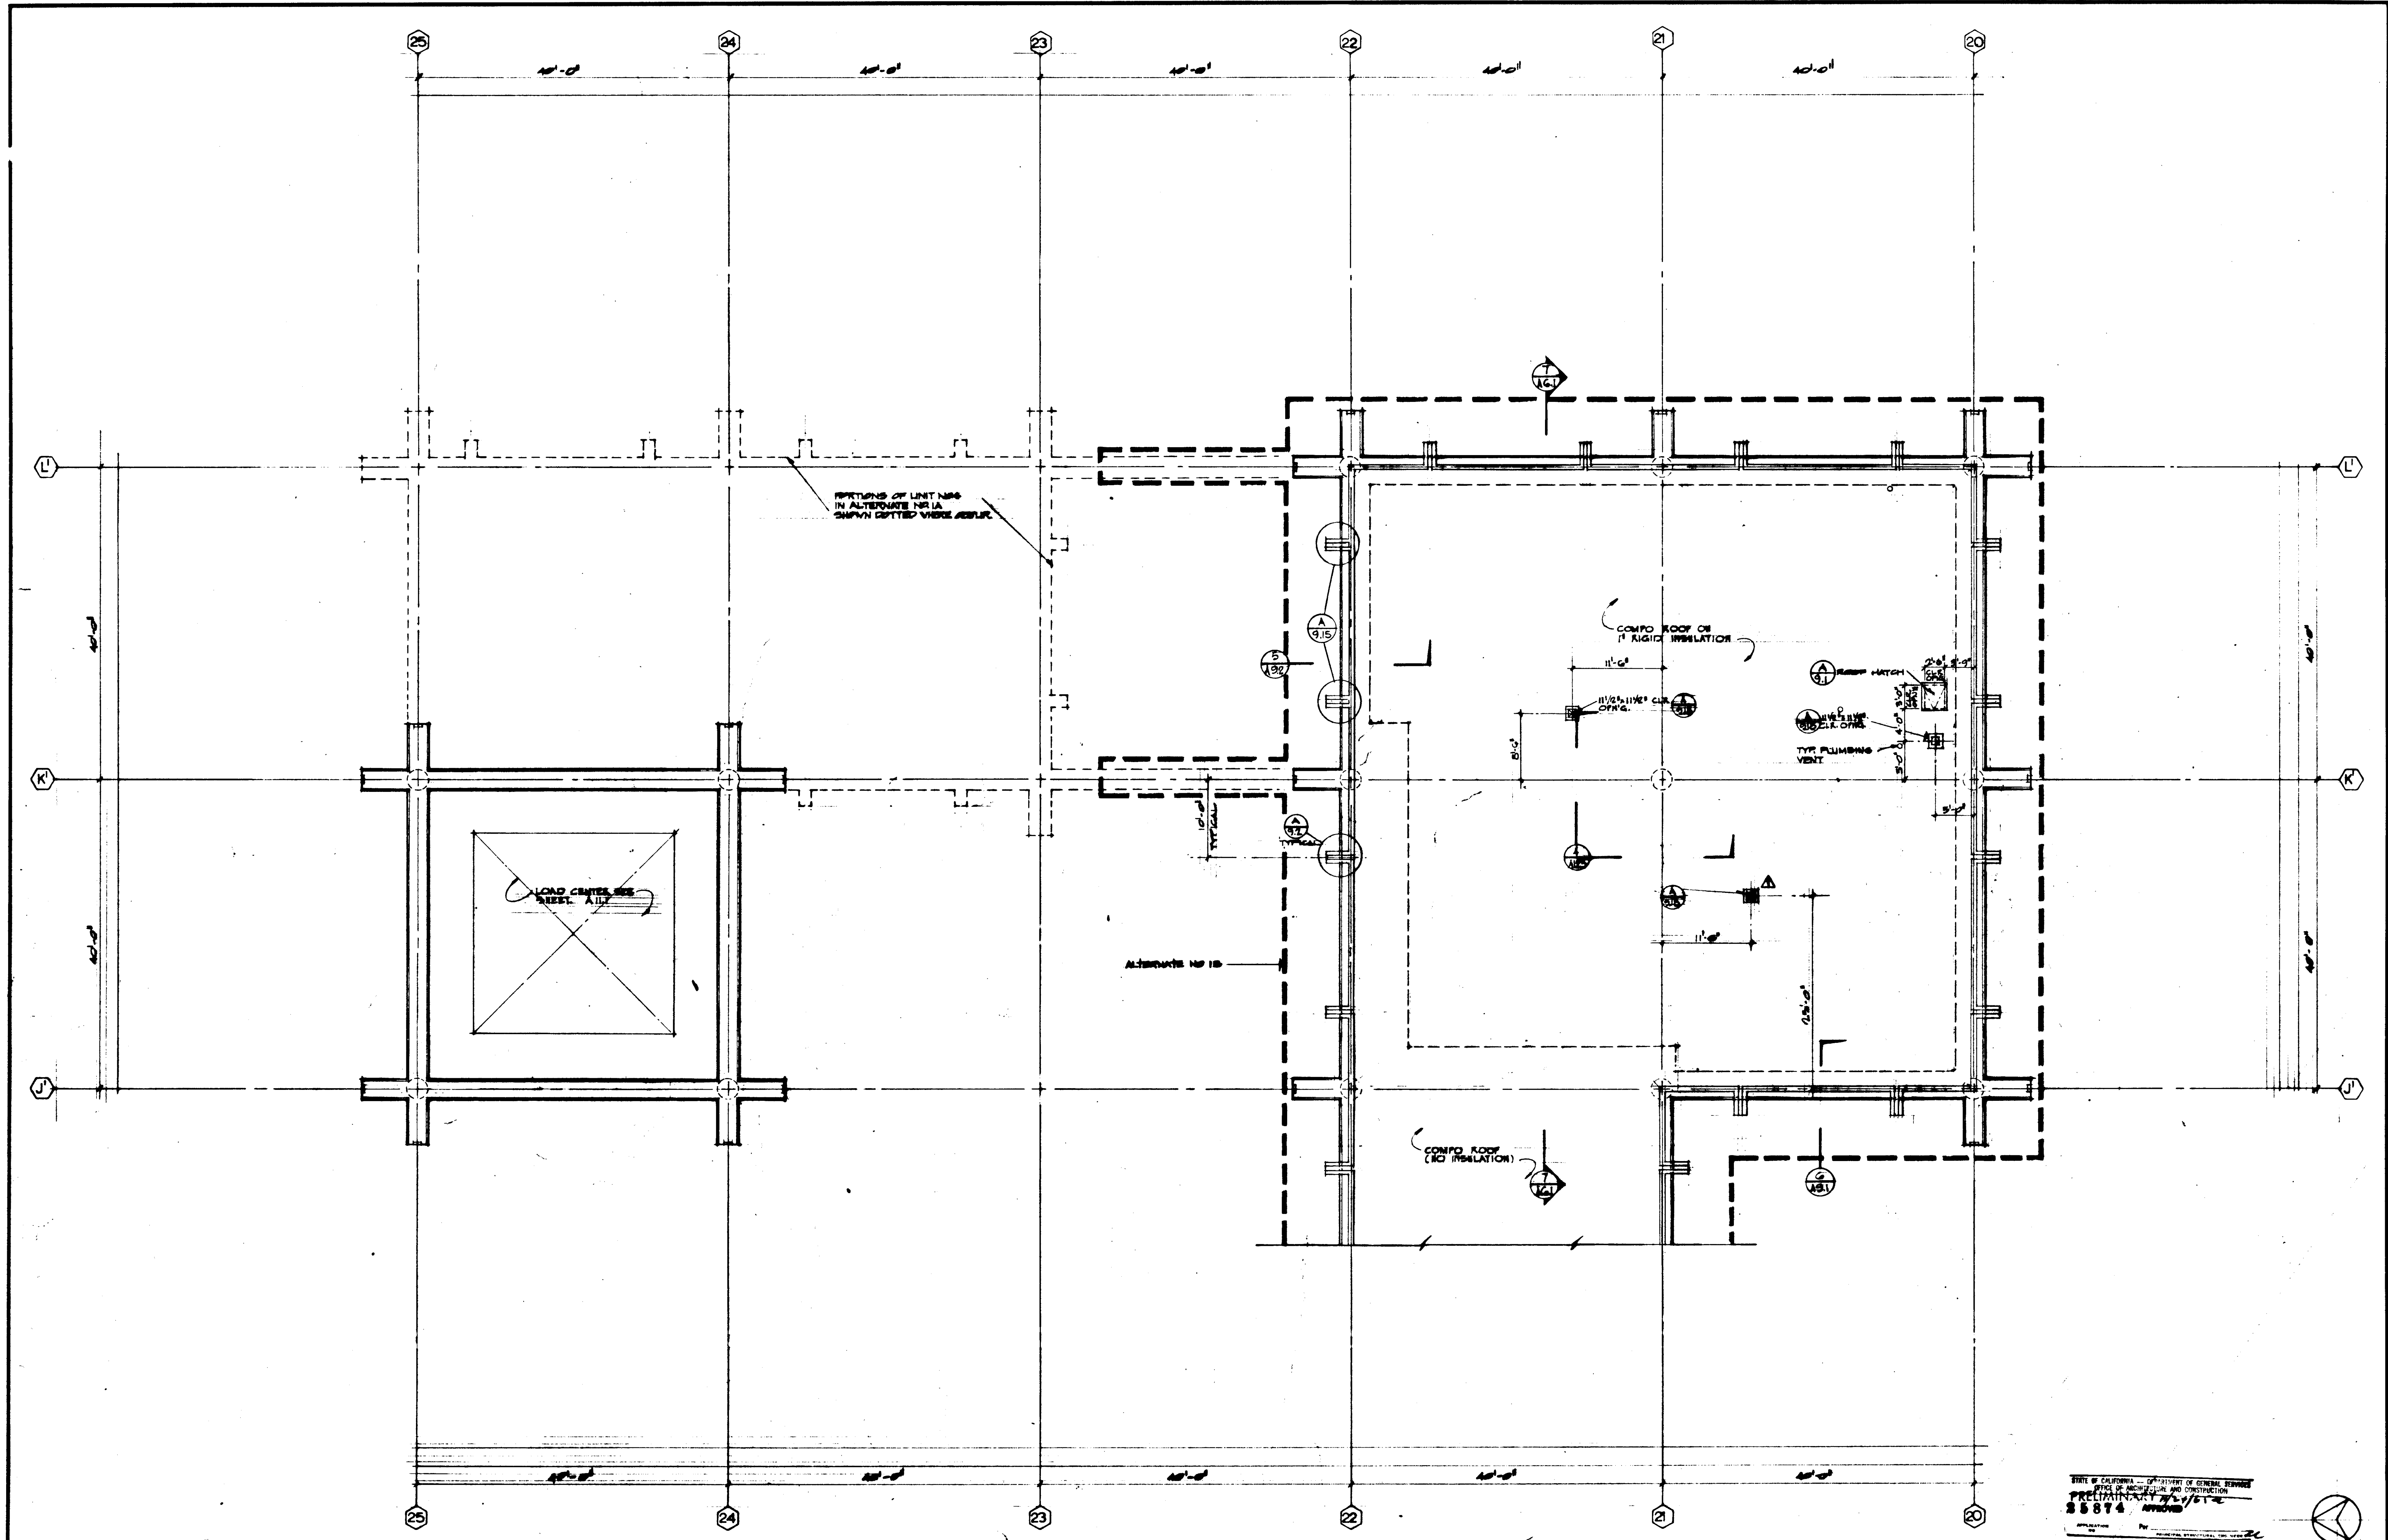


UNIT 2 ROOF PLAN

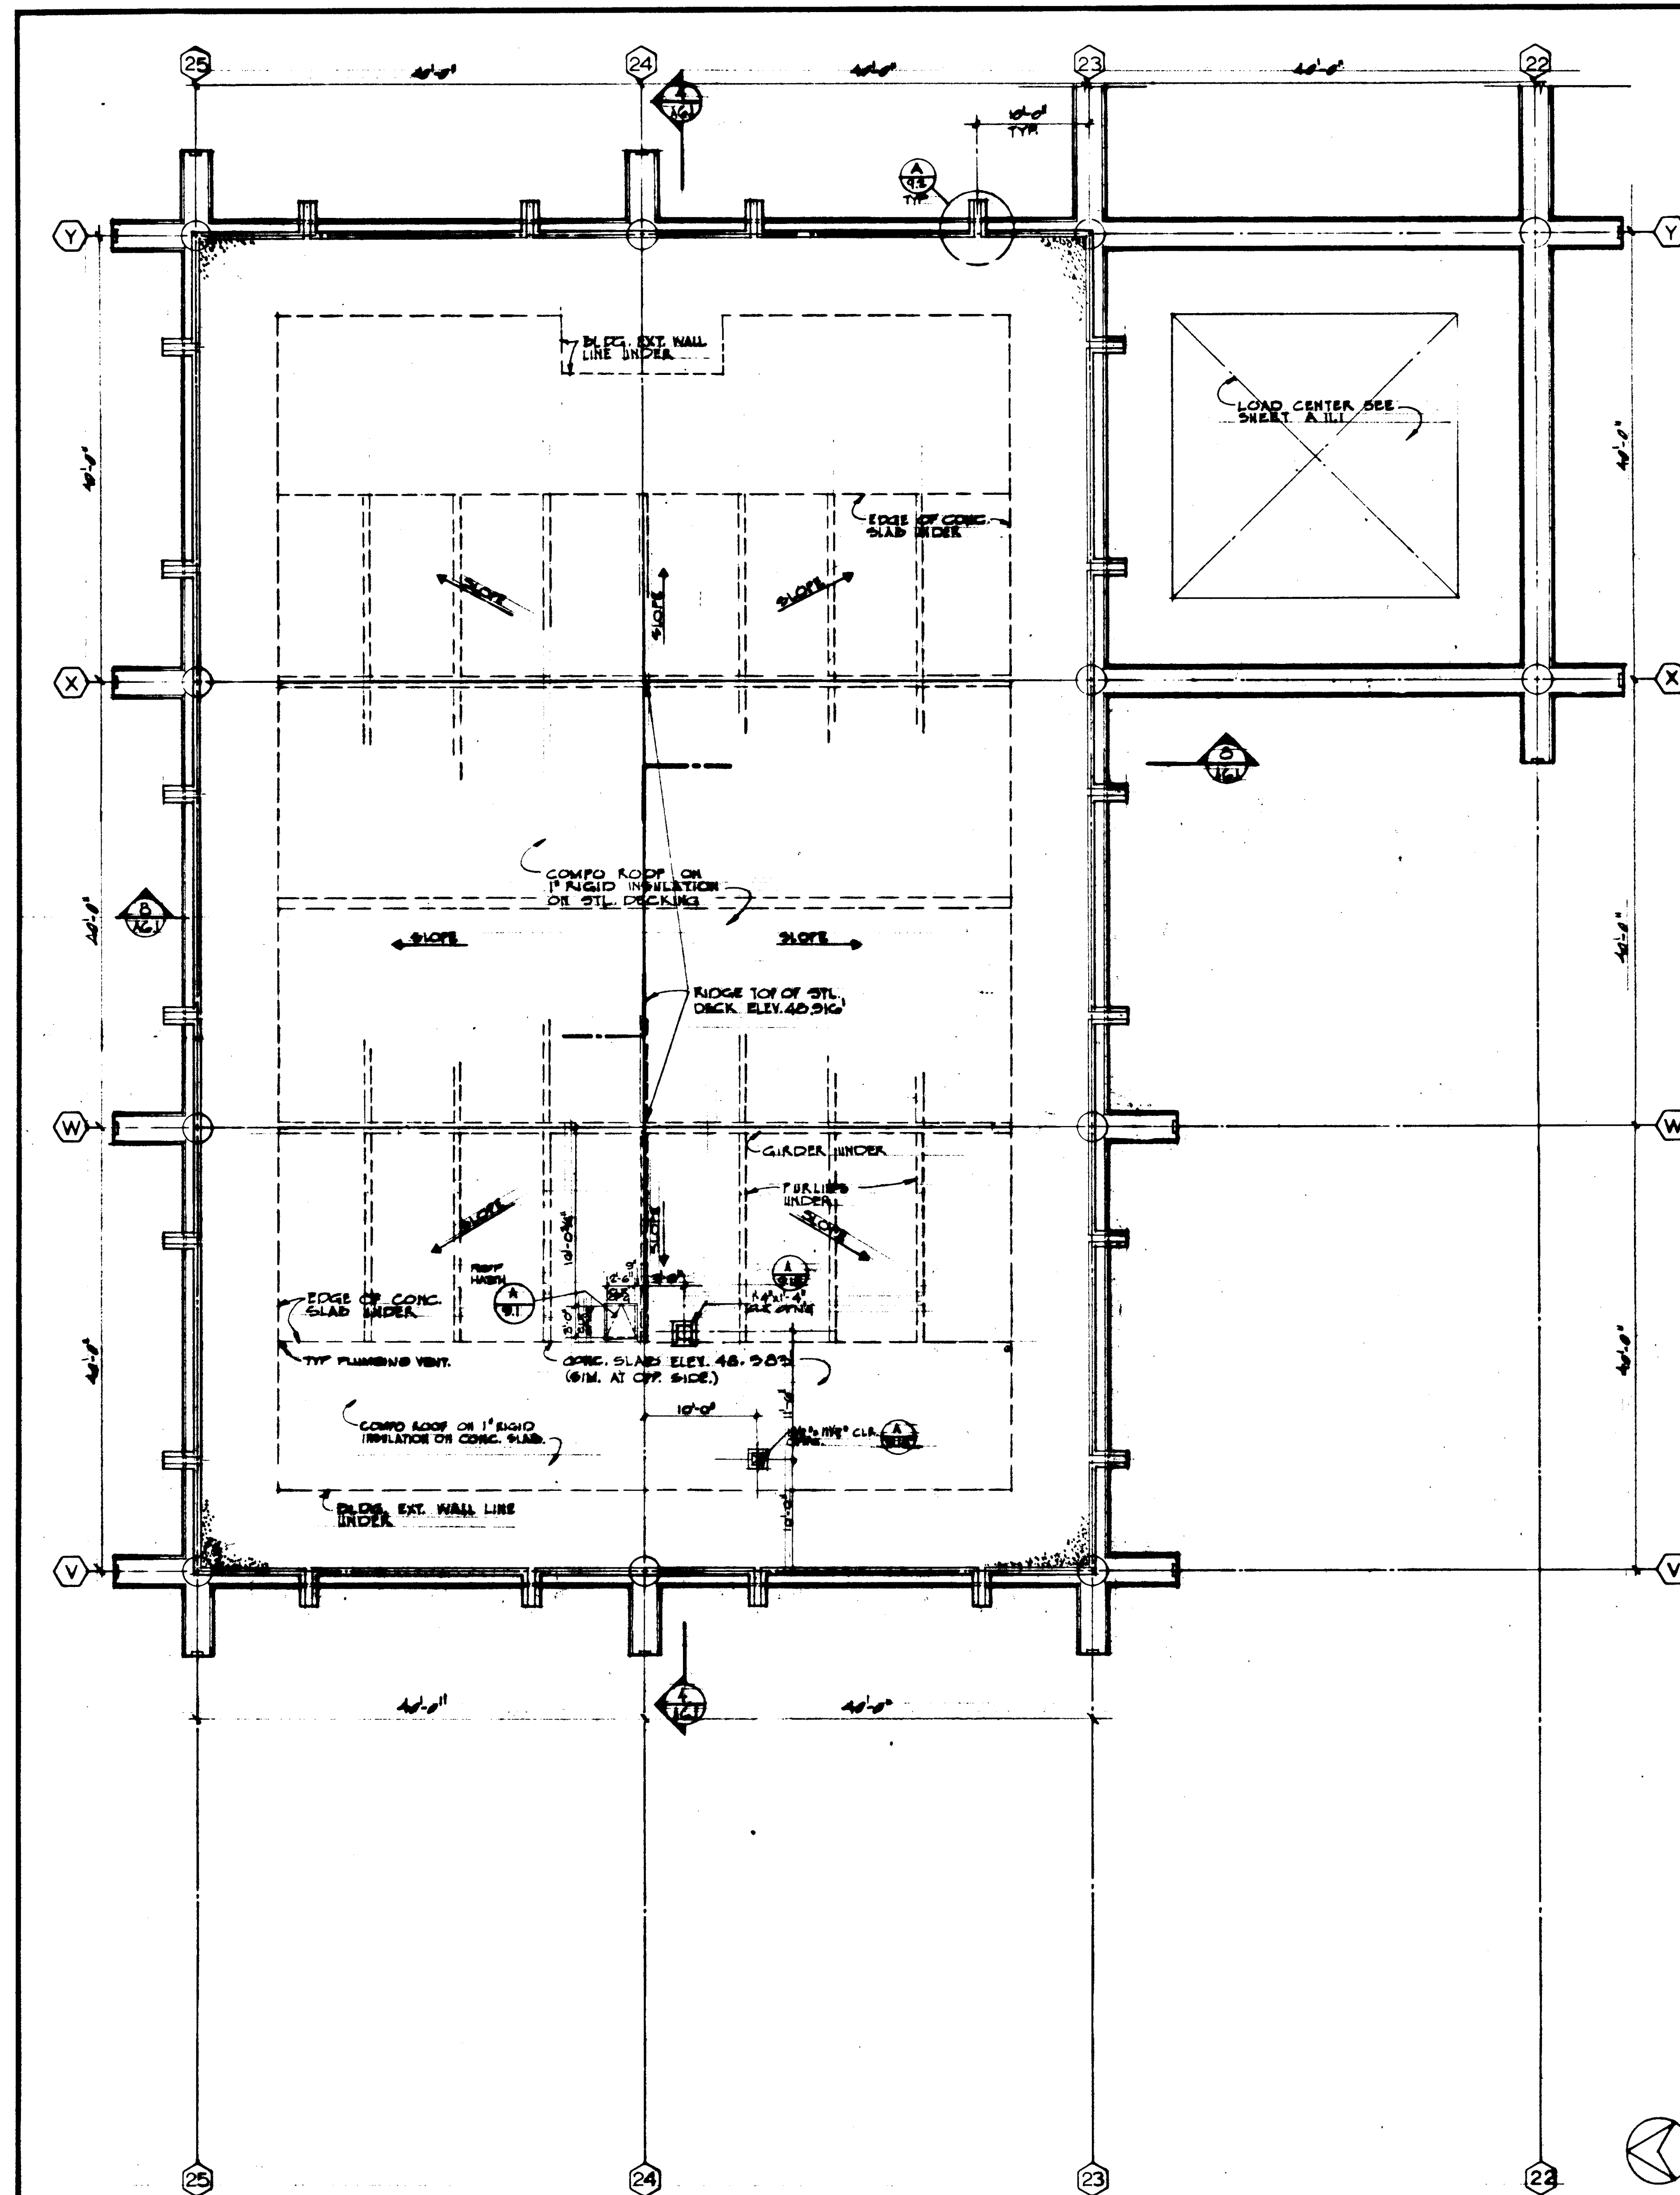

UNIT 3 ROOF PLAN



STRUCTURAL ENGINEERS BEANDOW & JOHNSTON 11111 1/2 STREET HUNTINGTON BEACH, CALIF. 92648		DESIGNED JHL-R-J 11/1/65		ARCHITECT WILLIAM L. PEREIRA & ASSOCIATES 11111 1/2 STREET HUNTINGTON BEACH, CALIF. 92648		APPROVED STATE FIRE MARSHAL STATE OF CALIFORNIA DATE JUN 21 1965 55874 APPROVED JUN 21 1965		ASSOCIATED ARCHITECTS: WILLIAM L. PEREIRA & ASSOCIATES A. QUINCY JONES-FREDERICK E. EMMONS & ASSOCIATES BLUROCK ELLERBROOK & ASSOCIATES URBANUS SQUARE • MACARTHUR BOULEVARD AT FORD ROAD TELEPHONE 714/675-2640 • CORONA DEL MAR, CALIFORNIA		GOLDEN WEST COLLEGE HUNTINGTON BEACH, CALIFORNIA ORANGE COAST JUNIOR COLLEGE DISTRICT		UNIT 2 - 3 ROOF PLANS		SCALE 1/8" = 1'-0" JOB NO. MD-1 DATE 15 JUN 1965 SHEET NO. A-12	
REVISIONS NO. DESCRIPTION 1.		MECHANICAL ENGINEERS RALPH E. PHILLIPS, INC. 11111 1/2 STREET HUNTINGTON BEACH, CALIF. 92648		DRAWN BY W. MAGALSKAS 11/1/65		CHECKED BY JHL 11/1/65		COLLEGE GOLDEN WEST COLLEGE HUNTINGTON BEACH, CALIF. 92648		CIVIL ENGINEERS G. SHURMAN & ASSOCIATES MOFFATT & MICROL 11111 1/2 STREET HUNTINGTON BEACH, CALIF. 92648					



STATE OF CALIFORNIA - DEPARTMENT OF GENERAL SERVICES
 OFFICE OF ARCHITECTURE AND CONSTRUCTION
 PRELIMINARY 55874


ROOF PLAN

STRUCTURAL ENGINEER BRANDON & JOHNSON I.A. MARTIN & ASSOCIATES MECHANICAL ENGINEER RALPH S. PHILLIPS, INC. ELECTRICAL ENGINEER RALPH S. PHILLIPS, INC. CIVIL ENGINEER G. SHURMAN & ASSOCIATES MOFFATT & MICHEL				DESIGNED J.H.L. 2.1. DRAWN BY K.B. M.A. CHECKED BY J.M. ARCHITECT WILLIAM L. FERRERA & ASSOCIATES A. QUINCY JONES-FREDERICK E. HENSON & ASSOCIATES BLUROCK ELLERBROCK & ASSOCIATES URBANUS SQUARE • MACARTHUR BOULEVARD AT FORD ROAD TELEPHONE 714/678-2640 • CORONA DEL MAR, CALIFORNIA	APPROVED STATE FIRE MARSHAL STATE OF CALIFORNIA DATE JUN 21 1968 55874 APPROVED JUN 21 1968 NOV 24 1968	GOLDEN WEST COLLEGE HUNTINGTON BEACH, CALIFORNIA ORANGE COAST JUNIOR COLLEGE DISTRICT	UNIT 4 ROOF PLAN	SHEET NO. 100-1 DATE 15 JUN 1968 SHEET NO. A-13
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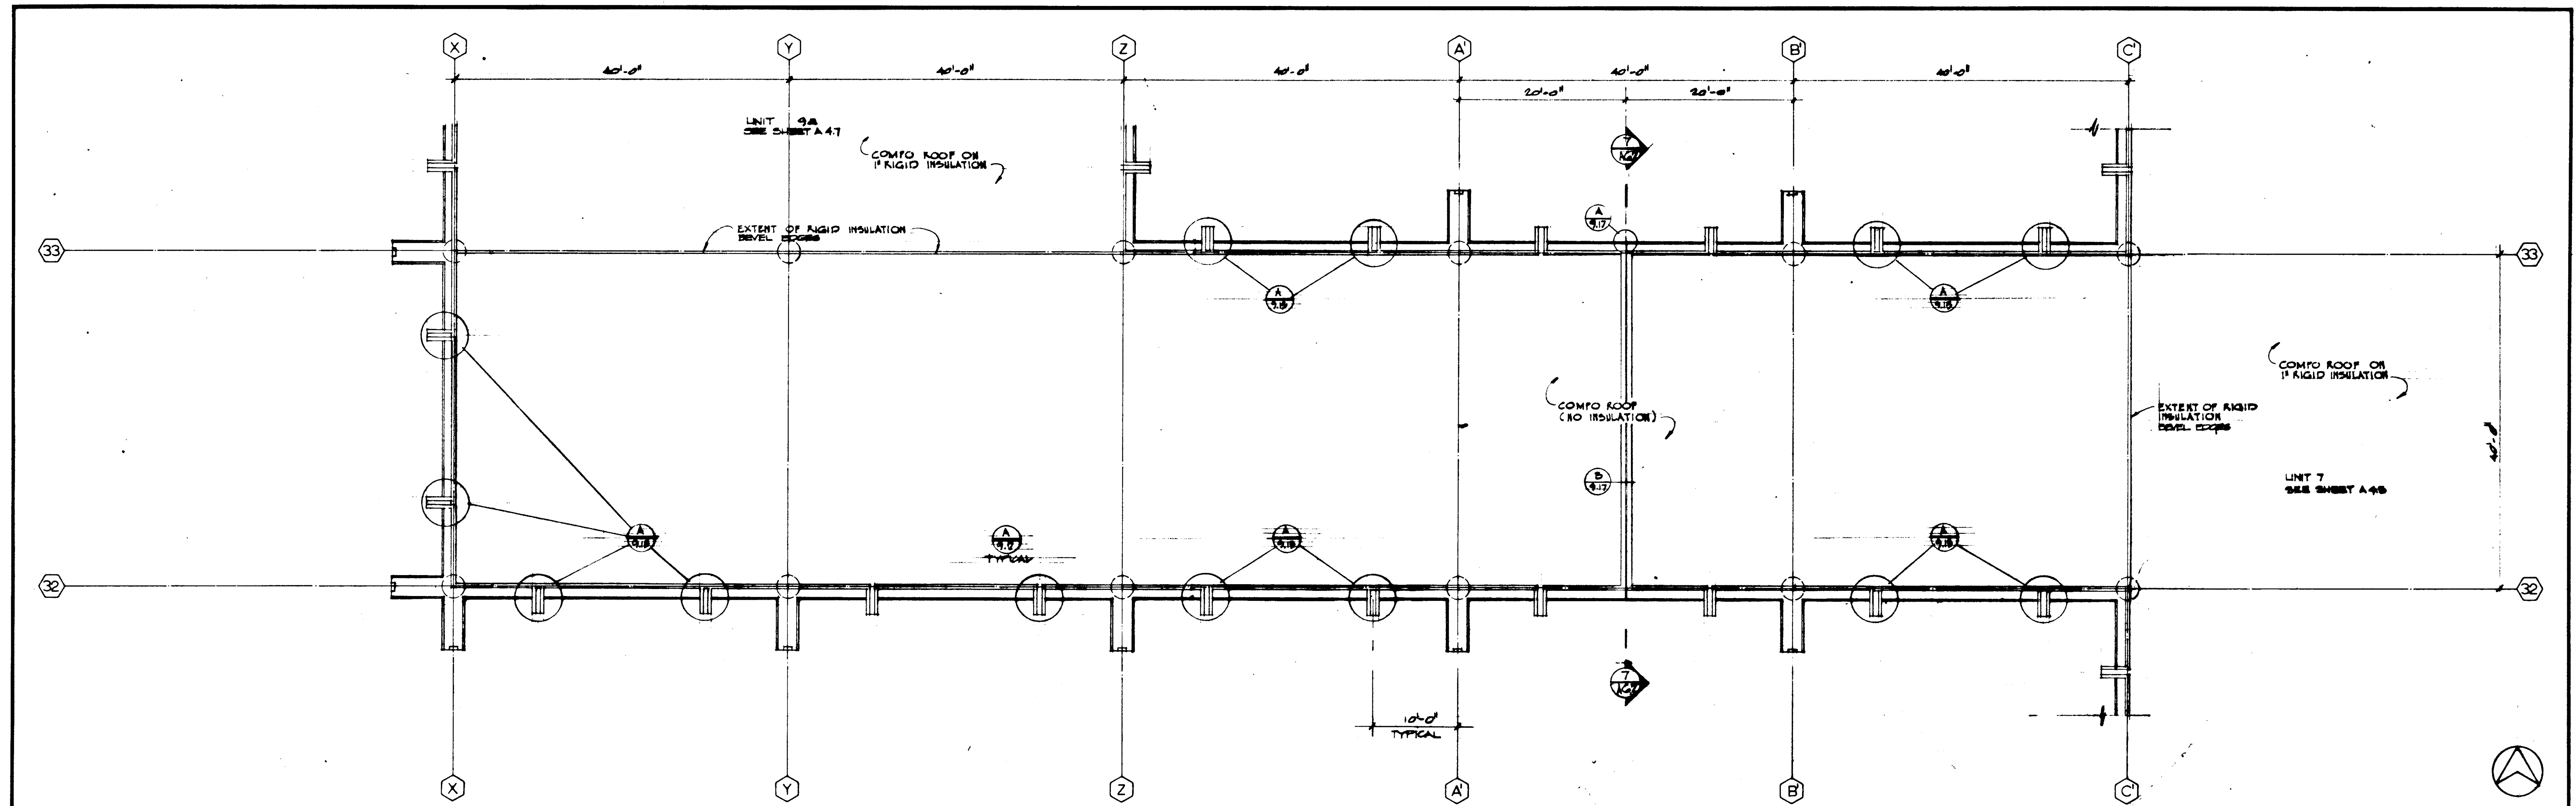
UNIT 8a ROOF PLAN										Scale	2	UNIT 8b ROOF PLAN										Scale	1				
										APPROVED												APPROVED					
STRUCTURAL ENGINEERS BRANDOW & JOHNSTON J.A. MARTIN & ASSOCIATES										DESIGNED JUL - 22		ARCHITECT WILLIAM L. PEREIRA		ASSOCIATED ARCHITECTS: WILLIAM L. PEREIRA & ASSOCIATES A. QUINCY JONES-FREDERICK E. EMMONS & ASSOCIATES BLUROCK ELLERBROEK & ASSOCIATES										UNIT 8a 8b		JOB NO. 100-4	
MECHANICAL ENGINEERS RALPH E. PHILLIPS, INC.										DRAWN BY W. PADGALSKAS		ENGINEER		STATE FIRE MARSHAL STATE OF CALIFORNIA DATE: JUN 23 1961										DATE 15 JUN 1961		SHEET NO.	
ELECTRICAL ENGINEERS RALPH E. PHILLIPS, INC.										CHECKED BY JUL		COLLEGE		URBANUS SQUARE • MACARTHUR BOULEVARD AT FORD ROAD TELEPHONE 714/675-2640 • CORONA DEL MAR, CALIFORNIA										ROOF PLANS		A-1.03	
CIVIL ENGINEERS G. SHURMAN & ASSOCIATES MOFFATT & NICHOL																											
REVISIONS																											

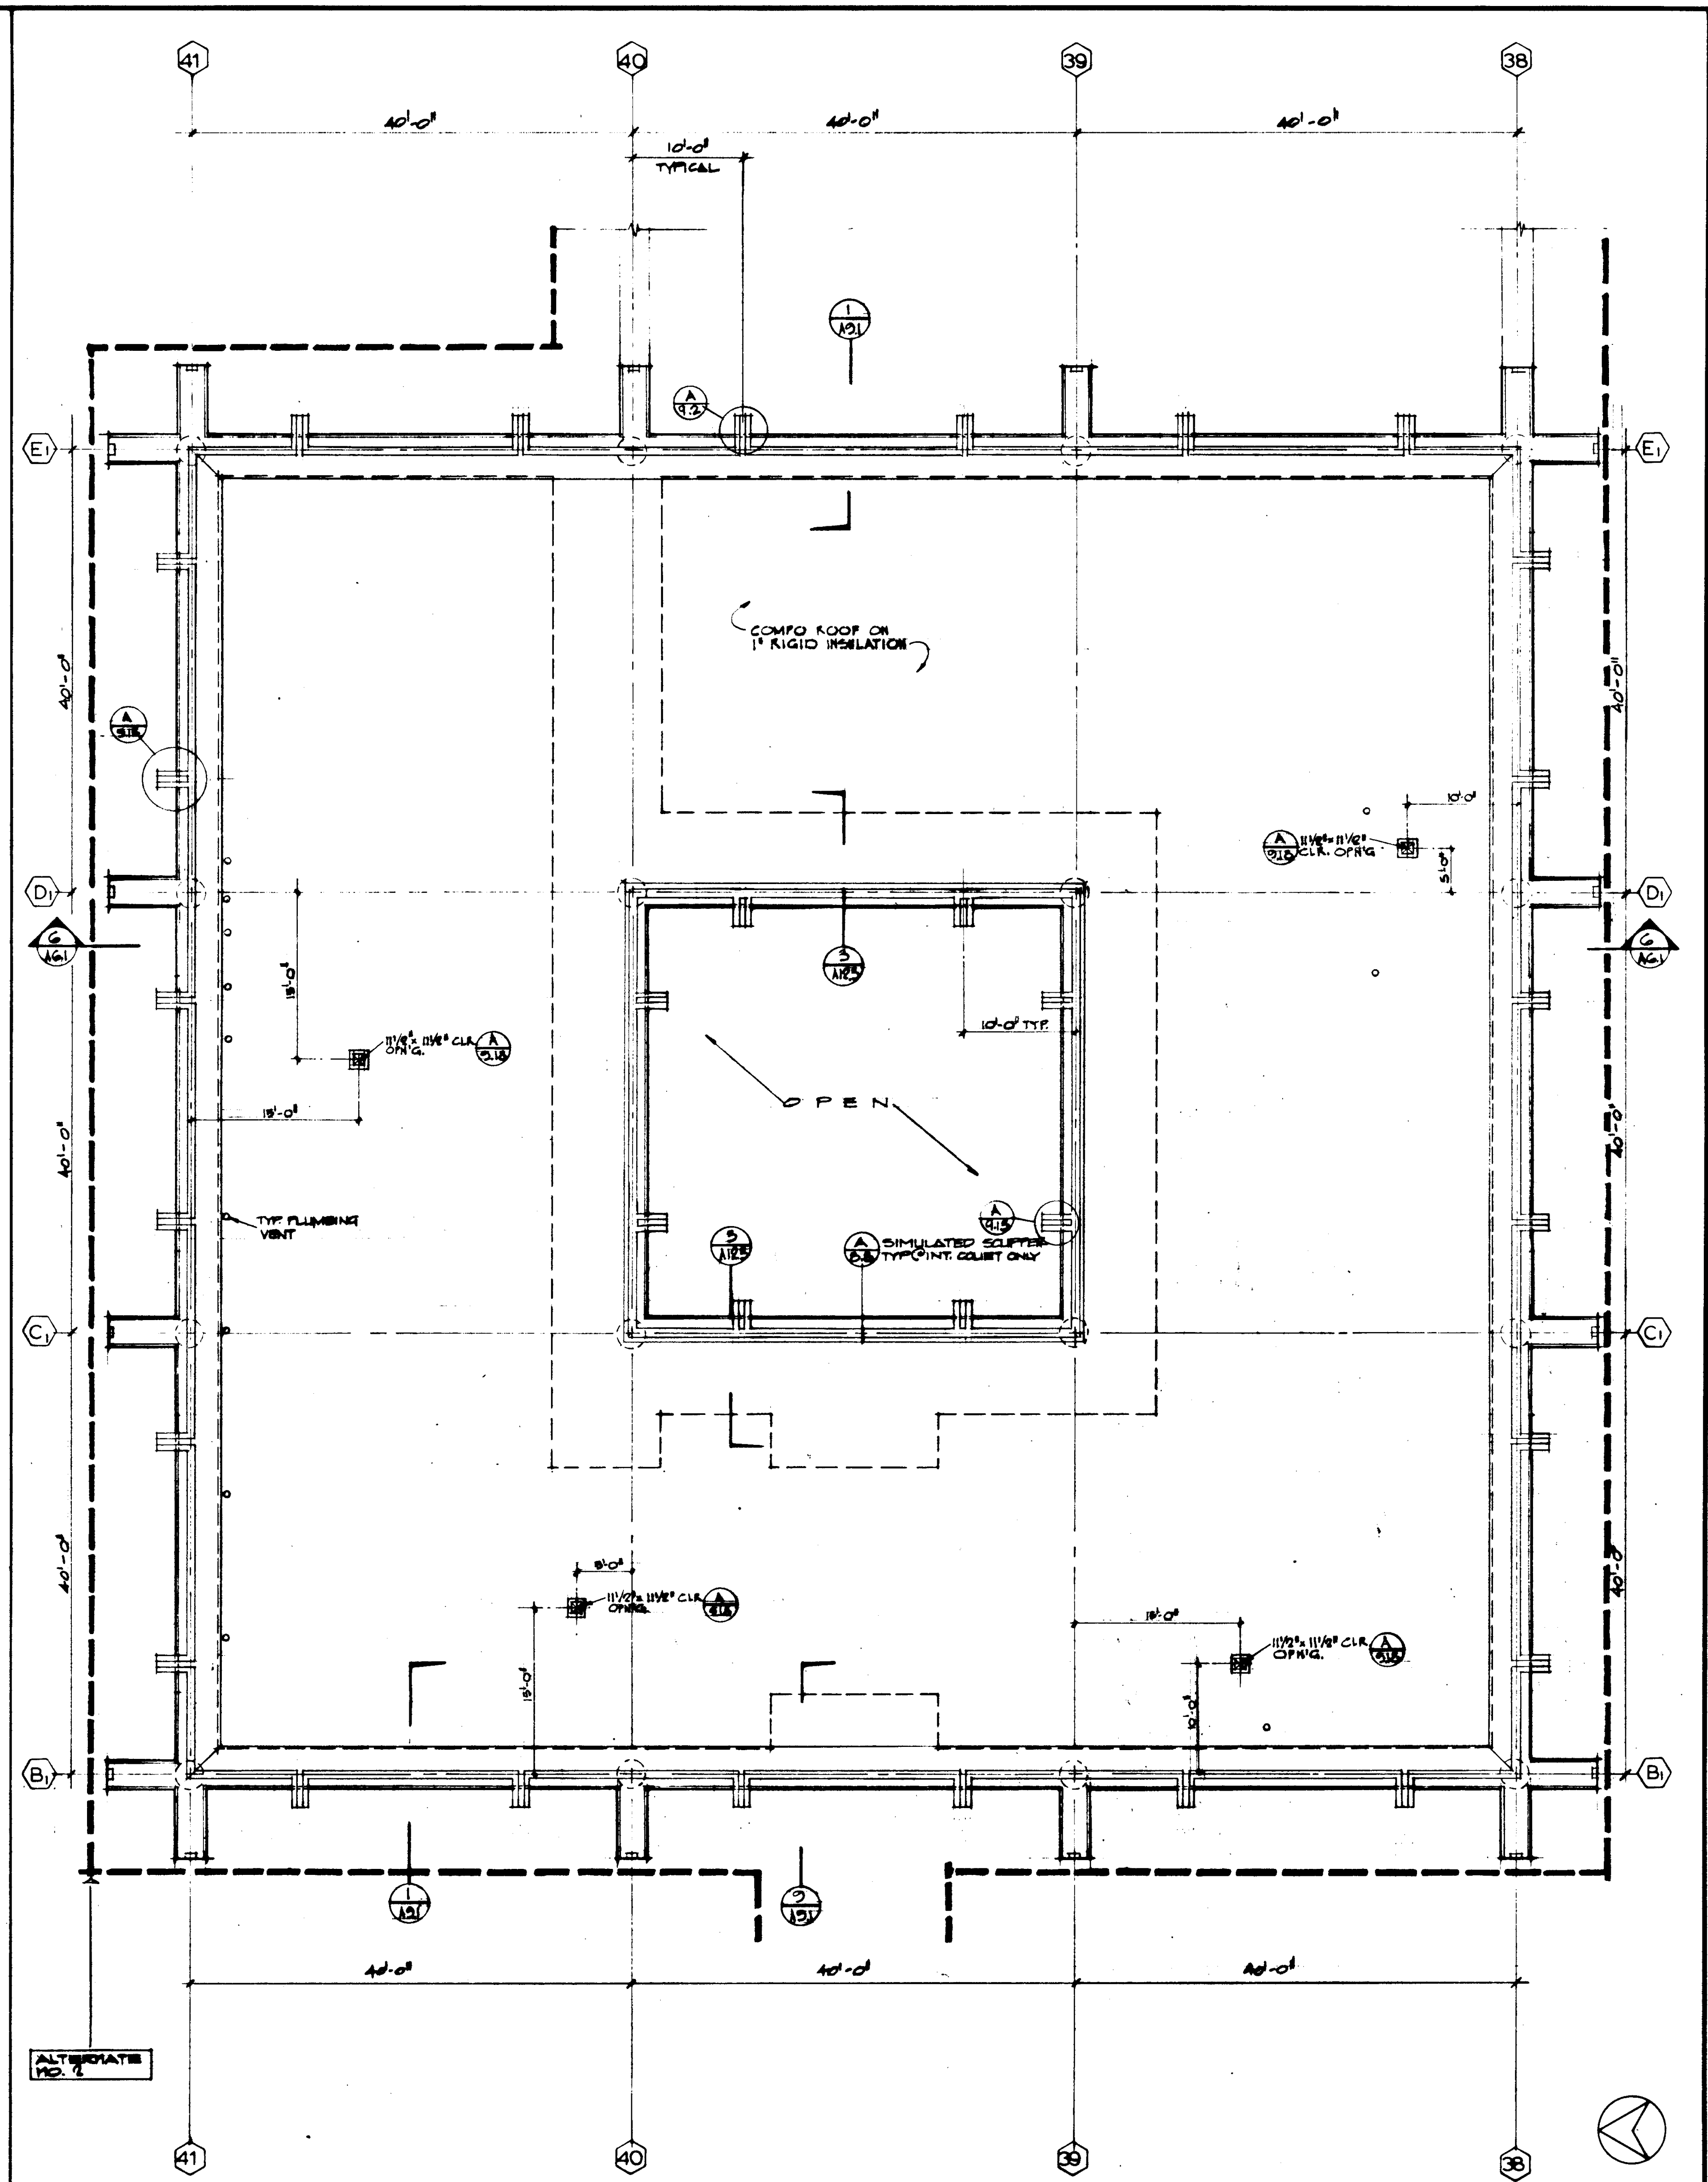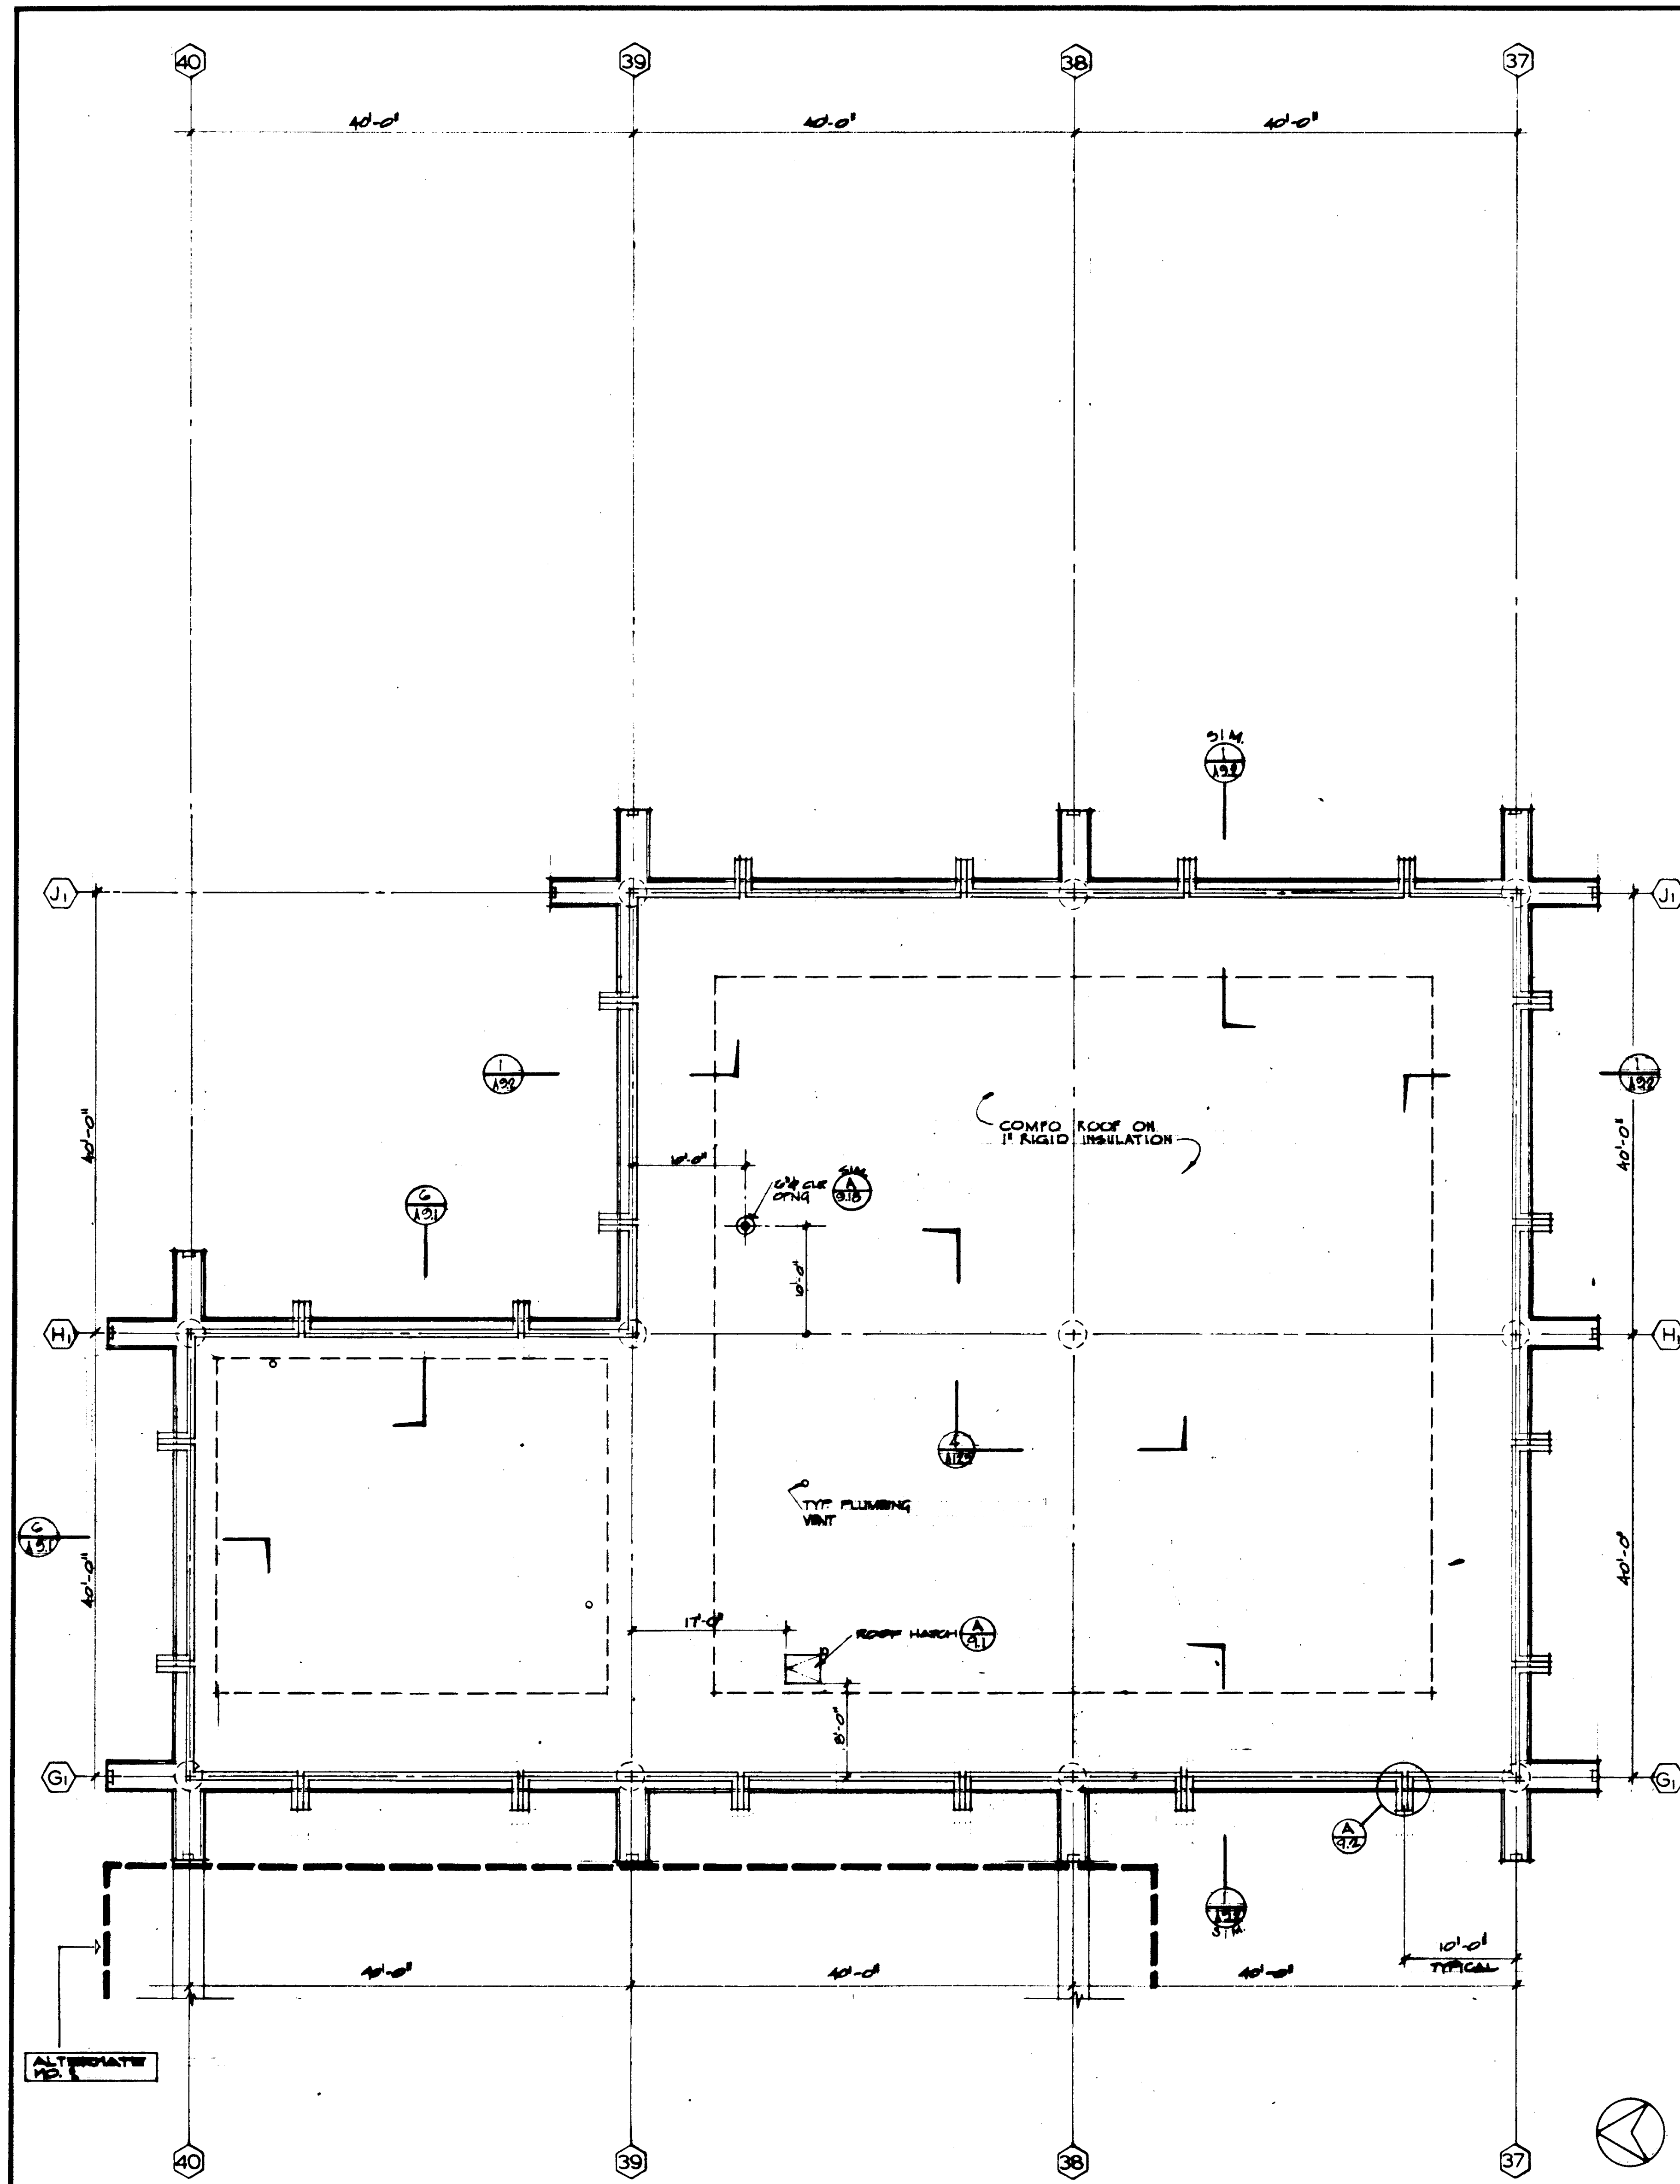GOLDEN WEST COLLEGE
HUNTINGTON BEACH, CALIFORNIA
ORANGE COAST JUNIOR COLLEGE DISTRICT




ROOF PLAN

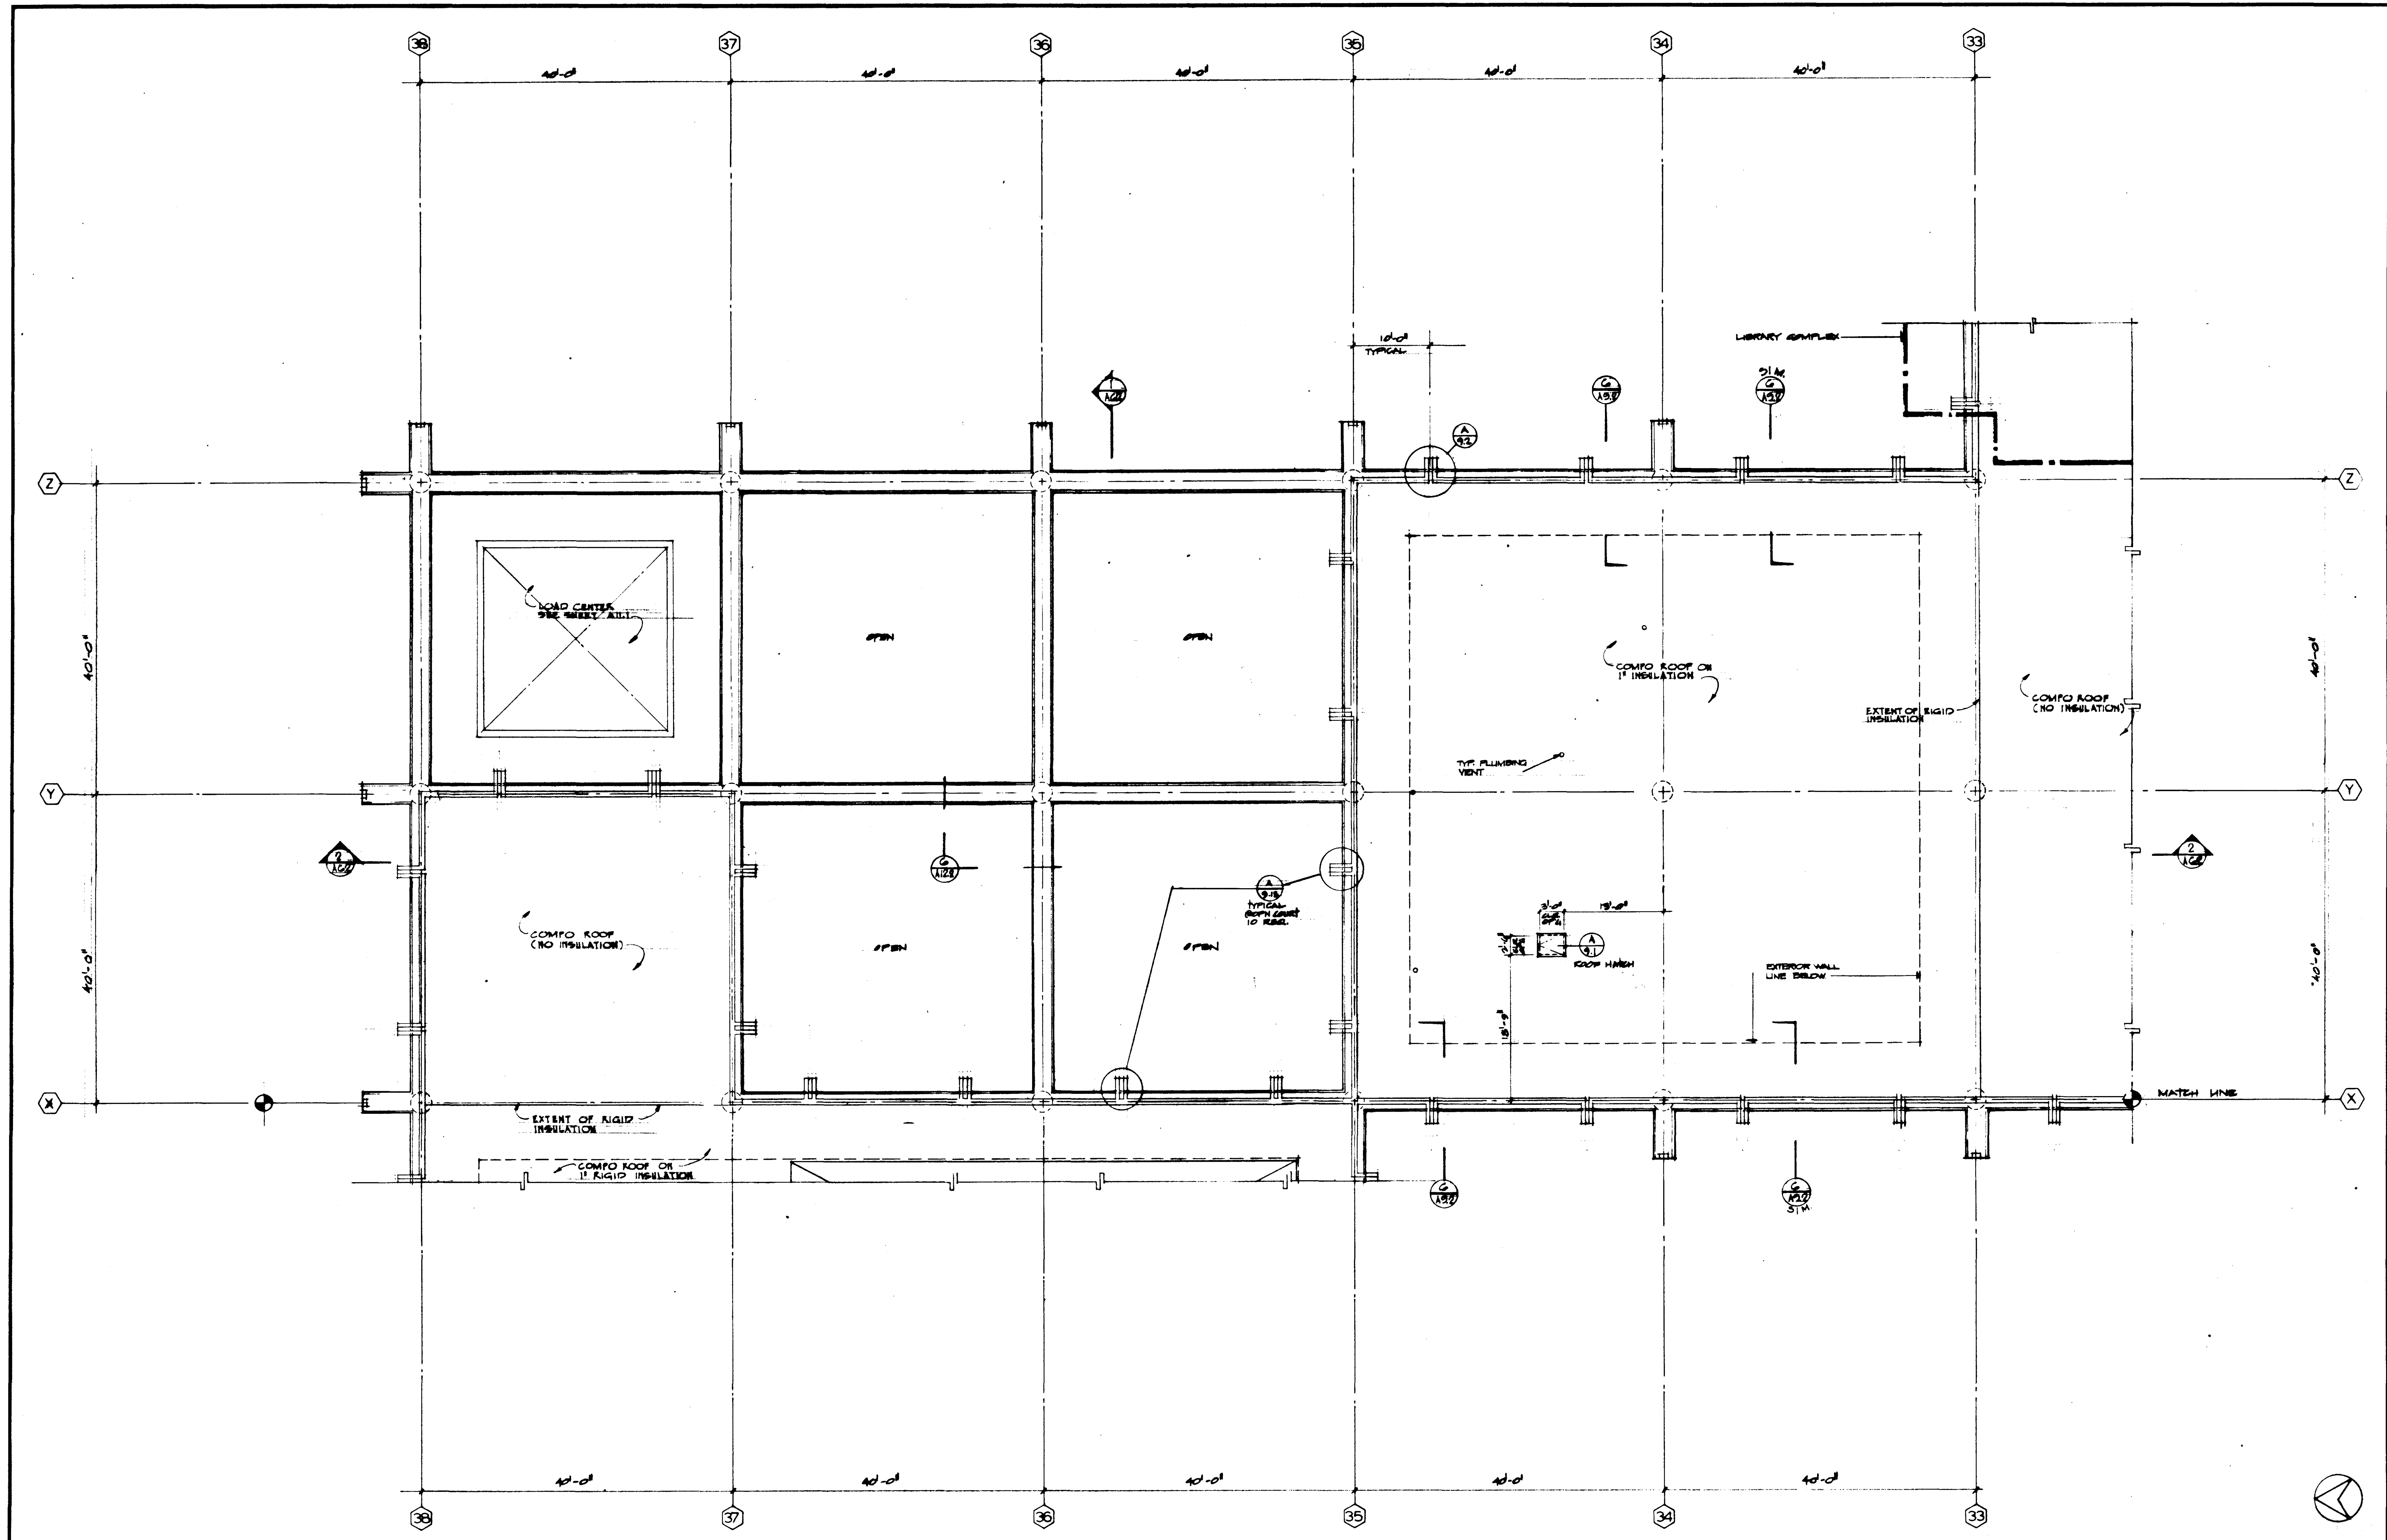STRUCTURAL ENGINEERS BRANDOW & JOHNSTON J.A. MARTIN & ASSOCIATES MECHANICAL ENGINEERS RALPH E. PHILLIPS, INC. ELECTRICAL ENGINEERS RALPH E. PHILLIPS, INC. CIVIL ENGINEERS G. SHURMAN & ASSOCIATES MOFFATT & NICOL				DESIGNED JAL: T2J DRAWN BY K. B. CHECKED BY J.M.	ARCHITECT WILLIAM L. PEREIRA ENGINEER COLLEGE	APPROVED STATE FIRE MARSHAL STATE OF CALIFORNIA DATE JUN 21 1967 25874 APPROVED JUN 21 1967	ASSOCIATED ARCHITECTS: WILLIAM L. PEREIRA & ASSOCIATES A. QUINCY JONES, FREDERICK E. HEMMONS & ASSOCIATES BLUROCK ELLERBROEK & ASSOCIATES URBANUS SQUARE • MACARTHUR BOULEVARD AT FORD ROAD TELEPHONE 714/675-2640 • CORONA DEL MAR, CALIFORNIA	GOLDEN WEST COLLEGE HUNTINGTON BEACH, CALIFORNIA ORANGE COAST JUNIOR COLLEGE DISTRICT	UNIT 32 ROOF PLAN	JOB NO. 1004 15 JUL 1967 SHEET NO. A 4.5
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UNIT 13 ROOF PLAN


SCALE 1/8" = 1'-0"




UNIT 12 ROOF PLAN

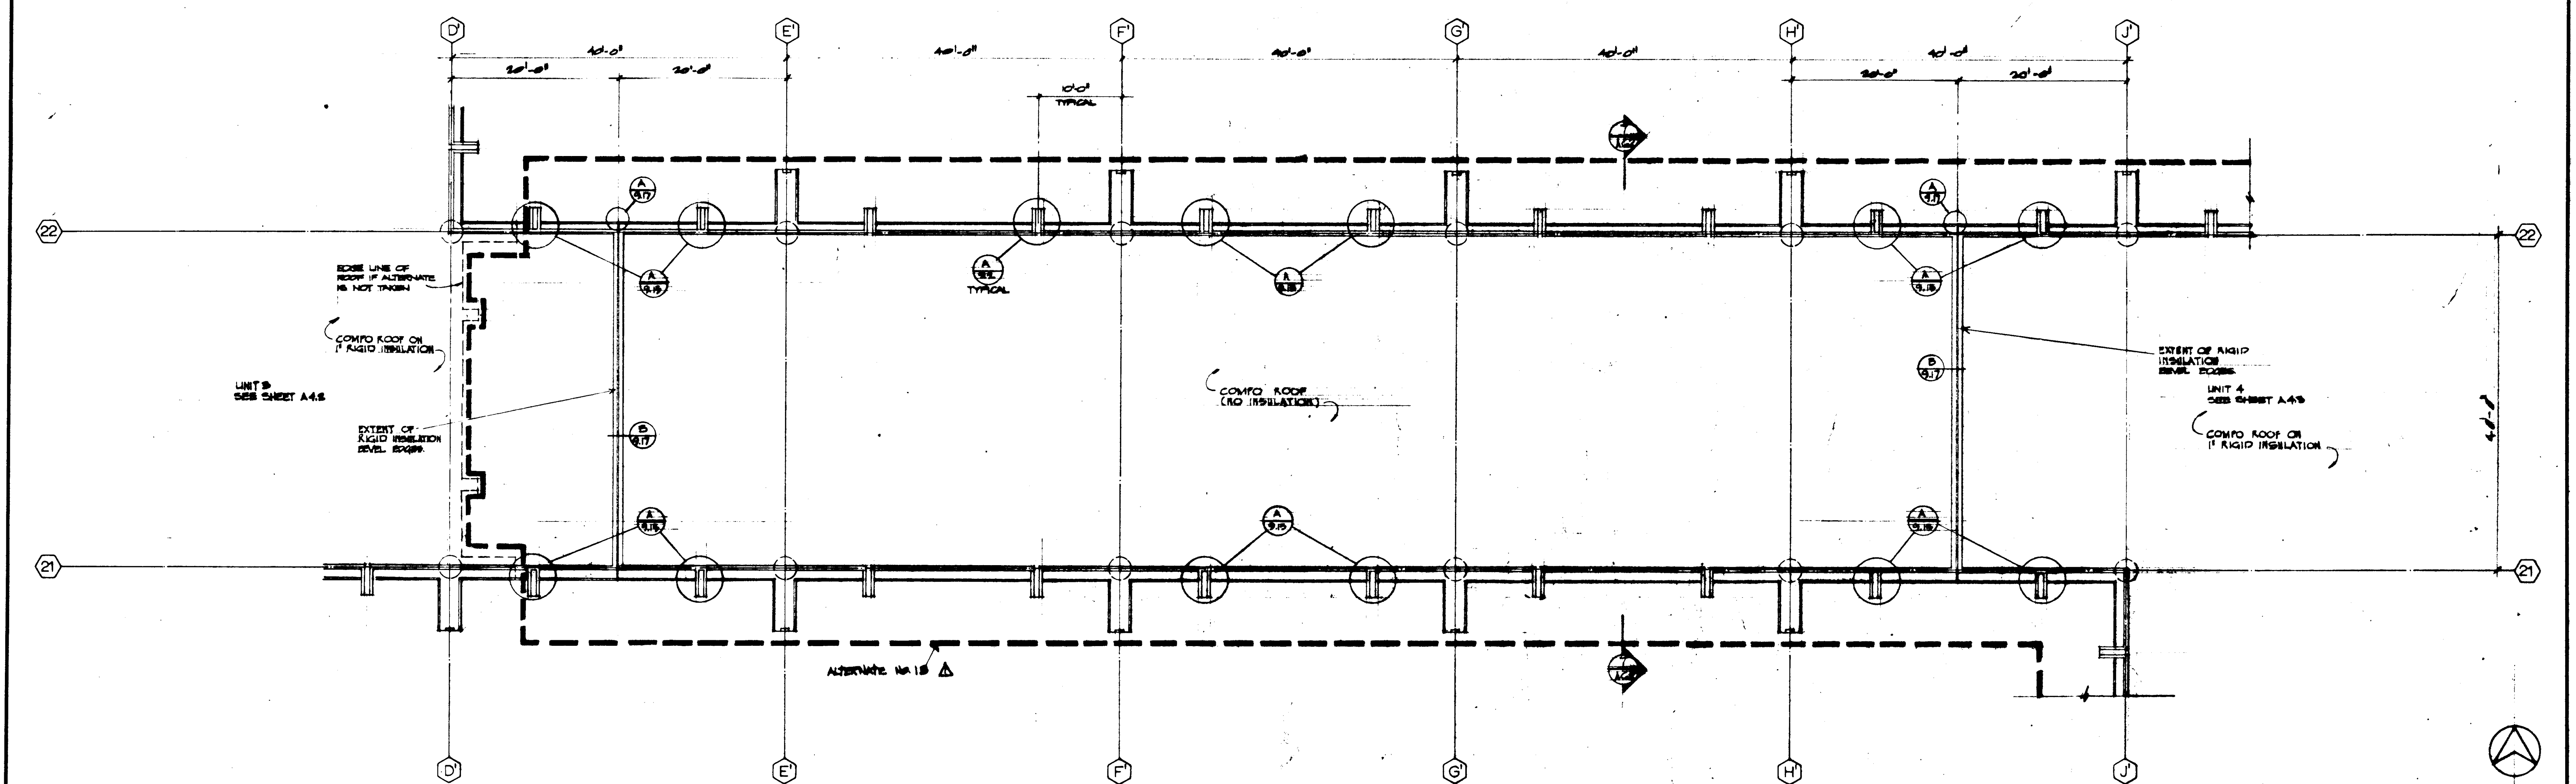SCALE 1/8" = 1'-0"

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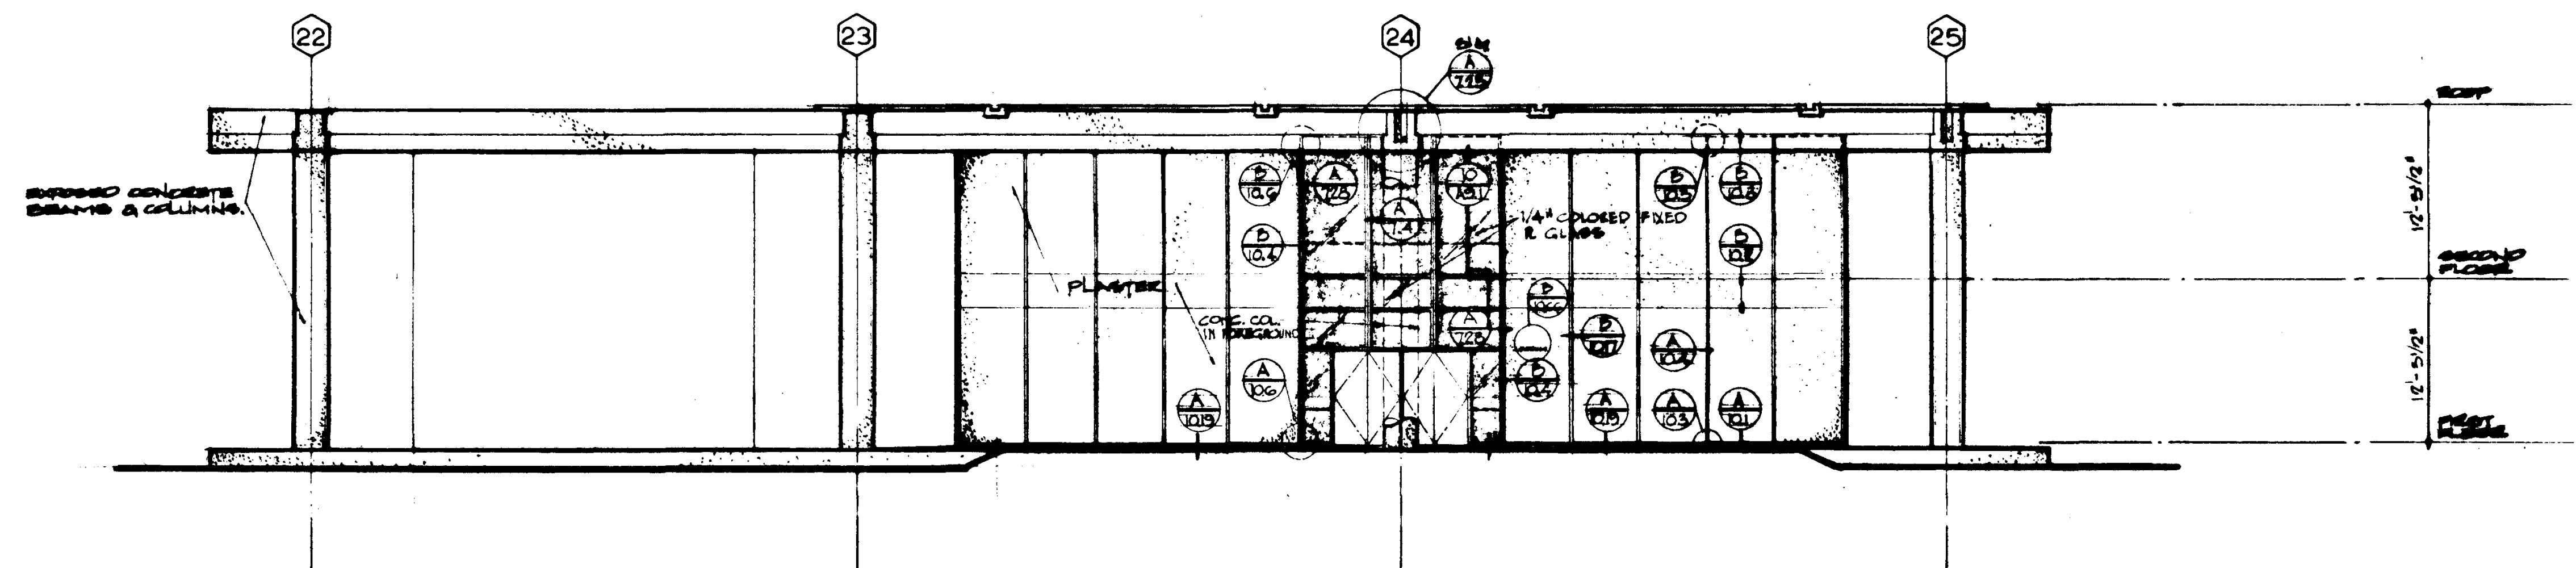


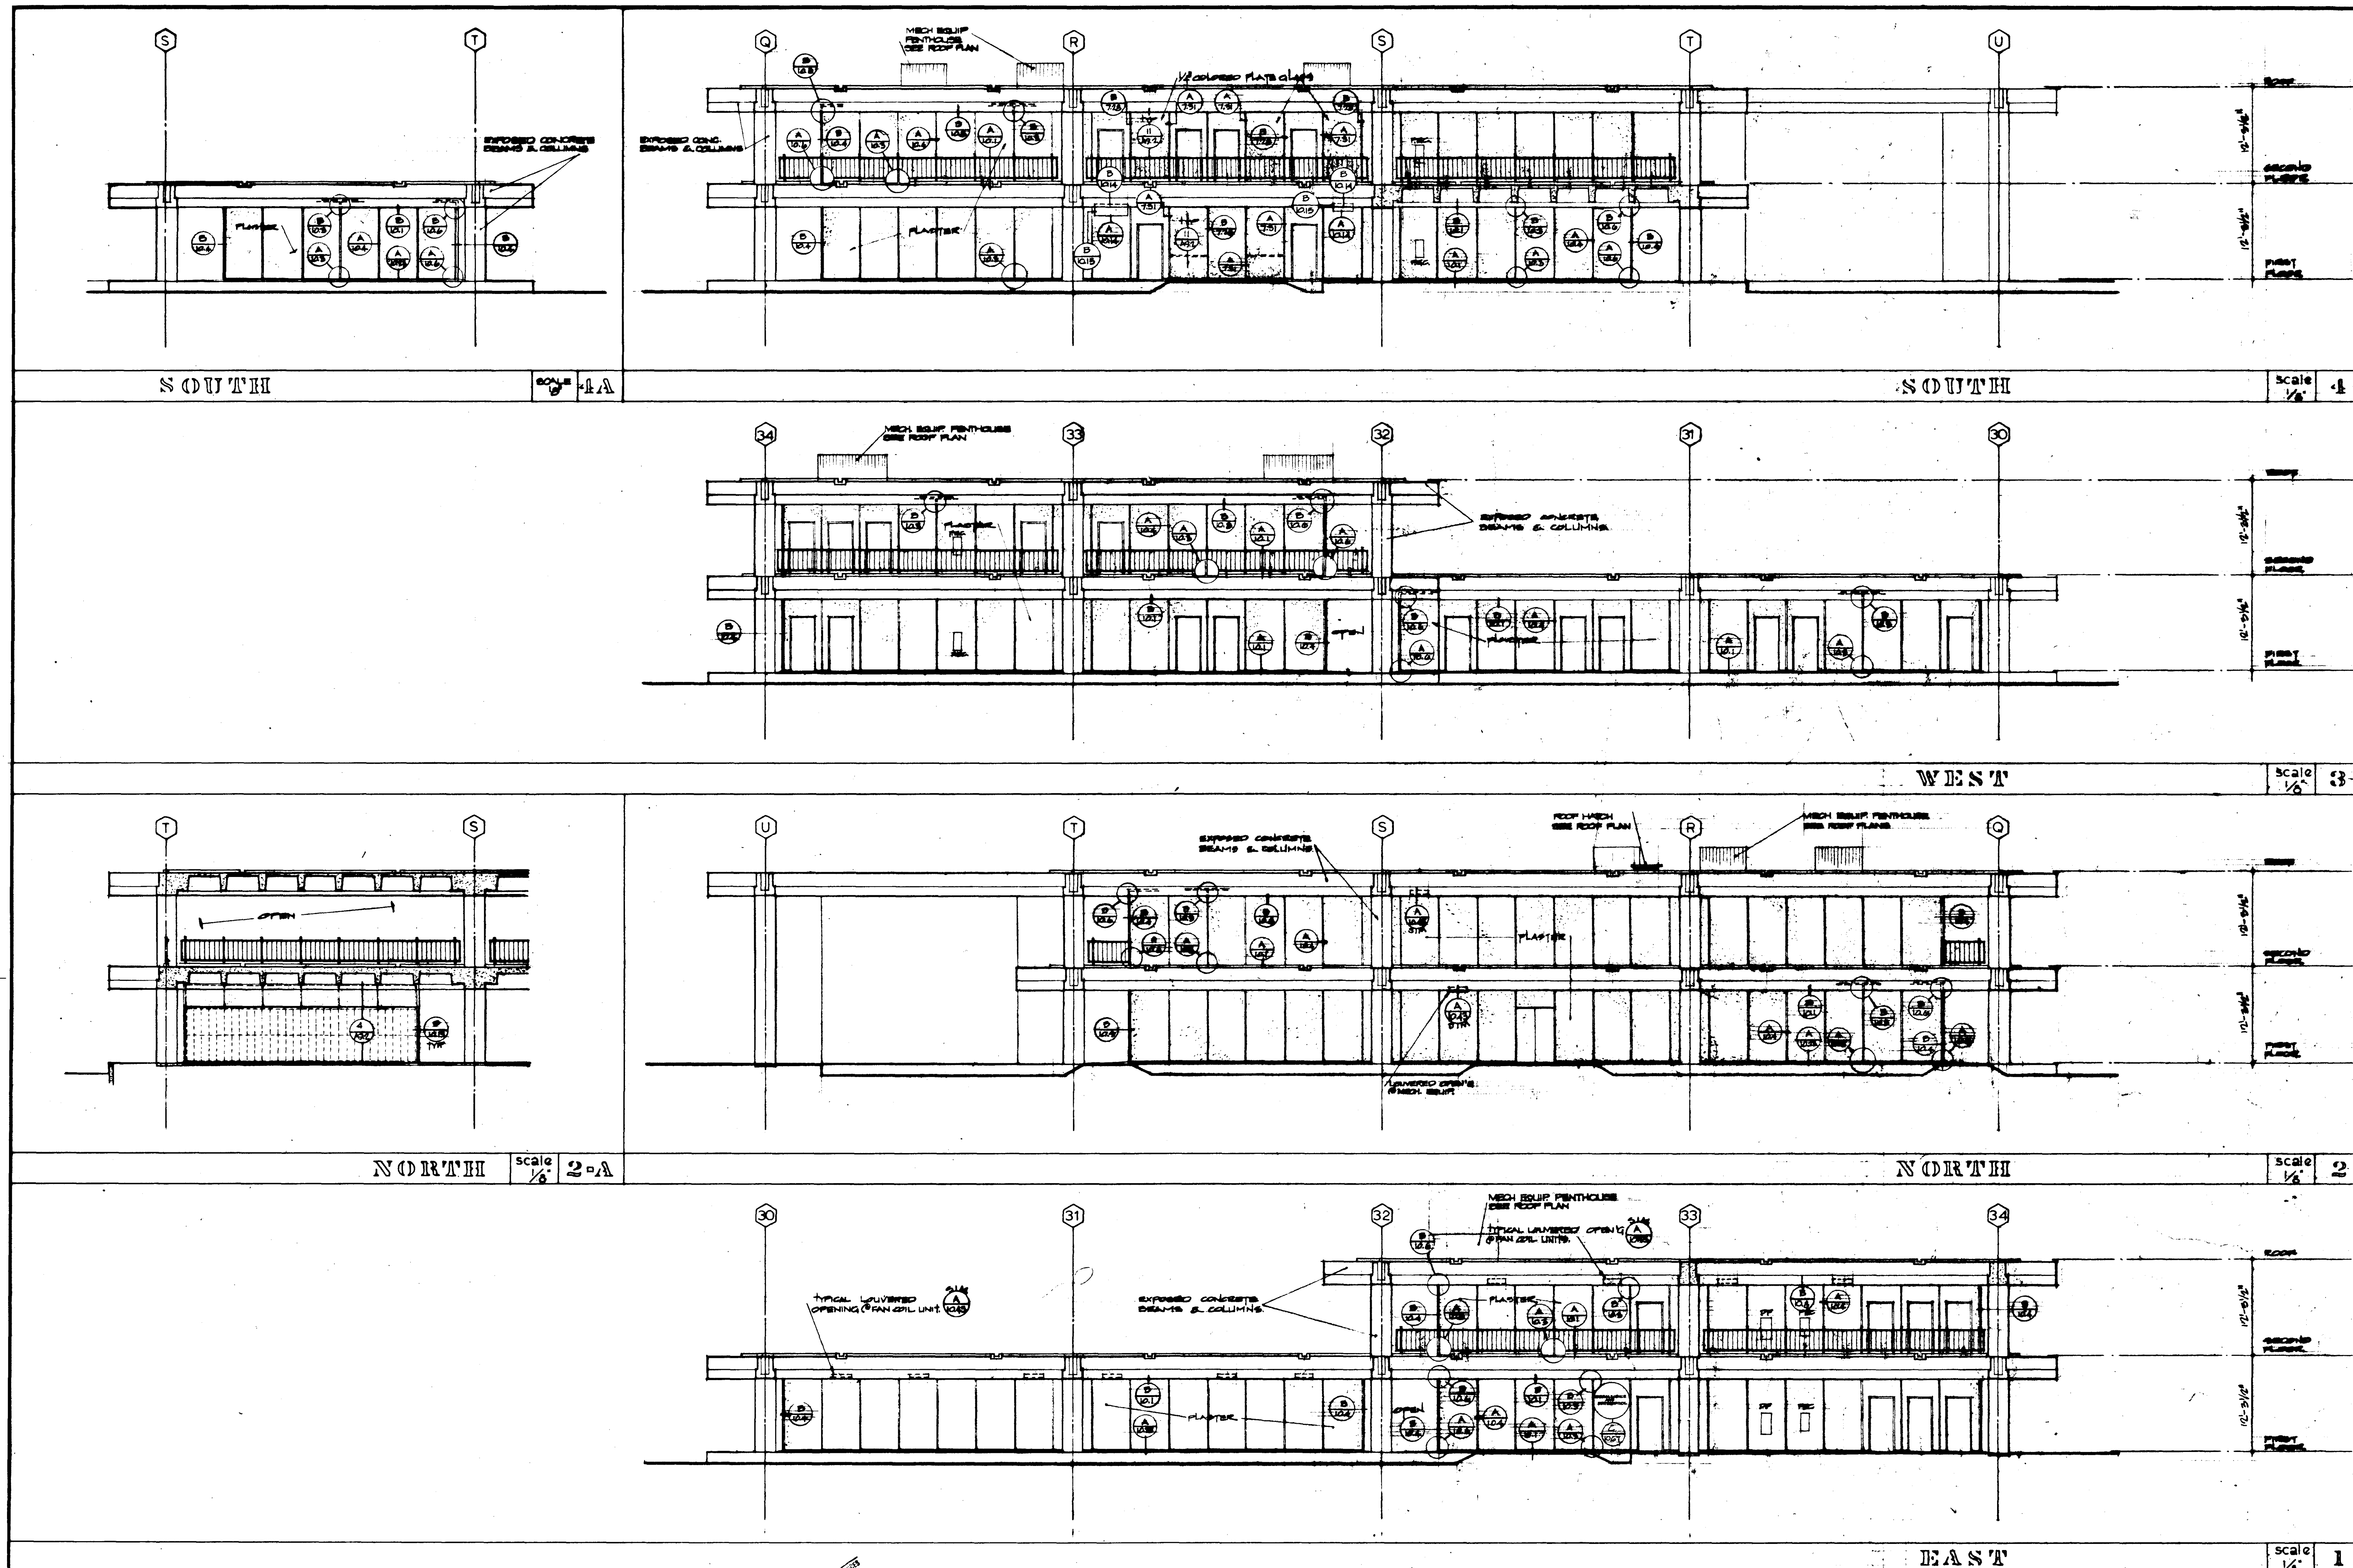STRUCTURAL ENGINEERS BRADDOCK & JOHNSTON 1111 1/2 STREET OCEANA, CALIF. 92650				DESIGNED BY W. PADGALSKAS				ARCHITECT WILLIAM L. PEREIRA & ASSOCIATES 1111 1/2 STREET OCEANA, CALIF. 92650				APPROVED STATE FIRE MARSHAL STATE OF CALIFORNIA DATE: JUN 21 1965				ASSOCIATED ARCHITECTS: WILLIAM L. PEREIRA & ASSOCIATES A. QUINCY JONES-FREDERICK E. EMMONS & ASSOCIATES BLUROCK ELLERBROEK & ASSOCIATES URBANUS SQUARE • MACARTHUR BOULEVARD AT FORD ROAD TELEPHONE 714/675-2640 • CORONA DEL MAR, CALIFORNIA				GOLDEN WEST COLLEGE HUNTINGTON BEACH, CALIFORNIA ORANGE COAST JUNIOR COLLEGE DISTRICT				UNIT 1 EXTERIOR ELEVATIONS A 5.1				JOB NO. 100-1 DATE: JUN 1965 SHEET NO. A 5.1			
MECHANICAL ENGINEERS RALPH E. PHILLIPS, INC. 1111 1/2 STREET OCEANA, CALIF. 92650				DRAWN BY W. PADGALSKAS				ENGINEER WILLIAM L. PEREIRA				APPROVED STATE FIRE MARSHAL STATE OF CALIFORNIA DATE: JUN 21 1965				ASSOCIATED ARCHITECTS: WILLIAM L. PEREIRA & ASSOCIATES A. QUINCY JONES-FREDERICK E. EMMONS & ASSOCIATES BLUROCK ELLERBROEK & ASSOCIATES URBANUS SQUARE • MACARTHUR BOULEVARD AT FORD ROAD TELEPHONE 714/675-2640 • CORONA DEL MAR, CALIFORNIA				GOLDEN WEST COLLEGE HUNTINGTON BEACH, CALIFORNIA ORANGE COAST JUNIOR COLLEGE DISTRICT				UNIT 1 EXTERIOR ELEVATIONS A 5.1				JOB NO. 100-1 DATE: JUN 1965 SHEET NO. A 5.1			
ELECTRICAL ENGINEERS RALPH E. PHILLIPS, INC. 1111 1/2 STREET OCEANA, CALIF. 92650				CHECKED BY W. PADGALSKAS				CIVIL ENGINEERS G. SHUIRMAN & ASSOCIATES MOFFATT & NICHOL				APPROVED STATE FIRE MARSHAL STATE OF CALIFORNIA DATE: JUN 21 1965				ASSOCIATED ARCHITECTS: WILLIAM L. PEREIRA & ASSOCIATES A. QUINCY JONES-FREDERICK E. EMMONS & ASSOCIATES BLUROCK ELLERBROEK & ASSOCIATES URBANUS SQUARE • MACARTHUR BOULEVARD AT FORD ROAD TELEPHONE 714/675-2640 • CORONA DEL MAR, CALIFORNIA				GOLDEN WEST COLLEGE HUNTINGTON BEACH, CALIFORNIA ORANGE COAST JUNIOR COLLEGE DISTRICT				UNIT 1 EXTERIOR ELEVATIONS A 5.1				JOB NO. 100-1 DATE: JUN 1965 SHEET NO. A 5.1			
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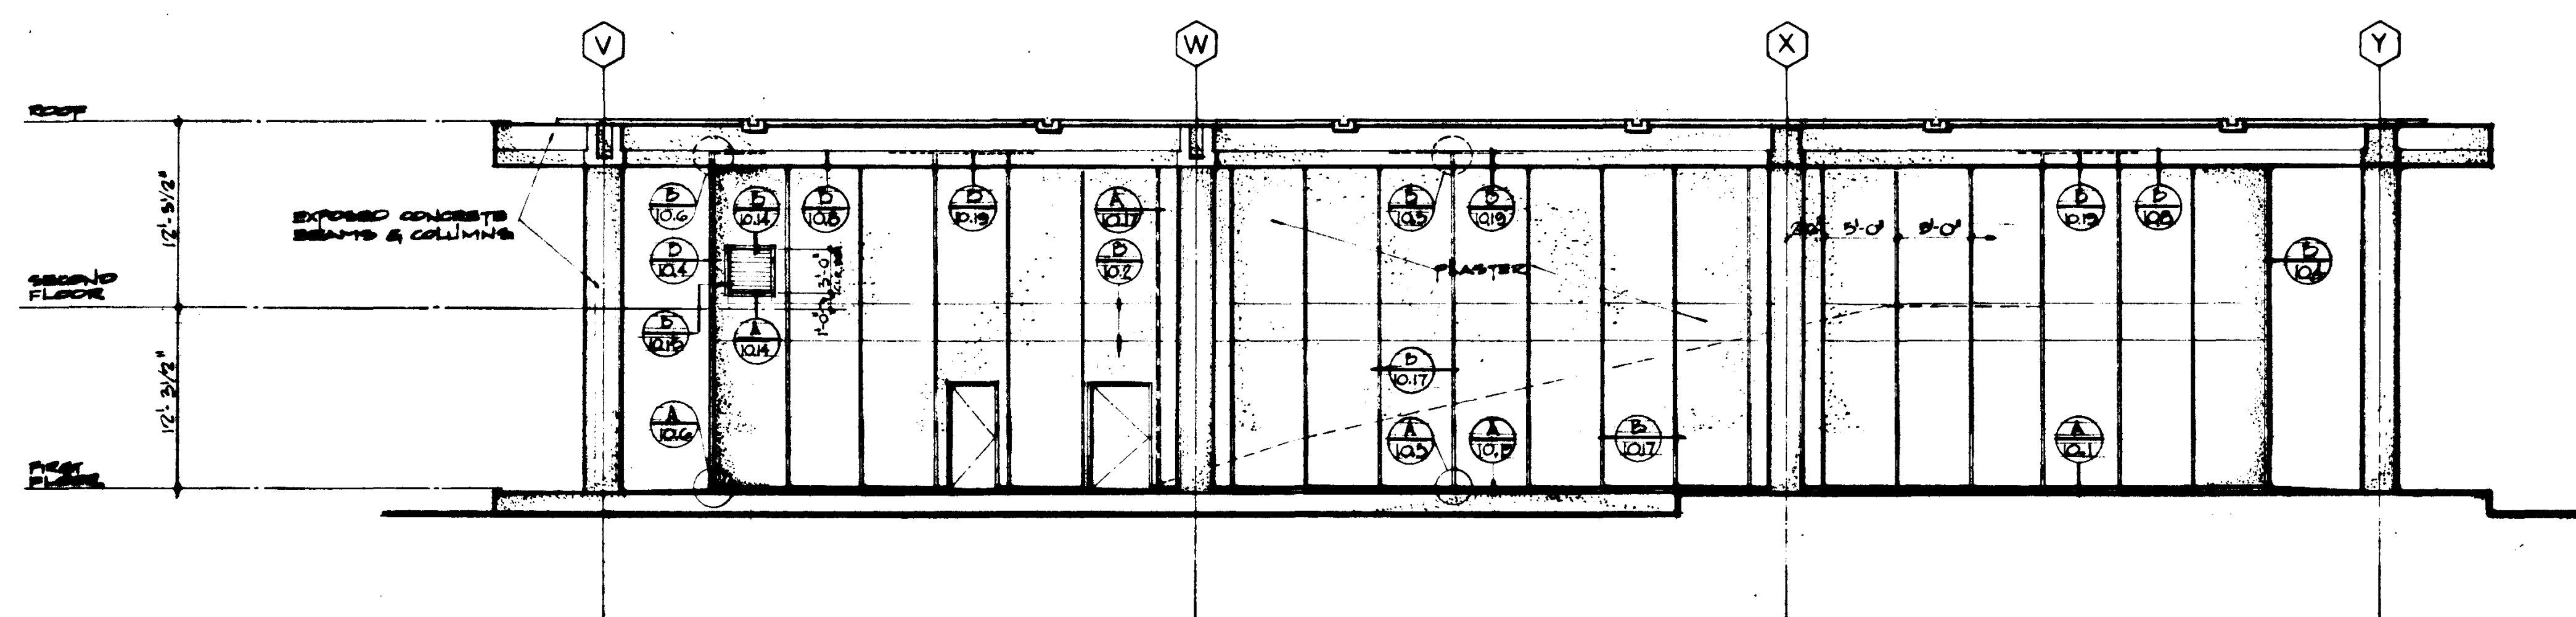
NORTH

SCALE 1/8" = 1'

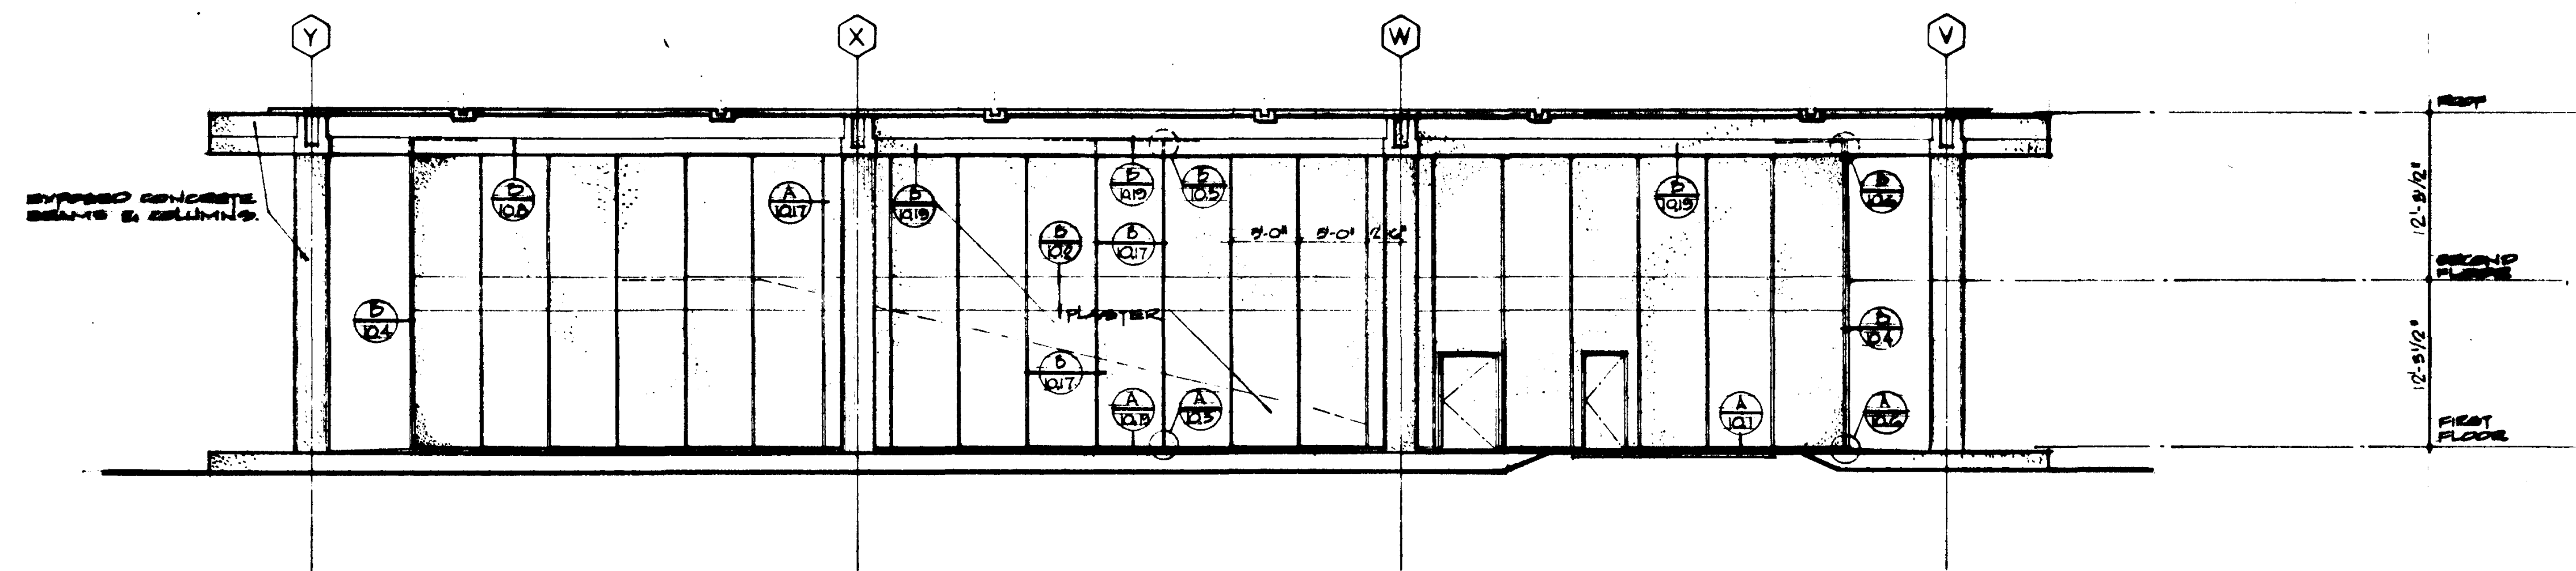


EAST

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SOUTH


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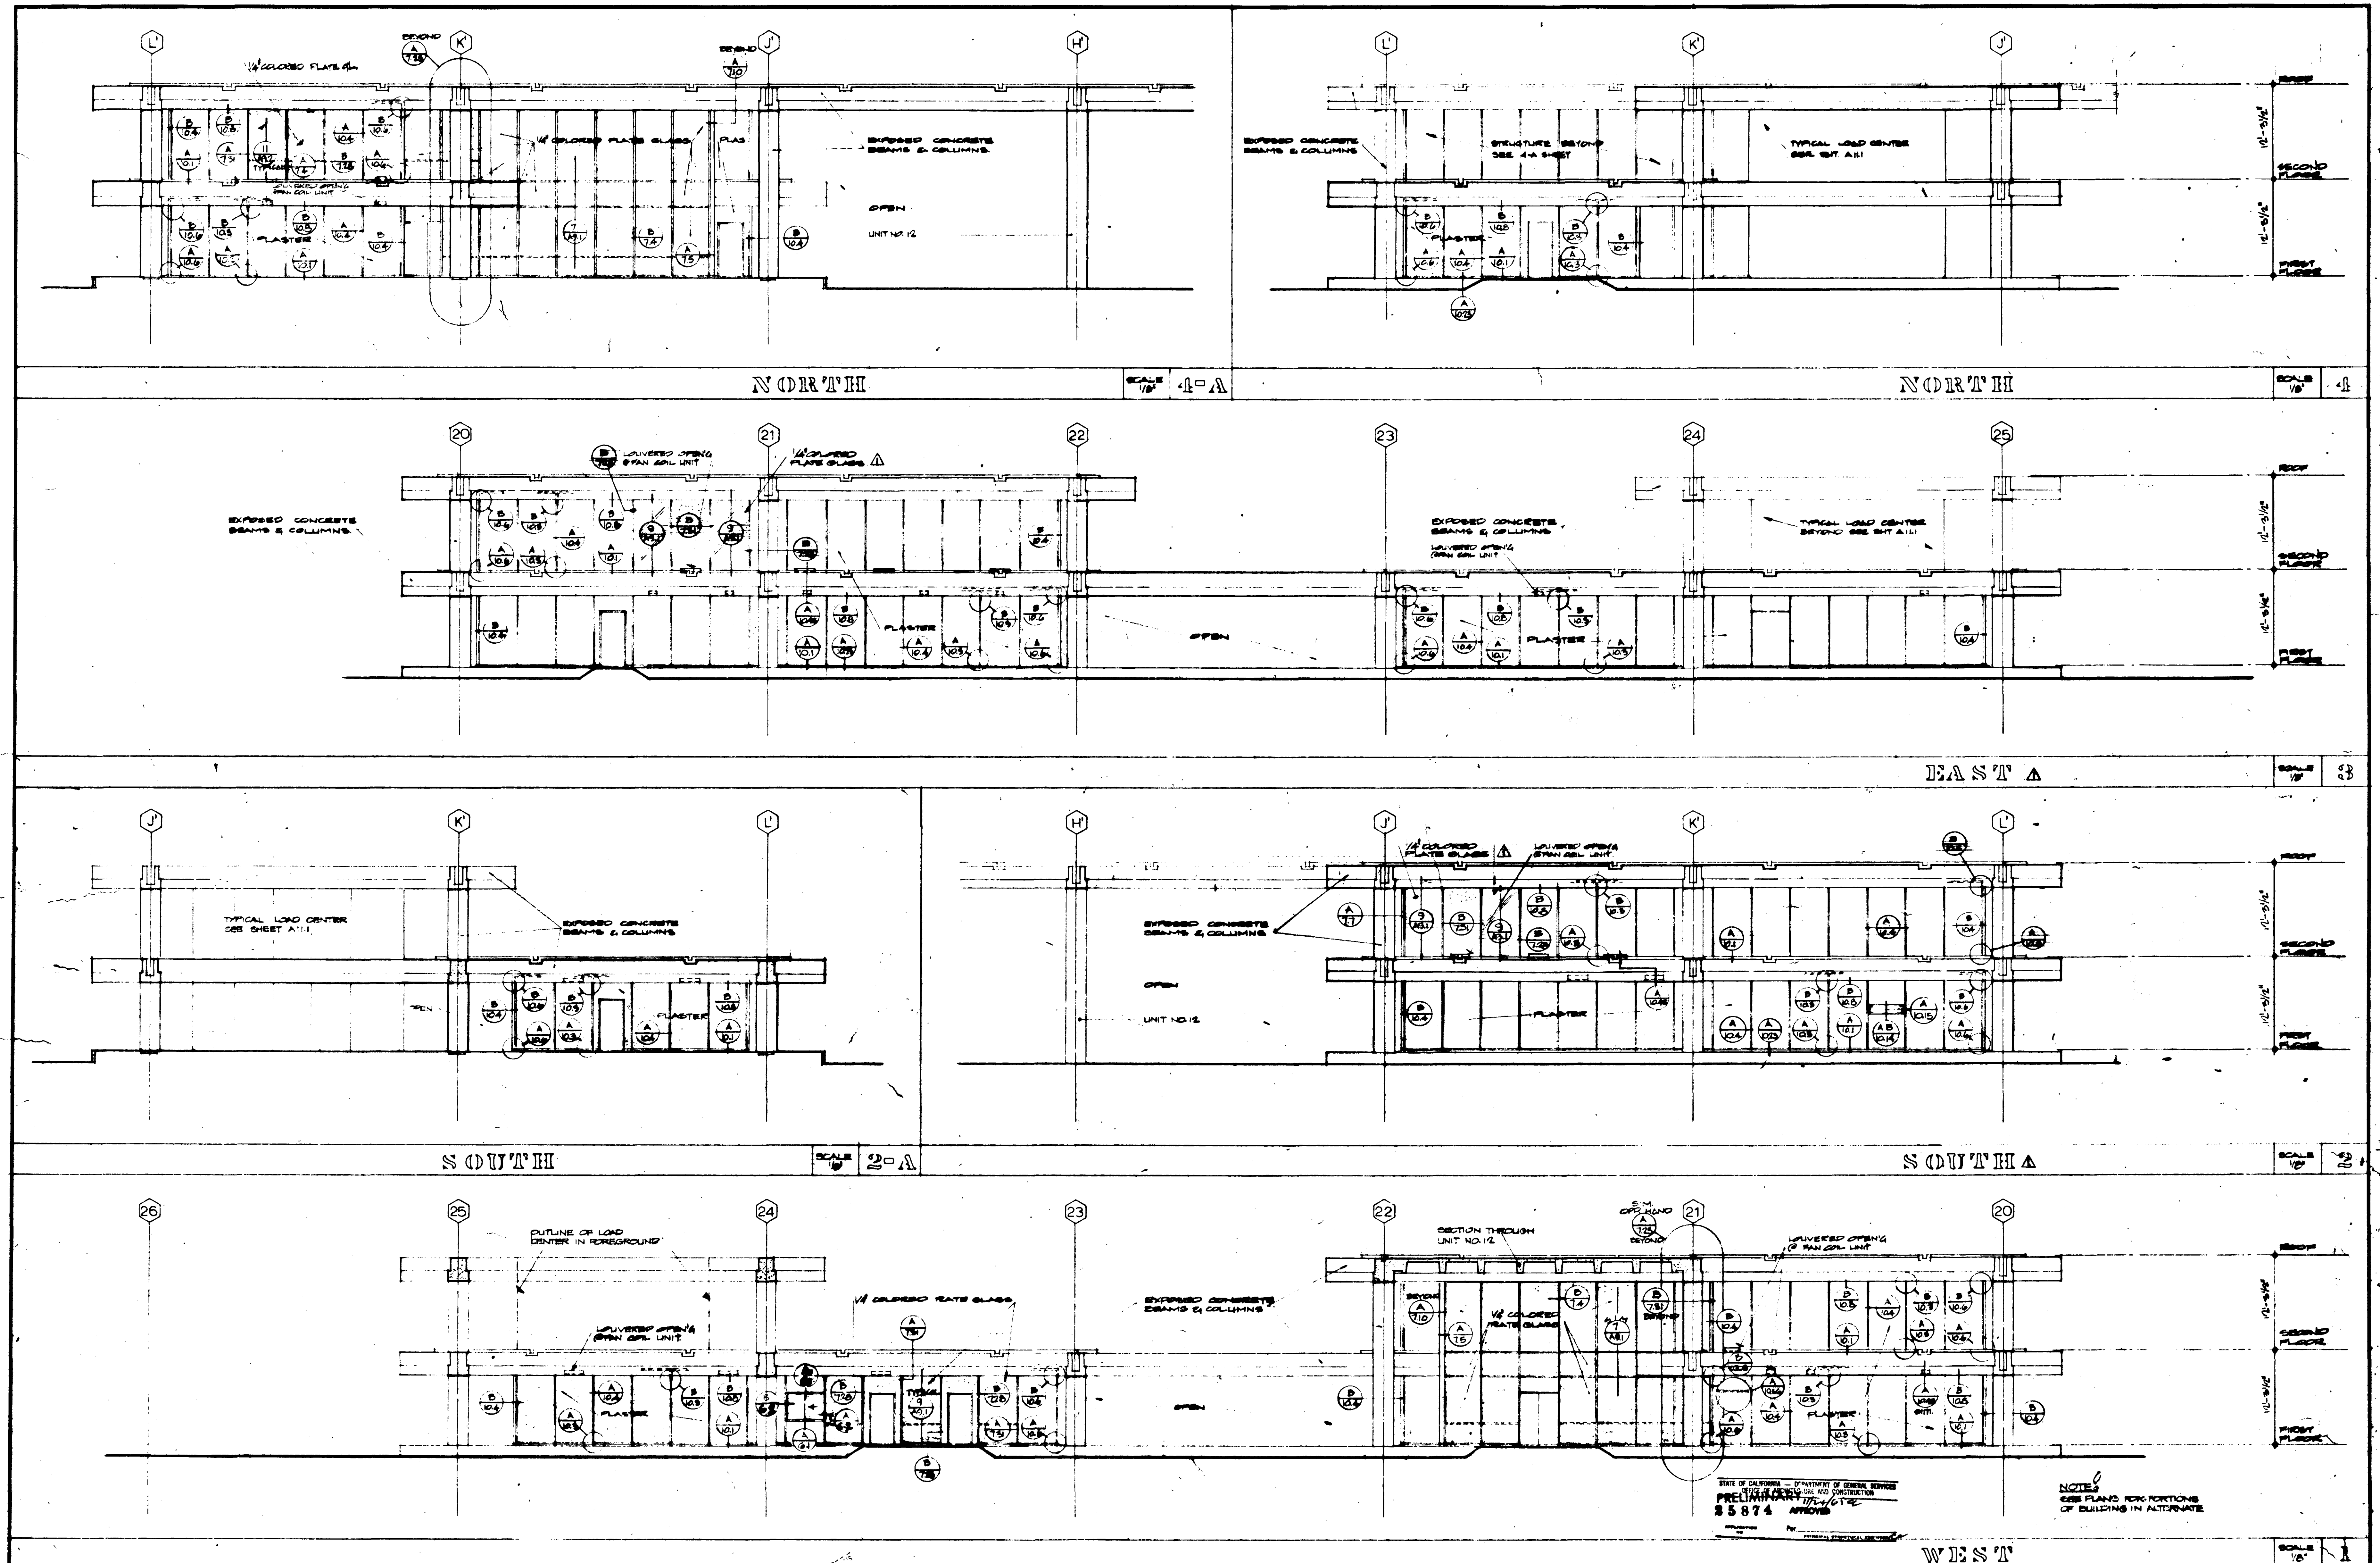
WEST

SCALE 1/8" = 1'


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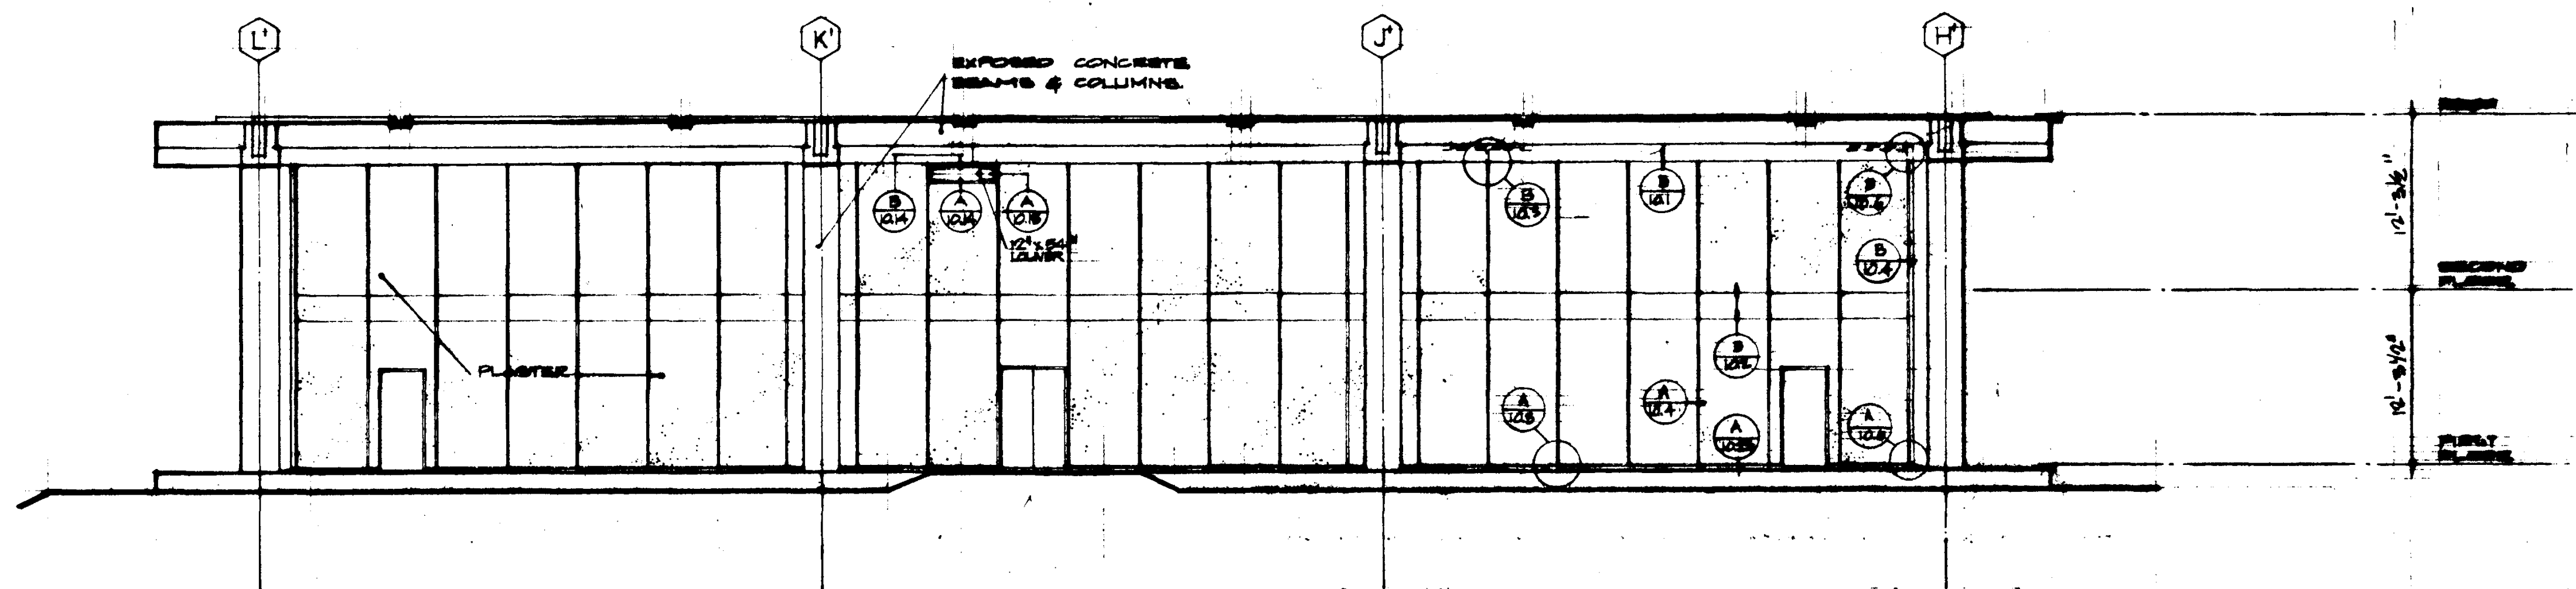
		STRUCTURAL ENGINEERS BRANDOW & JOHNSTON J.A. MARTIN & ASSOCIATES		DESIGNED	ARCHITECT WILLIAM L. PEREIRA	APPROVED STATE FIRE MARSHAL STATE OF CALIFORNIA DATE JUN 21 1968 25874 APPROVED JUN 21 1968 By [Signature]	ASSOCIATED ARCHITECTS: WILLIAM L. PEREIRA & ASSOCIATES A. QUINCY JONES-FREDERICK E. EMMONS & ASSOCIATES BLUROCK ELLERBROEK & ASSOCIATES		GOLDEN WEST COLLEGE HUNTINGTON BEACH, CALIFORNIA ORANGE COAST JUNIOR COLLEGE DISTRICT		UNIT 3	JOB NO. 1041
		MECHANICAL ENGINEERS RALPH E. PHILLIPS, INC.		DRAWN BY W. PROCALESKY	ENGINEER						EXTERIOR	JUN 1968
		ELECTRICAL ENGINEERS RALPH E. PHILLIPS, INC.		CHECKED BY	COLLGE						ELEVATIONS	SHEET NO. A 5.3
		CIVIL ENGINEERS O. SHURMAN & ASSOCIATES MOFFATT & NICHOL					URBANUS SQUARE • MACARTHUR BOULEVARD AT FORD ROAD TELEPHONE 714/675-2640 • CORONA DEL MAR, CALIFORNIA					
DATE DRAWN		REVISIONS										

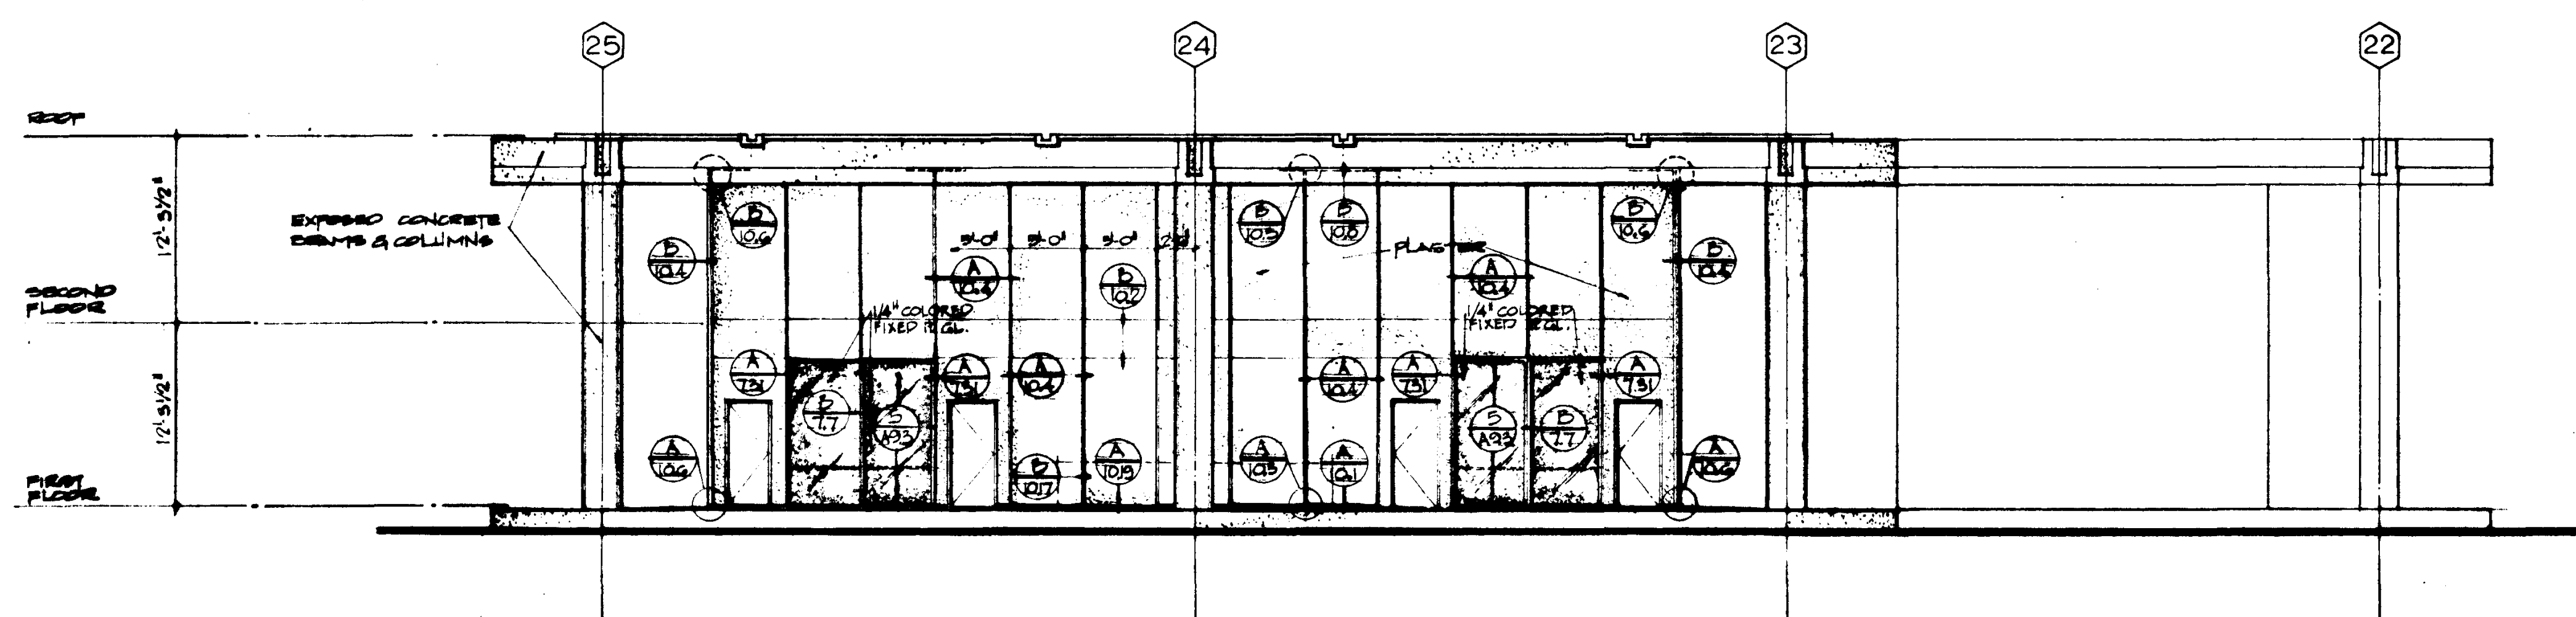

REVISIONS 1. AS SHOWN 2. AS SHOWN 3. AS SHOWN 4. AS SHOWN 5. AS SHOWN 6. AS SHOWN 7. AS SHOWN 8. AS SHOWN 9. AS SHOWN 10. AS SHOWN 11. AS SHOWN 12. AS SHOWN 13. AS SHOWN 14. AS SHOWN 15. AS SHOWN 16. AS SHOWN 17. AS SHOWN 18. AS SHOWN 19. AS SHOWN 20. AS SHOWN 21. AS SHOWN 22. AS SHOWN 23. AS SHOWN 24. AS SHOWN 25. AS SHOWN 26. AS SHOWN 27. AS SHOWN 28. AS SHOWN 29. AS SHOWN 30. AS SHOWN 31. AS SHOWN 32. AS SHOWN 33. AS SHOWN 34. AS SHOWN 35. AS SHOWN 36. AS SHOWN 37. AS SHOWN 38. AS SHOWN 39. AS SHOWN 40. AS SHOWN 41. AS SHOWN 42. AS SHOWN 43. AS SHOWN 44. AS SHOWN 45. AS SHOWN 46. AS SHOWN 47. AS SHOWN 48. AS SHOWN 49. AS SHOWN 50. AS SHOWN 51. AS SHOWN 52. AS SHOWN 53. AS SHOWN 54. AS SHOWN 55. AS SHOWN 56. AS SHOWN 57. AS SHOWN 58. AS SHOWN 59. AS SHOWN 60. AS SHOWN 61. AS SHOWN 62. AS SHOWN 63. AS SHOWN 64. AS SHOWN 65. AS SHOWN 66. AS SHOWN 67. AS SHOWN 68. AS SHOWN 69. AS SHOWN 70. AS SHOWN 71. AS SHOWN 72. AS SHOWN 73. AS SHOWN 74. AS SHOWN 75. AS SHOWN 76. AS SHOWN 77. AS SHOWN 78. AS SHOWN 79. AS SHOWN 80. AS SHOWN 81. AS SHOWN 82. AS SHOWN 83. AS SHOWN 84. AS SHOWN 85. AS SHOWN 86. AS SHOWN 87. AS SHOWN 88. AS SHOWN 89. AS SHOWN 90. AS SHOWN 91. AS SHOWN 92. AS SHOWN 93. AS SHOWN 94. AS SHOWN 95. AS SHOWN 96. AS SHOWN 97. AS SHOWN 98. AS SHOWN 99. AS SHOWN 100. AS SHOWN		STRUCTURAL ENGINEER BRANDOW & JOHNSON J. A. MARTIN & ASSOCIATES MECHANICAL ENGINEER RALPH E. PHILLIPS, INC. ELECTRICAL ENGINEER RALPH E. PHILLIPS, INC. CIVIL ENGINEER G. SHURMAN & ASSOCIATES MOFFATT & NICHOL	DESIGNED DRAWN BY CHECKED BY CALLED	ARCHITECT WILLIAM L. FERREIRA & ASSOCIATES A. QUINCY JONES-FREDERICK E. EMMONS & ASSOCIATES BLUROCK ELLERSBROCK & ASSOCIATES	APPROVED NOV 24 1965 JUN 21 1965 2557	ASSOCIATED ARCHITECTS: WILLIAM L. FERREIRA & ASSOCIATES A. QUINCY JONES-FREDERICK E. EMMONS & ASSOCIATES BLUROCK ELLERSBROCK & ASSOCIATES URBANUS SQUARE • MACARTHUR BOULEVARD AT FORD ROAD TELEPHONE 714/475-2640 • CORONA DEL MAR, CALIFORNIA	GOLDEN WEST COLLEGE HUNTINGTON BEACH, CALIFORNIA ORANGE COAST JUNIOR COLLEGE DISTRICT	UNIT 4 EXTENSION ELEVATIONS	JOB NO. 100-1 DATE 15 JUN 1965 SHEET NO. A 5.4
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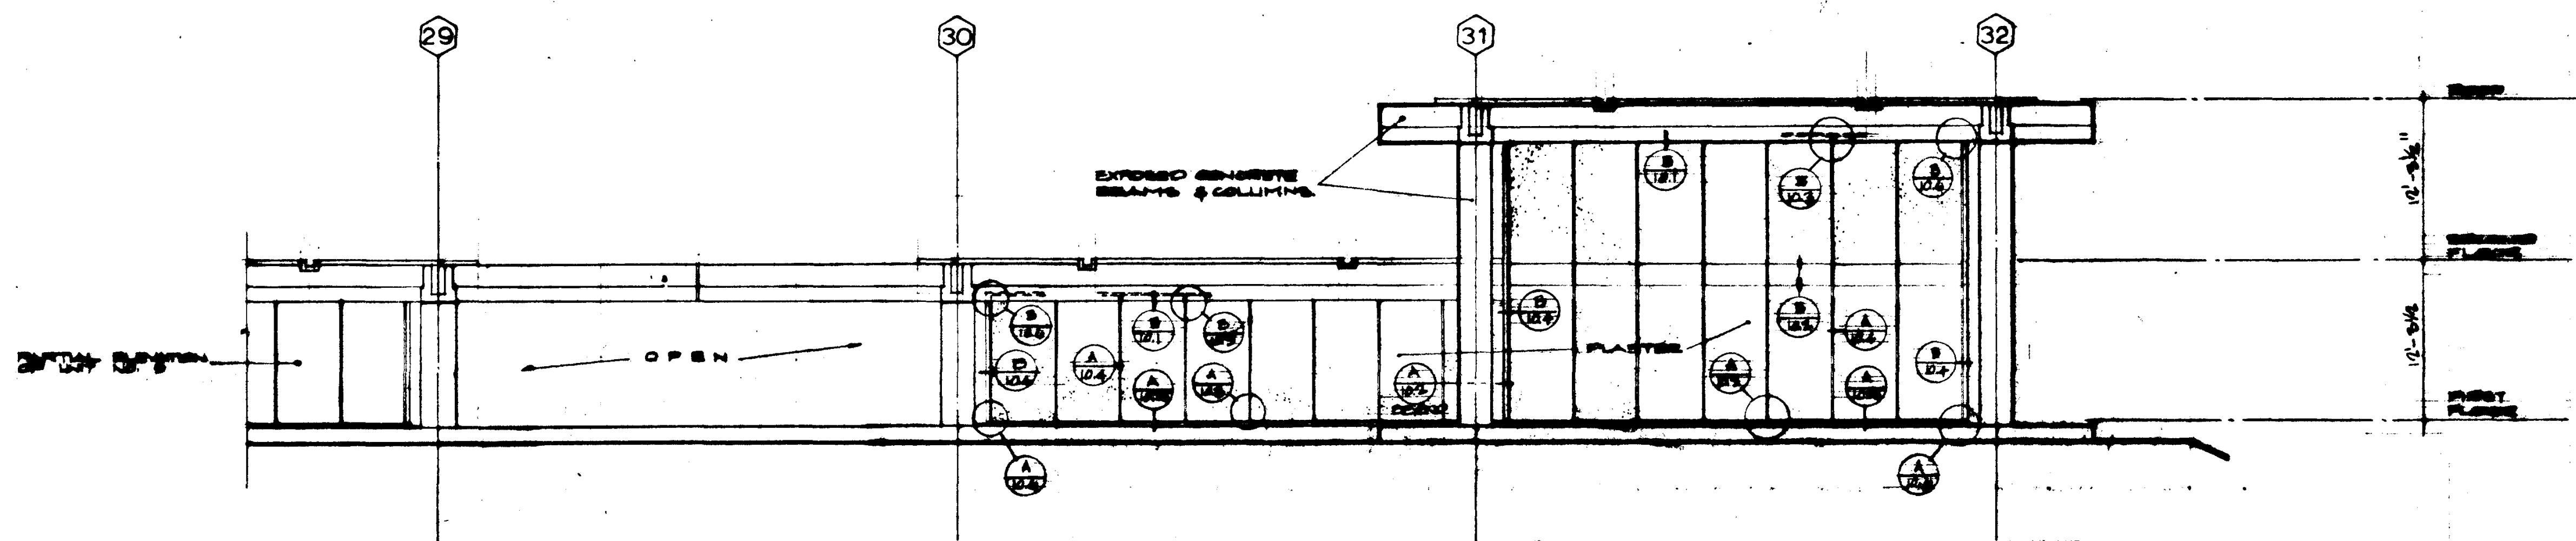


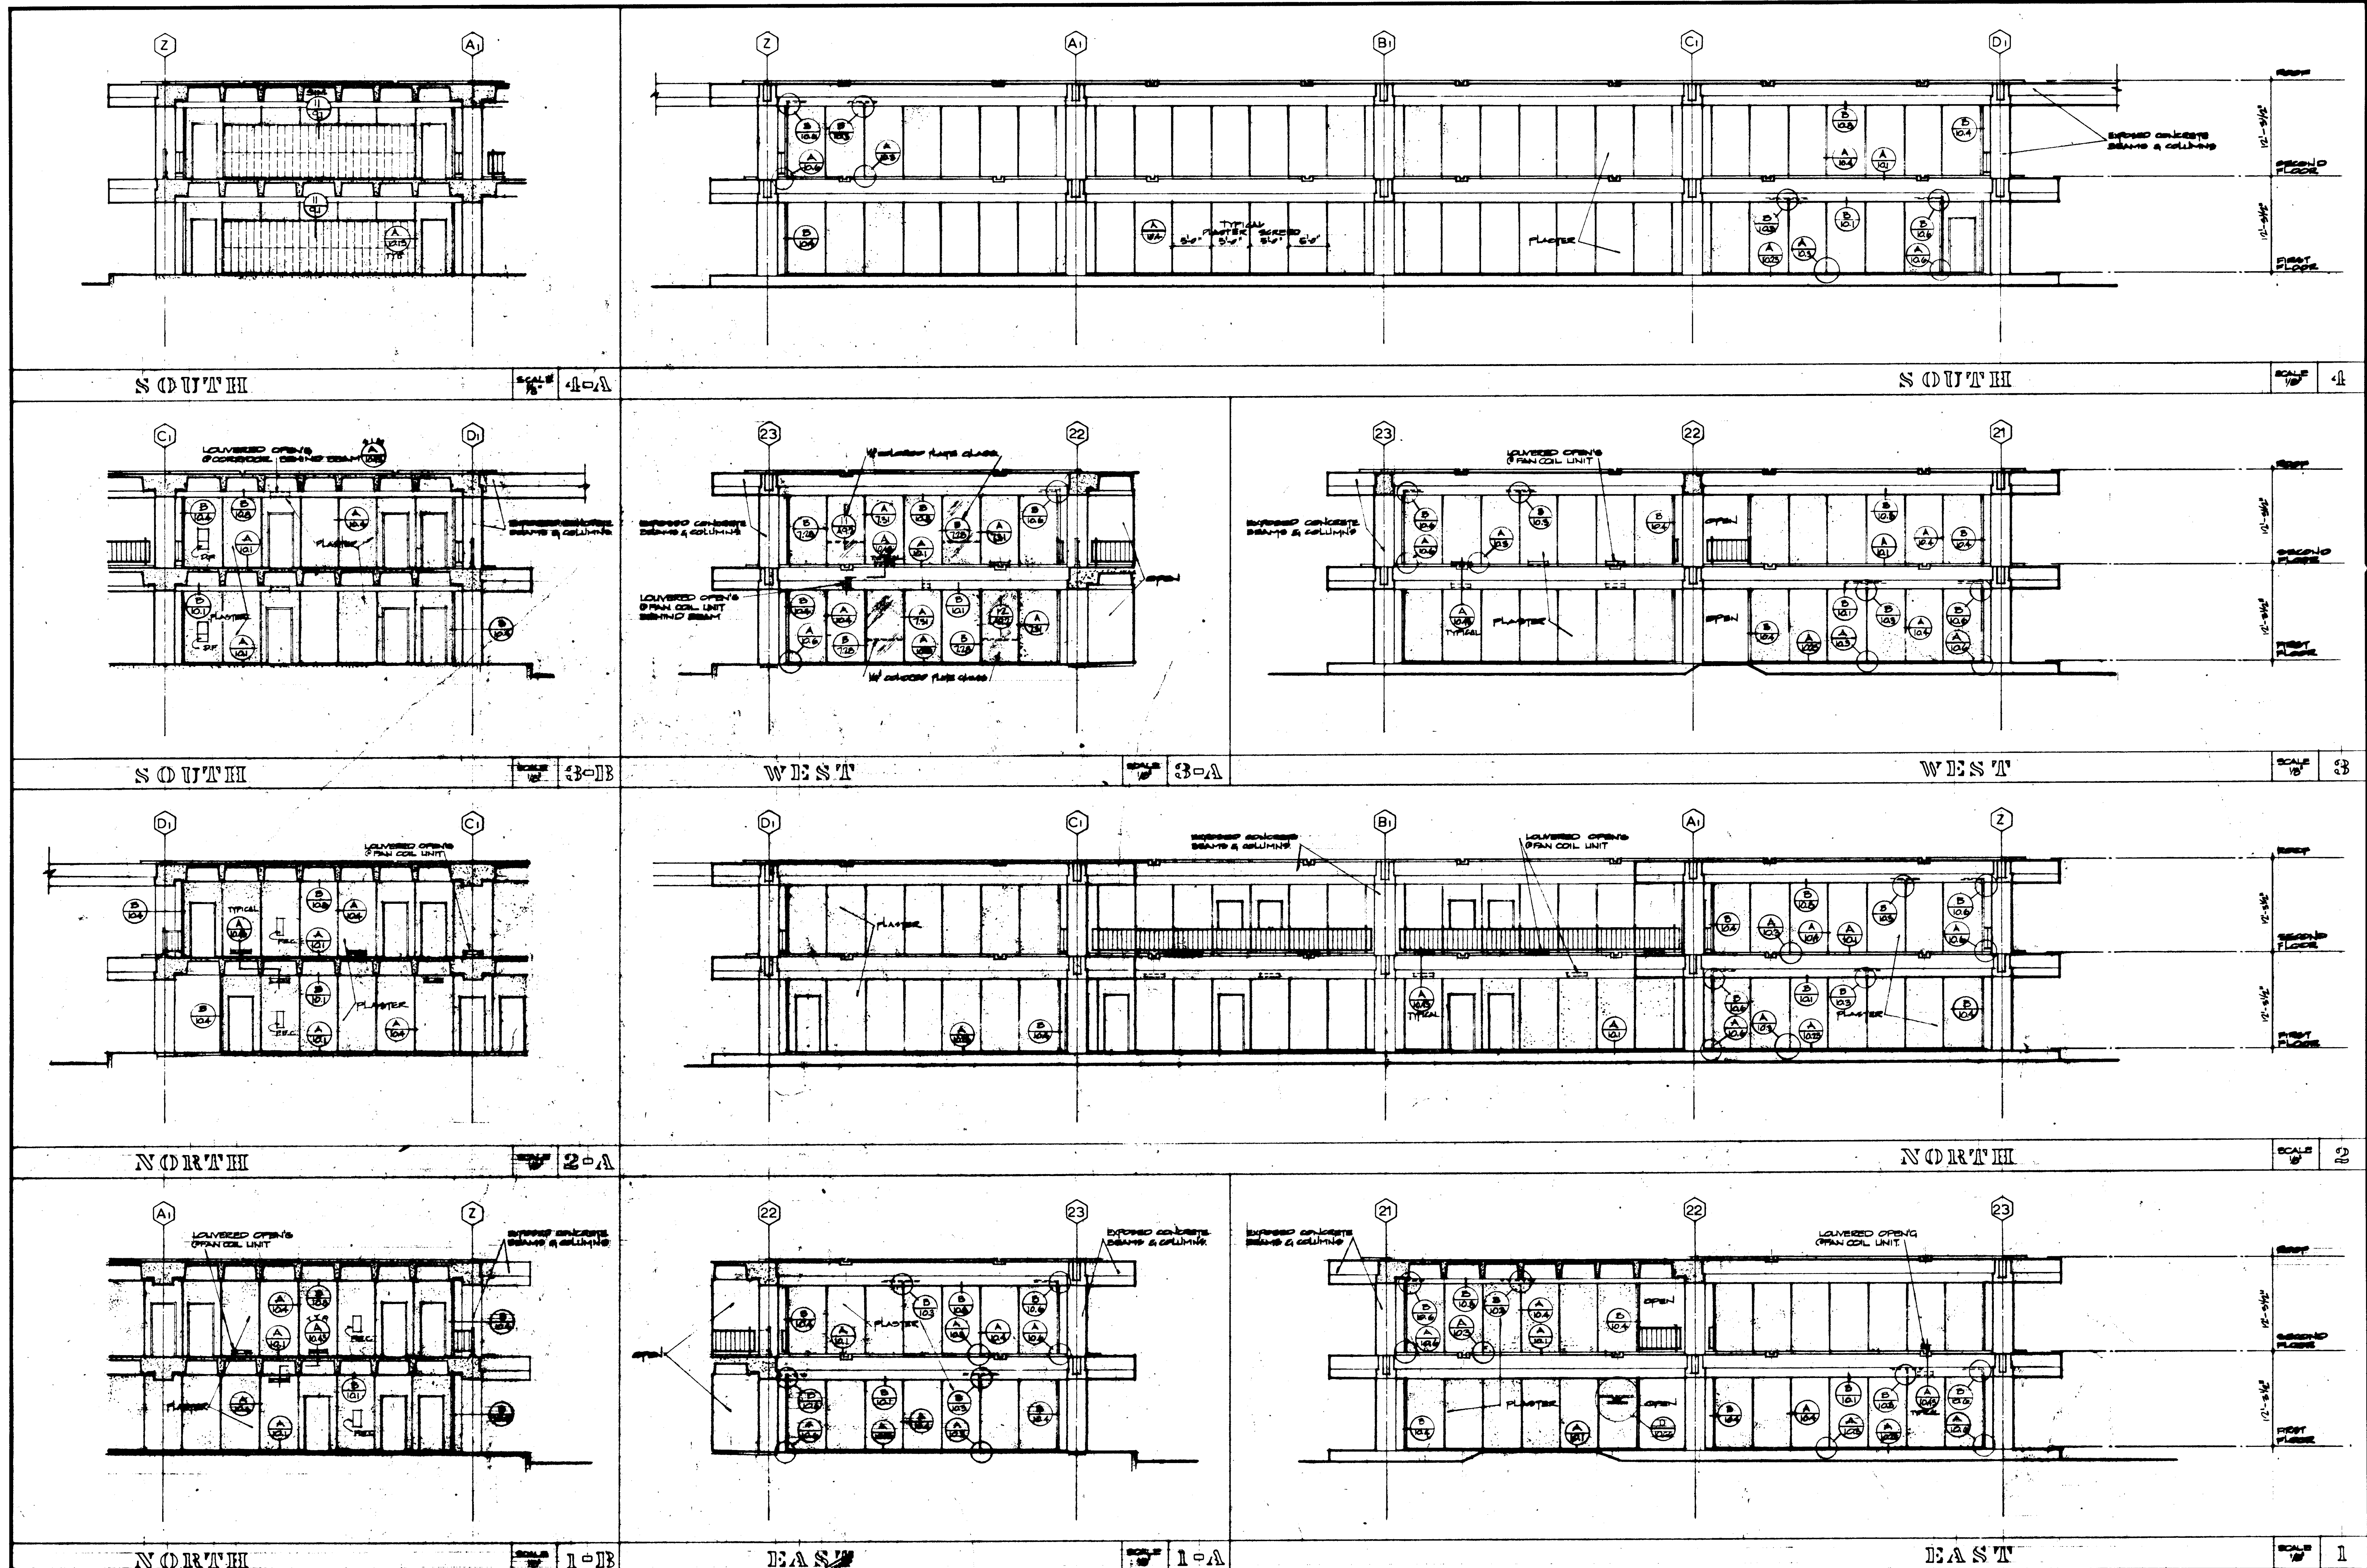STRUCTURAL ENGINEERS BRANDOW & JOHNSTON 11111 1/2 STREET, WEST HUNTINGTON BEACH, CALIF. 92648				DESIGNED BY J. A. MARTIN & ASSOCIATES 11111 1/2 STREET, WEST HUNTINGTON BEACH, CALIF. 92648				ARCHITECT WILLIAM L. PEREIRA & ASSOCIATES 11111 1/2 STREET, WEST HUNTINGTON BEACH, CALIF. 92648				APPROVED STATE FIRE MARSHAL DATE JUN 1965 25874 APPROVED JUN 21 1965				ASSOCIATED ARCHITECTS: A. QUINCY JONES-FREDERICK E. EMMONS & ASSOCIATES BLUROCK BLERBROOK & ASSOCIATES URBANUS SQUARE • MACARTHUR BOULEVARD AT FORD ROAD TELEPHONE 714/675-2640 • CORONA DEL MAR, CALIFORNIA				GOLDEN WEST COLLEGE HUNTINGTON BEACH, CALIFORNIA ORANGE COAST JUNIOR COLLEGE DISTRICT				UNIT 5 EXTERIOR ELEVATIONS				DATE 18 JUN 1965 SHEET NO. A 55				SCALE 1/8" = 1'-0"				1			
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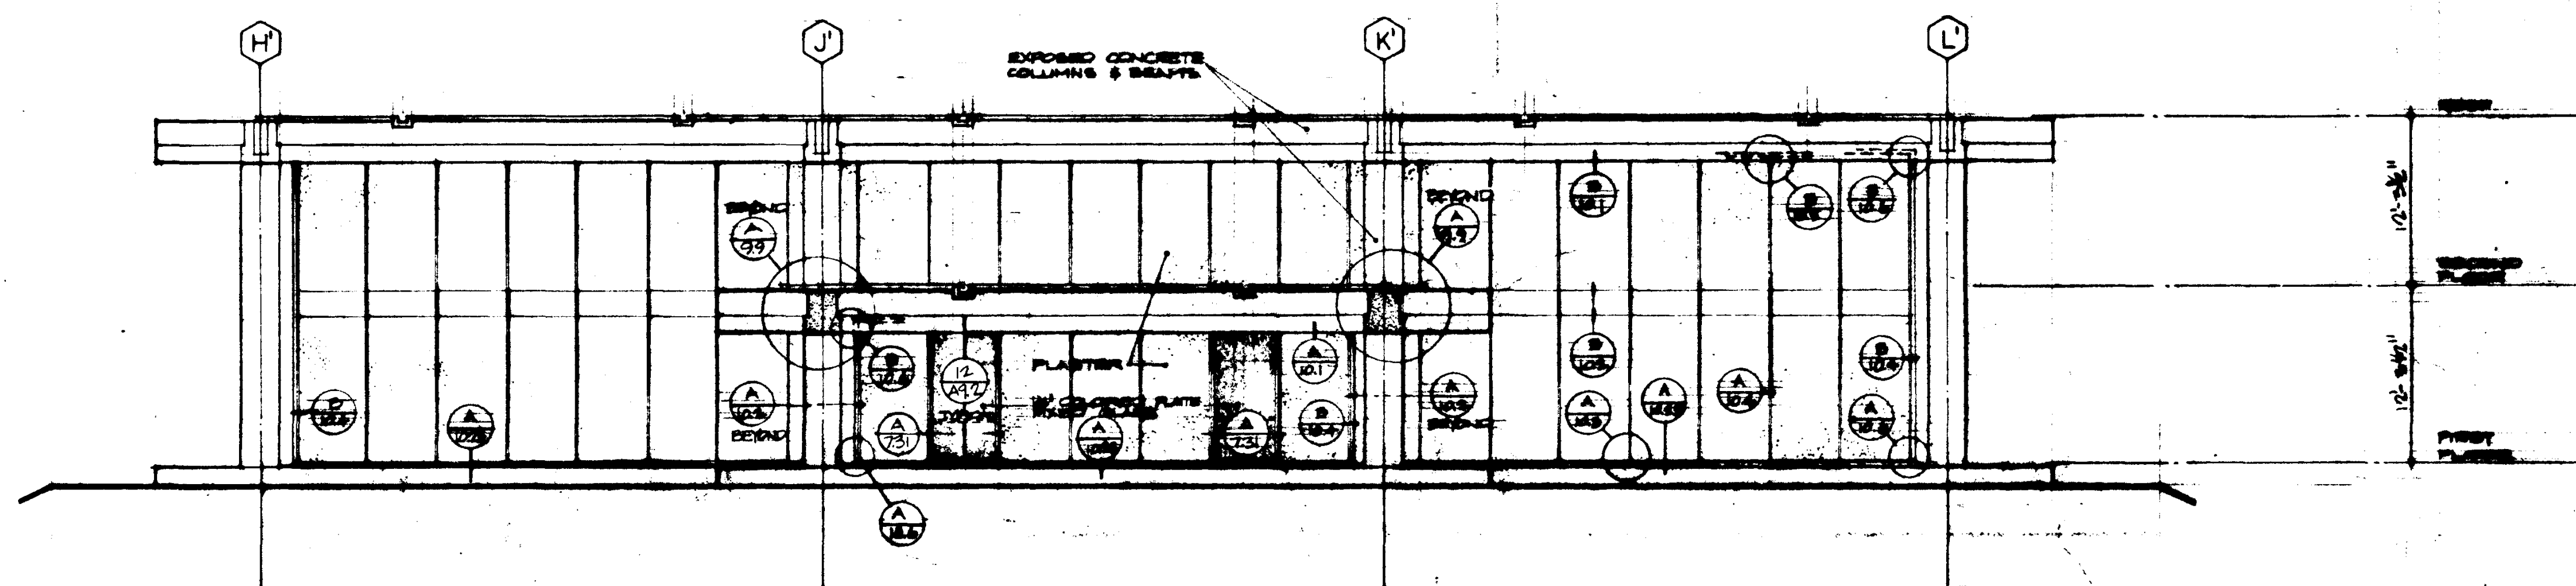
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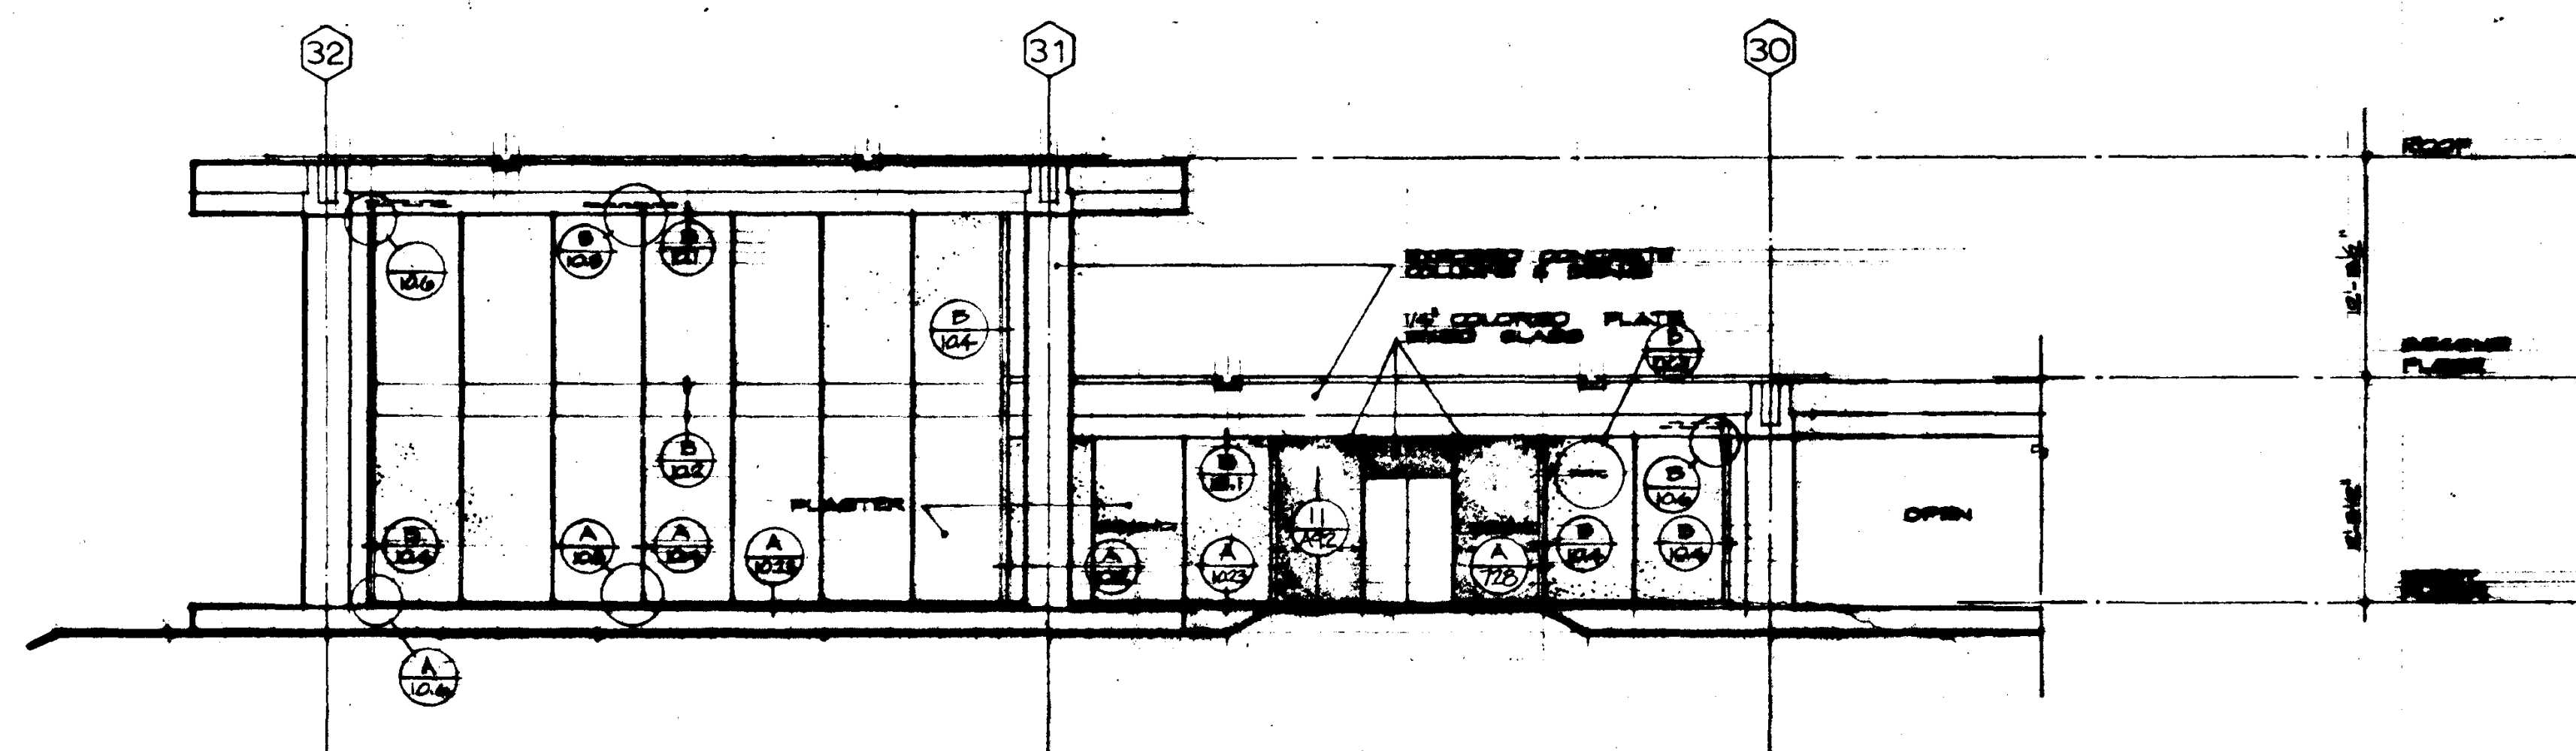
EAST

SCALE 1/8" = 1'-0"

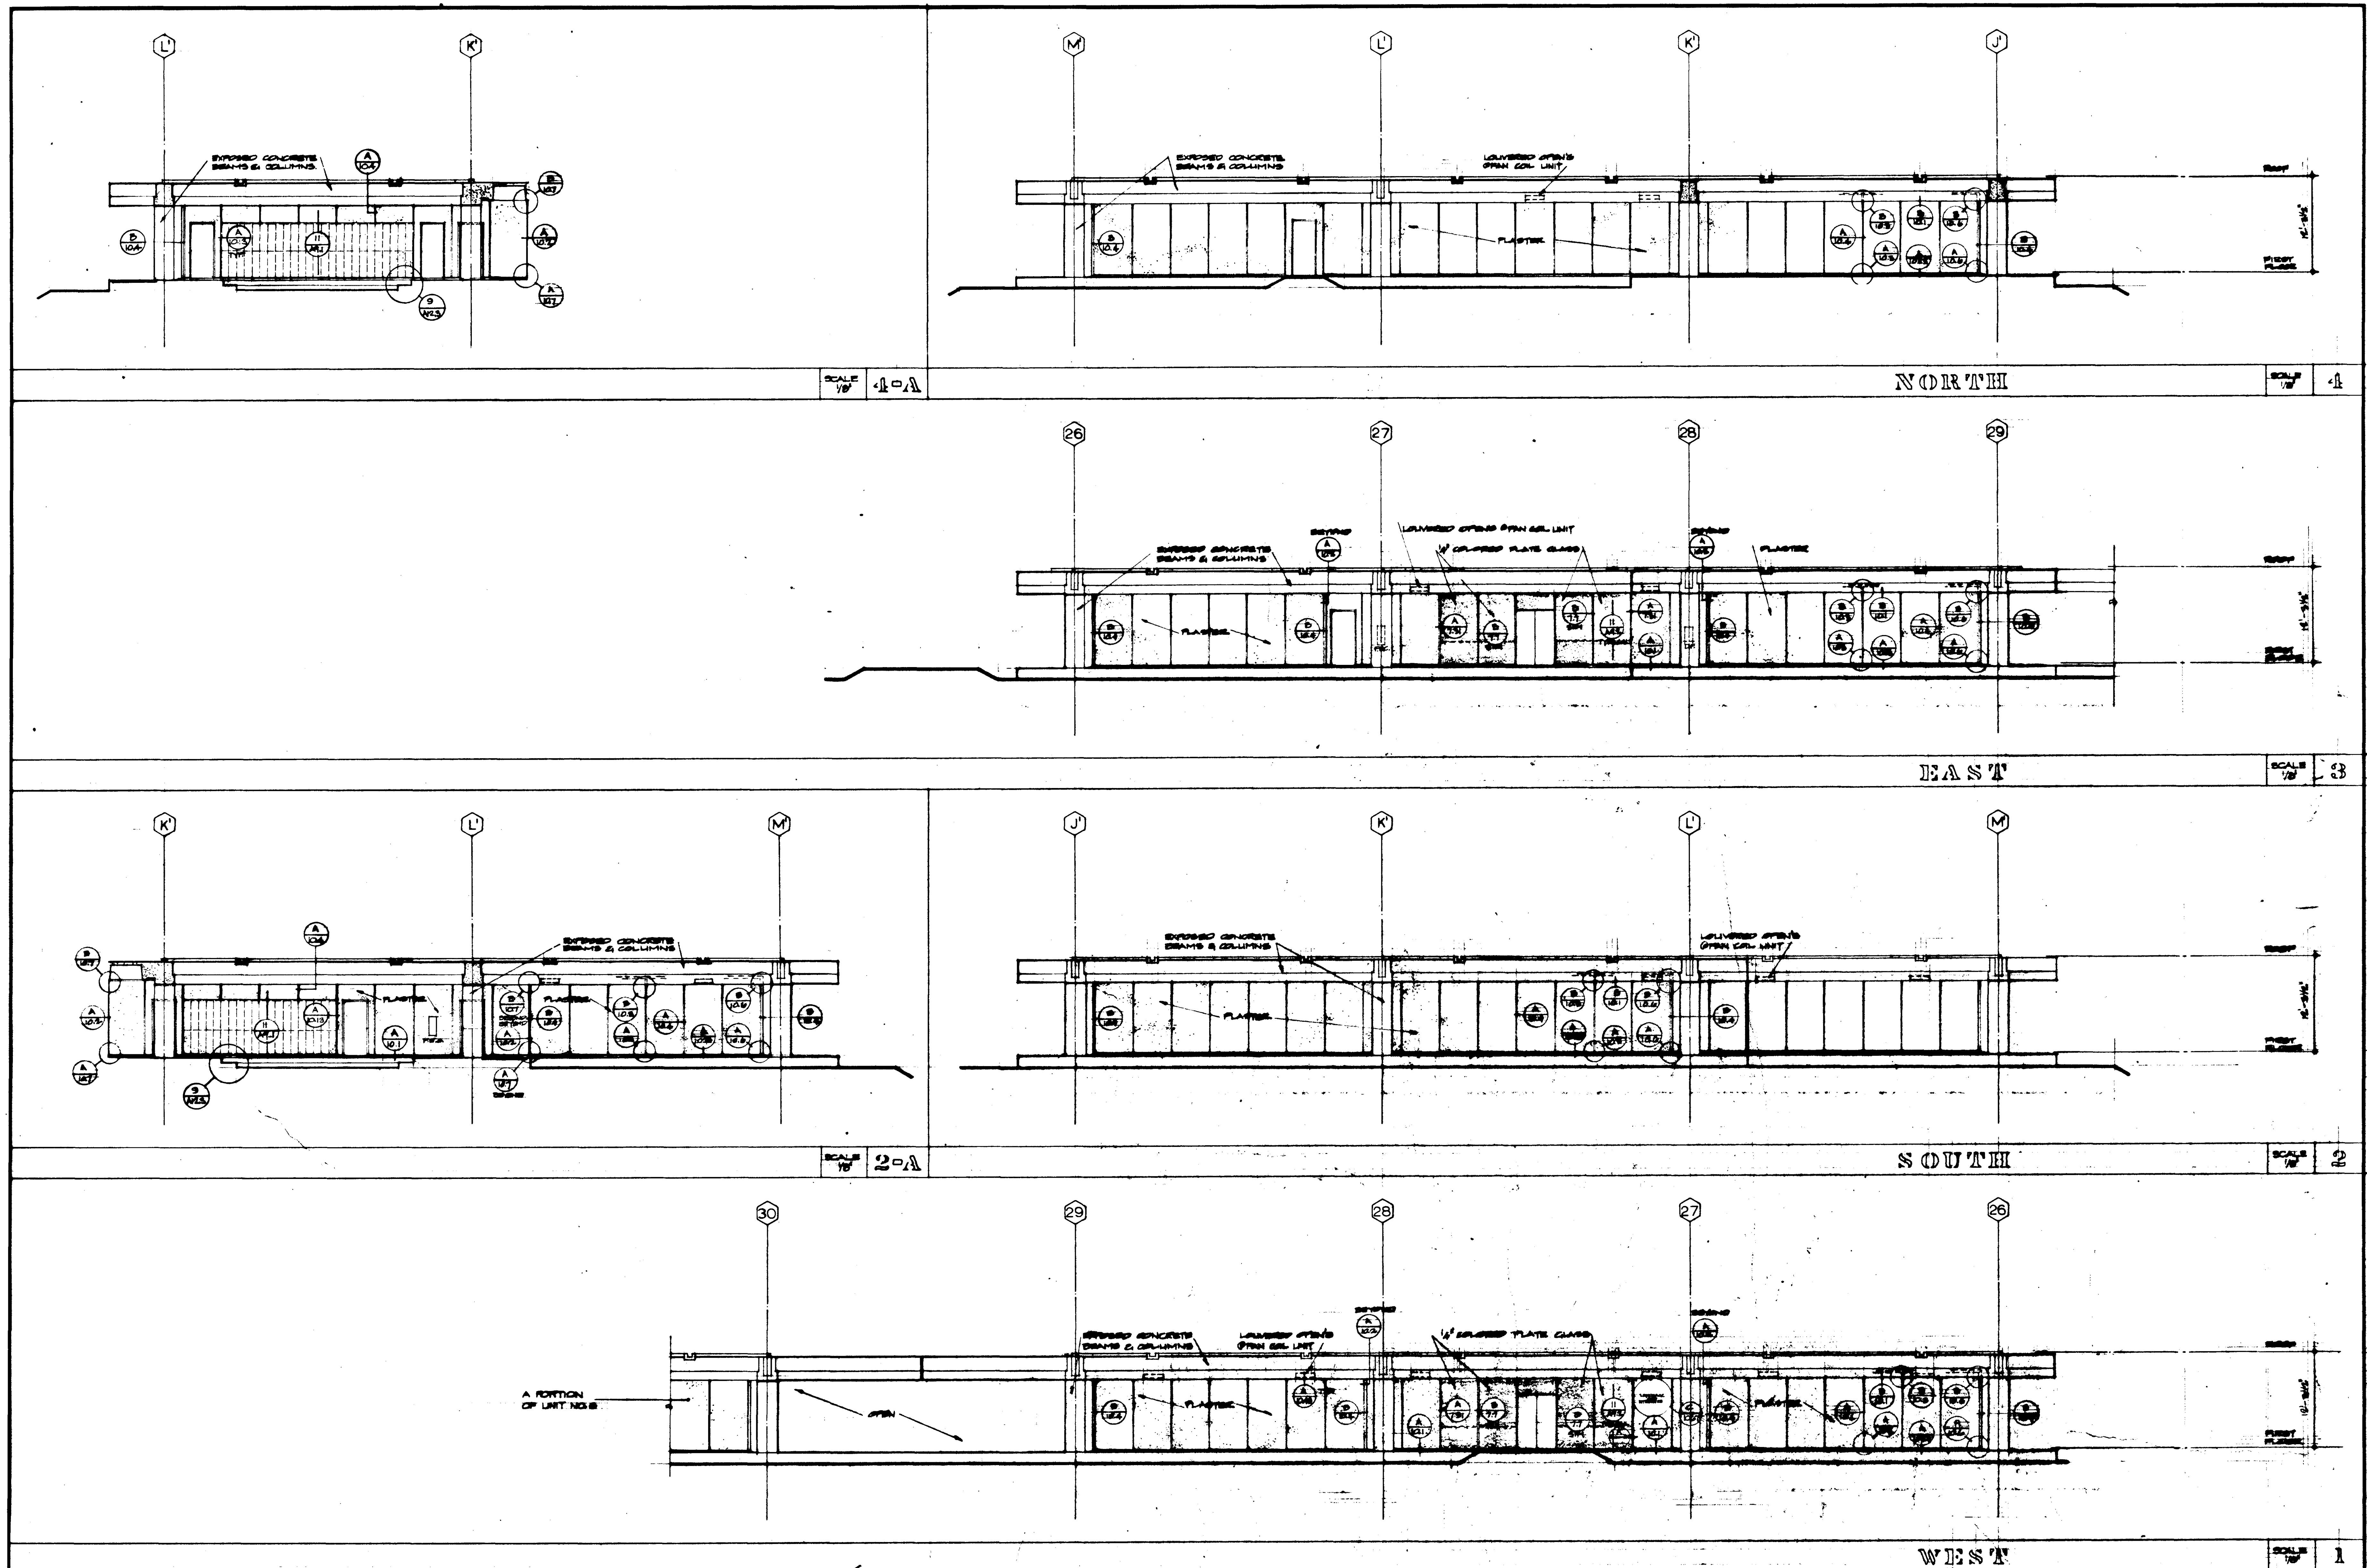

SOUTH


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WEST


SCALE 1/8" = 1'-0"

<p>REVISIONS</p>	<p>STRUCTURAL ENGINEERS BRANDOW & JOHNSTON J.A. MARTIN & ASSOCIATES</p> <p>MECHANICAL ENGINEERS RALPH E. PHILLIPS, INC.</p> <p>ELECTRICAL ENGINEERS RALPH E. PHILLIPS, INC.</p> <p>CIVIL ENGINEERS G. SHURMAN & ASSOCIATES MOFFATT & NICHOL</p>	<p>DESIGNED DRAWN BY CHECKED BY</p>	<p>ARCHITECT ENGINEER COLLGE</p>	<p>APPROVED STATE FIRE MARSHAL STATE OF CALIFORNIA DATE: JUN 21 1965</p> <p>25874 APPROVED JUN 21 1965</p>	<p>ASSOCIATED ARCHITECTS: WILLIAM L. PEREIRA & ASSOCIATES A. QUINCY JONES-FREDERICK E. EMMONS & ASSOCIATES BLUROCK ELLERBROOK & ASSOCIATES</p> <p>URBANUS SQUARE • MACARTHUR BOULEVARD AT FORD ROAD TELEPHONE 714/675-2640 • CORONA DEL MAR, CALIFORNIA</p>	<p>GOLDEN WEST COLLEGE HUNTINGTON BEACH, CALIFORNIA ORANGE COAST JUNIOR COLLEGE DISTRICT</p>	<p>UNIT C EXTERIOR ELEVATIONS</p> <p>JUN 1965 SHEET NO. A 54</p>
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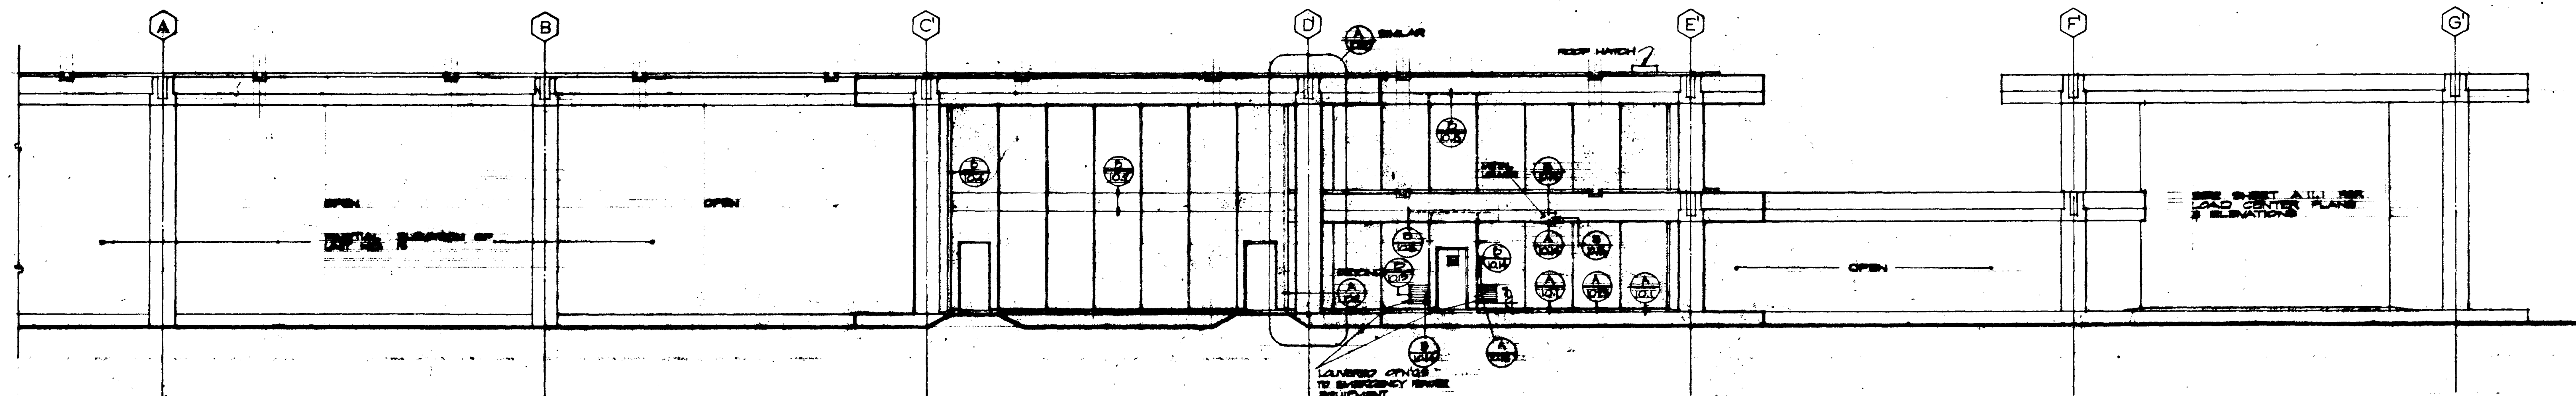
NORTH

SCALE 1/8" = 1'

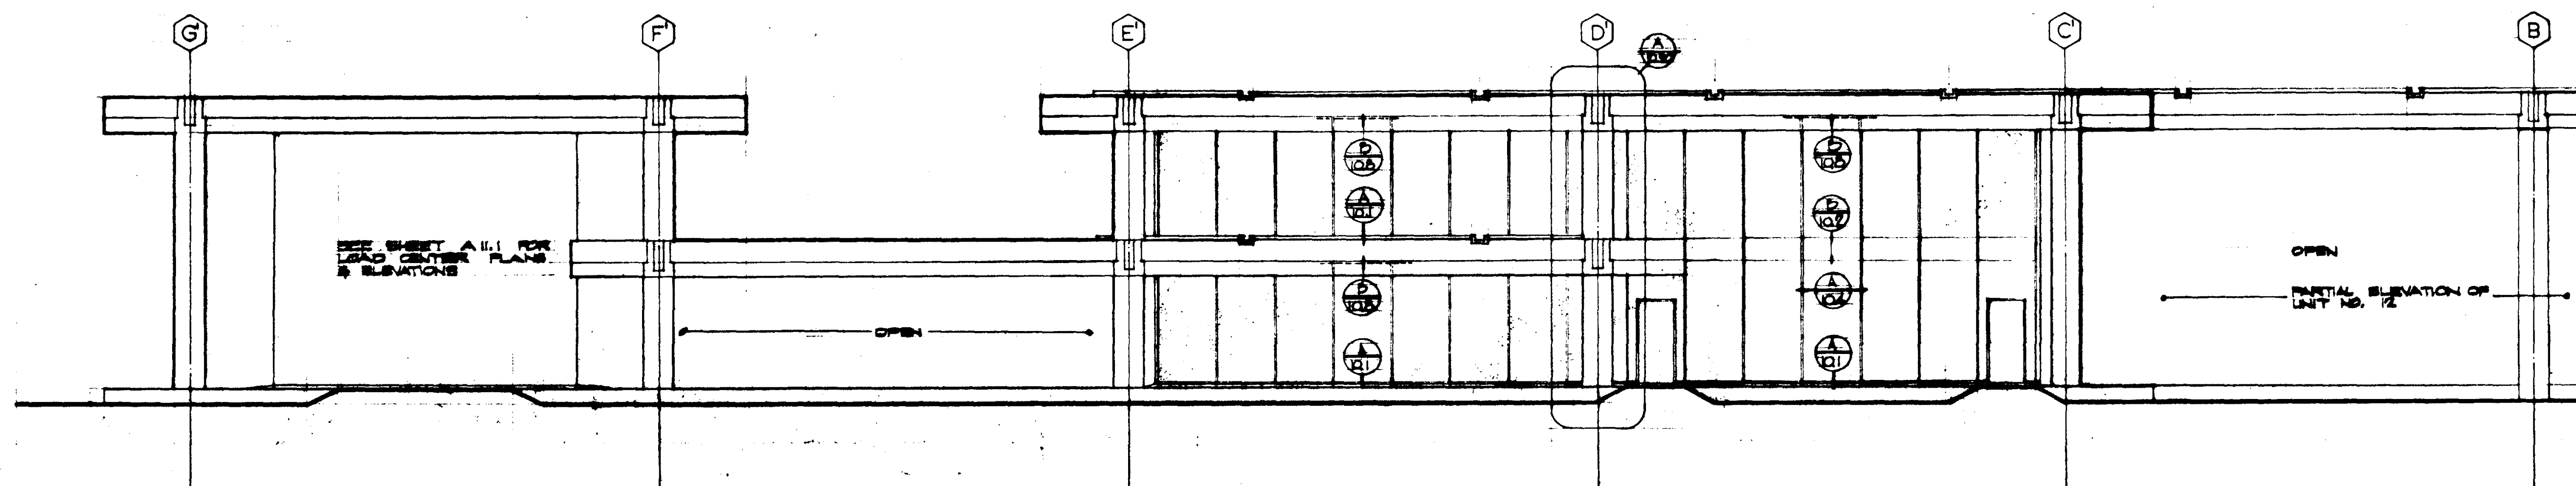


EAST
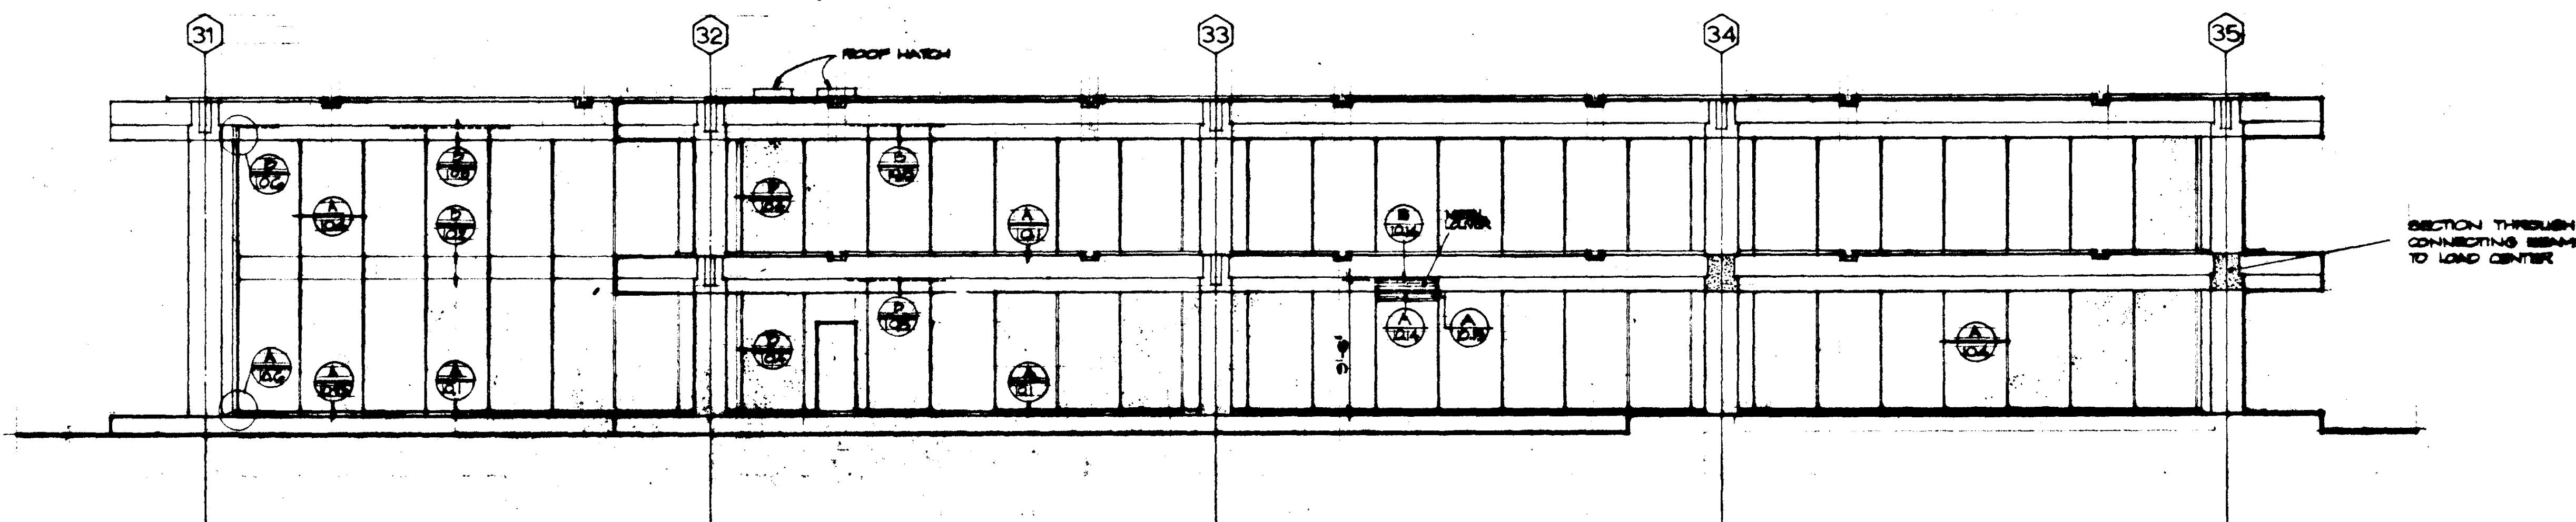
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SOUTH


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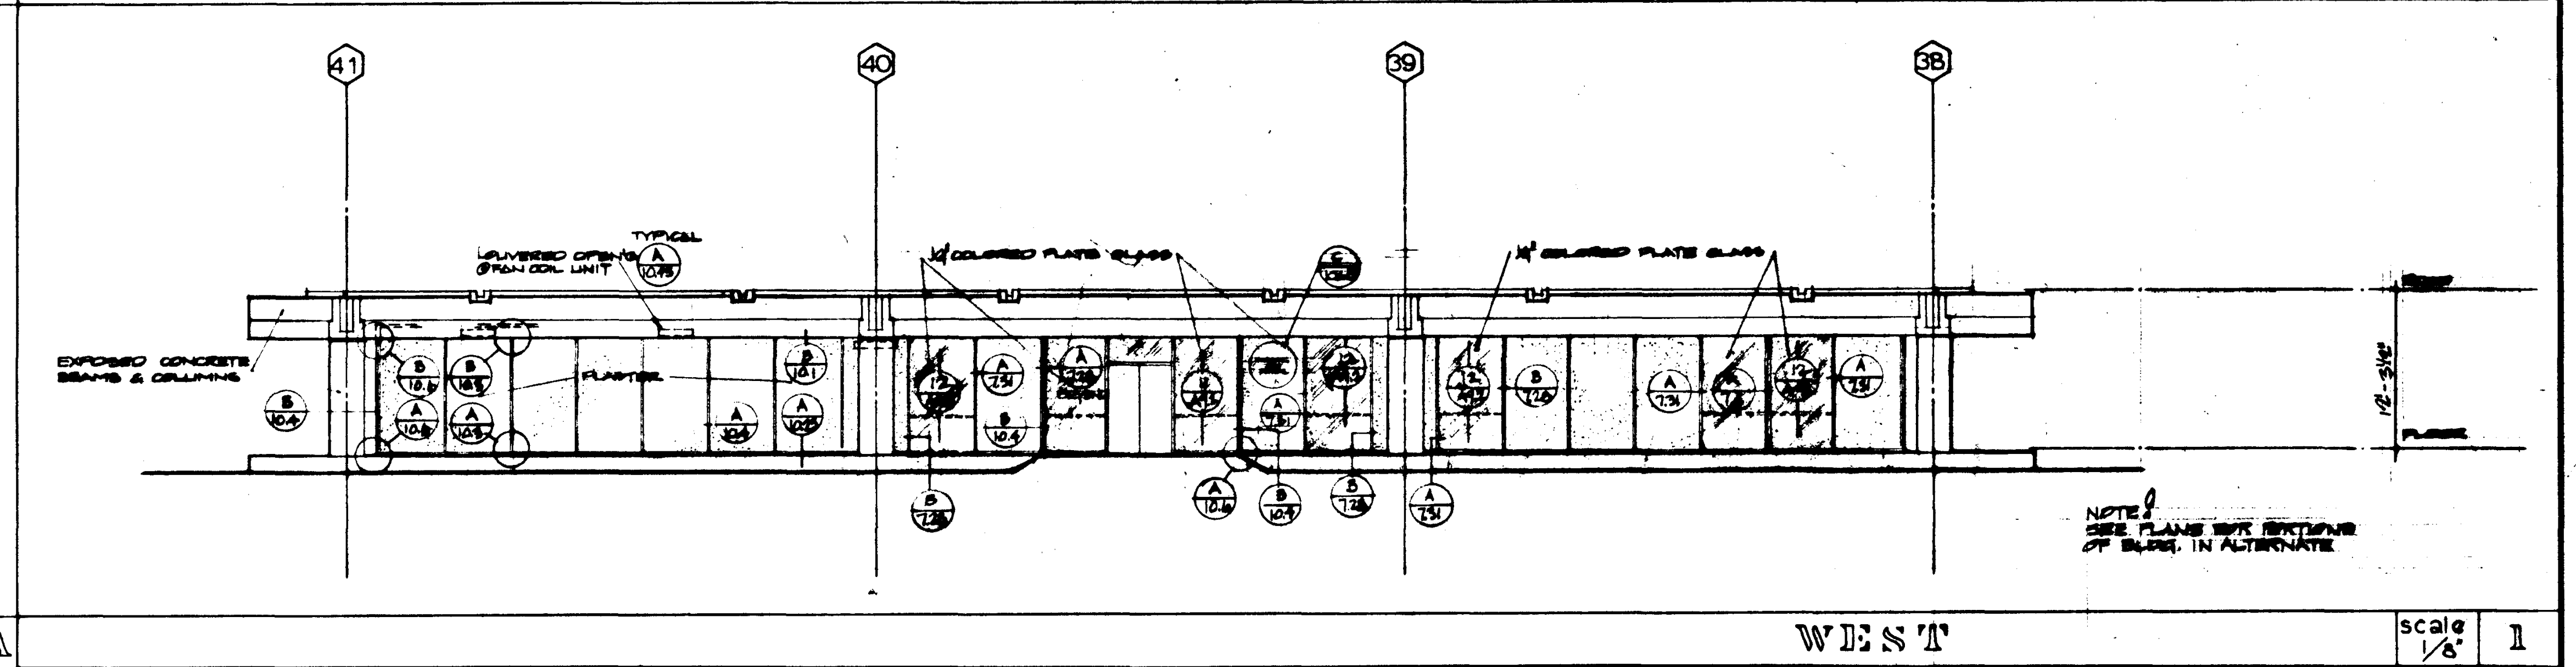
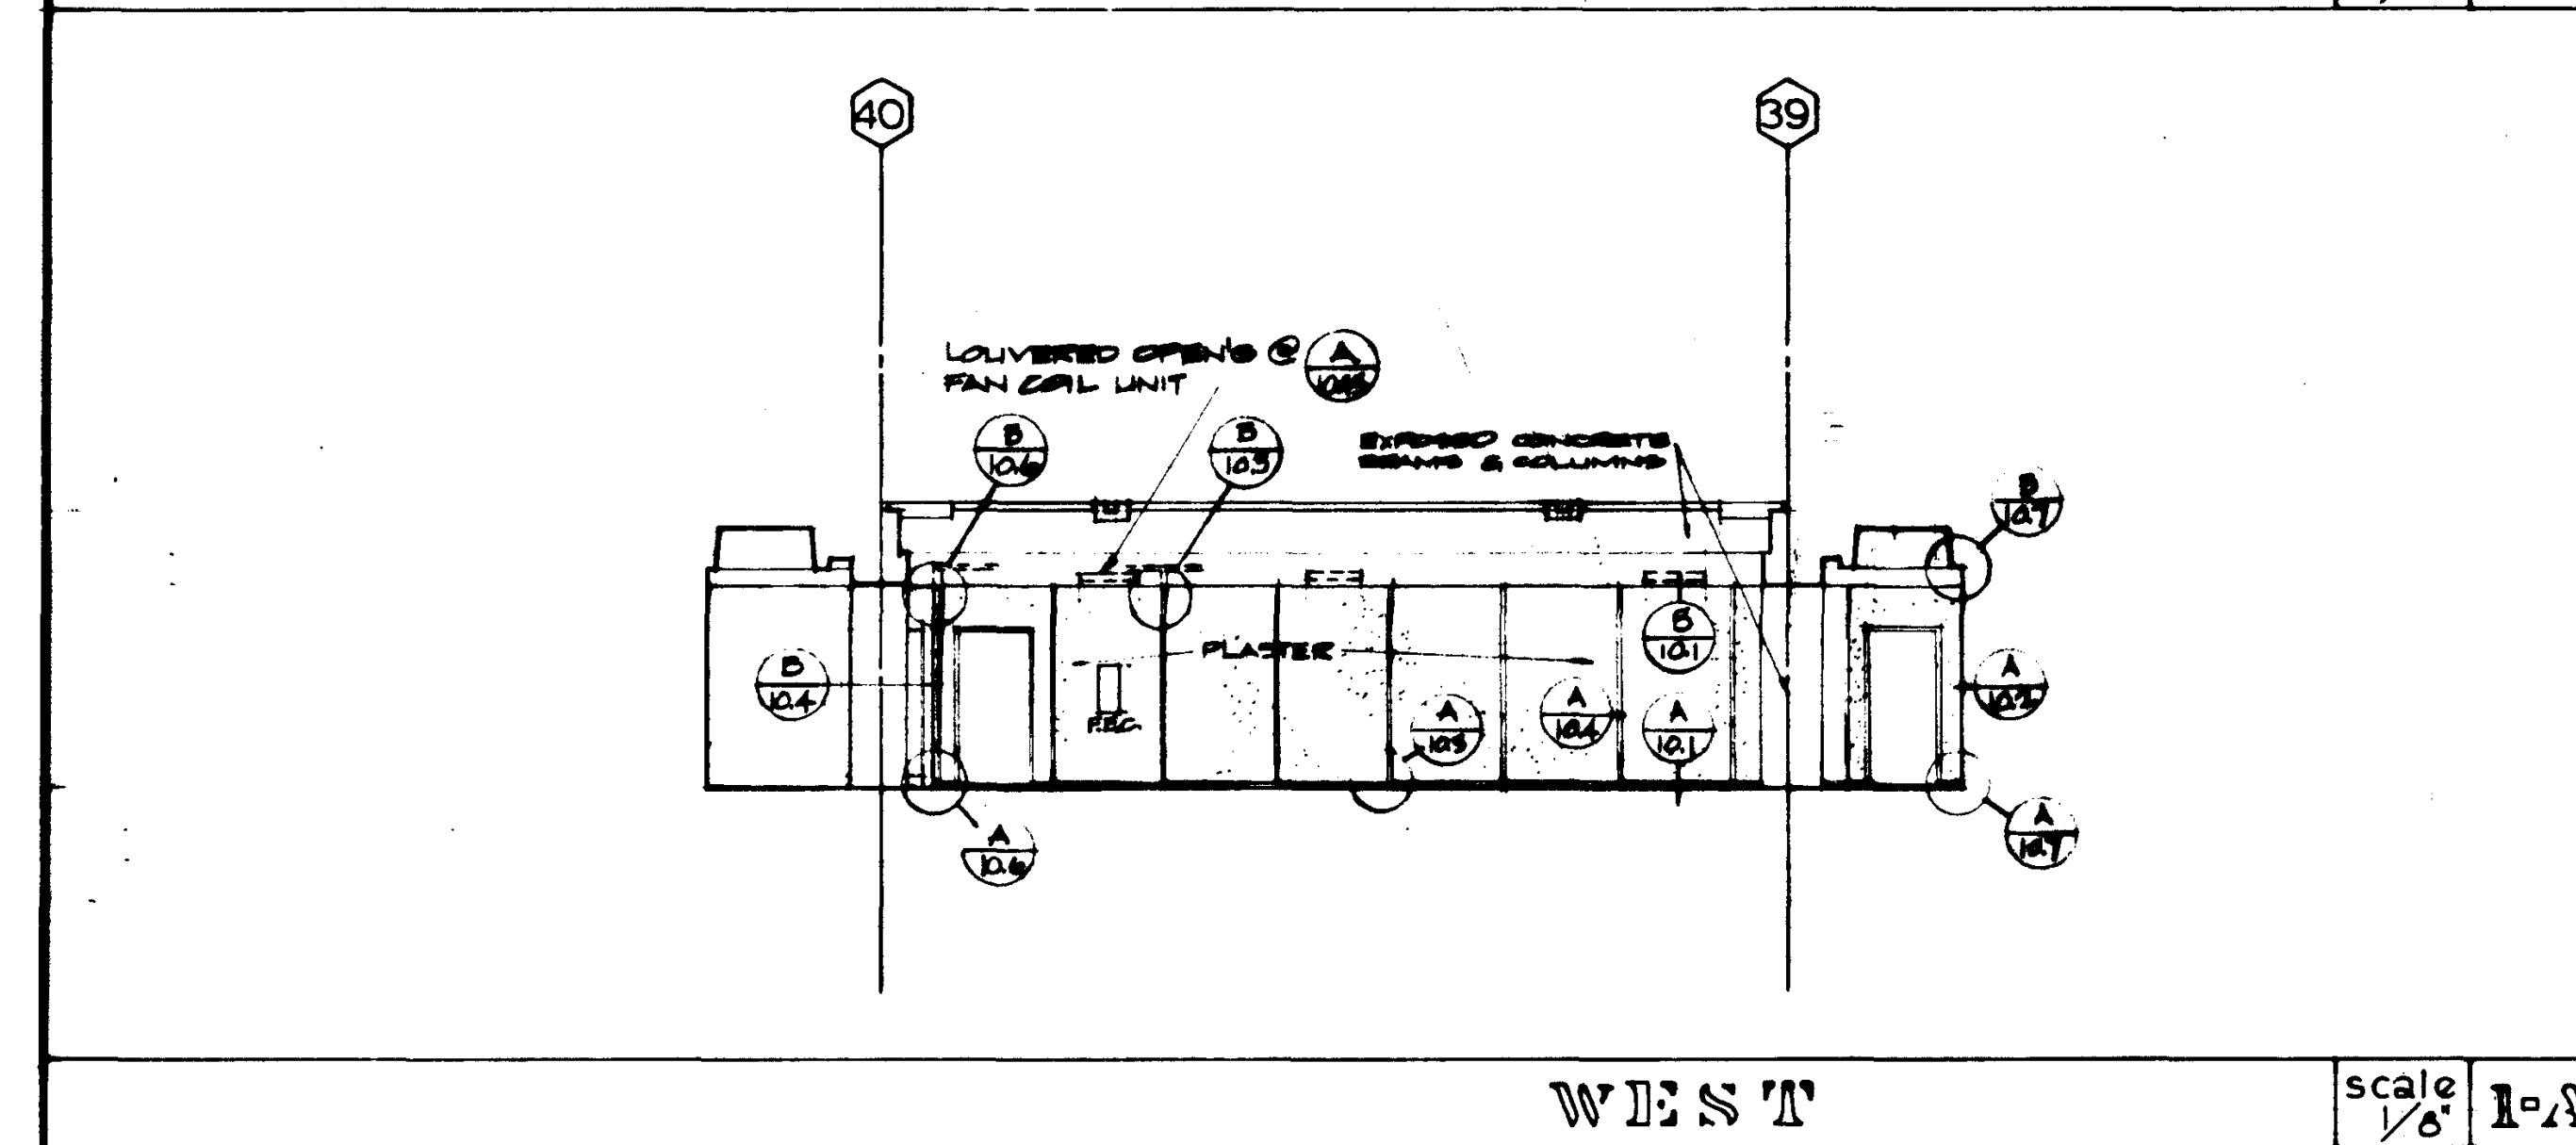
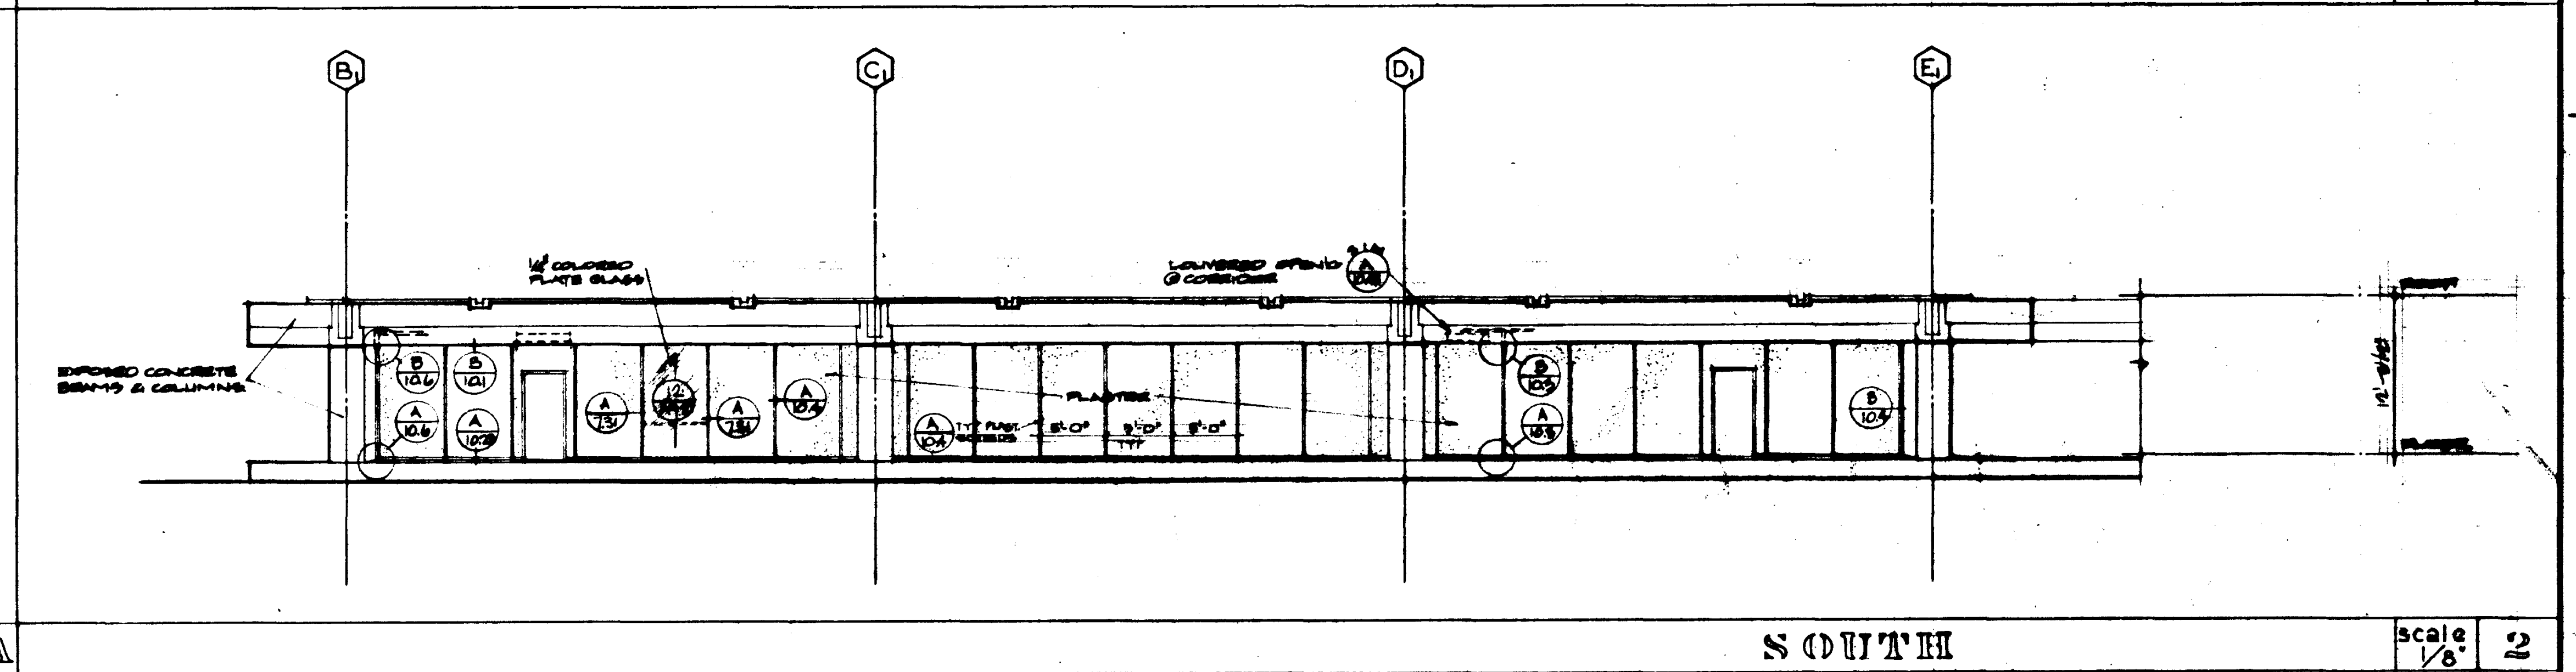
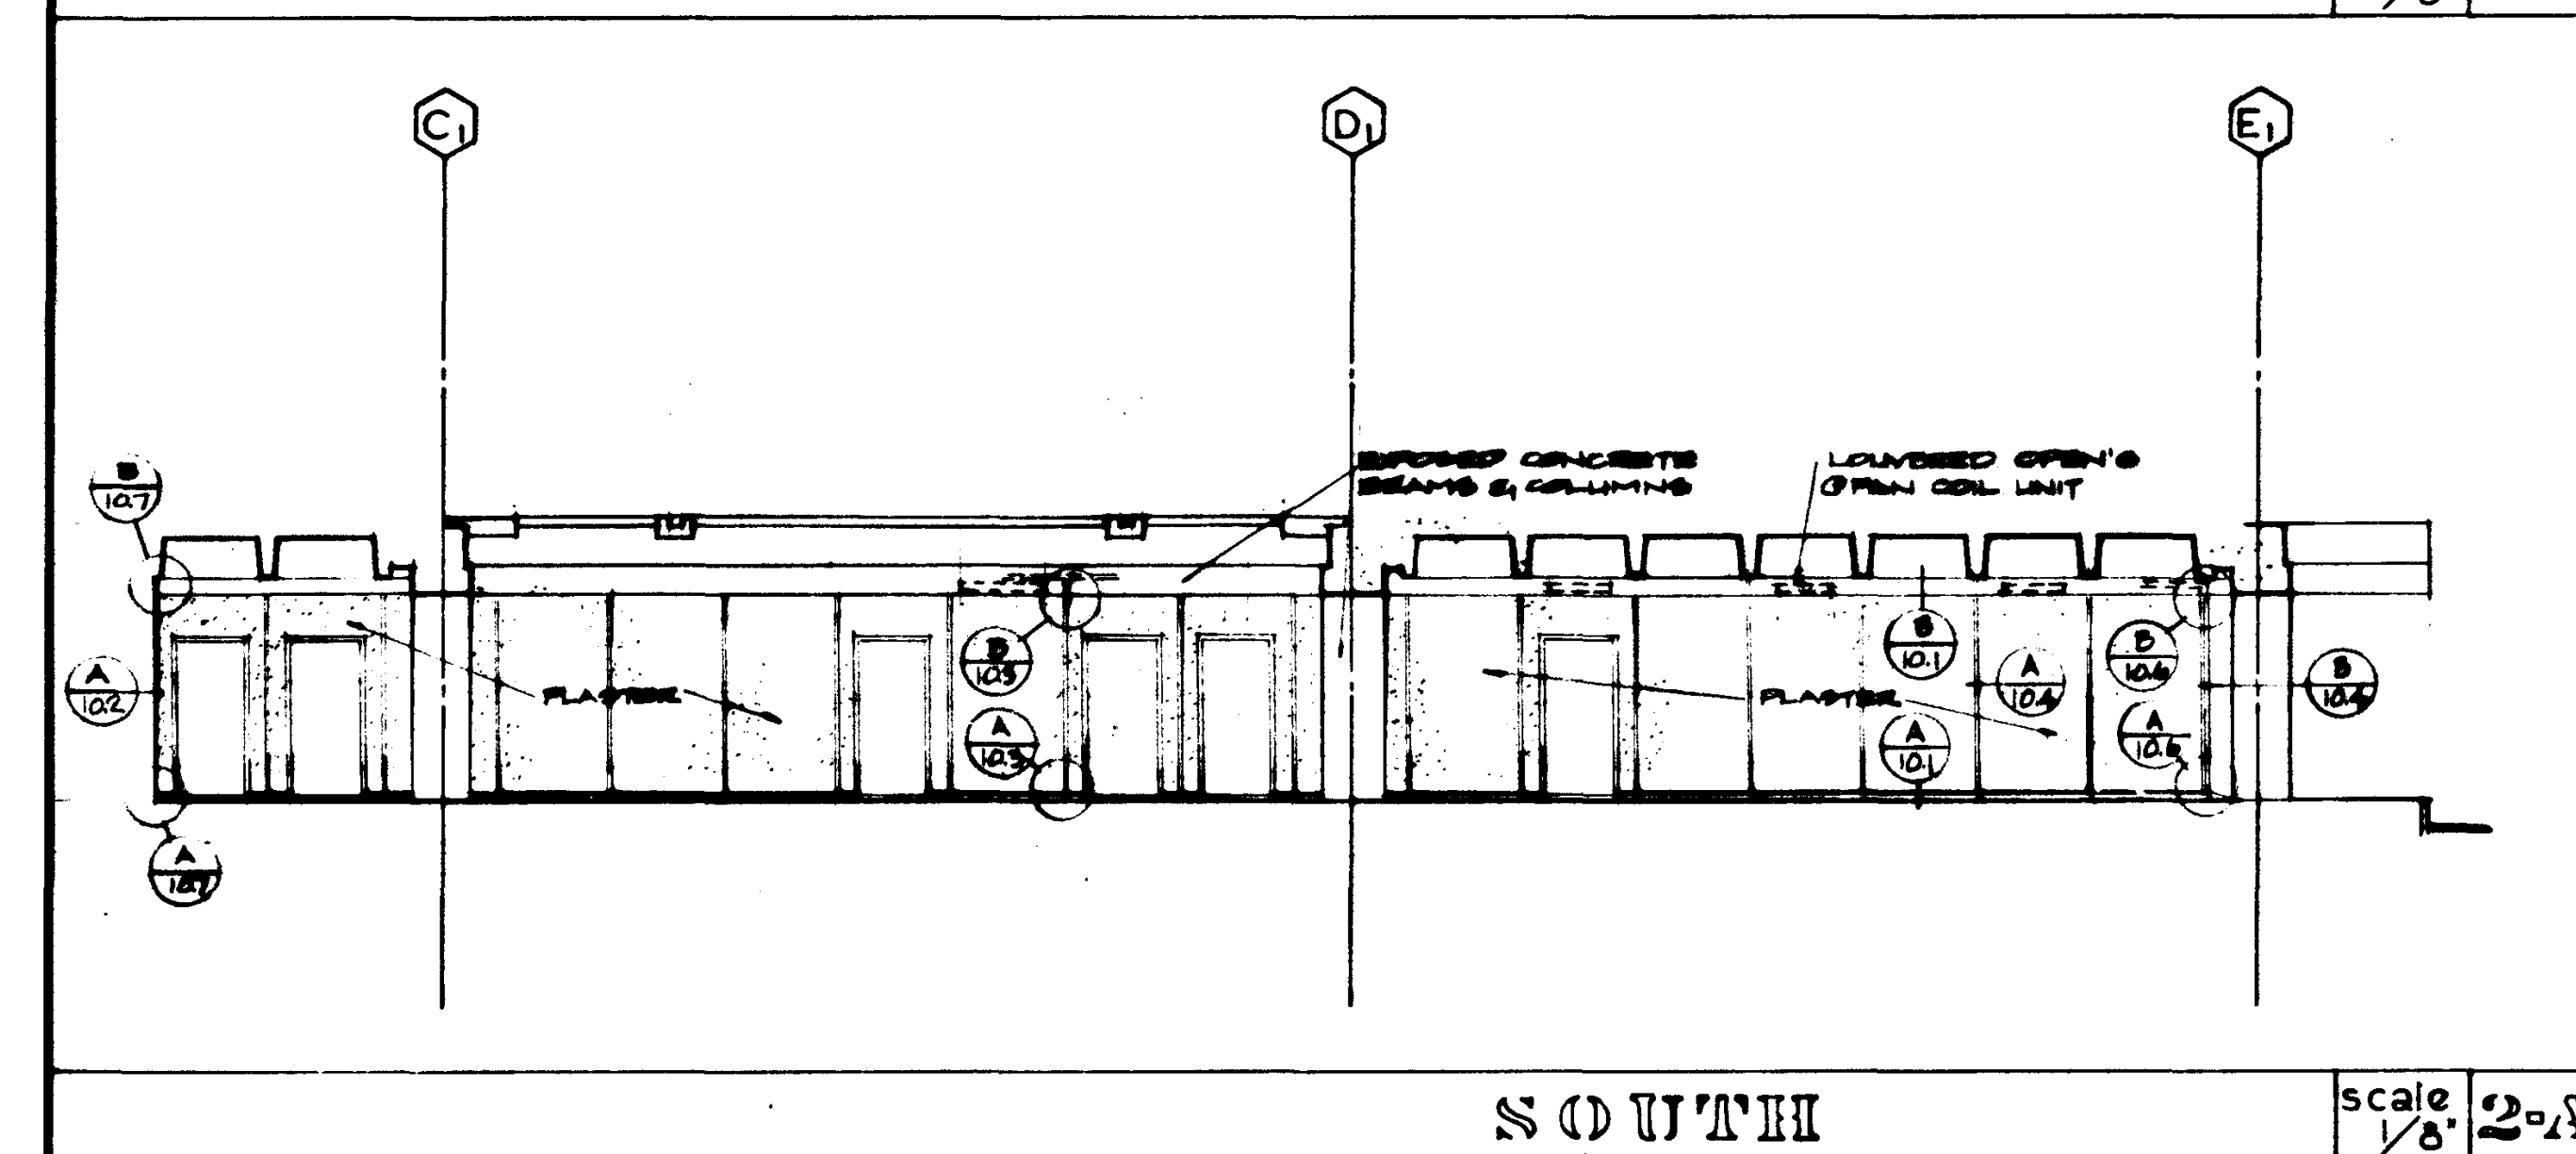
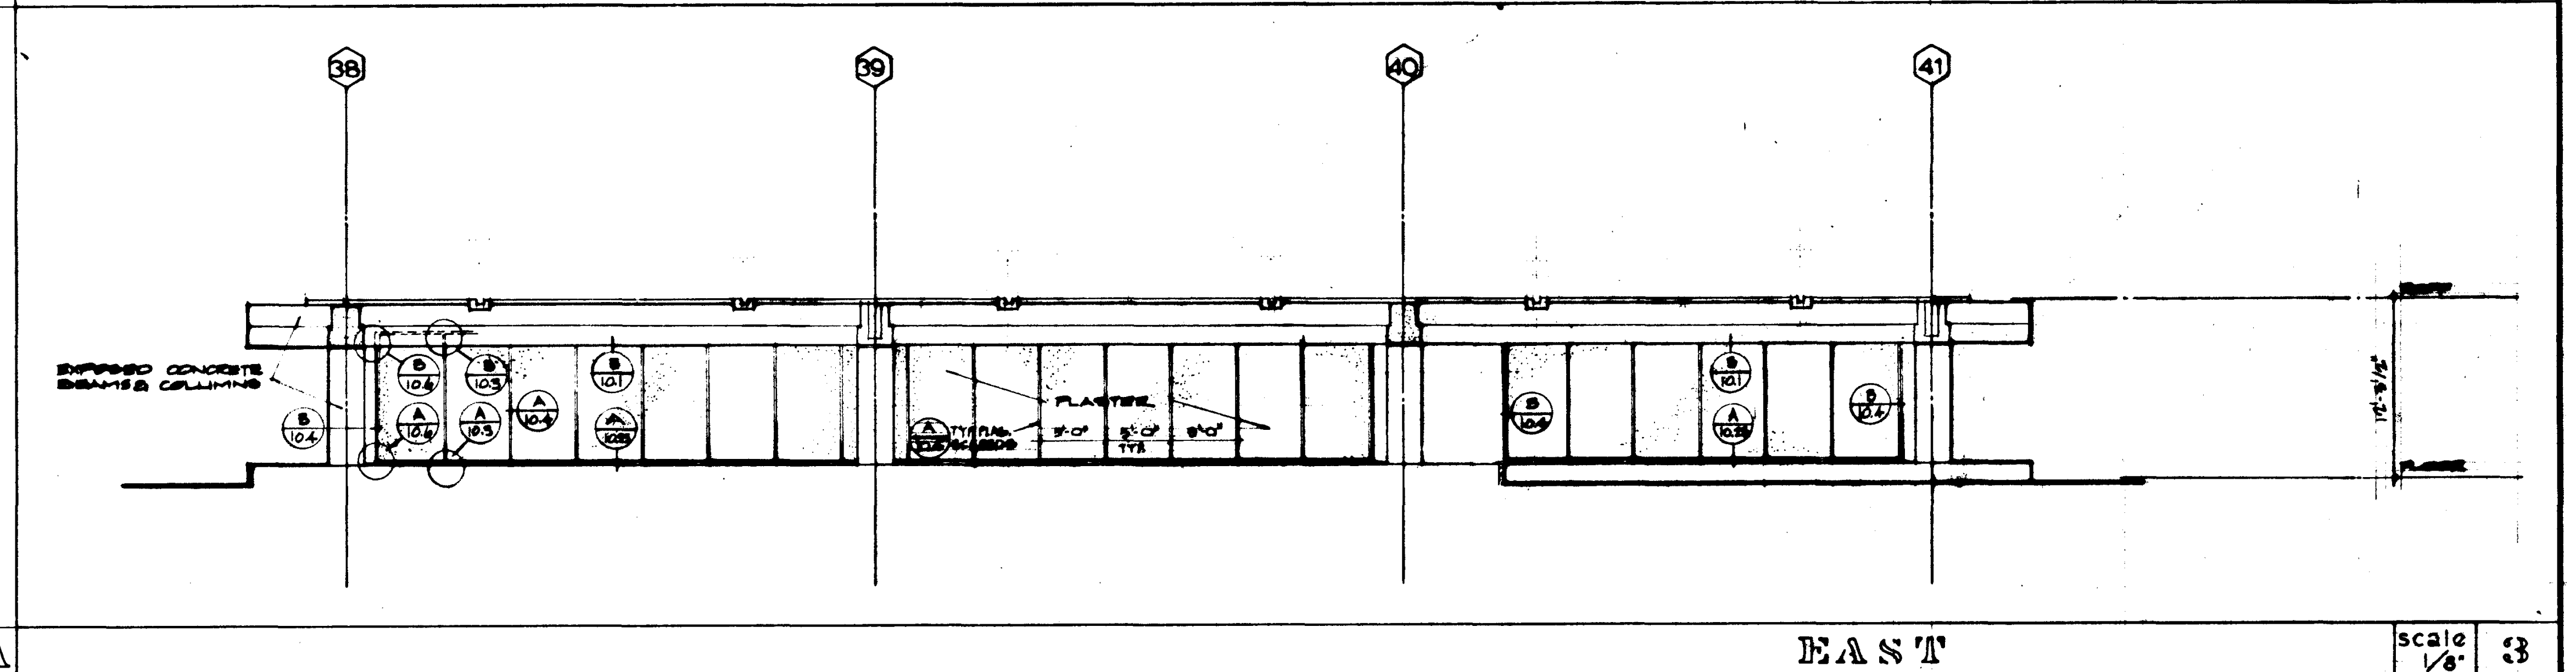
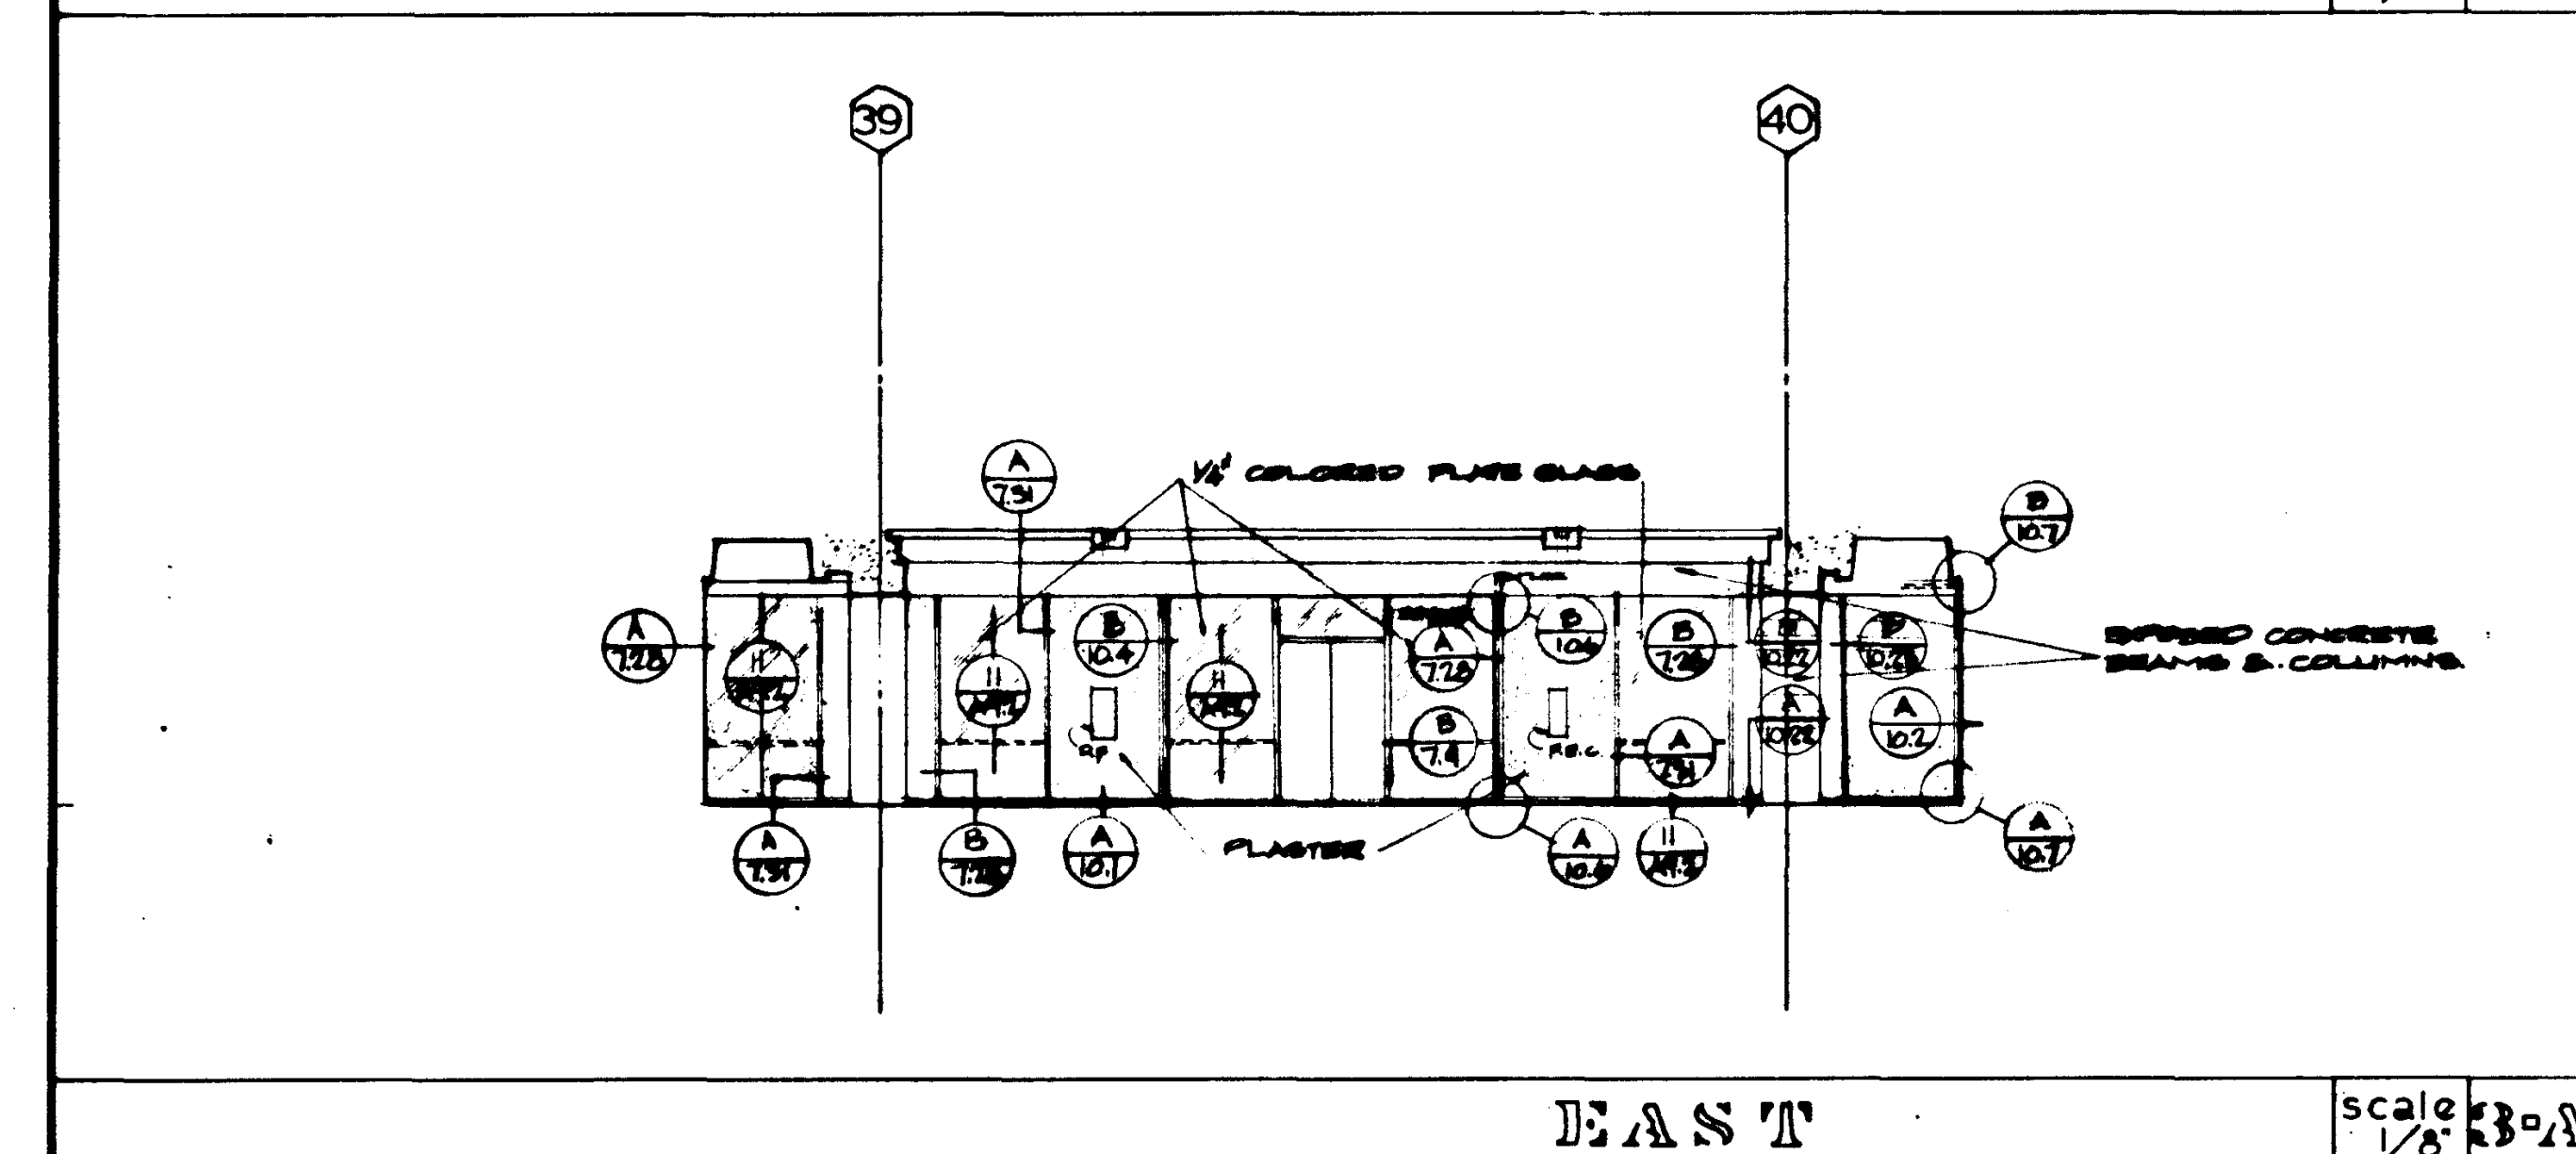
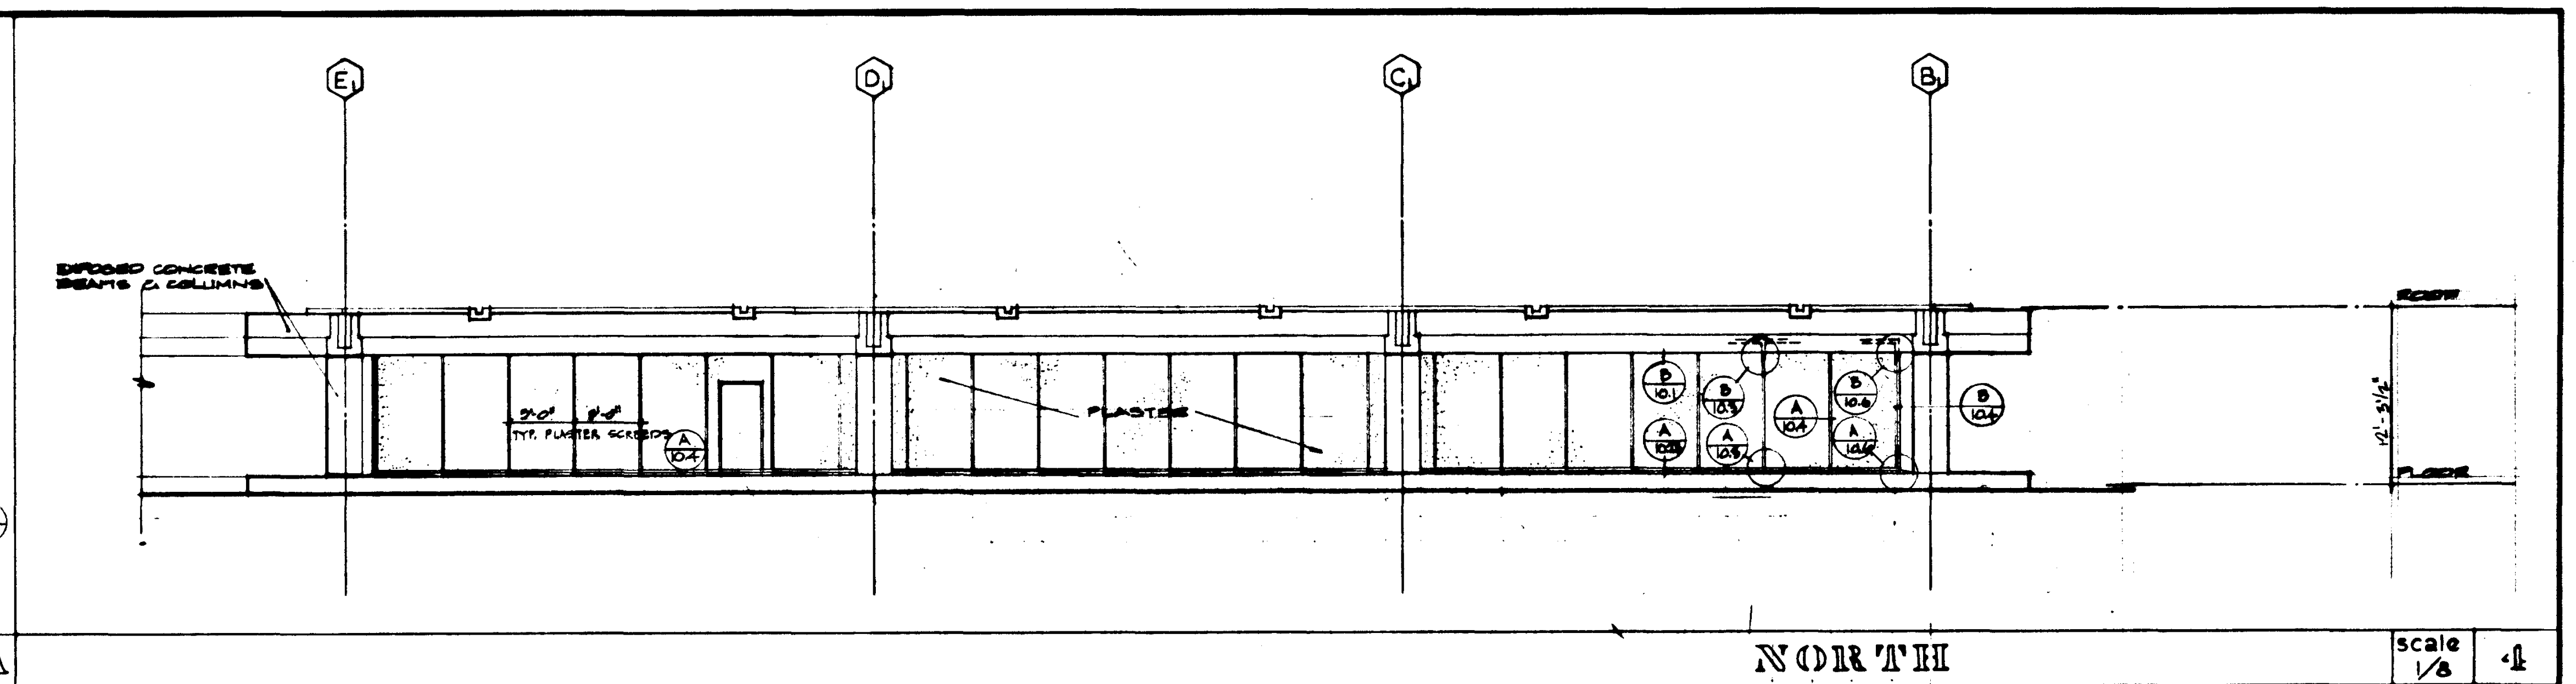
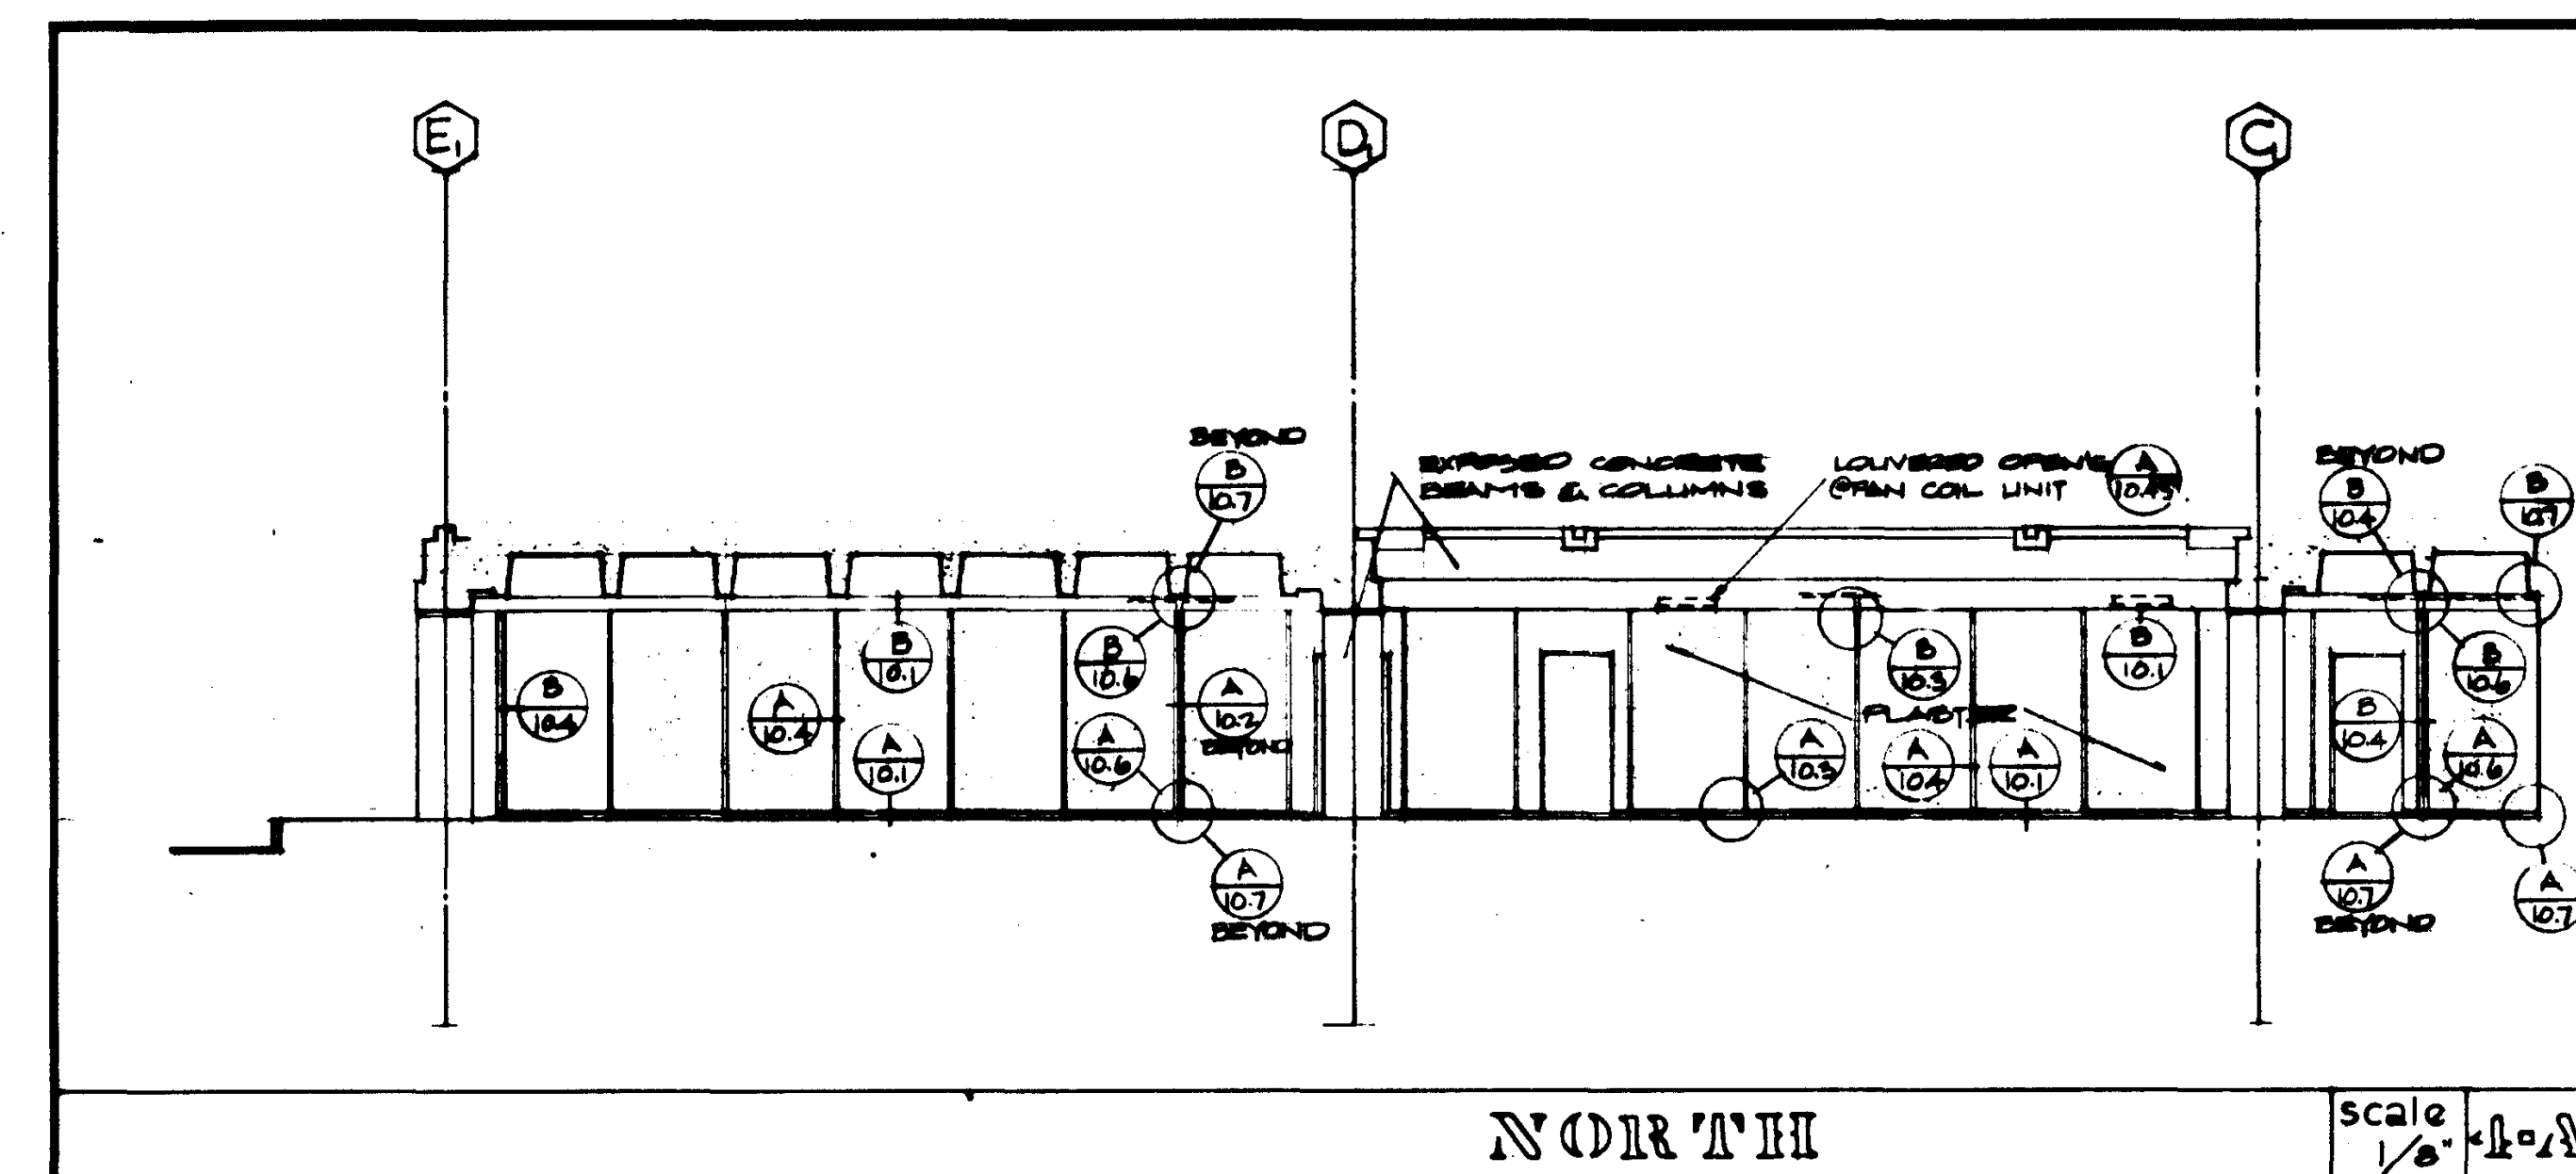
WEST

SCALE 1/8" = 1'

REVISIONS DATE DRAWN REVISIONS		STRUCTURAL ENGINEERS RANDOLPH & JOHNSTON J.A. MARTIN & ASSOCIATES MECHANICAL ENGINEERS RALPH E. PHILLIPS, INC. ELECTRICAL ENGINEERS RALPH E. PHILLIPS, INC. CIVIL ENGINEERS G. SMITHMAN & ASSOCIATES MOTTATT & NICHOL	DESIGNED DRAWN BY CHECKED BY COLLEGE	ARCHITECT WILLIAM L. PEREIRA ENGINEER COLLEGE	APPROVED STATE FIRE MARSHAL STATE OF CALIFORNIA DATE JUN 21 1965 35874 APPROVED JUN 21 1965	ASSOCIATED ARCHITECTS: WILLIAM L. PEREIRA & ASSOCIATES A. QUINCY JONES-FREDERICK E. EMMONS & ASSOCIATES BLUROCK ELLERBROCK & ASSOCIATES URBANUS SQUARE • MACARTHUR BOULEVARD AT FORD ROAD TELEPHONE 714/675-2640 • CORONA DEL MAR, CALIFORNIA	GOLDEN WEST COLLEGE HUNTINGTON BEACH, CALIFORNIA ORANGE COAST JUNIOR COLLEGE DISTRICT		UNIT 7 EXTERIOR ELEVATIONS	SCALE 1/8" = 1' JOB NO. MD-4 DATE 18 JUN 1965 SHEET NO. A 55
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STRUCTURAL ENGINEERS BRADDOCK & JOHNSON J. A. MARTIN & ASSOCIATES MECHANICAL ENGINEERS RALPH S. PHILLIPS, INC. ELECTRICAL ENGINEERS RALPH S. PHILLIPS, INC. CIVIL ENGINEERS G. SHUTMAN & ASSOCIATES MOFFATT & NICHOL				DESIGNED DRAWN BY CHECKED BY	ARCHITECT ENGINEER COLLEGE	APPROVED STATE FIRE MARSHAL STATE OF CALIFORNIA DATE JUN 21 1965 25874	ASSOCIATED ARCHITECTS: WILLIAM L. PEREIRA & ASSOCIATES A. GIBNEY JONES-FREDERICK B. HENSON & ASSOCIATES BLUROCK ELLERBROCK & ASSOCIATES URBANUS SQUARE • MACARTHUR BOULEVARD AT FORD ROAD TELEPHONE 714/675-2640 • CORONA DEL MAR, CALIFORNIA	GOLDEN WEST COLLEGE HUNTINGTON BEACH, CALIFORNIA ORANGE COAST JUNIOR COLLEGE DISTRICT	UNIT 88a EXTERIOR ELEVATIONS	JOB NO. 100-A DATE JUN 1965 SHEET NO. A5.88
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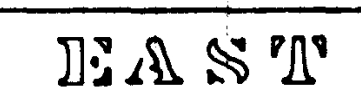
			STRUCTURAL ENGINEERS BRANDOW & JOHNSTON J.A. MARTIN & ASSOCIATES	DESIGNED	ARCHITECT <i>W.H. Martin</i>	APPROVED
			MECHANICAL ENGINEERS RALPH E. PHILLIPS, INC.	DRAWN BY W. PADGALSKAS	ENGINEER	APPROVED STATE FIRE MARSHAL OFFICE OF CALIFORNIA FIRE INSURANCE COMMISSION JULY 1968 <i>[Signature]</i>
			ELECTRICAL ENGINEERS RALPH E. PHILLIPS, INC.	CHECKED BY	COLLEGE	APPROVED ARTIST 25874 <i>Bellard</i>
			CIVIL ENGINEERS O. SHUHRMAN & ASSOCIATES MOFFATT & NICHOL			
DATE	DRAWN	REVISIONS				

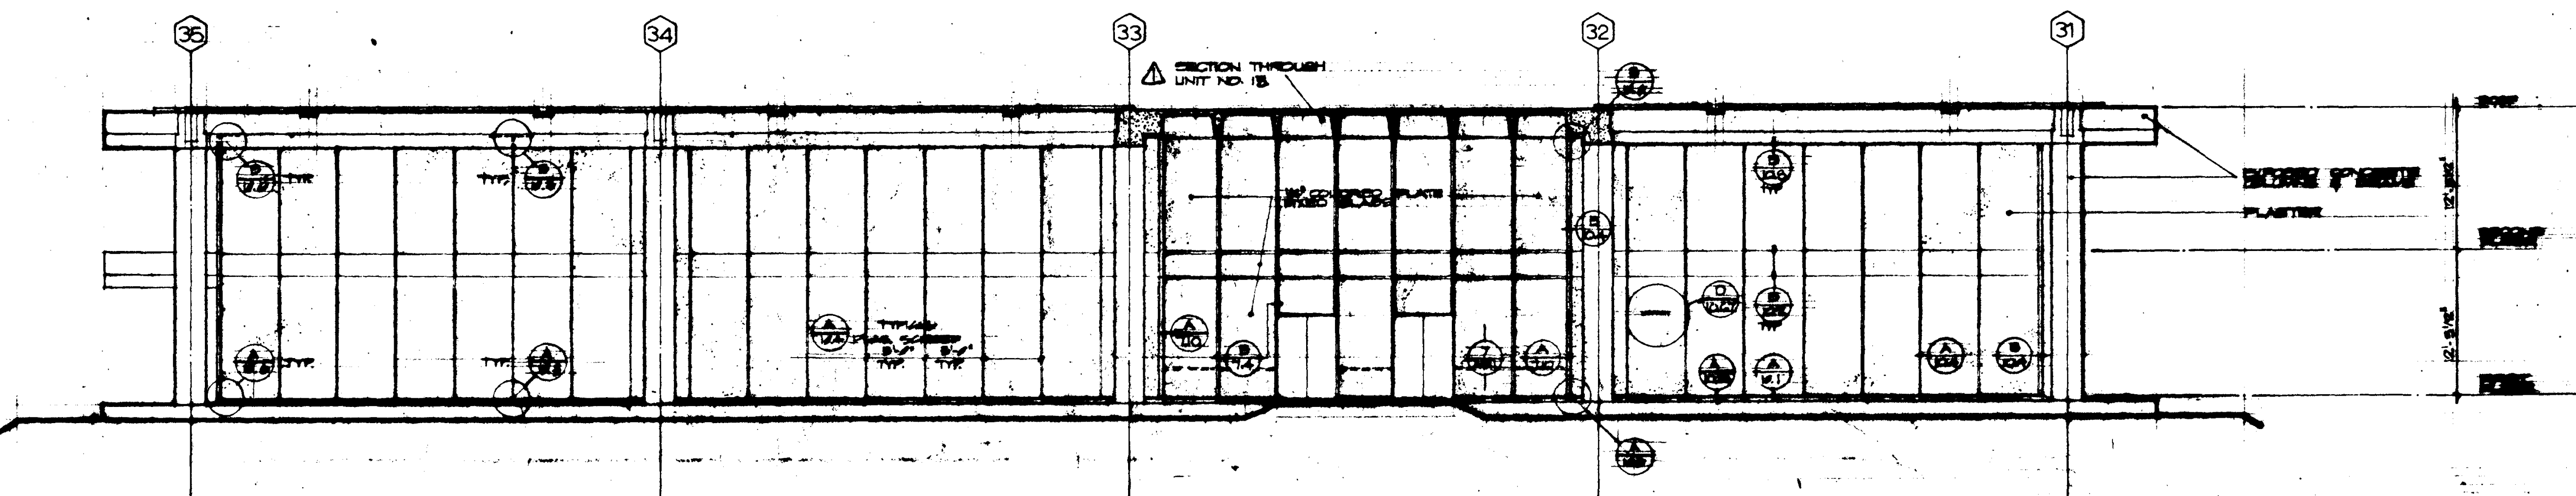ASSOCIATED ARCHITECTS:
WILLIAM L. PEREIRA & ASSOCIATES
A. QUINCY JONES • FREDERICK R. EMMONS & ASSOCIATES
BLUROCK ELLERBROEK & ASSOCIATES


URBANUS SQUARE • MACARTHUR BOULEVARD AT FORD ROAD
 TELEPHONE 714/675-2640 • CORONA DEL MAR, CALIFORNIA

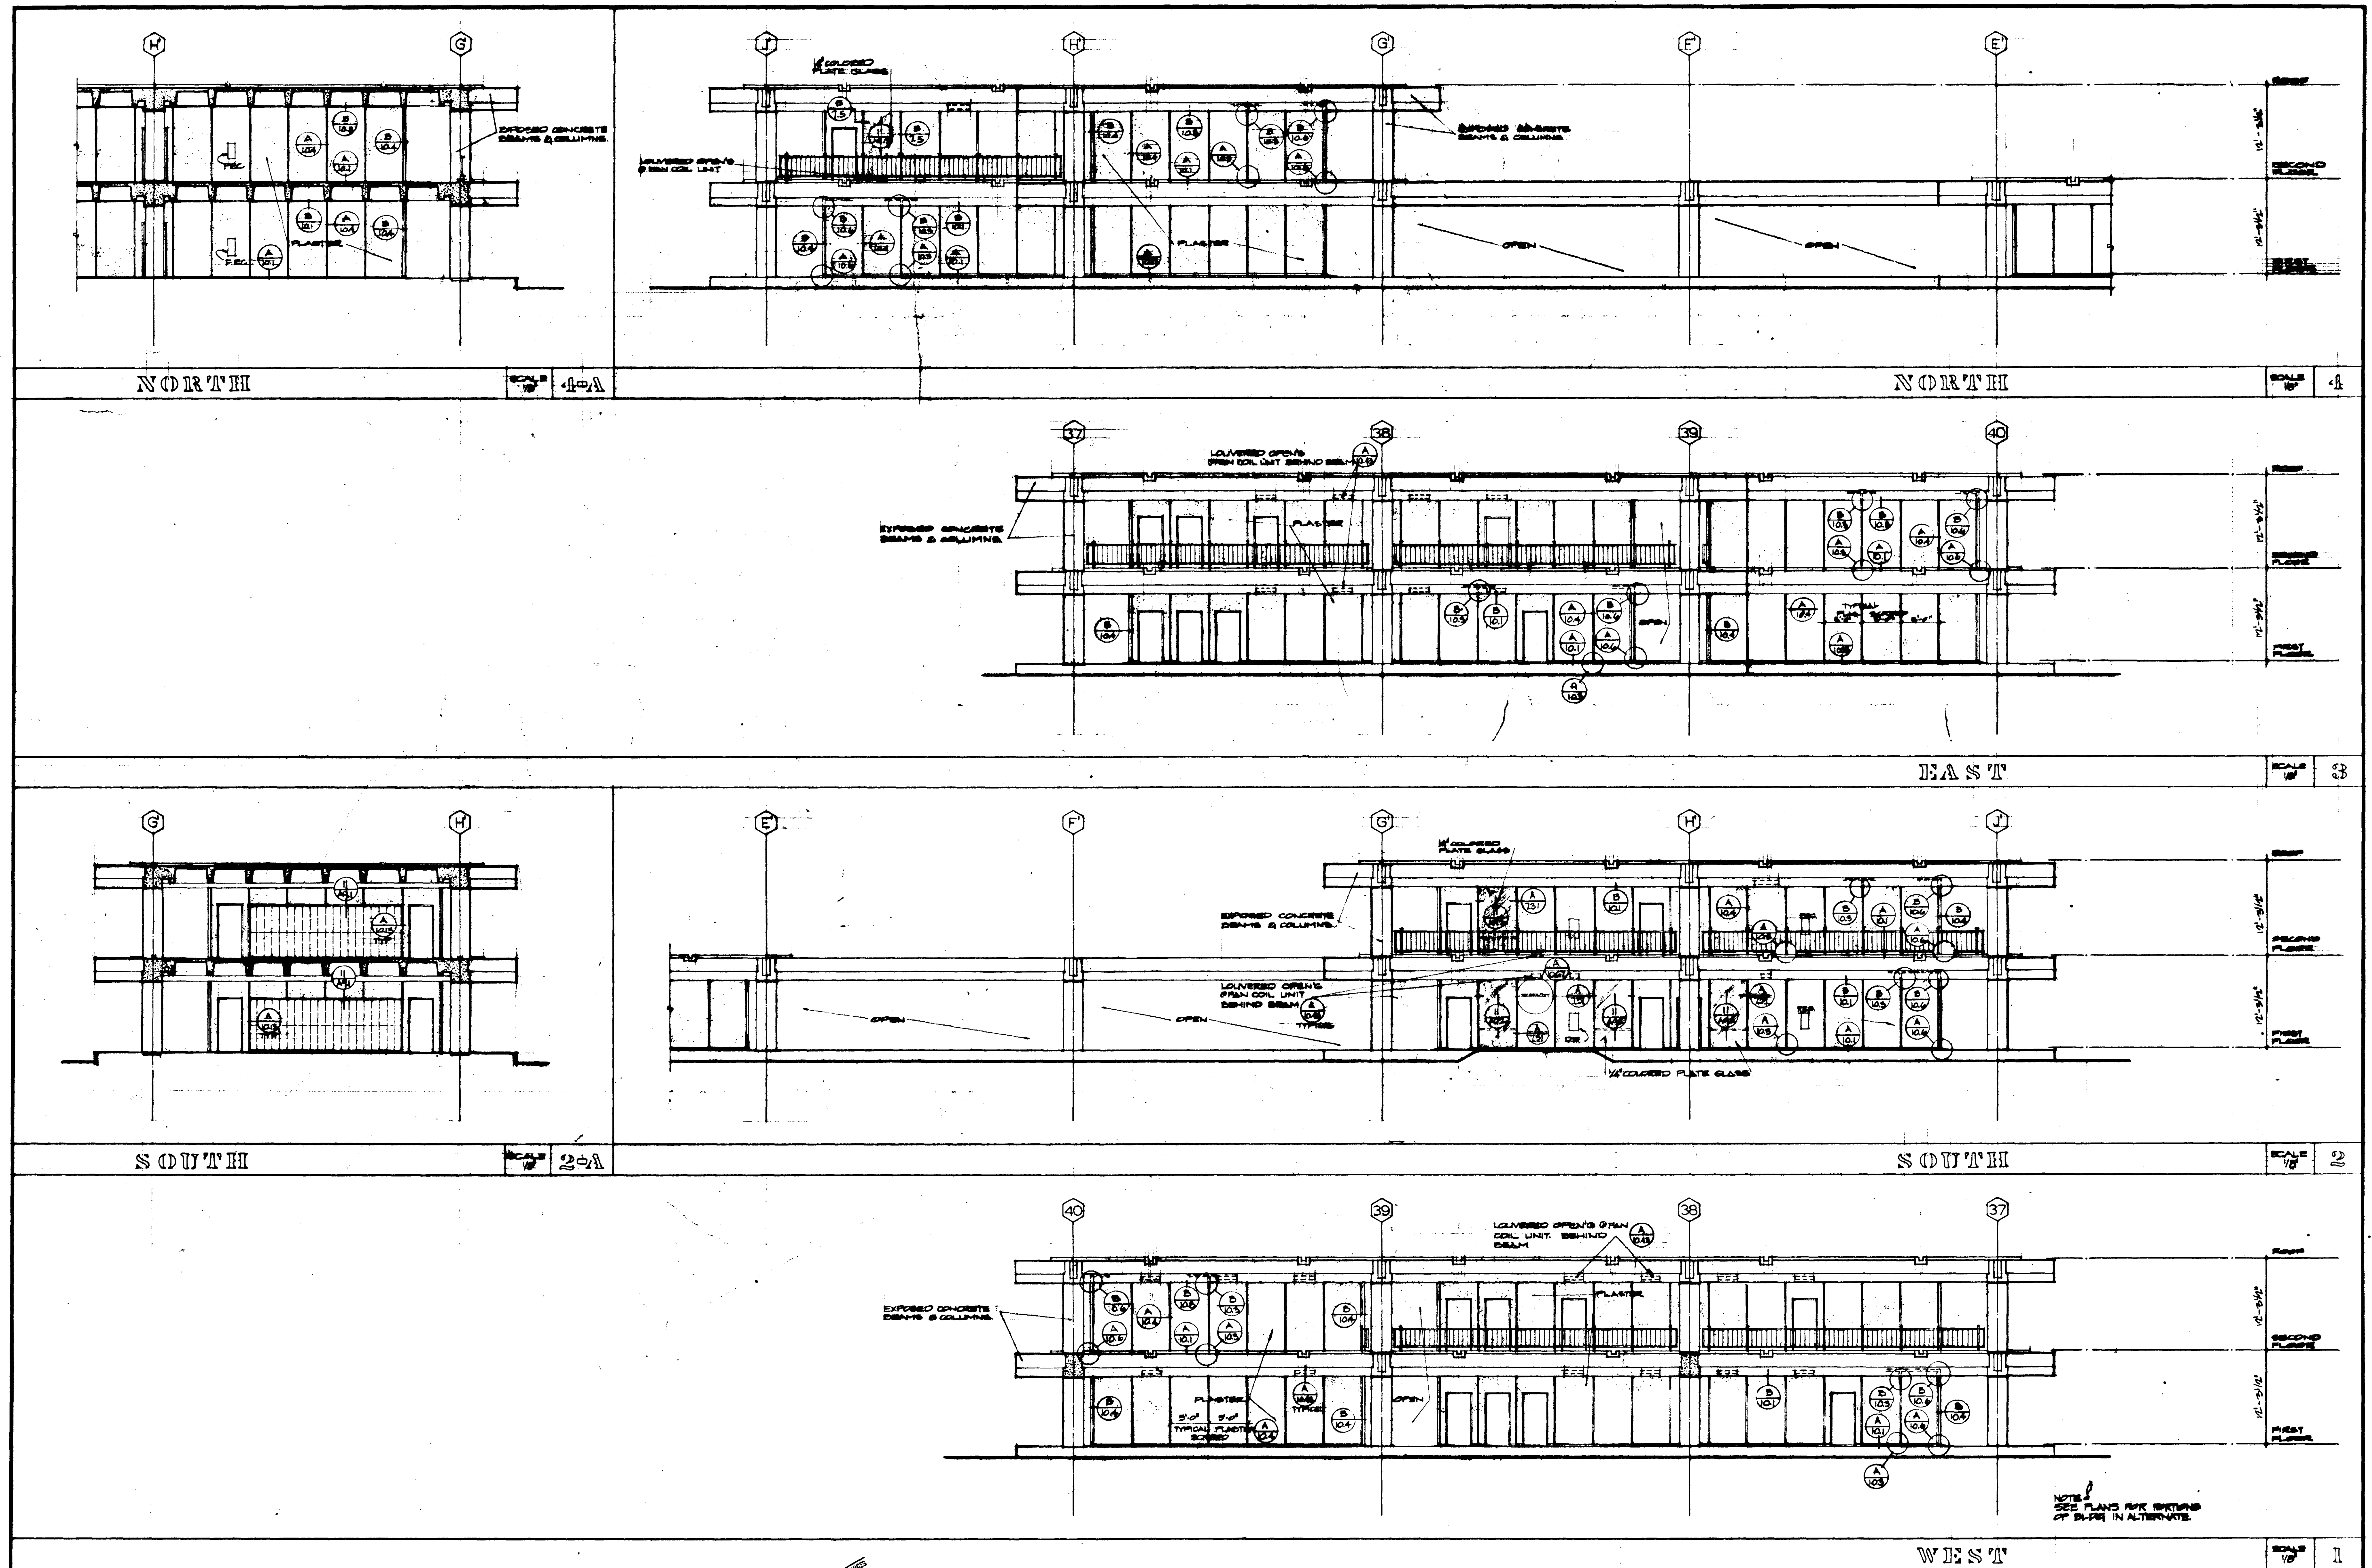GOLDEN WEST COLLEGE
HUNTINGTON BEACH, CALIFORNIA
ORANGE COAST JUNIOR COLLEGE DISTRICT


UNIT	880	ALTERNATE NO. 2	JOB NO. 100-1
EXTERIOR ELEVATIONS			DATE 15 JUN 1966 SHEET NO. A 5.0



		STRUCTURAL ENGINEERS BRADDOCK & JOHNSON J. A. MARTIN & ASSOCIATES	DESIGNED <i>William J. Martin</i>	ARCHITECTS APPROVED <i>William J. Martin</i>	<div>ASSOCIATED ARCHITECTS: WILLIAM L. FERRIER & ASSOCIATES A. GEORGE JONES, FREDERICK R. EDMONDS & ASSOCIATES BLUROCK MILLERBROOK & ASSOCIATES URBANUS SQUARE • MACARTHUR BOULEVARD AT FORD ROAD TELEPHONE 714-264-6400 • CORONA DEL MAR, CALIFORNIA</div>	<div>GOLDEN WEST COLLEGE HUNTINGTON BEACH, CALIFORNIA ORANGE COAST JUNIOR COLLEGE DISTRICT</div>	UNIT 1a & 1b	JOB NO. 100-1	
		MECHANICAL ENGINEERS RALPH E. PHILLIPS, INC.	DRAWN BY	ENGINEER			DATE 15 JUN 1965	EXTERIOR	
		ELECTRICAL ENGINEERS RALPH E. PHILLIPS, INC.	CHECKED BY	COLLEGE			SHEET NO.	ELEVATIONS	A 3.100
		CIVIL ENGINEERS G. SHUVERMAN & ASSOCIATES BOSTWICK & STODOLSKY							
REVISIONS									

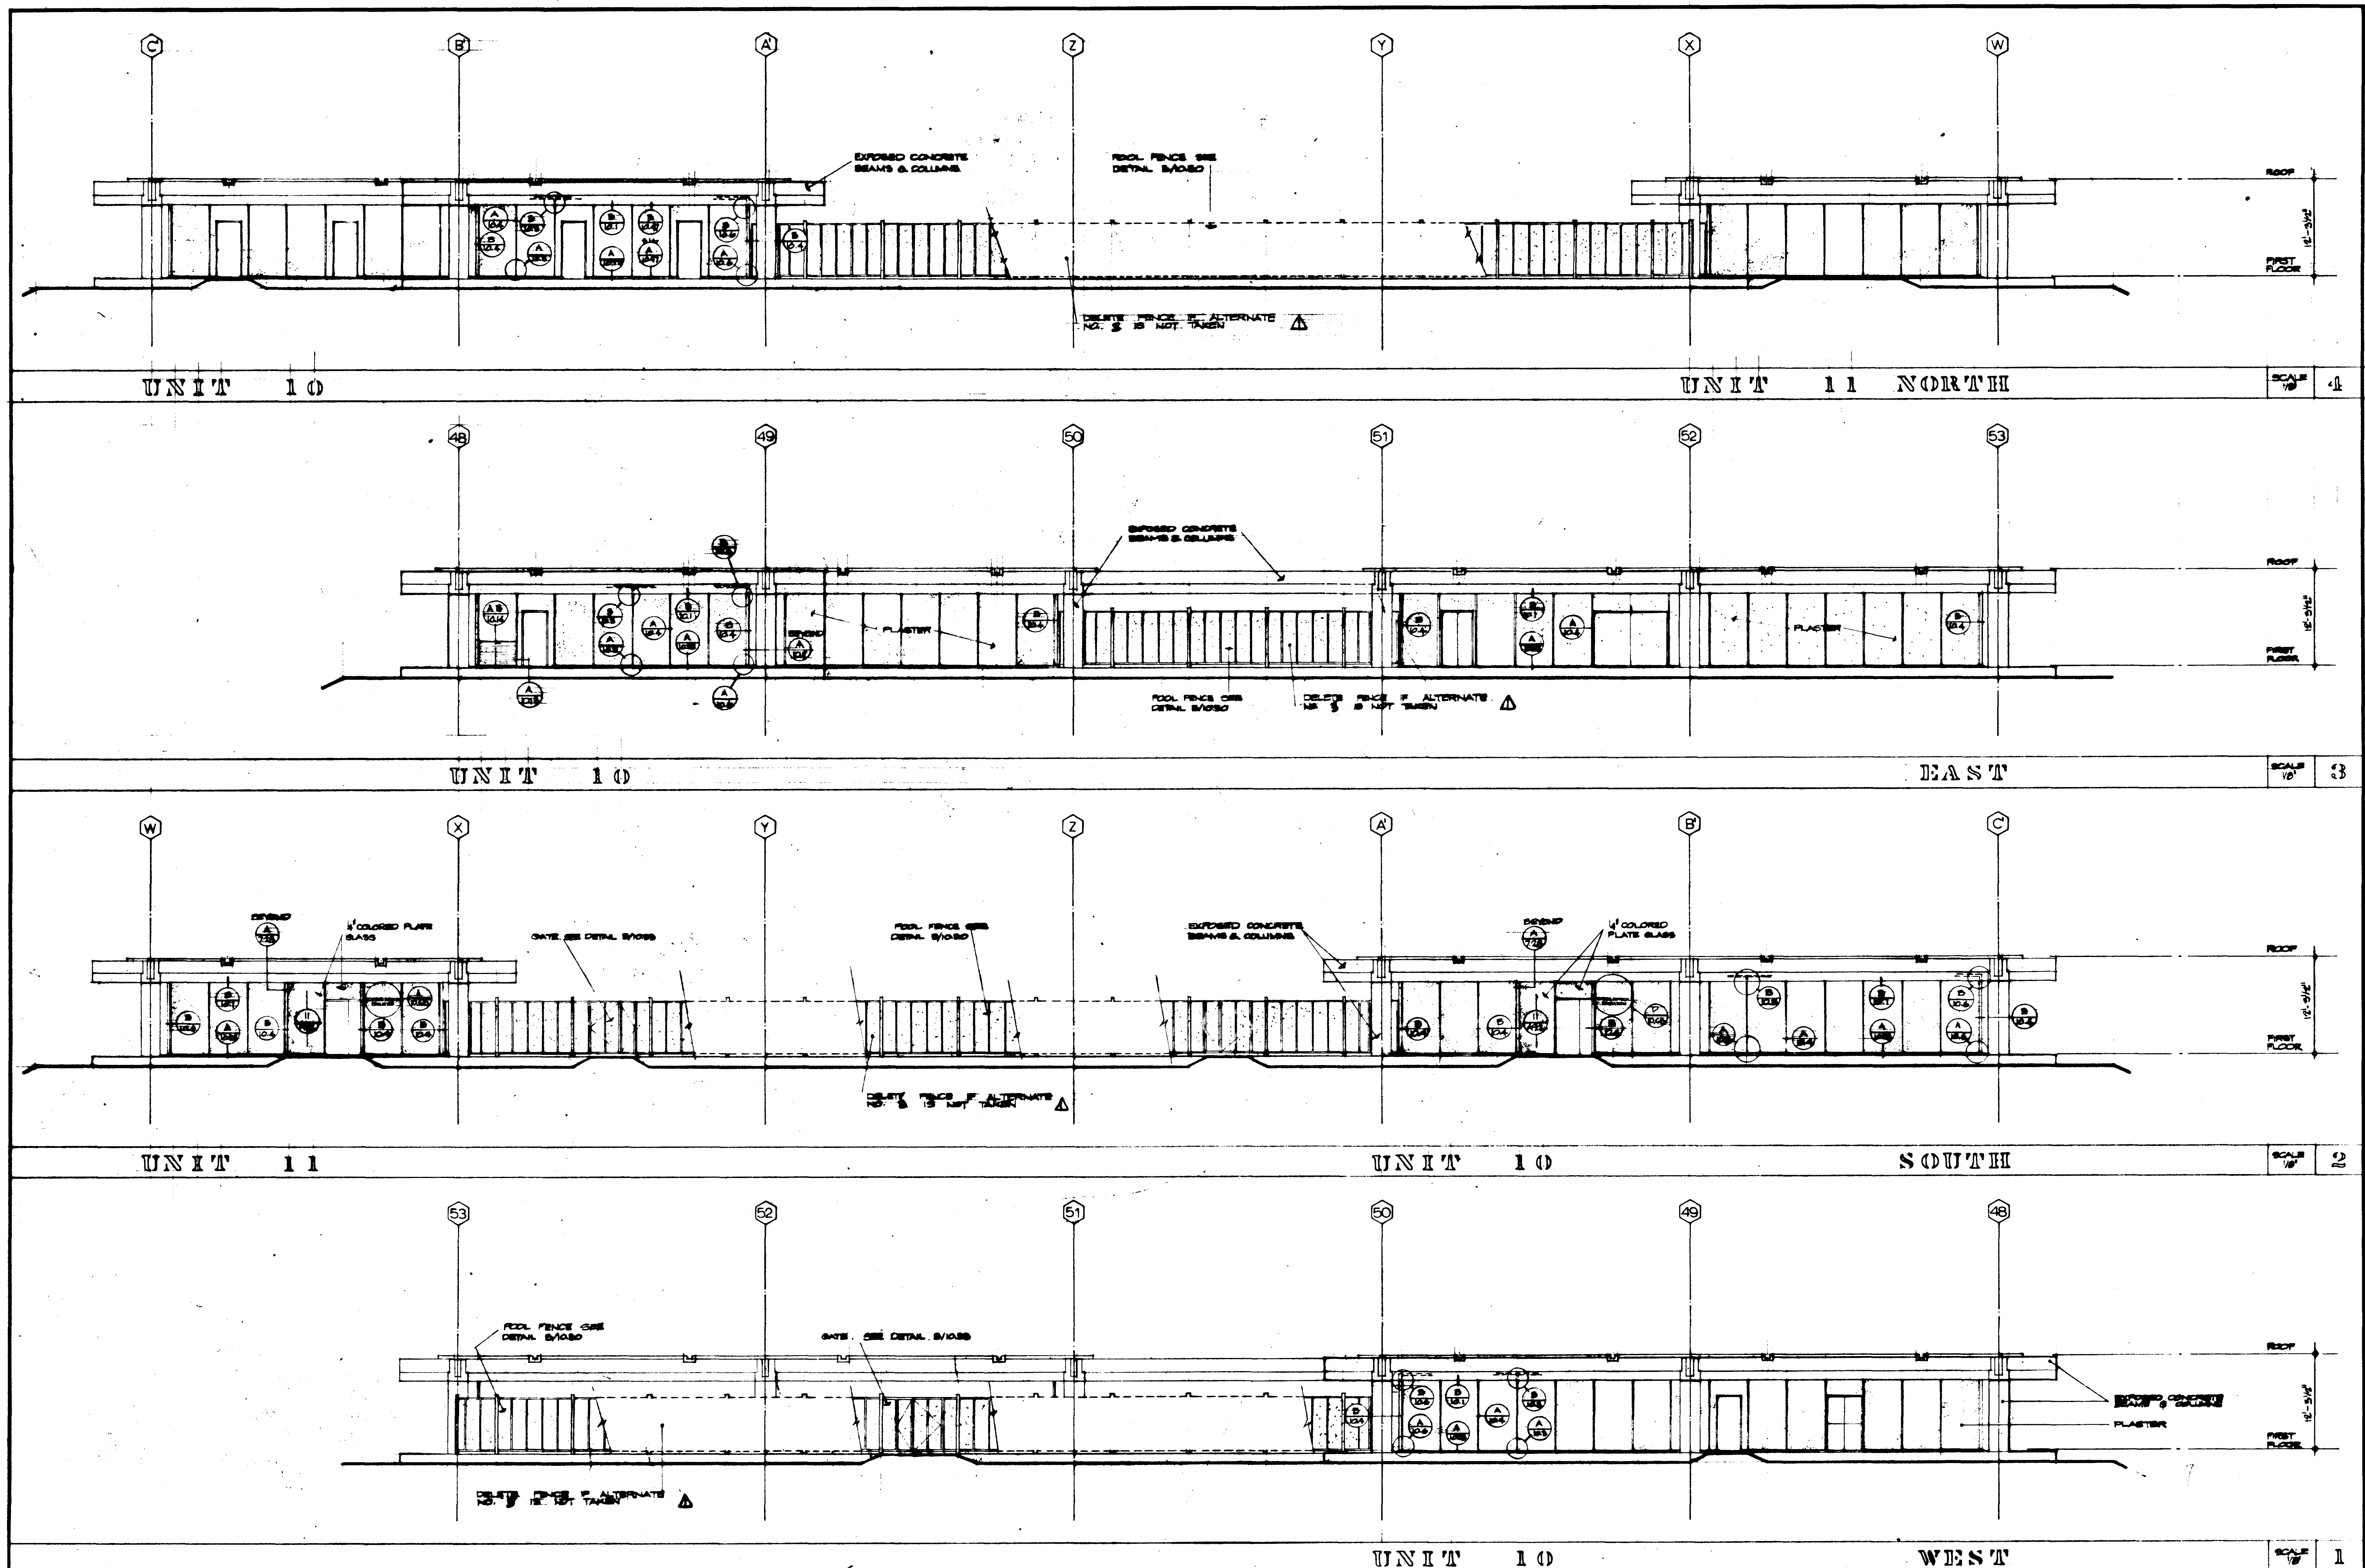


REVISIONS DATE BY DESCRIPTION		STRUCTURAL ENGINEER BRANDOW & JOHNSON J.A. MARTIN & ASSOCIATES MECHANICAL ENGINEER RALPH E. PHILLIPS, INC. ELECTRICAL ENGINEER RALPH E. PHILLIPS, INC. CIVIL ENGINEER G. SHURMAN & ASSOCIATES MOFFAT & NICHOL		DESIGNED ARCHITECT WILLIAM L. PEREIRA & ASSOCIATES DRAWN BY ENGINEER CHECKED BY COLLEGE	APPROVED STATE FIRE MARSHAL STATE OF CALIFORNIA DATE JUN 21 1965 25874	ASSOCIATED ARCHITECTS: WILLIAM L. PEREIRA & ASSOCIATES A. QUINCY JONES-FREDERICK E. EMMONS & ASSOCIATES BLUROCK ELLERBROOK & ASSOCIATES URBANUS SQUARE • MACARTHUR BOULEVARD AT FORD ROAD TELEPHONE 714/675-2640 • CORONA DEL MAR, CALIFORNIA	GOLDEN WEST COLLEGE HUNTINGTON BEACH, CALIFORNIA ORANGE COAST JUNIOR COLLEGE DISTRICT	UNIT 10 - 11 EXTENSION ELEVATIONS	JOB NO. 10-11 DATE 15 JUN 1965 SHEET NO. A-311
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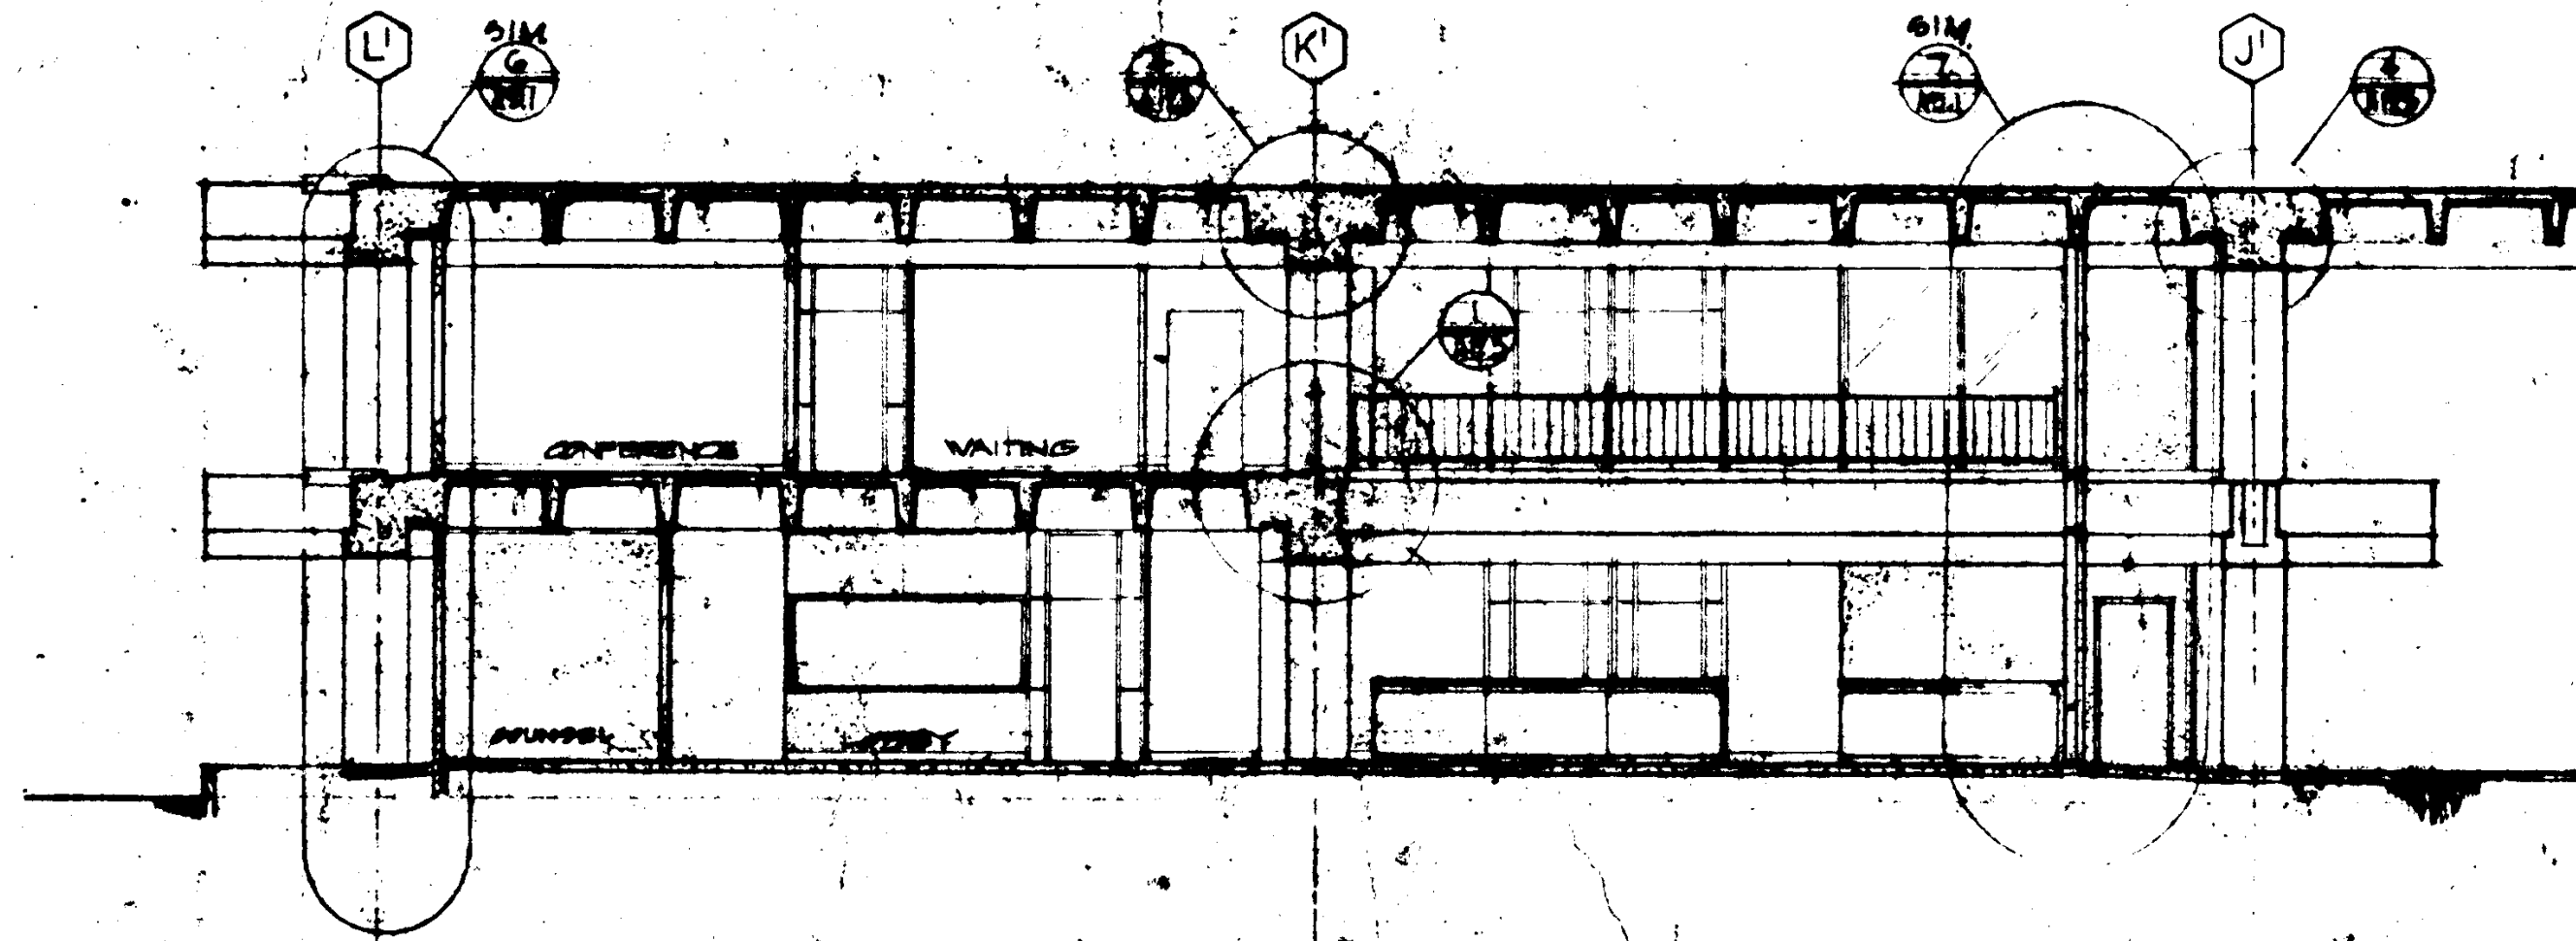
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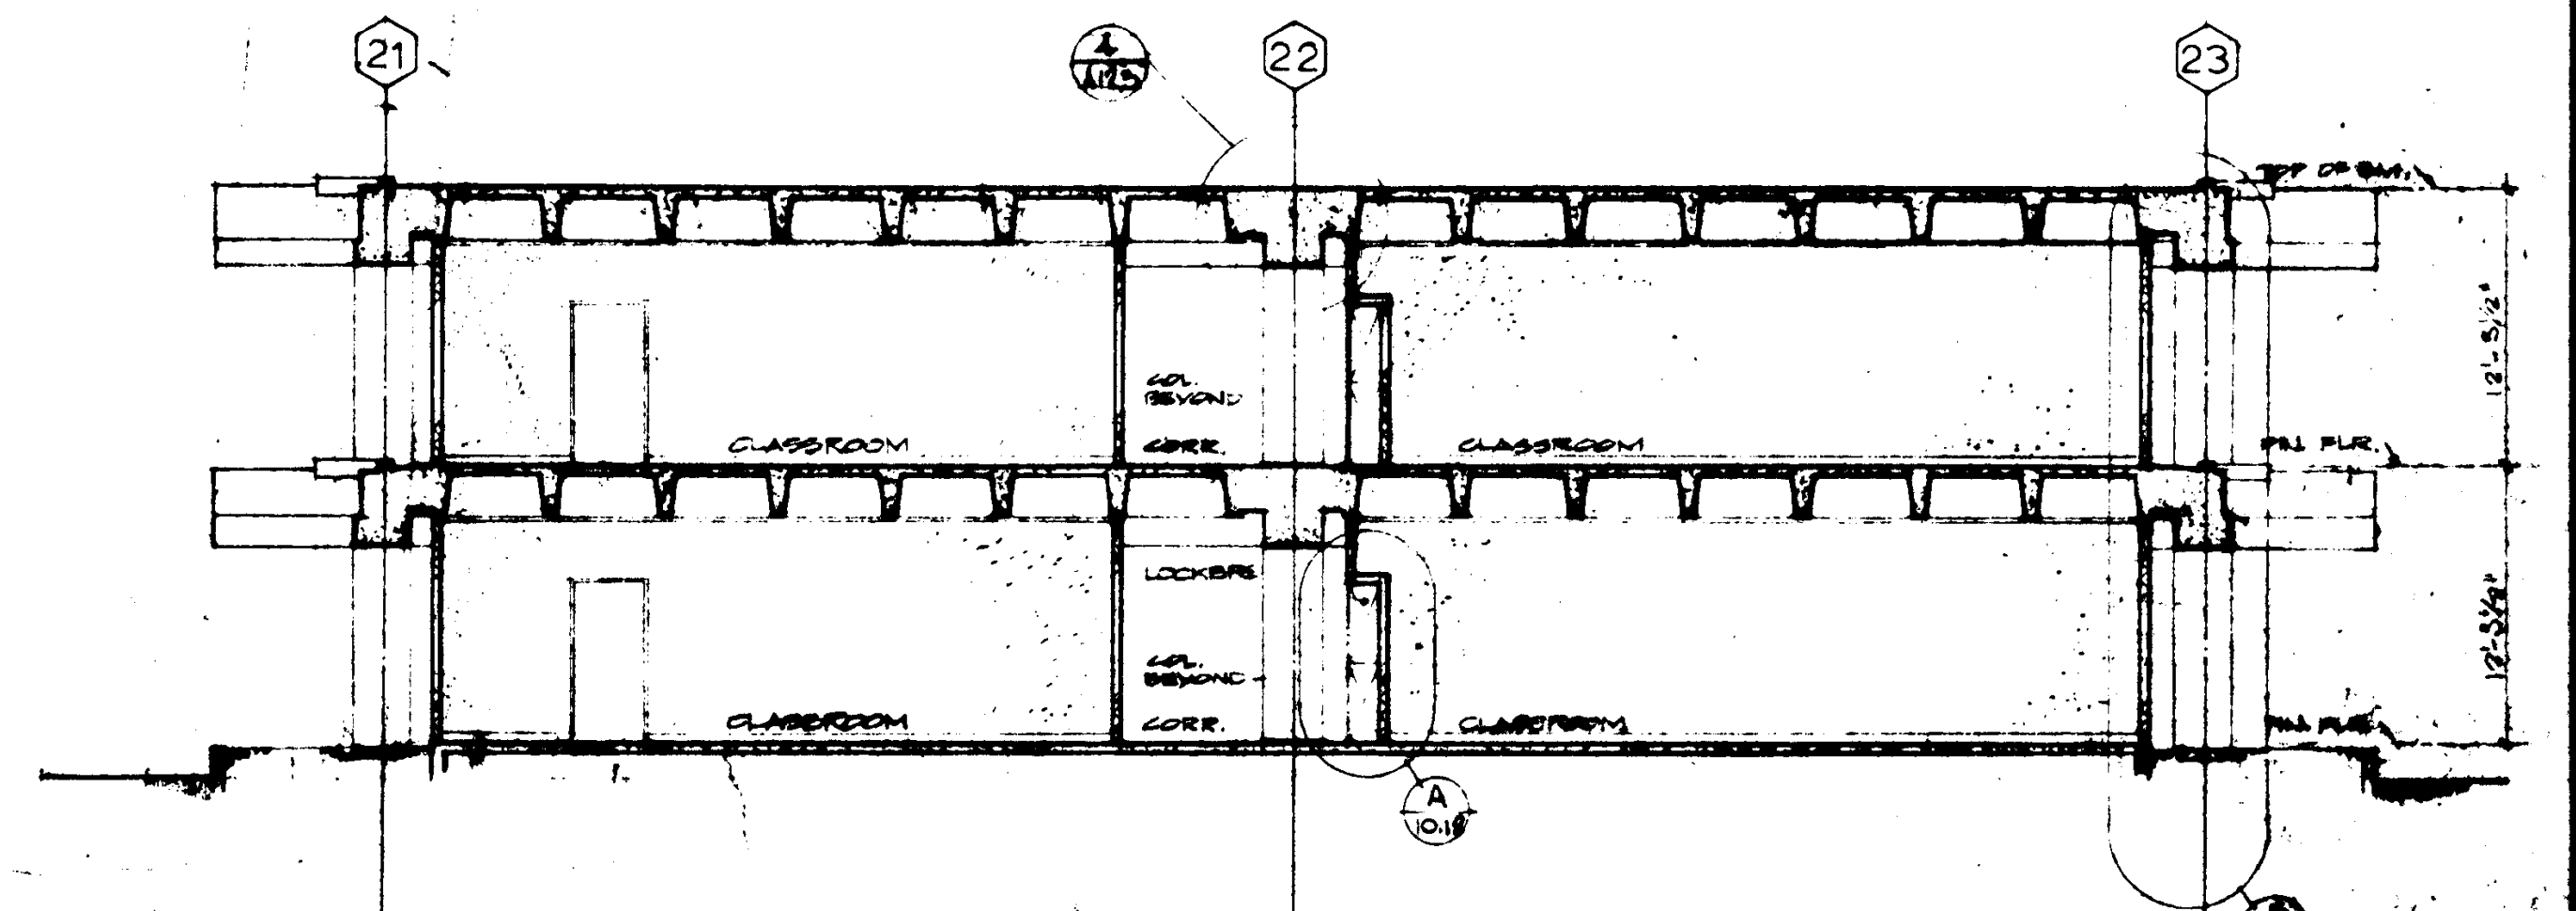
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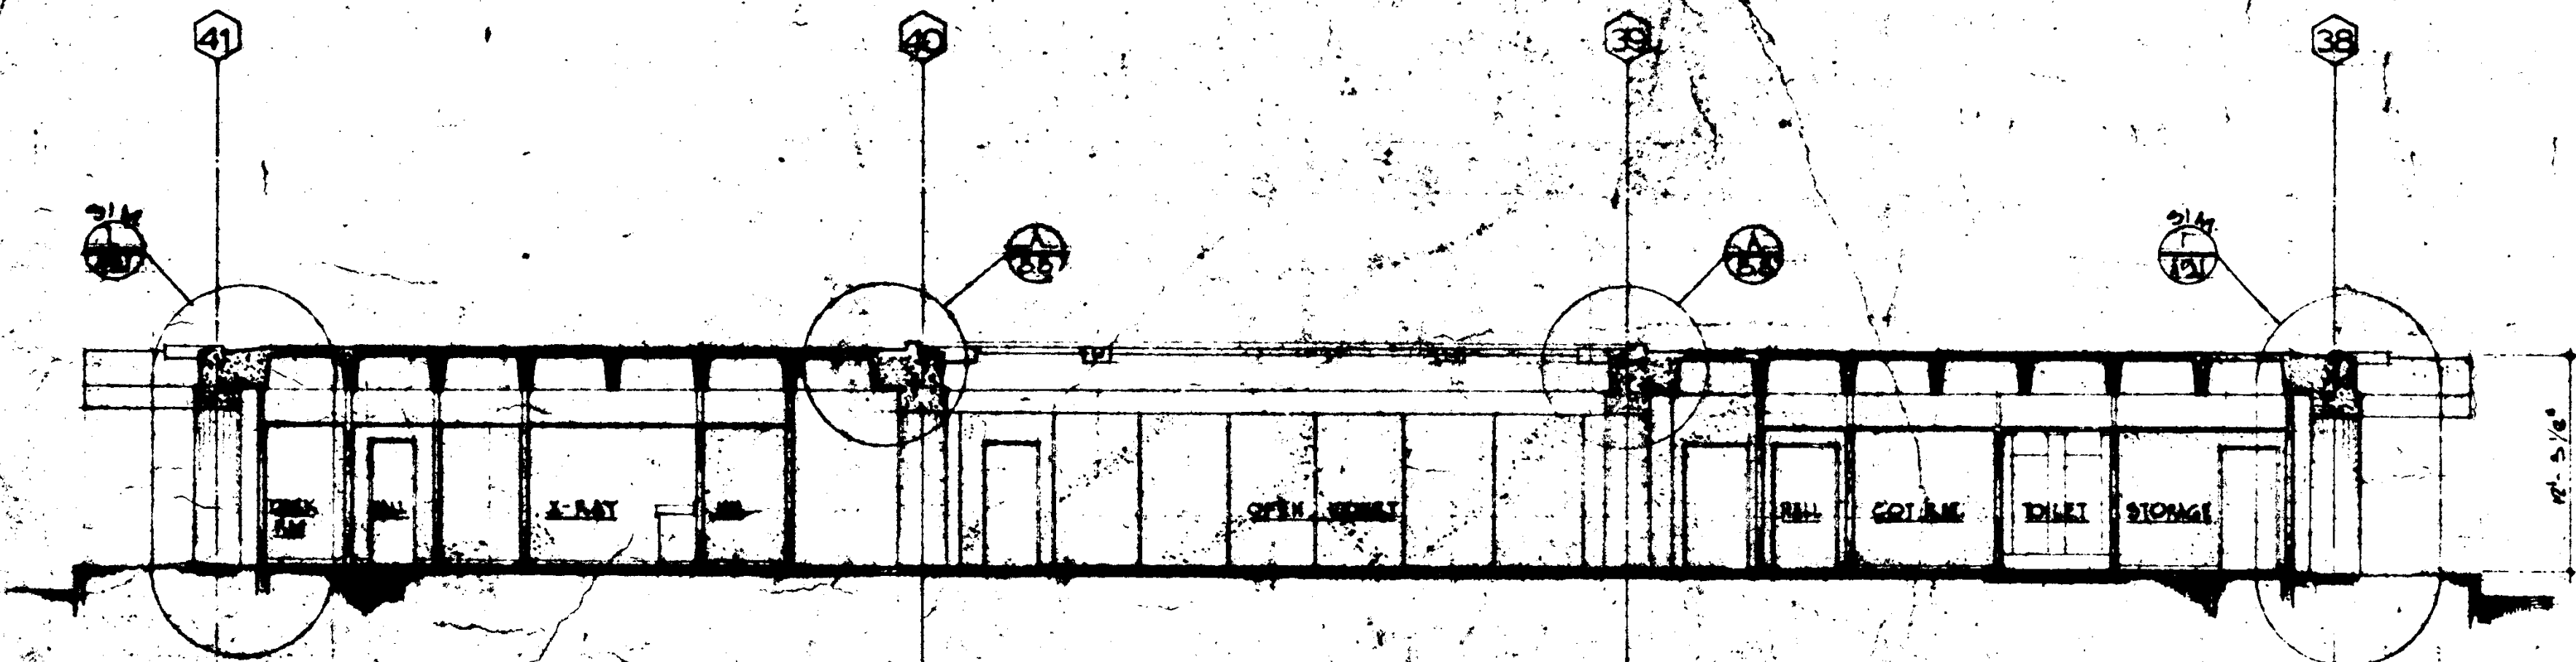
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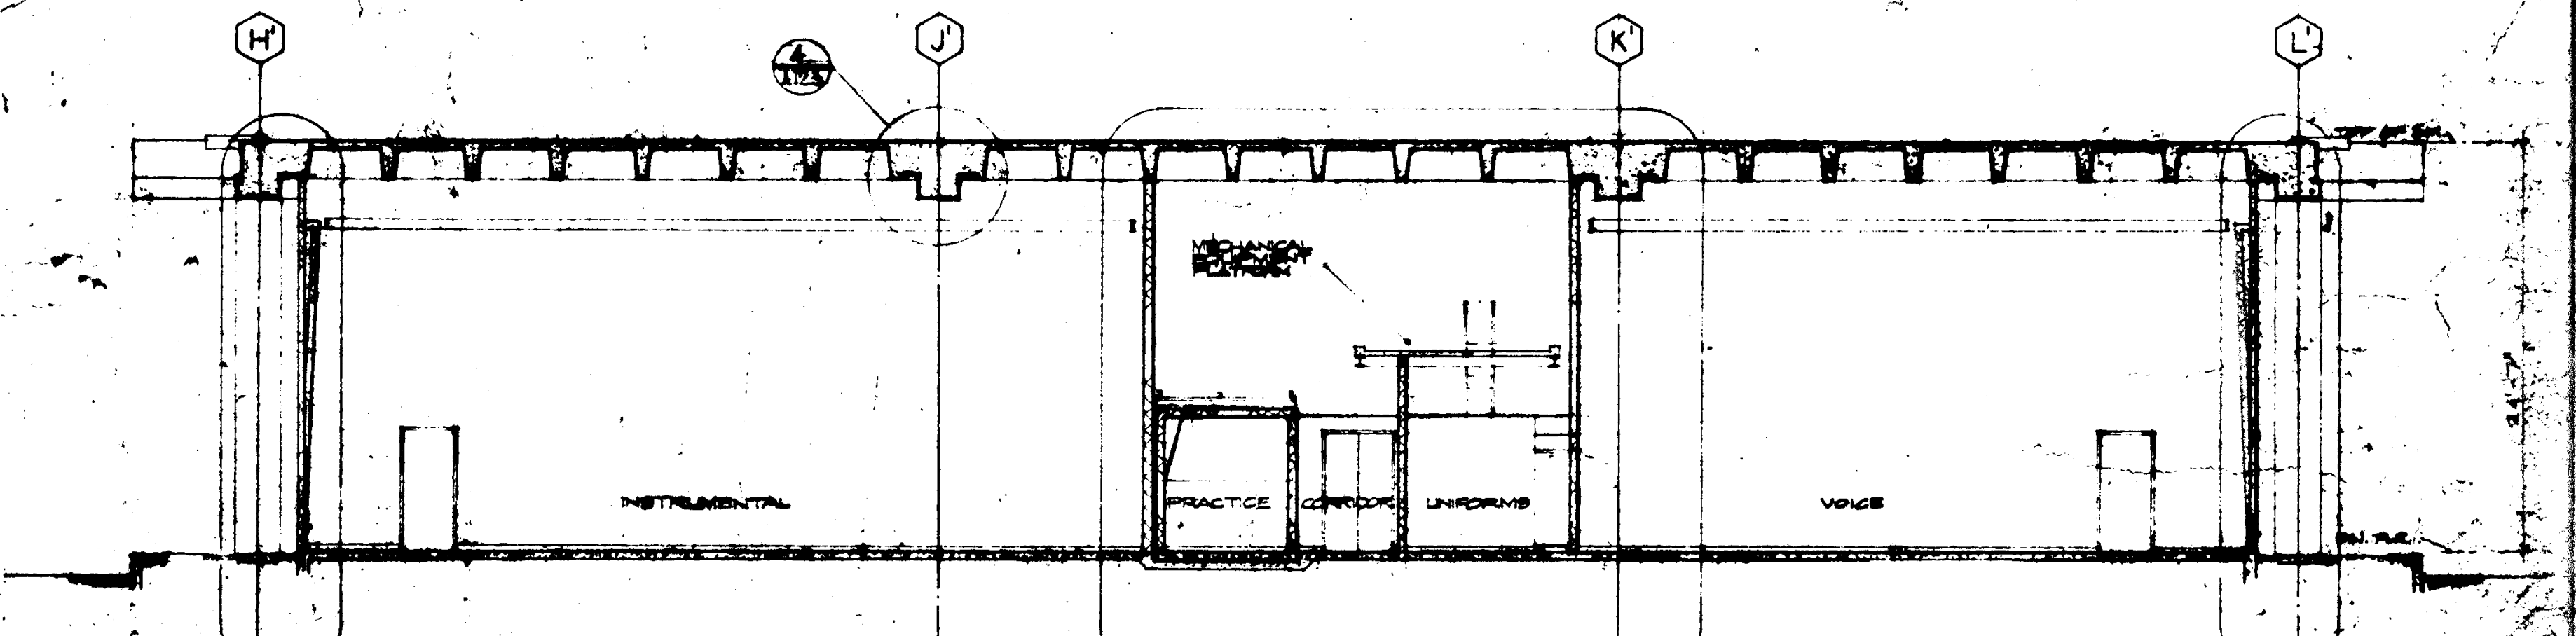
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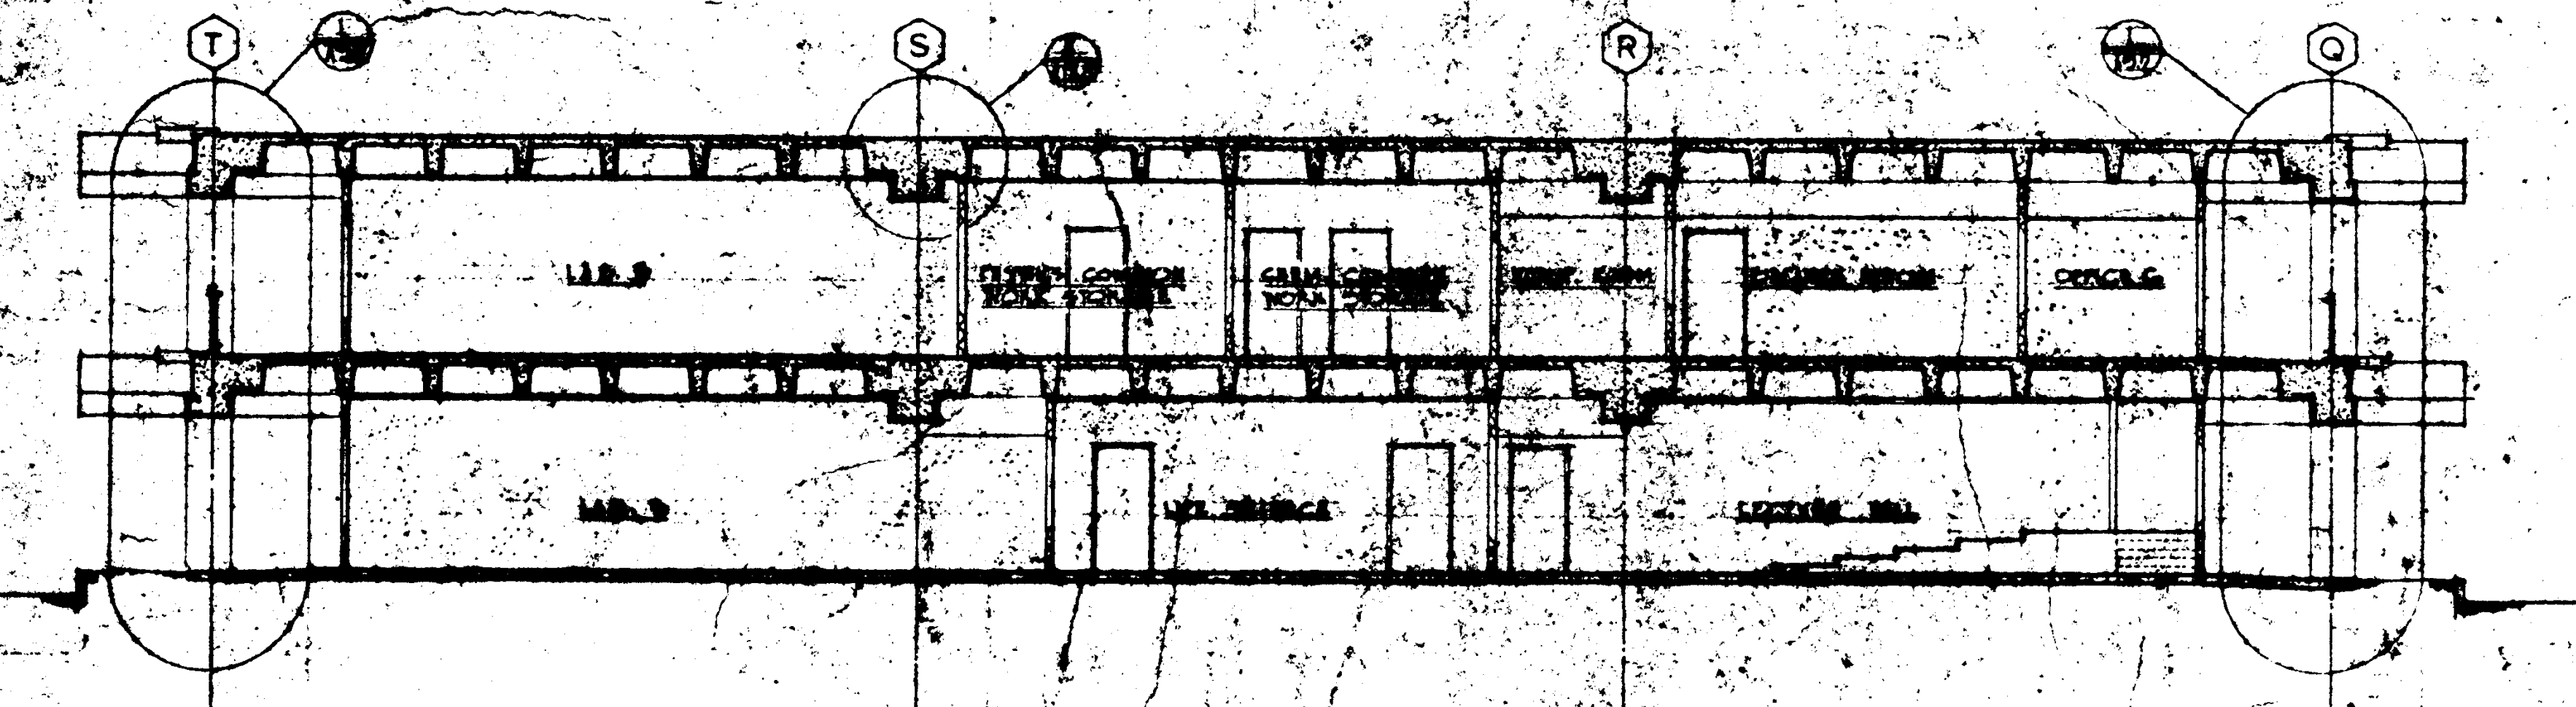
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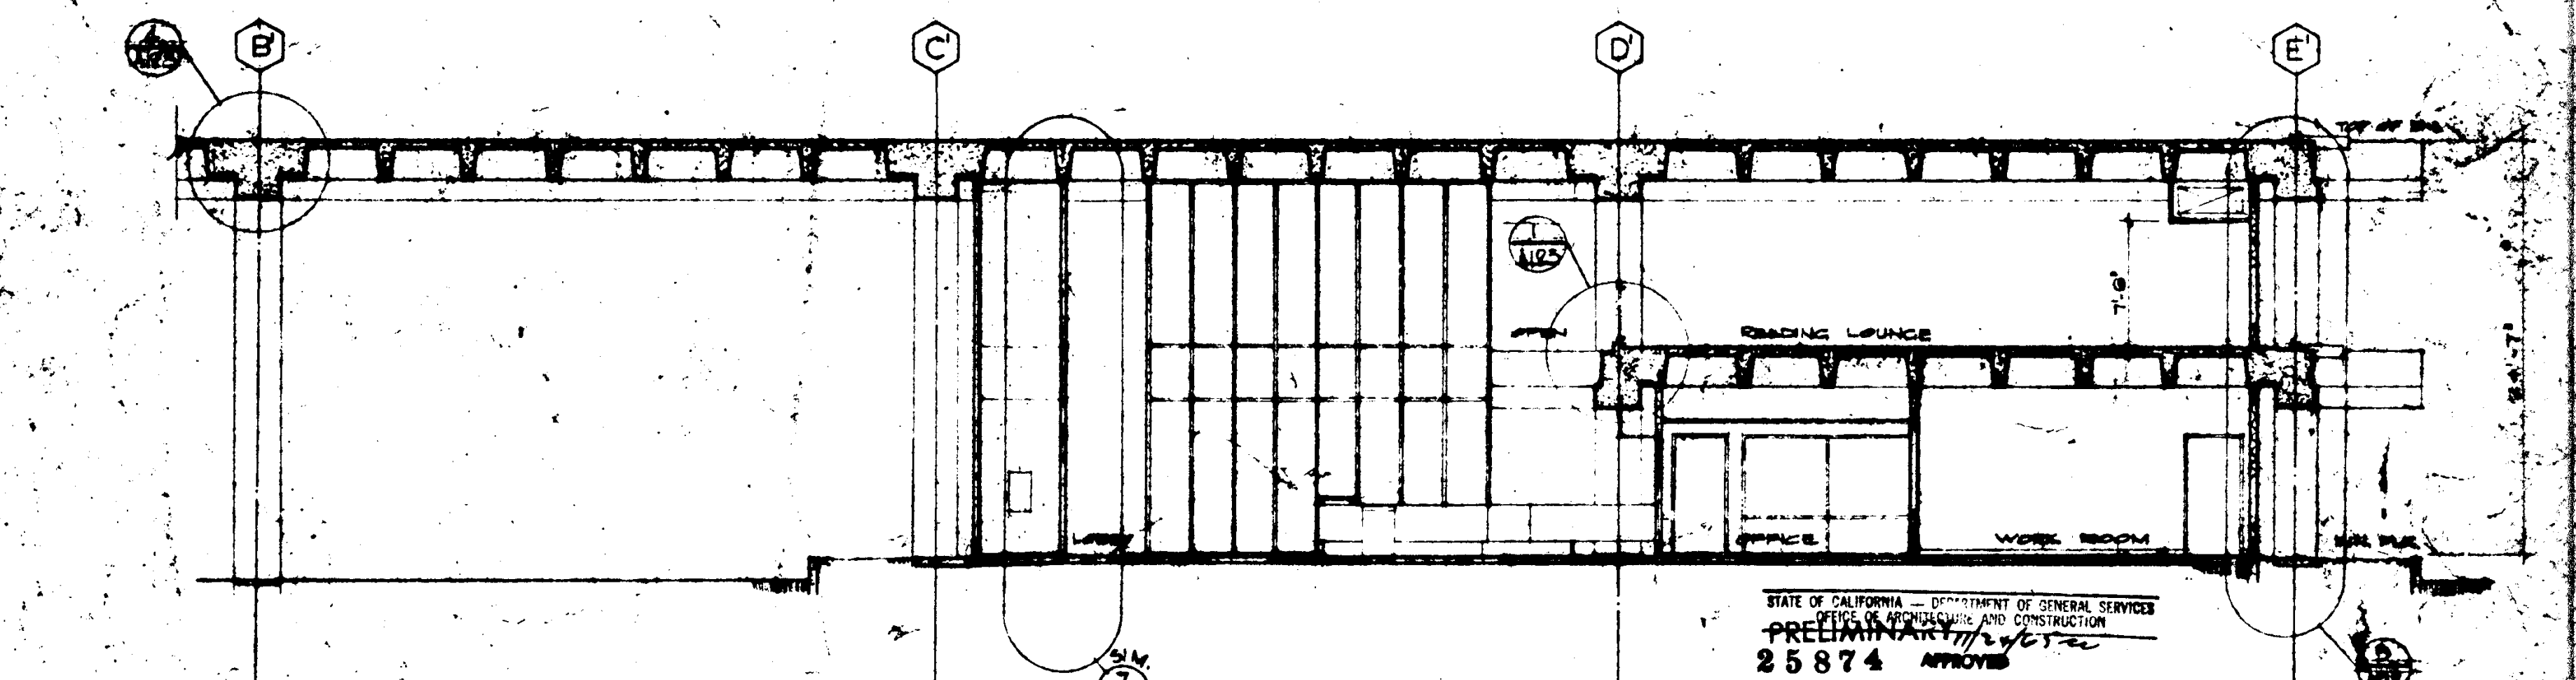
UNIT 3 SECTION

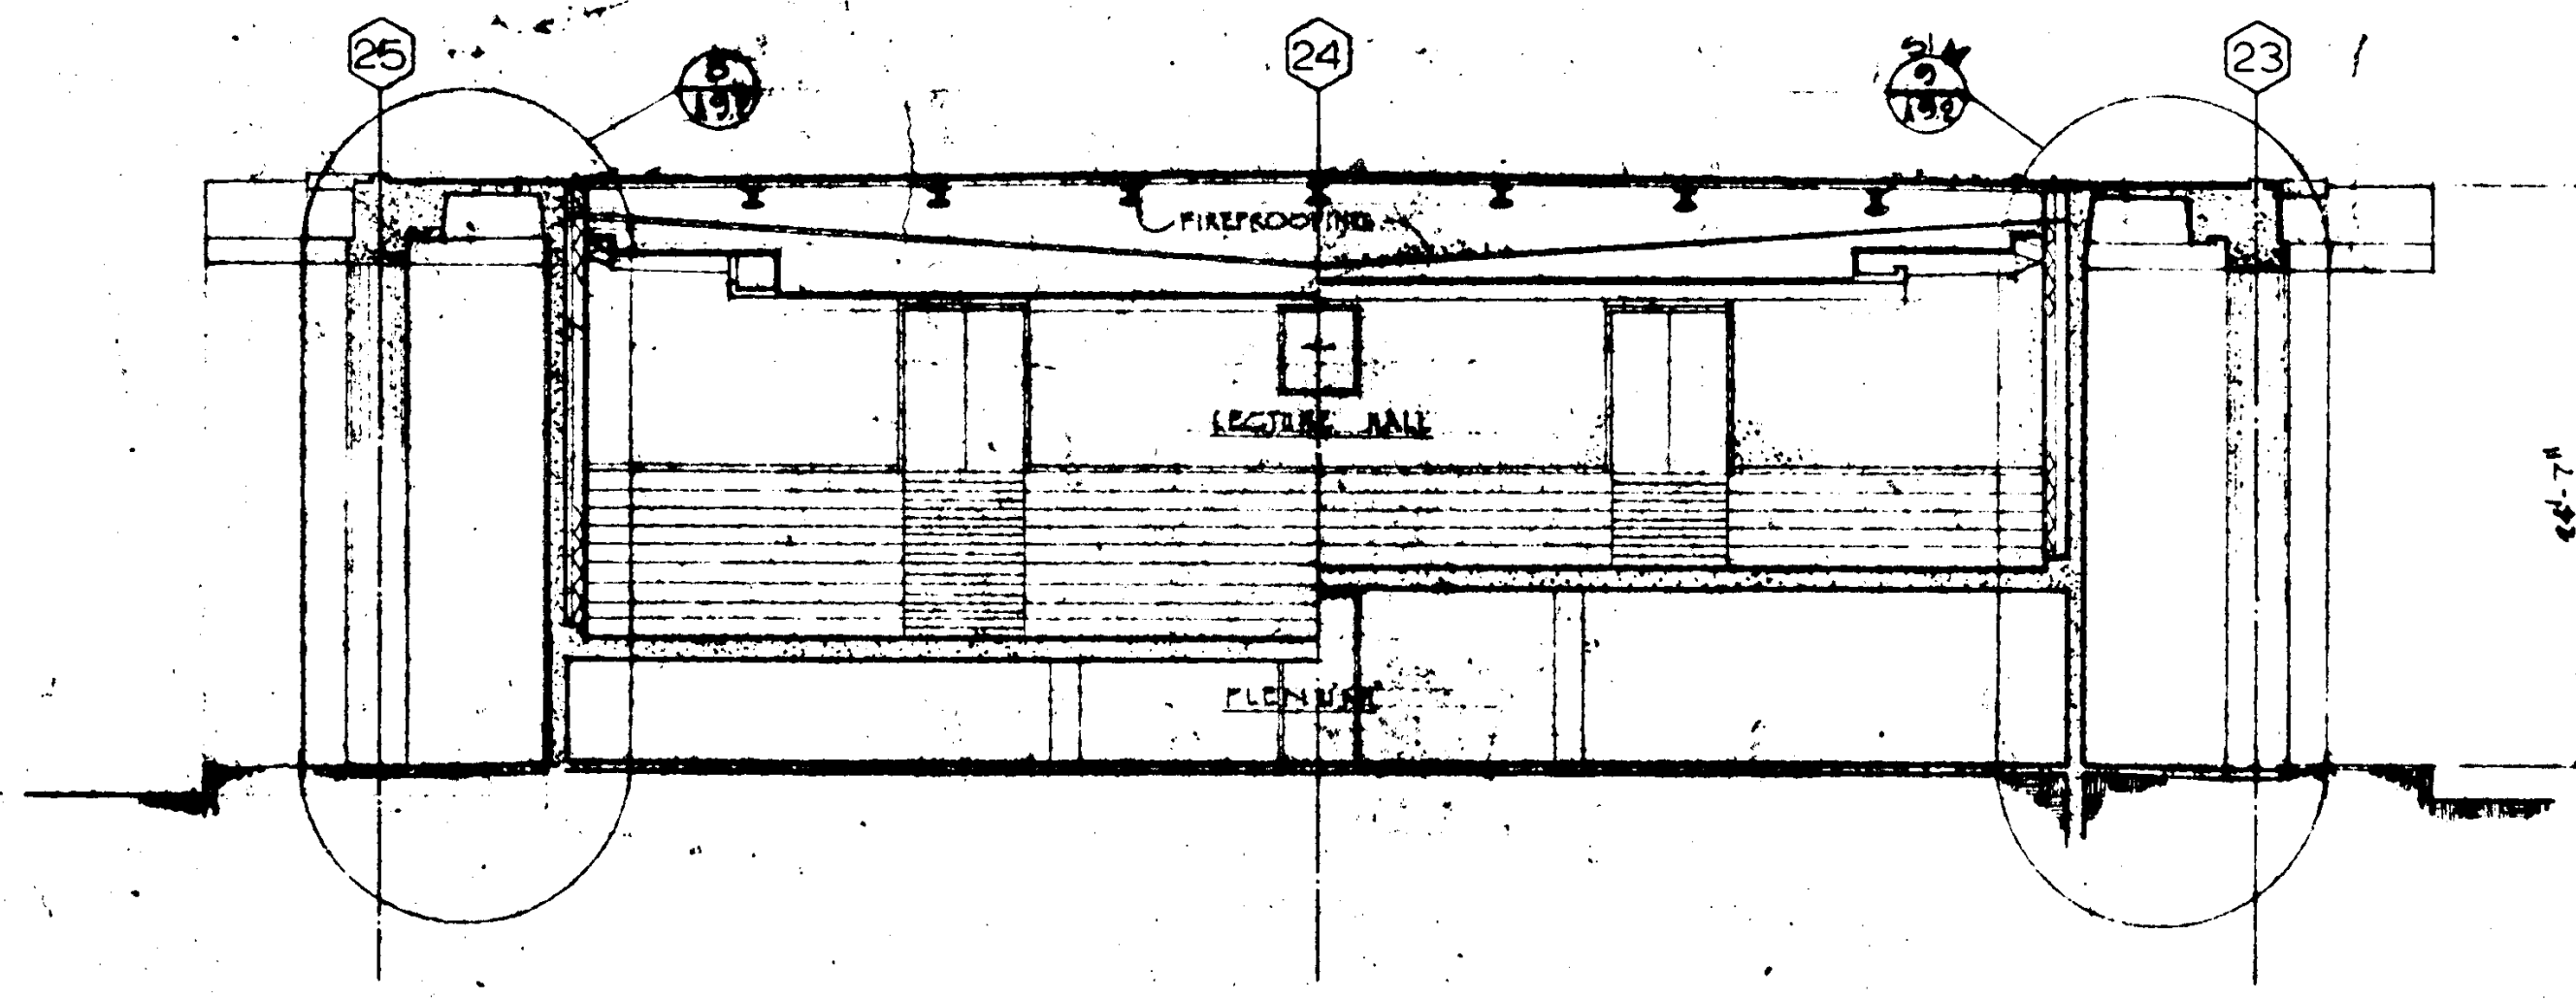SCALE: 1/8" = 1'-0"




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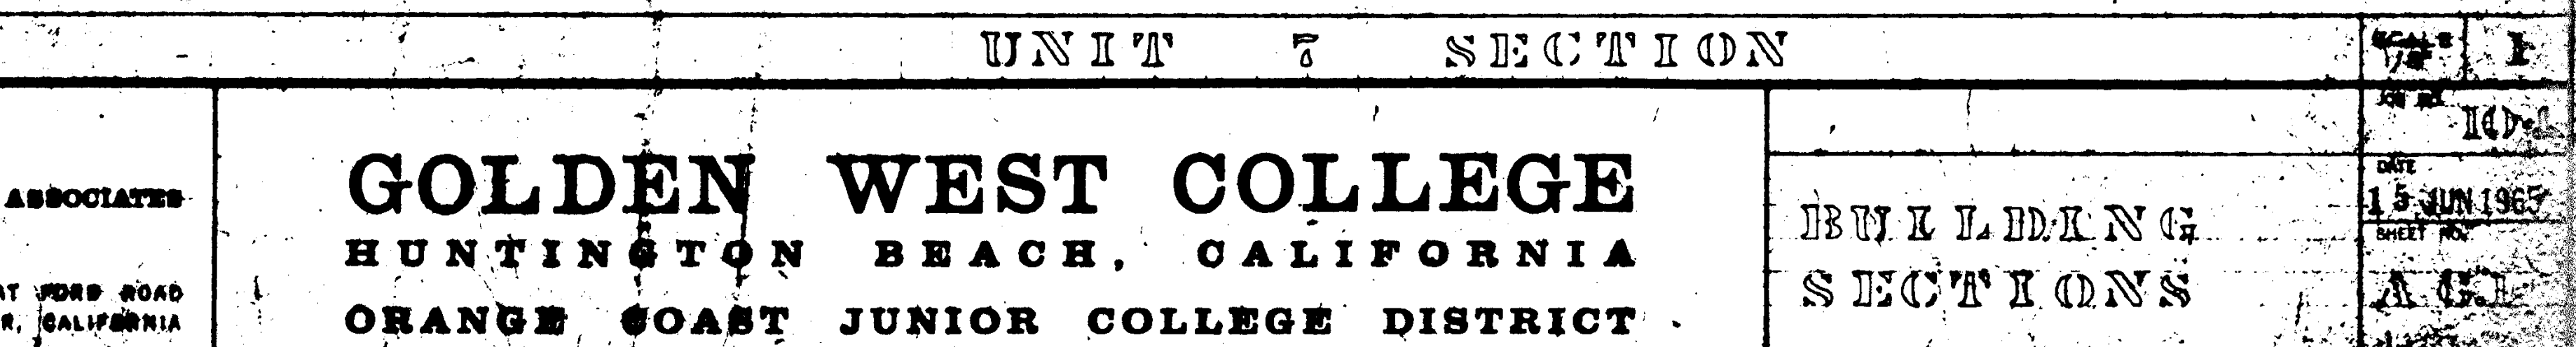
UNIT 6 SECTION
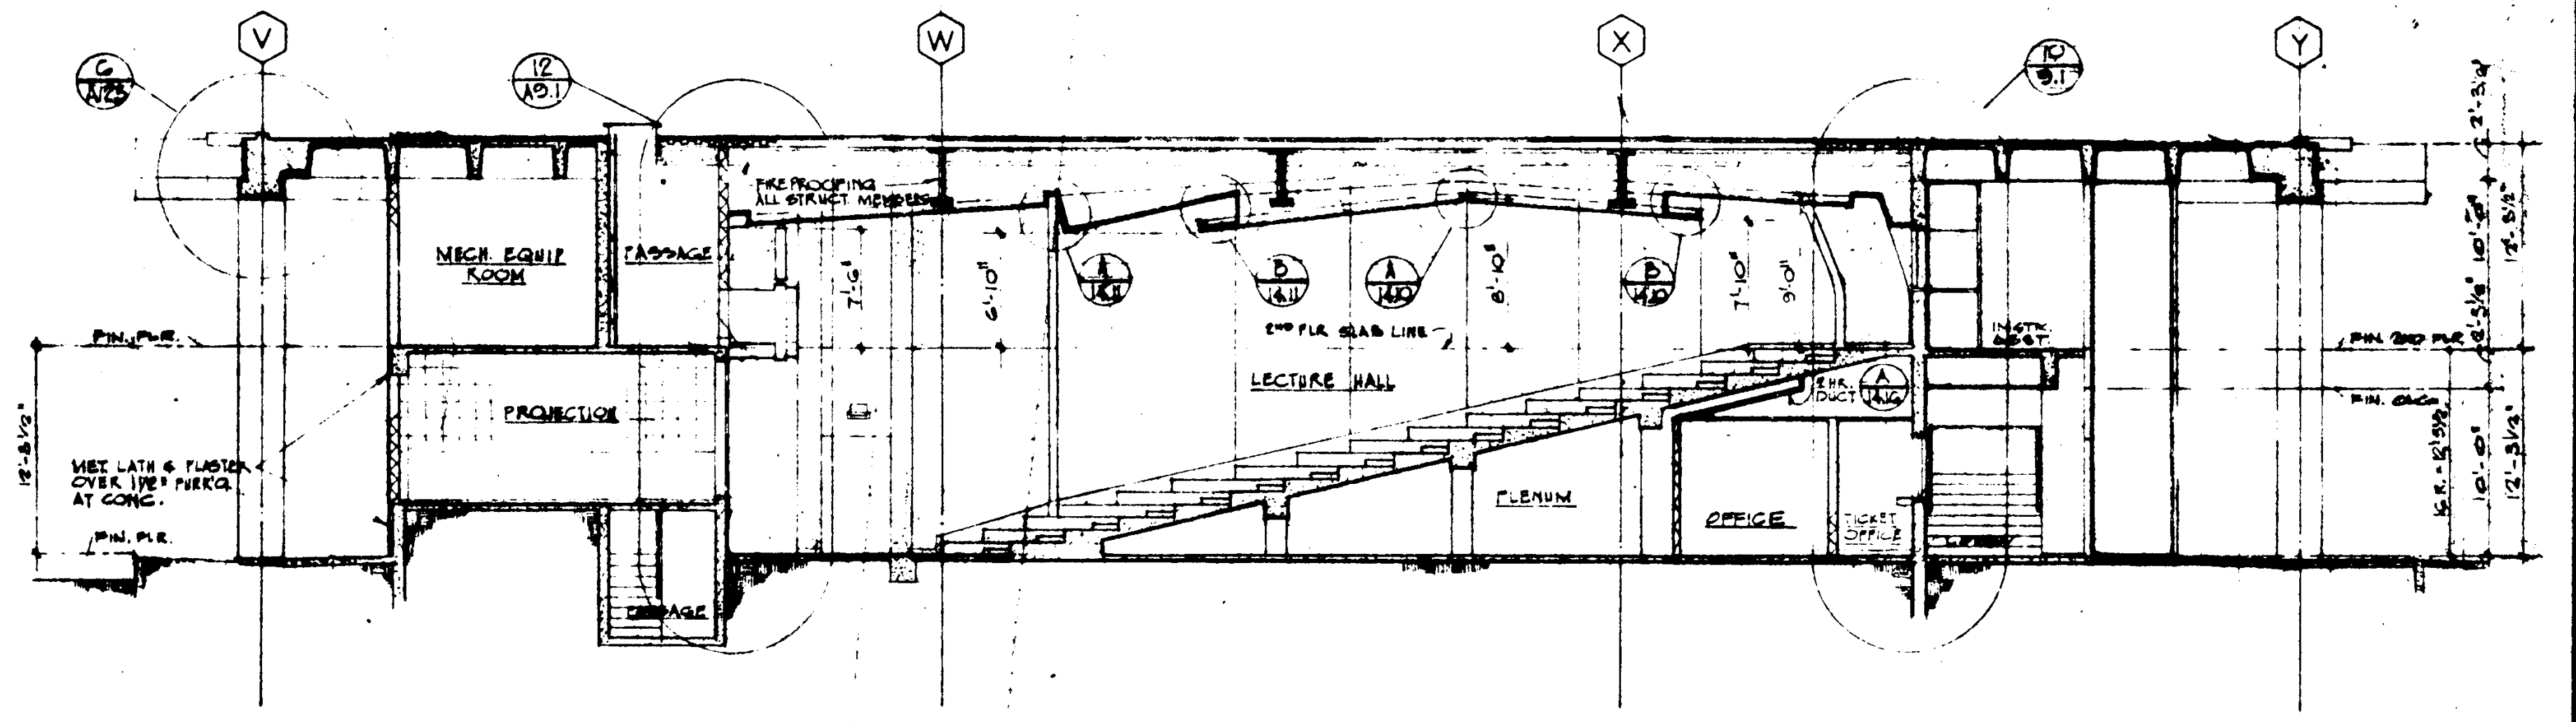
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UNIT 1 SECTION


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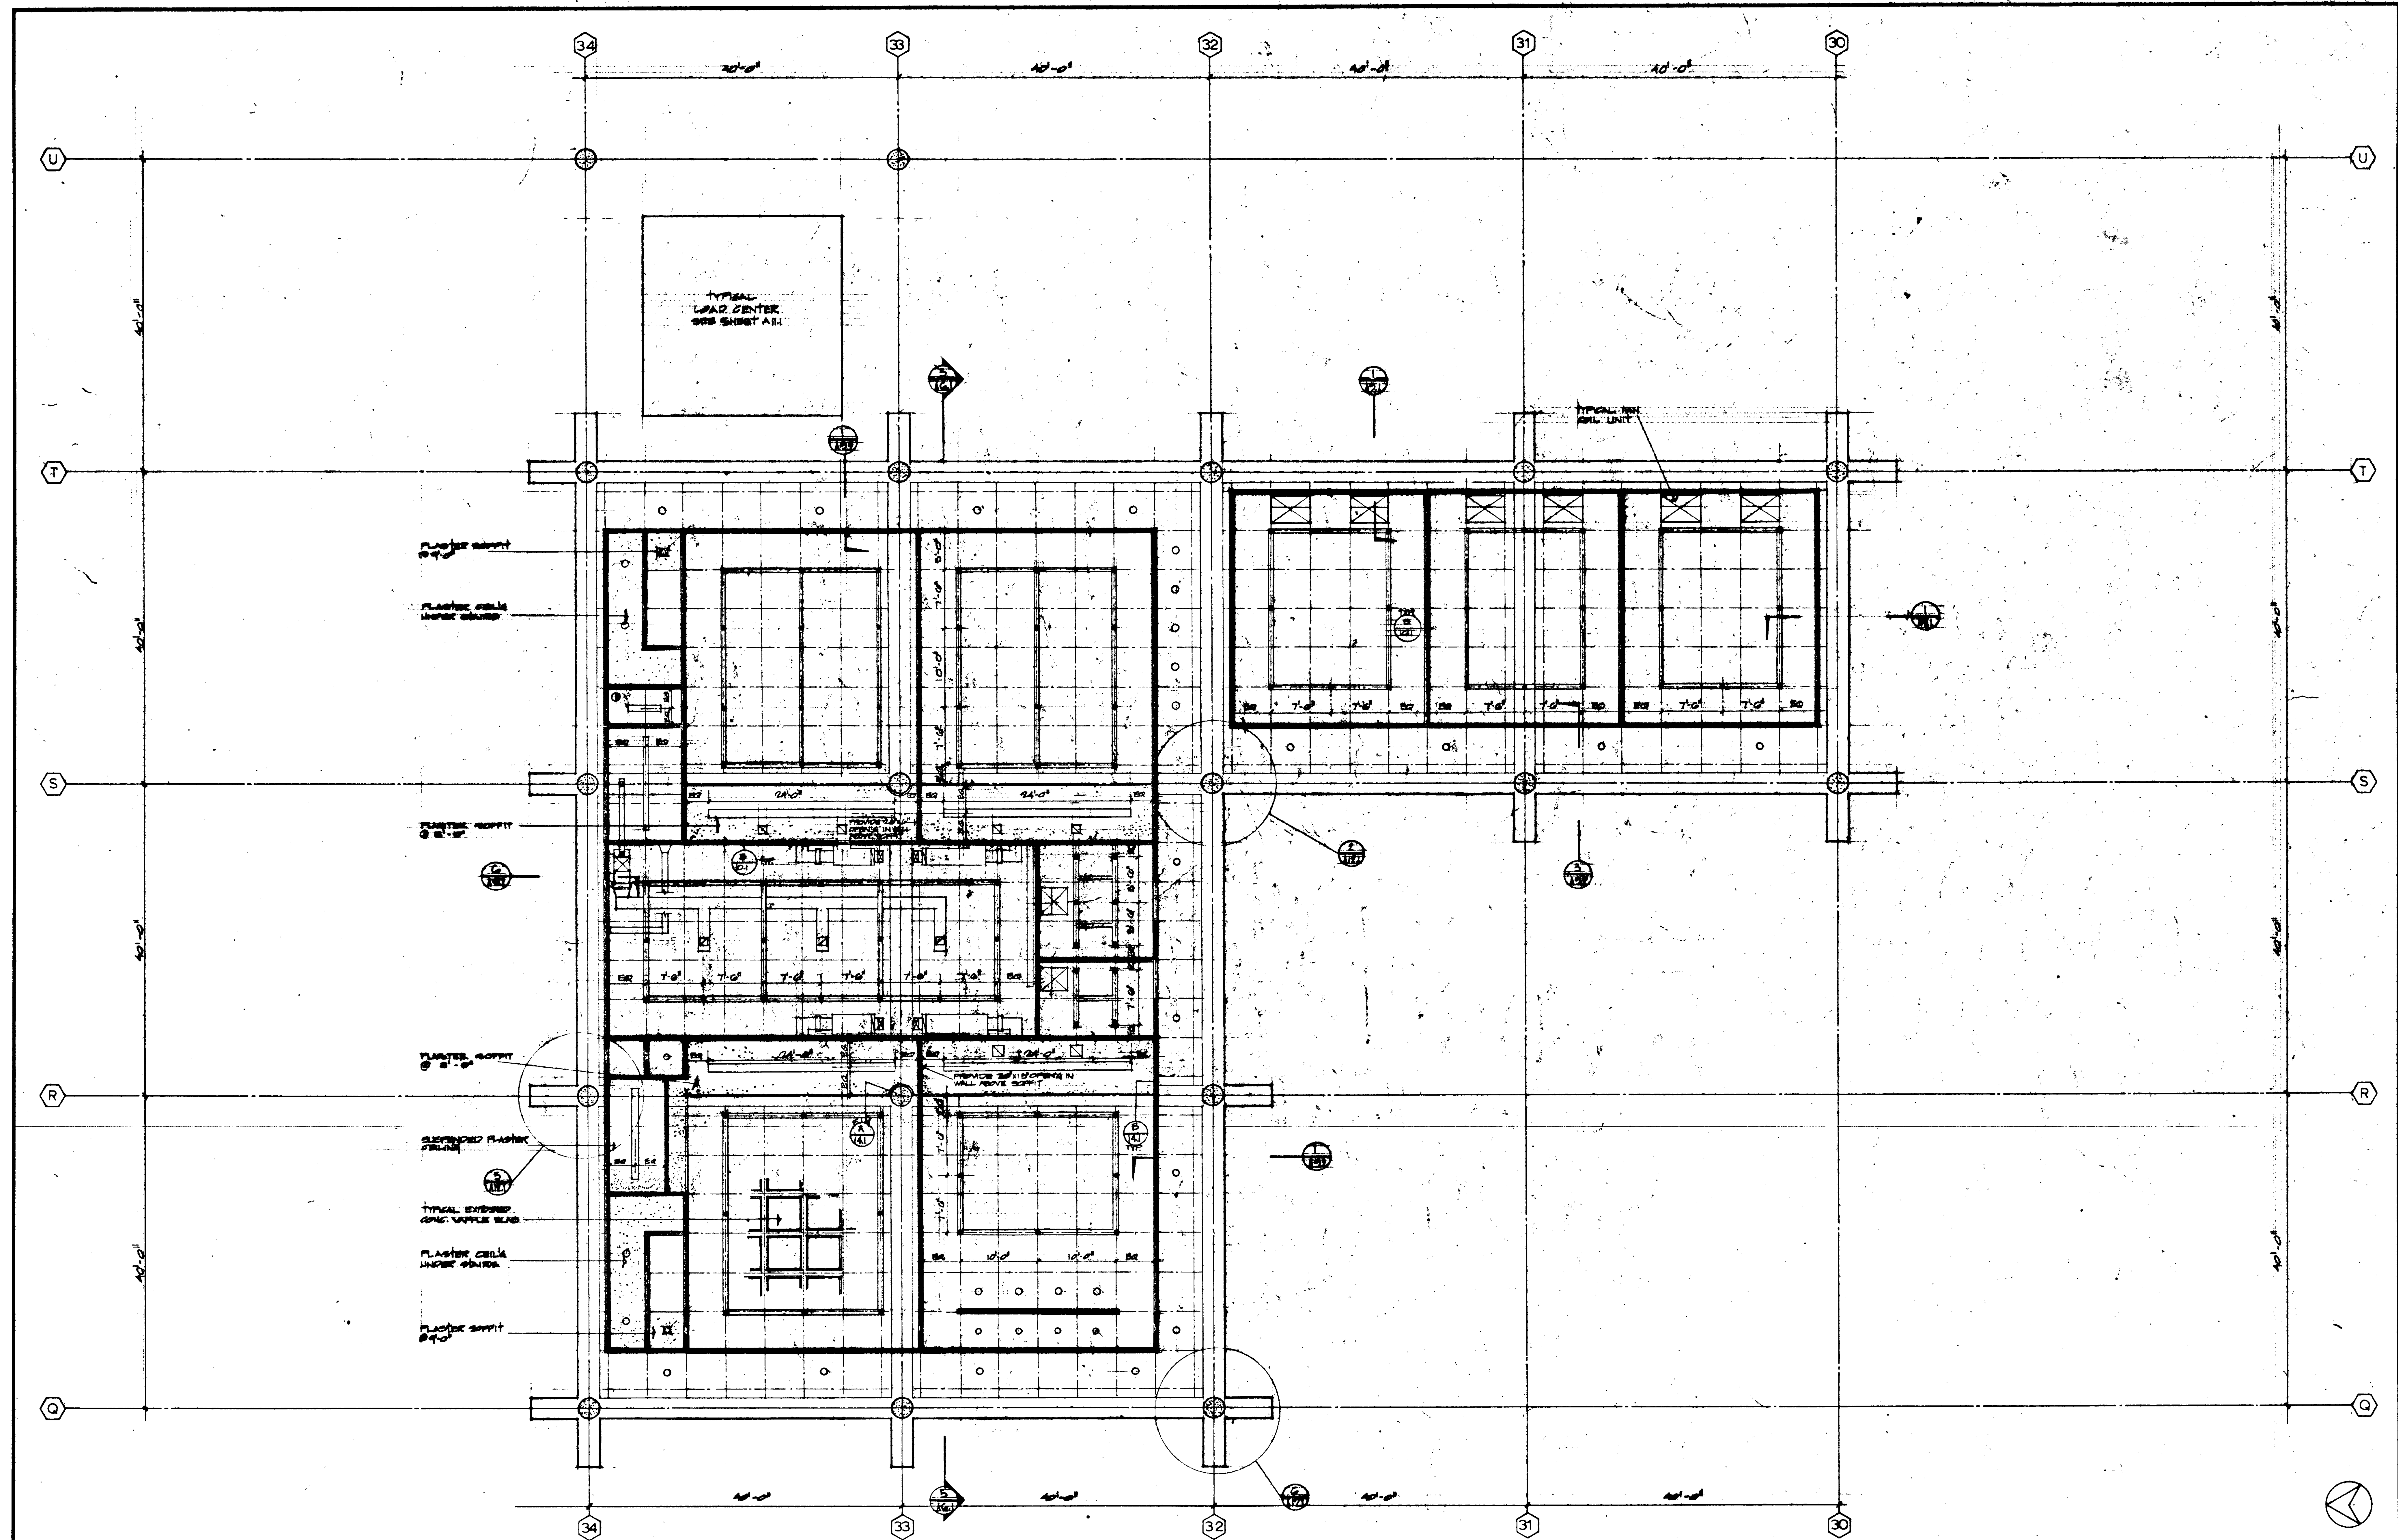
UNIT 7 SECTION

SCALE: 1/8" = 1'-0"

<p>REVISIONS</p>	<p>DESIGNED BY DRAFTER CHECKED BY APPROVED</p>	<p>DATE NOV 24 1967</p>	<p>ASSOCIATED ARCHITECTS: WILLIAM L. PEREIRA & ASSOCIATES A. QUINCY JONES-FREDERICK E. EDMUNDS & ASSOCIATES BLURCK ELLERBROCK & ASSOCIATES</p>	<p>STANIS SQUARE • MACARTHUR BOULEVARD AT PORS ROAD TELEPHONE 714/879-2500 • CORONA DEL MAR, CALIFORNIA</p>	<p>GOLDEN WEST COLLEGE HUNTINGTON BEACH, CALIFORNIA ORANGE COAST JUNIOR COLLEGE DISTRICT</p>	<p>BUILDING SECTIONS DATE: 15 JUN 1967 SHEET NO. 100-1</p>
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REVISIONS DATE _____ BY _____		STRUCTURAL ENGINEERS BLANDY & JOHNSTON J. A. MARTIN & ASSOCIATES MECHANICAL ENGINEERS RALPH E. PHILLIPS, INC. ELECTRICAL ENGINEERS RALPH E. PHILLIPS, INC. CIVIL ENGINEERS O. SHURTMAN & ASSOCIATES MOFFATT & NICOL		DESIGNED J. A. MARTIN & ASSOCIATES DRAWN BY J. A. MARTIN & ASSOCIATES CHECKED BY J. A. MARTIN & ASSOCIATES COLLEGE		APPROVED STATE FIRE MARSHAL STATE OF CALIFORNIA DATE JULY 1 1955 25874		ASSOCIATED ARCHITECTS: WILLIAM L. PEREIRA & ASSOCIATES A. QUINCY JONES-FREDERICK E. EMMONS & ASSOCIATES BLUROCK ELLERBROCK & ASSOCIATES URBANUS SQUARE • MACARTHUR BOULEVARD AT FORD ROAD TELEPHONE 714/675-2640 • CORONA DEL MAR, CALIFORNIA		GOLDEN WEST COLLEGE HUNTINGTON BEACH, CALIFORNIA ORANGE COAST JUNIOR COLLEGE DISTRICT		BUILDING SECTIONS SCALE: 1/8" = 1'-0" JOB NO. 104 DATE 15 JUN 1955 SHEET NO. A 22	
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FIRST FLOOR										SCALE	1
										JOB NO.	100-1
										DATE	15 JUN 1966
										SHEET NO.	A 7.1
										UNIT 1	
										REFLECTED	
										CEILING	
										PLAN	

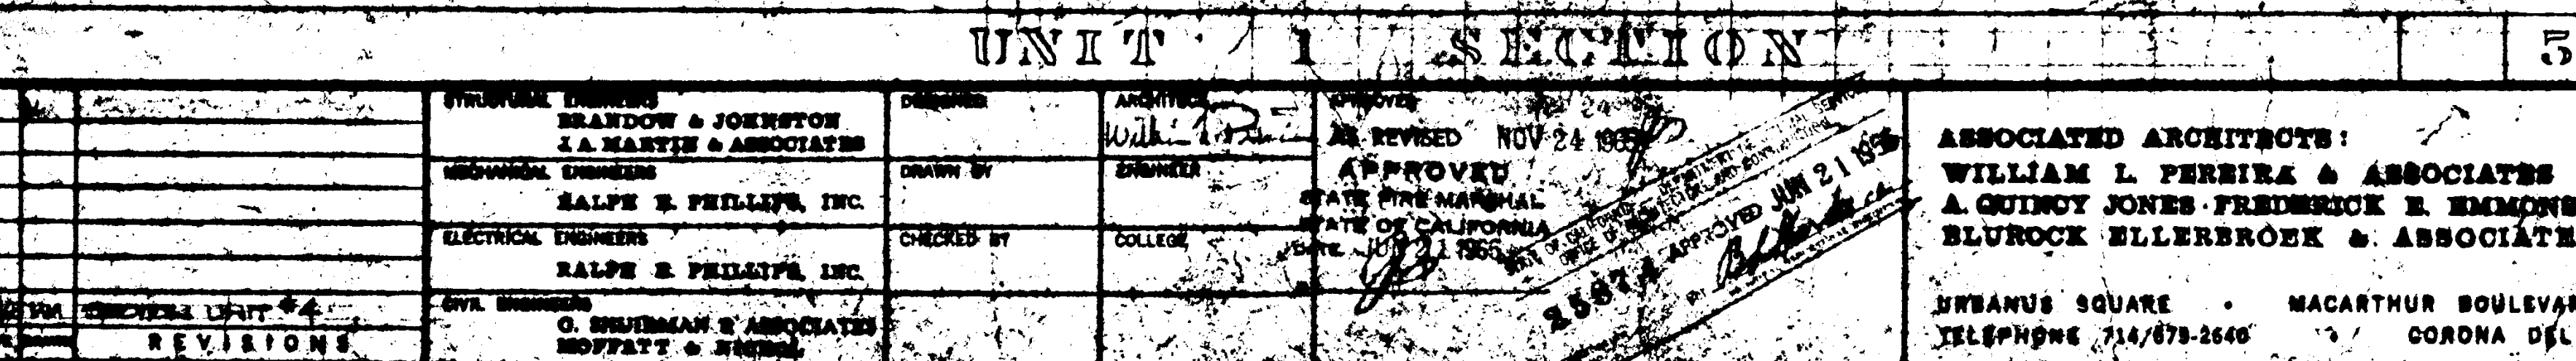DATE	REVISIONS

STRUCTURAL ENGINEERS BRANDOW & JOHNSTON J.A. MARTIN & ASSOCIATES	DESIGNED W. PADGALSKY	ARCHITECT W. L. PEREIRA	APPROVED STATE FIRE MARSHAL JUN 21 1966
MECHANICAL ENGINEERS RALPH E. PHILLIPS, INC.	DRAWN BY W. PADGALSKY	ENGINEER COLLEGE	
ELECTRICAL ENGINEERS RALPH E. PHILLIPS, INC.	CHECKED BY		
CIVIL ENGINEERS G. SHURMAN & ASSOCIATES MOFFATT & NICOL			

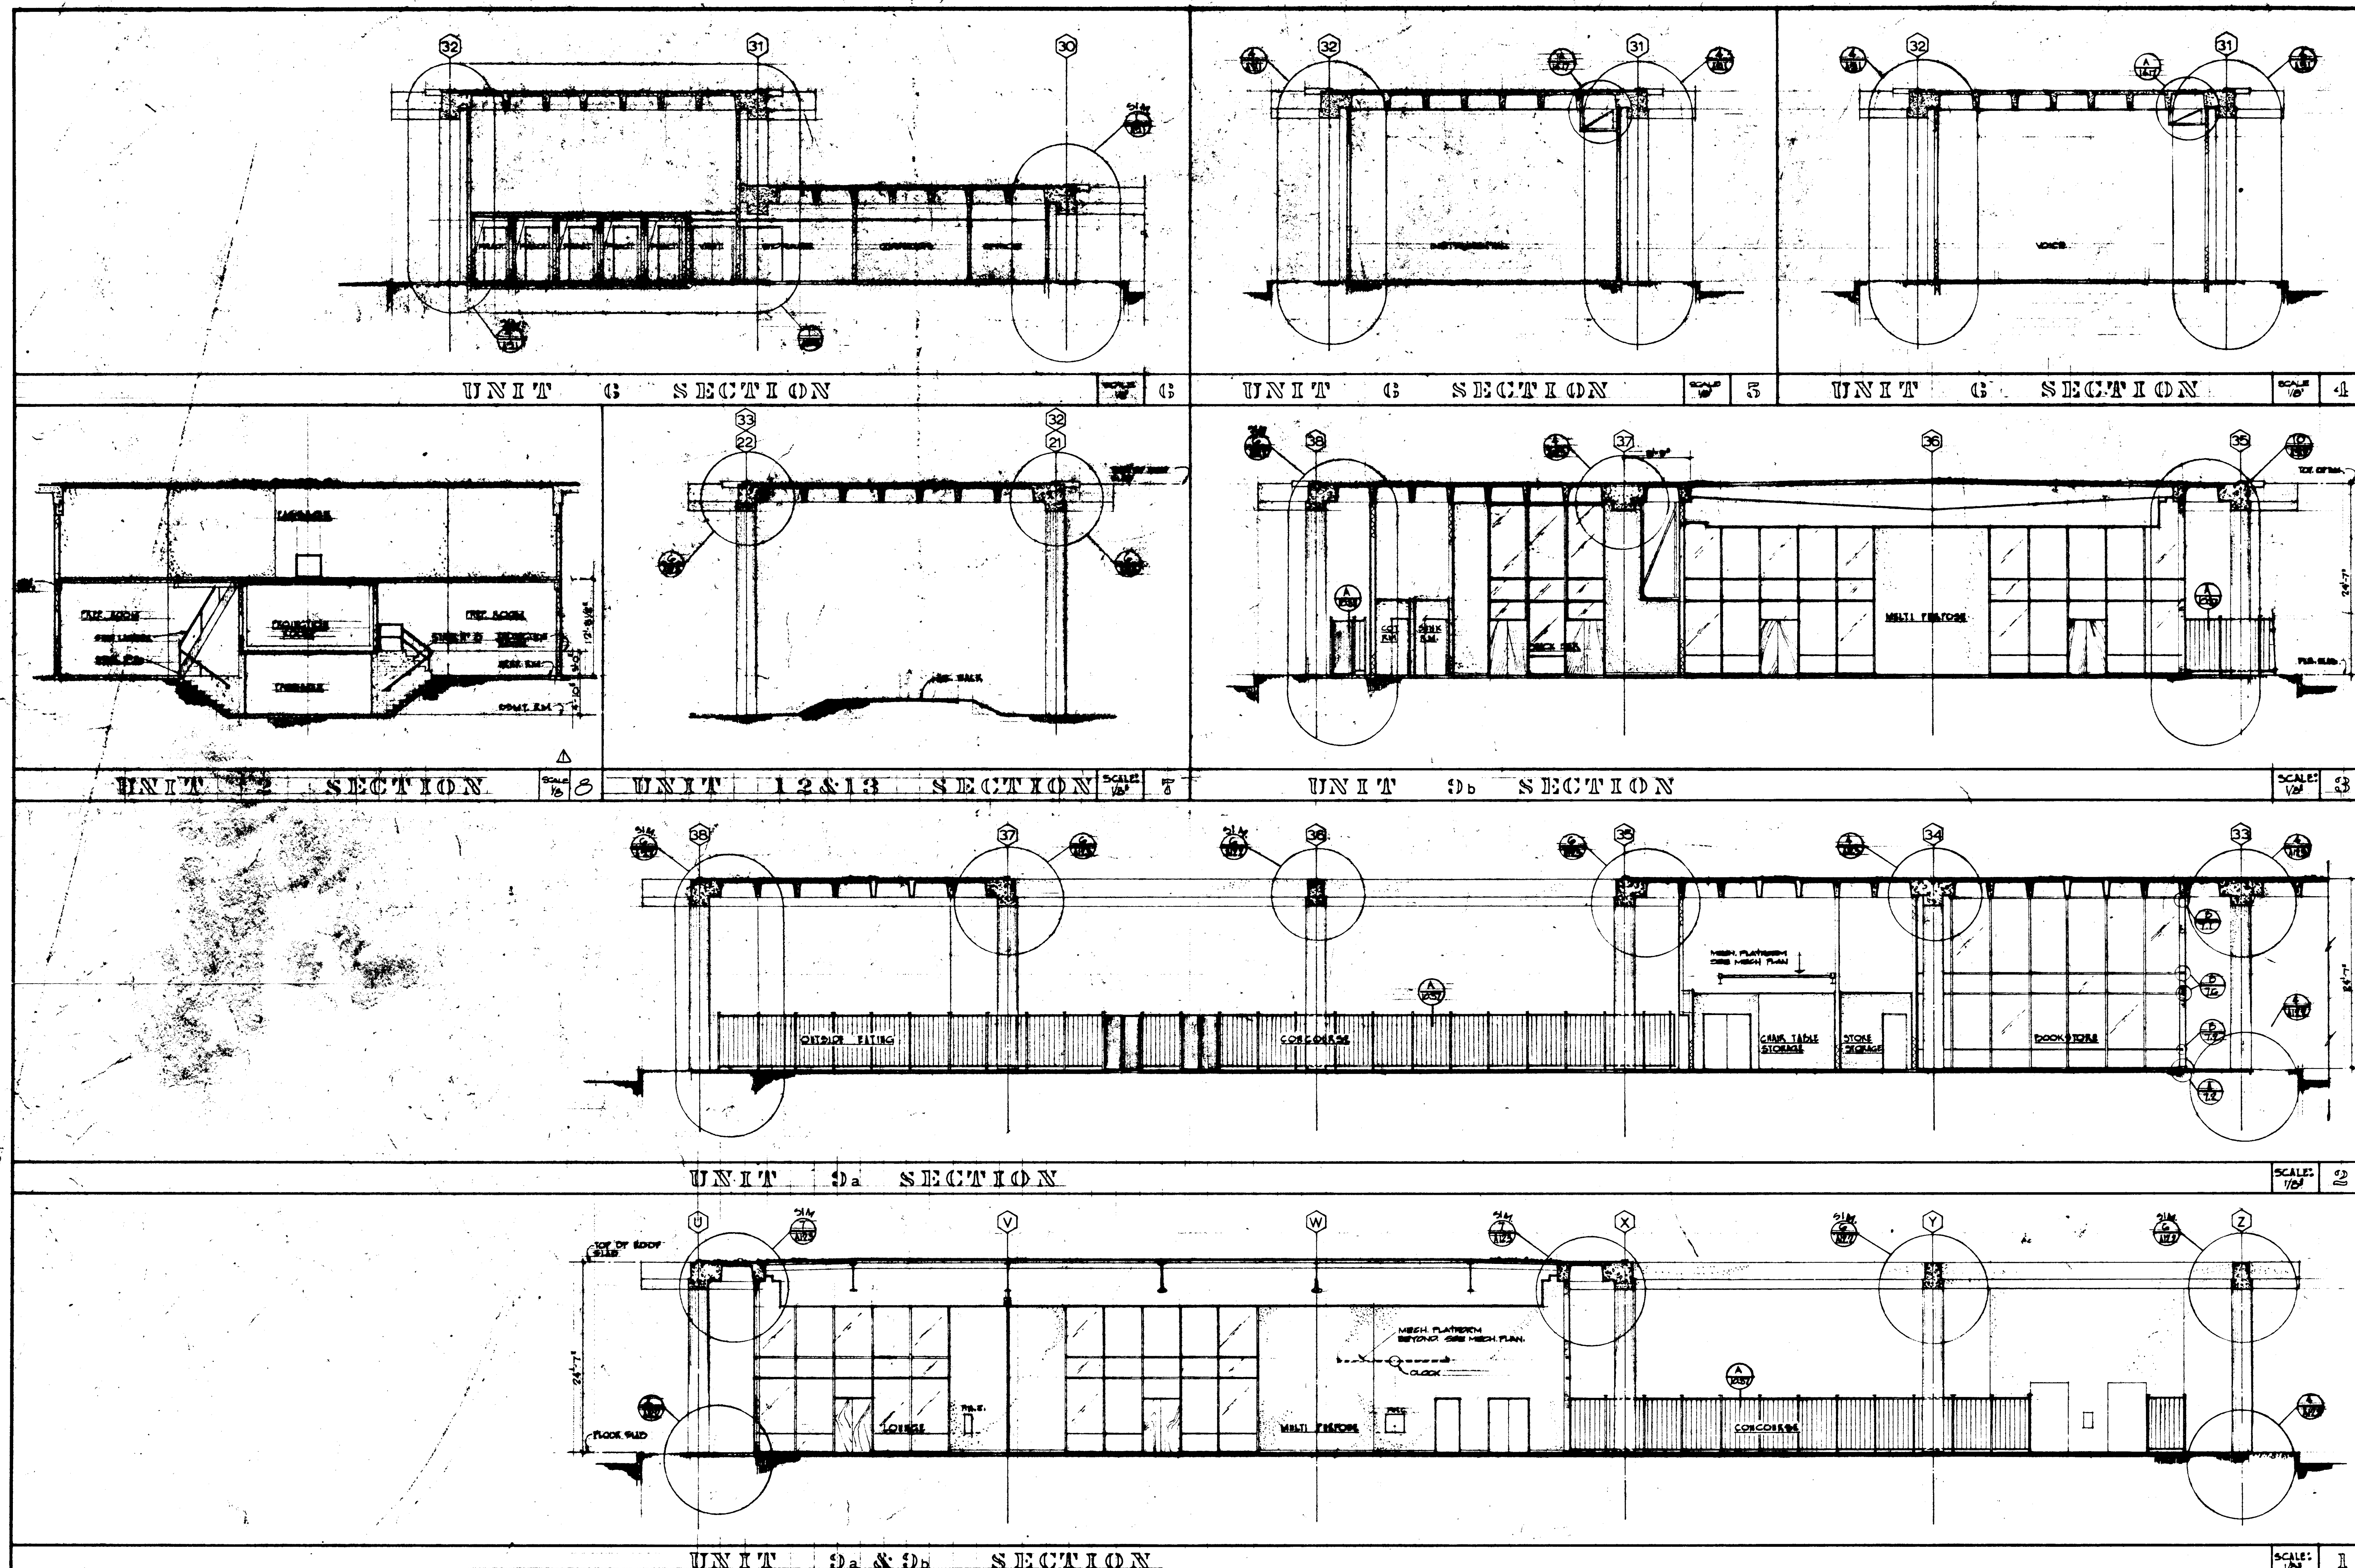
APPROVED STATE FIRE MARSHAL JUN 21 1966	25874 APPROVED JUN 21 1966
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ASSOCIATED ARCHITECTS: WILLIAM L. PEREIRA & ASSOCIATES A QUINCY JONES-FREDERICK E. EMMONS & ASSOCIATES BLUROCK ELLERBROEK & ASSOCIATES


URBANUS SQUARE • MACARTHUR BOULEVARD AT FORD ROAD TELEPHONE 714/675-2640 • CORONA DEL MAR, CALIFORNIA
--

GOLDEN WEST COLLEGE HUNTINGTON BEACH, CALIFORNIA ORANGE COAST JUNIOR COLLEGE DISTRICT
--

UNIT 1
REFLECTED
CEILING
PLAN

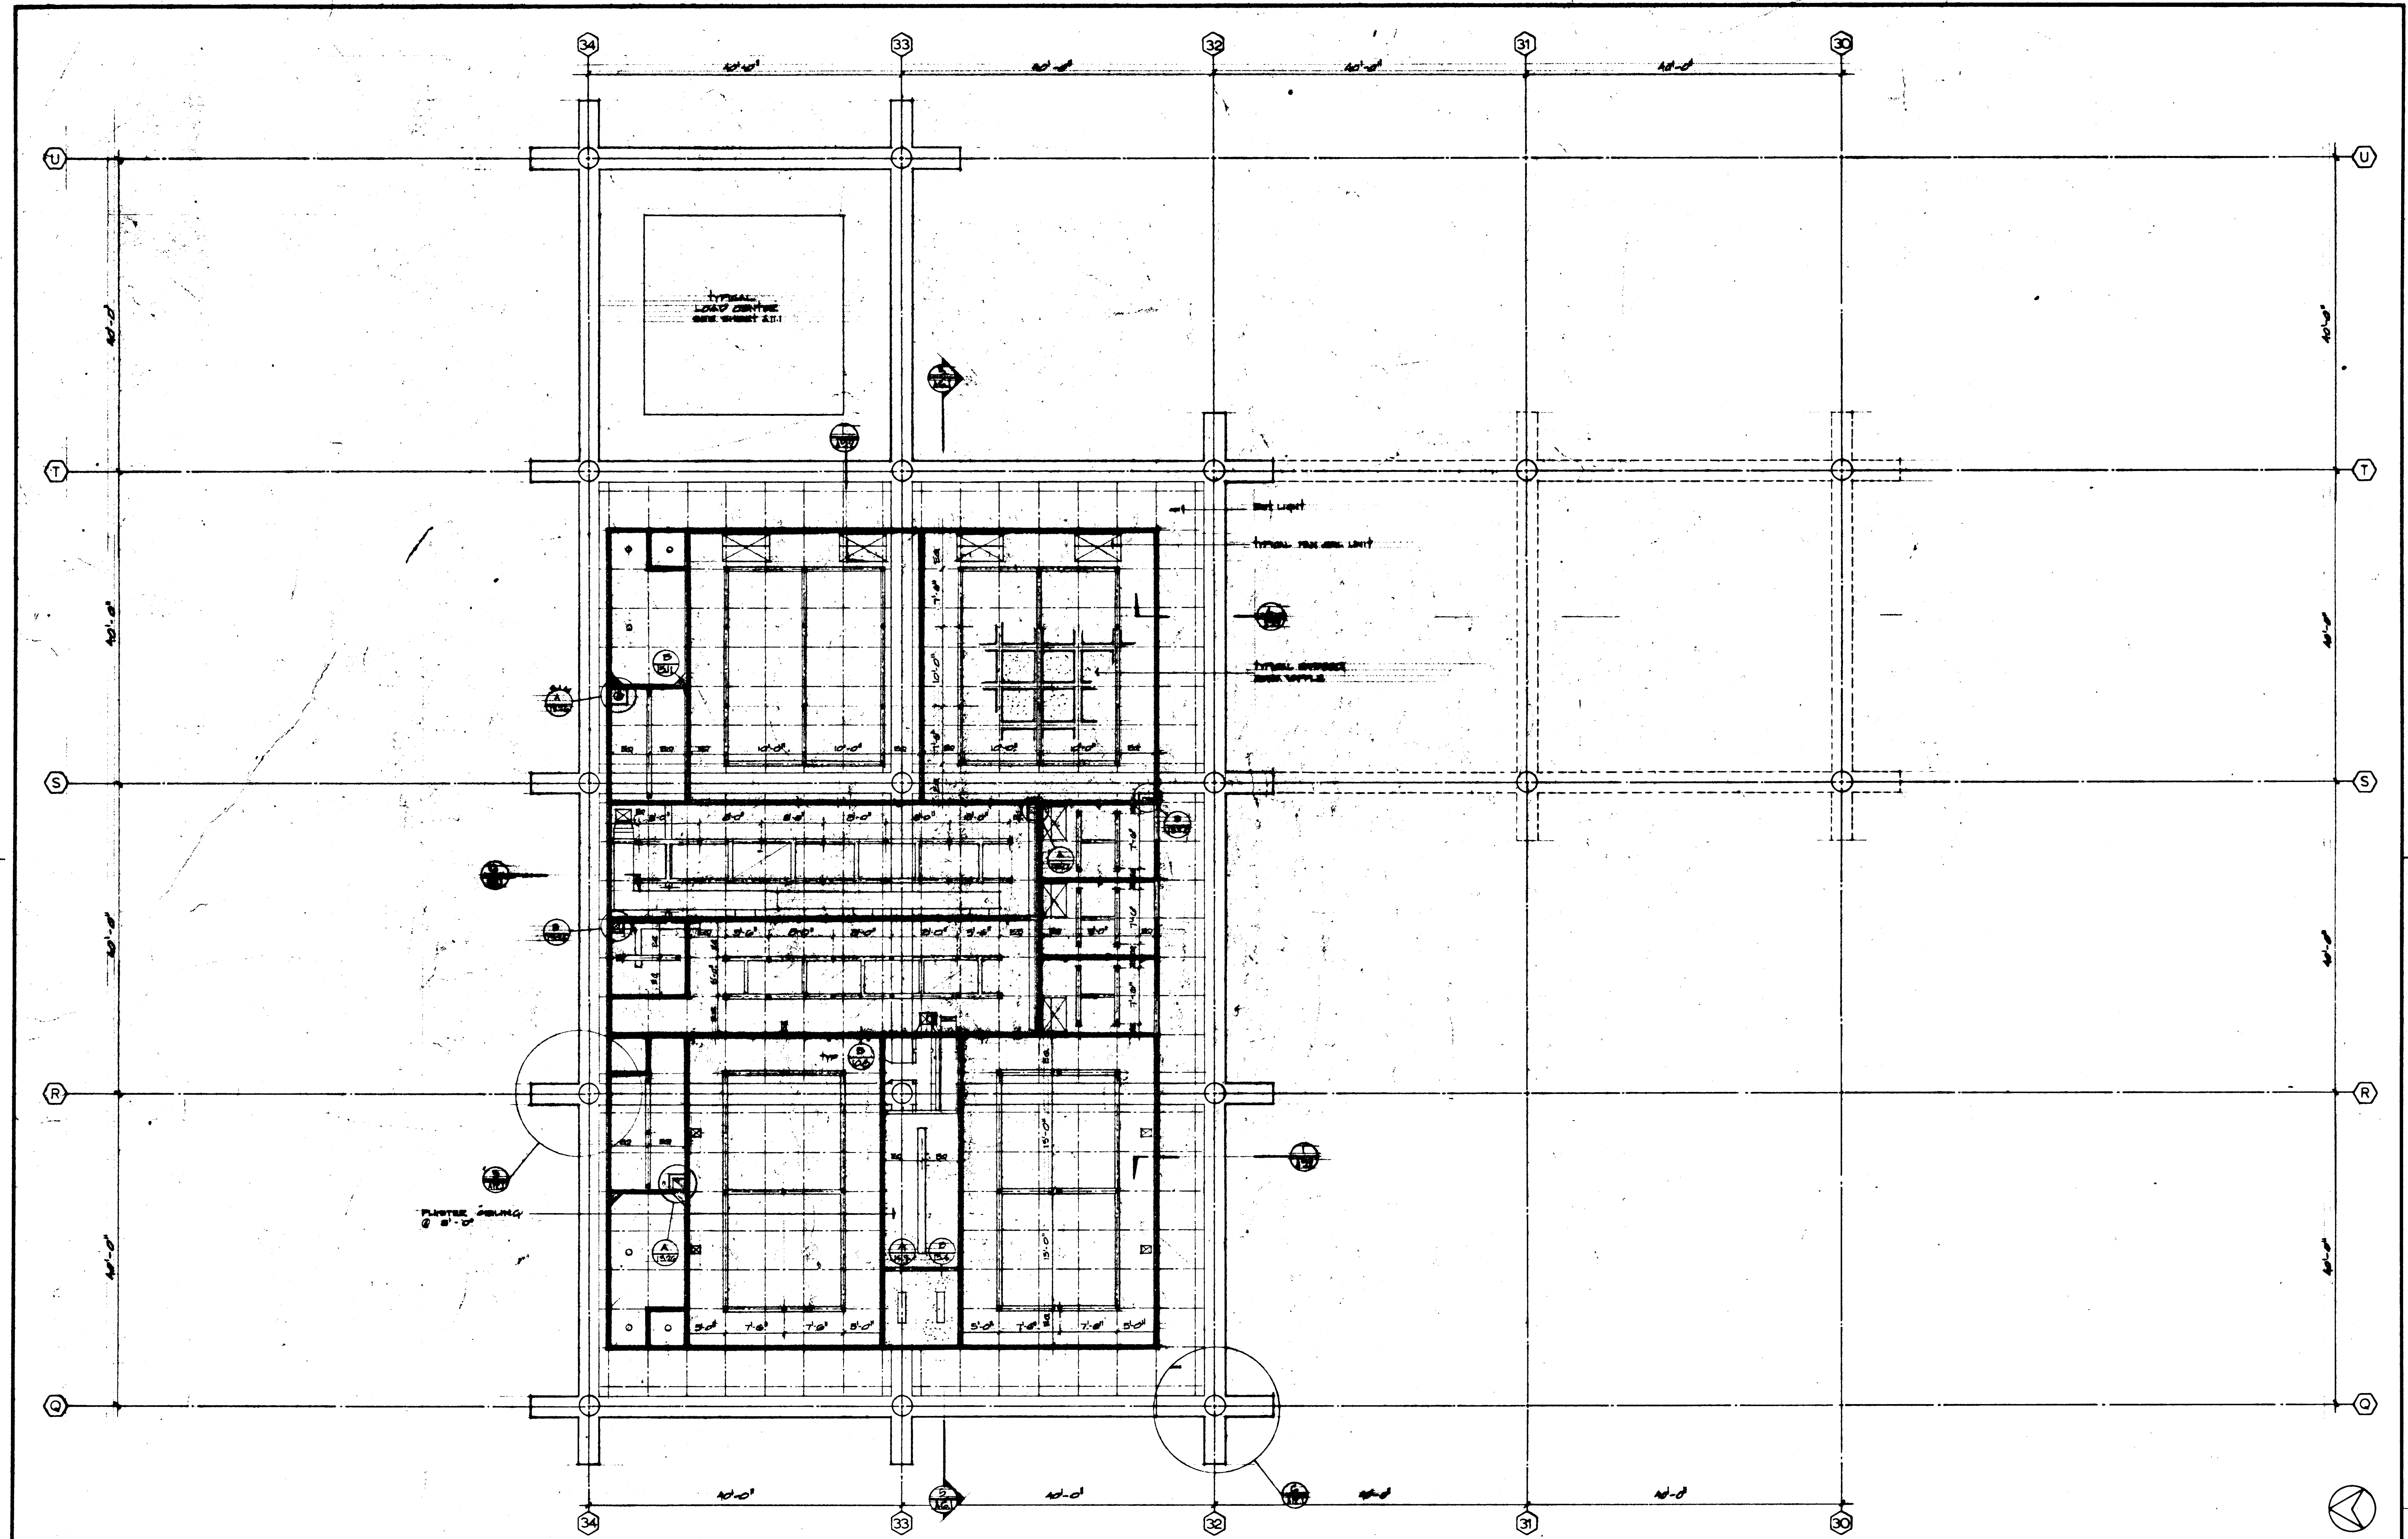


SECOND FLOOR										SCALE	1
										JOB NO.	1004
										DATE	15 JUN 1965
										SHEET NO.	A 7.2

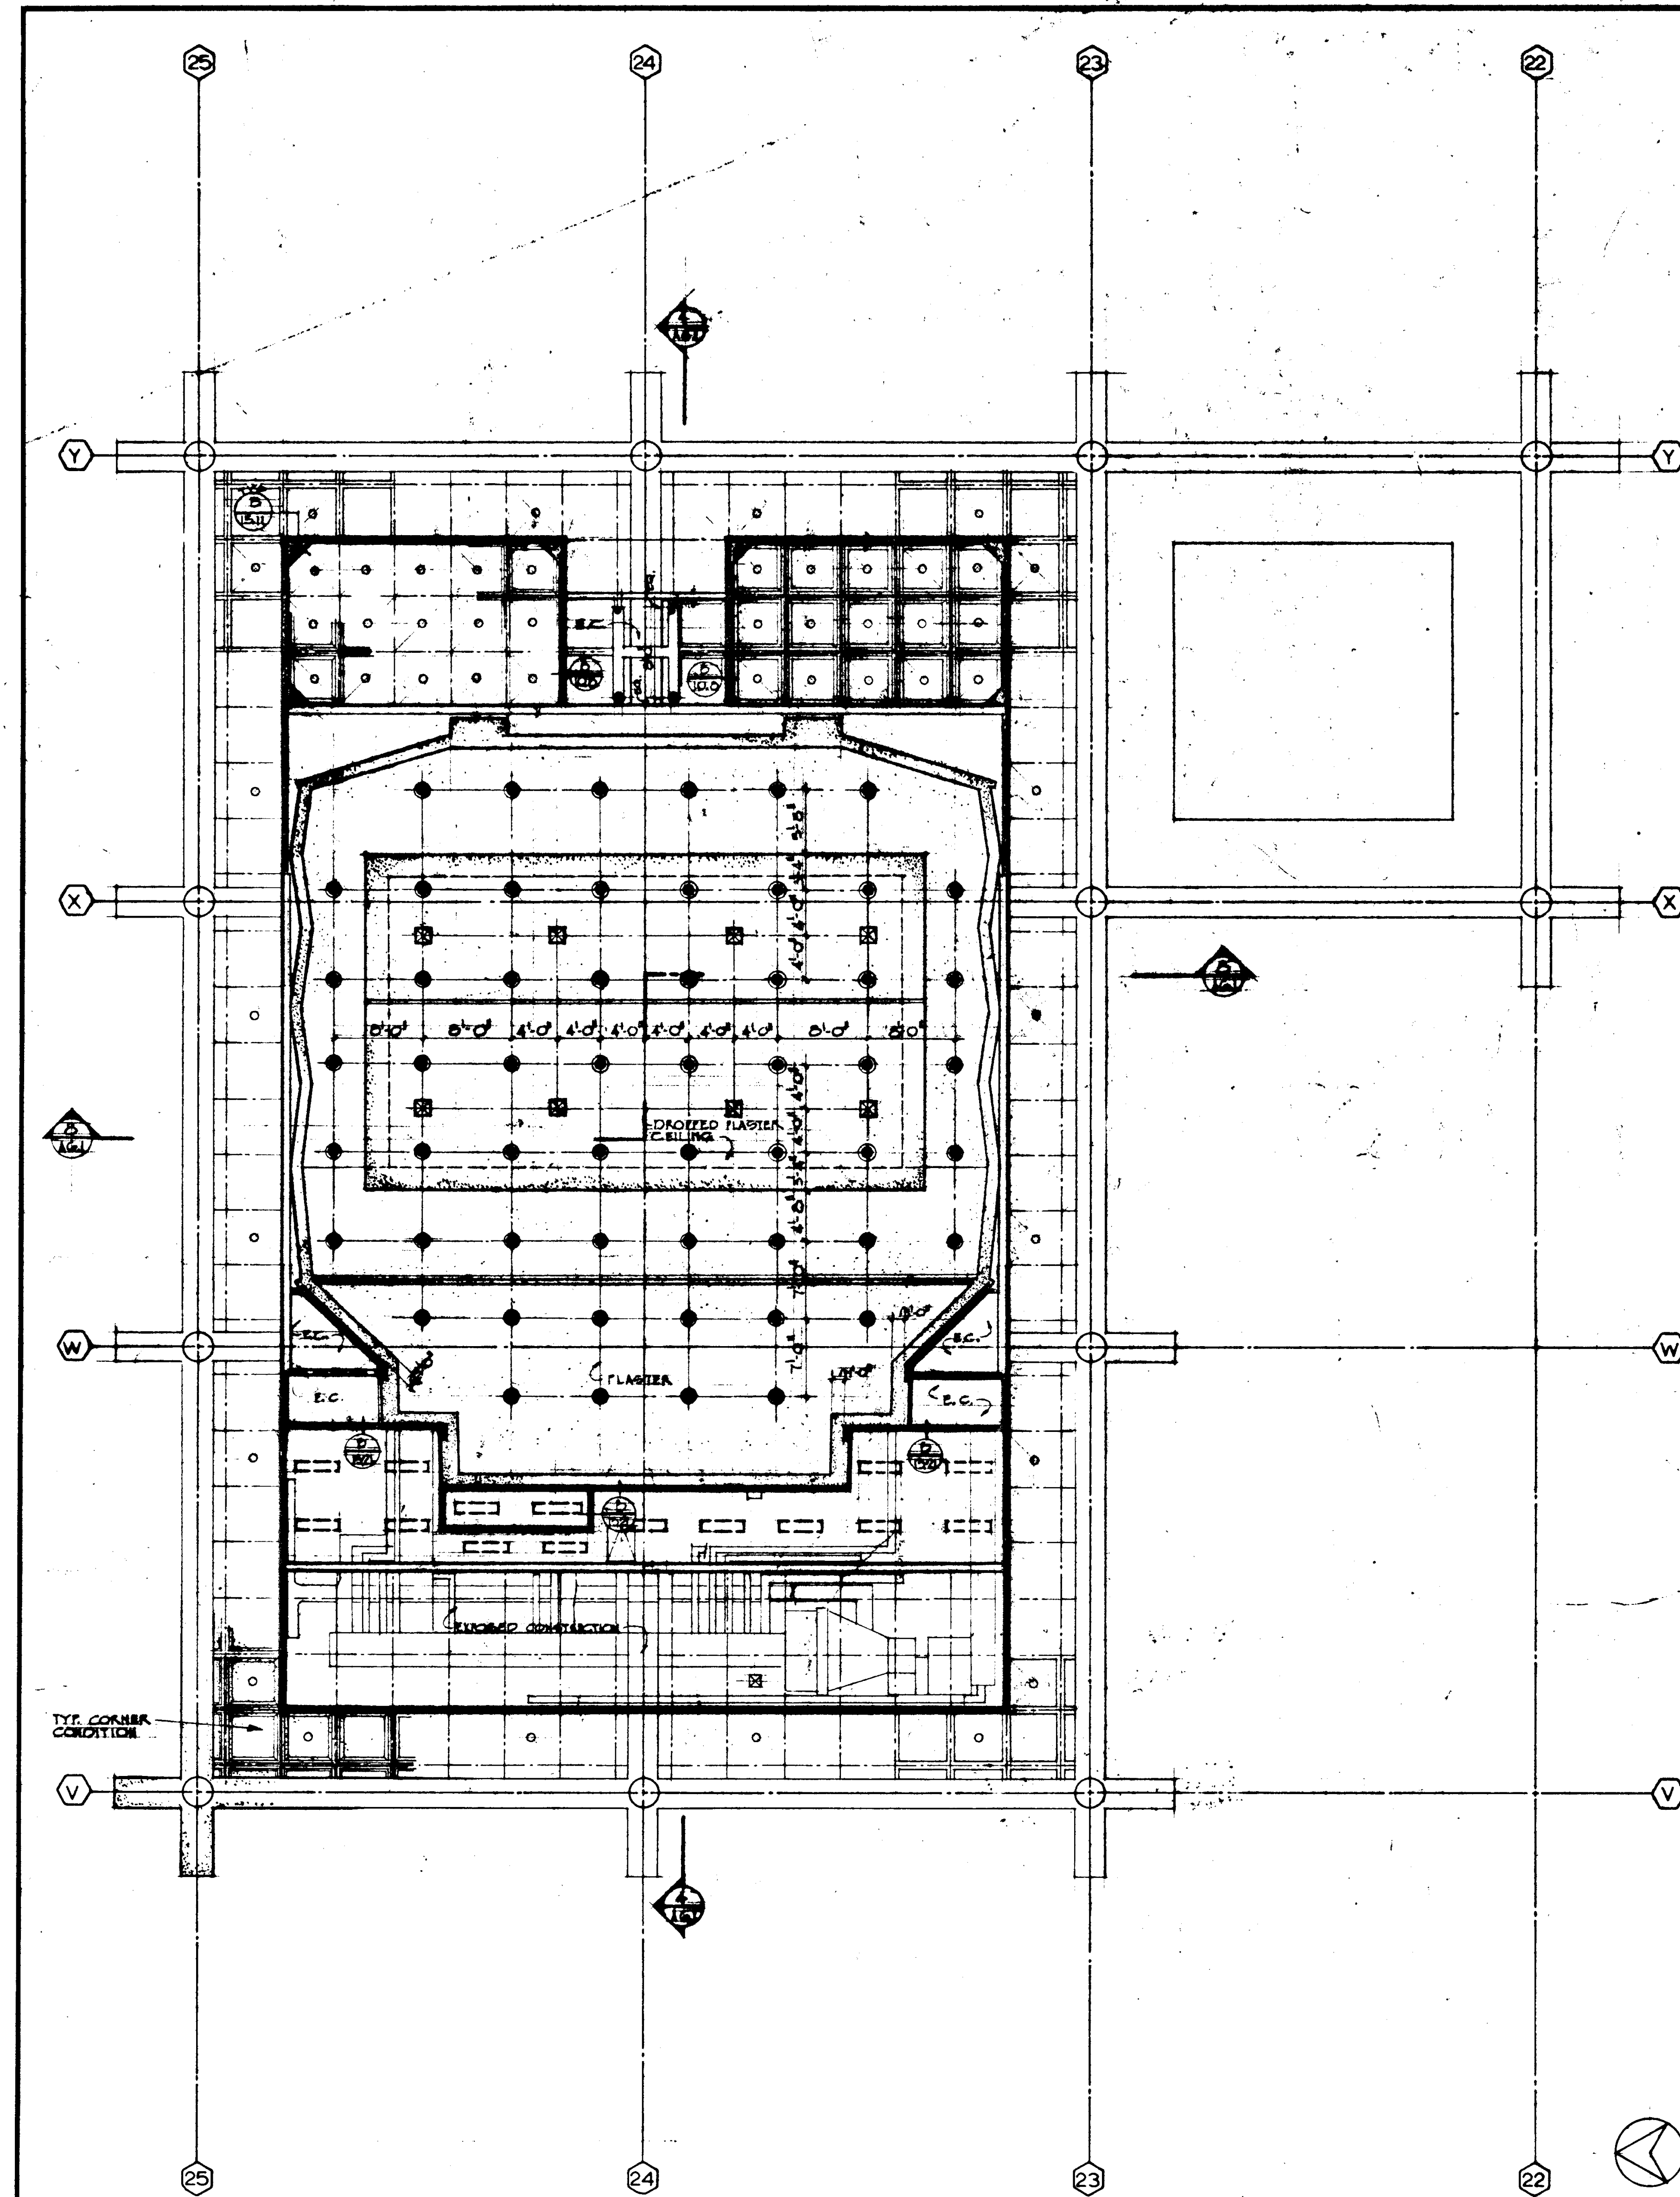

SECOND FLOOR

Scale 1/8" = 1'-0"

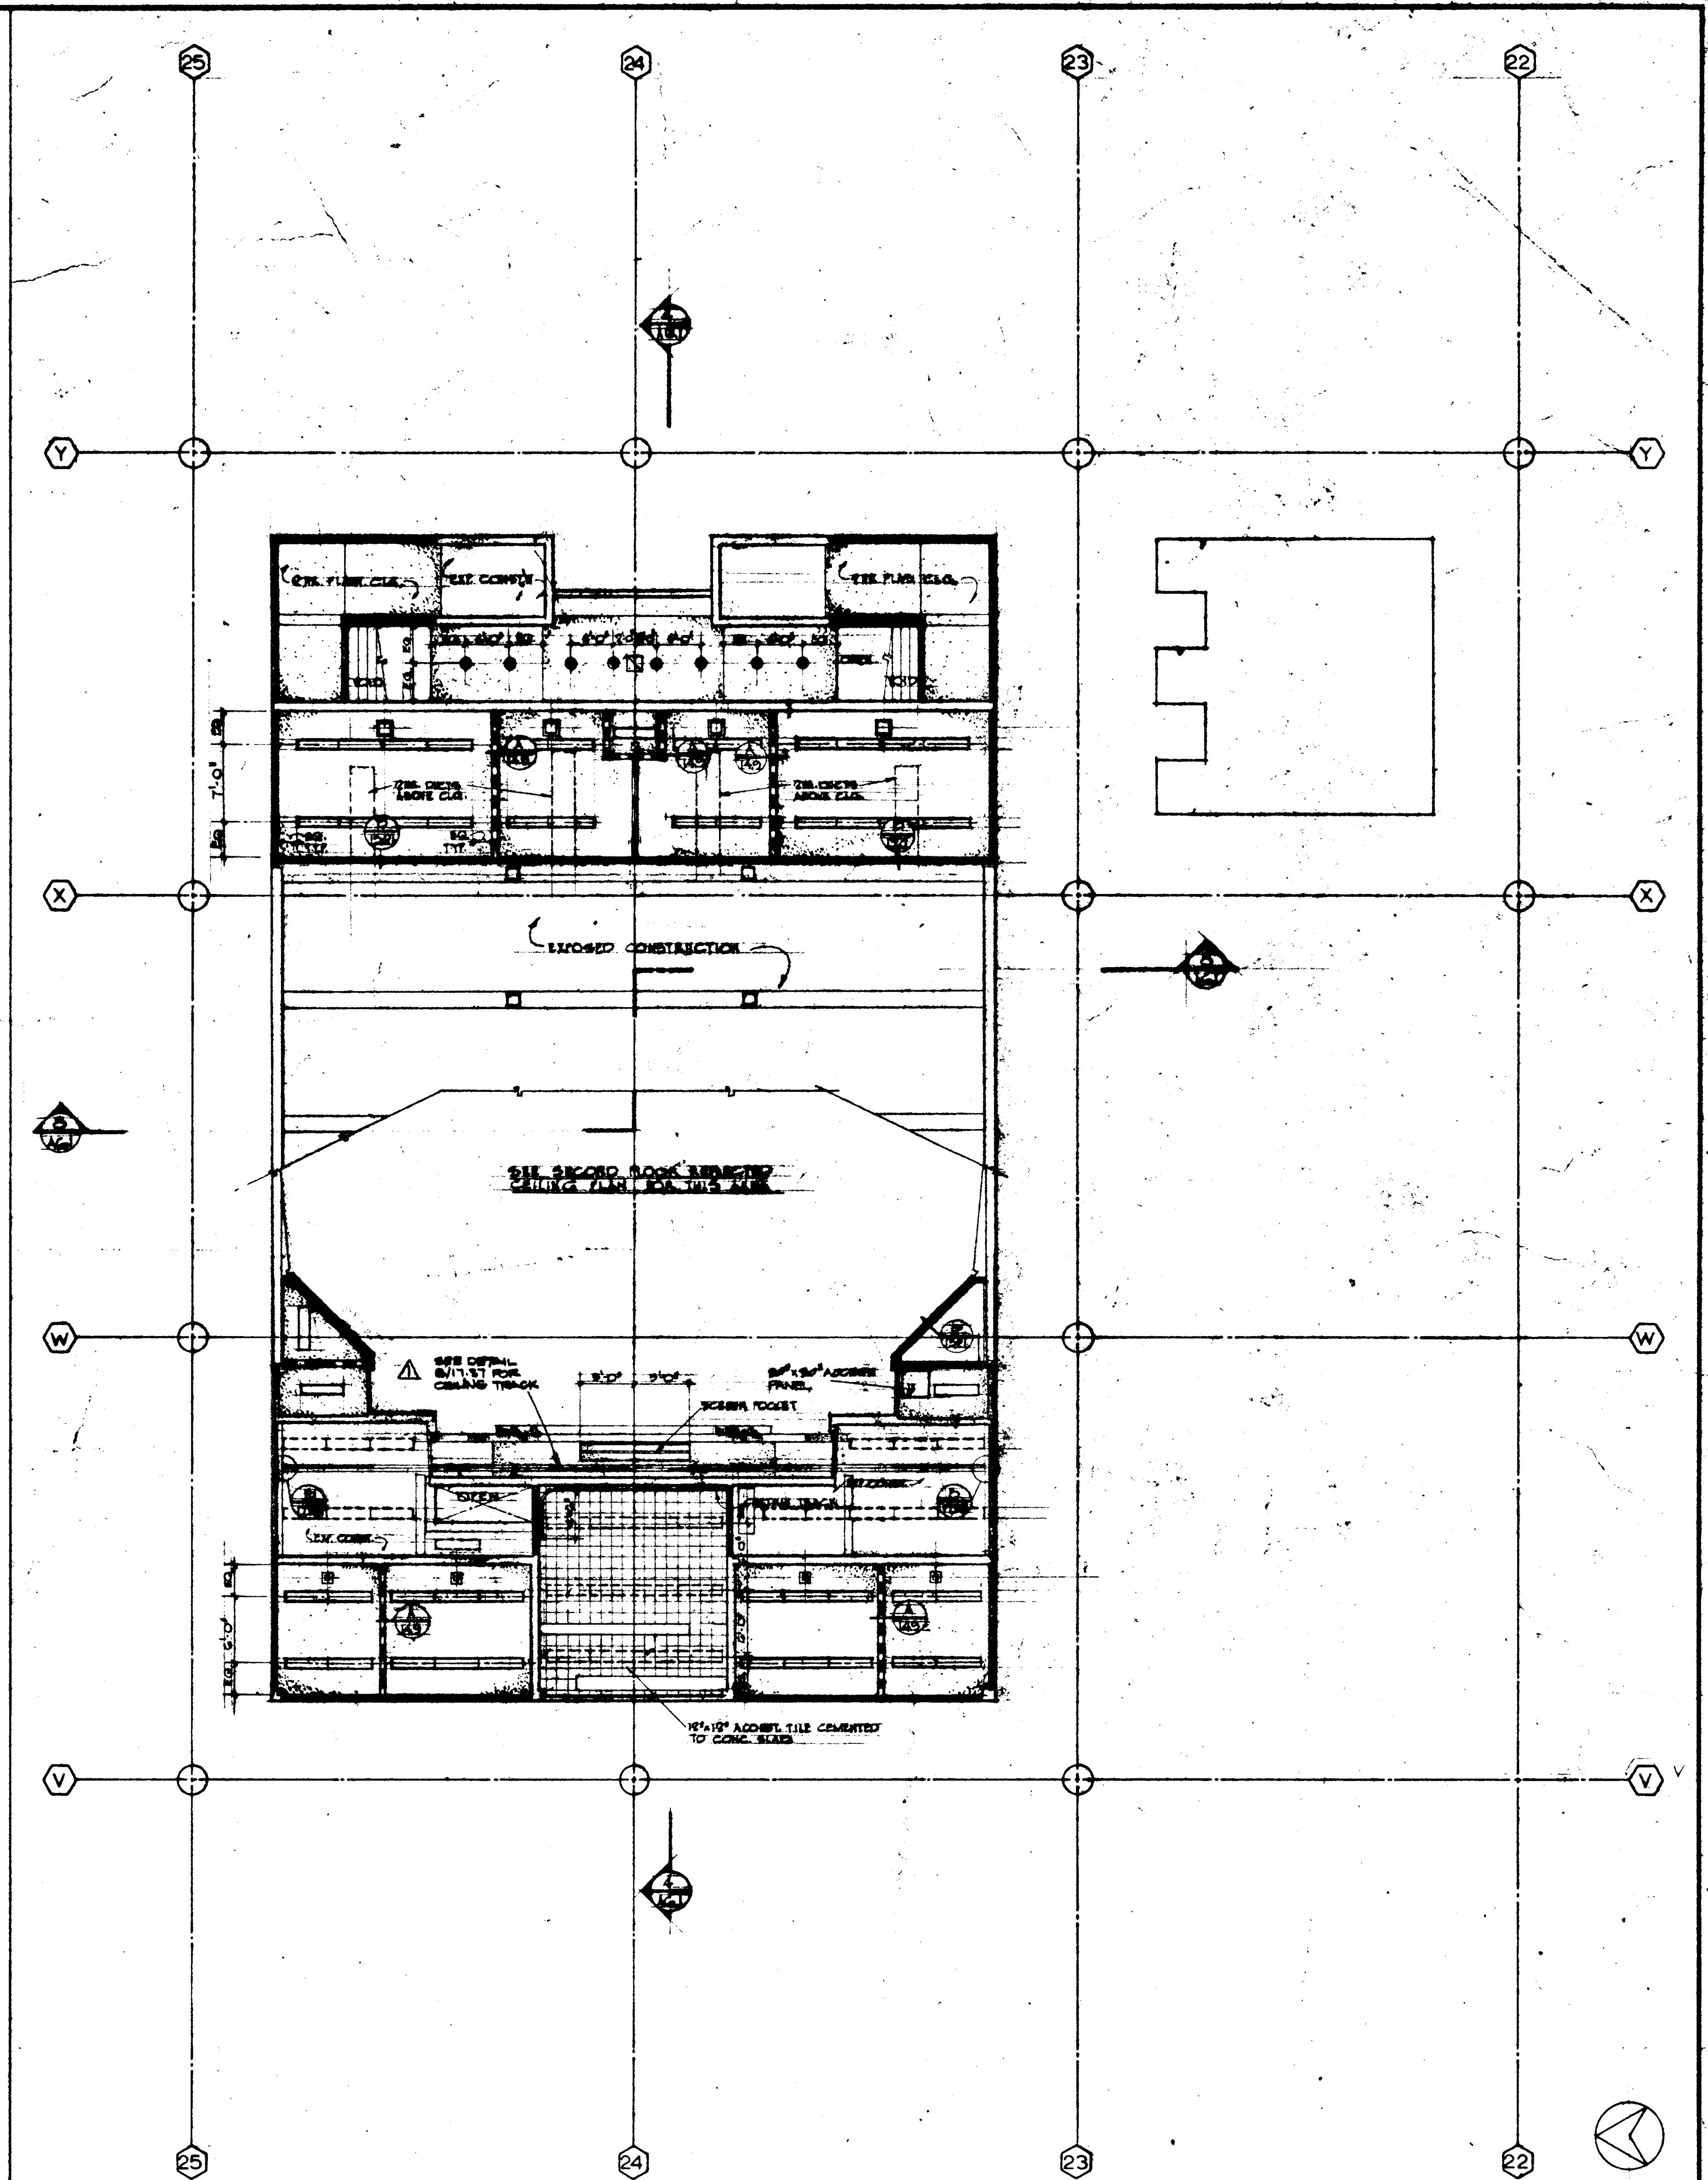

FIRST FLOOR

Scale 1/8" = 1'-0"

NO.	DATE	REVISIONS
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STRUCTURAL ENGINEERS BRANDOW & JOHNSTON J.A. MARTIN & ASSOCIATES	DESIGNED W. PADGALSKAS
MECHANICAL ENGINEERS RALPH E. PHILLIPS, INC.	DRAWN BY W. PADGALSKAS
ELECTRICAL ENGINEERS RALPH E. PHILLIPS, INC.	CHECKED BY COLLEGE
CIVIL ENGINEERS O. SHURMAN & ASSOCIATES MOFFATT & NICOL	

ARCHITECT WILLIAM L. PEREIRA & ASSOCIATES	APPROVED STATE FIRE MARSHAL STATE OF CALIFORNIA DATE JUN 21 1985
ENGINEER WILLIAM L. PEREIRA	


25874 APPROVED JUN 21 1985
OFFICE OF THE ARCHITECT AND ENGINEER
STATE OF CALIFORNIA

ASSOCIATED ARCHITECTS:
WILLIAM L. PEREIRA & ASSOCIATES
A. QUINCY JONES, FREDERICK E. EDMONS & ASSOCIATES
BLUMOCK HILBERBRONK & ASSOCIATES
URBANUS SQUARE • MACARTHUR BOULEVARD AT FORD ROAD
TELEPHONE 714/675-2640 • CORONA DEL MAR, CALIFORNIA


GOLDEN WEST COLLEGE
HUNTINGTON BEACH, CALIFORNIA
ORANGE COAST JUNIOR COLLEGE DISTRICT

UNIT 2
REFLECTED
CEILING
PLANS

SHEET NO.
A 7.3
JUN 1985

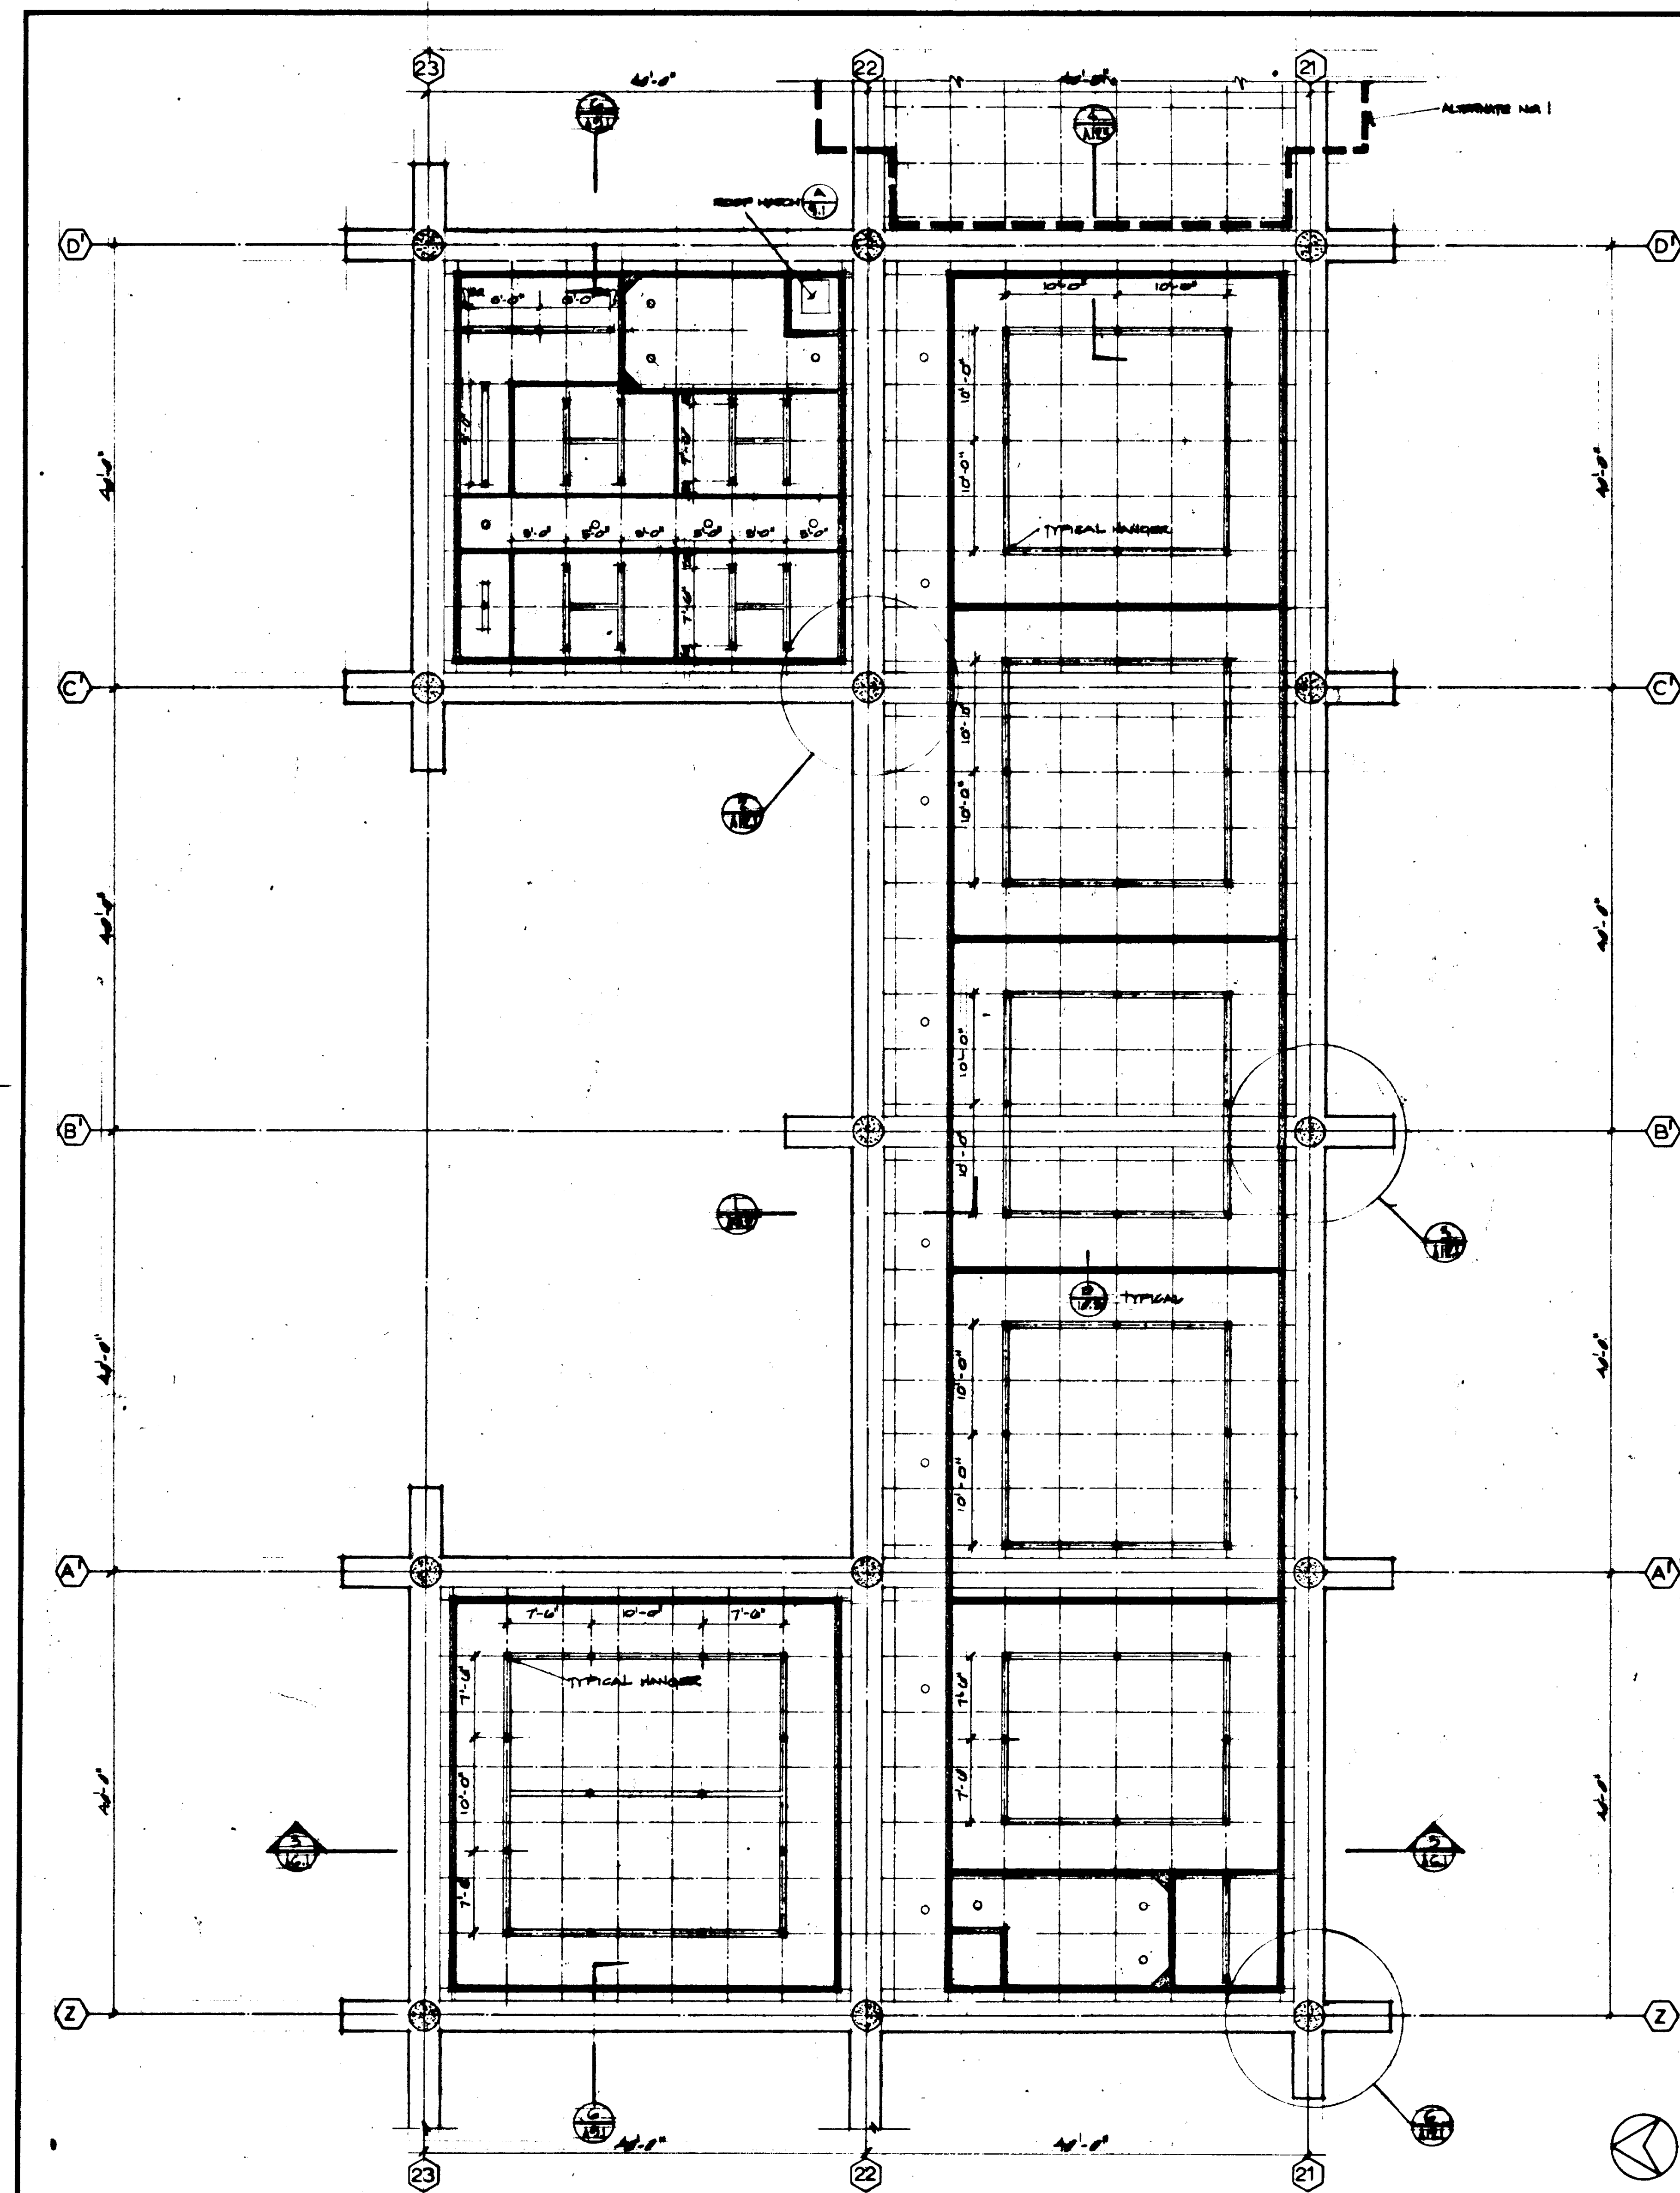

SECOND FLOOR

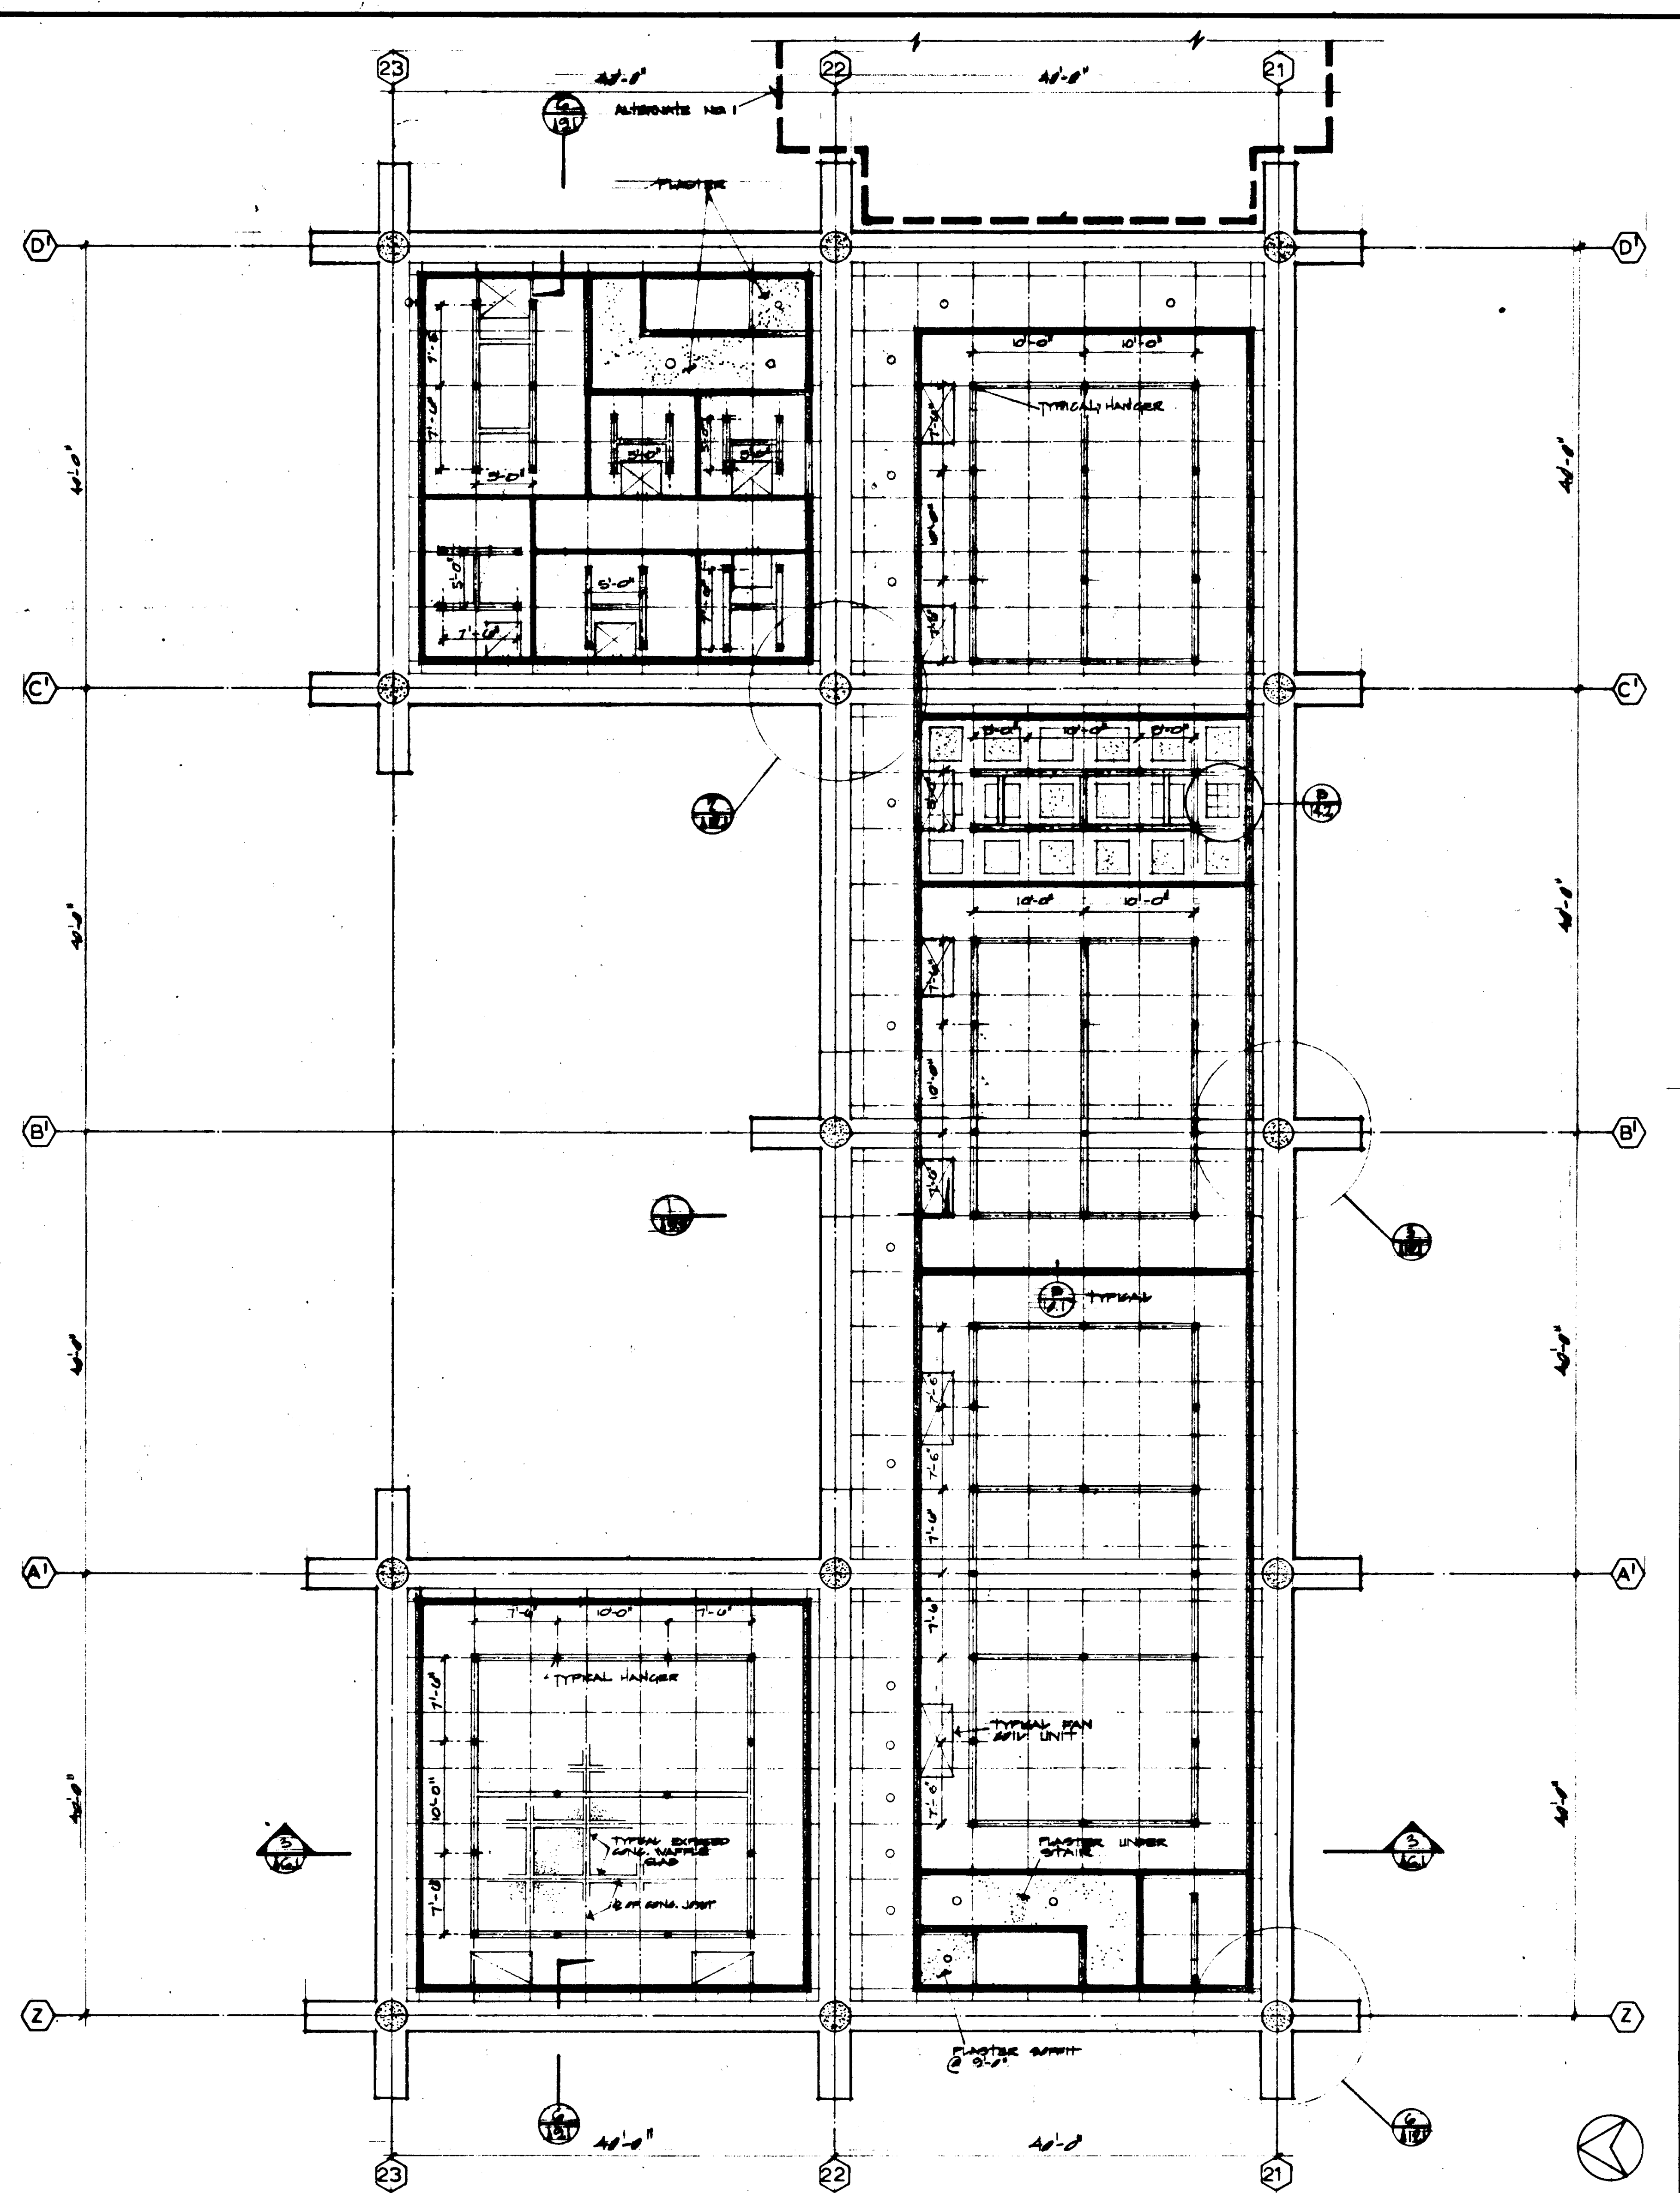

FIRST FLOOR

NO.	REVISIONS
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STRUCTURAL ENGINEER BLANDY & JOHNSTON J.A. MARTIN & ASSOCIATES	DESIGNED ARCHITECT WILLIAM L. PEREIRA & ASSOCIATES
MECHANICAL ENGINEER RALPH E. PHILLIPS, INC.	DRAWN BY W. PADRAL-SPAS
ELECTRICAL ENGINEER RALPH E. PHILLIPS, INC.	CHECKED BY COLLEGE
CIVIL ENGINEER O. SHURMAN & ASSOCIATES MOFFATT & NICHOL	

APPROVED STATE FIRE MARSHAL STATE OF CALIFORNIA DATE JUN 3 1965	APPROVED JUN 21 1965
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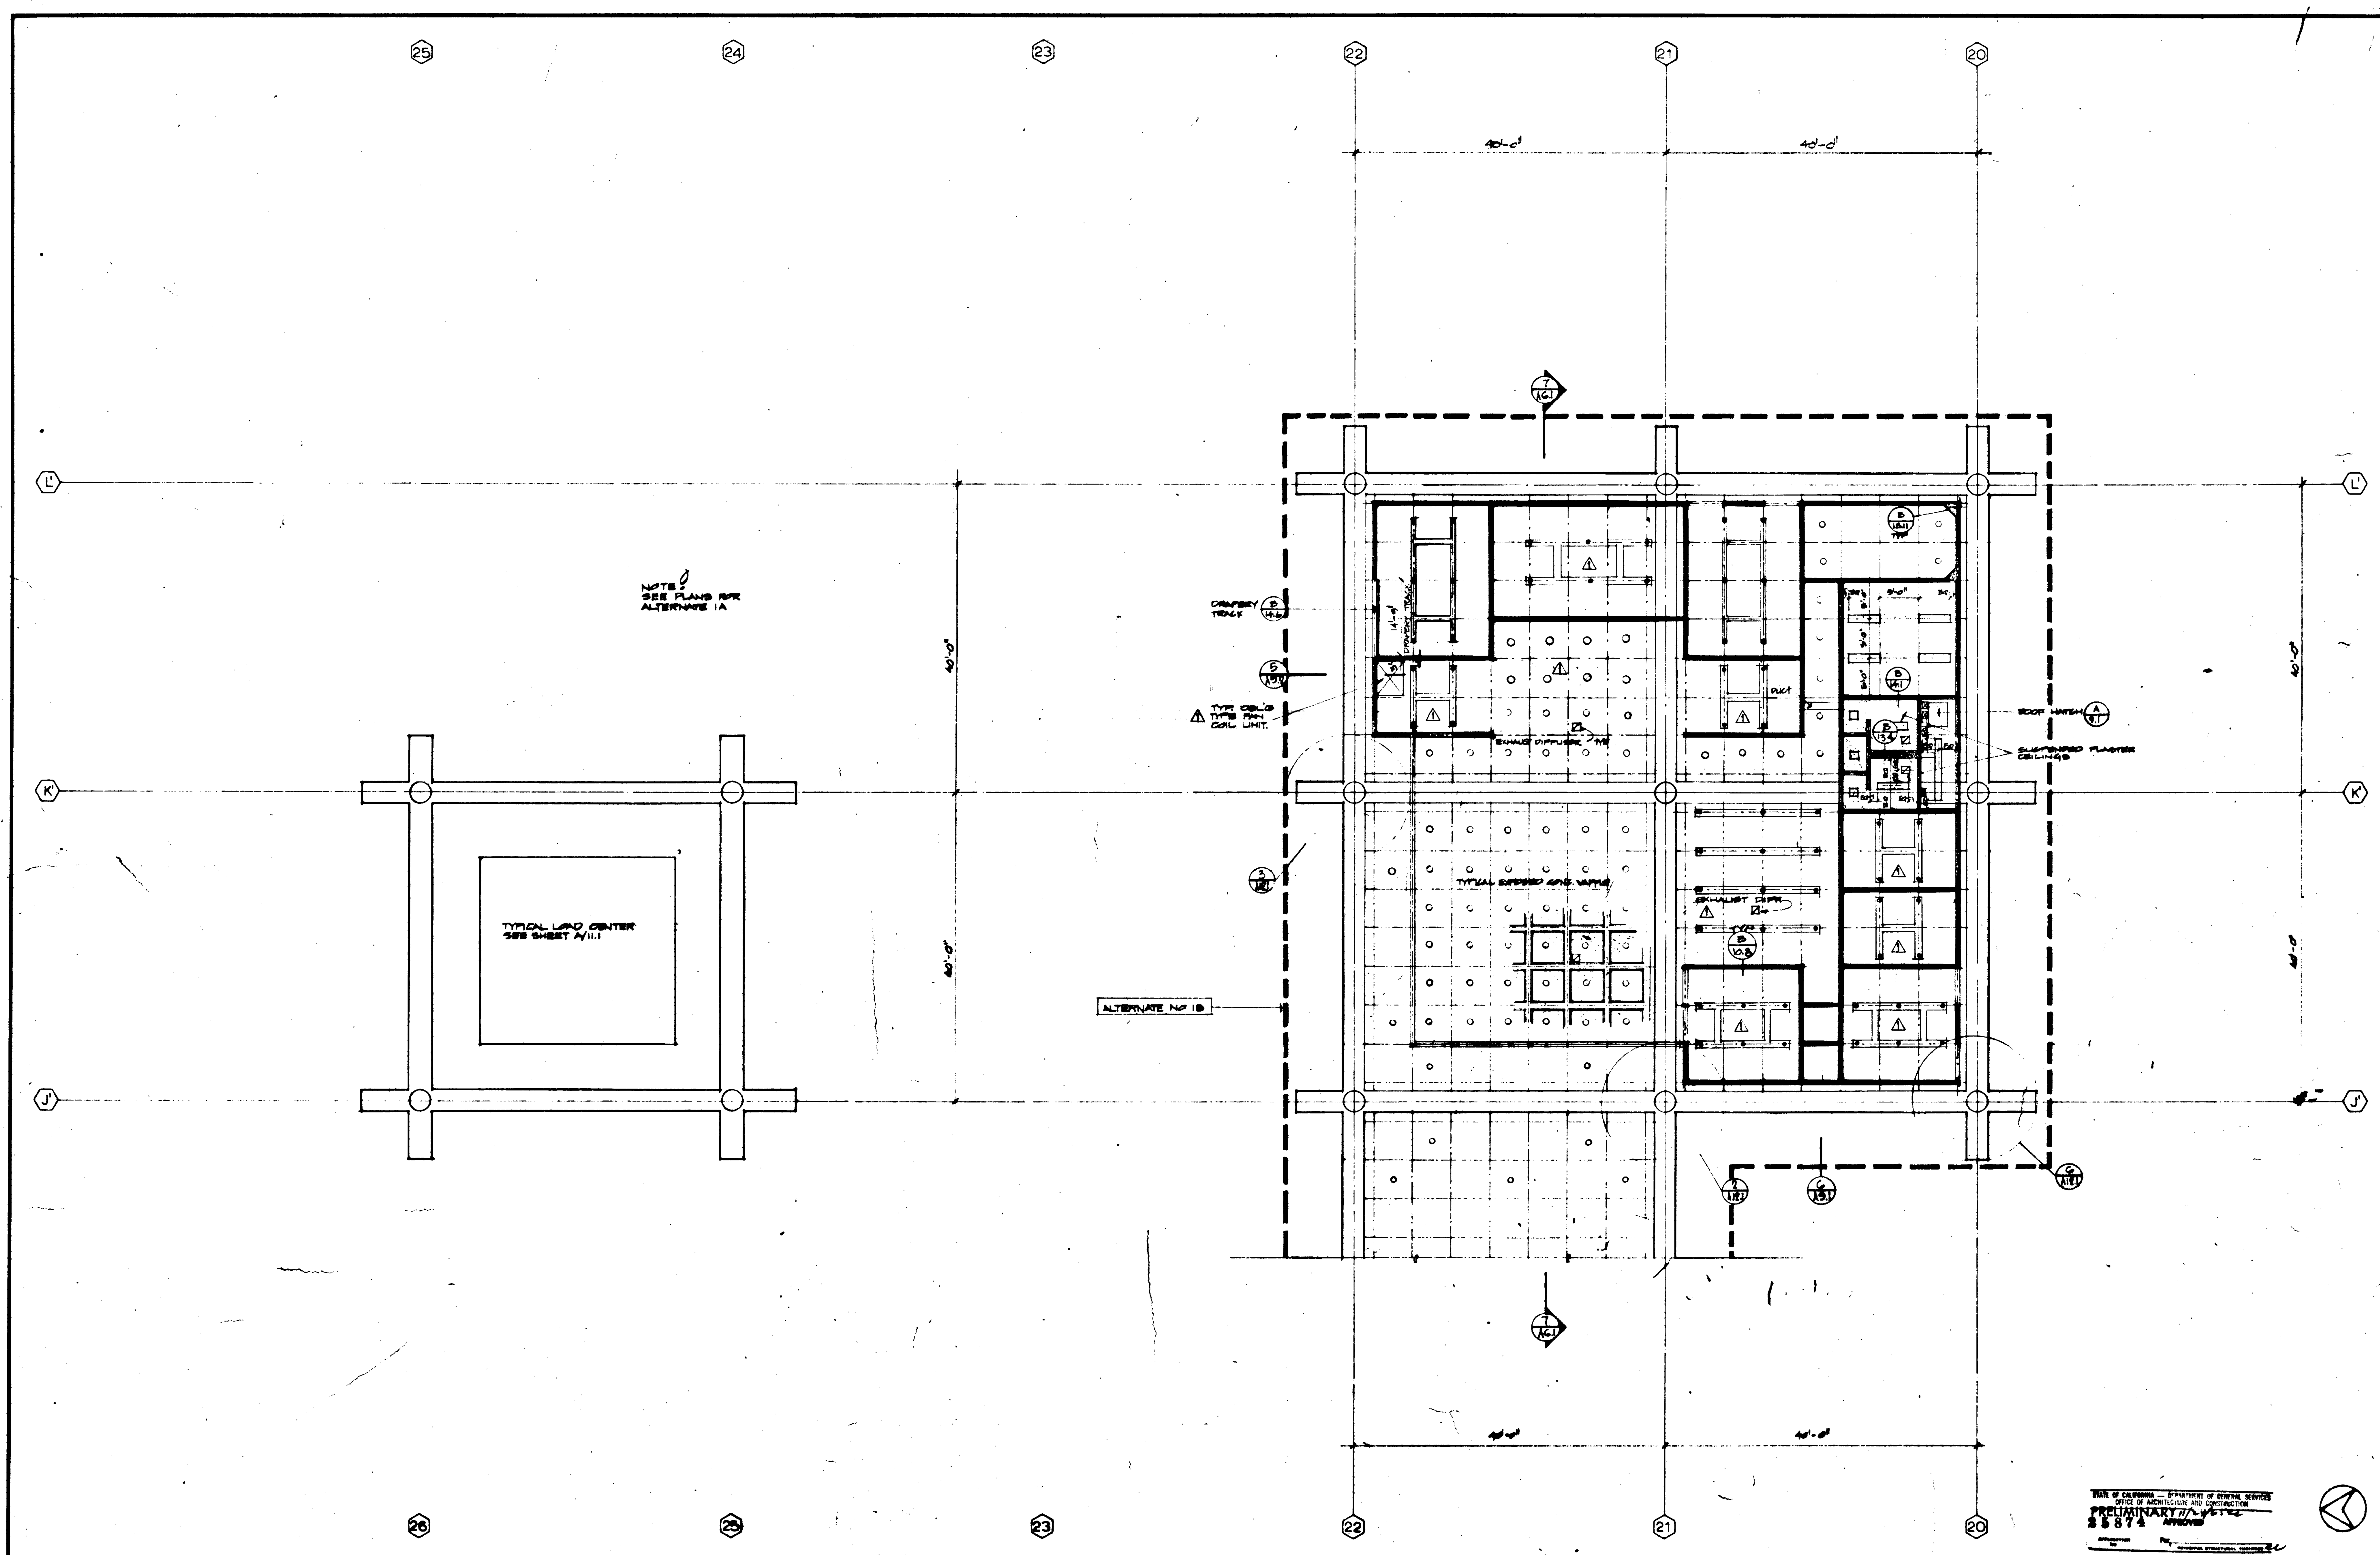
35874 APPROVED JUN 21 1965

ASSOCIATED ARCHITECTS:
WILLIAM L. PEREIRA & ASSOCIATES
A. QUINCY JONES-FREDERICK E. EMMONS & ASSOCIATES
BLUROCK ELLERBROCK & ASSOCIATES
URBANUS SQUARE • MACARTHUR BOULEVARD AT FORD ROAD
TELEPHONE 714/675-2640 • CORONA DEL MAR, CALIFORNIA



GOLDEN WEST COLLEGE
HUNTINGTON BEACH, CALIFORNIA
ORANGE COAST JUNIOR COLLEGE DISTRICT

UNIT 3	SCALE 1/8" = 1'-0"
REFLECTED	JOB NO. MD-1
CEILING	15 JUN 1965
PLANS	SHEET NO. A-1





<p>STRUCTURAL ENGINEER BEARDOW & JOHNSON J.A. MARTIN & ASSOCIATES</p>				<p>DESIGNED [Signature]</p>	<p>ARCHITECT [Signature]</p>	<p>APPROVED [Signature]</p>	<p>ASSOCIATED ARCHITECTS: WILLIAM L. PEREIRA & ASSOCIATES A. SWINNEY JONES-FREDERICK R. EDMONDS & ASSOCIATES BLUEBOOK HILLSBOROUGH & ASSOCIATES</p>	<p>URBANUS SQUARE • MACARTHUR BOULEVARD AT FORD ROAD TELEPHONE 714/675-2648 CORONA DEL MAR, CALIFORNIA</p>	<p>GOLDEN WEST COLLEGE HUNTINGTON BEACH, CALIFORNIA ORANGE COAST JUNIOR COLLEGE DISTRICT</p>	<p>UNIT 4 REFLECTED CEILING PLAN</p>	<p>SCALE 1" = 1'</p>
<p>MECHANICAL ENGINEER RALPH E. PHILLIPS, INC.</p>				<p>DRAWN BY [Signature]</p>	<p>CHECKED BY [Signature]</p>	<p>APPROVED [Signature]</p>	<p>STATE FIRE MARSHAL STATE OF CALIFORNIA DATE 11/20/1965 25874 APPROVED [Signature]</p>	<p>AS REVISED NOV 24 1965 APPROVED [Signature]</p>	<p>DATE 18 JUN 1965 SHEET NO. A 503</p>	<p>JOB NO. MD-4</p>	
<p>ELECTRICAL ENGINEER RALPH E. PHILLIPS, INC.</p>				<p>DESIGNED BY [Signature]</p>	<p>CHECKED BY [Signature]</p>	<p>APPROVED [Signature]</p>	<p>DATE 11/20/1965 SHEET NO. A 503</p>	<p>URBANUS SQUARE • MACARTHUR BOULEVARD AT FORD ROAD TELEPHONE 714/675-2648 CORONA DEL MAR, CALIFORNIA</p>	<p>GOLDEN WEST COLLEGE HUNTINGTON BEACH, CALIFORNIA ORANGE COAST JUNIOR COLLEGE DISTRICT</p>	<p>UNIT 4 REFLECTED CEILING PLAN</p>	<p>SCALE 1" = 1'</p>
<p>CIVIL ENGINEER O. SHURMAN & ASSOCIATES MOFFATT & WICKOL</p>				<p>DESIGNED BY [Signature]</p>	<p>CHECKED BY [Signature]</p>	<p>APPROVED [Signature]</p>	<p>STATE FIRE MARSHAL STATE OF CALIFORNIA DATE 11/20/1965 25874 APPROVED [Signature]</p>	<p>AS REVISED NOV 24 1965 APPROVED [Signature]</p>	<p>DATE 18 JUN 1965 SHEET NO. A 503</p>	<p>JOB NO. MD-4</p>	

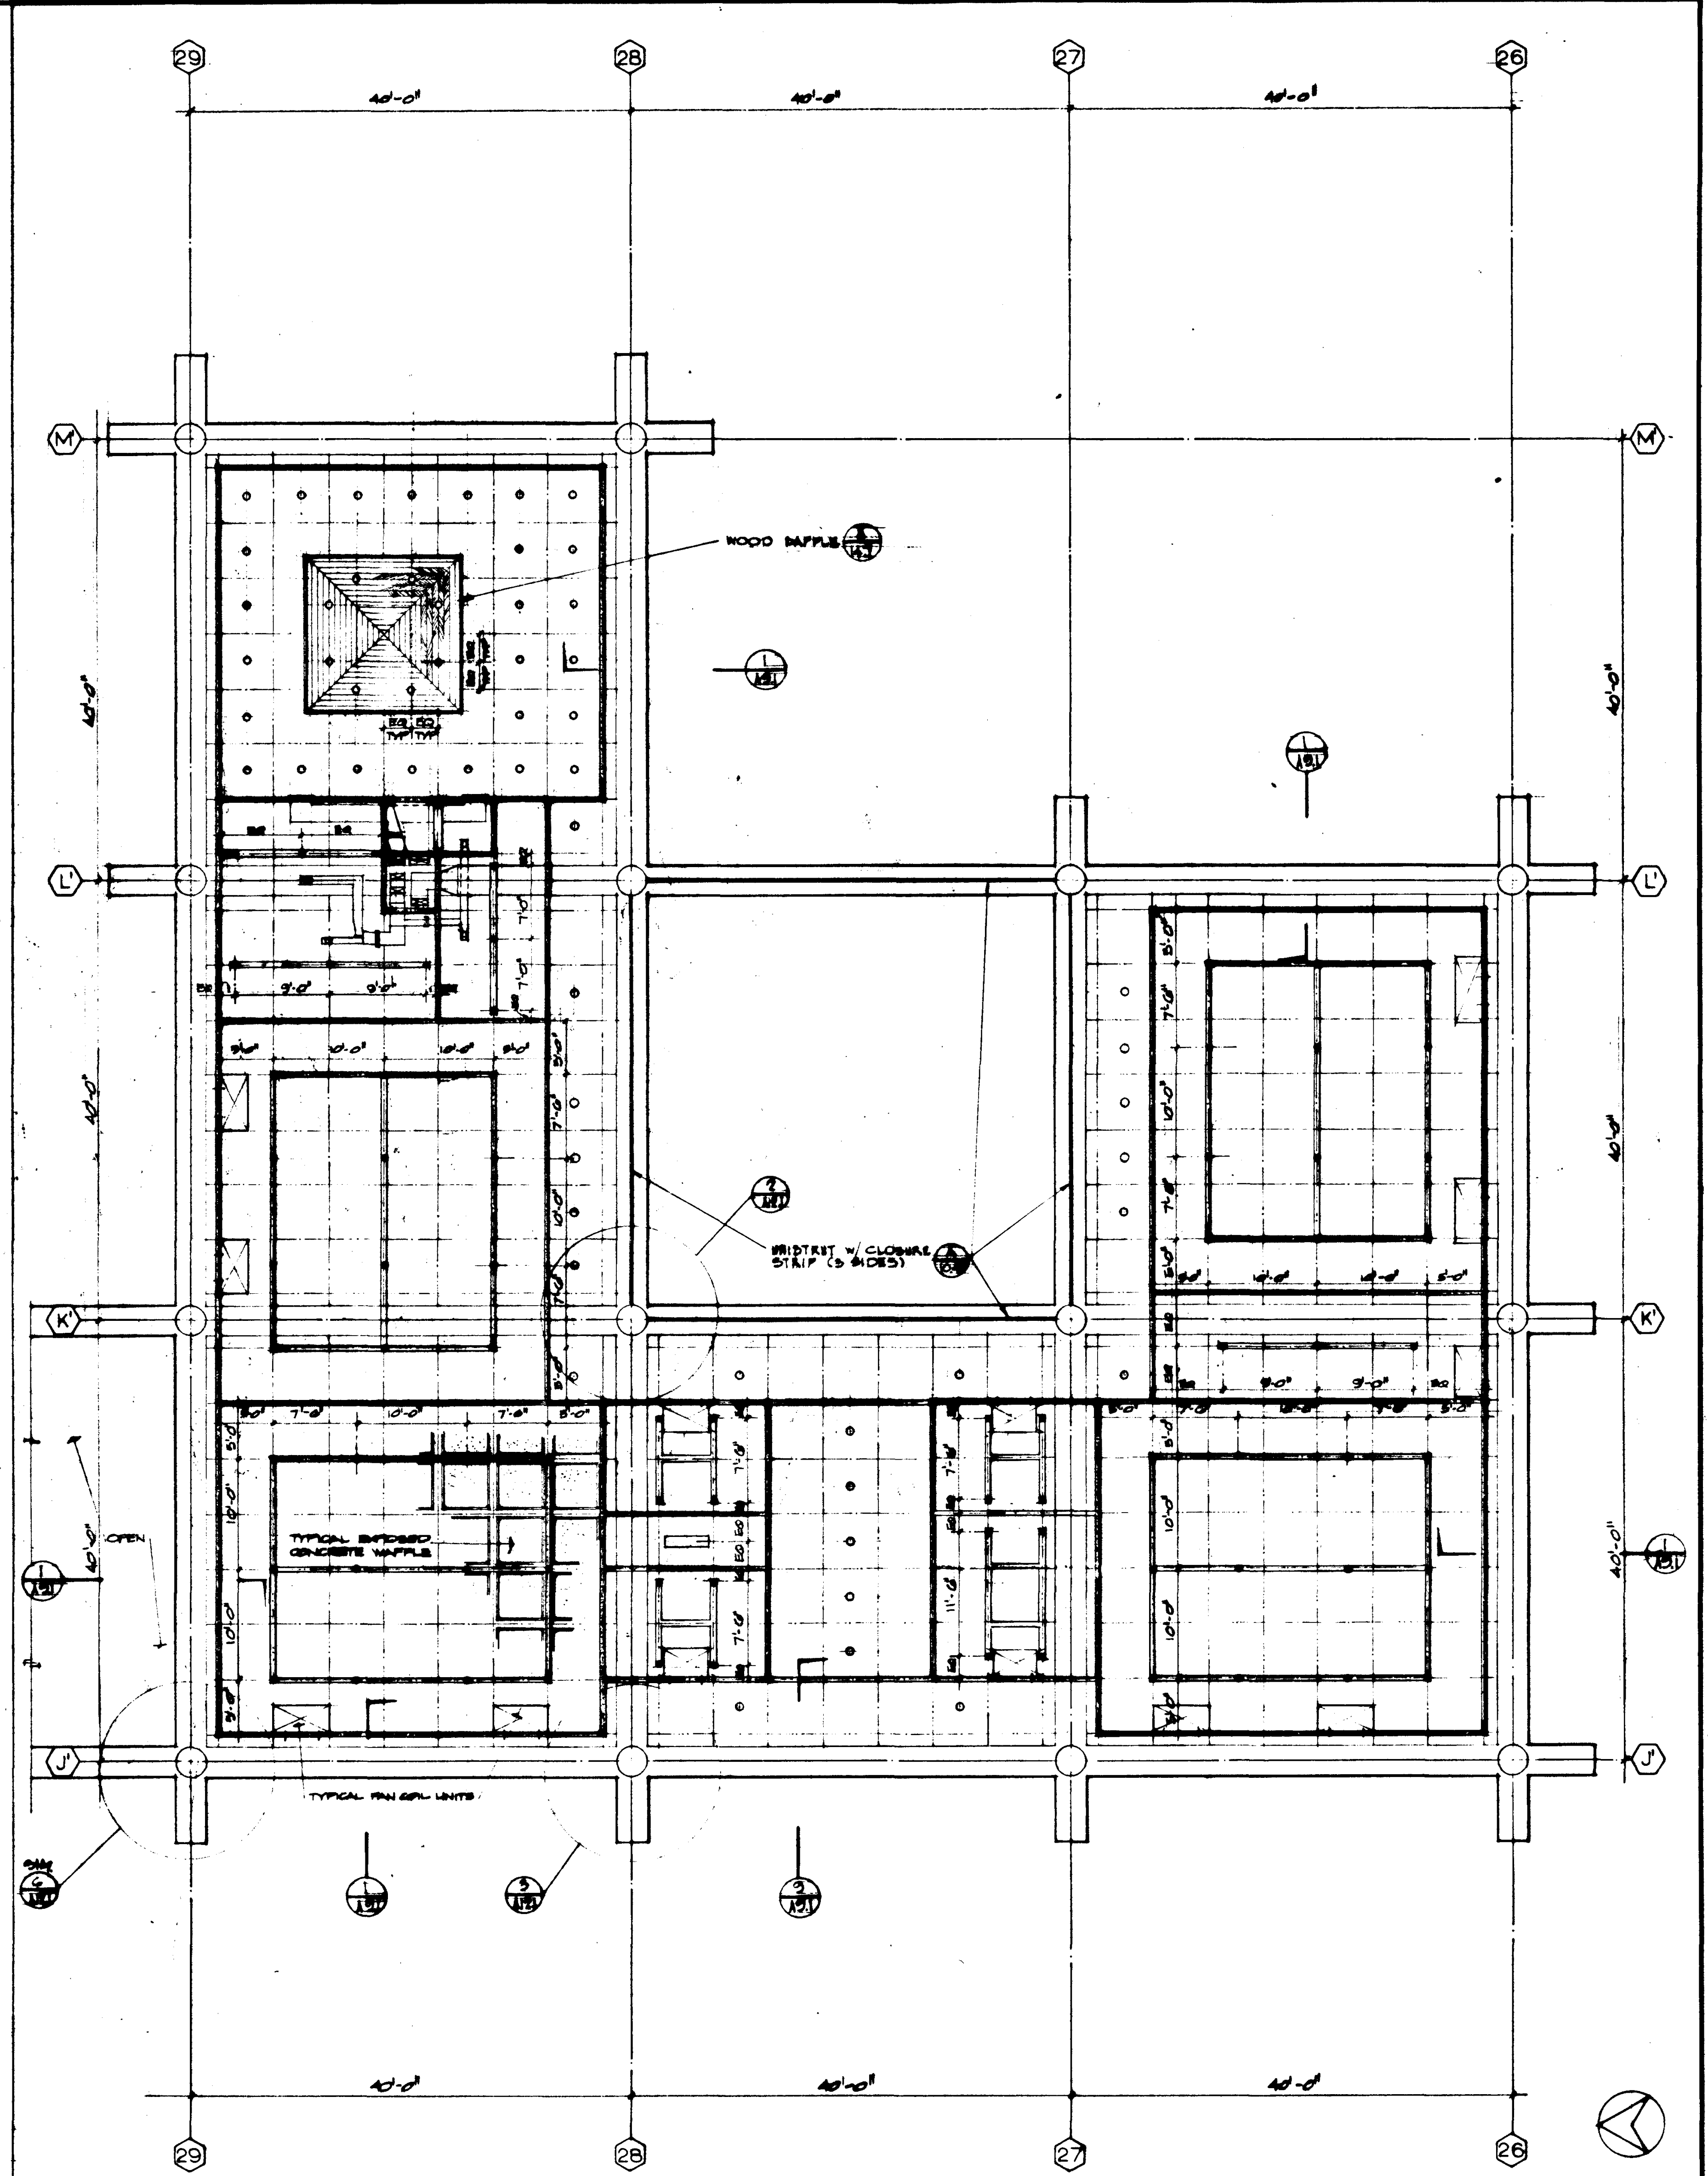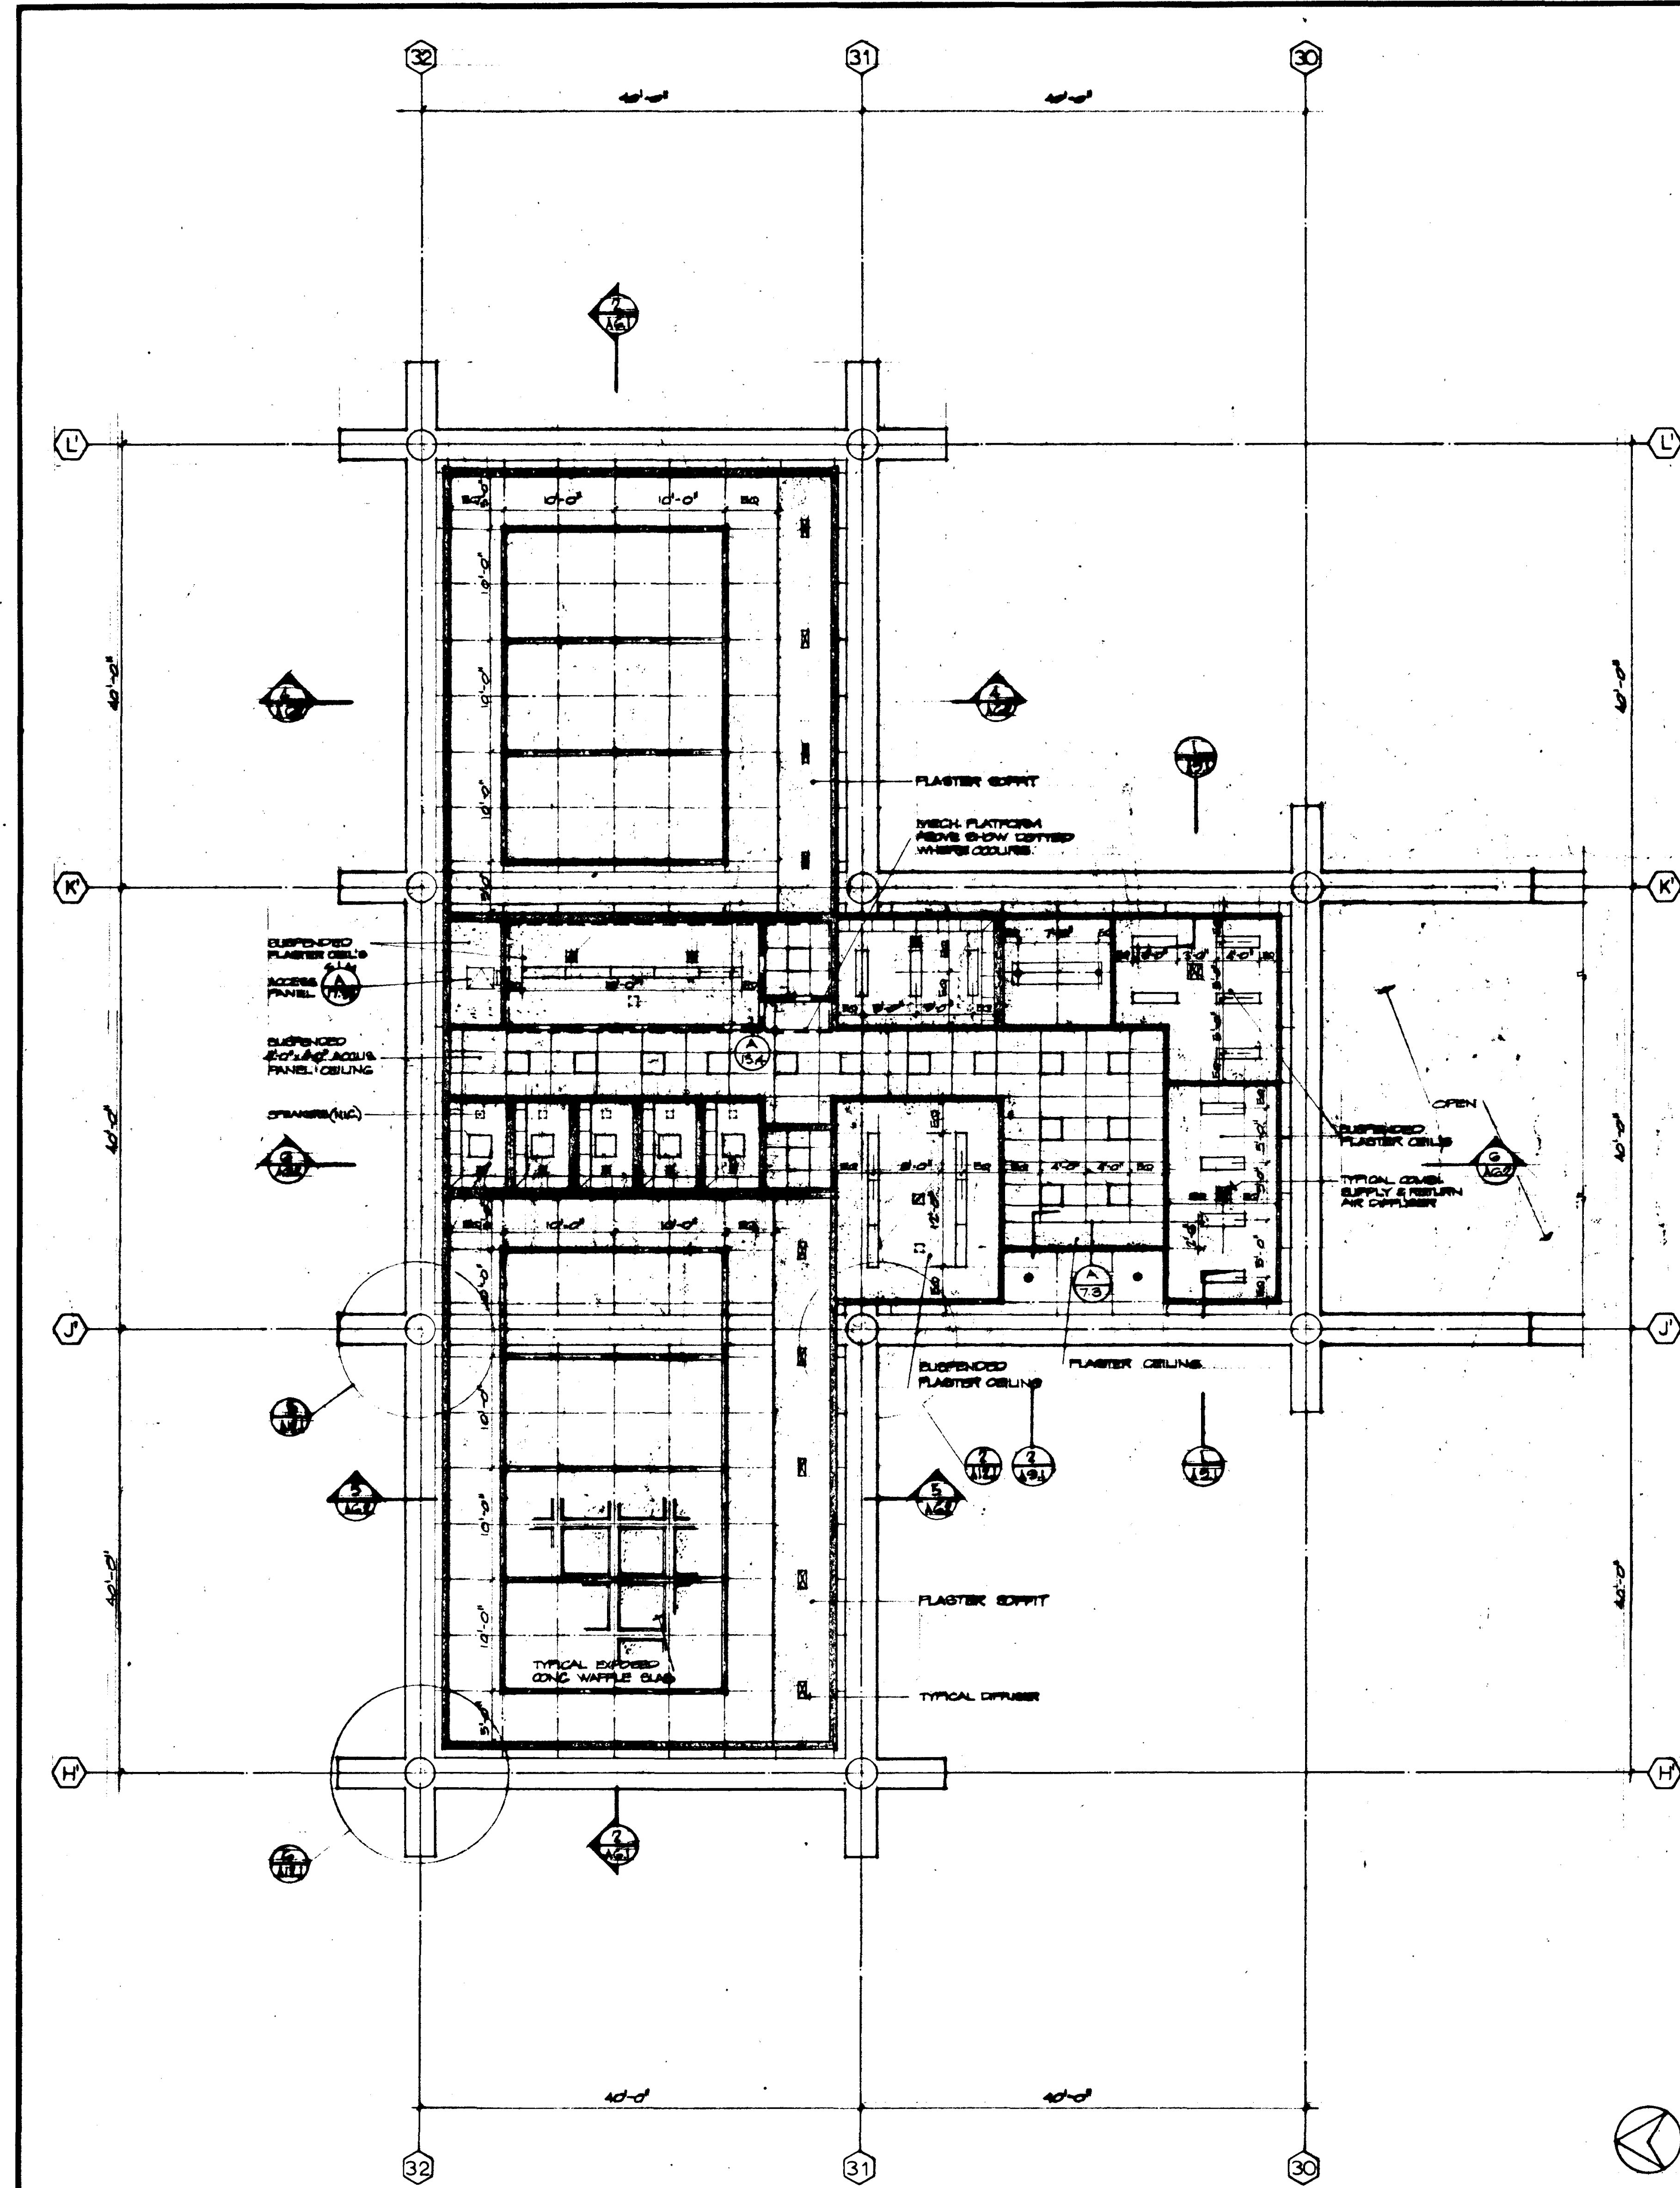

UNIT C FIRST FLOOR

UNIT 5 FIRST FLOOR

NO.	REVISIONS
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STRUCTURAL ENGINEERS BRANDOW & JOHNSON J.A. MARTIN & ASSOCIATES	DESIGNED ARCHITECT ENGINEER
MECHANICAL ENGINEERS RALPH E. PHILLIPS, INC.	DRAWN BY ENGINEER
ELECTRICAL ENGINEERS RALPH E. PHILLIPS, INC.	CHECKED BY COLLEGE
CIVIL ENGINEERS G. SHURMAN & ASSOCIATES MOFFATT & NICKOL	

APPROVED STATE FIRE MARSHAL STATE OF CALIFORNIA DATE: JUN 21 1965 35874	
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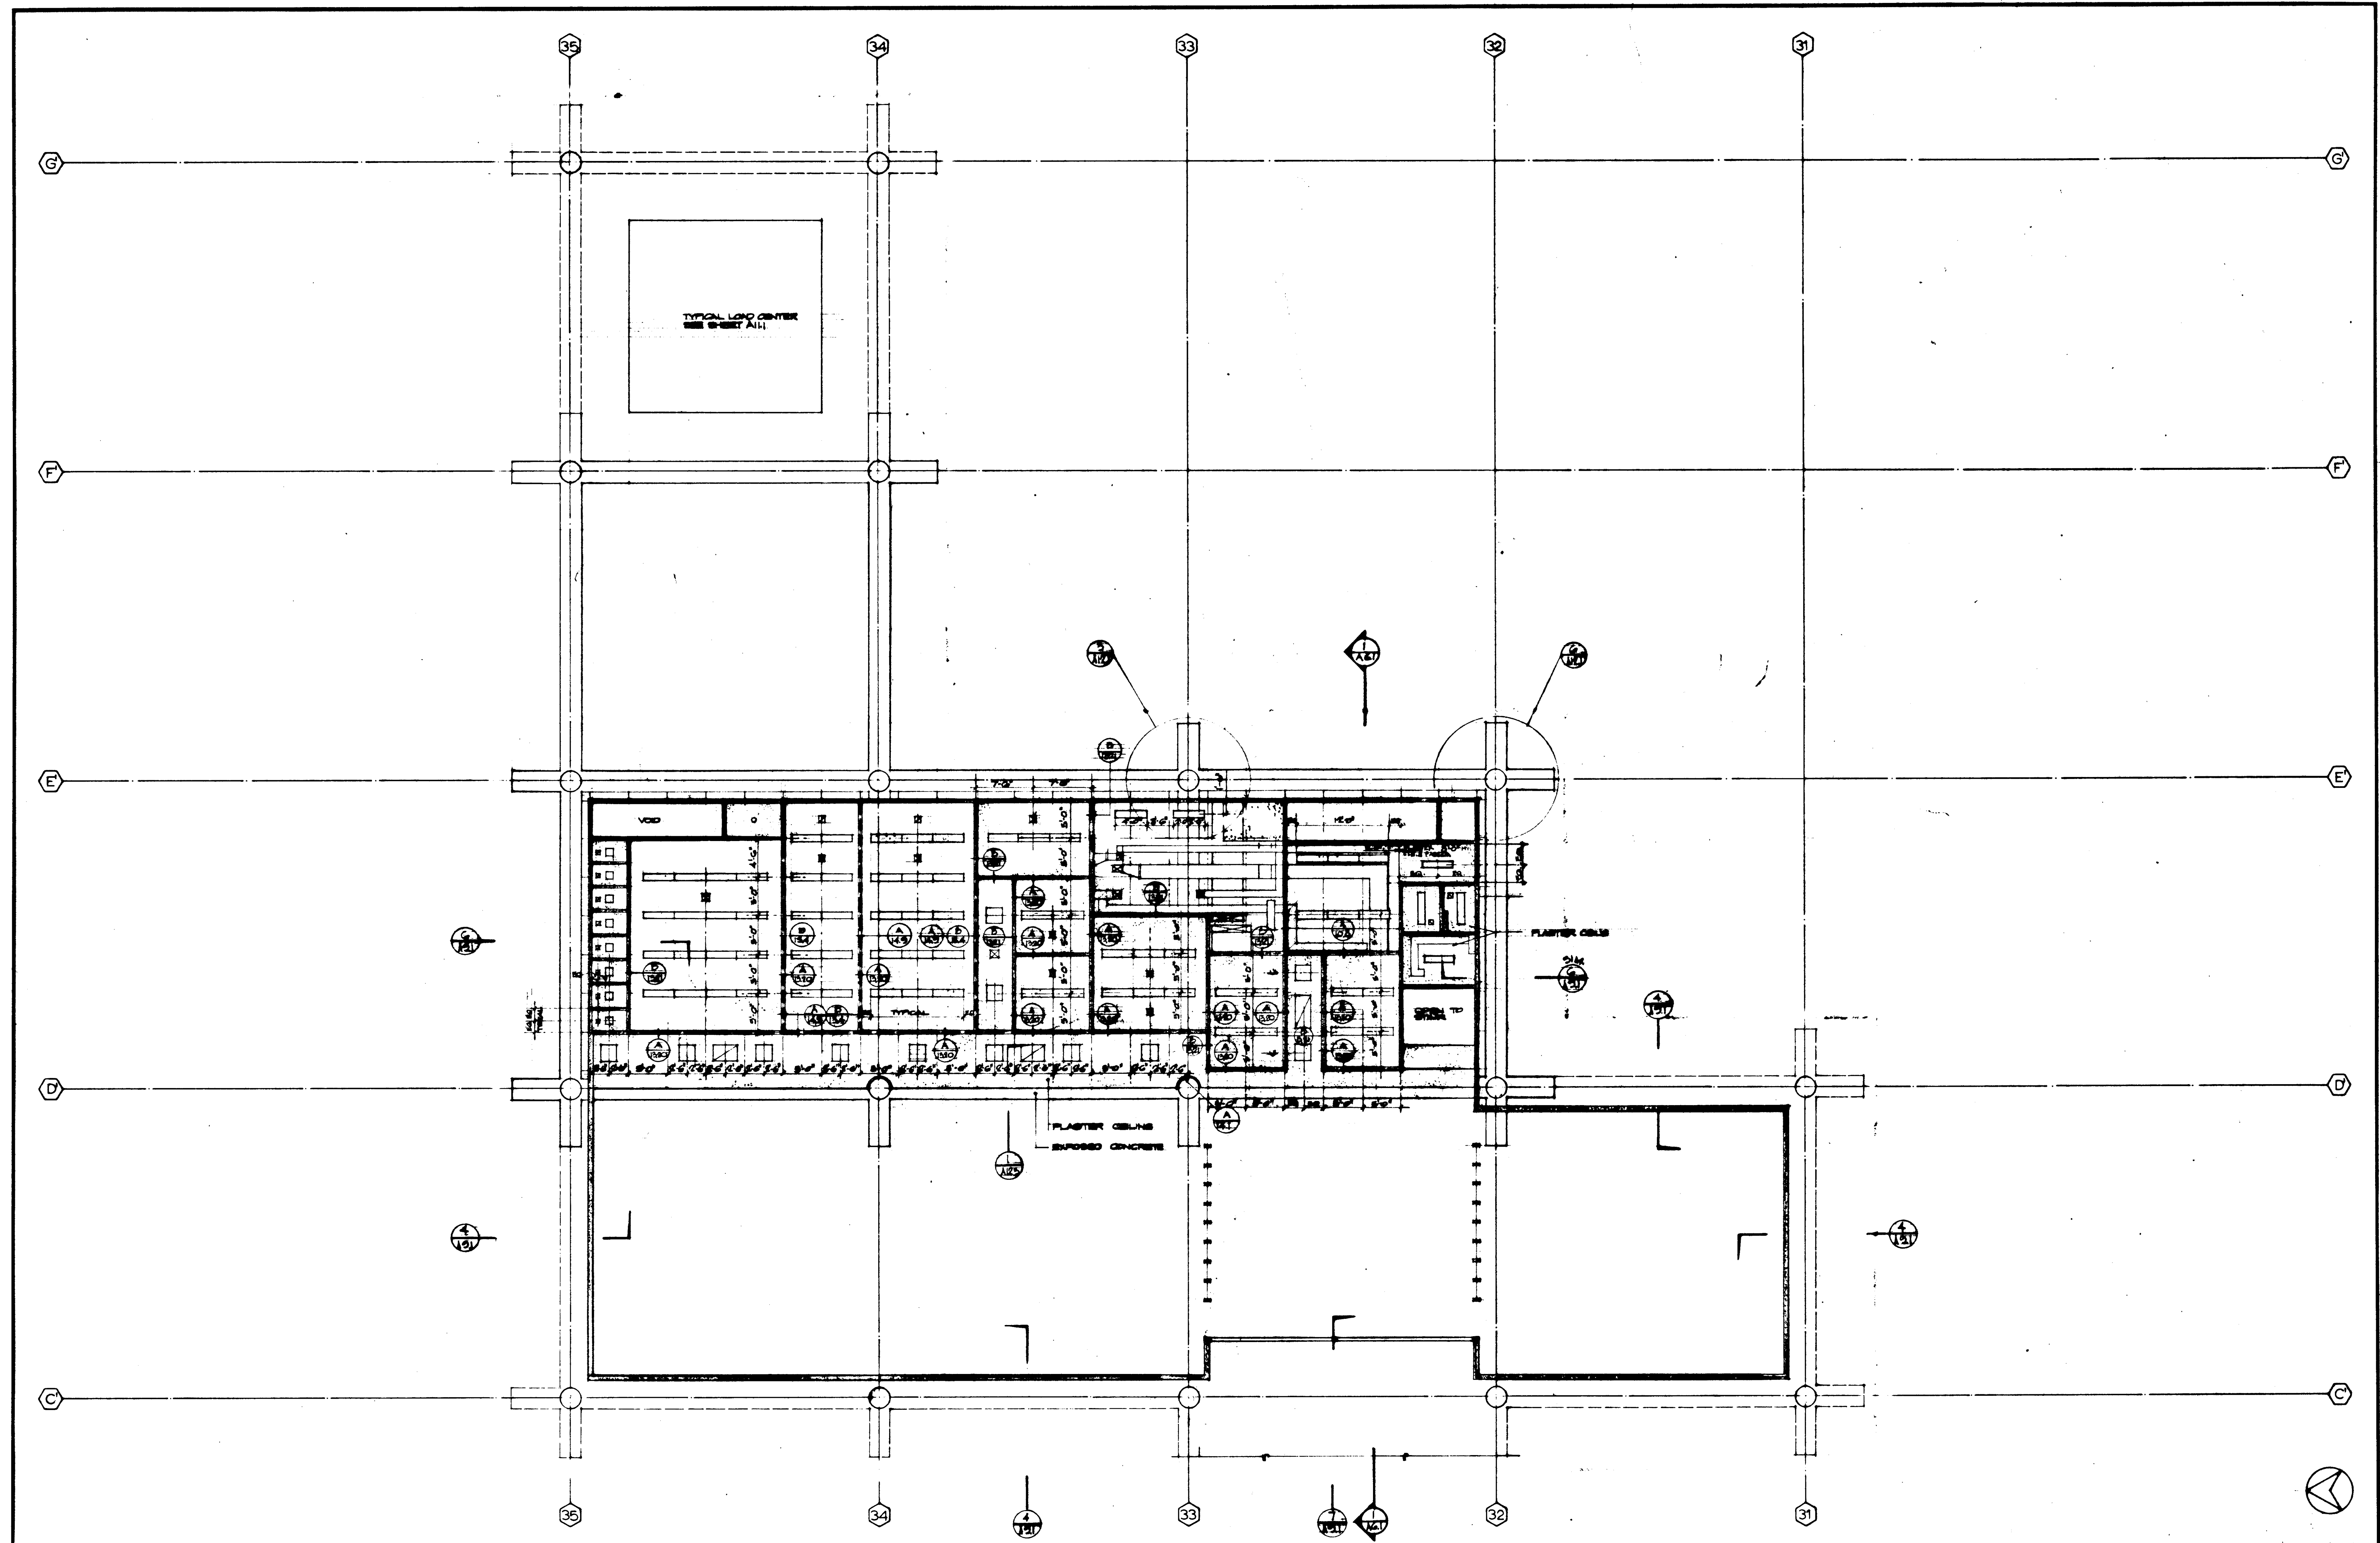
ASSOCIATED ARCHITECTS:
WILLIAM L. PEREIRA & ASSOCIATES
A. QUINCY JONES-FREDERICK E. EMMONS & ASSOCIATES
BLUROCK ELLERBROOK & ASSOCIATES

URBANUS SQUARE • MACARTHUR BOULEVARD AT FORD ROAD
TELEPHONE 714/678-2640 • CORONA DEL MAR, CALIFORNIA

GOLDEN WEST COLLEGE
HUNTINGTON BEACH, CALIFORNIA
ORANGE COAST JUNIOR COLLEGE DISTRICT


UNIT 5 - C
REFLECTED
CEILING
PLAN

SCALE 1/8" = 1'-0"	JOB NO. MD-1
DATE 15 JUN 1965	SHEET NO. A 65




FIRST FLOOR

<p>REVISIONS</p>	<p>STRUCTURAL ENGINEERS BRANDOW & JOHNSON J.A. MARTIN & ASSOCIATES</p> <p>MECHANICAL ENGINEERS RALPH E. PHILLIPS, INC.</p> <p>ELECTRICAL ENGINEERS RALPH E. PHILLIPS, INC.</p> <p>CIVIL ENGINEERS G. SHURMAN & ASSOCIATES MOFFATT & MICROL</p>	<p>DESIGNED DRAWN BY CHECKED BY</p>	<p>ARCHITECT ENGINEER COLLEGE</p>	<p>APPROVED STATE FINE MARSHAL DATE JUN 11 1966 25874</p>	<p>ASSOCIATED ARCHITECTS: WILLIAM L. PEREIRA & ASSOCIATES A. QUINCY JONES-FREDERICK E. EMMONS & ASSOCIATES BLUROCK ELLERBROEK & ASSOCIATES</p> <p>URBANUS SQUARE • MACARTHUR BOULEVARD AT FORD ROAD TELEPHONE 714/675-2640 • CORONA DEL MAR, CALIFORNIA</p>	<p>GOLDEN WEST COLLEGE HUNTINGTON BEACH, CALIFORNIA ORANGE COAST JUNIOR COLLEGE DISTRICT</p>	<p>UNIT 7 REFLECTED CEILING PLAN</p>	<p>SCALE 1/8" = 1'-0" JOB NO. MD-1 DATE 15 JUN 1966 SHEET NO. A 543</p>
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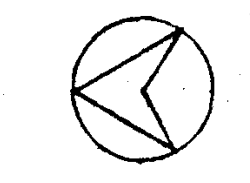


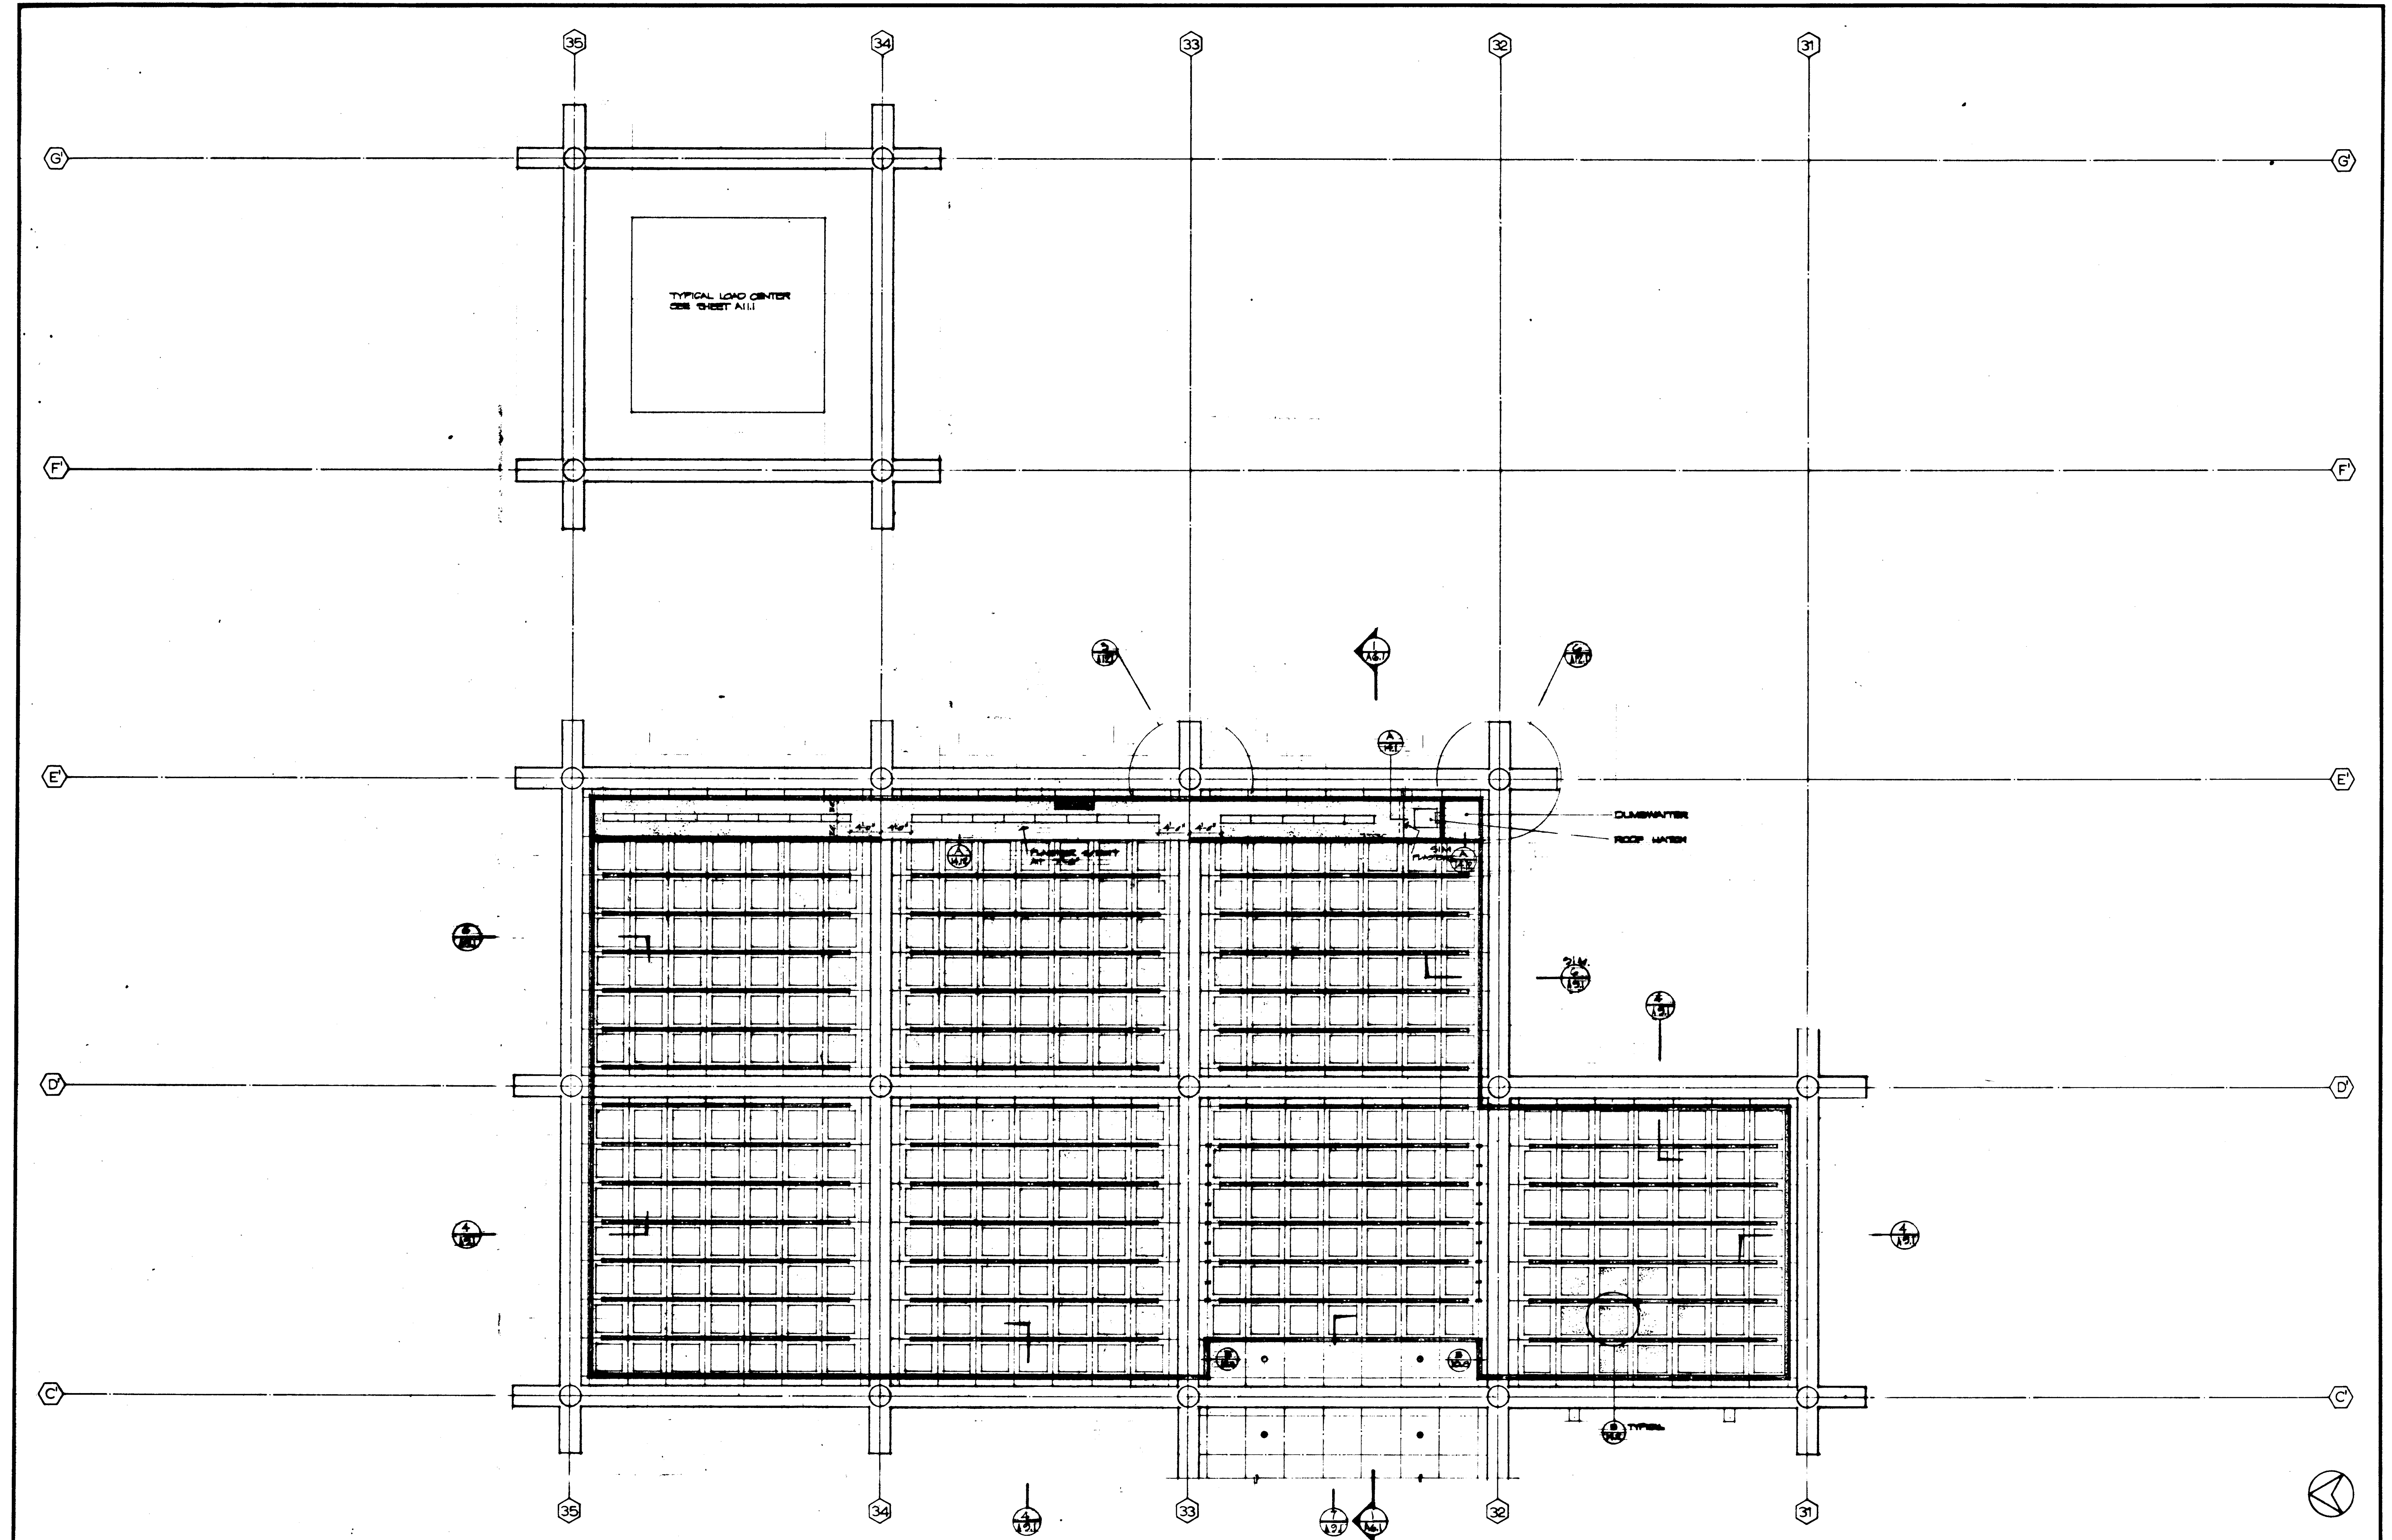SECOND FLOOR

				SCALES		1
				JOB NO.		100-1
				DATE		15 JUN 1966
				SHEET NO.		A 32
				UNIT		7
				REFLECTED		
				CEILING		
				PLAN		
				GOLDEN WEST COLLEGE		
				HUNTINGTON BEACH, CALIFORNIA		
				ORANGE COAST JUNIOR COLLEGE DISTRICT		
				ASSOCIATED ARCHITECTS:		
				WILLIAM L. FERREIRA & ASSOCIATES		
				A. QUINCY JONES-FREDERICK E. EMMONS & ASSOCIATES		
				BLUROCK ELLERBROOK & ASSOCIATES		
				URBANUS SQUARE • MACARTHUR BOULEVARD AT FORD ROAD		
				TELEPHONE 714/675-2640 • CORONA DEL MAR, CALIFORNIA		
				APPROVED		
				STATE FIRE MARSHAL		
				DATE JUN 21 1966		
				25874		
				APPROVED JUN 21 1966		
				ARCHITECT		
				DESIGNED		
				DRAWN BY		
				CHECKED BY		
				DATE		
				REVISIONS		
				STRUCTURAL ENGINEERS		
				BRANDOW & JOHNSON		
				I.A. MARTIN & ASSOCIATES		
				MECHANICAL ENGINEERS		
				RALPH E. PHILLIPS, INC.		
				ELECTRICAL ENGINEERS		
				RALPH E. PHILLIPS, INC.		
				CIVIL ENGINEERS		
				G. SHURMAN & ASSOCIATES		
				MOFFATT & NICKOL		

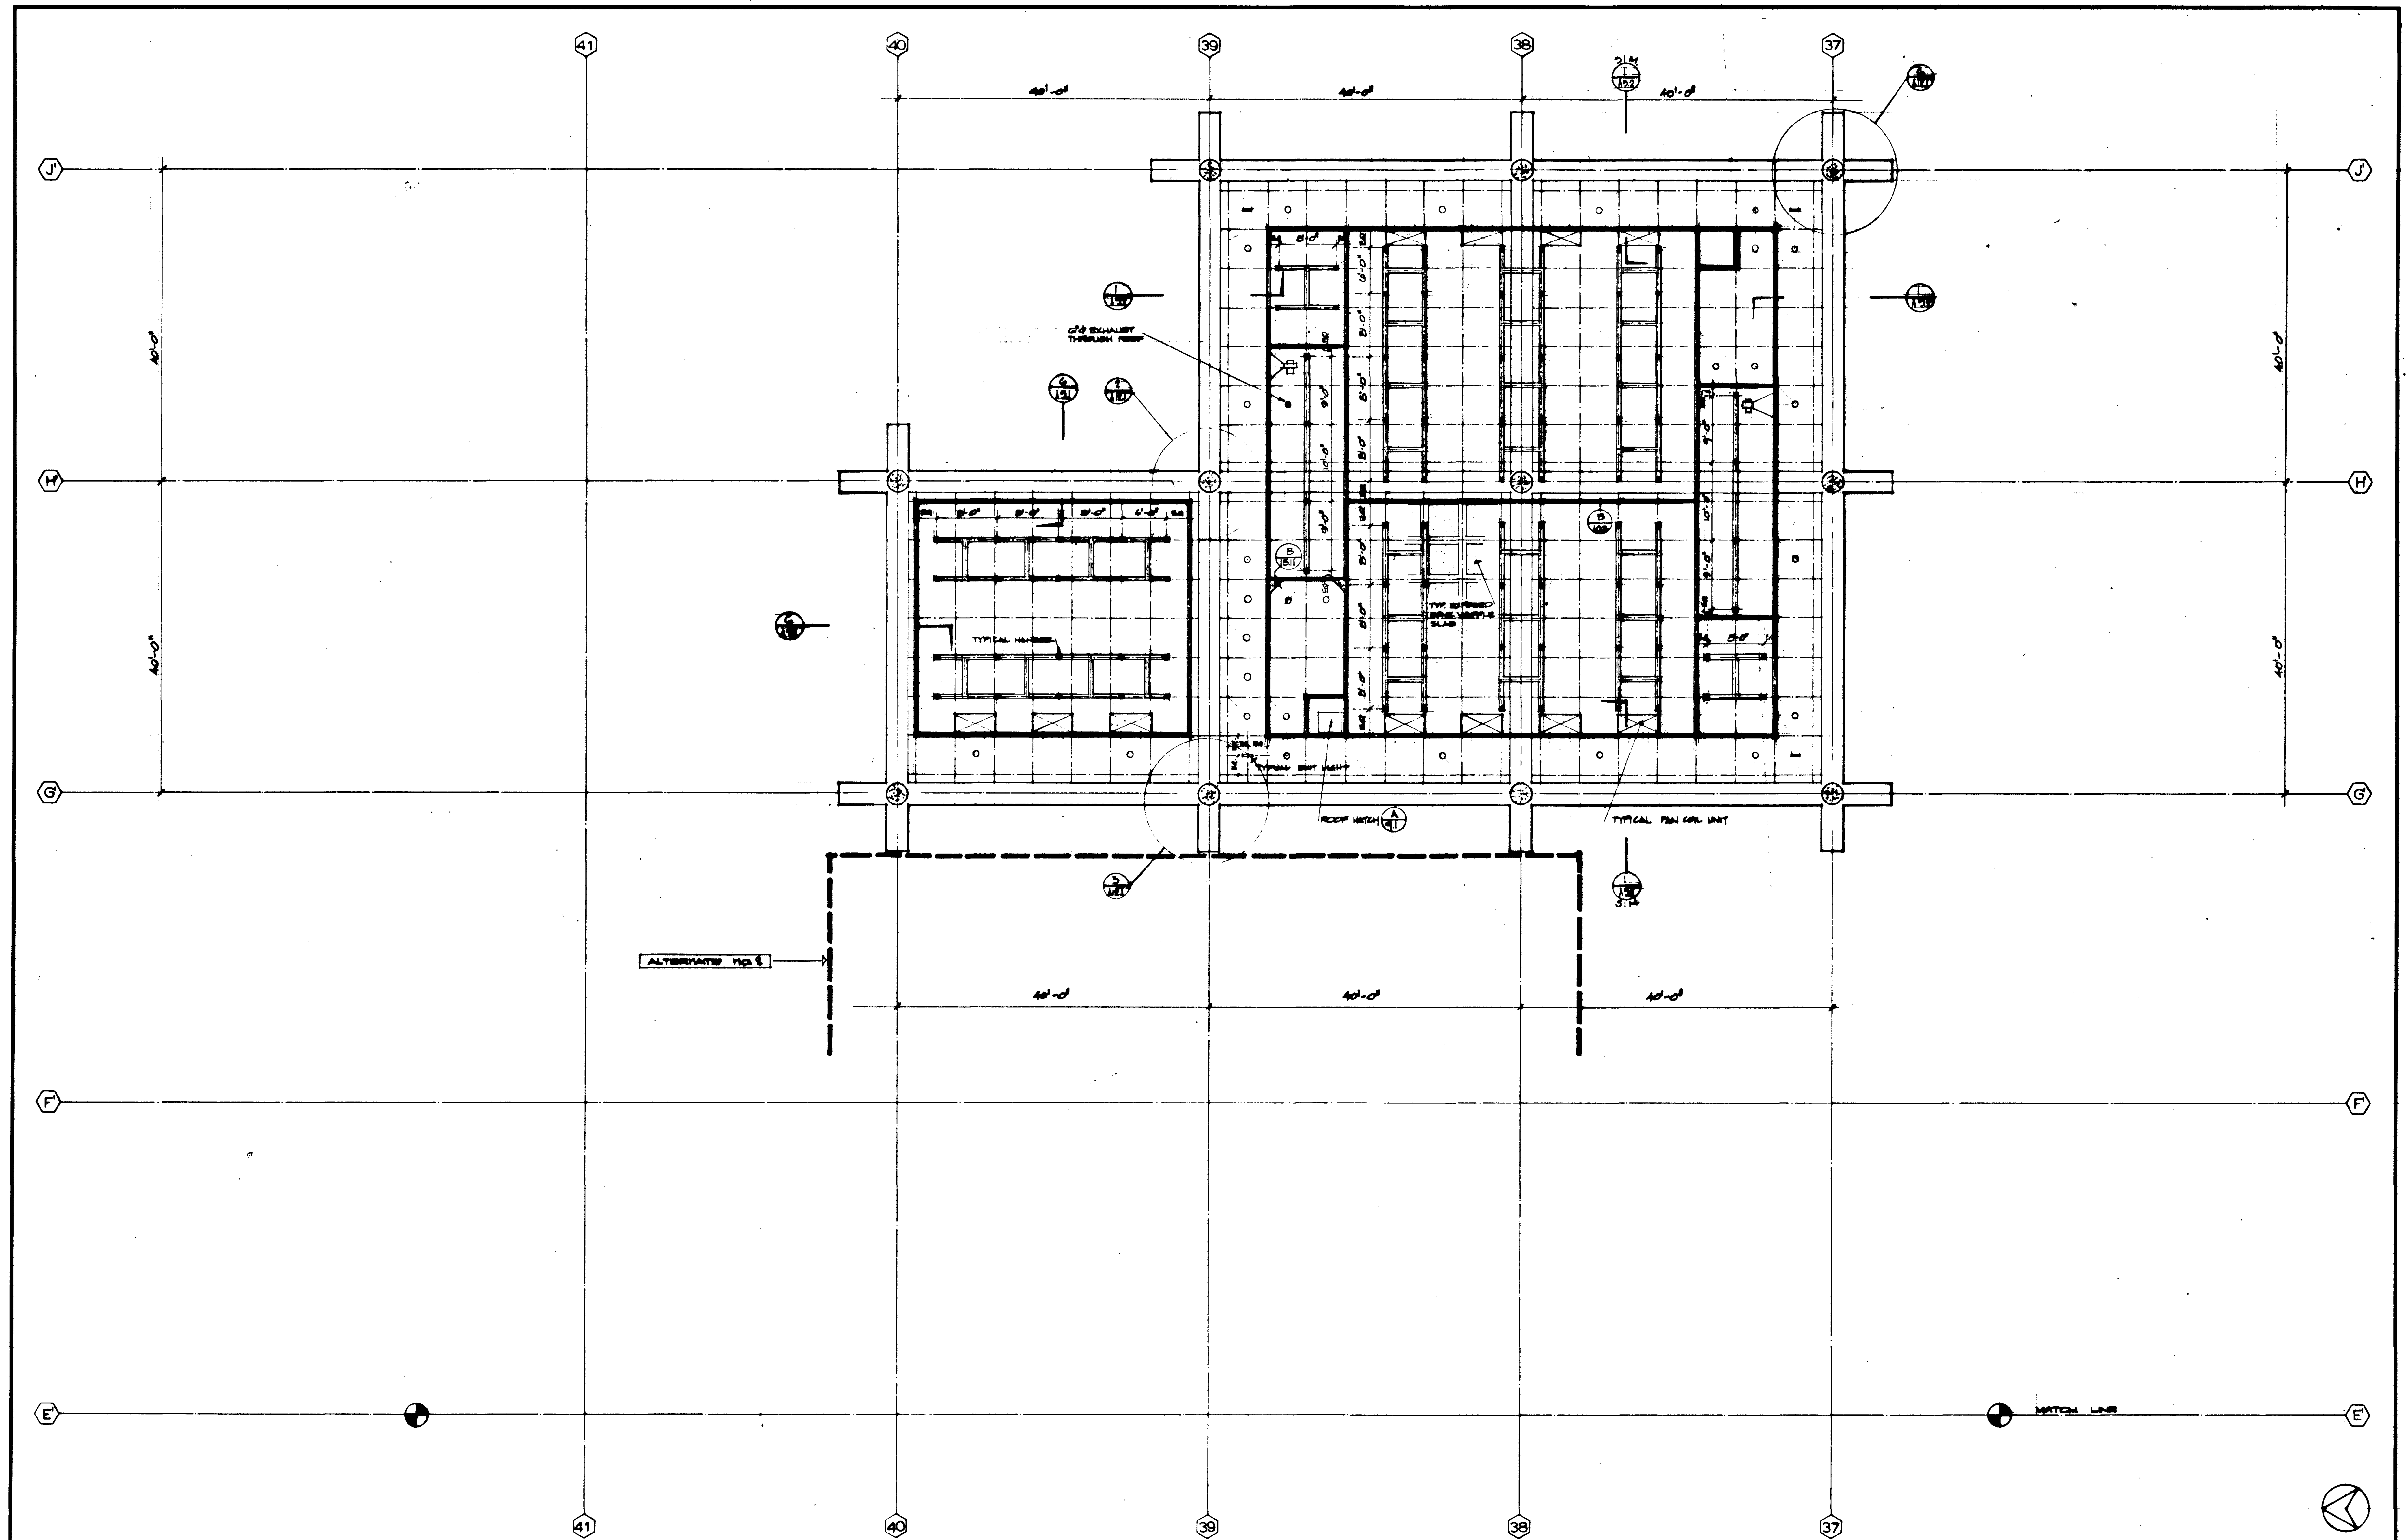


SECOND FLOOR										SCALE	1																			
STRUCTURAL ENGINEERS BRADY & JOHNSON J. A. MARTIN & ASSOCIATES		DESIGNED	ARCHITECT W. L. FERRERA	APPROVED	ASSOCIATED ARCHITECTS: WILLIAM L. FERRERA & ASSOCIATES A. QUINCY JONES-FREDERICK E. EMMONS & ASSOCIATES BLUMOCK ELLERBROCK & ASSOCIATES		GOLDEN WEST COLLEGE HUNTINGTON BEACH, CALIFORNIA ORANGE COAST JUNIOR COLLEGE DISTRICT		UNIT 83 a	JOB NO. MD-4																				
MECHANICAL ENGINEERS RALPH E. PHILLIPS, INC.		DRAWN BY	ENGINEER	APPROVED STATE FIRE MARSHAL STATE OF CALIFORNIA JUL 21 1965				REFLECTED		DATE 15 JUN 1965																				
ELECTRICAL ENGINEERS RALPH E. PHILLIPS, INC.		CHECKED BY	COLLEGE	35874 APPROVED JUN 21 1965				CEILING		SHEET NO. A-11																				
CIVIL ENGINEERS O. SEUTERMAN & ASSOCIATES HOFFATT & NICHOL								PLAN																						
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DATE	REVISIONS																													




SCALE -	I
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JOB NO. 100-1
DATE 15 JAN 1960
SHEET NO. A 7.12

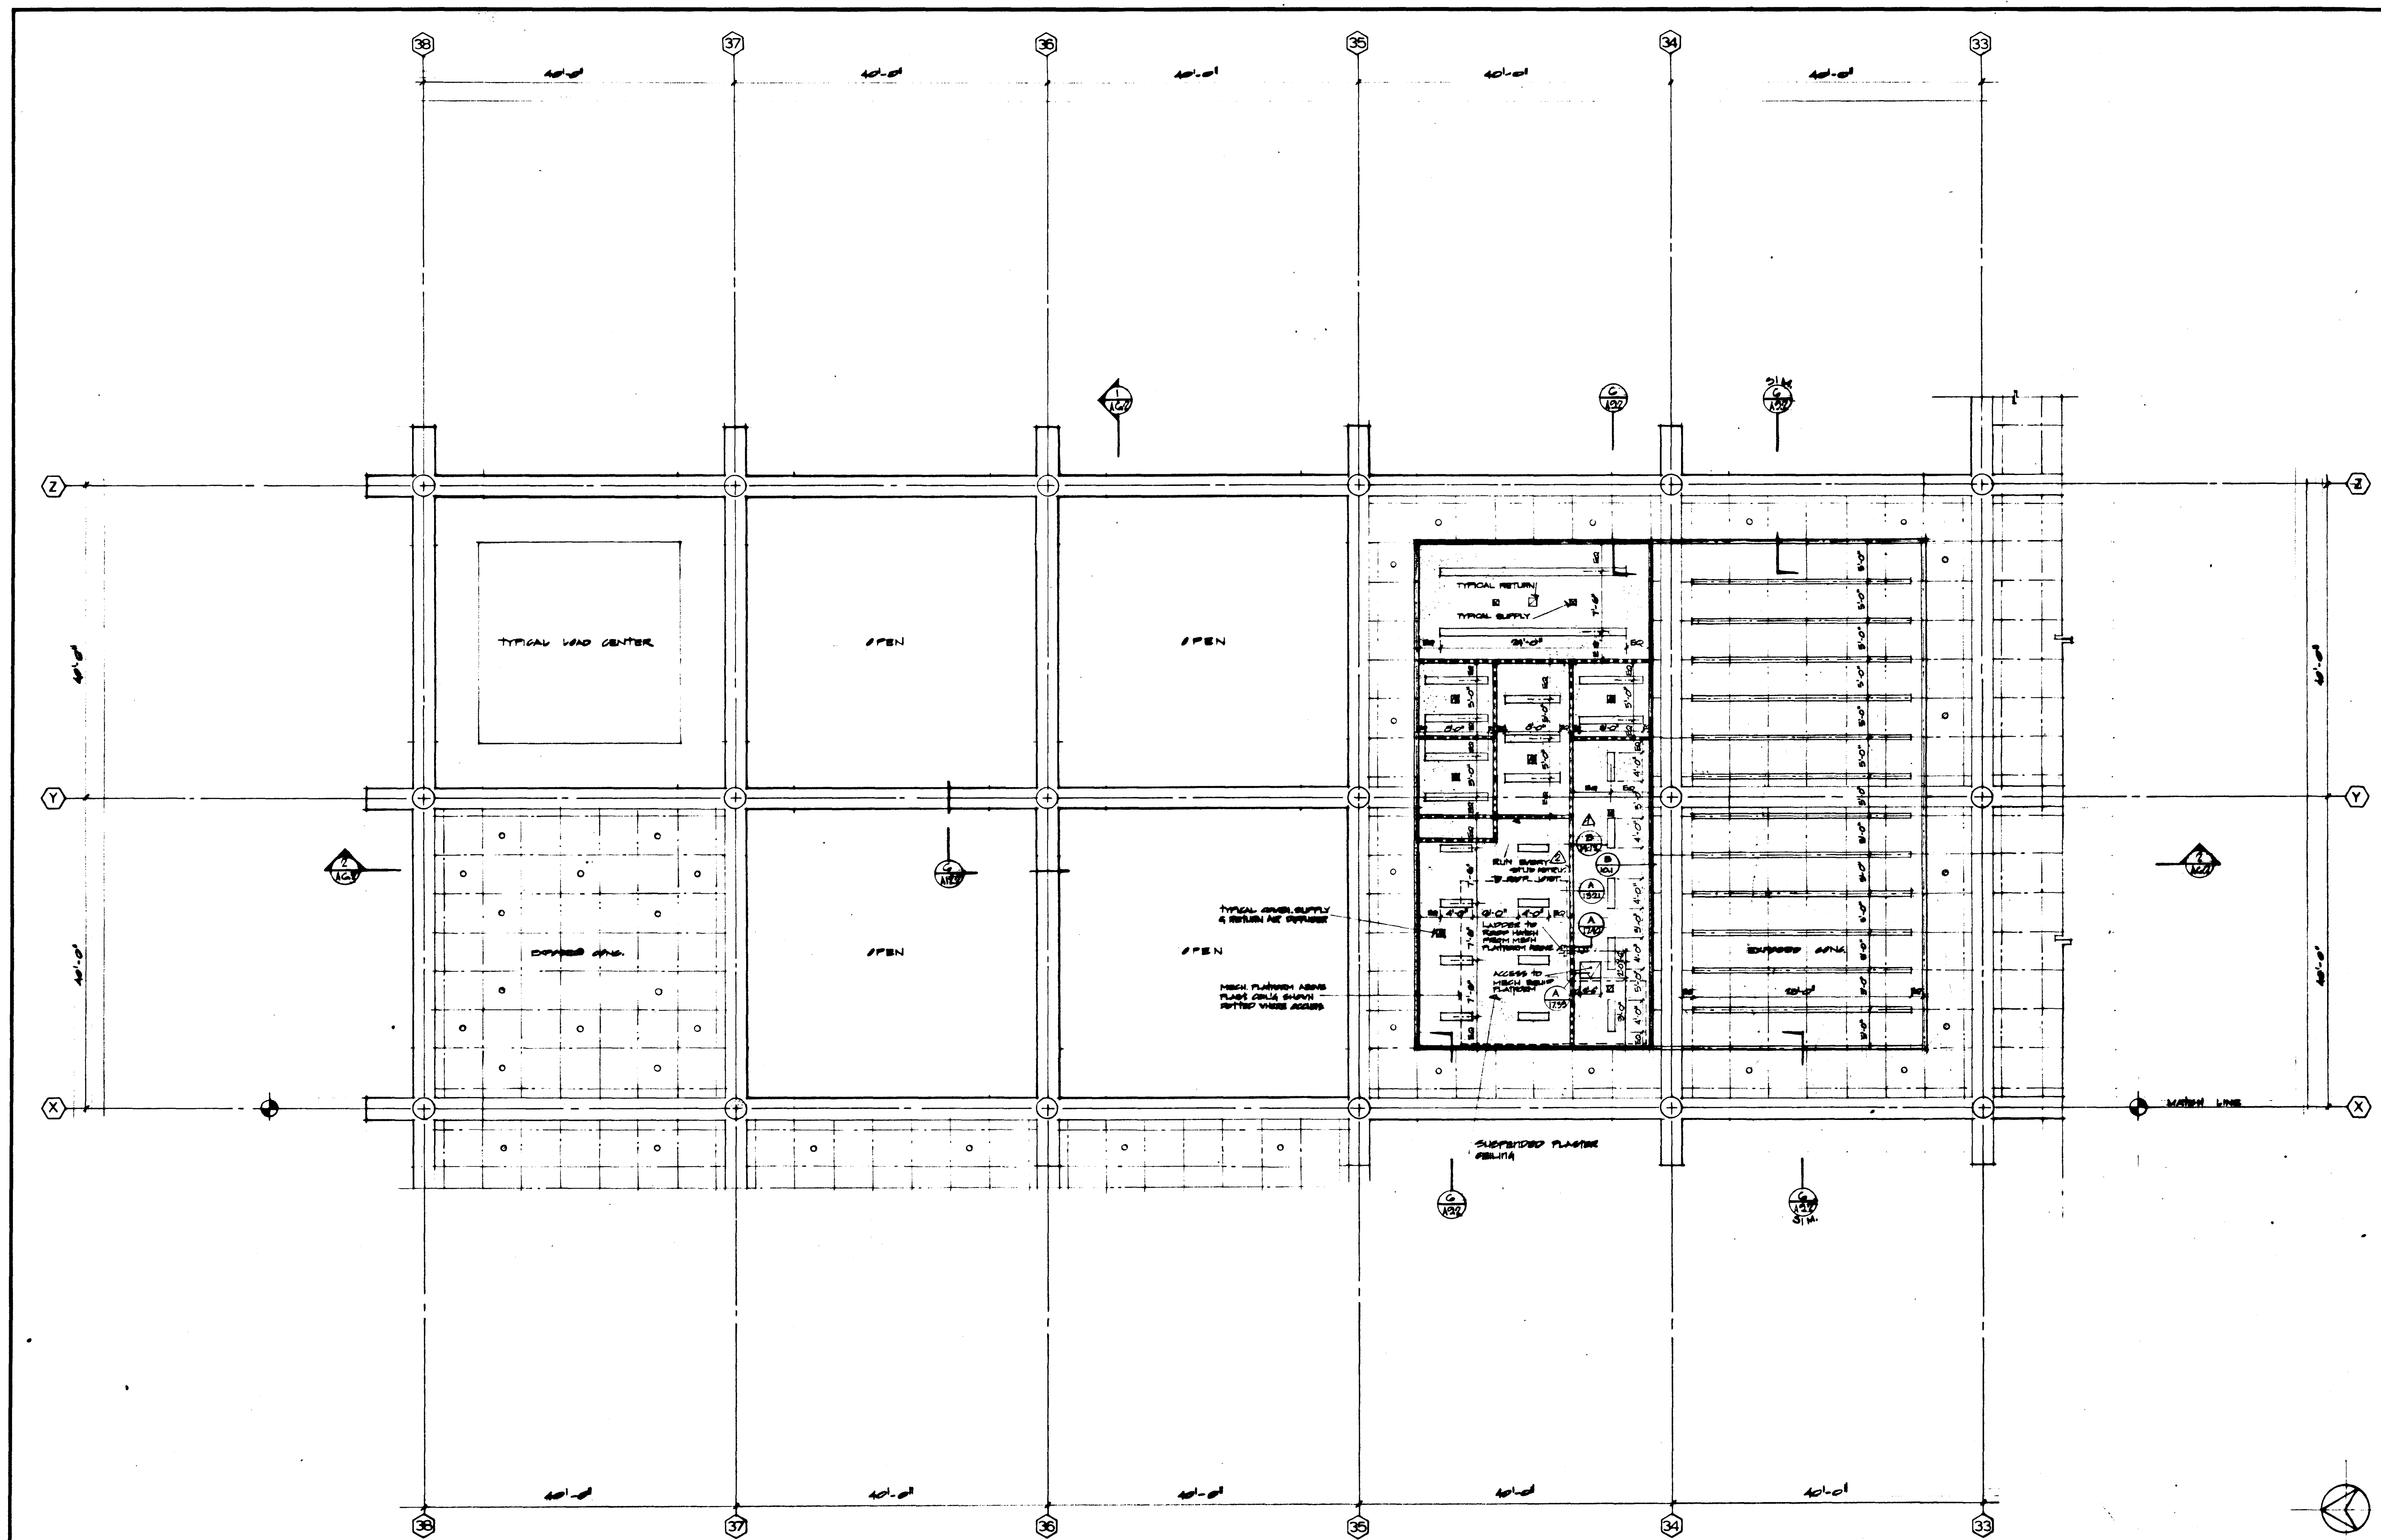


FIRST FLOOR

A	DATE	BY	REVISIONS	STRUCTURAL ENGINEER BLANDOW & JOHNSON J.A. MARTIN & ASSOCIATES	DESIGNED	ARCHITECT WILLIAM L. PEREIRA	APPROVED STATE FIRE MARSHAL STATE OF CALIFORNIA JUN 2 1965 25874	ASSOCIATED ARCHITECTS: WILLIAM L. PEREIRA & ASSOCIATES A. QUINCY JONES-FREDERICK E. EMMONS & ASSOCIATES BLUROCK ELLERBROOK & ASSOCIATES	URBANUS SQUARE • MACARTHUR BOULEVARD AT FORD ROAD TELEPHONE 714/675-2640 • CORONA DEL MAR, CALIFORNIA	GOLDEN WEST COLLEGE HUNTINGTON BEACH, CALIFORNIA ORANGE COAST JUNIOR COLLEGE DISTRICT	UNIT 1a	JOB NO. 100-1
	DATE	BY	REVISIONS								REFLECTED	18 JUN 1965
	DATE	BY	REVISIONS								CEILING	SHEET NO.
	DATE	BY	REVISIONS								PLAN	A 7.13
	DATE	BY	REVISIONS									

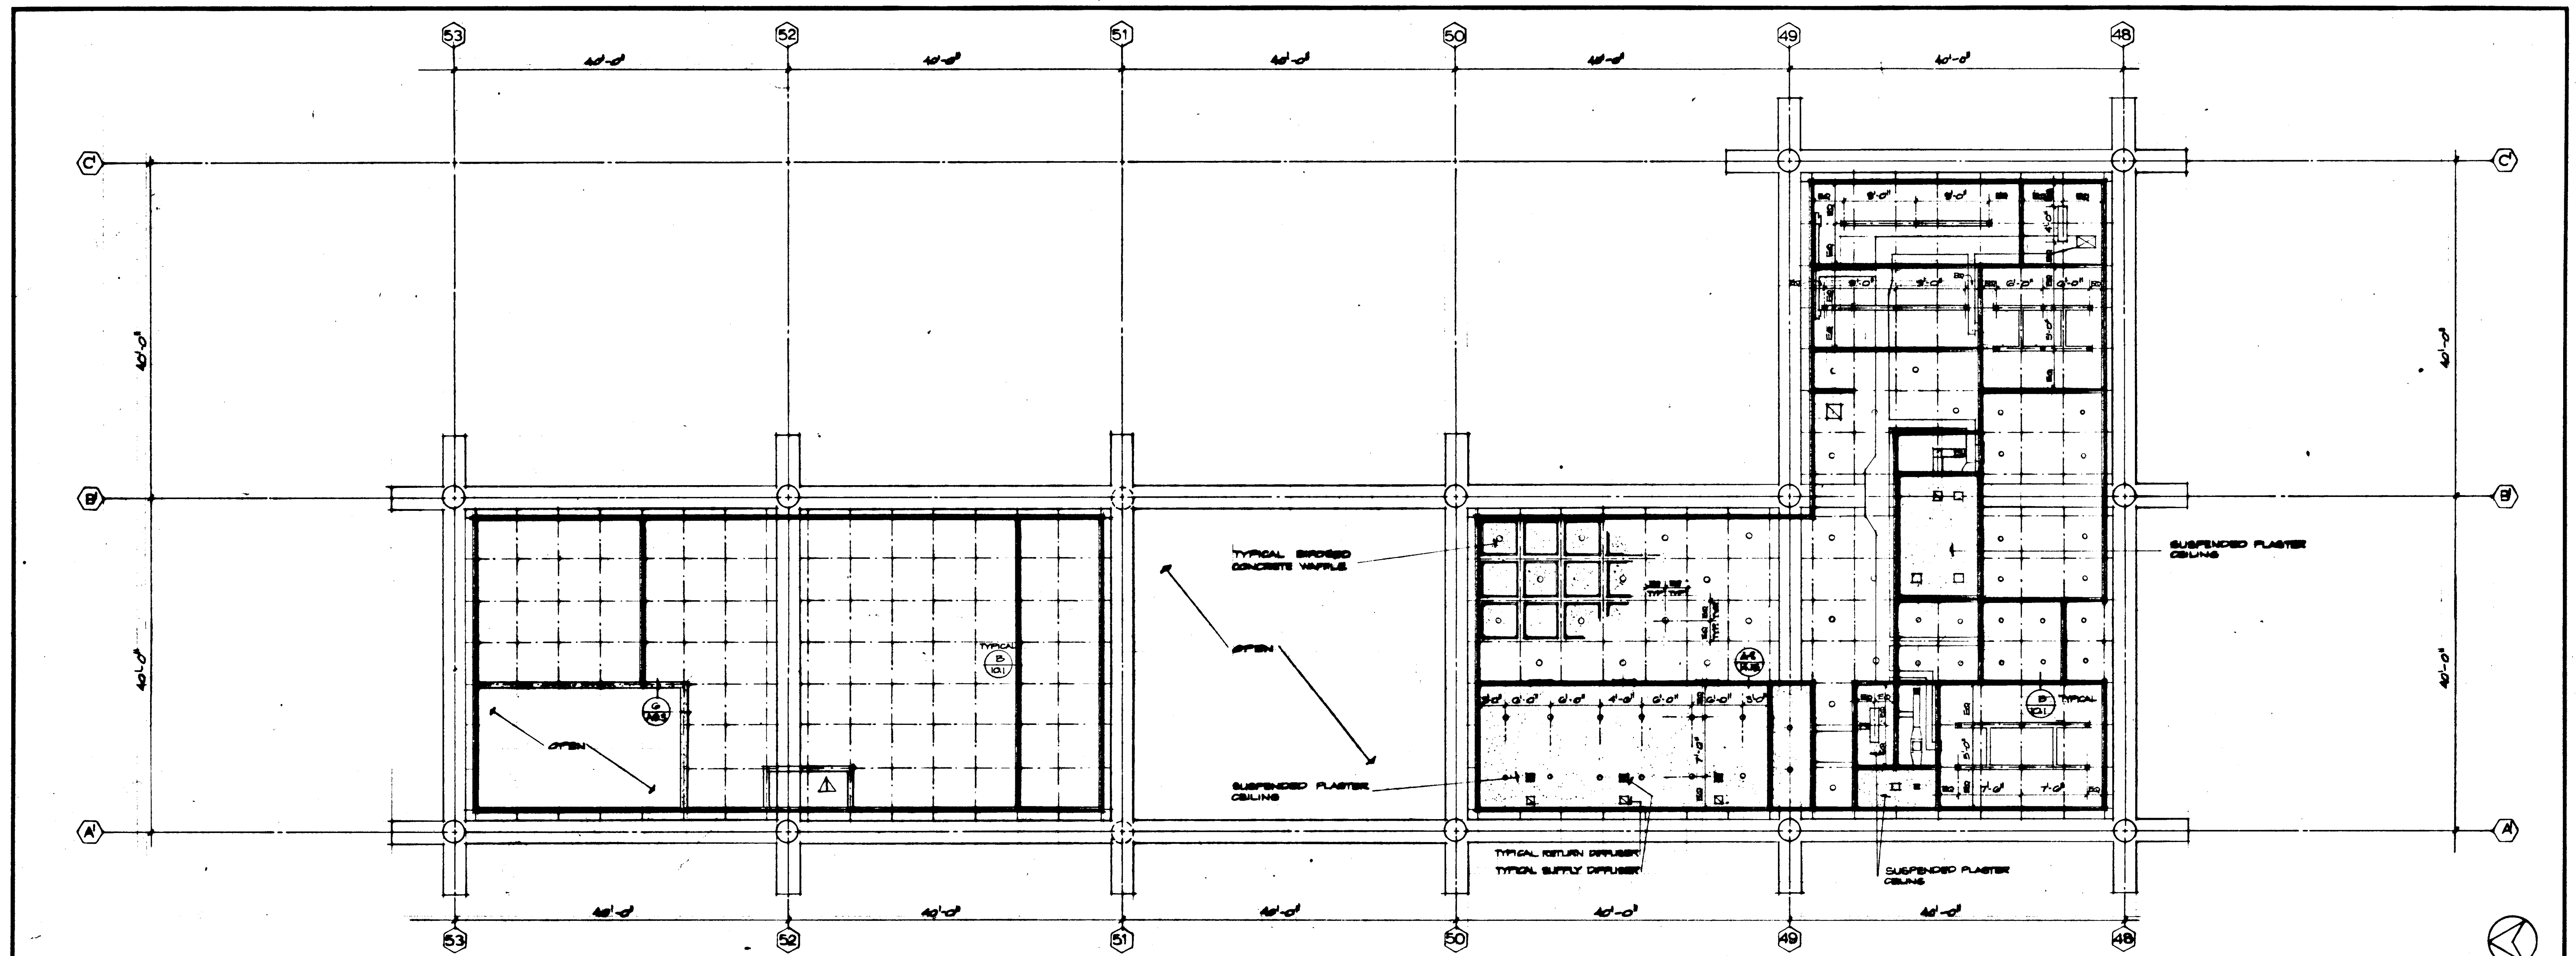

UNIT 10 FIRST FLOOR


SCALE 1/8" = 1'-0"

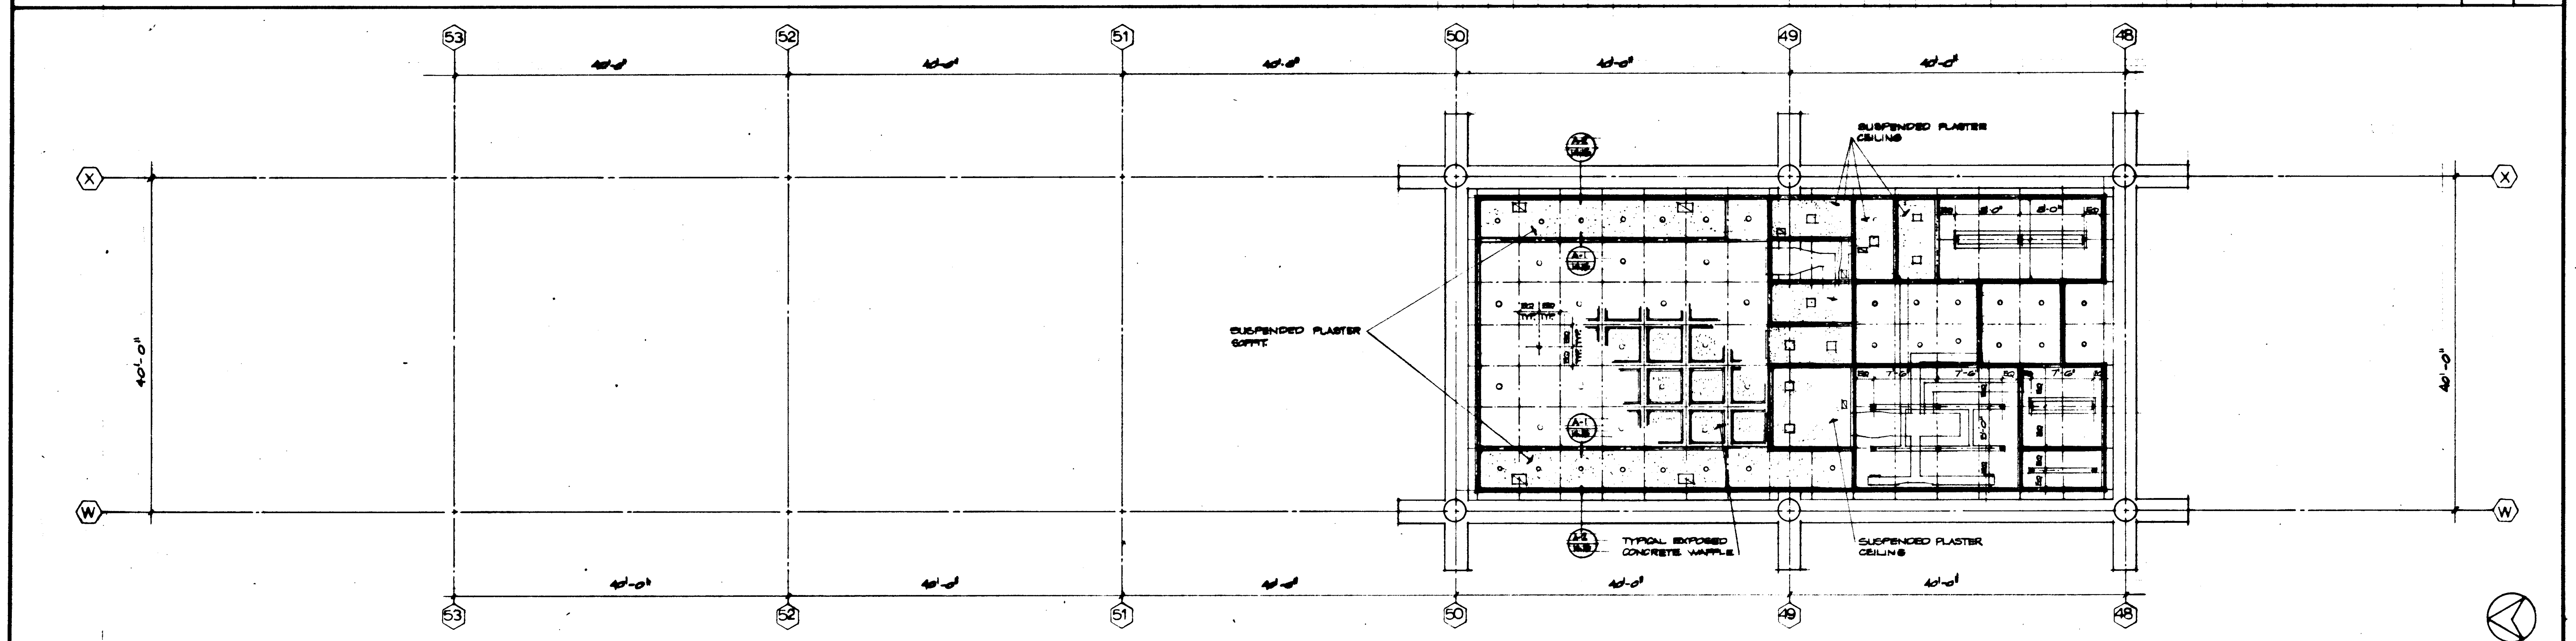

UNIT 11 FIRST FLOOR


SCALE 1/8" = 1'-0"

DATE	BY	REVISIONS	DESIGNED	ARCHITECT	APPROVED	ASSOCIATED ARCHITECTS:	GOLDEN WEST COLLEGE	UNIT 10-11	JOB NO.
						WILLIAM L. FERREIRA & ASSOCIATES	HUNTINGTON BEACH, CALIFORNIA	REFLECTED	10-1
						A. QUINCY JONES, FREDERICK E. EDMONDS & ASSOCIATES	ORANGE COAST JUNIOR COLLEGE DISTRICT	CEILING	
						BLUBROCK HILSBROCK & ASSOCIATES		PLANS	
						URBANUS SQUARE • MACARTHUR BOULEVARD AT FORD ROAD			
						TELEPHONE 714/675-2640 • CORONA DEL MAR, CALIFORNIA			

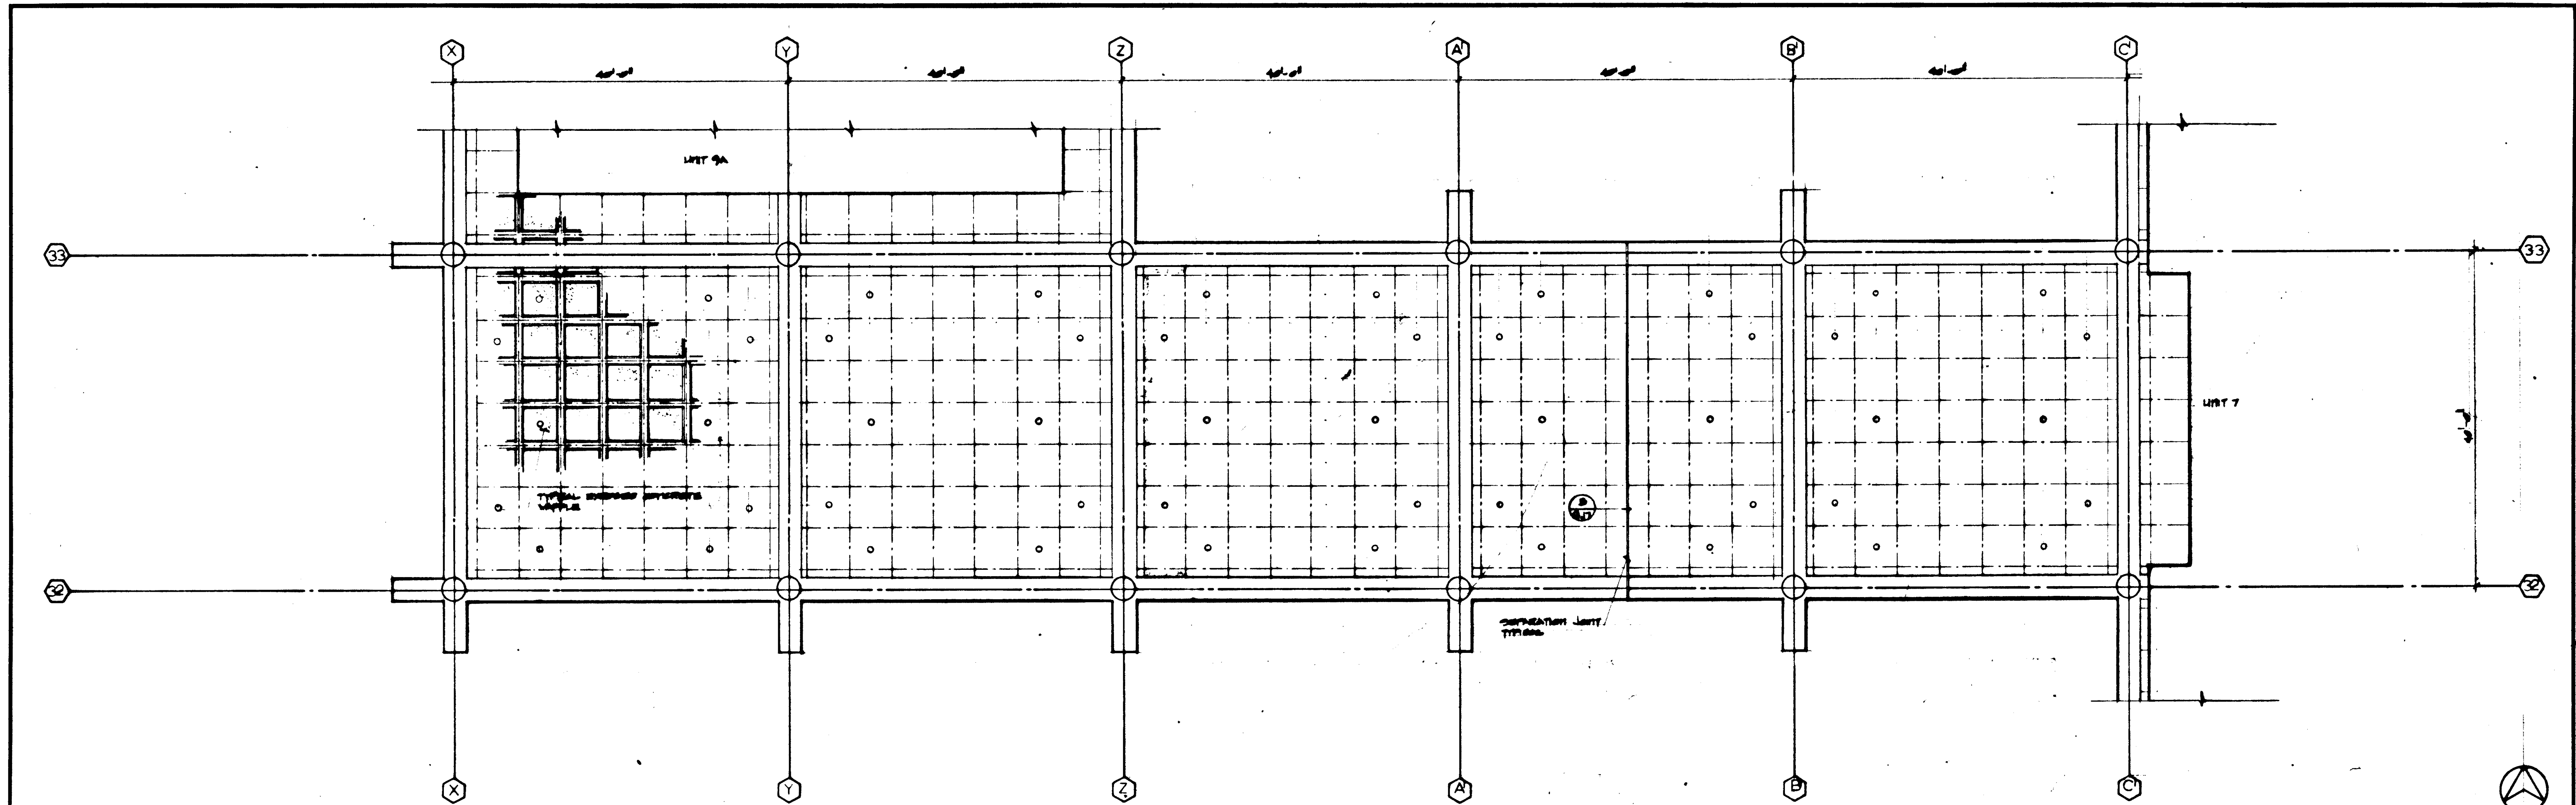

UNIT 13 FIRST FLOOR


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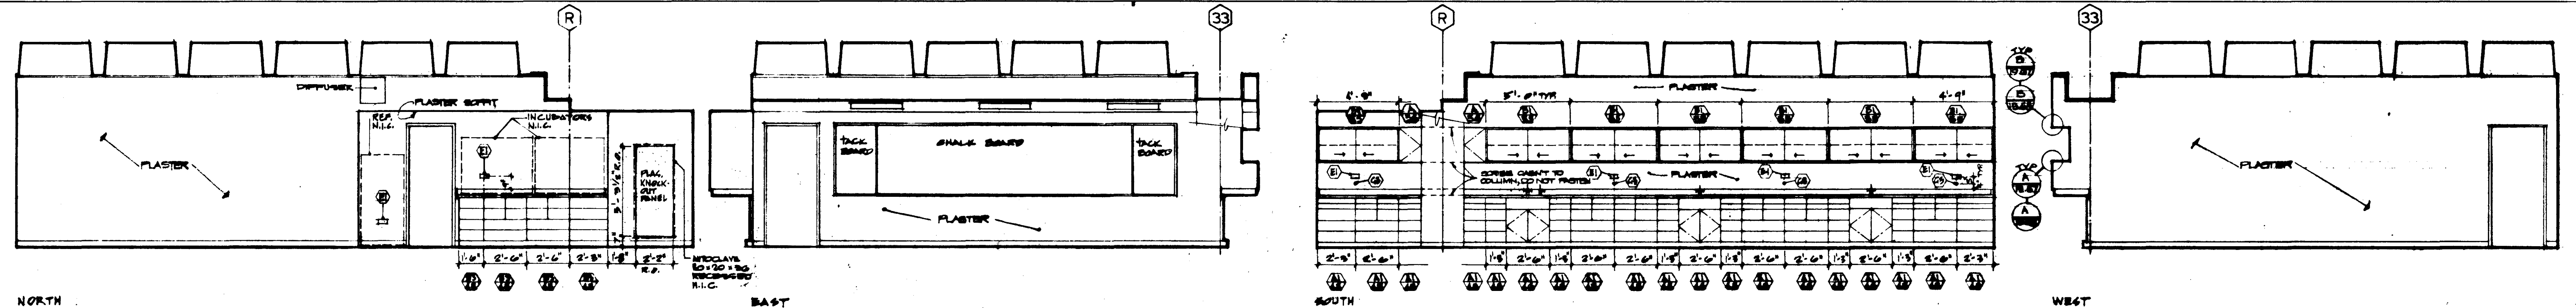
UNIT 12 FIRST FLOOR
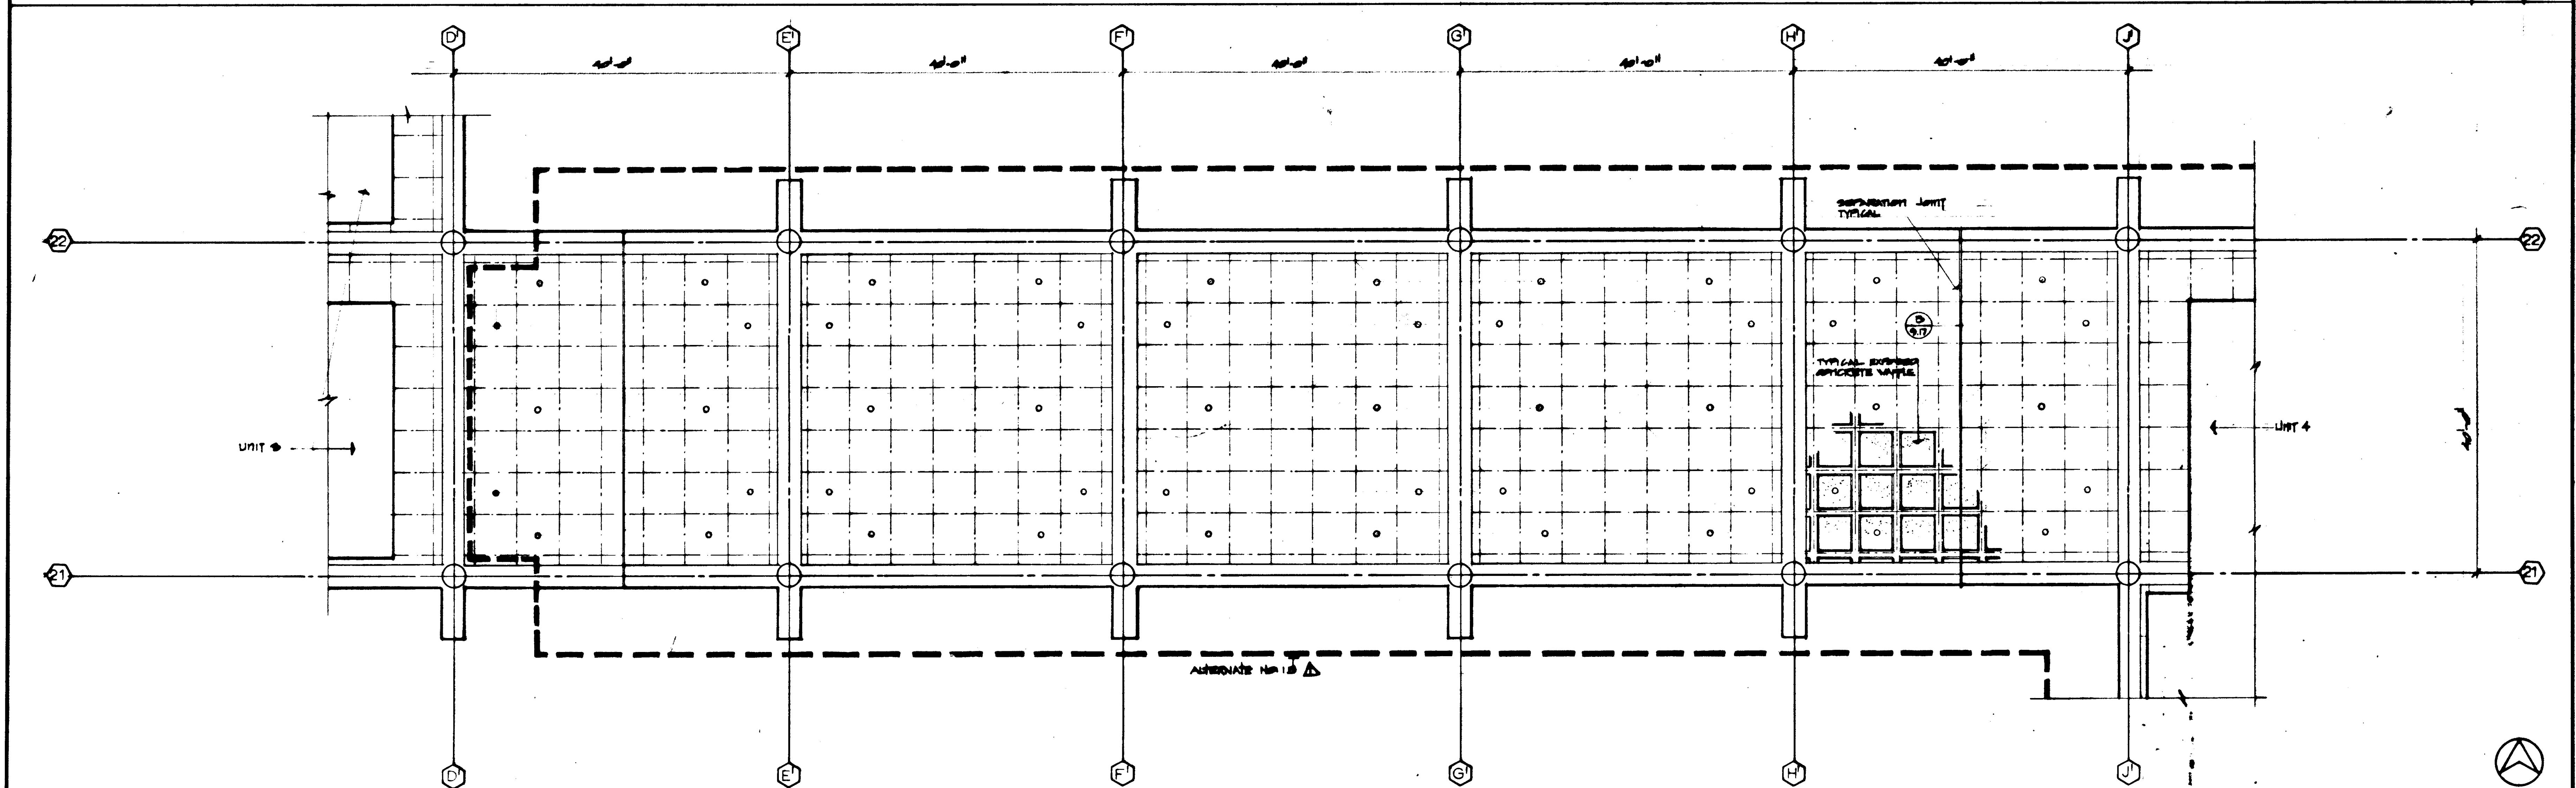
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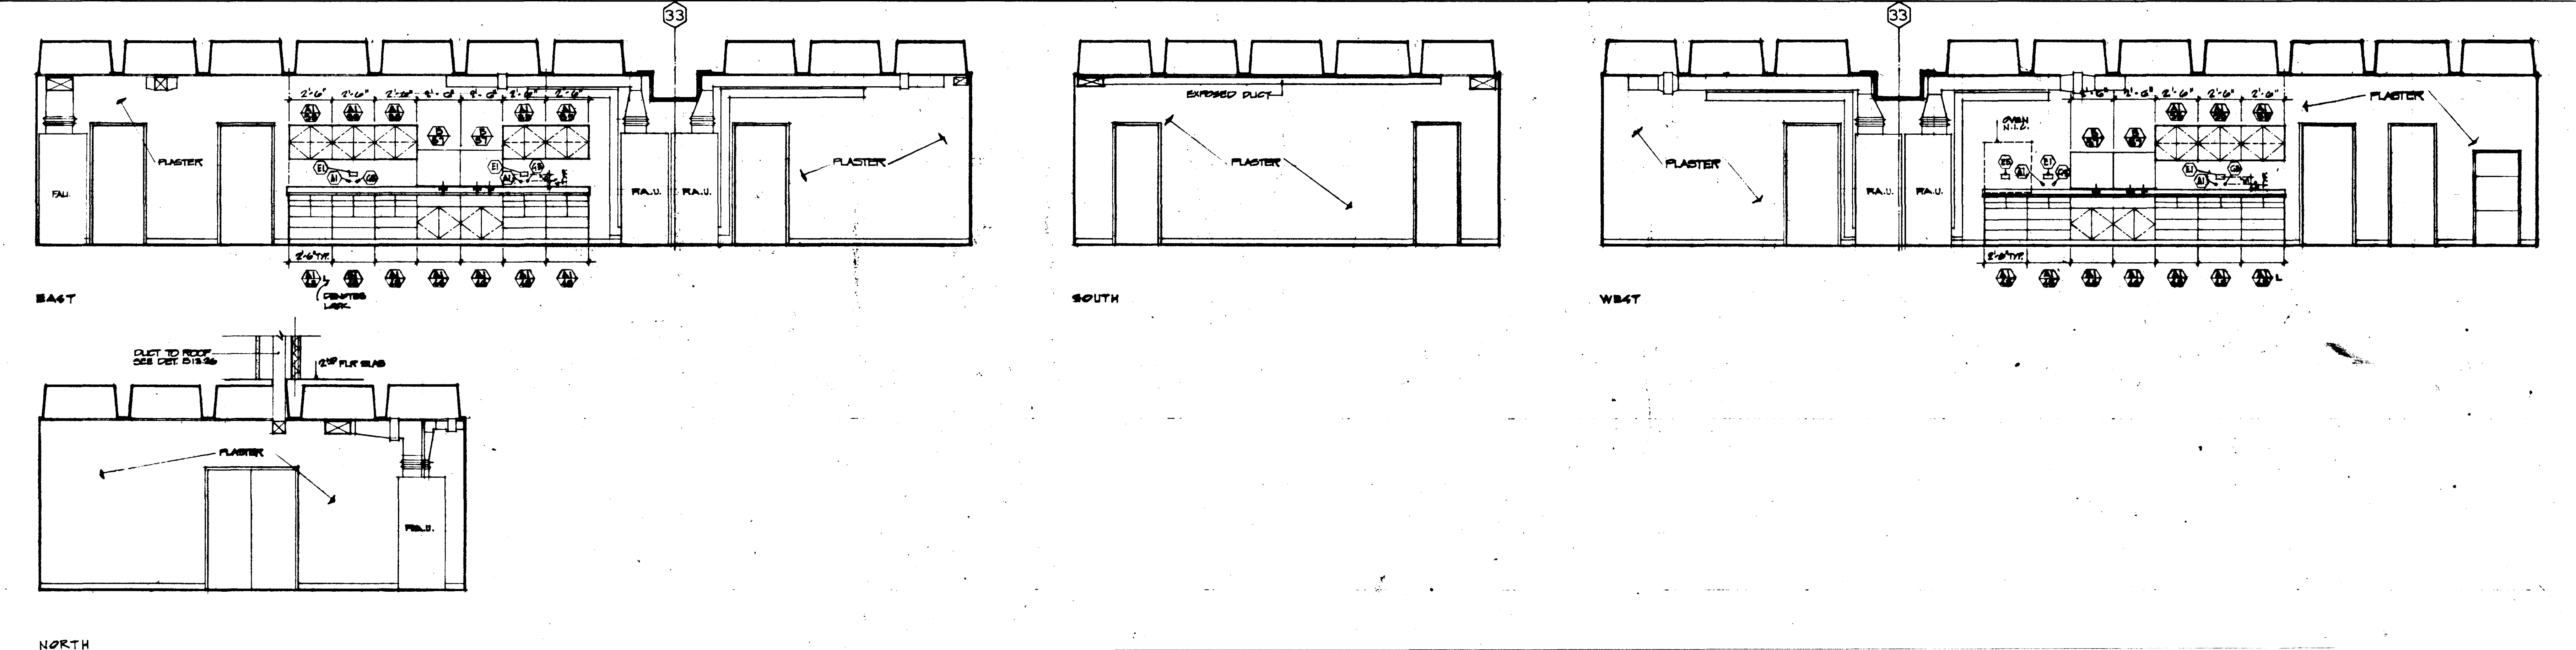
UNIT 12 FIRST FLOOR		UNIT 12 & 13
GOLDEN WEST COLLEGE HUNTINGTON BEACH, CALIFORNIA ORANGE COAST JUNIOR COLLEGE DISTRICT		REFLECTED CEILING PLANS
ASSOCIATED ARCHITECTS: WILLIAM L. PEREIRA & ASSOCIATES A. QUINCY JONES-FREDERICK E. EMMONS & ASSOCIATES BLUROCK ELLERBROCK & ASSOCIATES URBANUS SQUARE • MACARTHUR BOULEVARD AT FORD ROAD TELEPHONE 714/675-2640 • CORONA DEL MAR, CALIFORNIA		JOB NO. 10-1 DATE 15 JUN 1965 SHEET NO. A.M.C.




LECTURE HALL 101

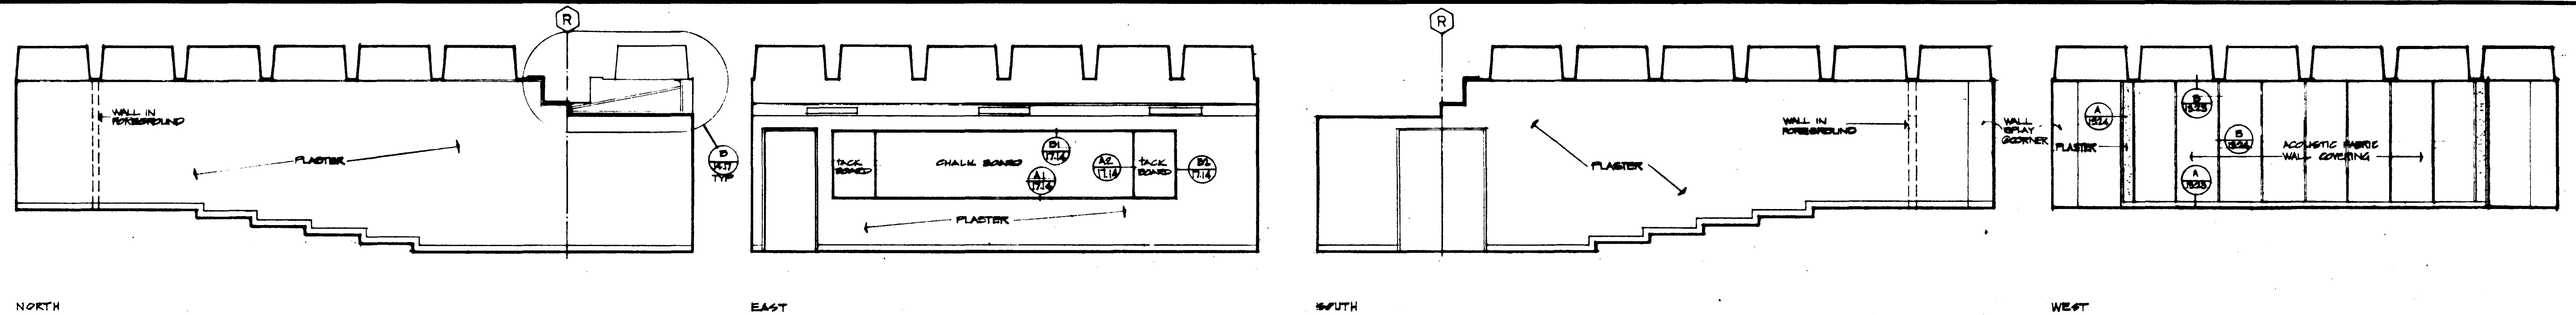

LAB. 1 103








LIFE SCIENCE COMMON WORK STORAGE 104

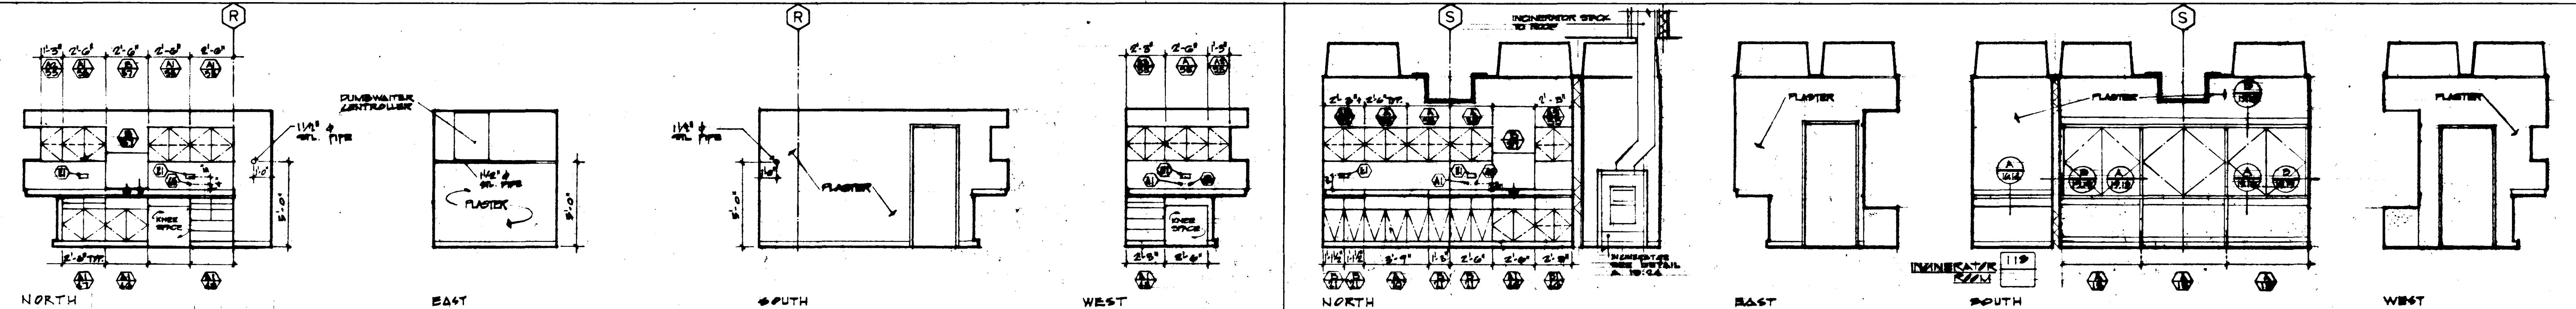


















PREPARATION 105

ANIMAL COLONY 109


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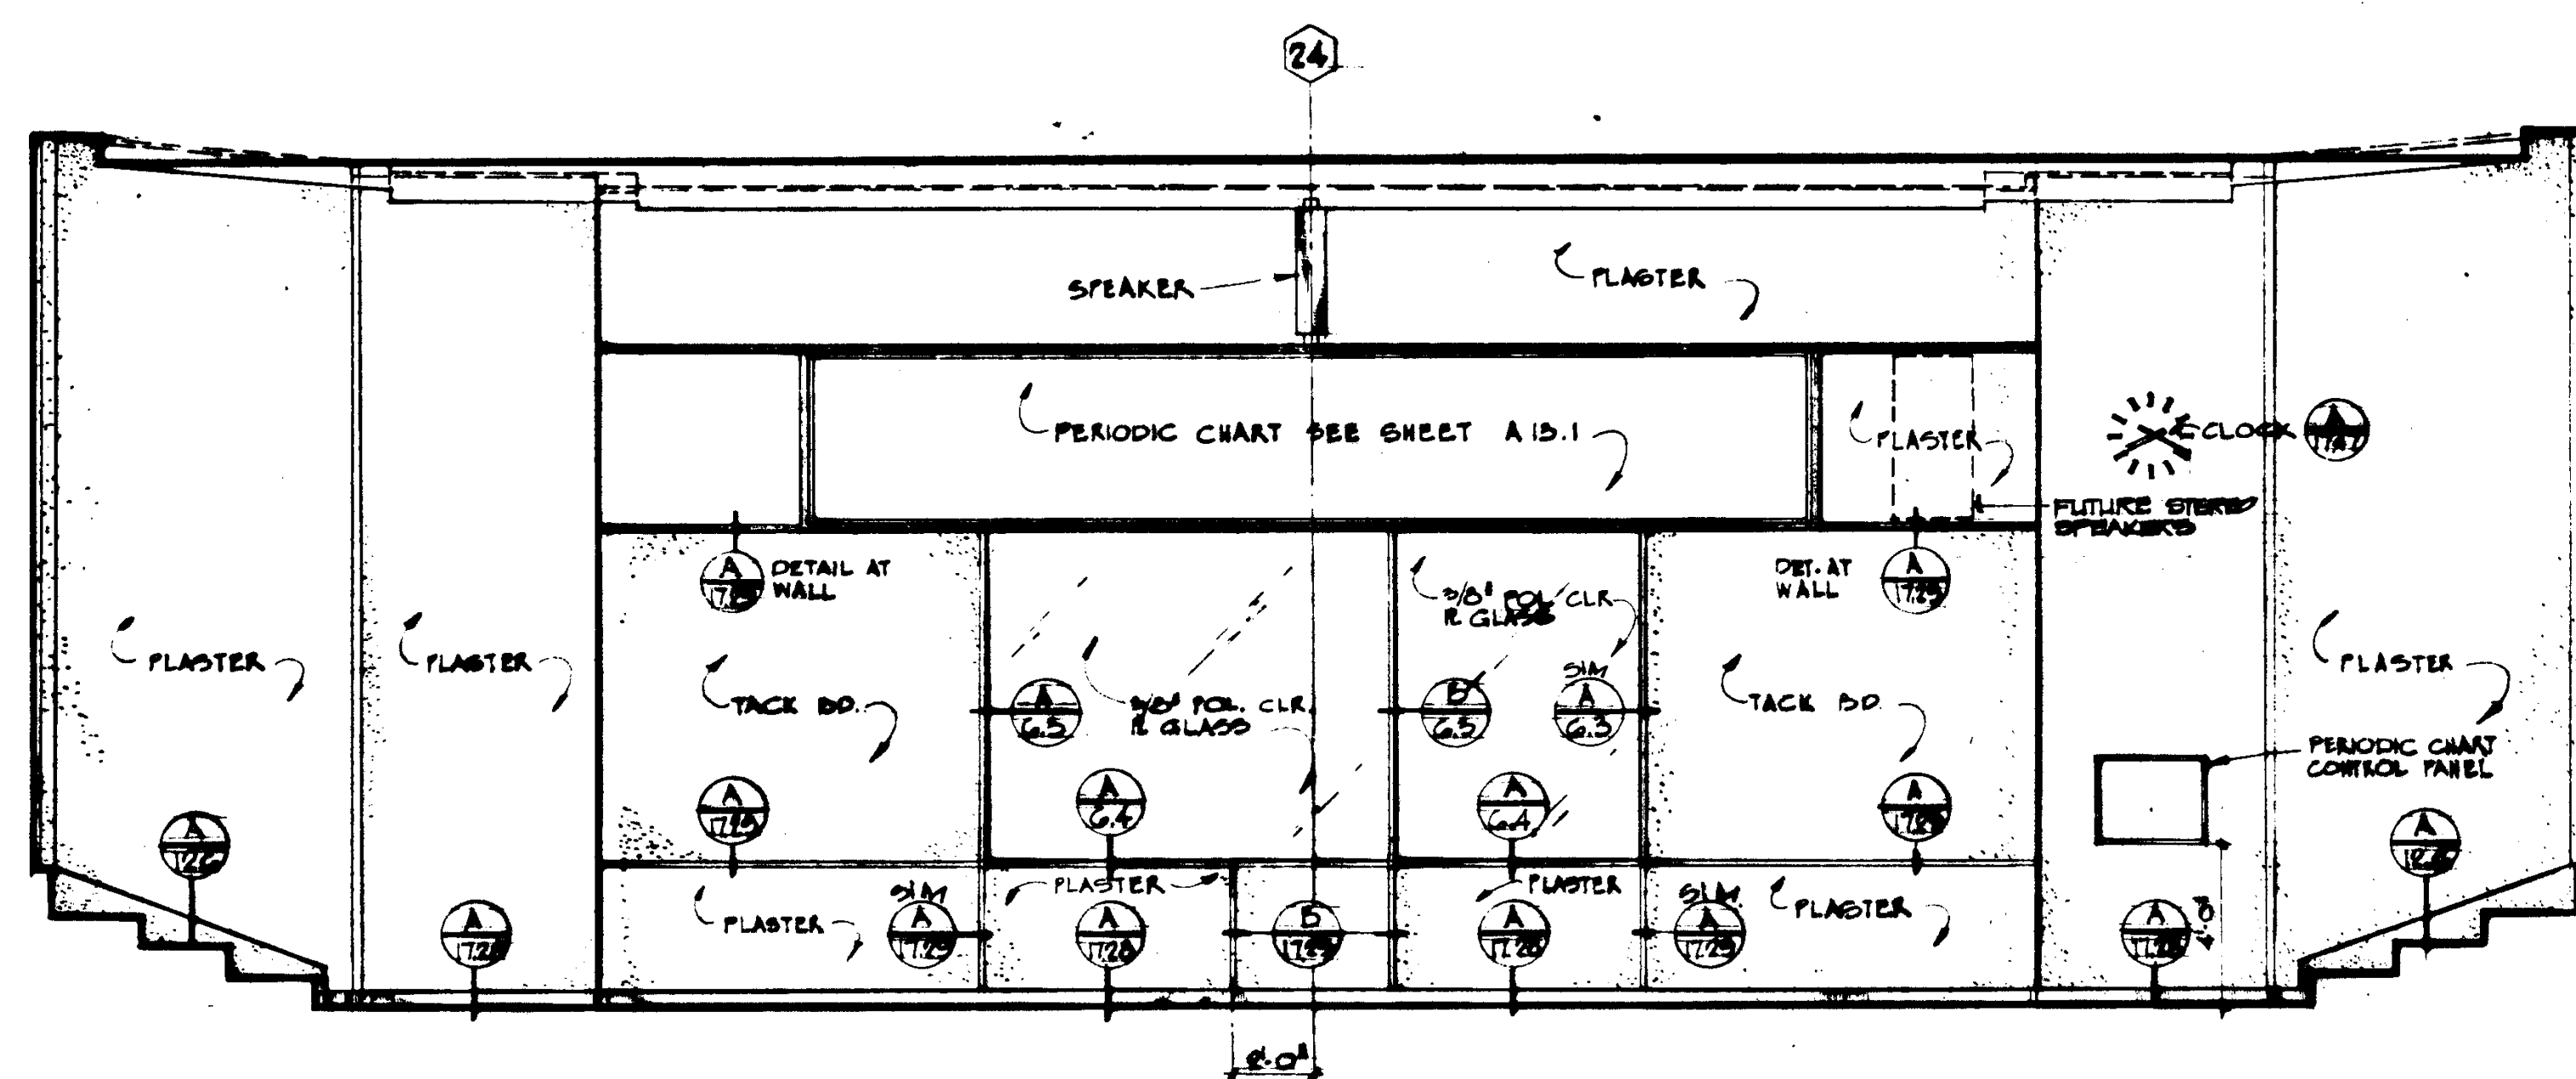

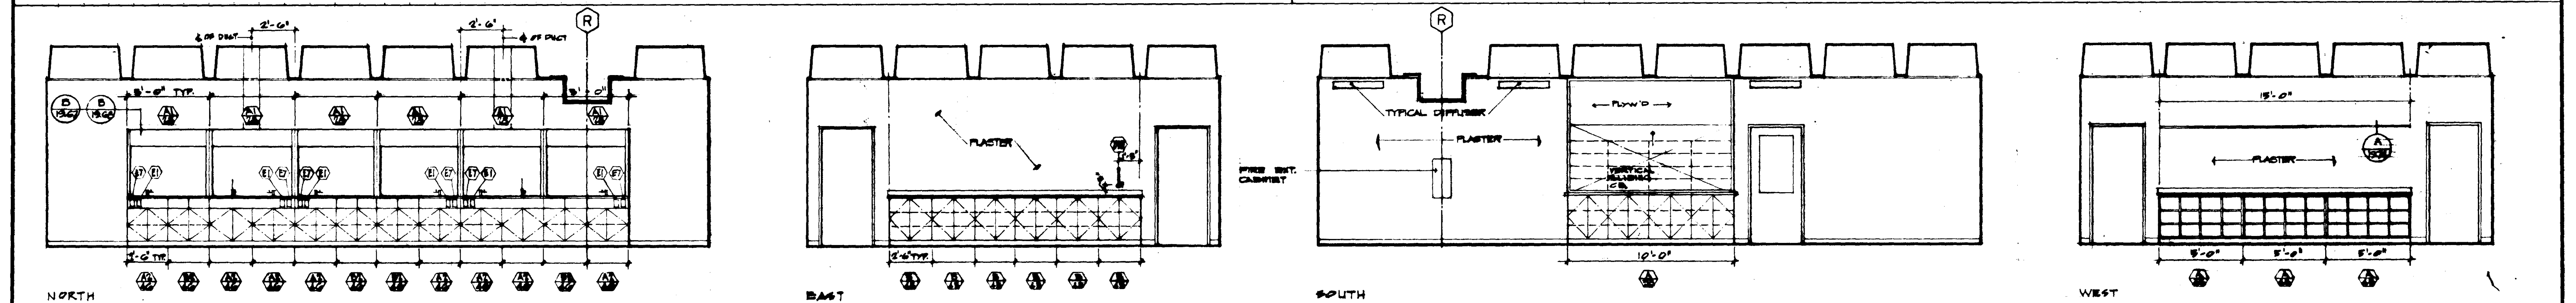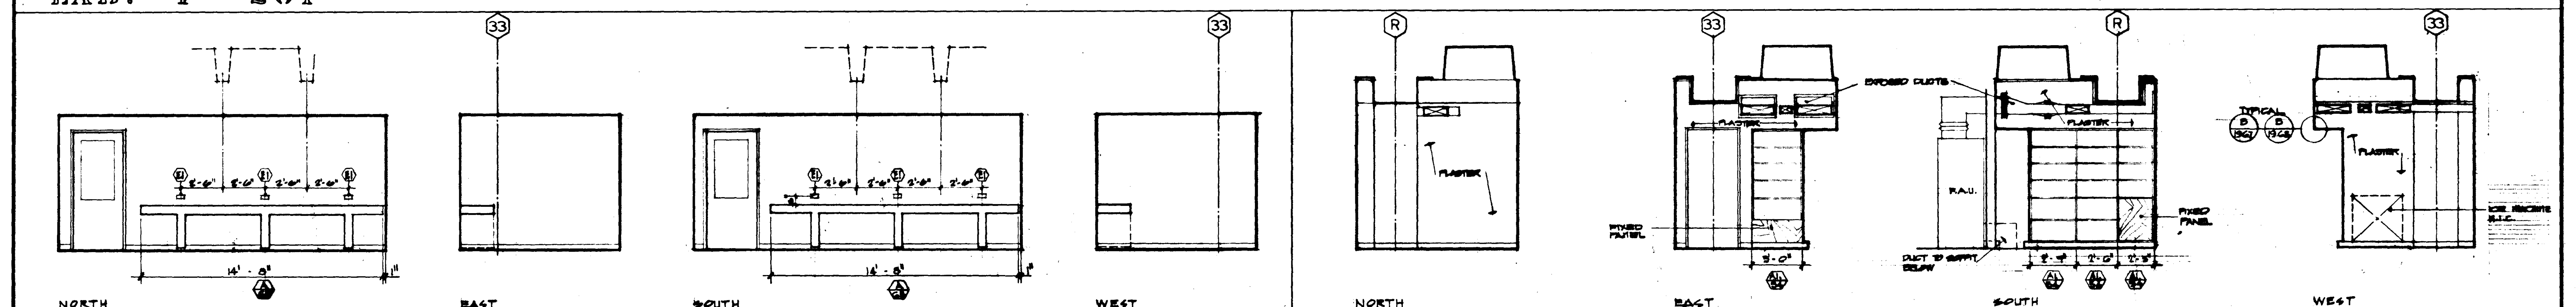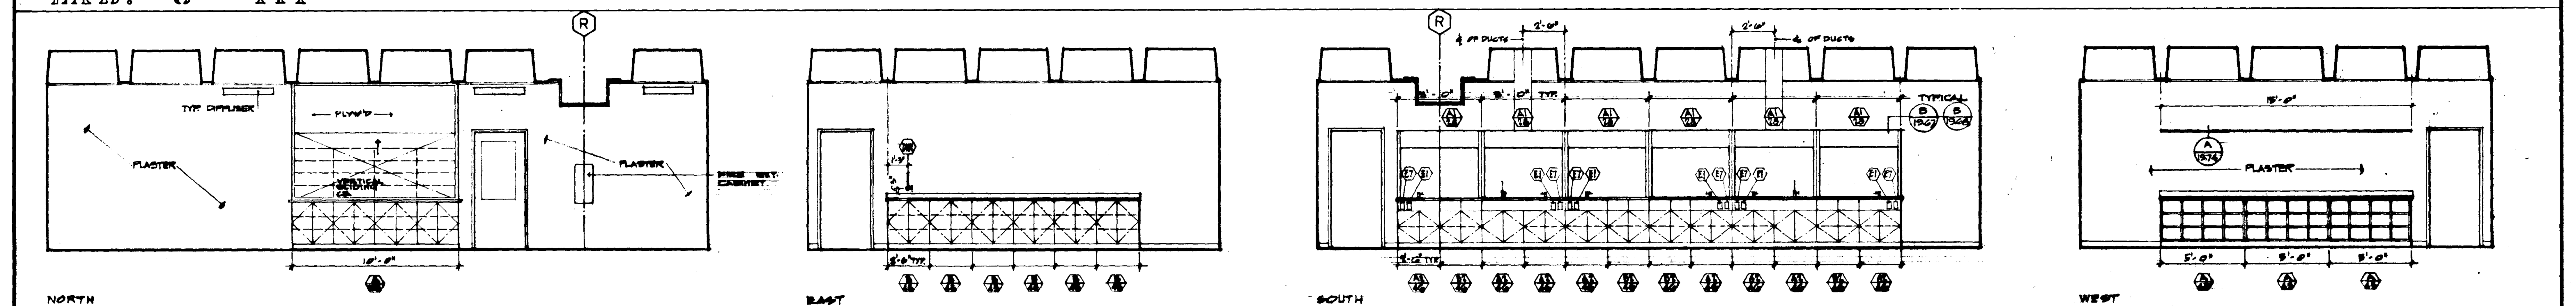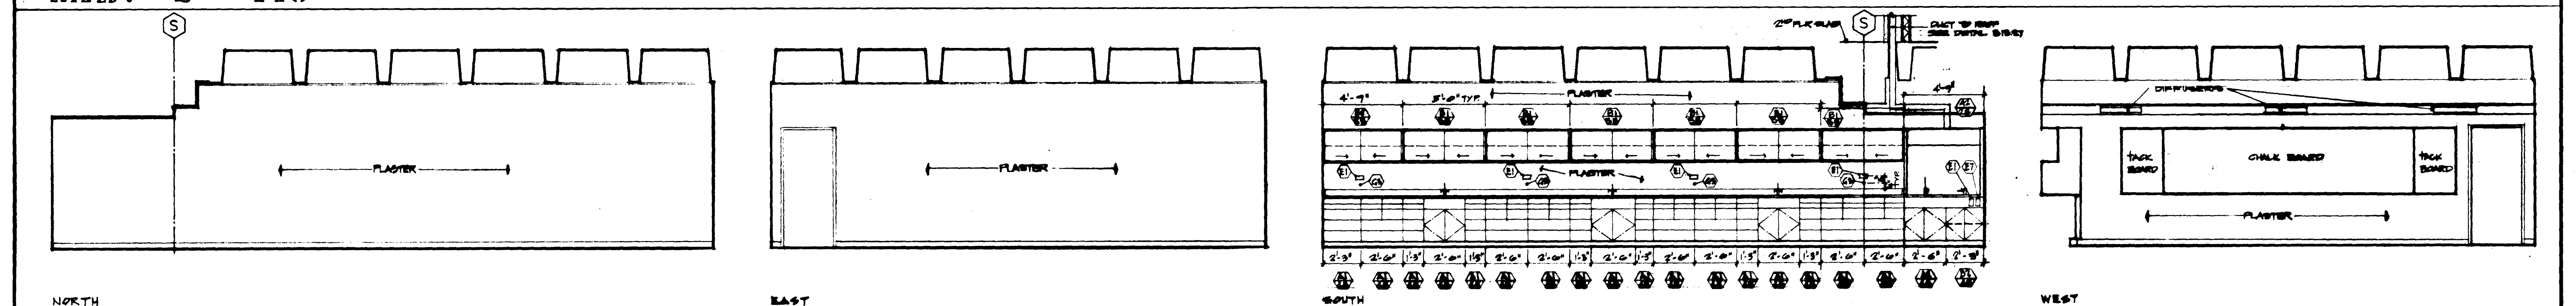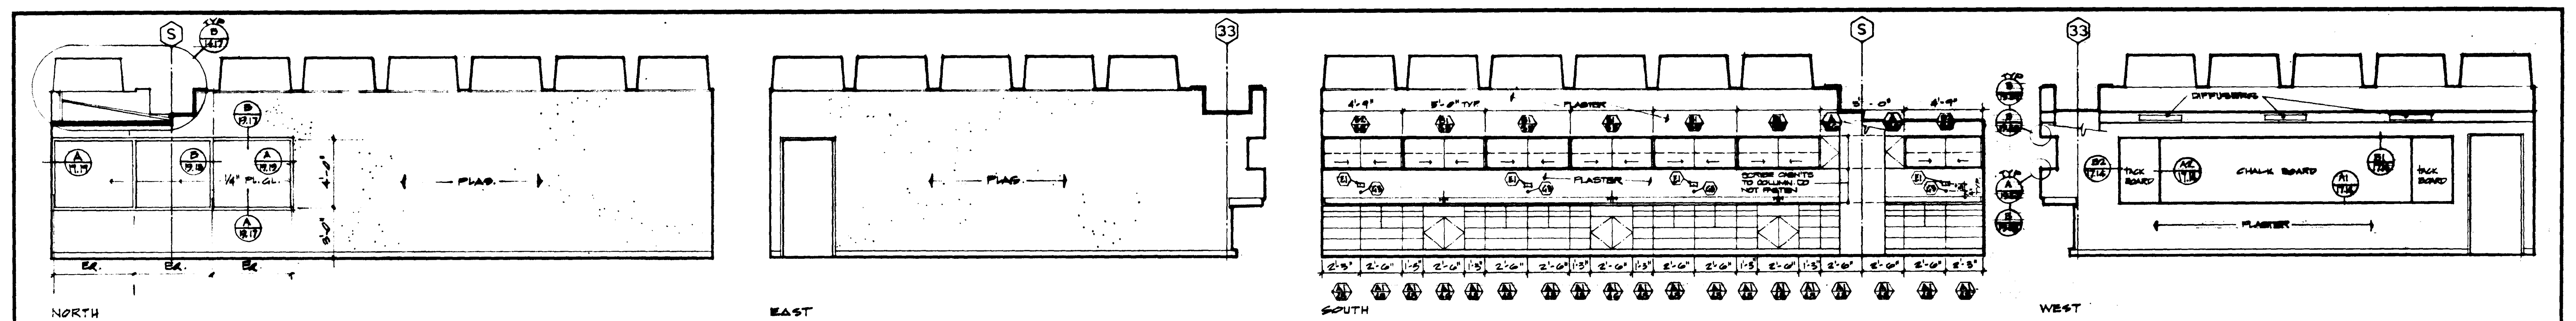
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	MECHANICAL ENGINEERS RALPH E. PHILLIPS, INC.	DRAWN BY	ENGINEER	APPROVED STATE FIRE MARSHAL STATE OF CALIFORNIA JUN 21 1965				
	ELECTRICAL ENGINEERS RALPH E. PHILLIPS, INC.	CHECKED BY	COLLEGE					
	CIVIL ENGINEERS G. SHUFLMAN & ASSOCIATES MOPART & HIGDON							

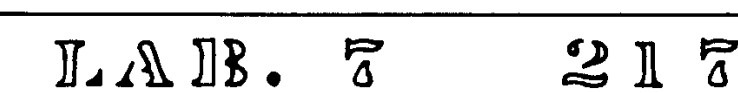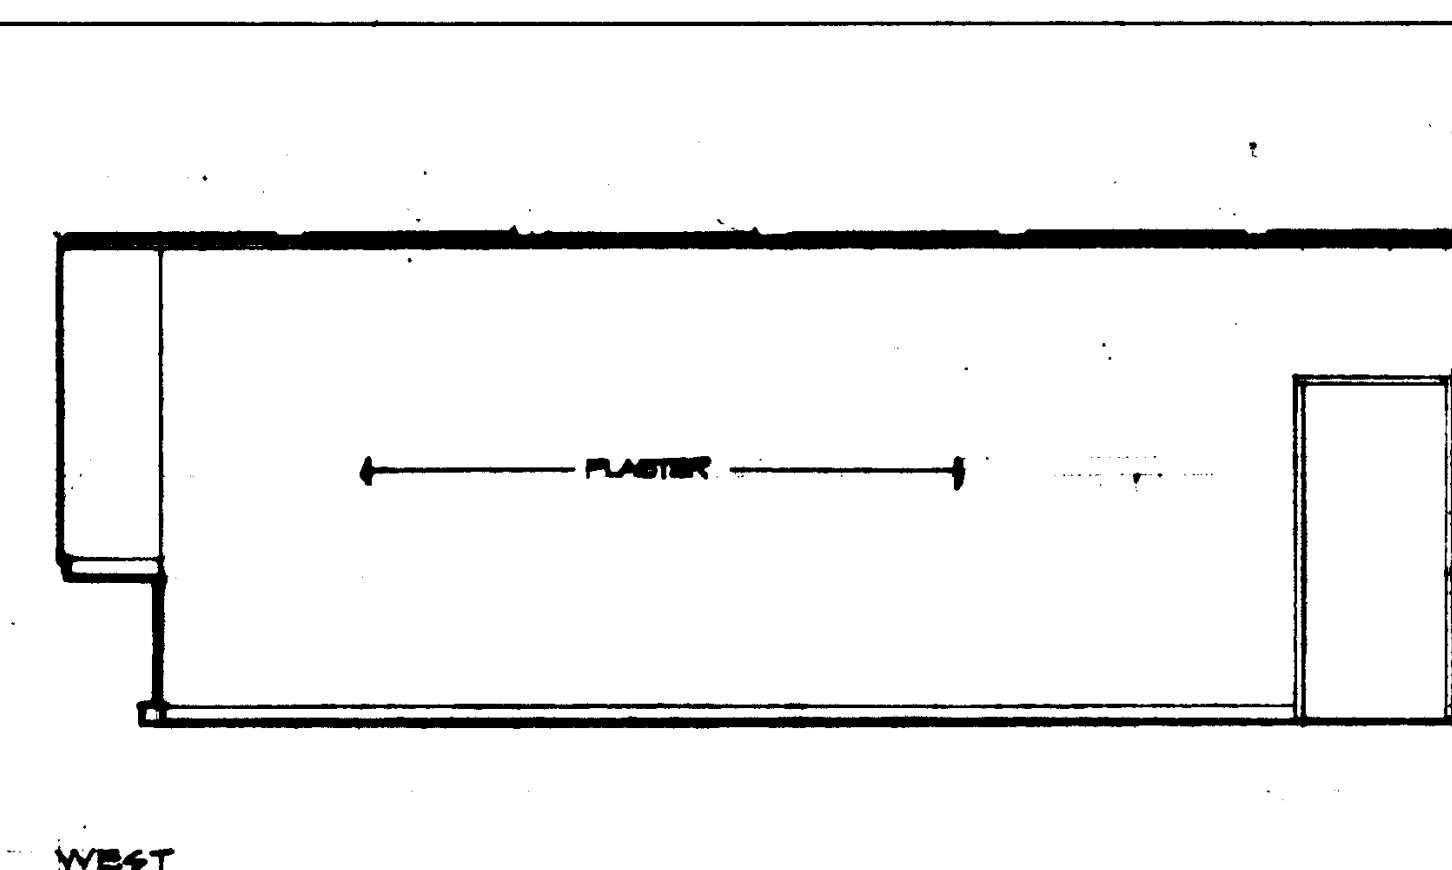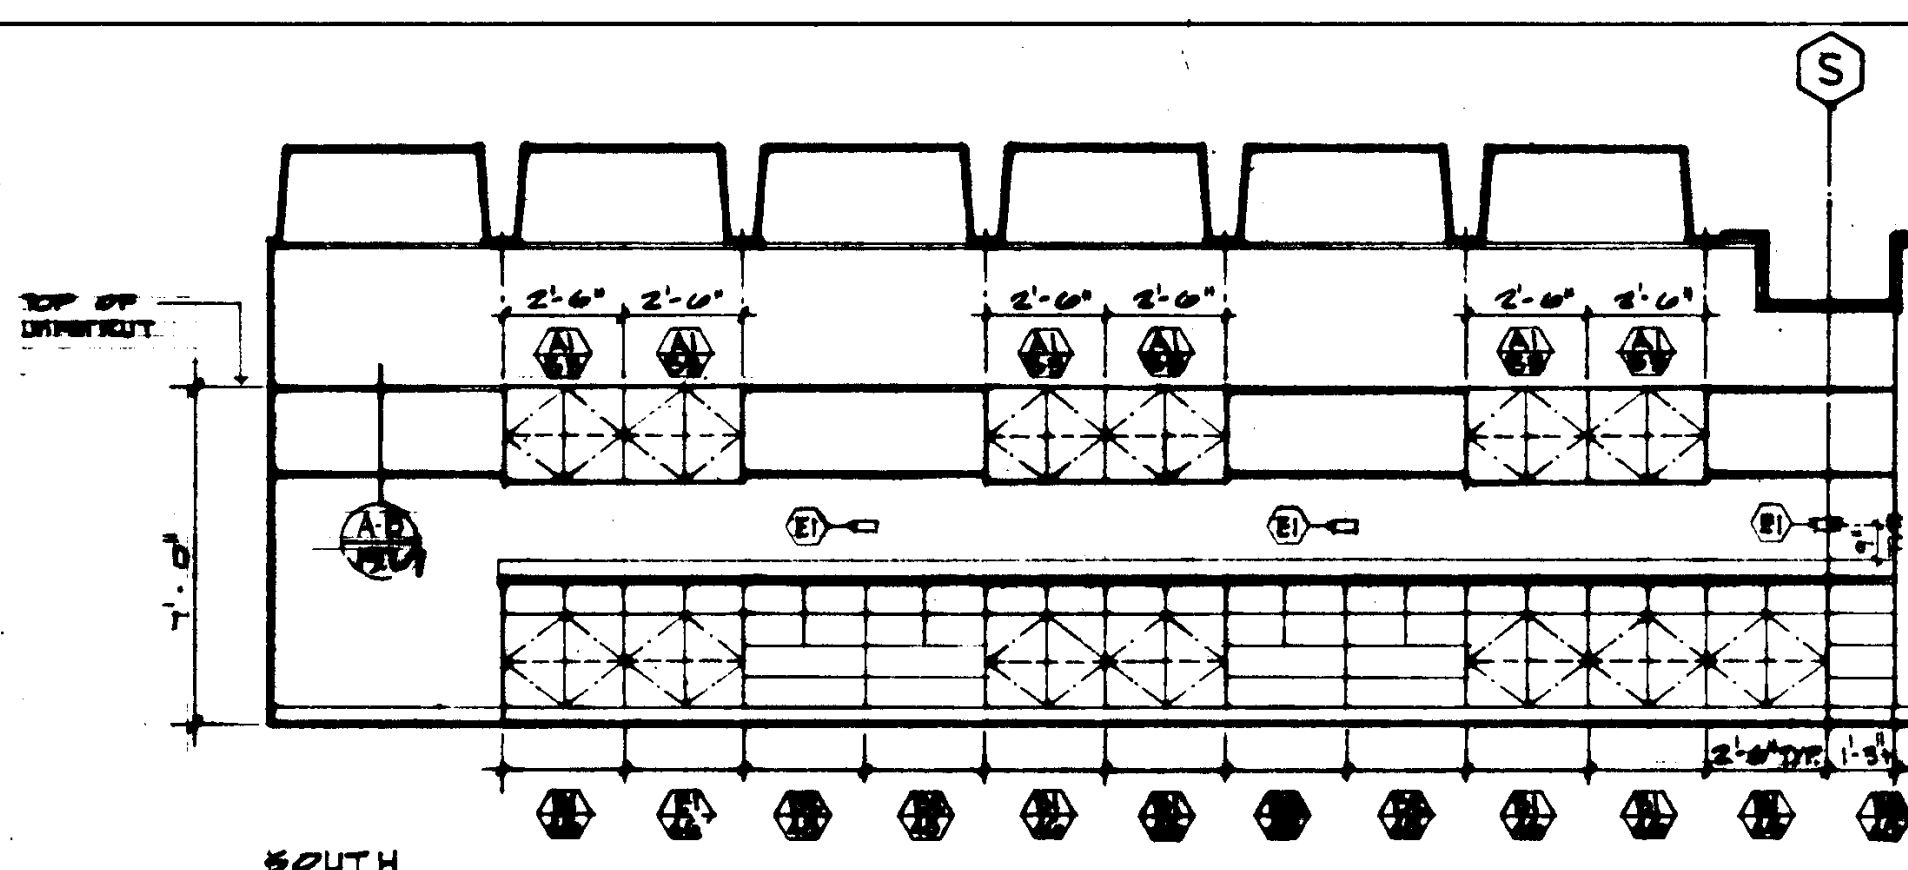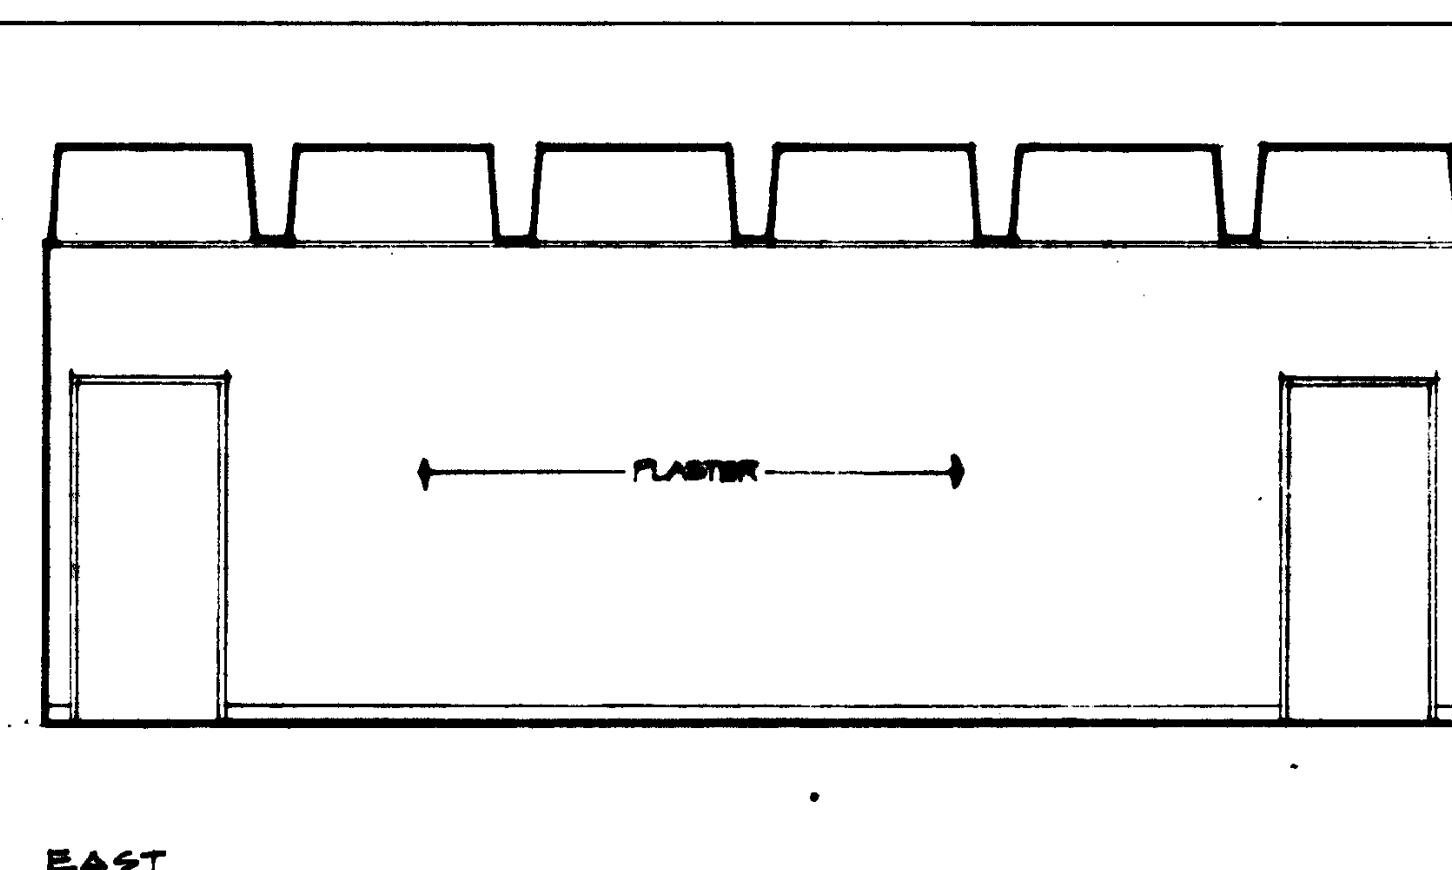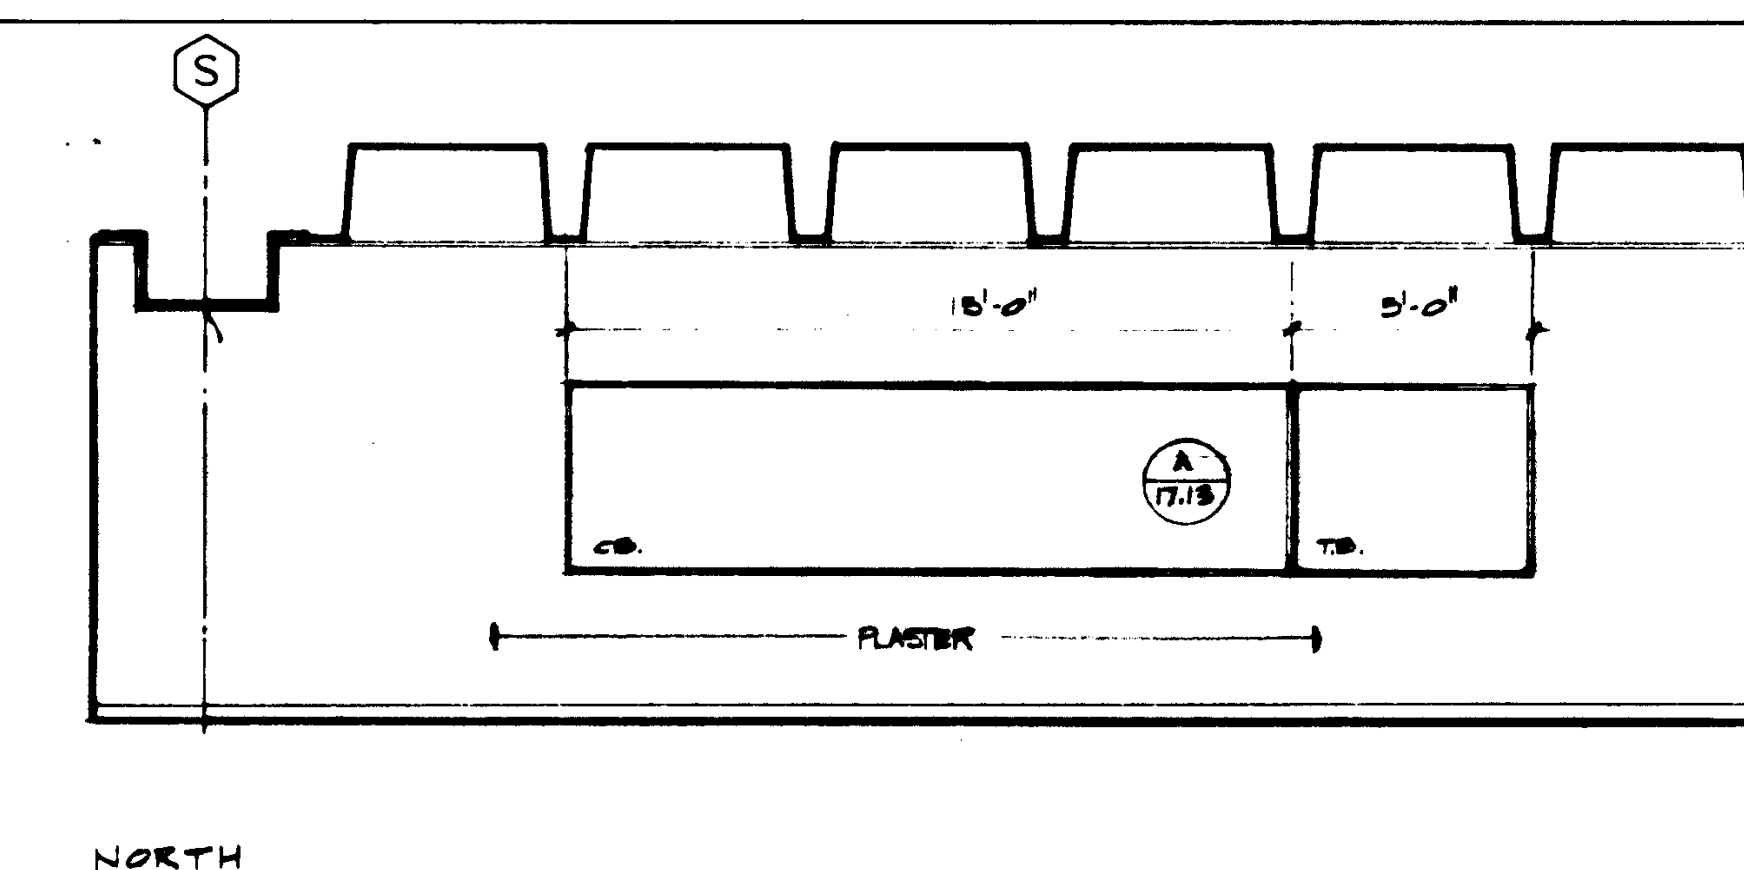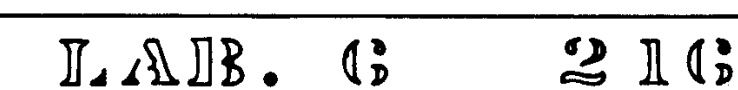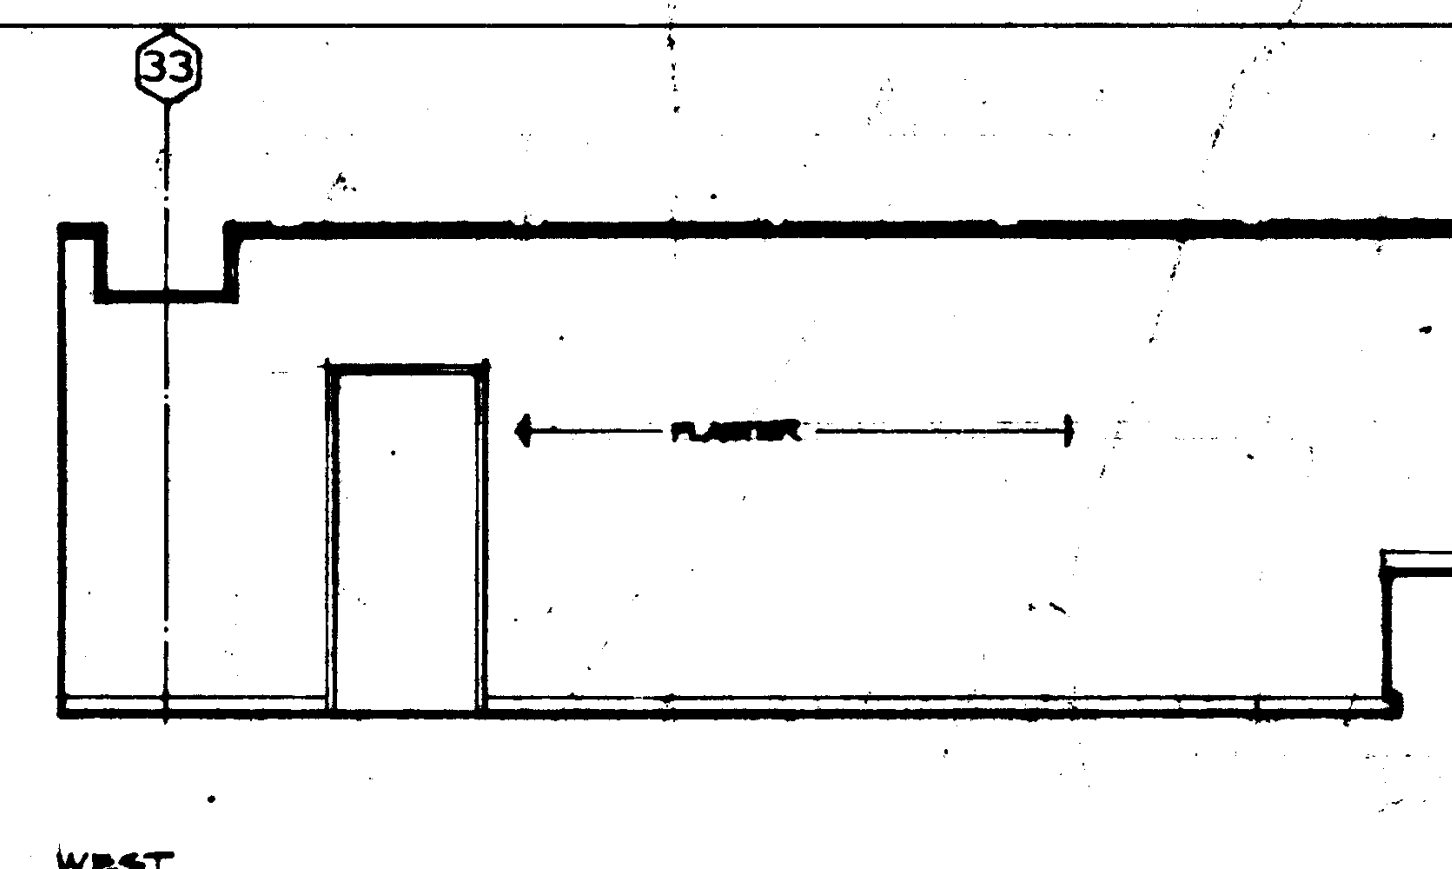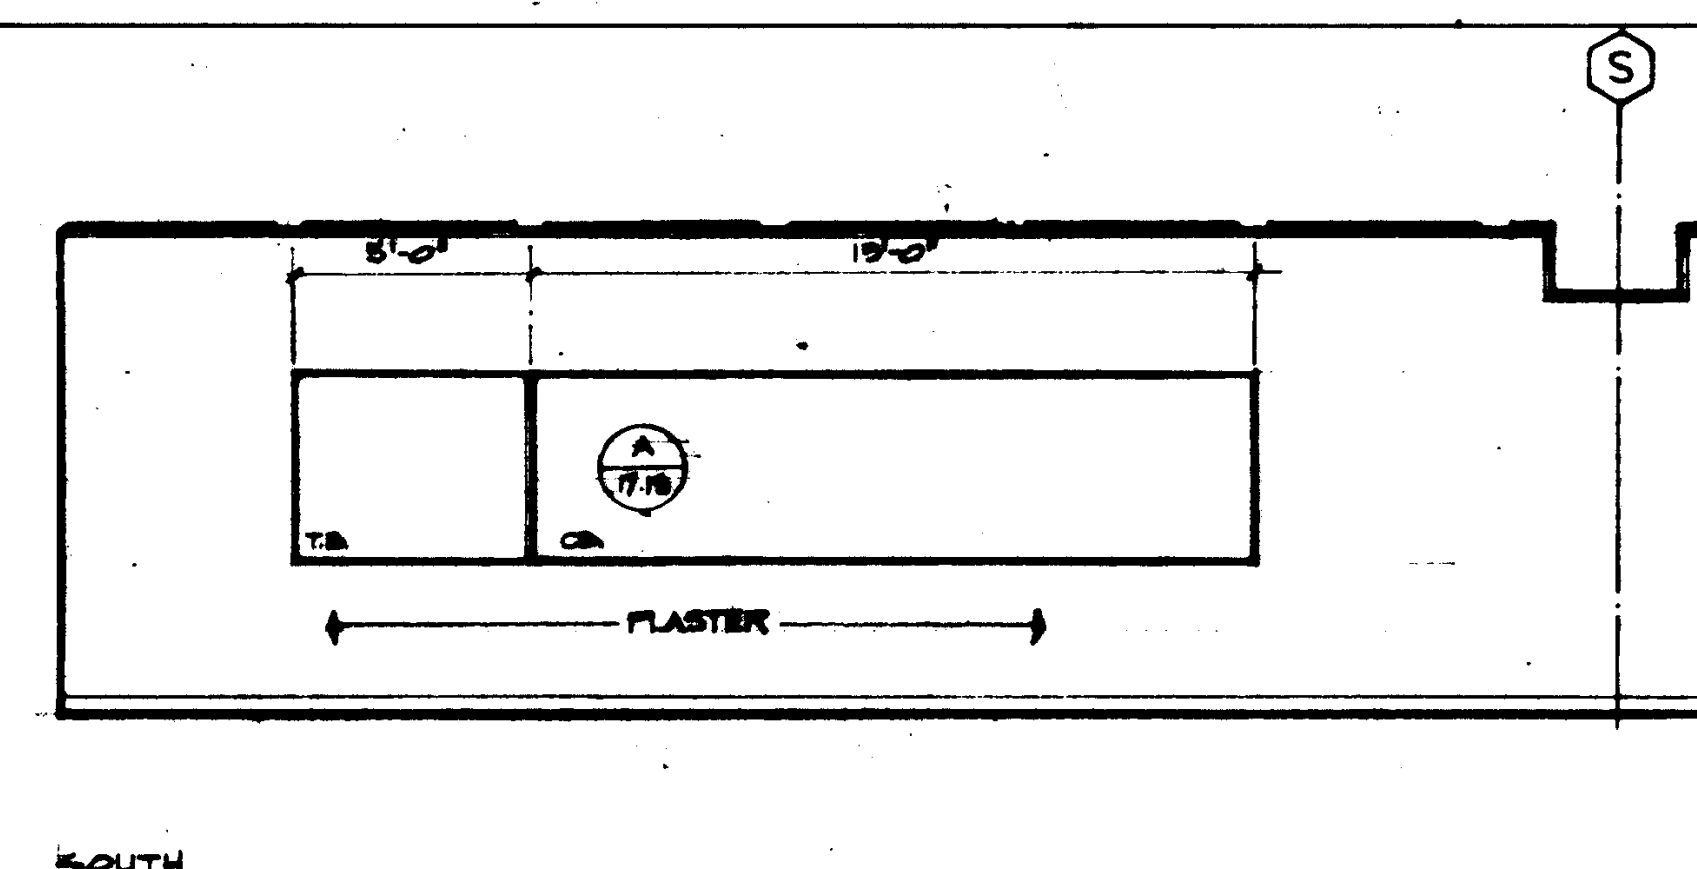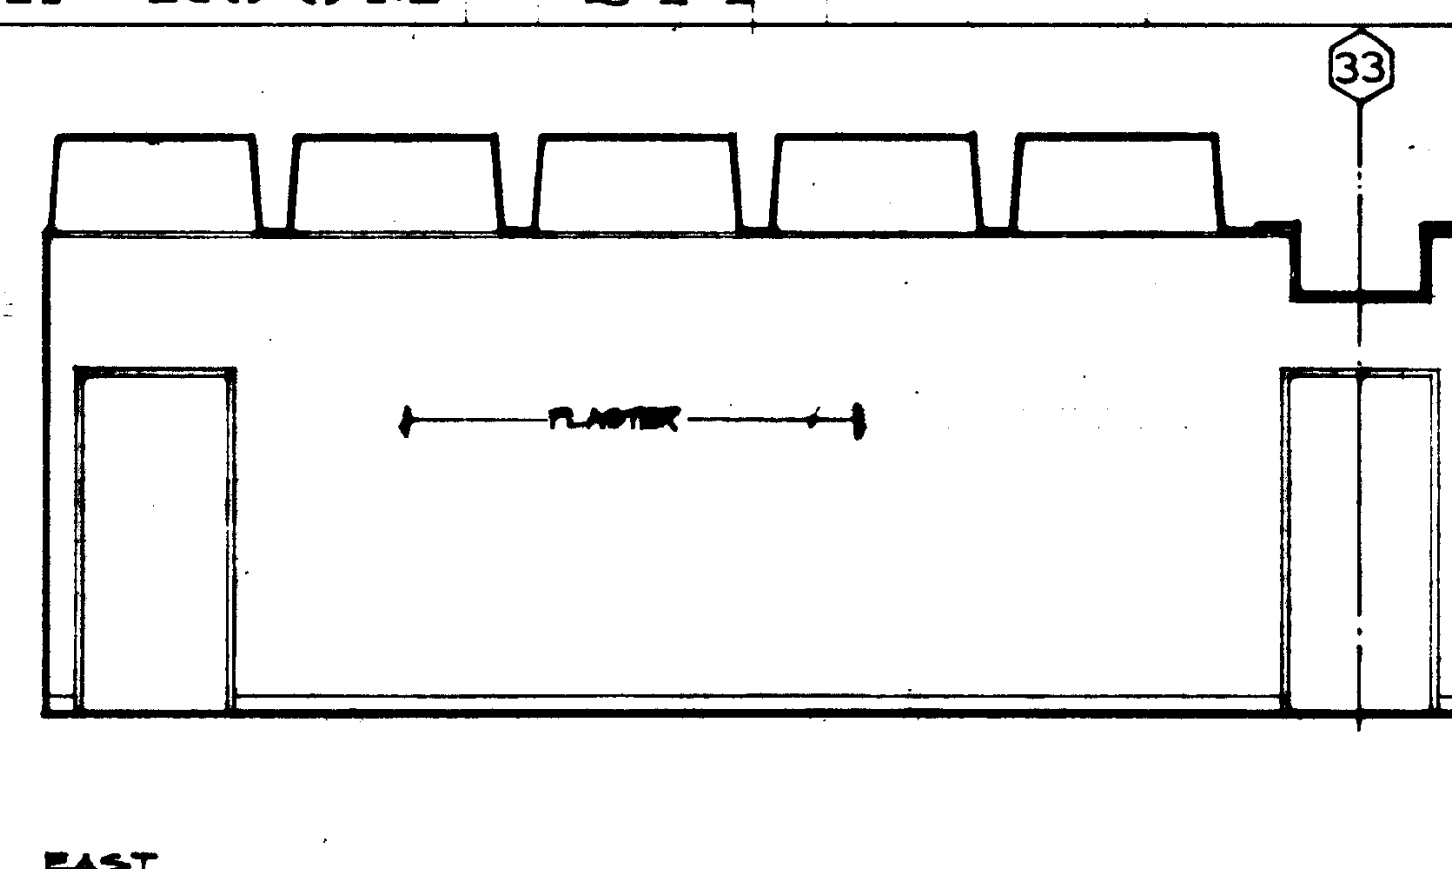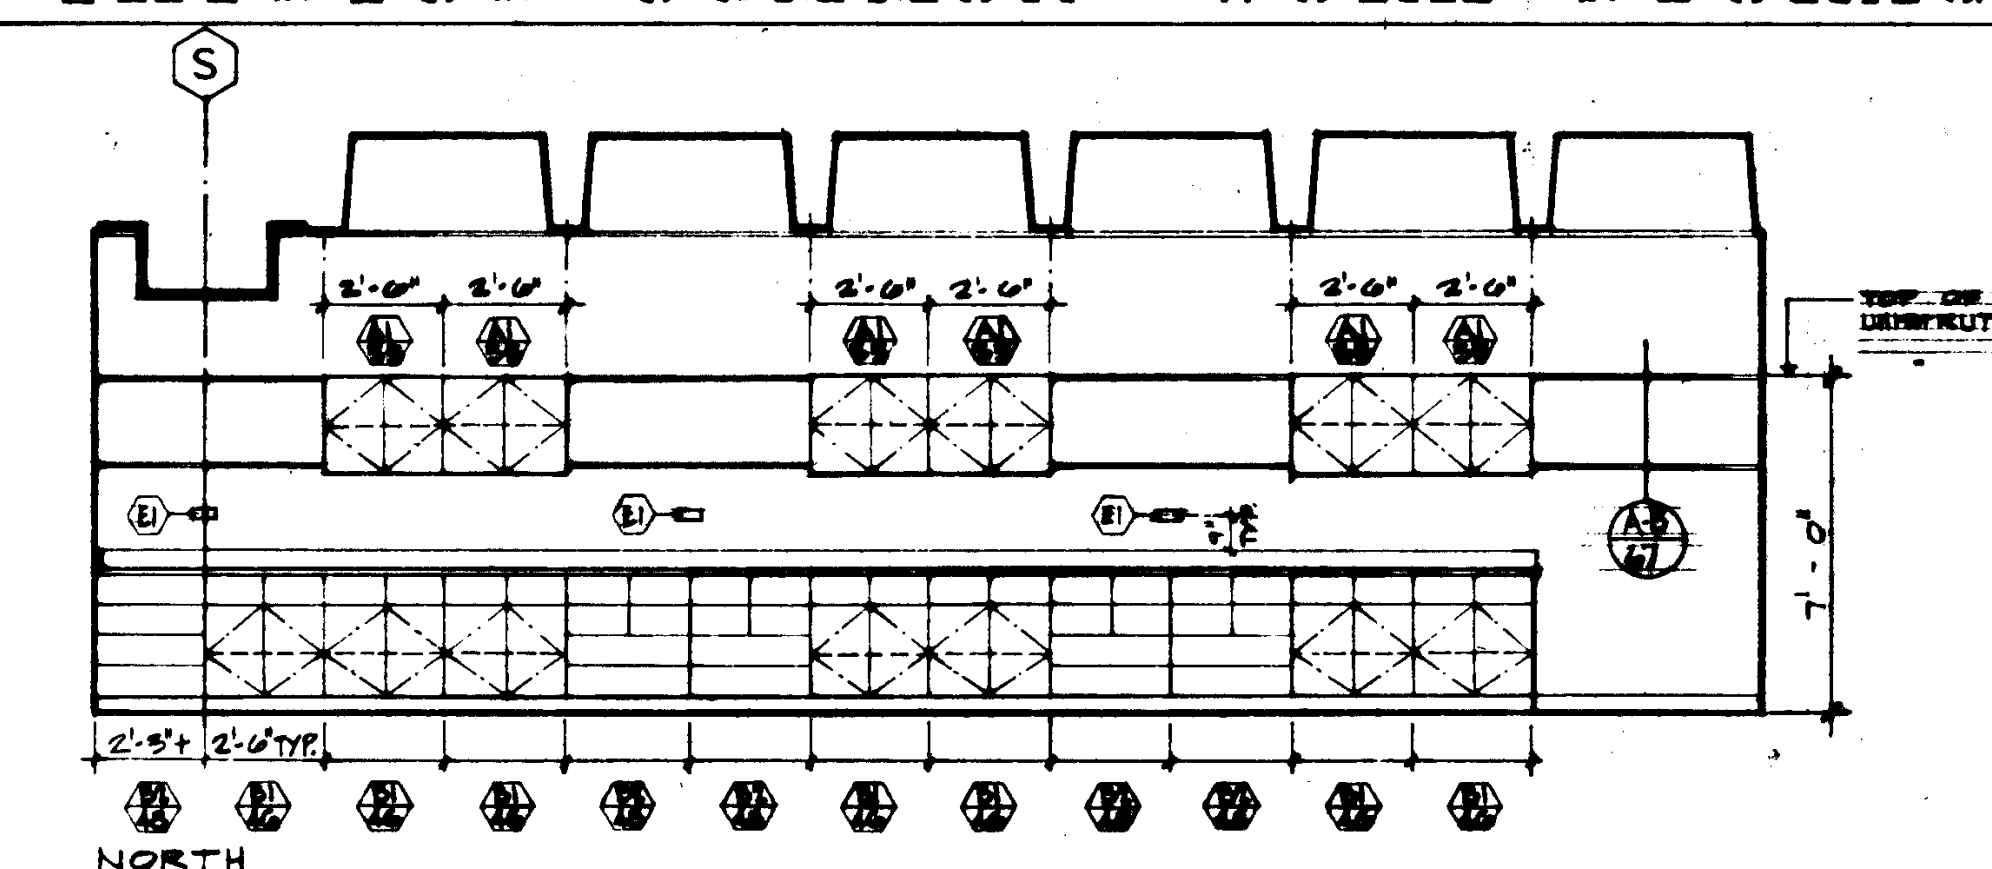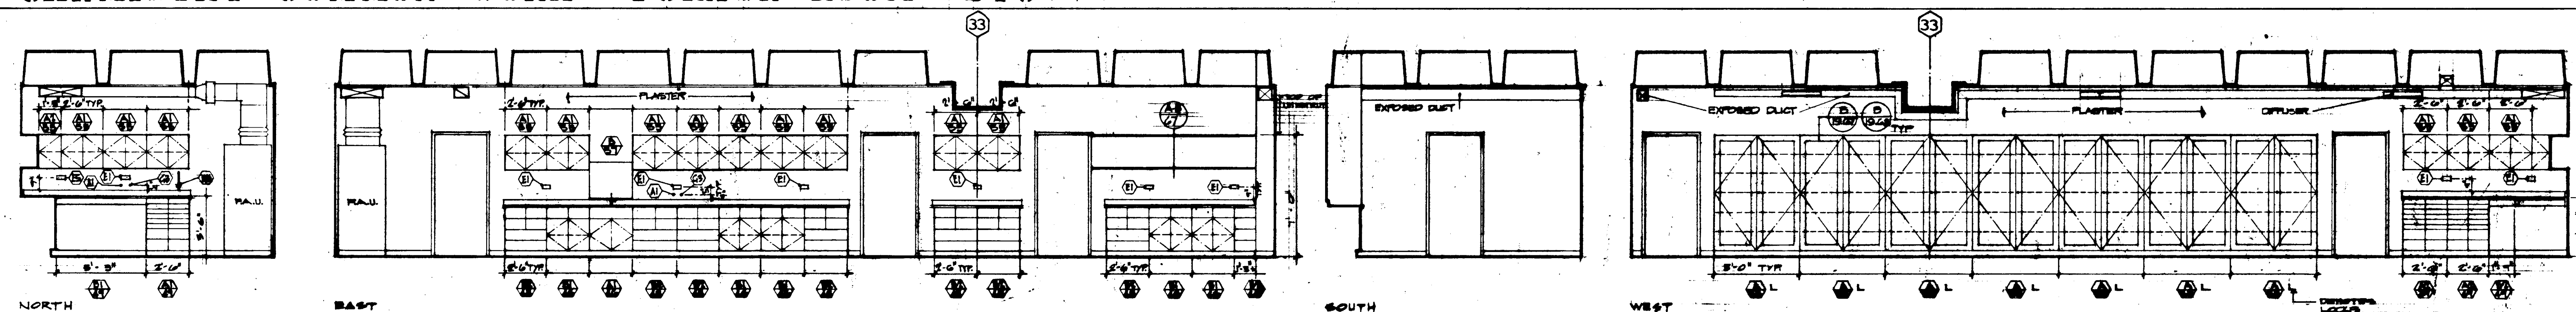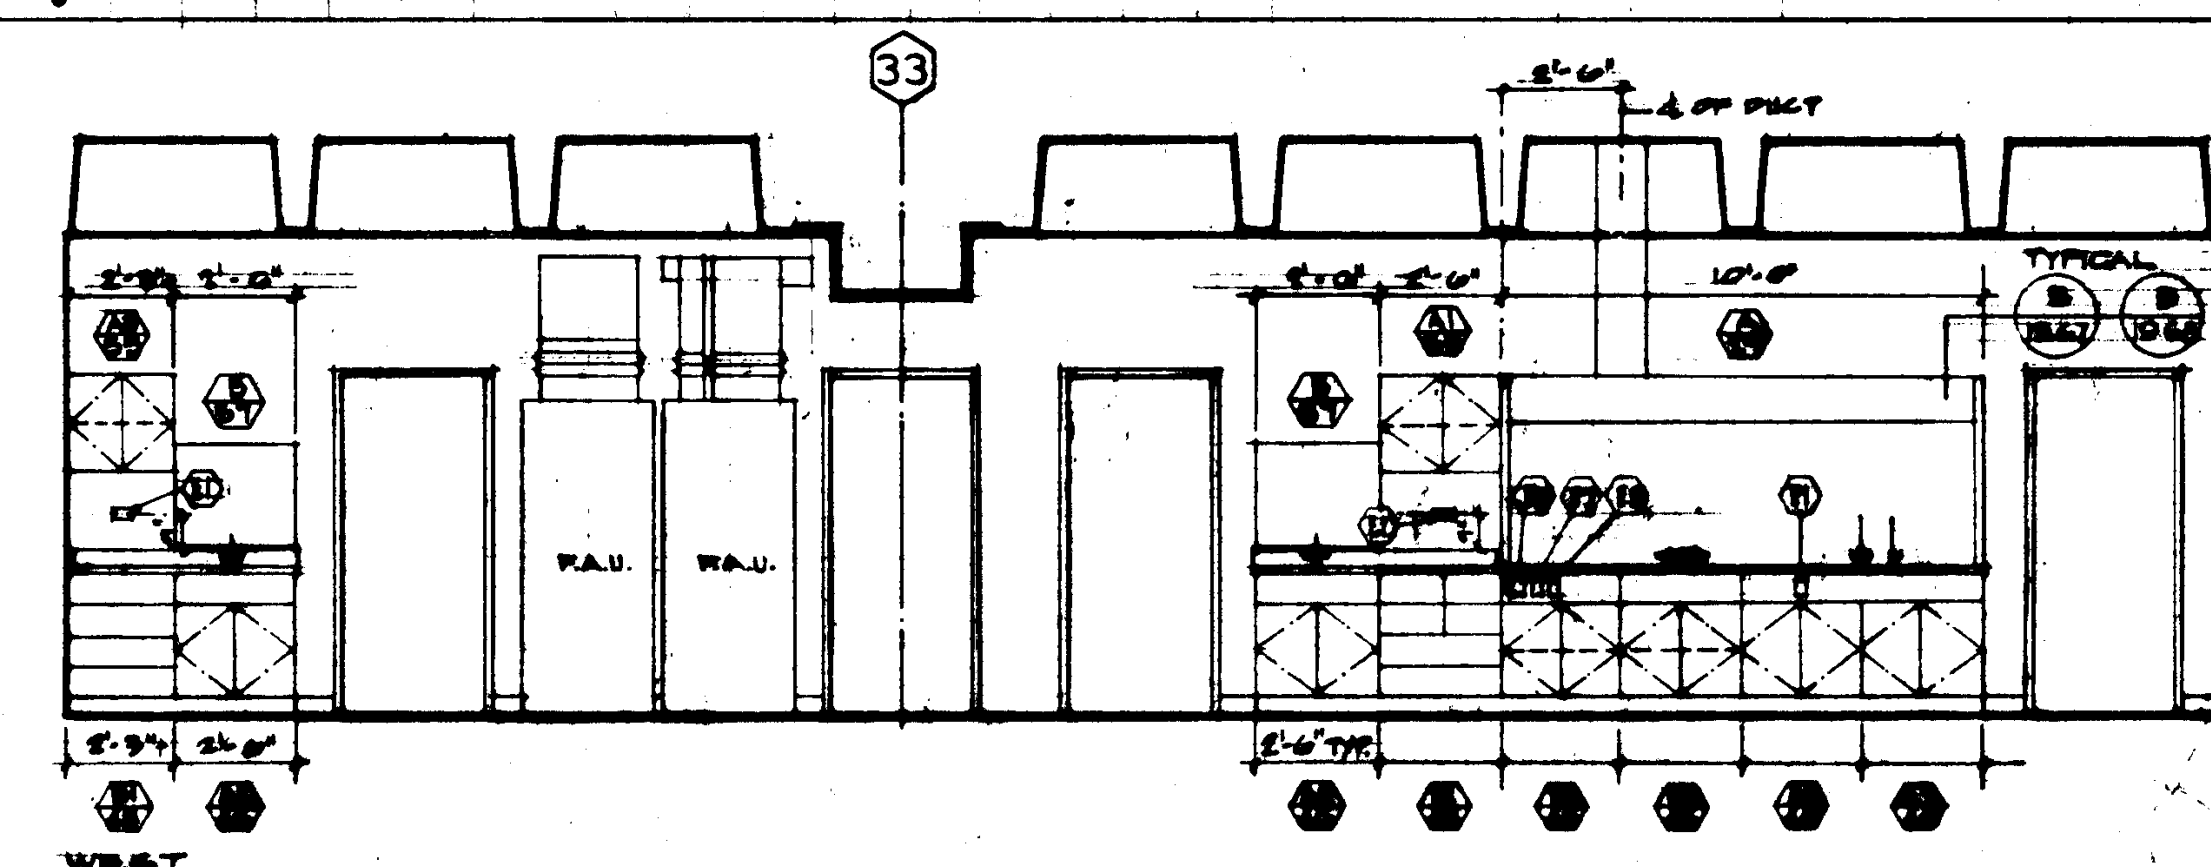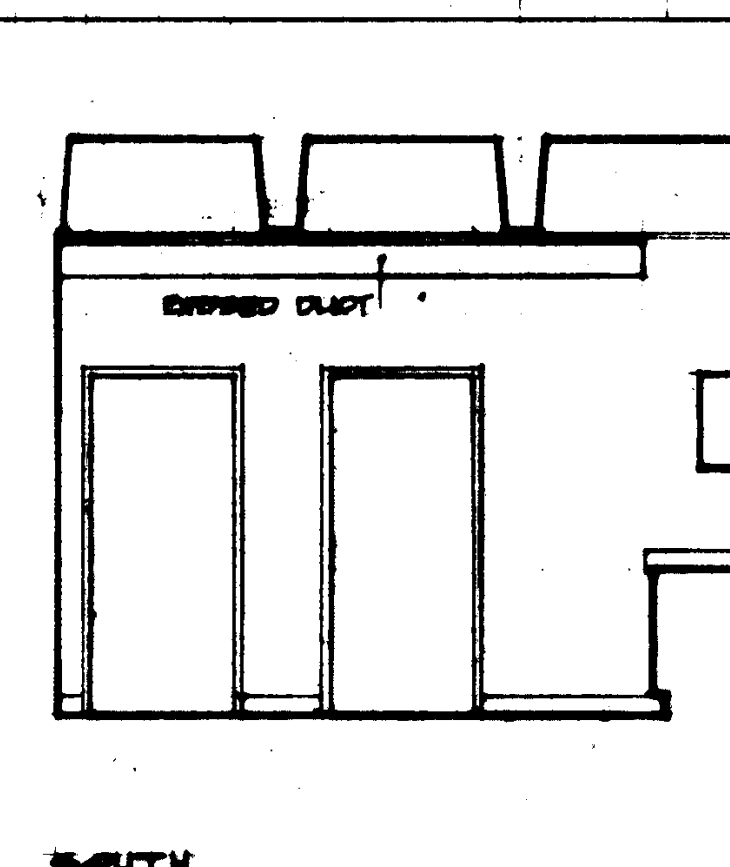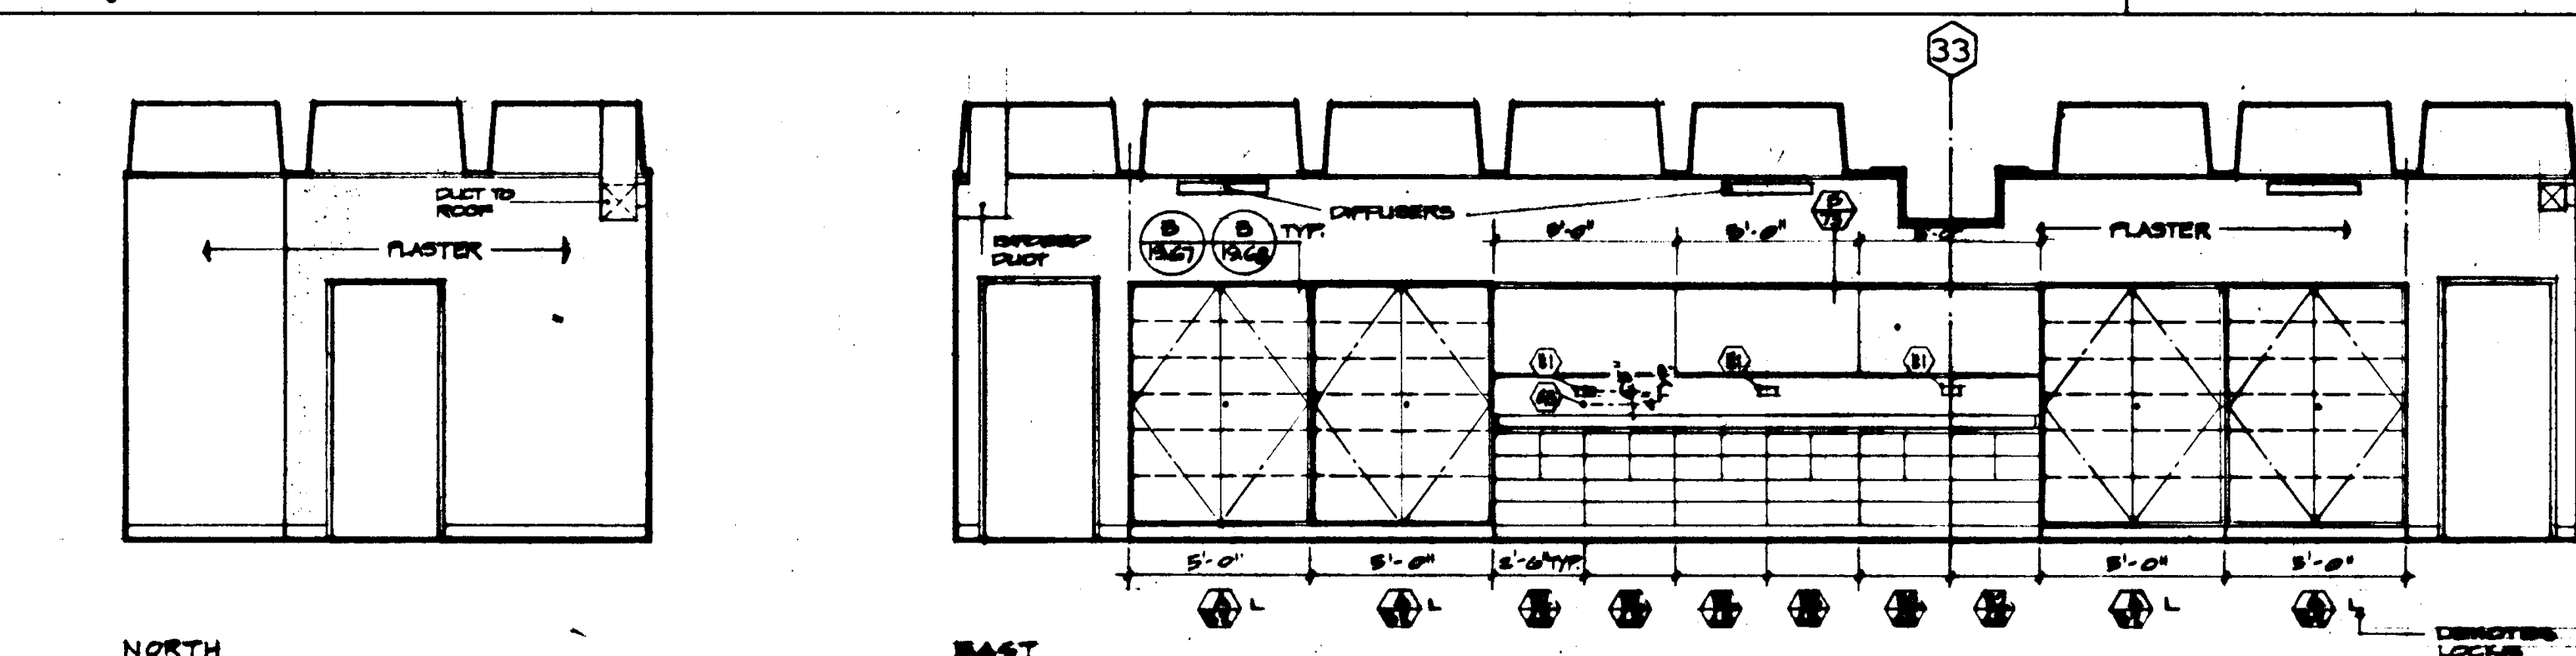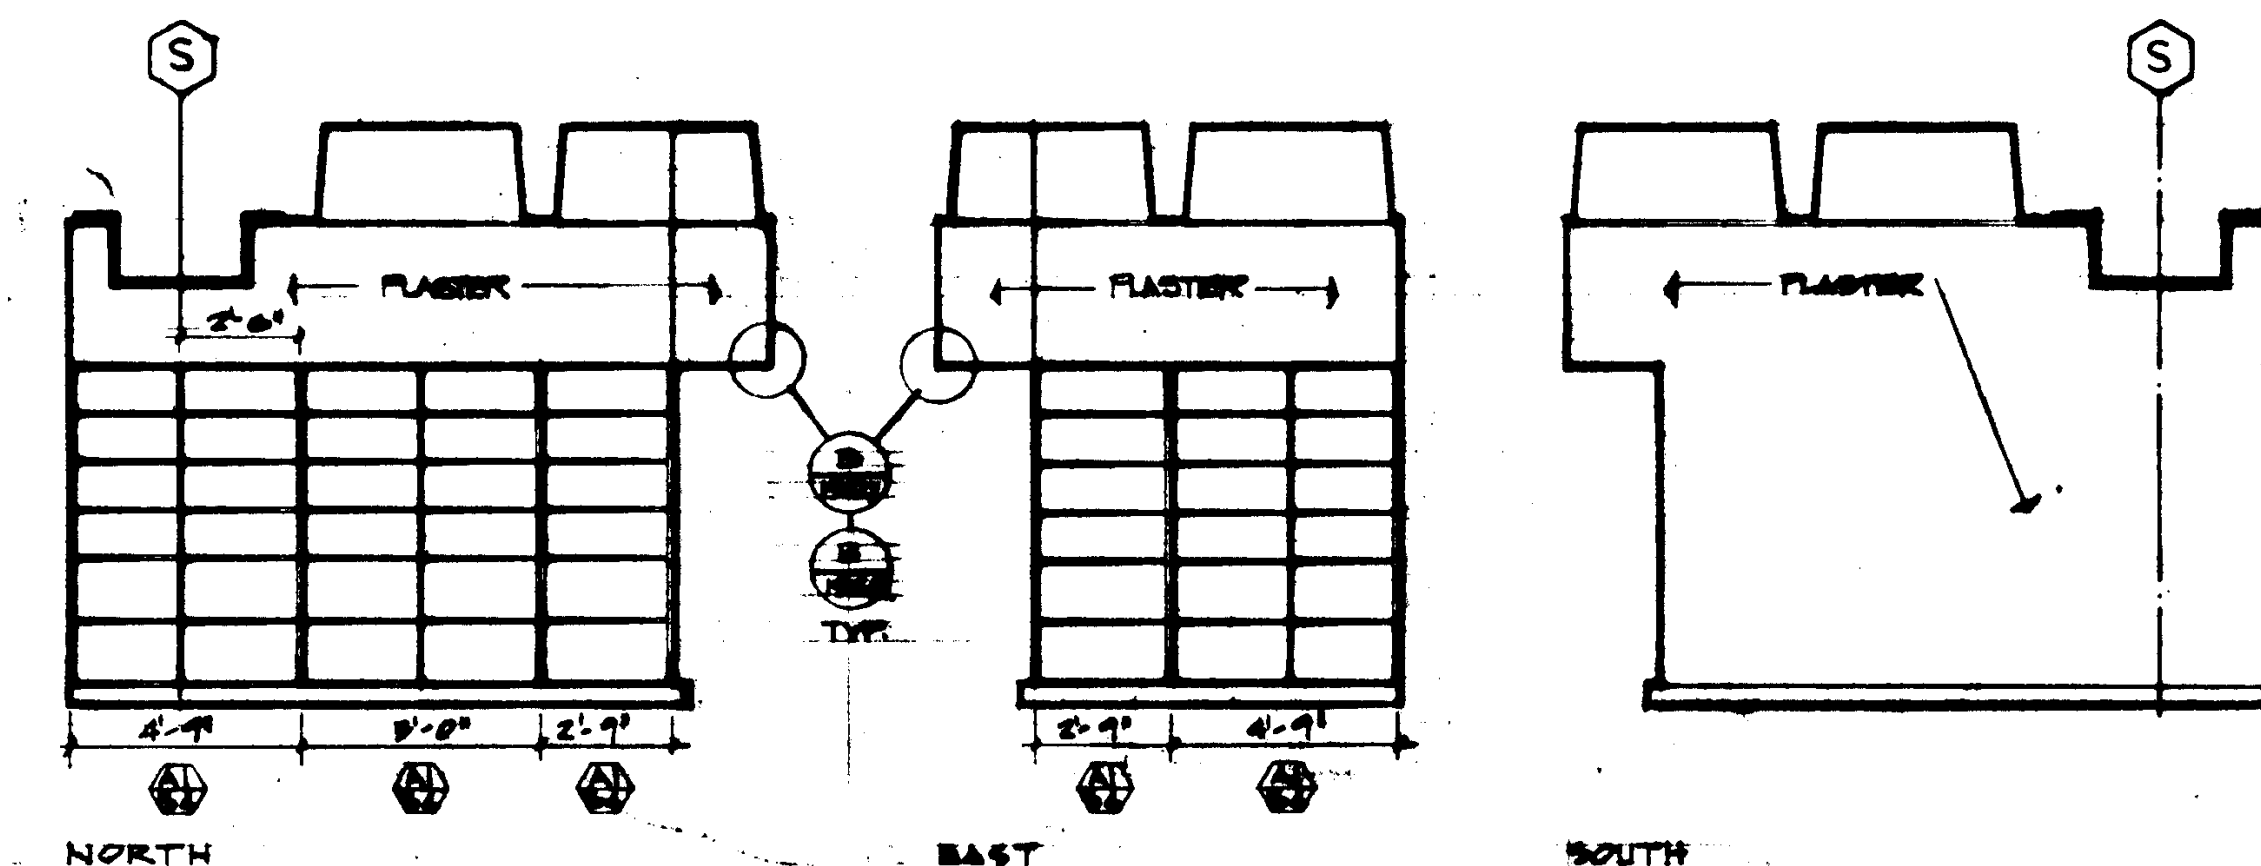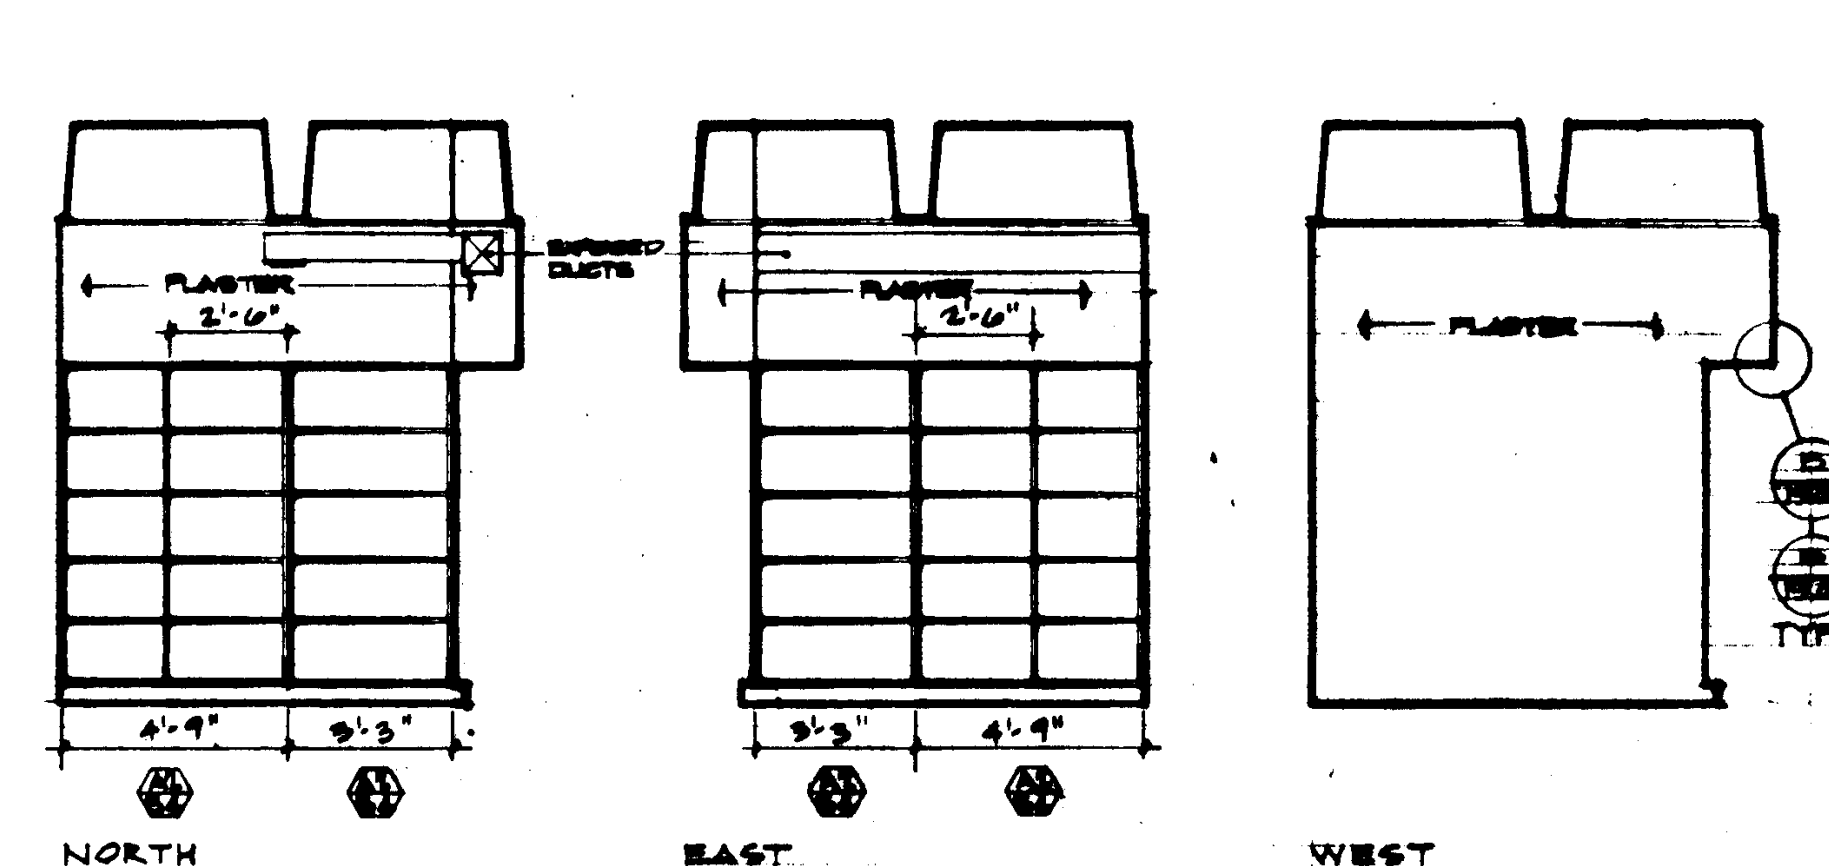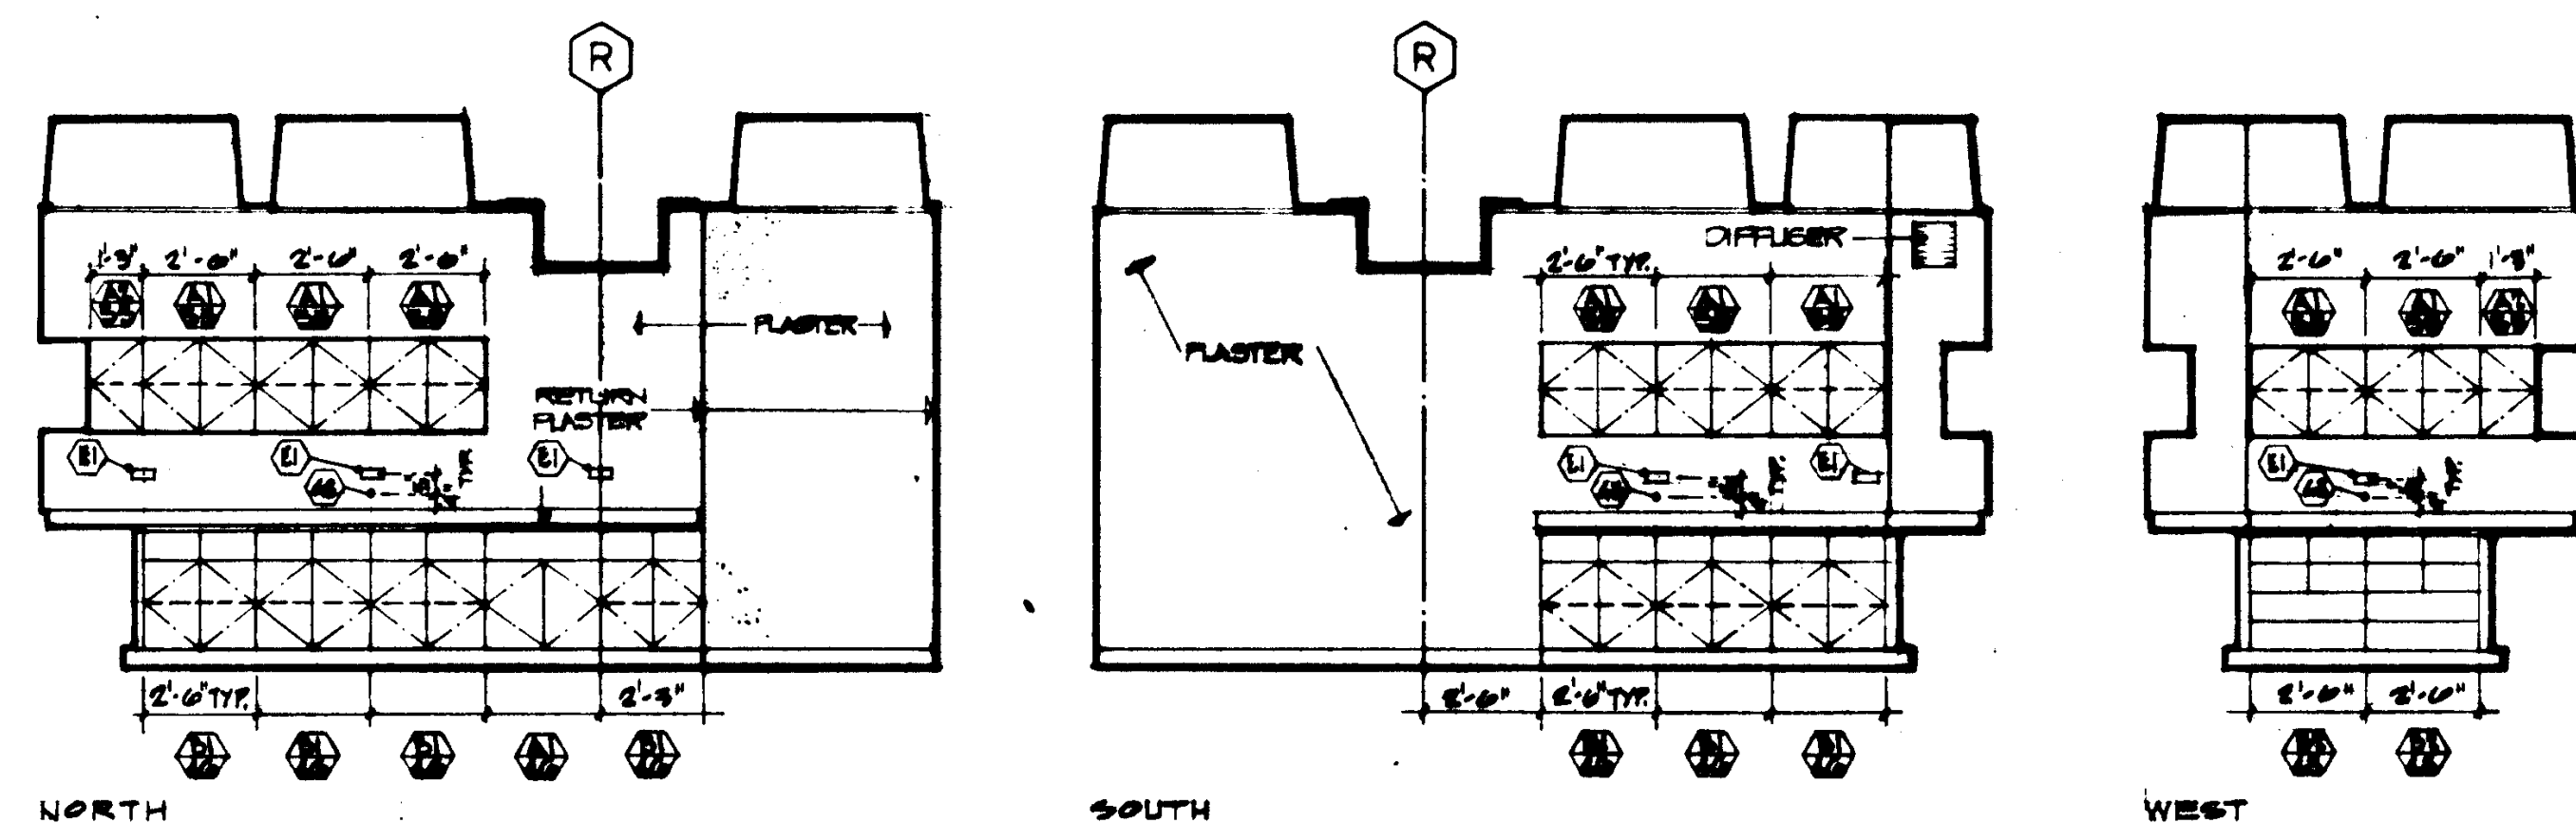


NORTH ELEVATION
SOUTH ELEVATION SIM. OFF. HAND

LECTURE ROOM 110

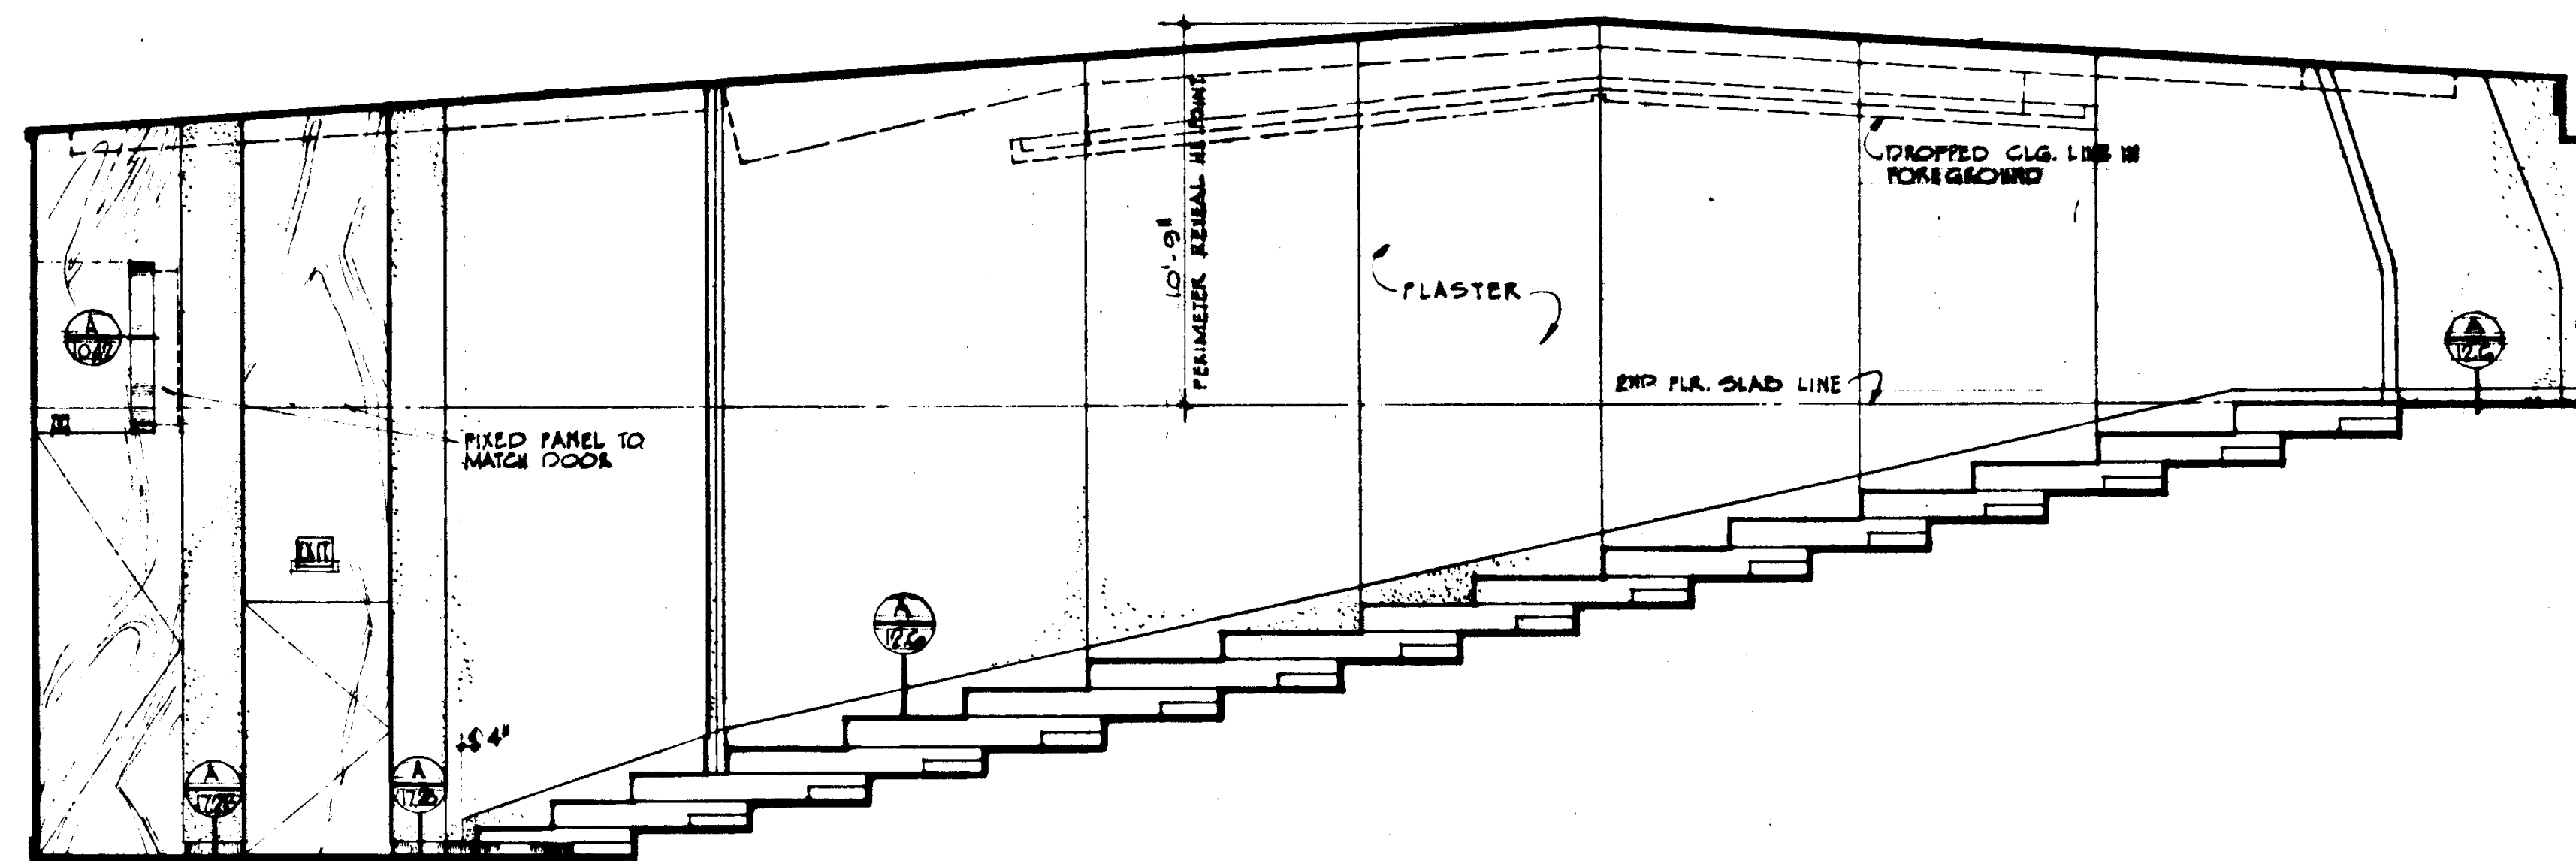


WEST ELEVATION

LECTURE ROOM 110

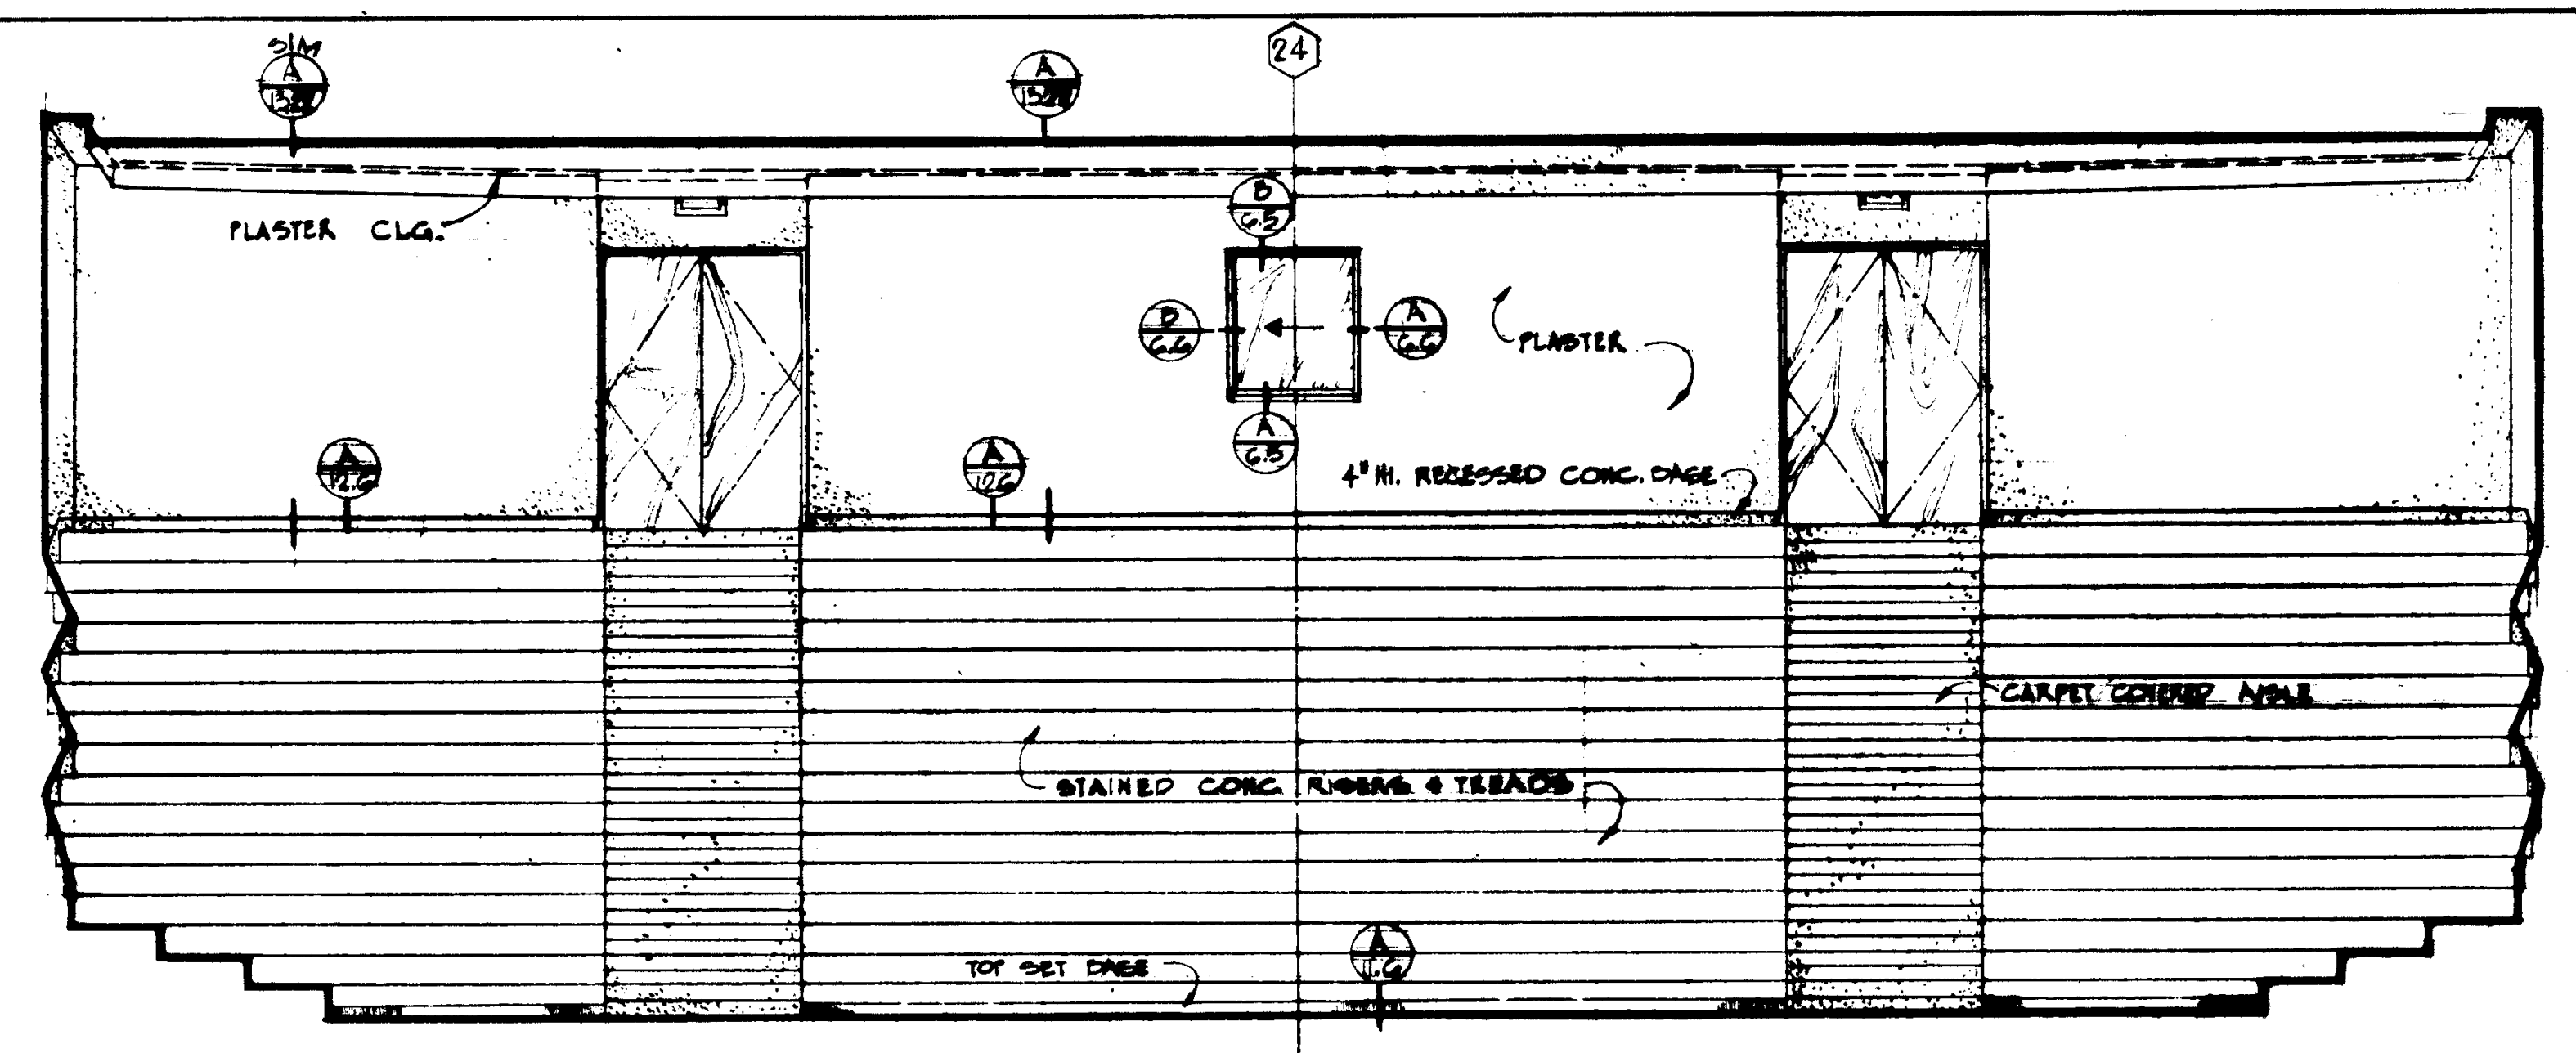


EAST ELEVATION

LECTURE ROOM 110

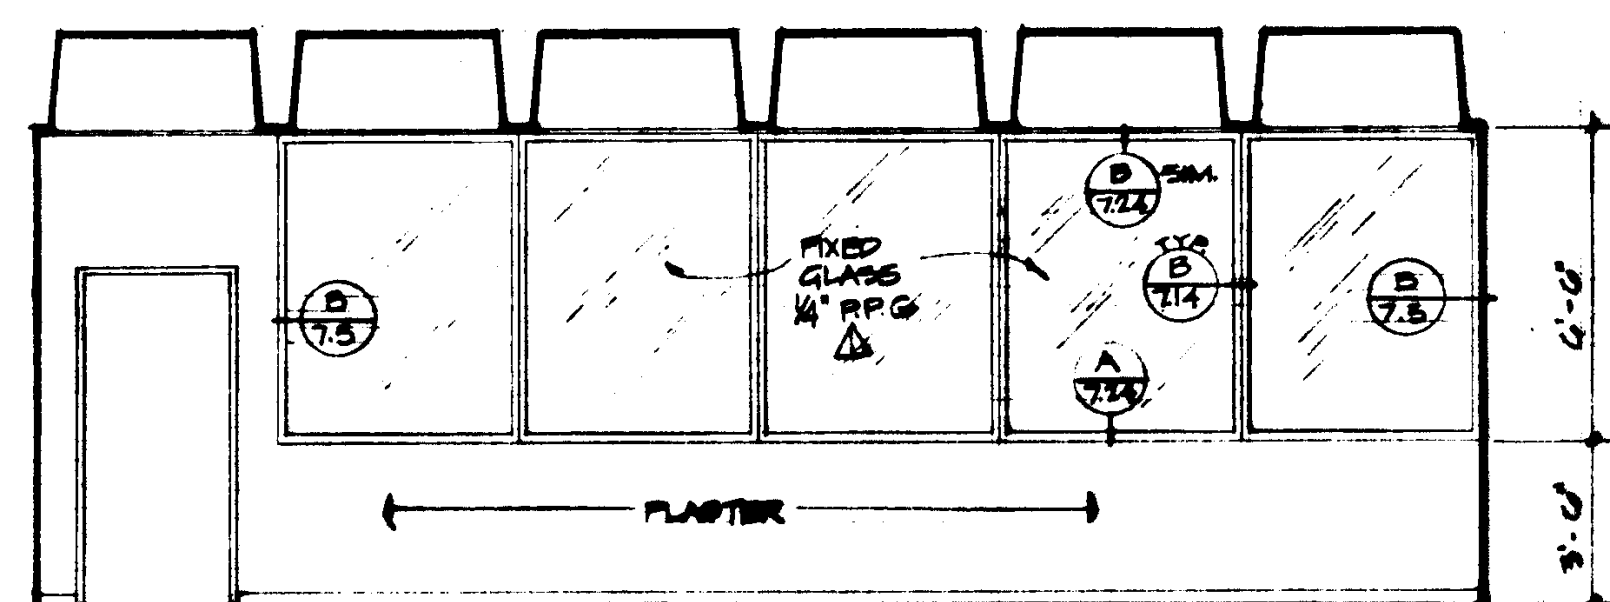

EAST ELEVATION

CLASSROOM 105

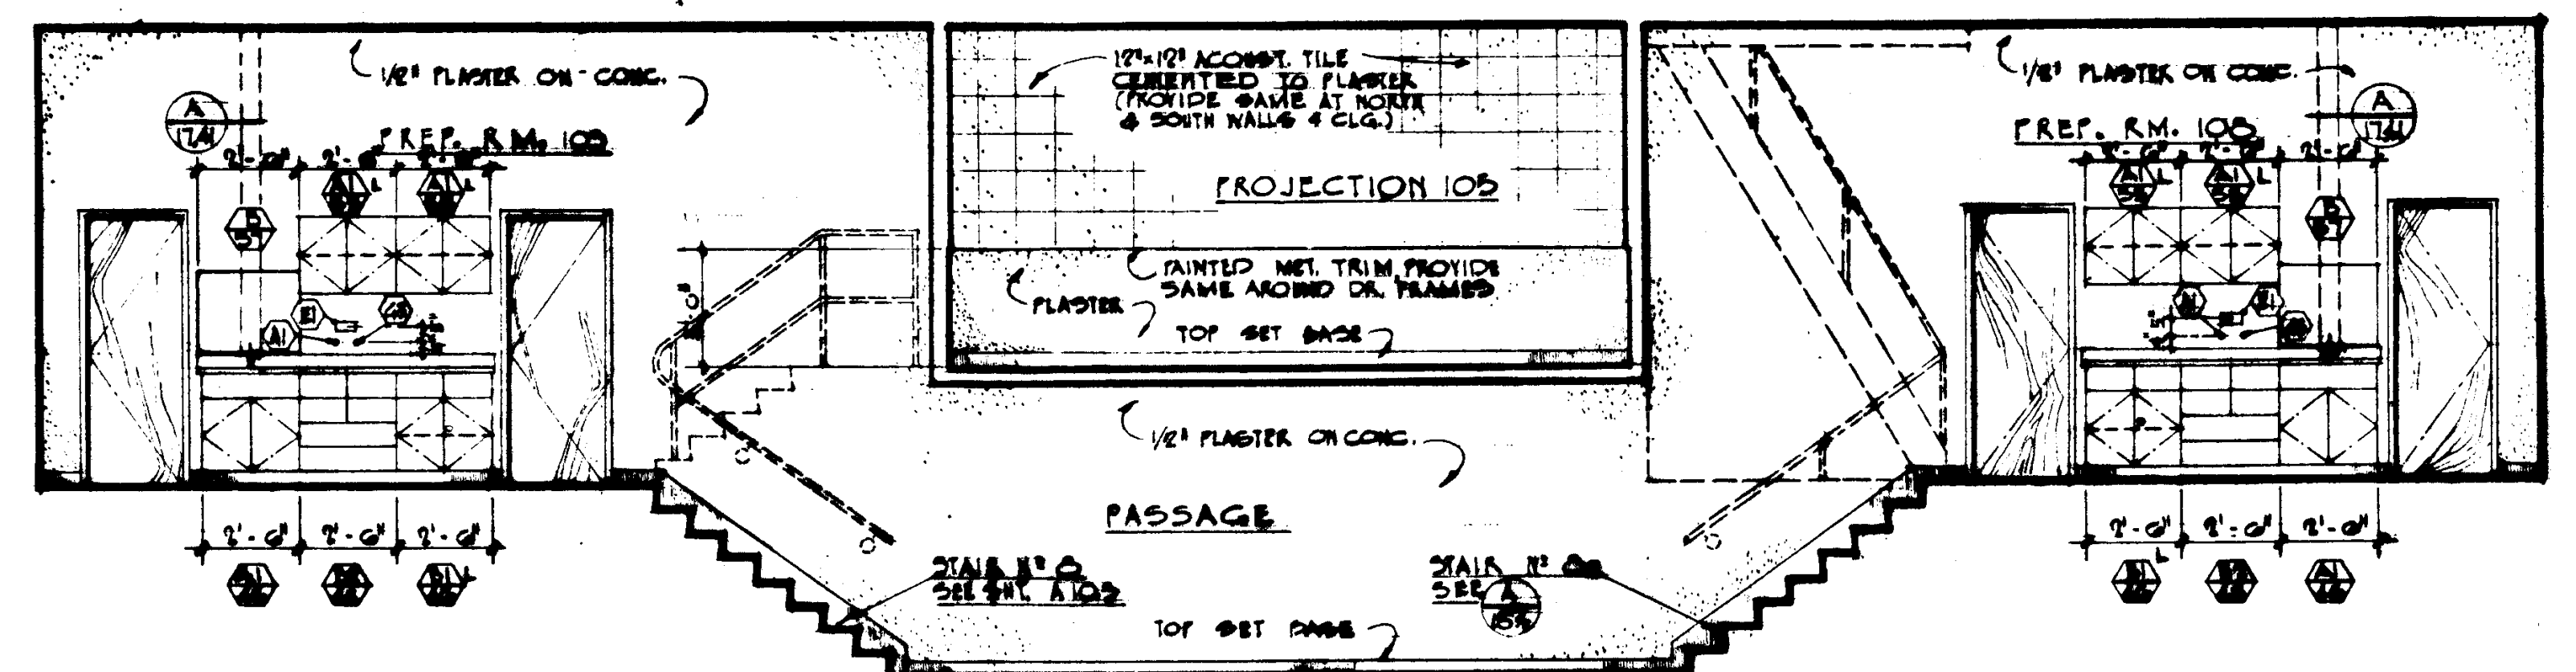


WEST ELEVATION


PREP. RM. 102

PREP. RM. 103


UNIT 3				CLASSROOM 105				PREP. RM. 102				PREP. RM. 103			
DATE	REVISIONS	STRUCTURAL ENGINEERS BRANDOW & JOHNSON J.A. MARTIN & ASSOCIATES	DESIGNED ARCHITECT WILLIAM L. PEREIRA & ASSOCIATES	APPROVED STATE OF CALIFORNIA DATE 11/14/1985	DRAWN BY ENGINEER	CHECKED BY COLLEGE	ASSOCIATED ARCHITECTS: WILLIAM L. PEREIRA & ASSOCIATES A. QUINCY JONES-FREDERICK E. HENRONS & ASSOCIATES BLUROCK ELLERBROOK & ASSOCIATES	GOLDEN WEST COLLEGE HUNTINGTON BEACH, CALIFORNIA ORANGE COAST JUNIOR COLLEGE DISTRICT				UNIT 2 & 3	JOB NO. 100-1		
DATE	REVISIONS	MECHANICAL ENGINEERS RALPH S. PHILLIPS, INC.	DESIGNED ARCHITECT WILLIAM L. PEREIRA & ASSOCIATES	APPROVED STATE OF CALIFORNIA DATE 11/14/1985	DRAWN BY ENGINEER	CHECKED BY COLLEGE	ASSOCIATED ARCHITECTS: WILLIAM L. PEREIRA & ASSOCIATES A. QUINCY JONES-FREDERICK E. HENRONS & ASSOCIATES BLUROCK ELLERBROOK & ASSOCIATES					INTERIOR ELEVATIONS	DATE 15 JUN 1985		
DATE	REVISIONS	ELECTRICAL ENGINEERS RALPH S. PHILLIPS, INC.	DESIGNED ARCHITECT WILLIAM L. PEREIRA & ASSOCIATES	APPROVED STATE OF CALIFORNIA DATE 11/14/1985	DRAWN BY ENGINEER	CHECKED BY COLLEGE	ASSOCIATED ARCHITECTS: WILLIAM L. PEREIRA & ASSOCIATES A. QUINCY JONES-FREDERICK E. HENRONS & ASSOCIATES BLUROCK ELLERBROOK & ASSOCIATES						SHEET NO. A8.1		
DATE	REVISIONS	CIVIL ENGINEERS O. SHUIMAN & ASSOCIATES MOFFATT & NICHOL	DESIGNED ARCHITECT WILLIAM L. PEREIRA & ASSOCIATES	APPROVED STATE OF CALIFORNIA DATE 11/14/1985	DRAWN BY ENGINEER	CHECKED BY COLLEGE	ASSOCIATED ARCHITECTS: WILLIAM L. PEREIRA & ASSOCIATES A. QUINCY JONES-FREDERICK E. HENRONS & ASSOCIATES BLUROCK ELLERBROOK & ASSOCIATES								

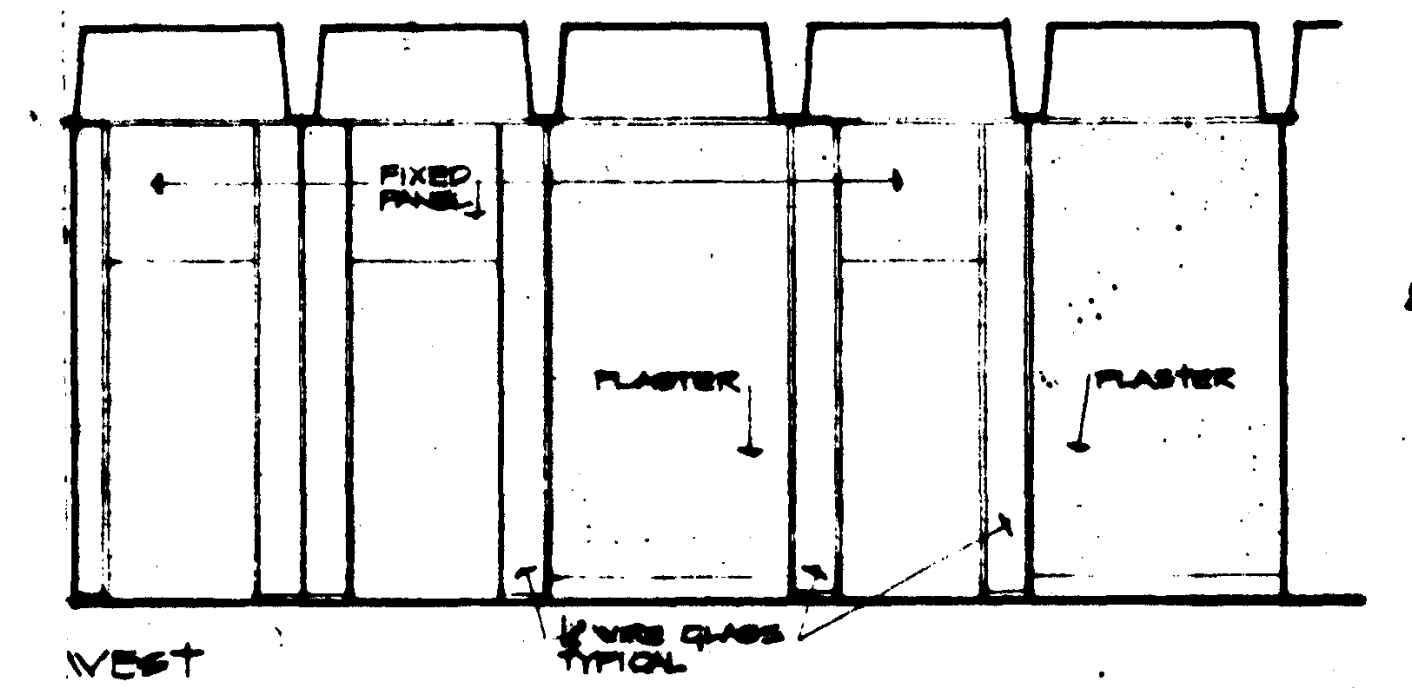


SEC. 11000 L 107

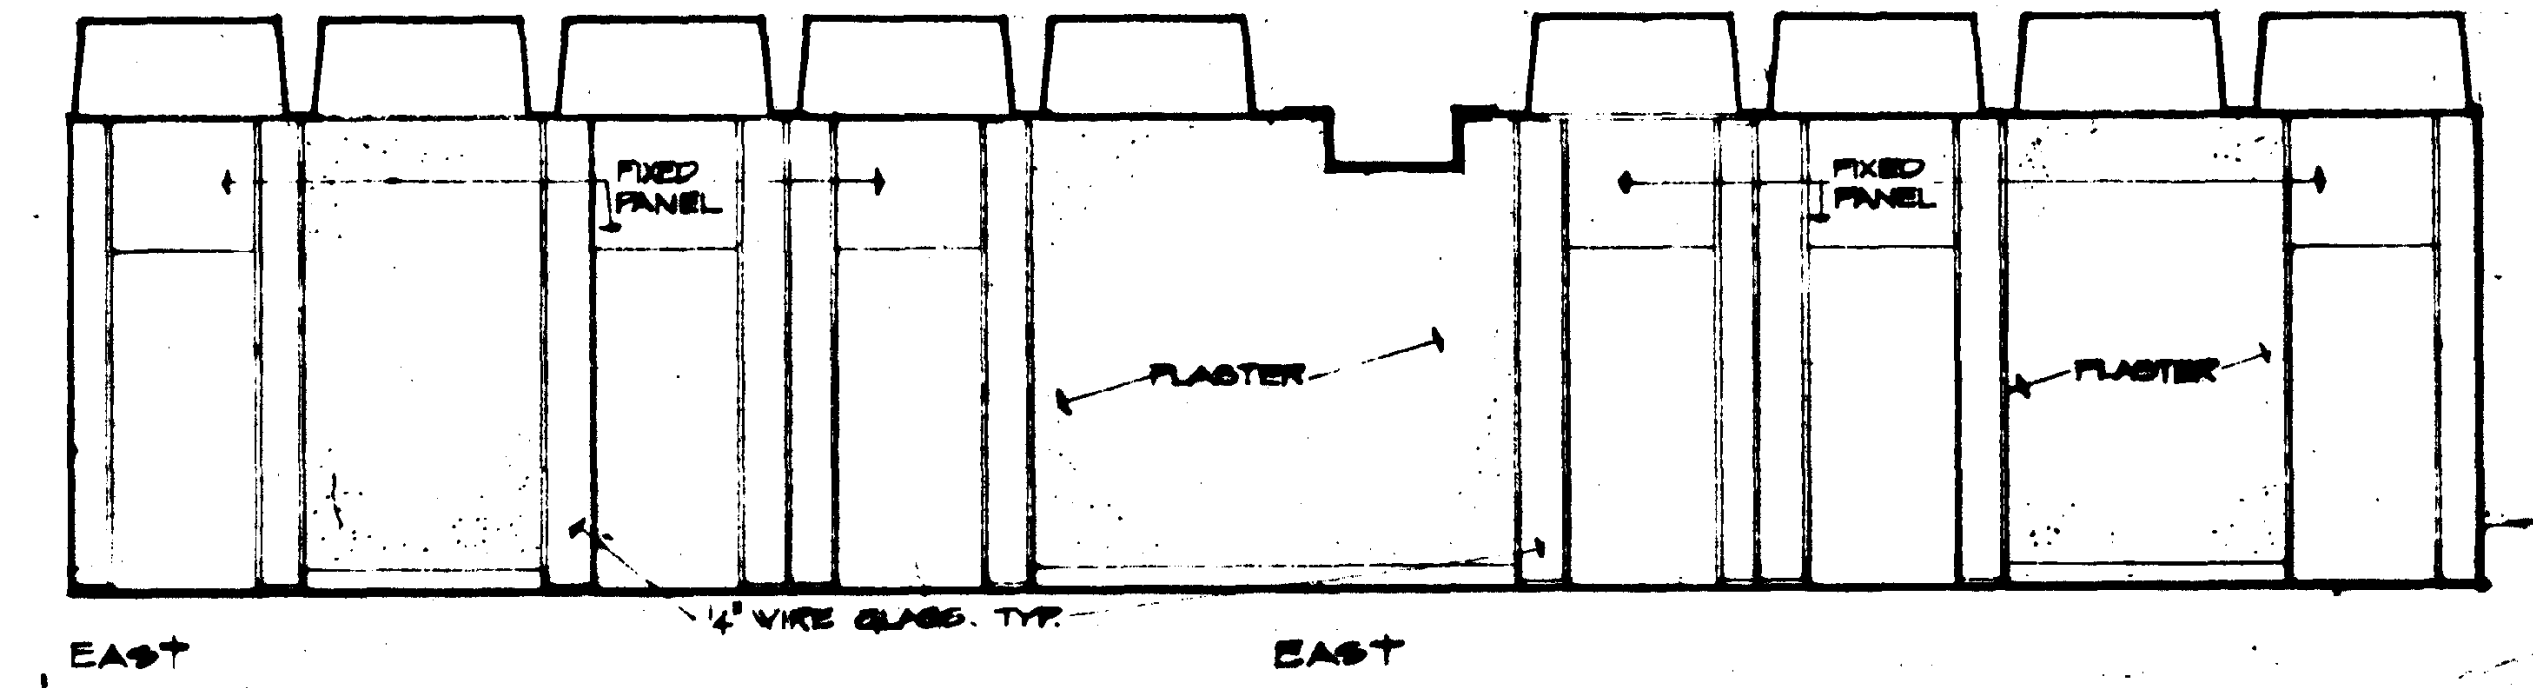


HALL 123

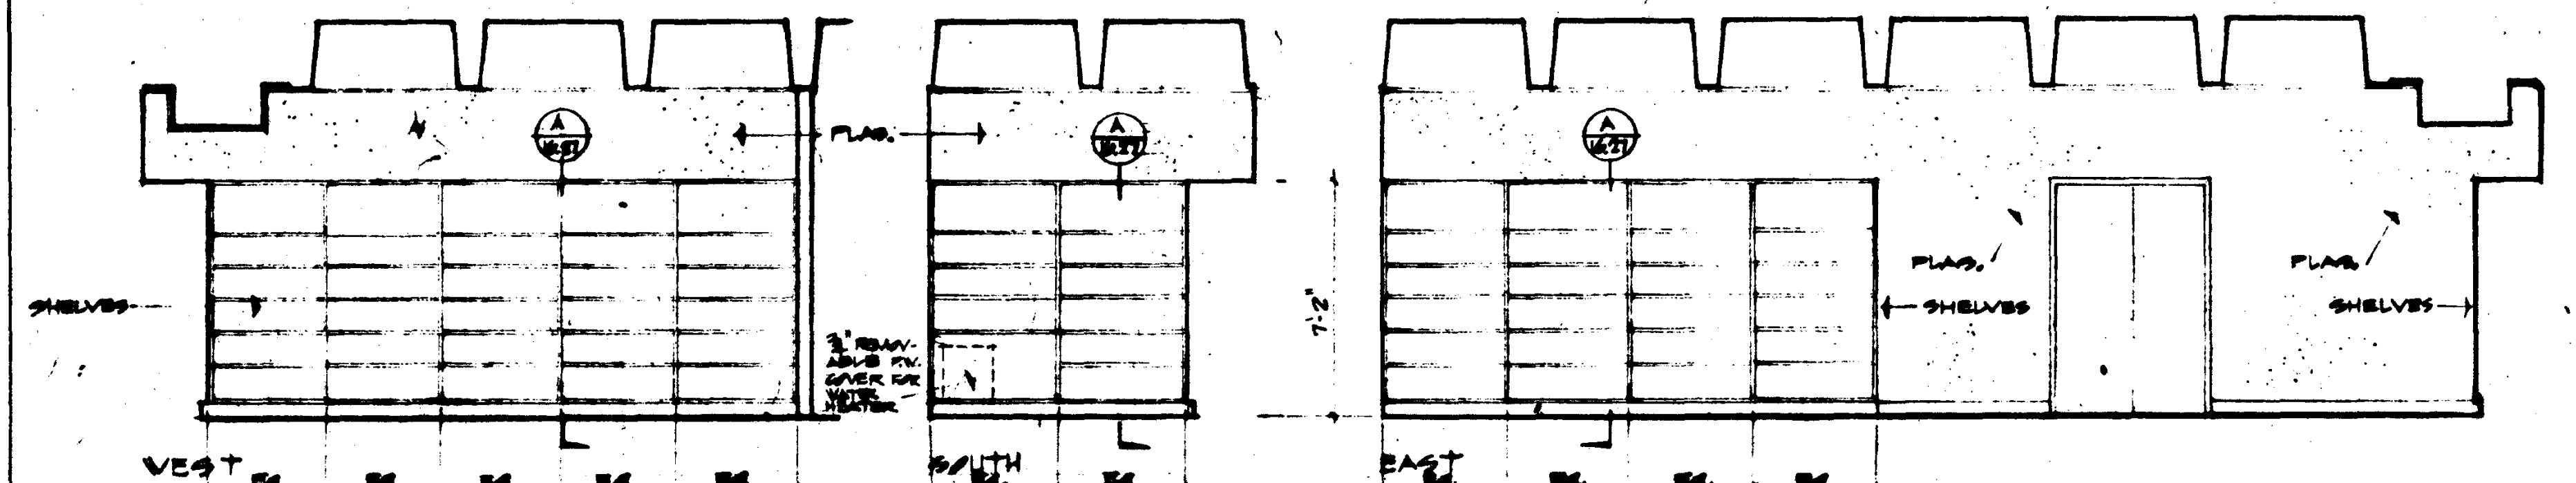

STORAGE	132	VISUAL	AIDS	134	STORAGE	132
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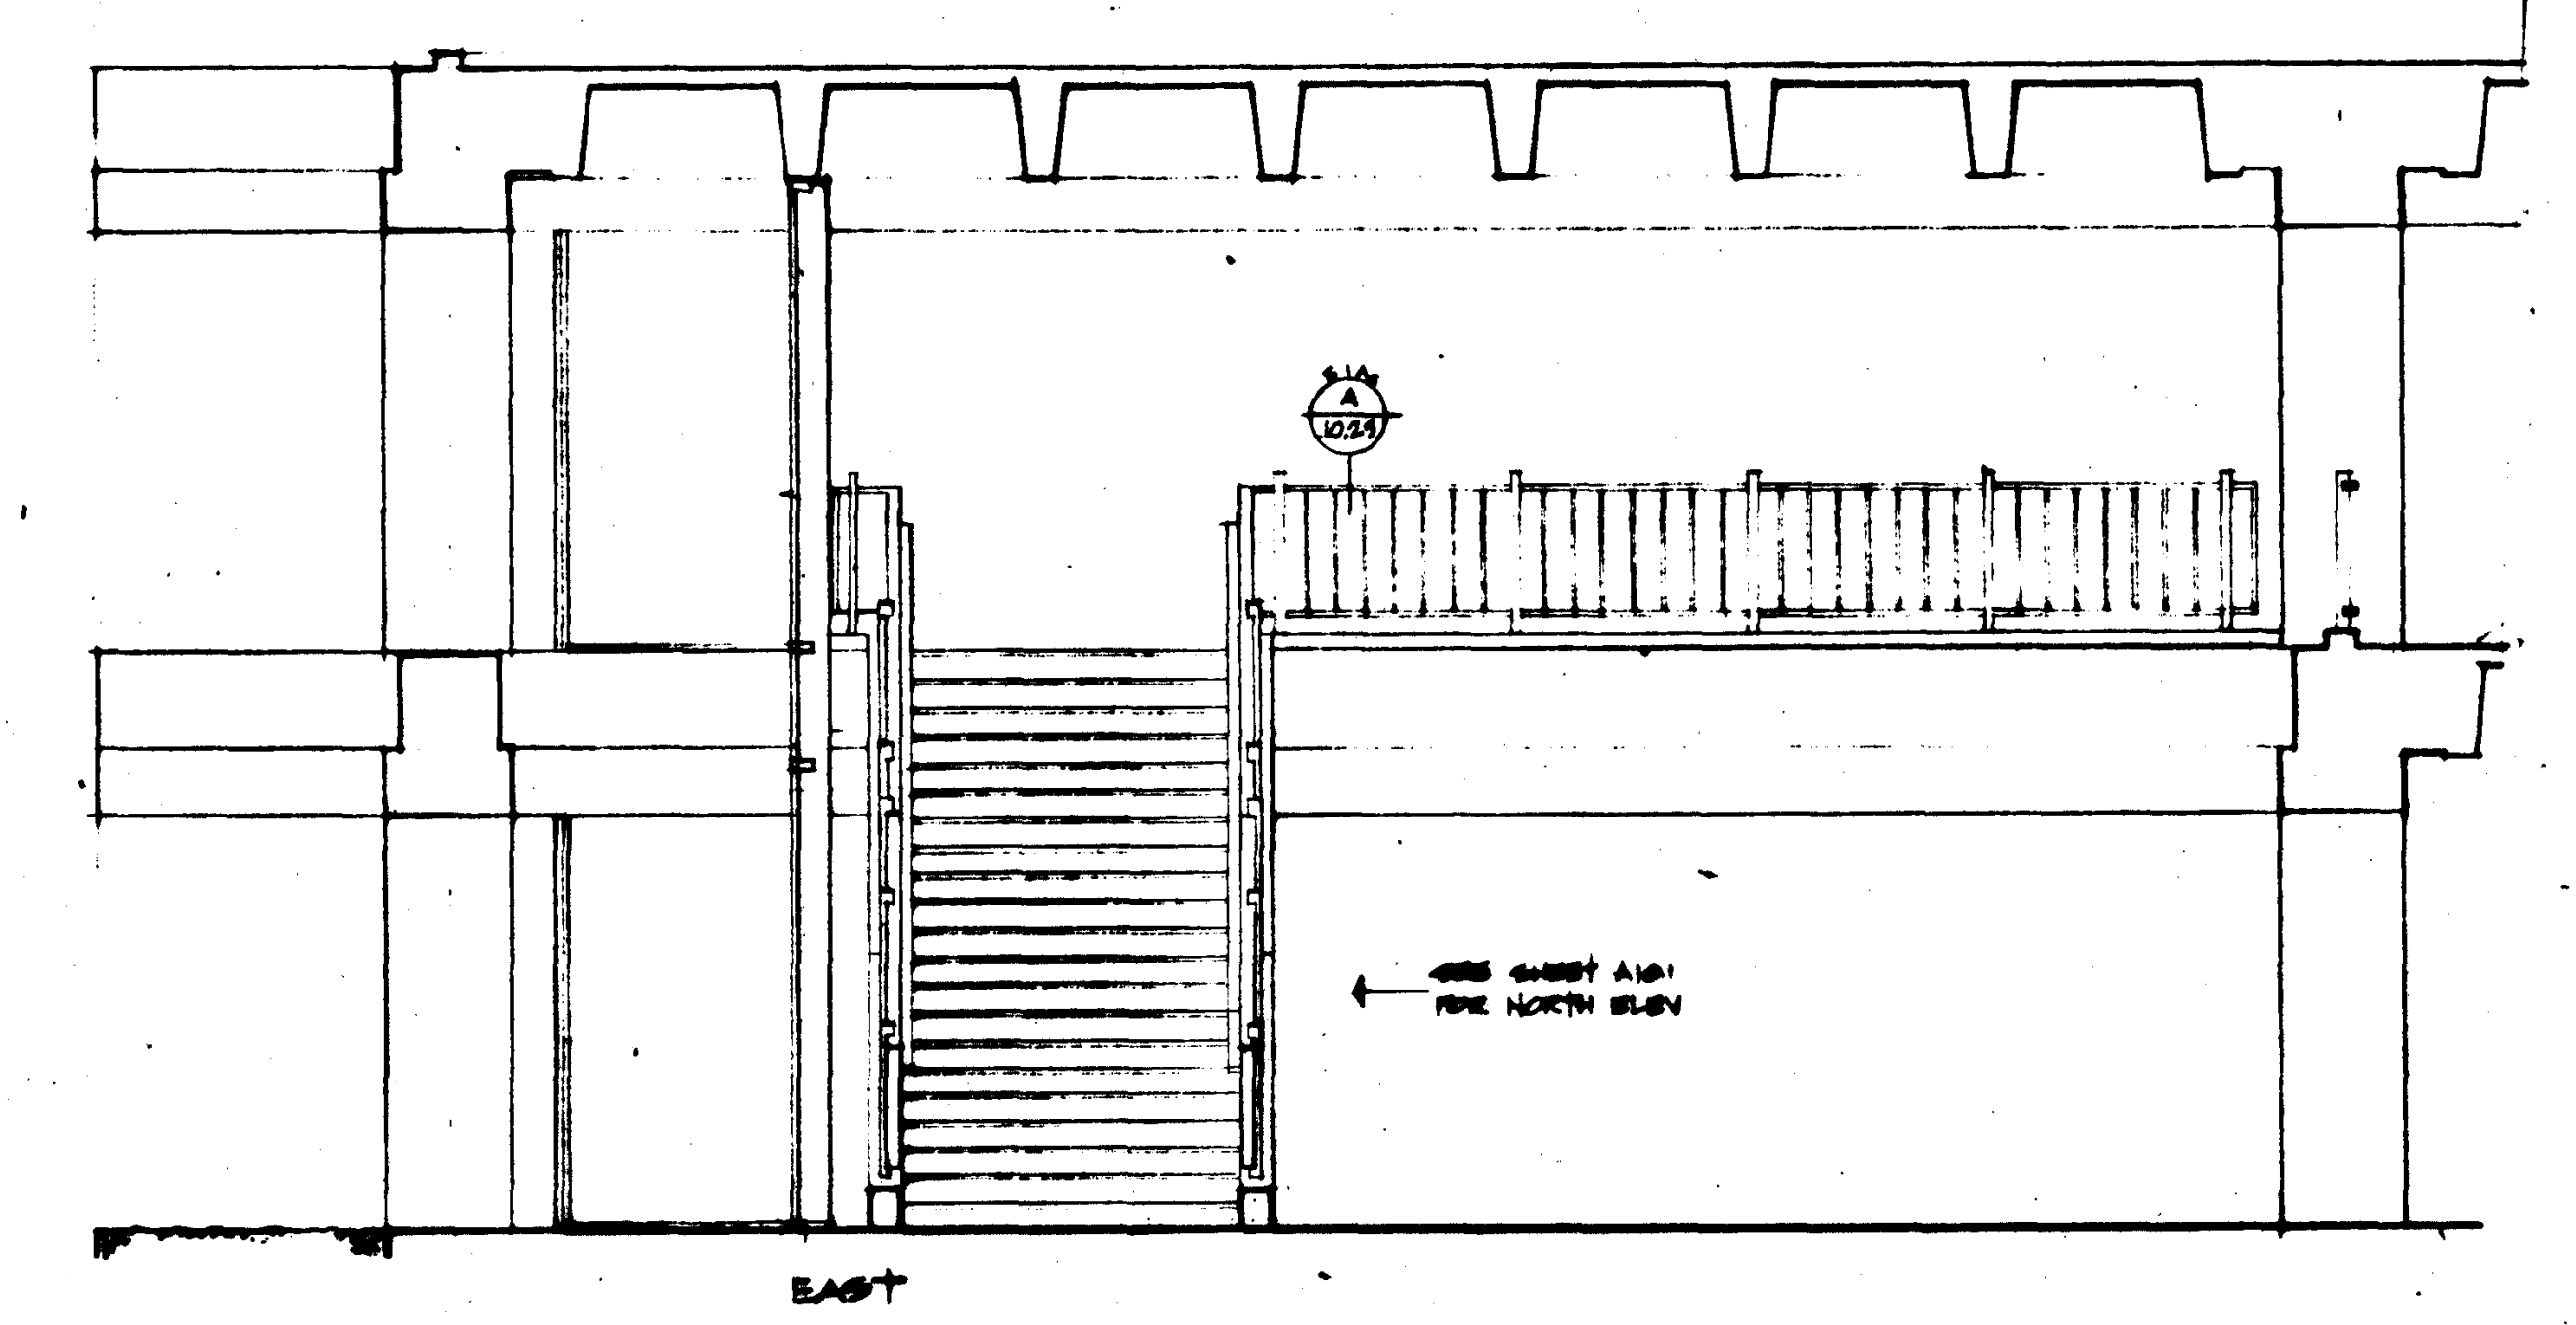
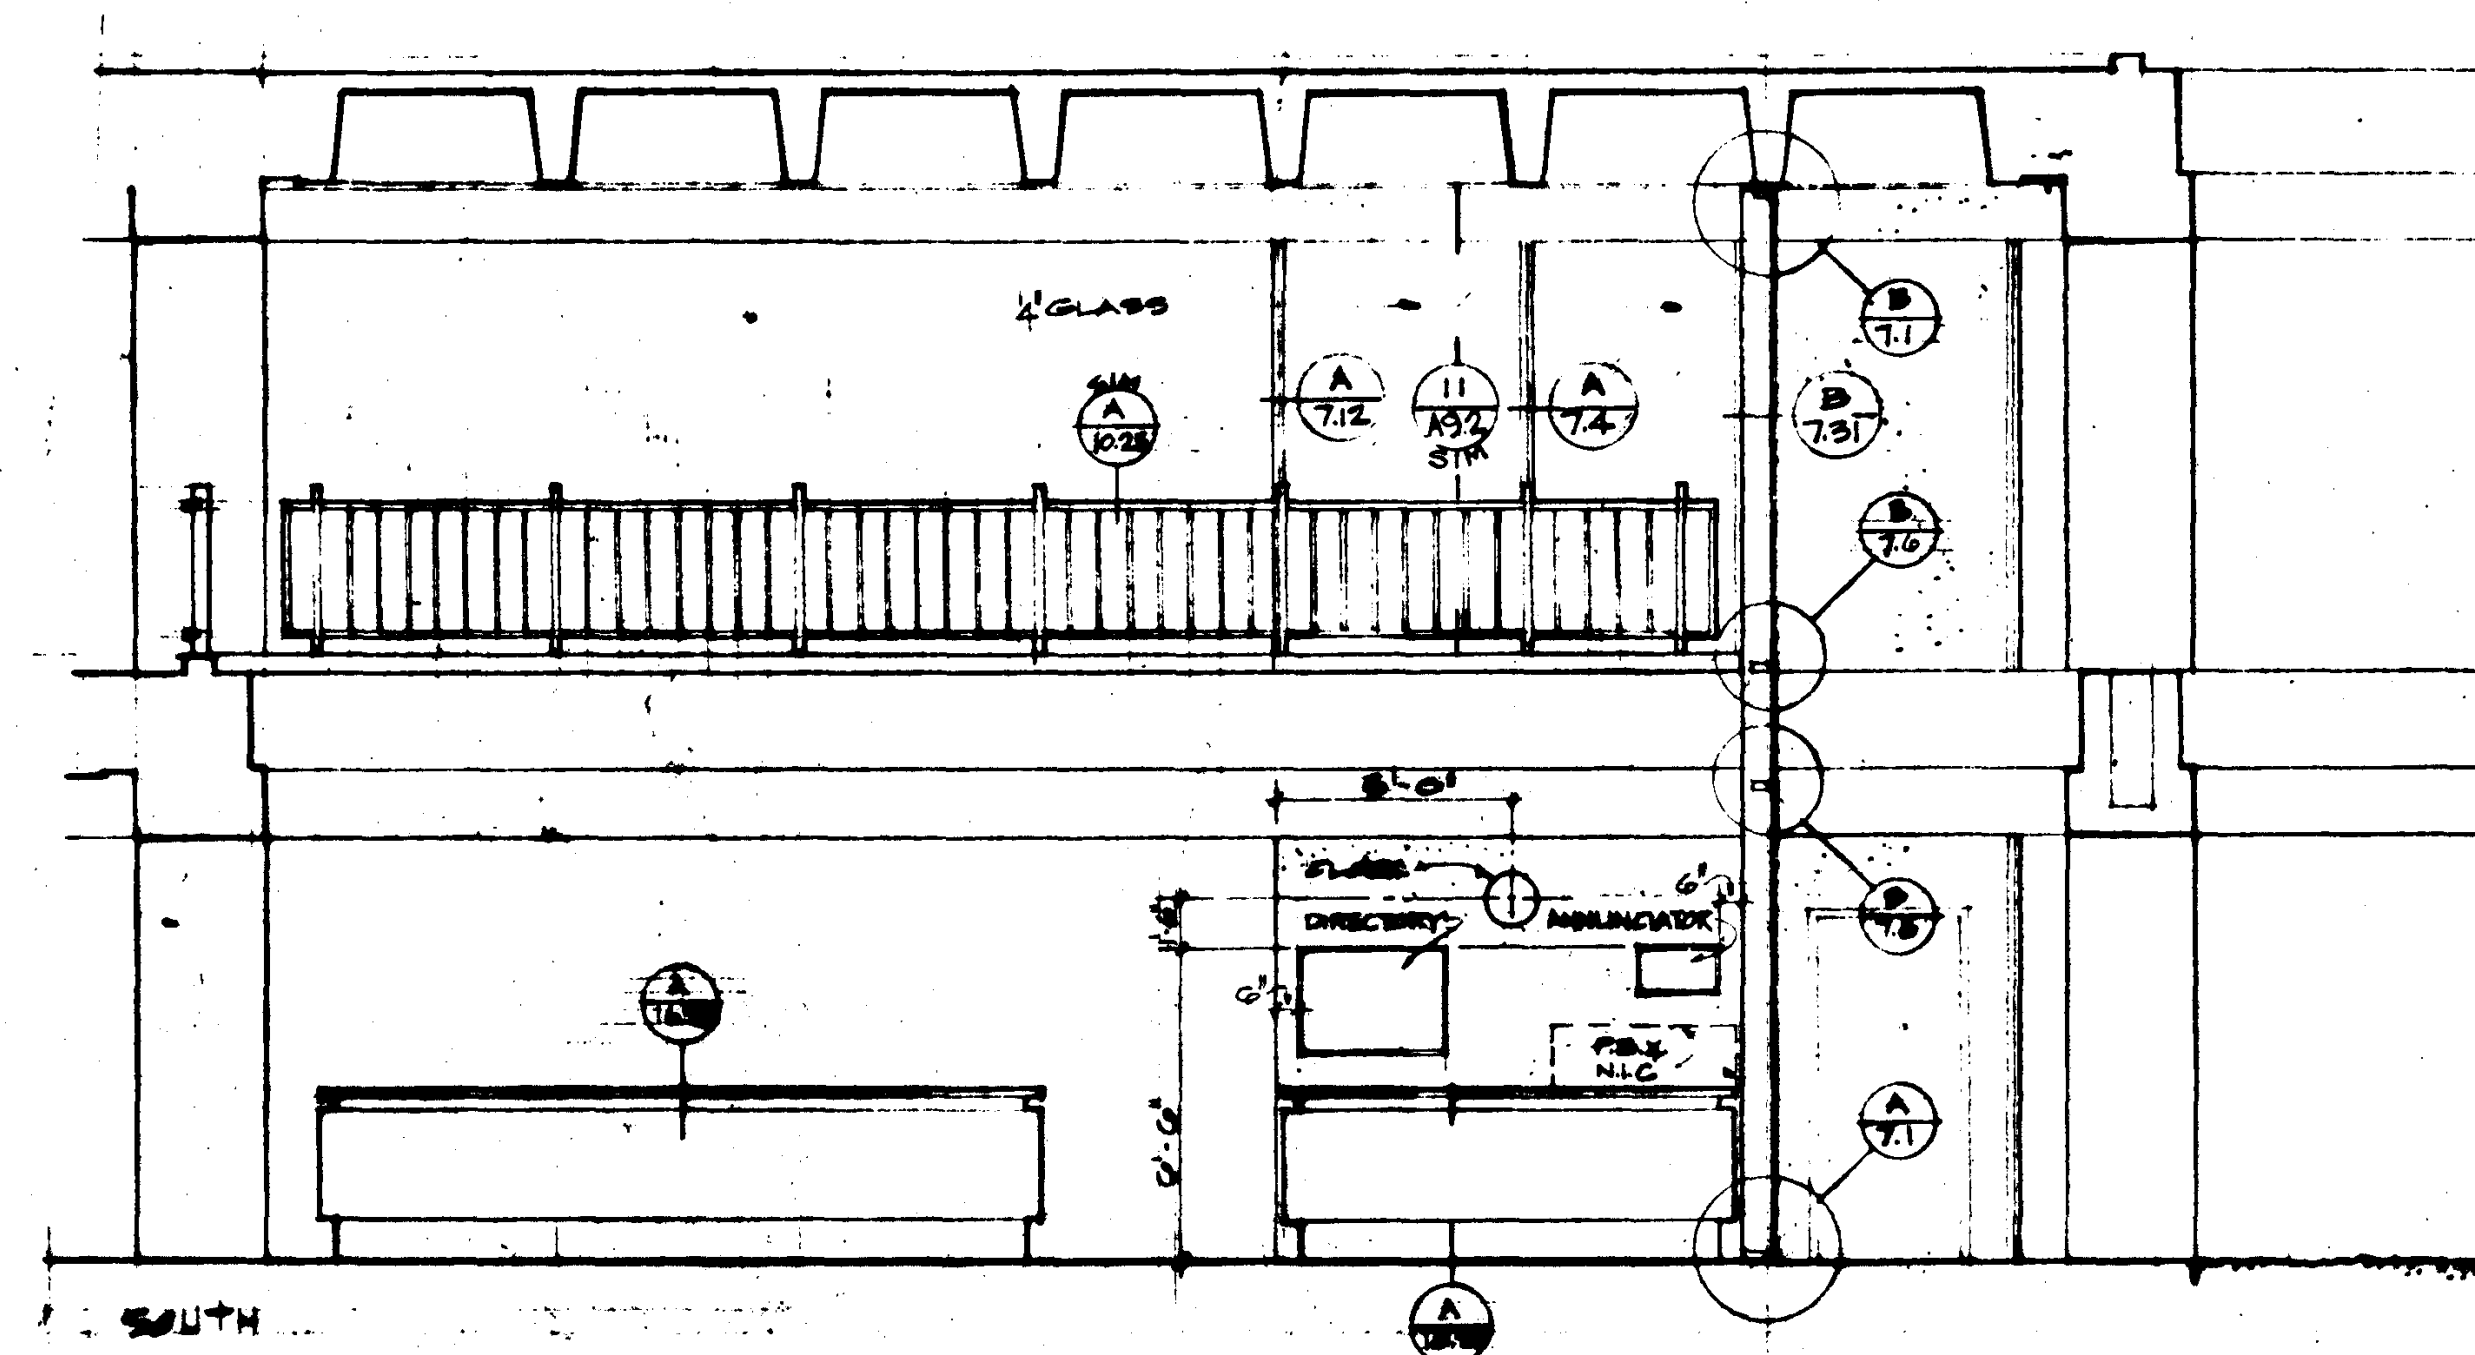


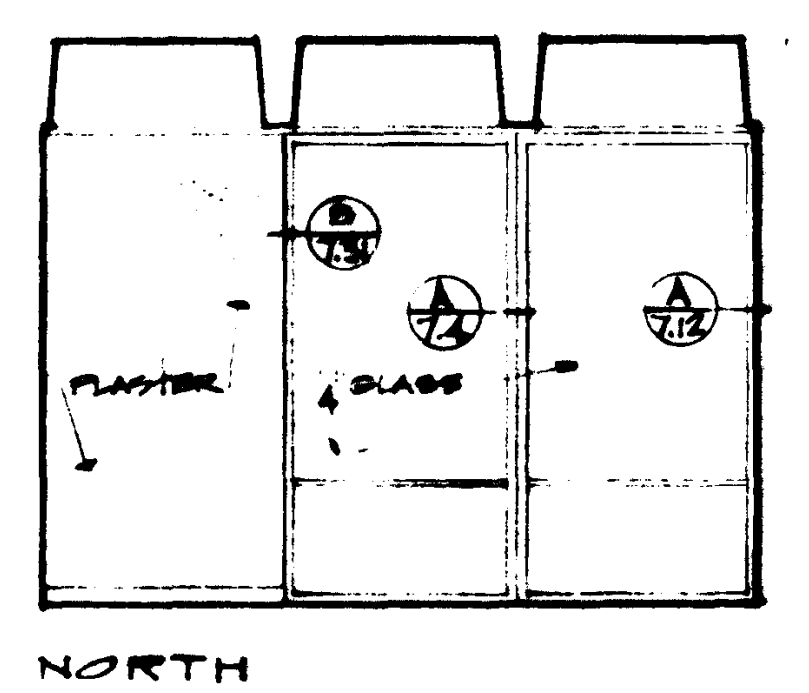OFFICE. 201 A

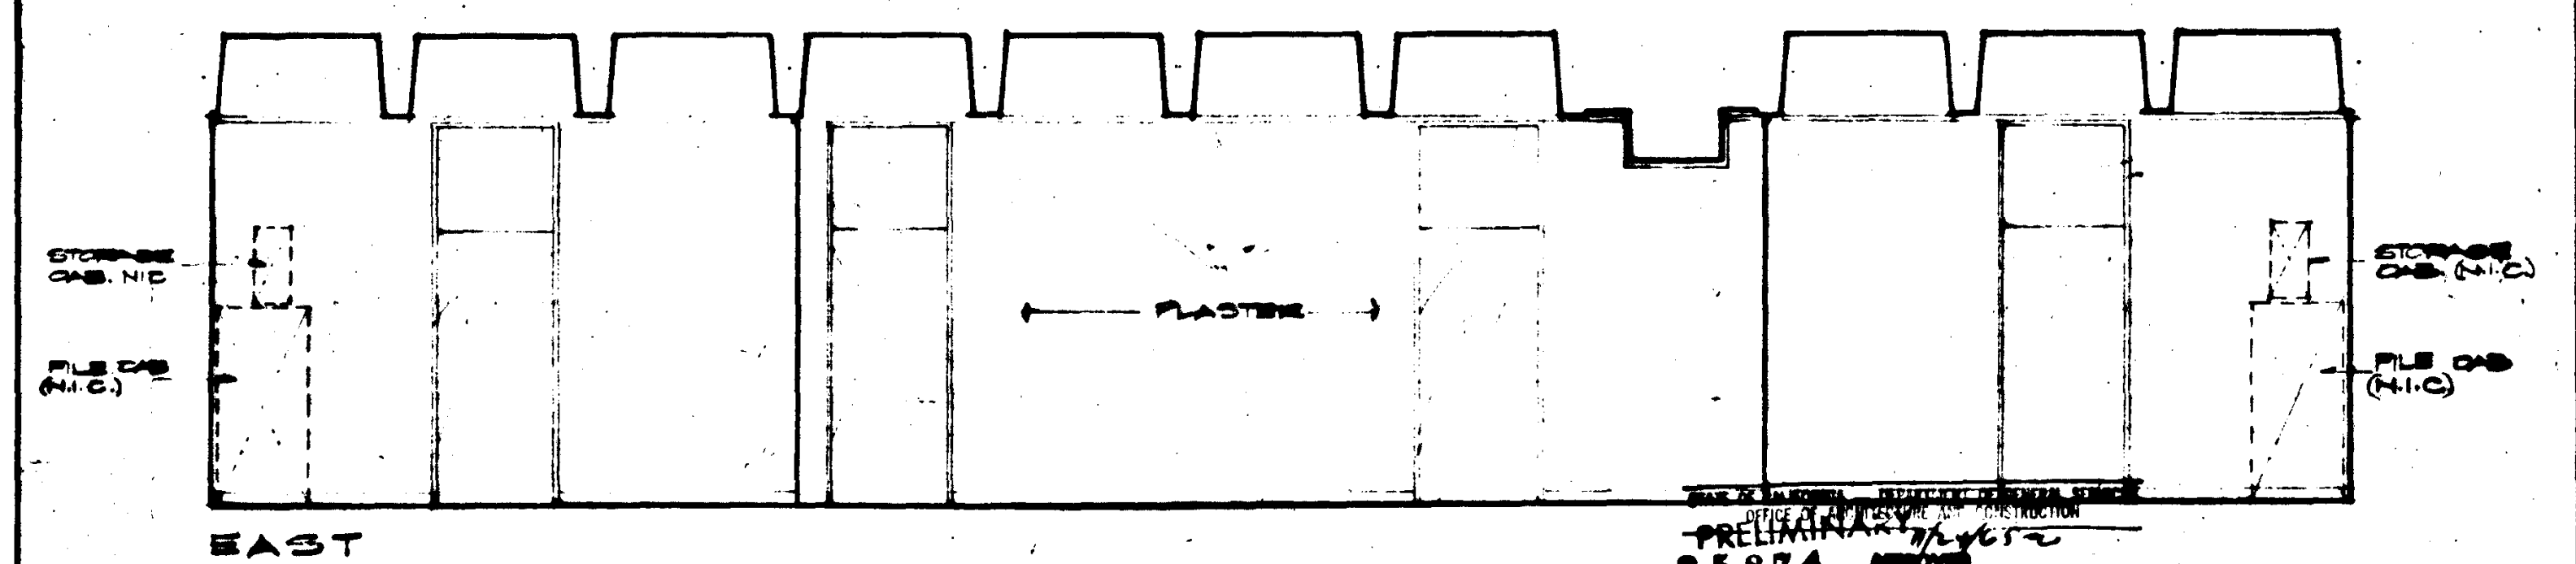




SEC. 208 A

GOLDEN WEST COLLEGE
HUNTINGTON BEACH, CALIFORNIA
ORANGE COAST JUNIOR COLLEGE DISTRICT







LOBBY 101A


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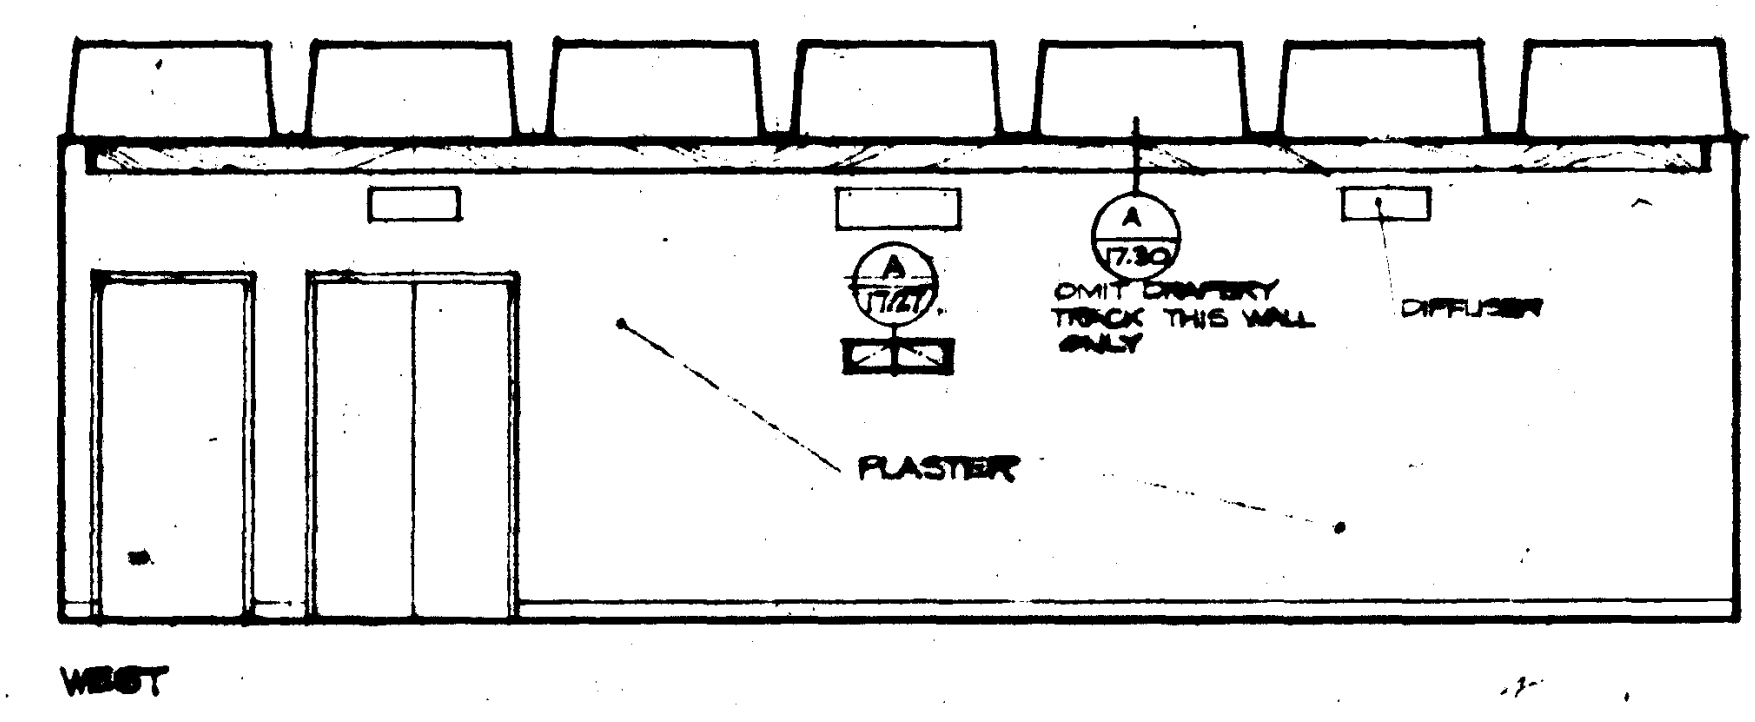
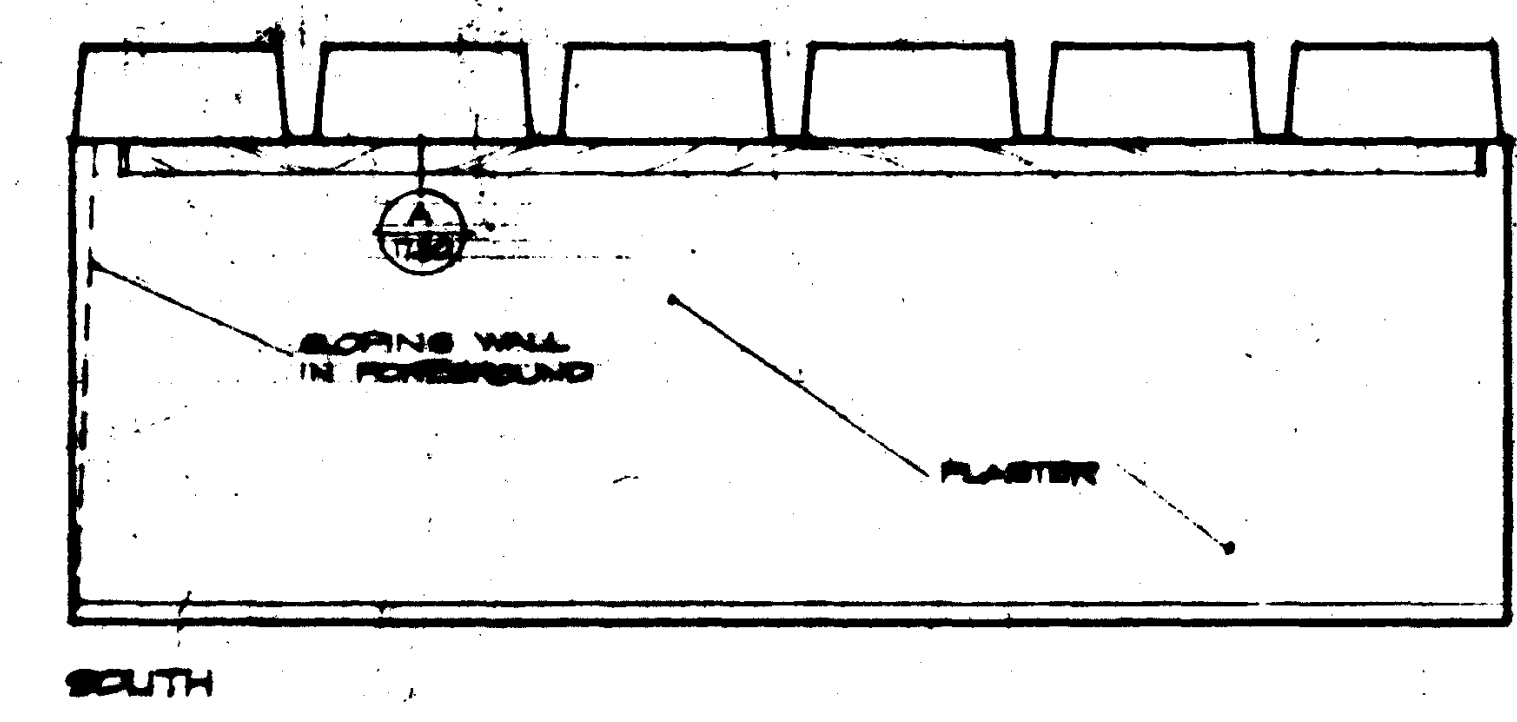
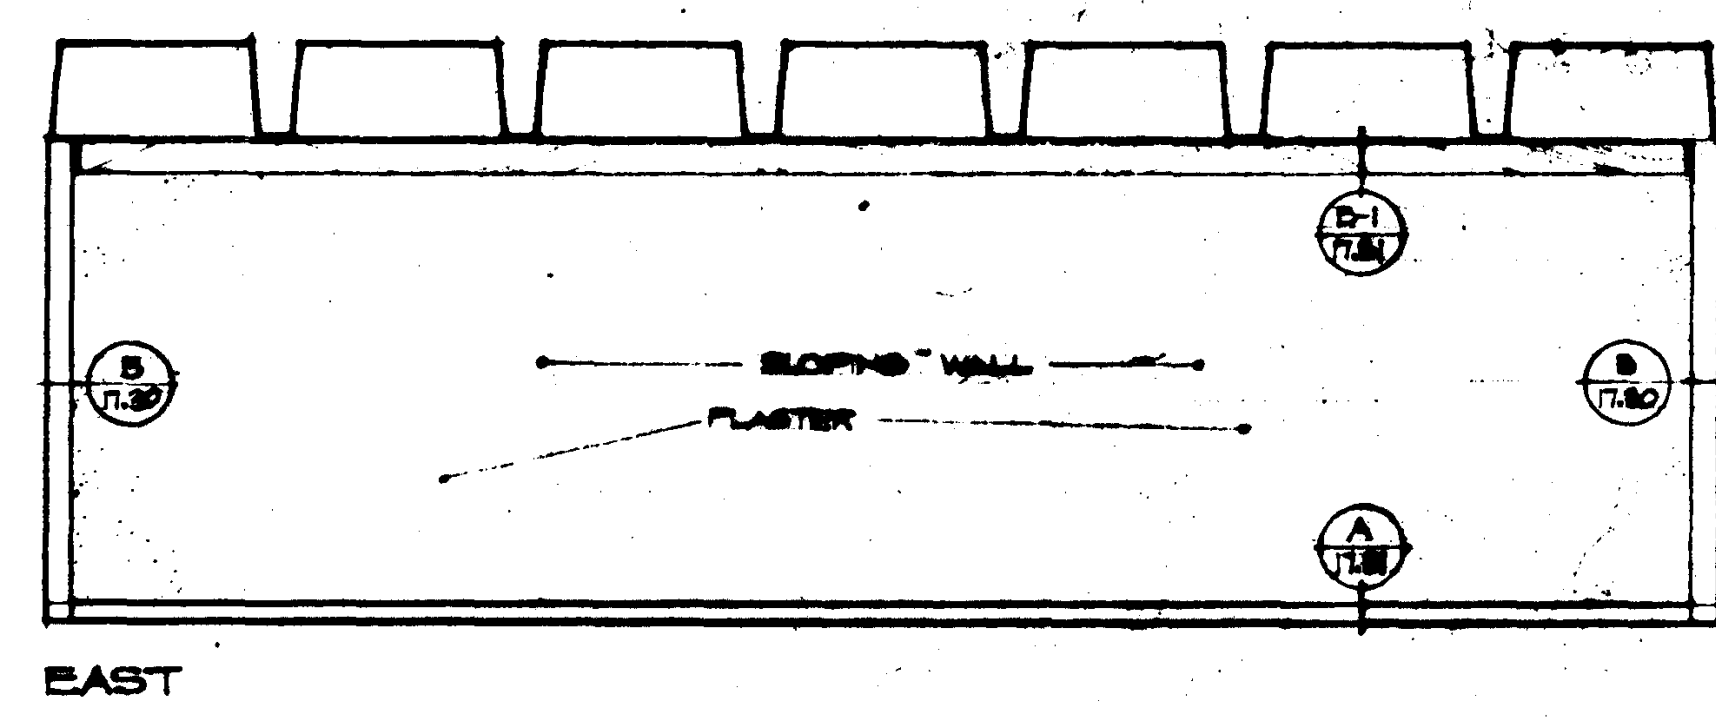
CLASSROOM 110

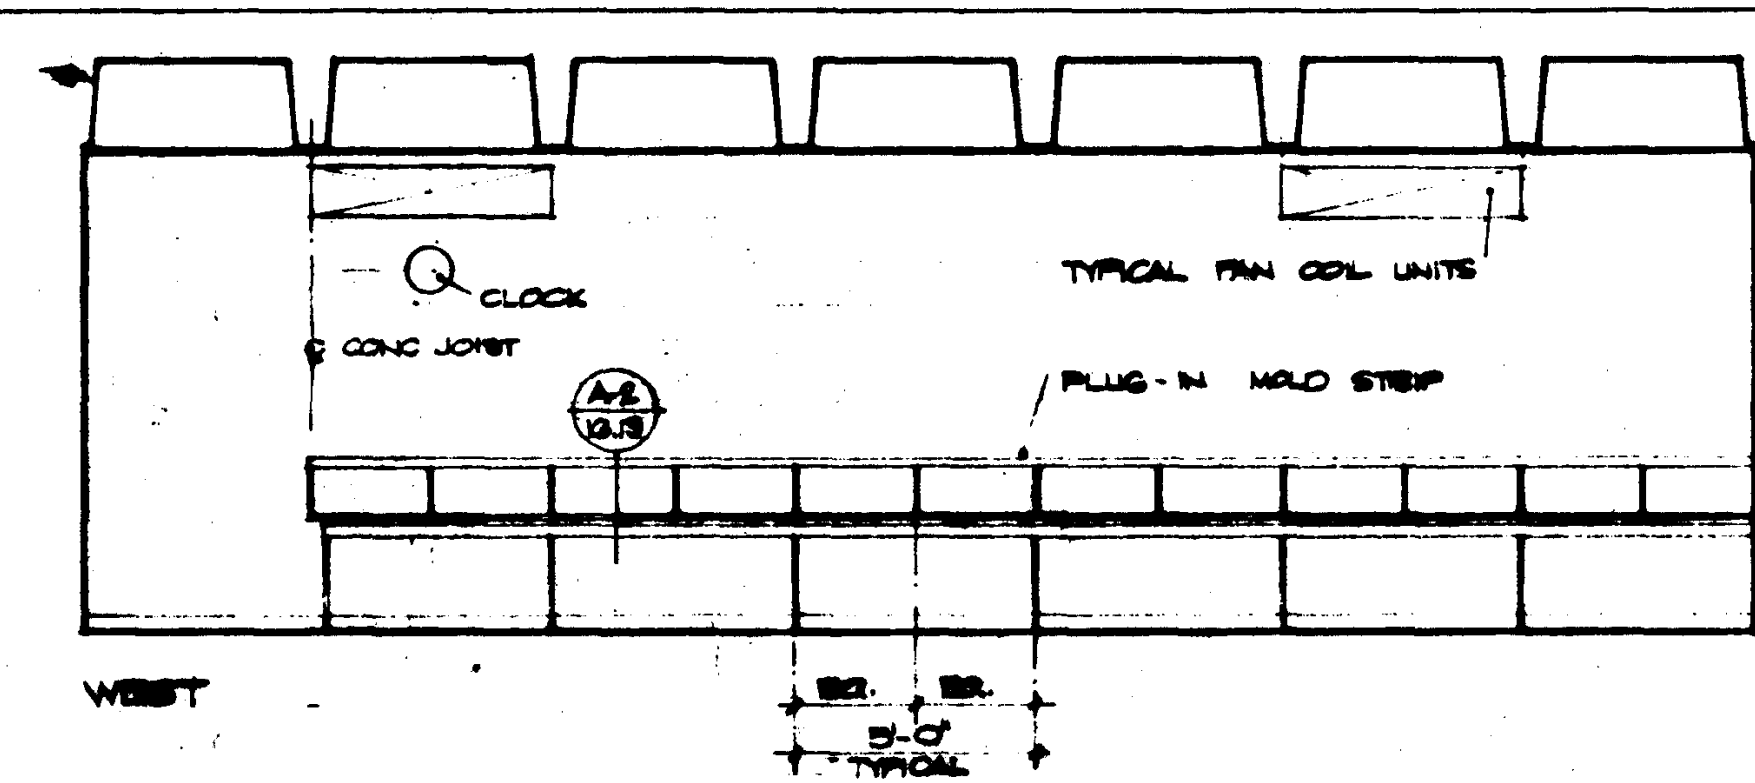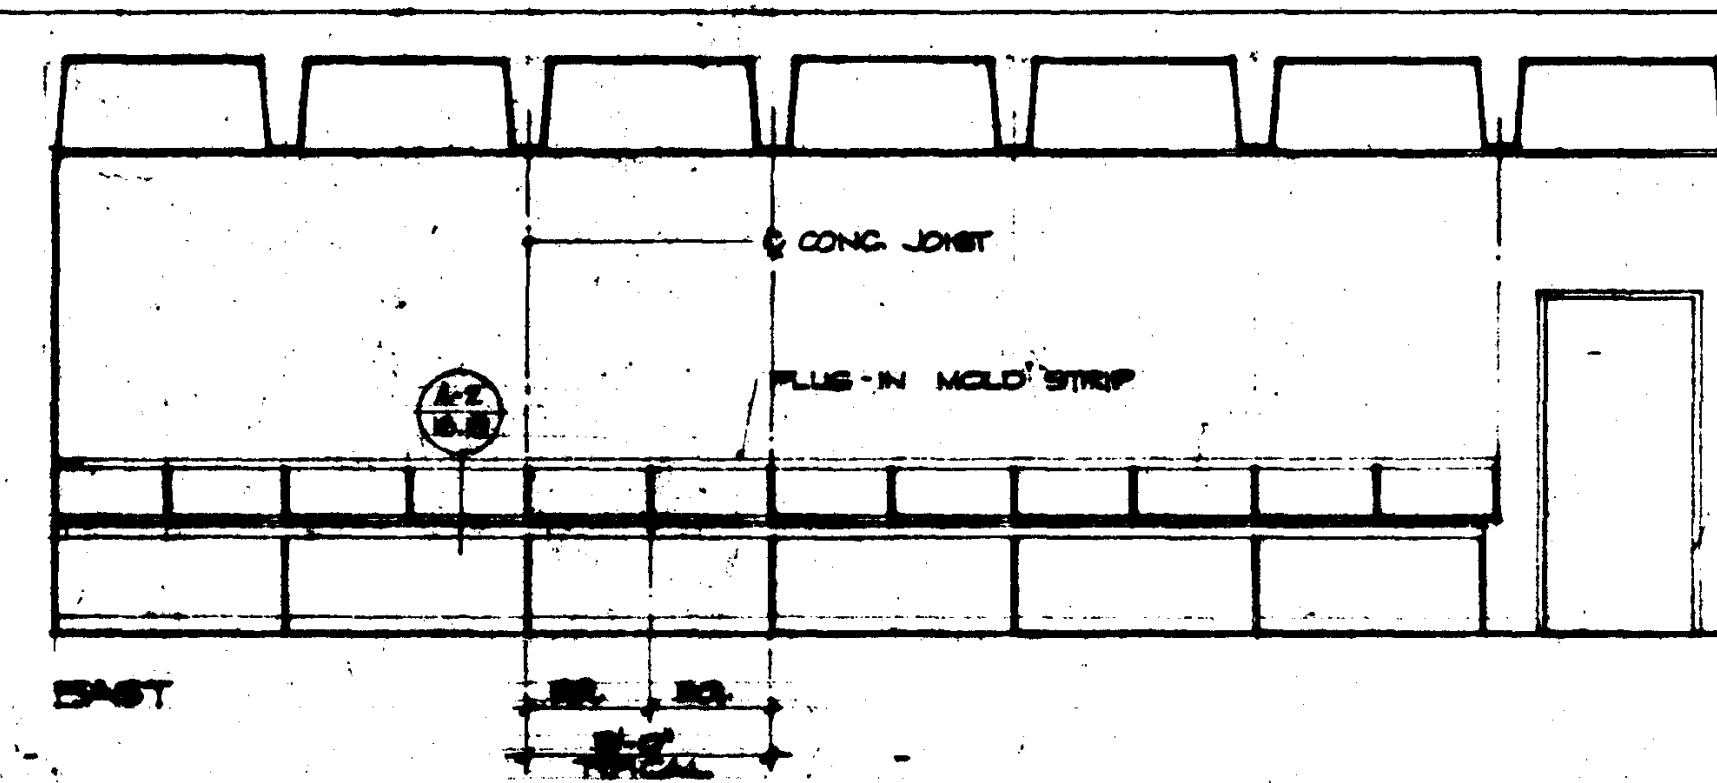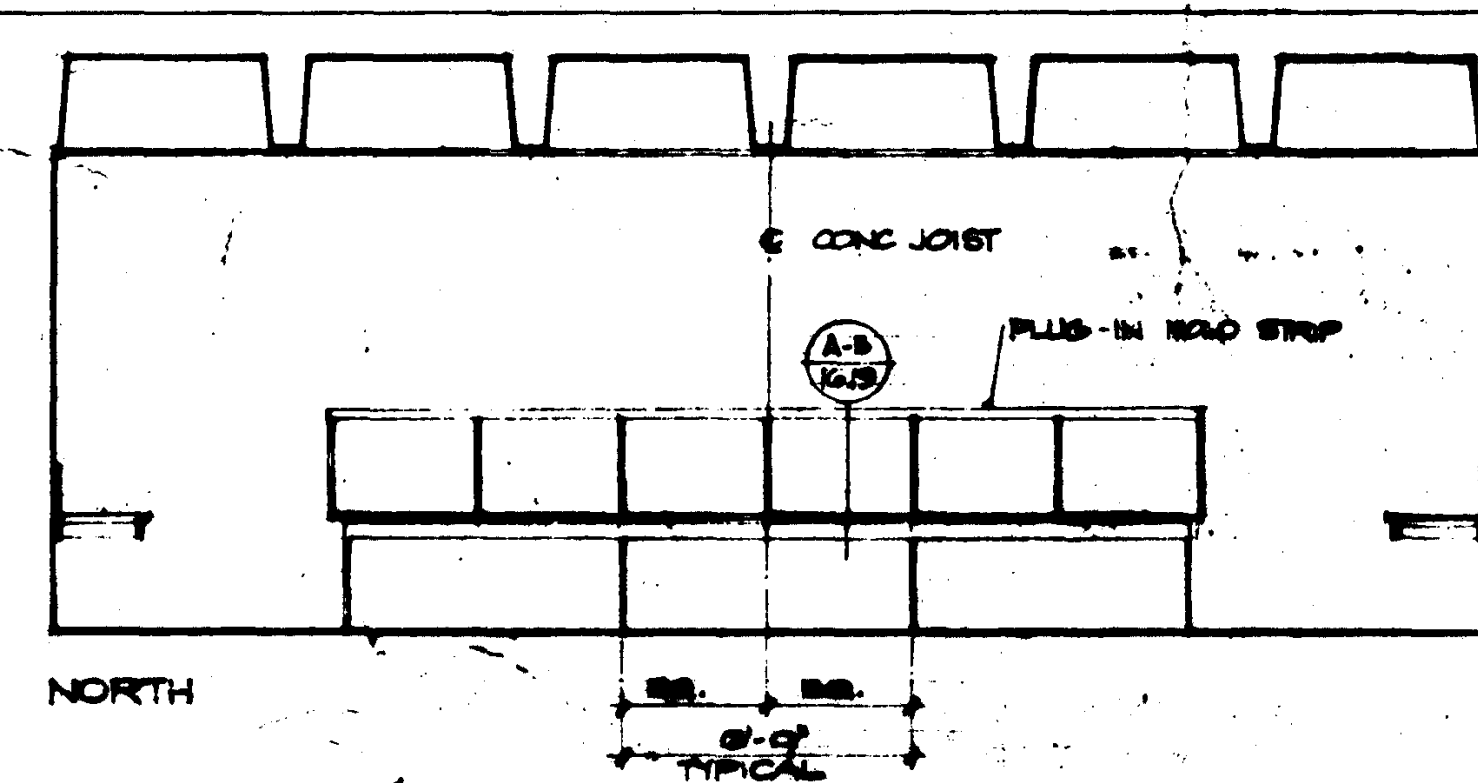


DRESSING 112

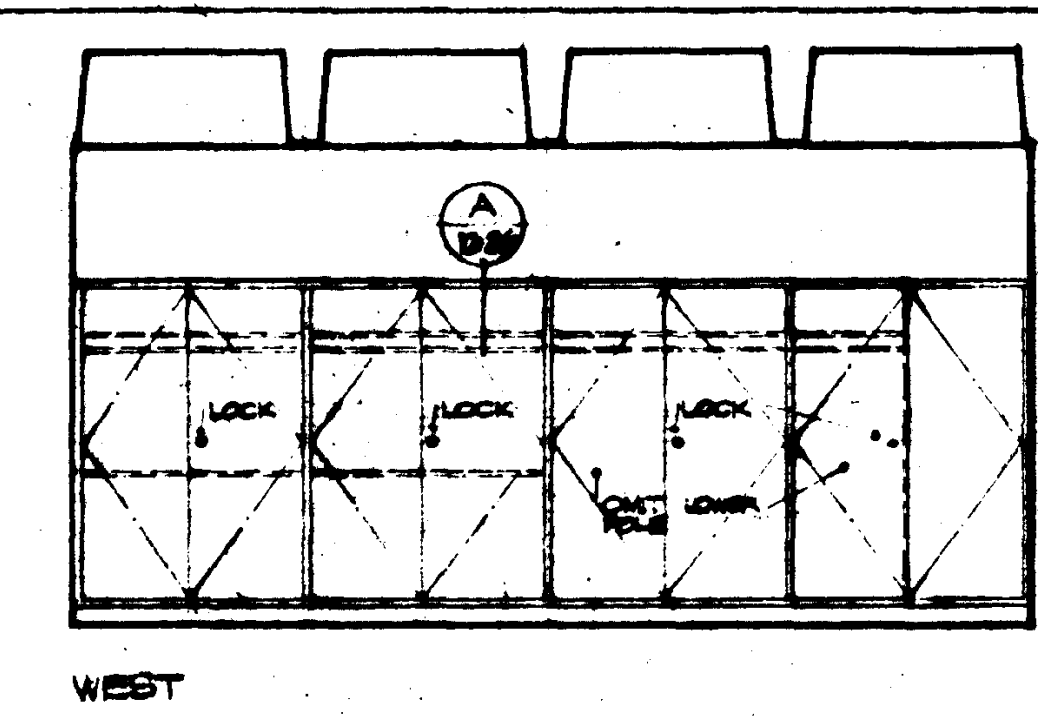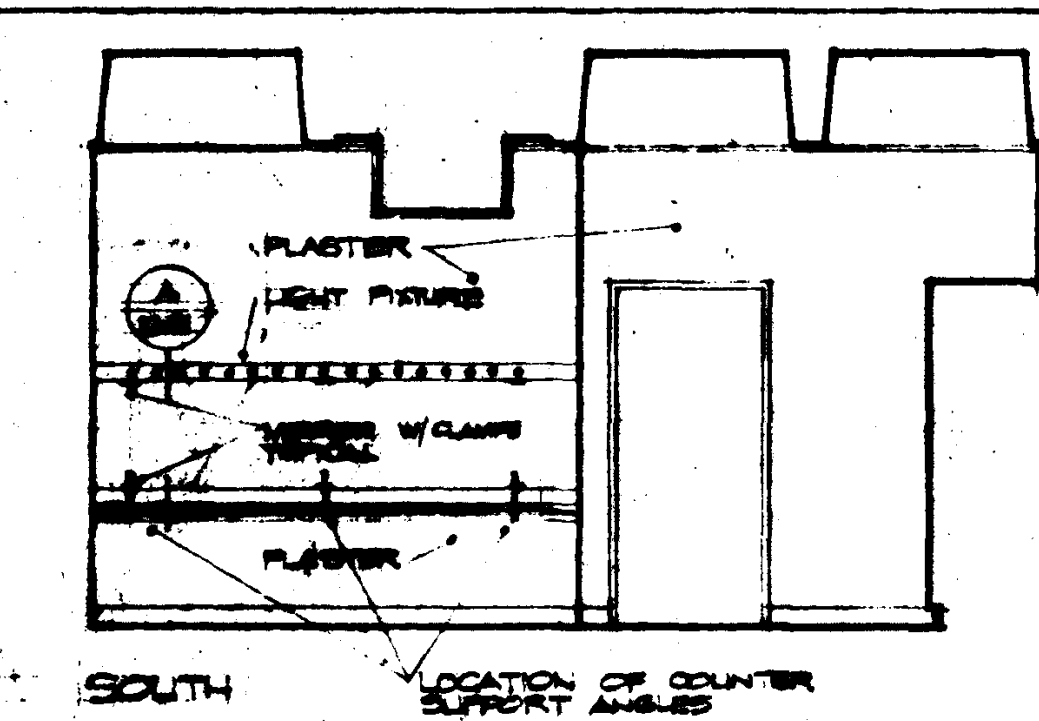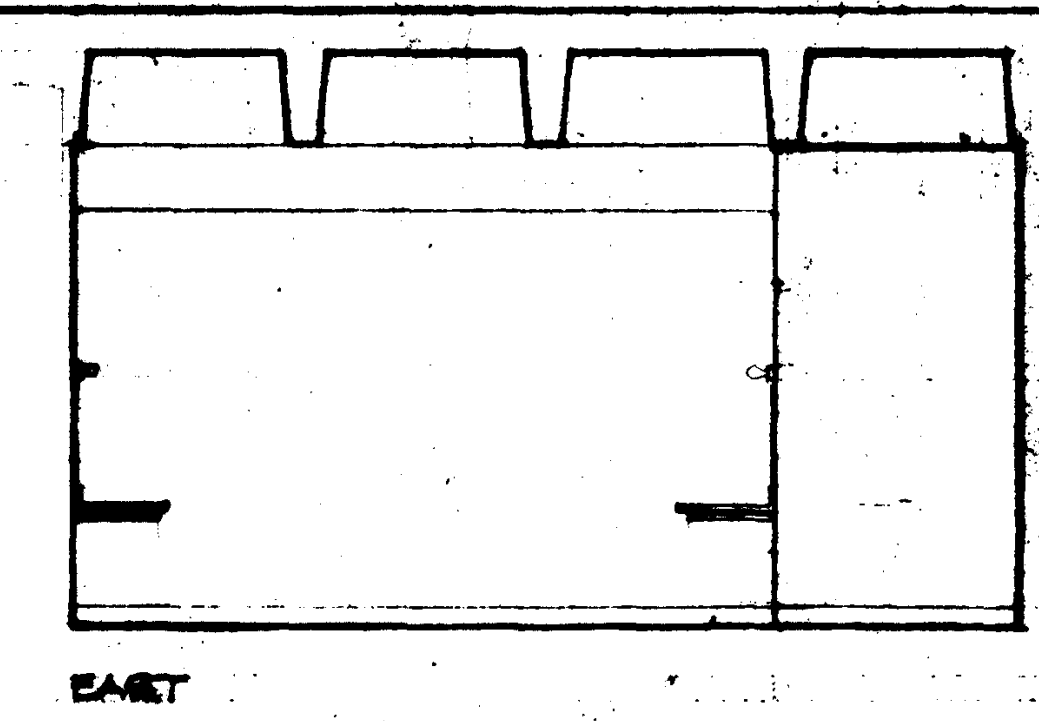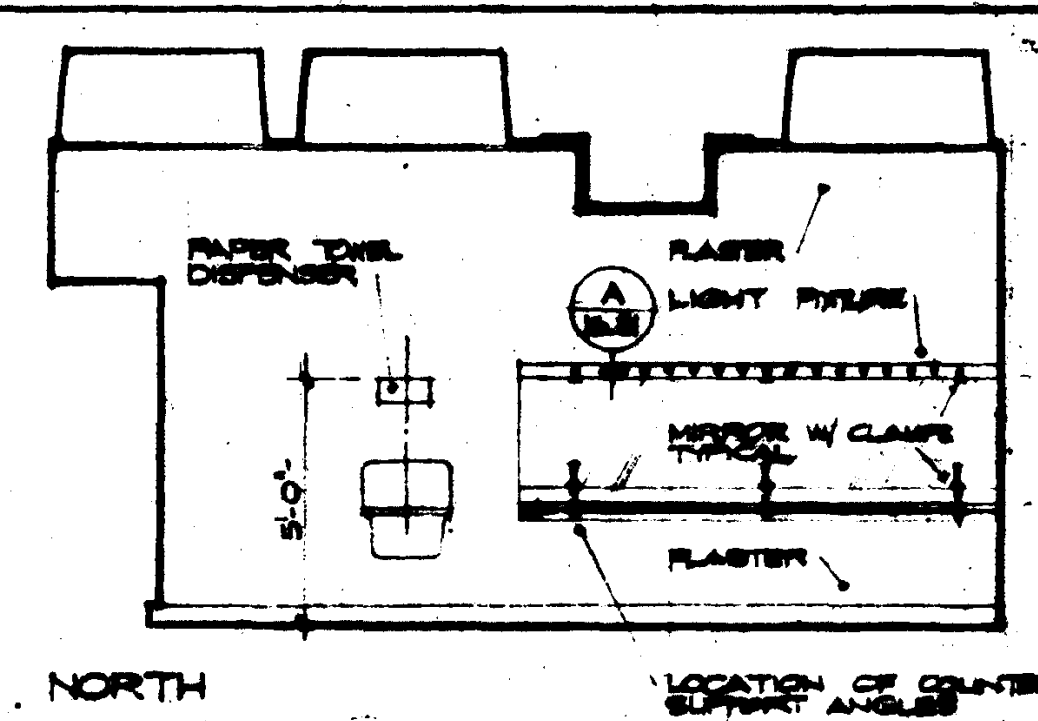

THEATRE 115

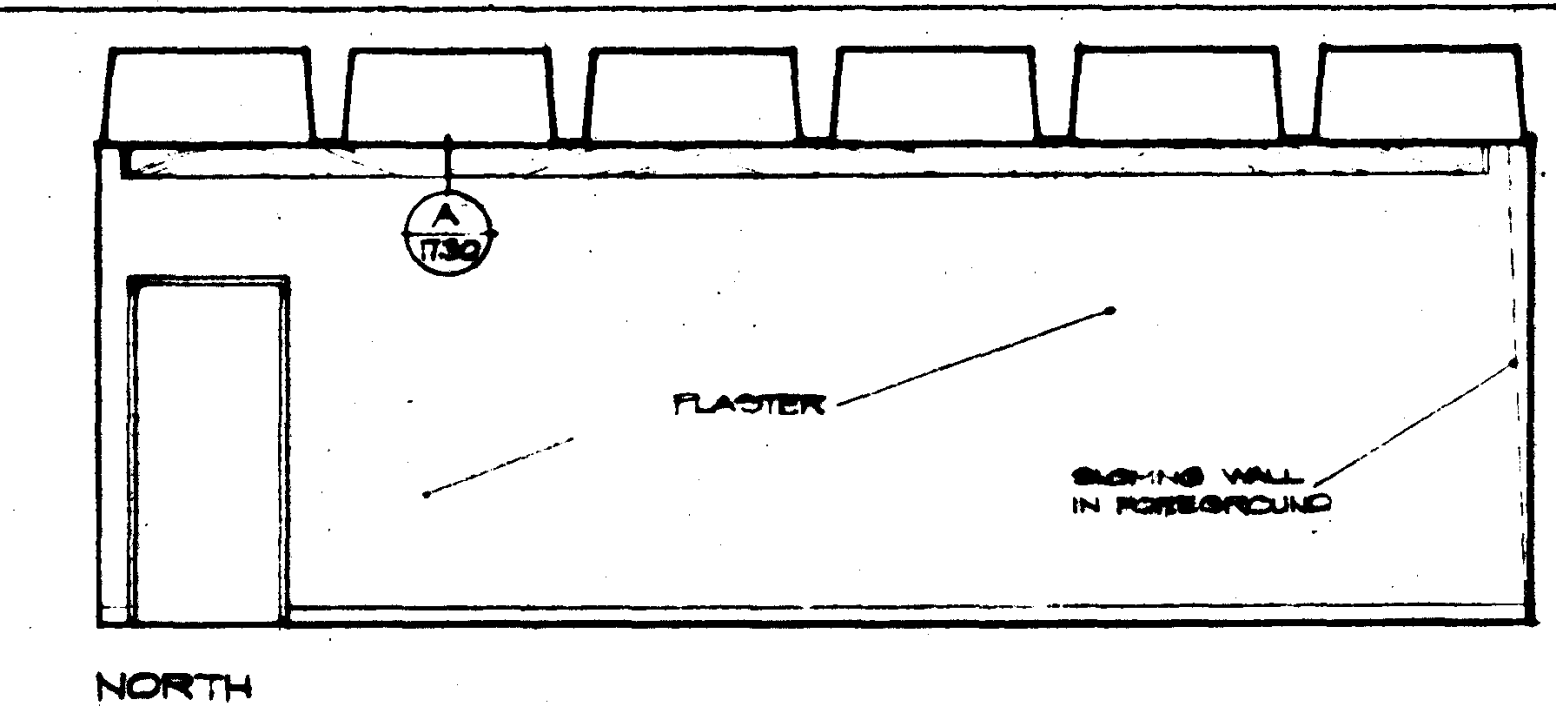

THEATRE 115

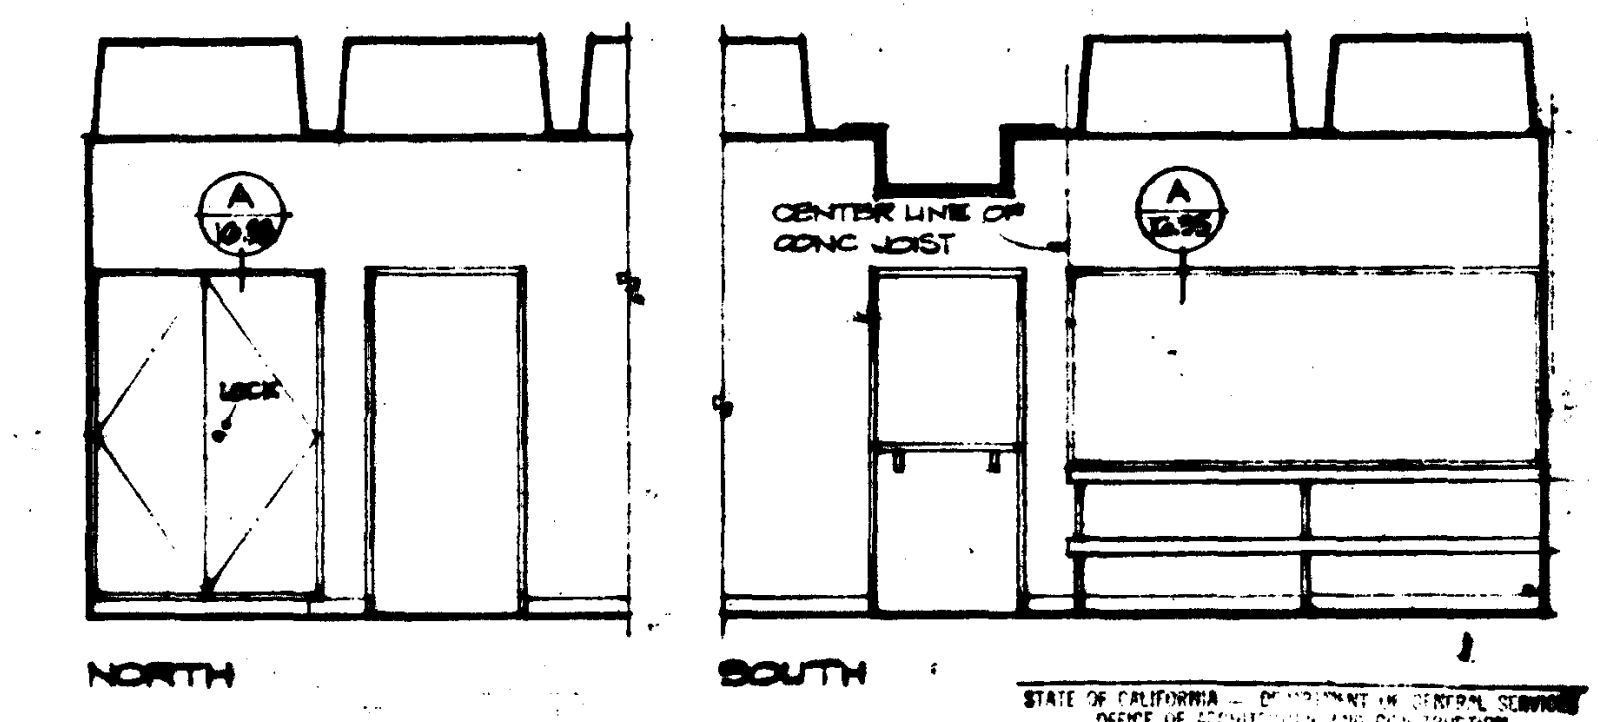

SHOP 113


UNIT 5

UNIT 4 & 5


INTERIOR ELEVATIONS

JOB NO. 104
DATE 15 JUN 1965
SHEET NO. A 3.6


<p>REVISIONS</p> <p>1. SEE SHEET A-10 FOR NORTH ELEVATION</p>	<p>STRUCTURAL ENGINEERS BRANDOW & JOHNSON I.A. MARTIN & ASSOCIATES</p> <p>MECHANICAL ENGINEERS RALPH E. PHILLIPS, INC.</p> <p>ELECTRICAL ENGINEERS RALPH E. PHILLIPS, INC.</p> <p>CIVIL ENGINEERS G. SHURMAN & ASSOCIATES HOFFATT & NICHOL</p>	<p>DESIGNED DRAWN BY CHECKED BY</p> <p>ARCHITECT ENGINEER COLLEGE</p>	<p>APPROVED AS REVISED NOV 24 1965 APPROVED STATE FIRE MARSHAL STATE OF CALIFORNIA DATE: JUN 15 1965 35874 APPROVED JUN 21 1965</p>	<p>ASSOCIATED ARCHITECTS: WILLIAM L. PEREIRA & ASSOCIATES A. QUINCY JONES-FREDERICK & EMMONS & ASSOCIATES BLUROCK ELLERBROCK & ASSOCIATES</p> <p>URBANUS SQUARE • MACARTHUR BOULEVARD AT FORD ROAD TELEPHONE 714/675-2640 • CORONA DEL MAR, CALIFORNIA</p>	<p>GOLDEN WEST COLLEGE HUNTINGTON BEACH, CALIFORNIA ORANGE COAST JUNIOR COLLEGE DISTRICT</p>	<p>UNIT 4 & 5 INTERIOR ELEVATIONS A 3.6</p>
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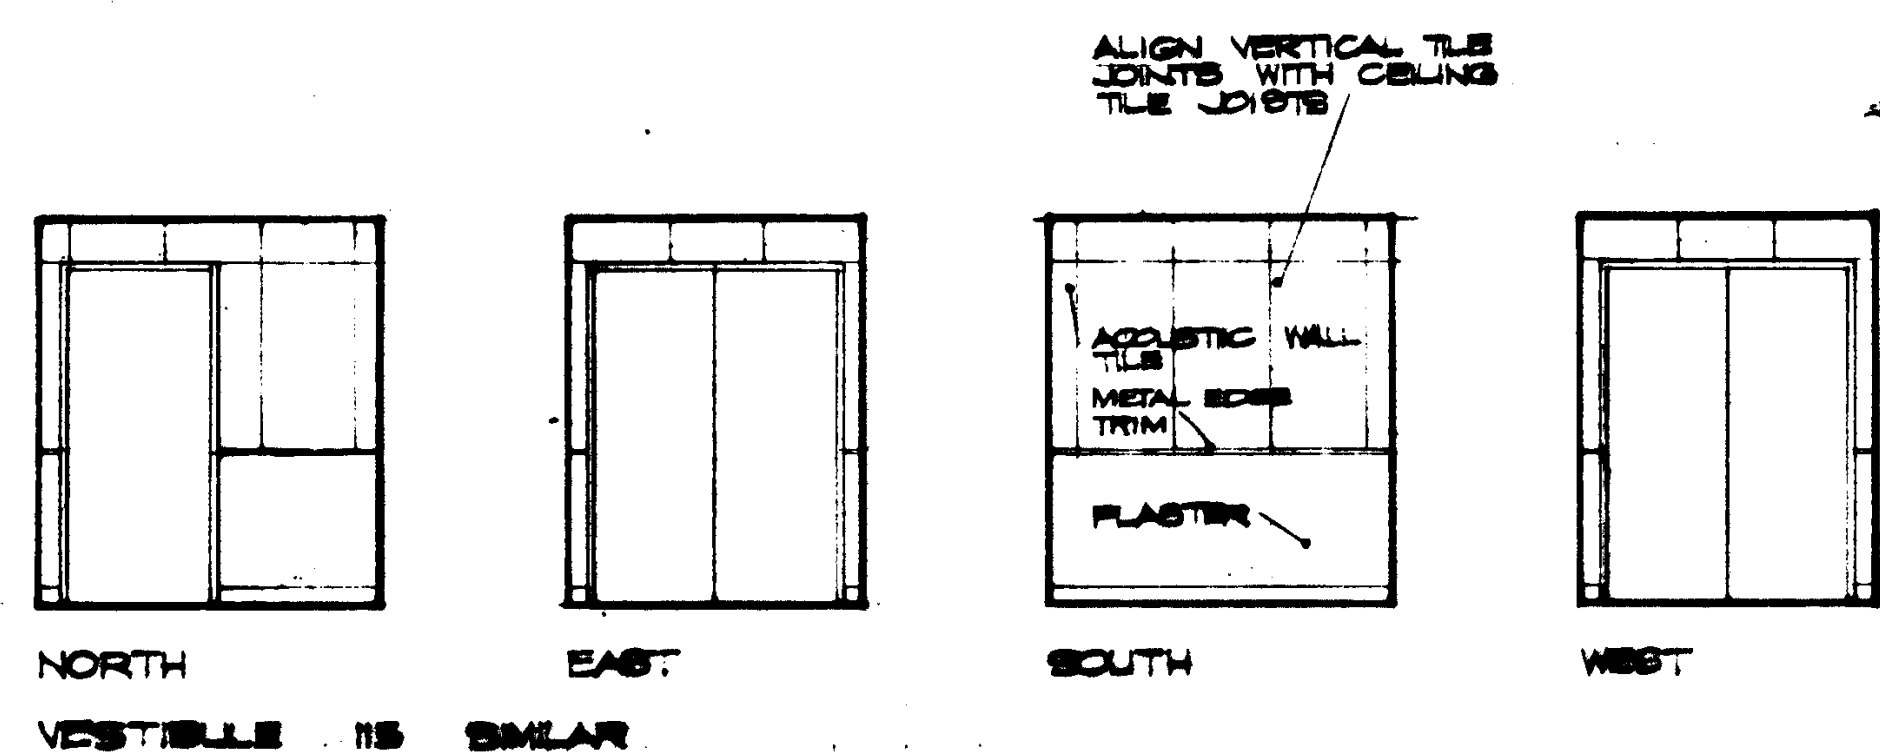
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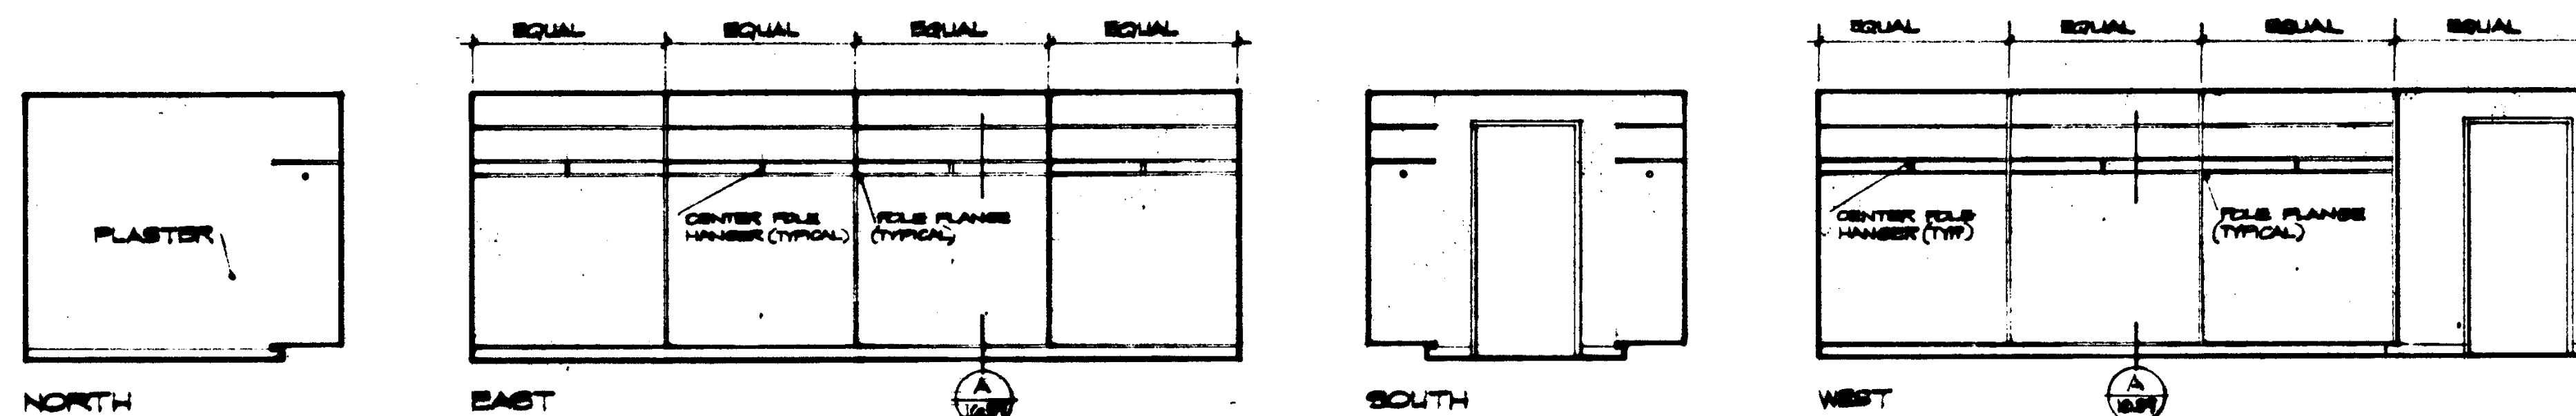
CORRIDOR 101

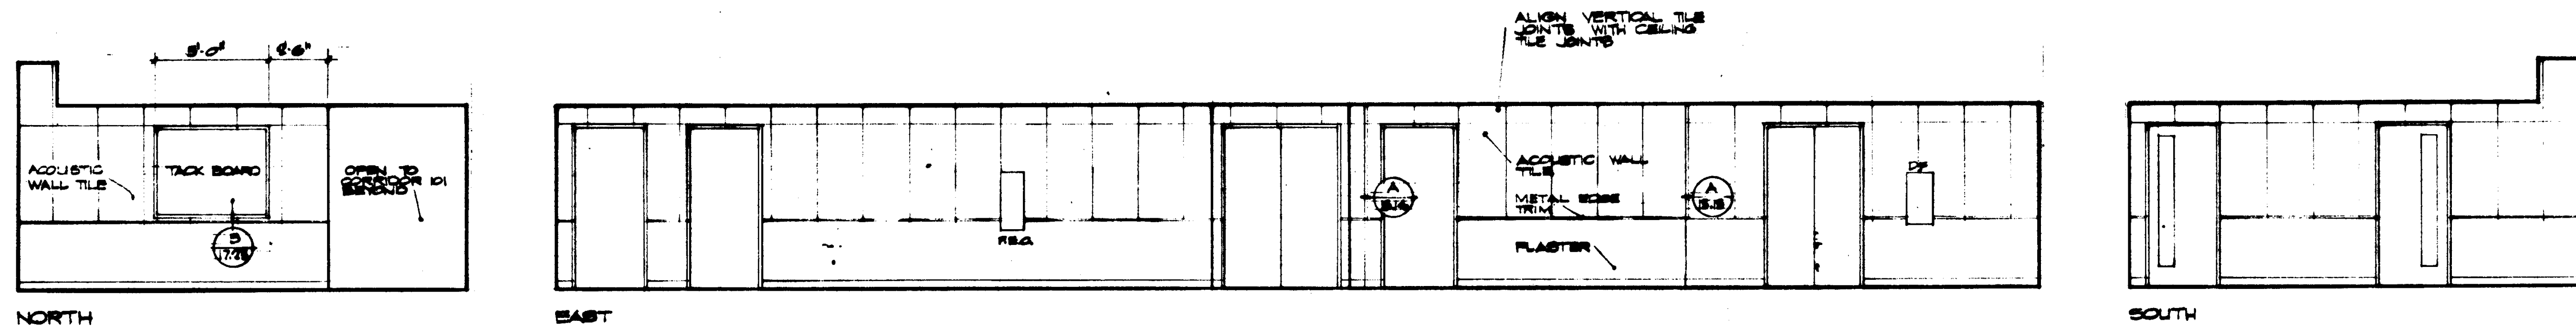


PRACTICE 103

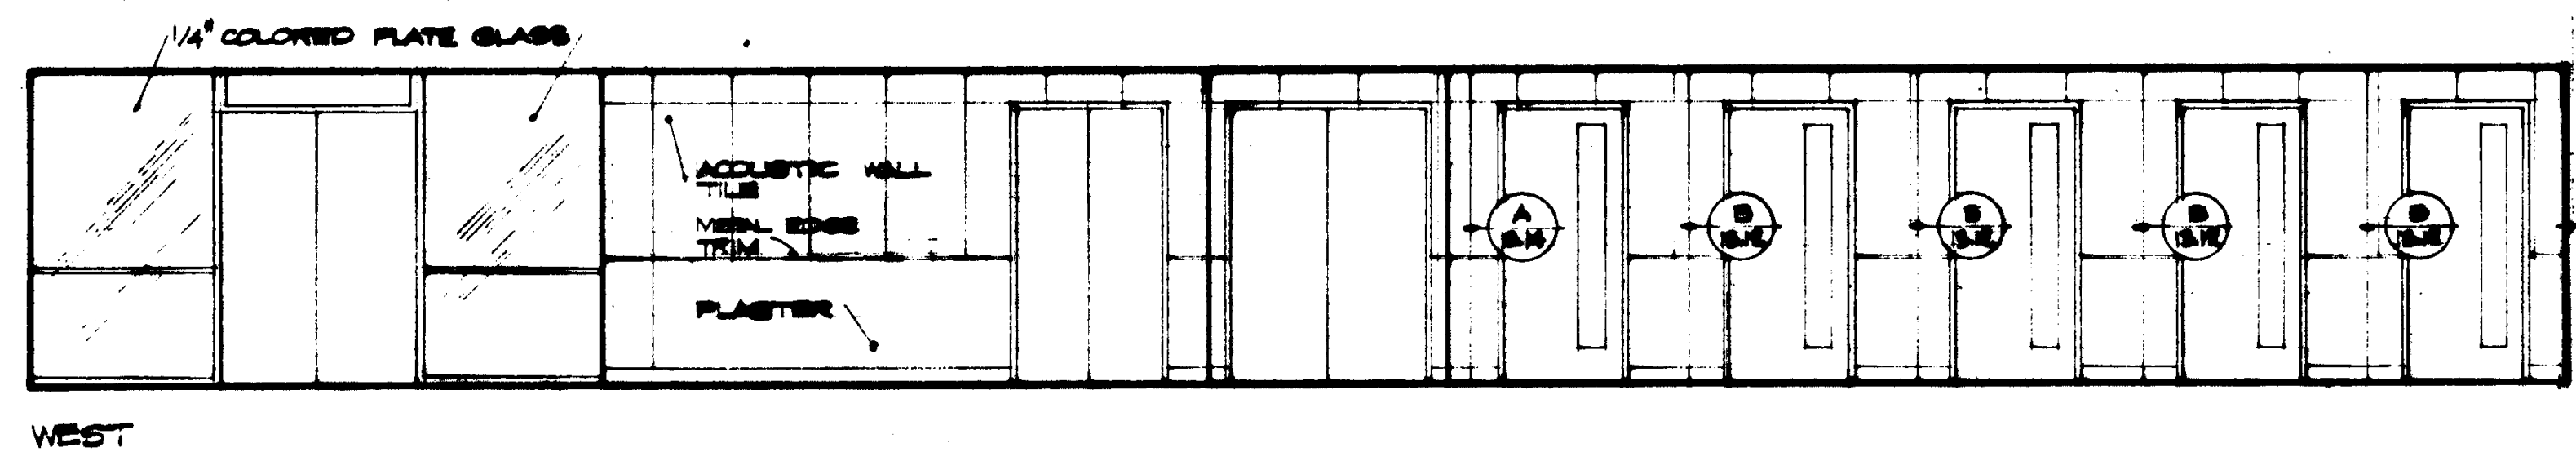


VESTIBULE 106

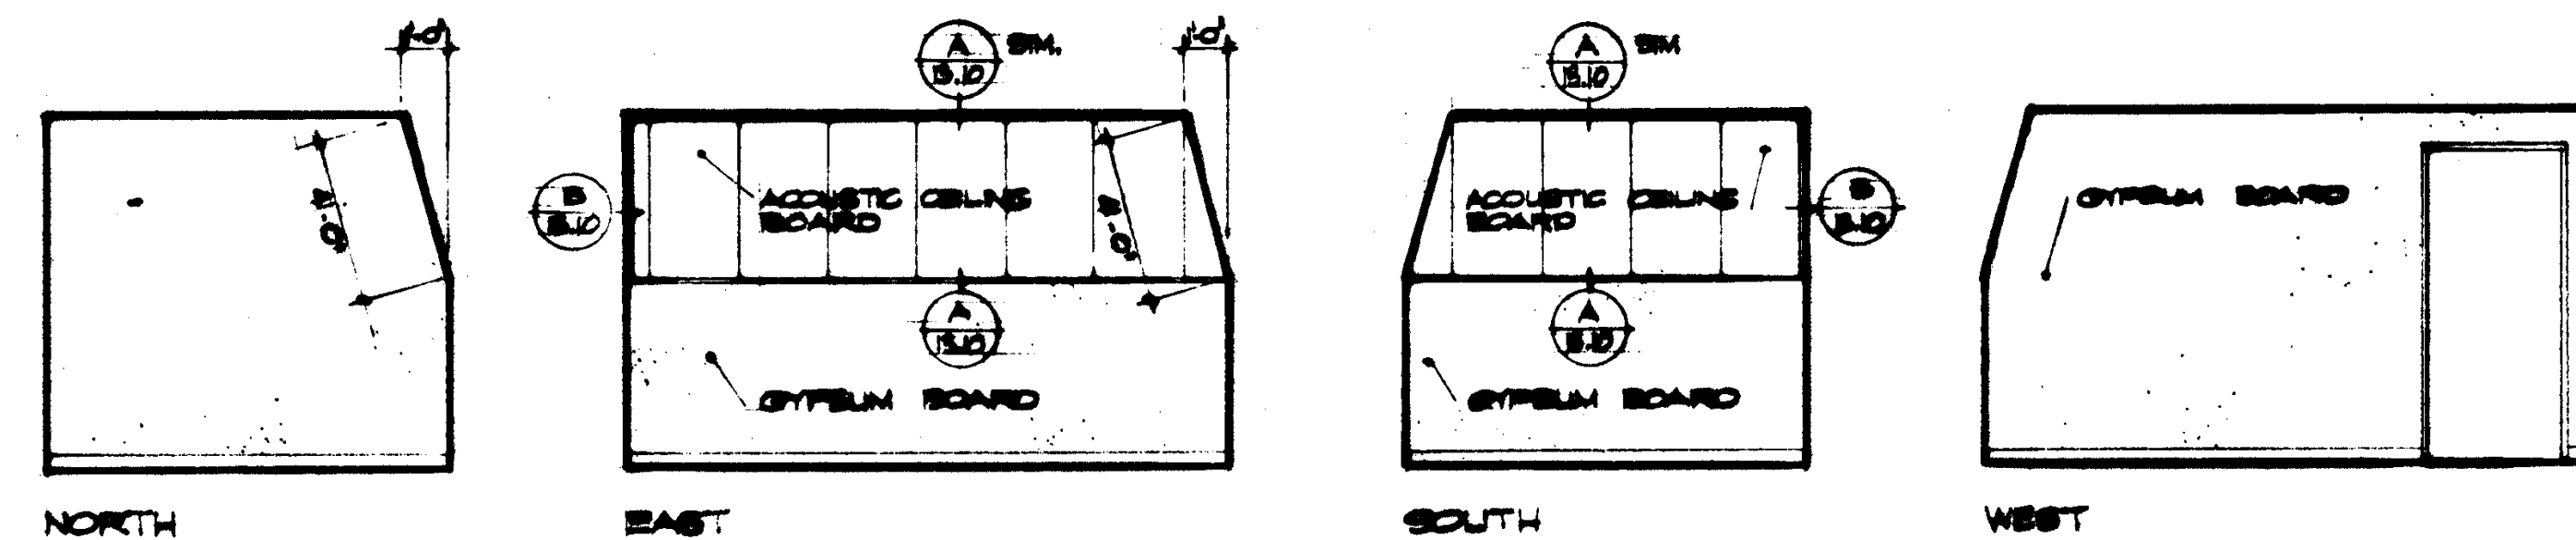

UNIFORMS 107

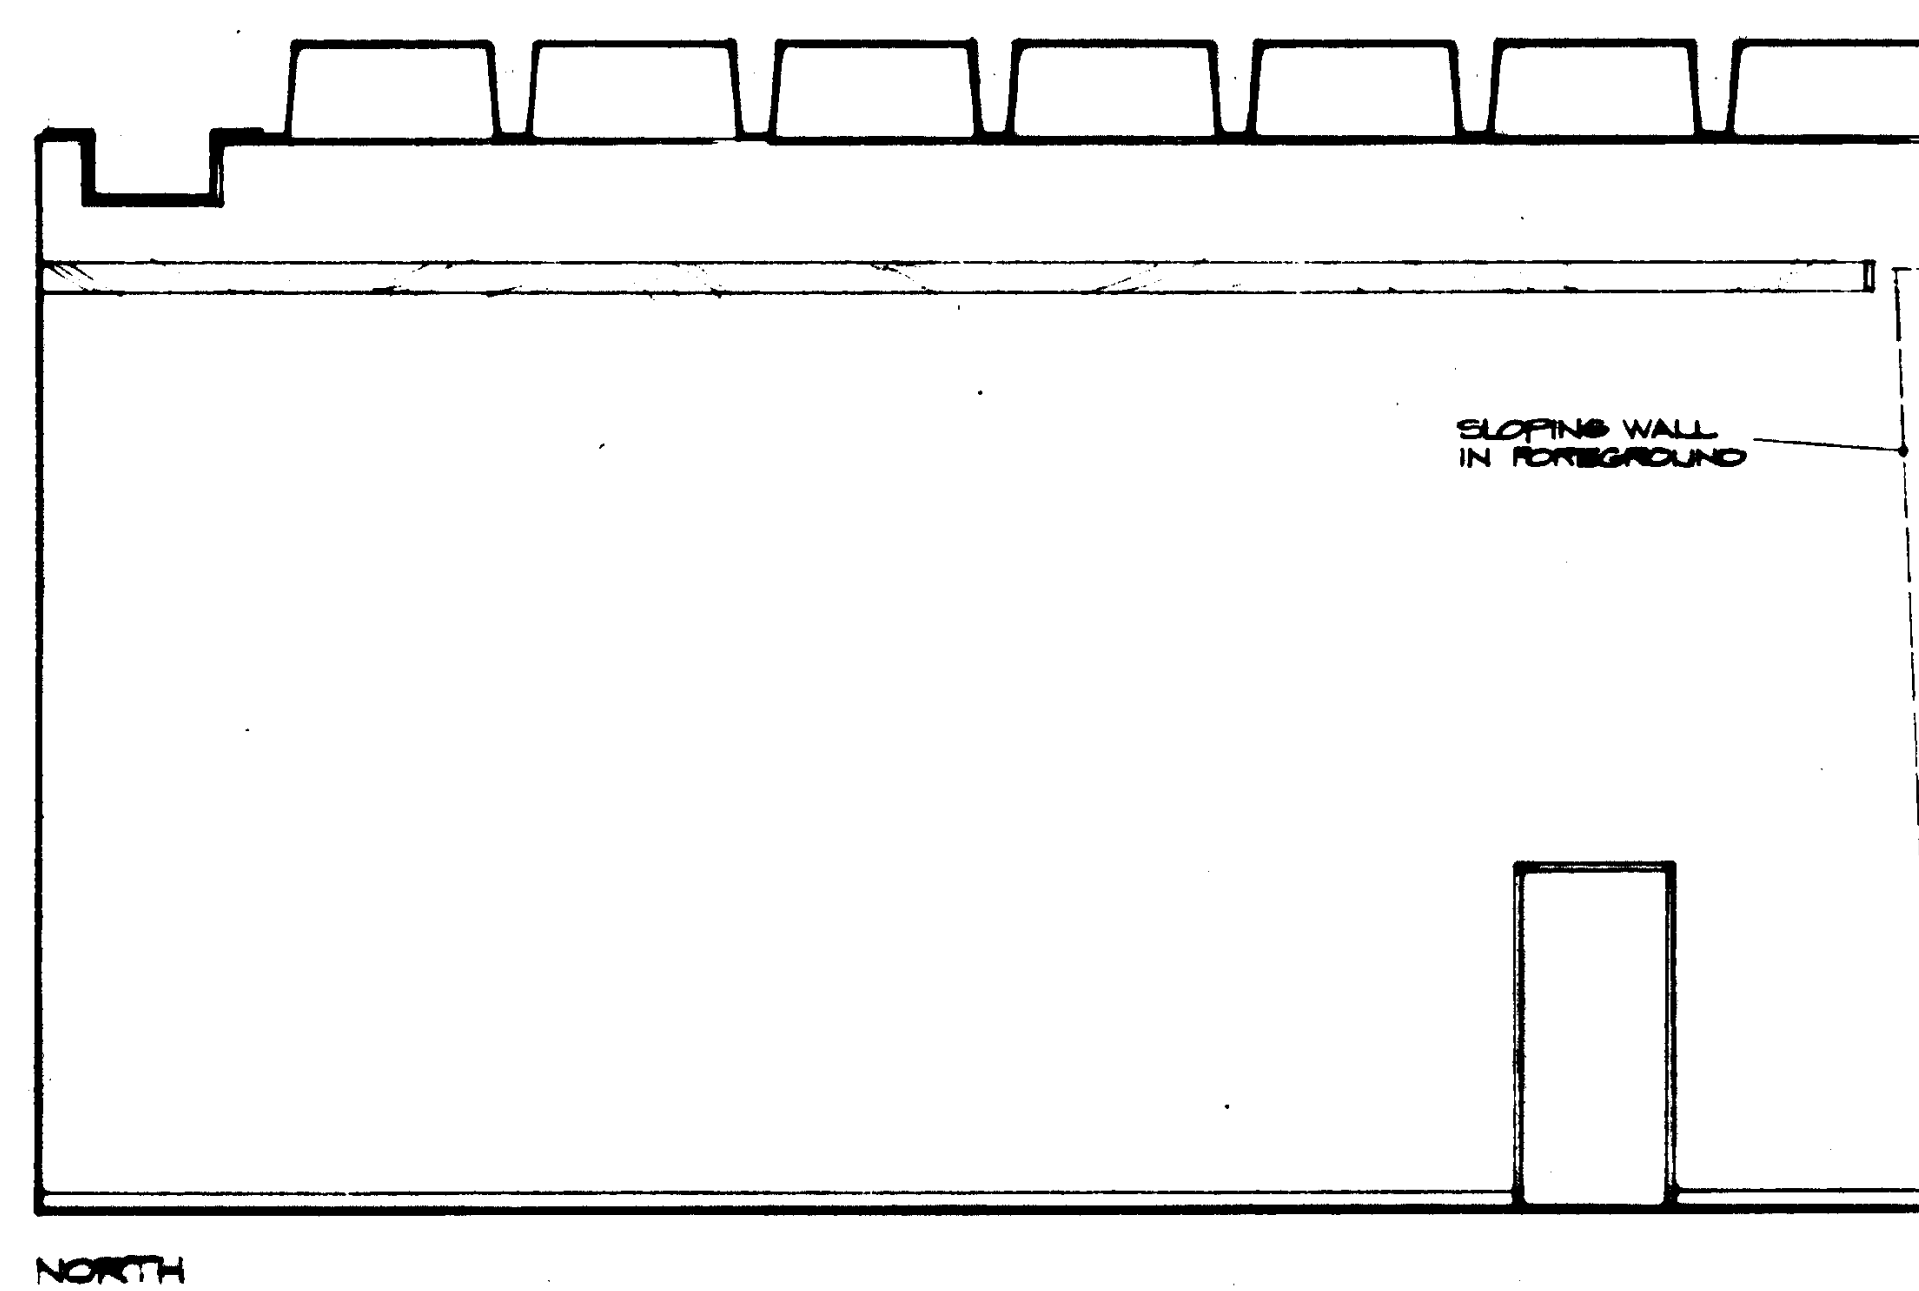

VOICE 108

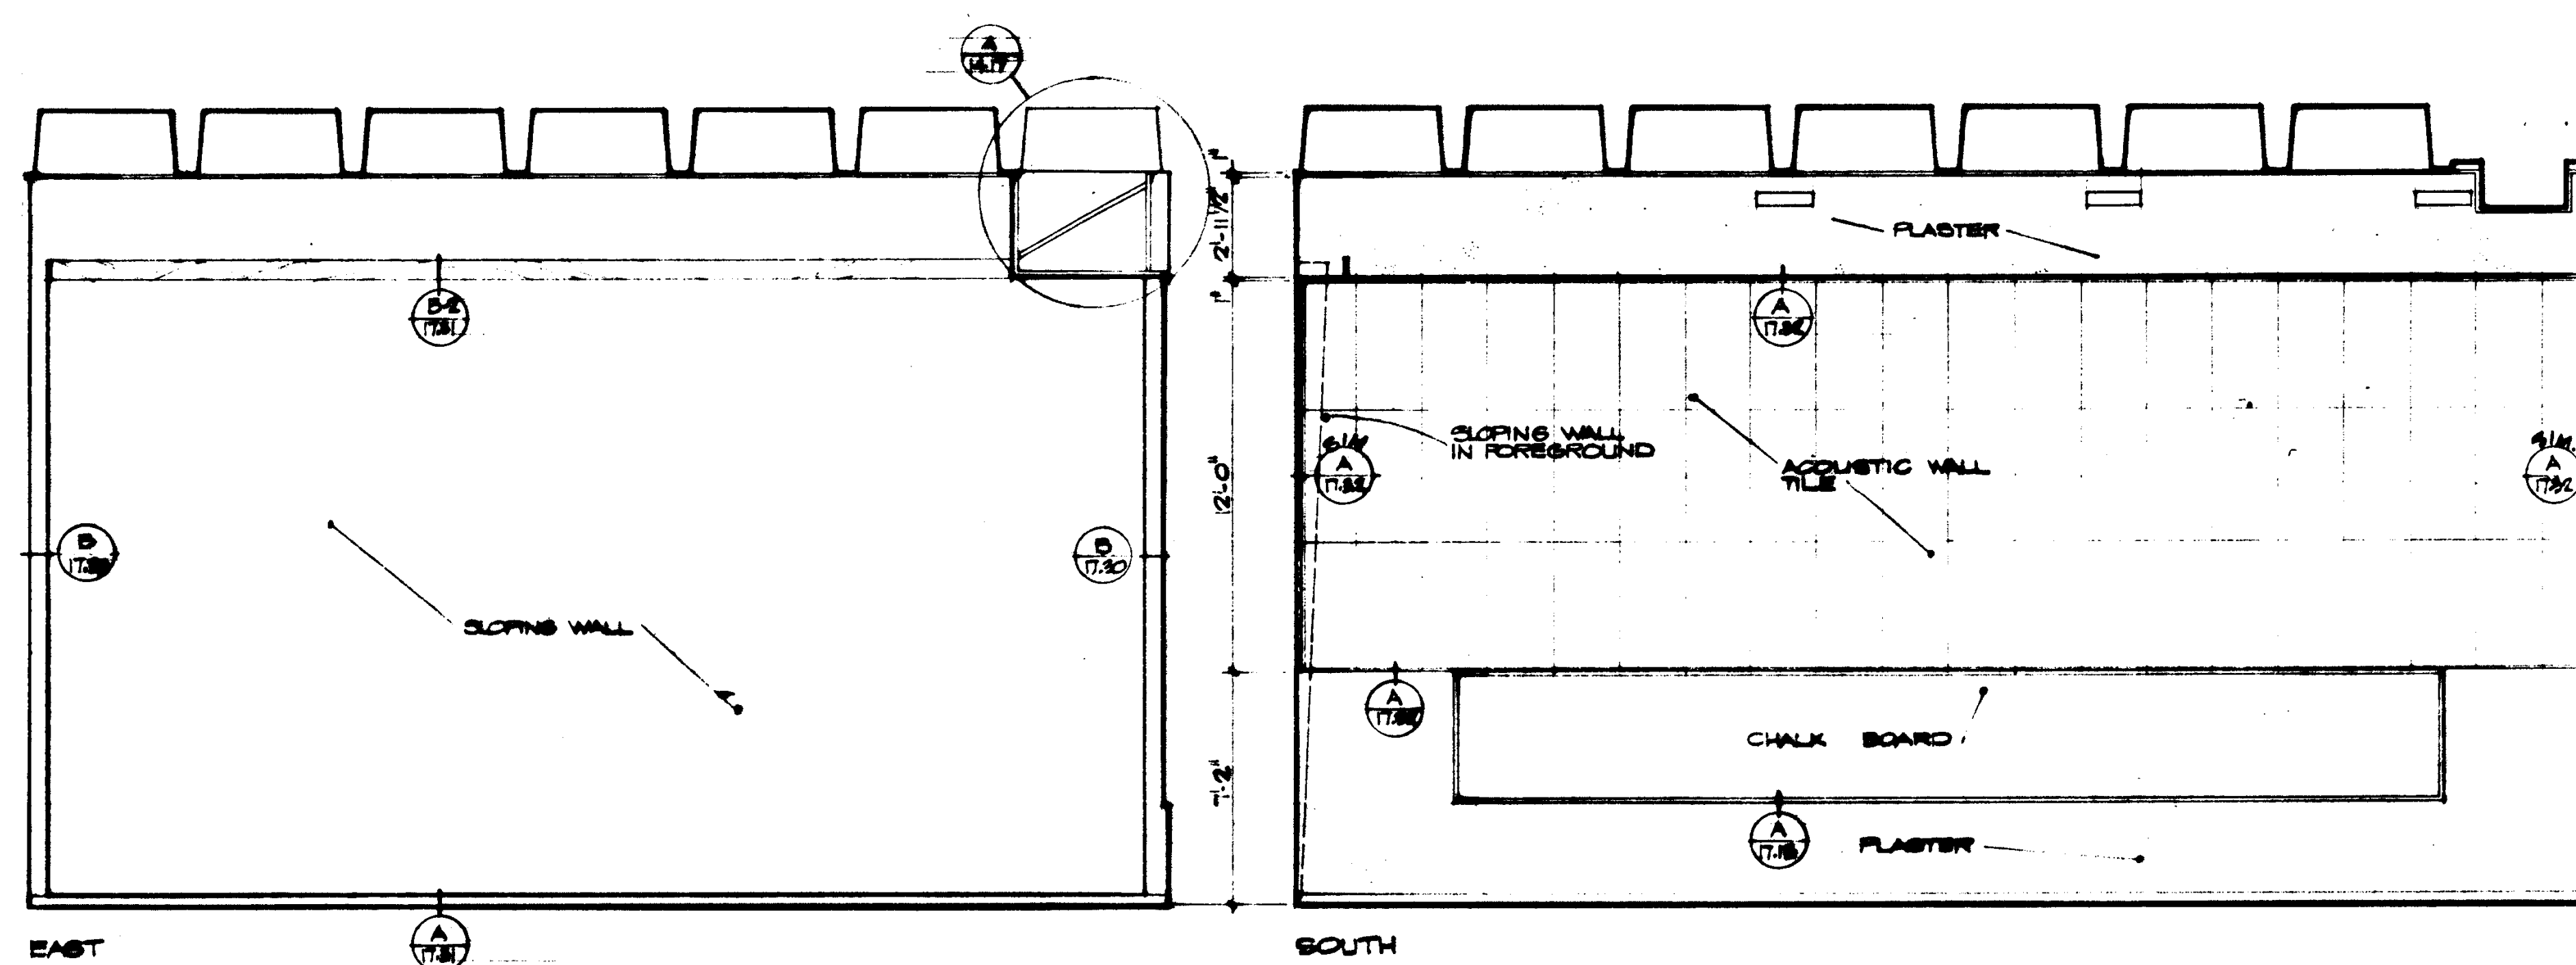

REVISIONS DATE DRAWN REVISIONS		STRUCTURAL ENGINEERS BRANDOW & JOHNSTON J.A. MARTIN & ASSOCIATES MECHANICAL ENGINEERS RALPH E. PHILLIPS, INC. ELECTRICAL ENGINEERS RALPH E. PHILLIPS, INC. CIVIL ENGINEERS G. SHURMAN & ASSOCIATES MOFFATT & NICKOL	DESIGNED DRAWN BY CHECKED BY	ARCHITECT WILLIAM L. PEREIRA ENGINEER COLLEGE	APPROVED STATE FIRE MARSHAL STATE OF CALIFORNIA DATE JUN 15 1965 25874	ASSOCIATED ARCHITECTS: WILLIAM L. PEREIRA & ASSOCIATES A. QUINCY JONES-FREDERICK E. EMMONS & ASSOCIATES BLUROCK ELLERBROCK & ASSOCIATES URBANUS SQUARE • MACARTHUR BOULEVARD AT FORD ROAD TELEPHONE 714/675-2640 • CORONA DEL MAR, CALIFORNIA	GOLDEN WEST COLLEGE HUNTINGTON BEACH, CALIFORNIA ORANGE COAST JUNIOR COLLEGE DISTRICT	UNIT G INTERIOR ELEVATIONS	JOB NO. 100-1 DATE 15 JUN 1965 SHEET NO. A 88.7
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FACE OF WALL AT
POINT OF WALL IN
FOREGROUND OMITTED

PLASTER

FLAT

NORTH


NOTE

Floor plan of the classroom showing the layout of the room. The room is rectangular with a door on the right wall. The front wall (top) has a chalkboard and a tack board. The back wall (bottom) has a door. The left wall has a window. The floor is labeled "EAST".

EAST

[illegible]

WEST.

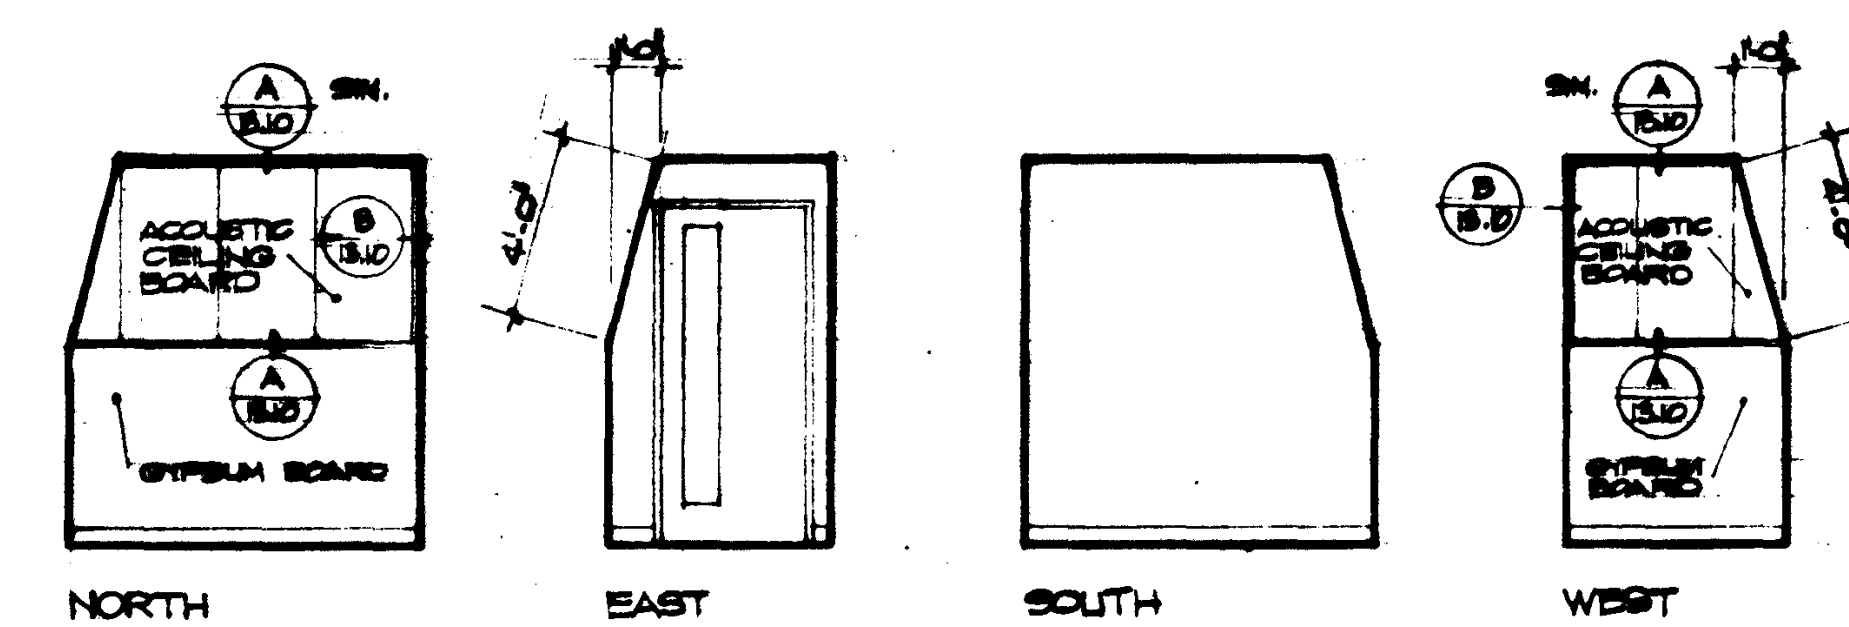

NORTH EAST
PRACTICE III, IV, V, VI, VII



			STRUCTURAL ENGINEERS BRANDOW & JOHNSTON C.A. MARTIN & ASSOCIATES	DESIGNED	ARCHITECT <i>(initials)</i>	APPROVED
			MECHANICAL ENGINEERS RALPH E. PHILLIPS, INC.	DRAWN BY	ENGINEER	APPROVED STATE OF CALIFORNIA DATE 11-27-1968
			ELECTRICAL ENGINEERS RALPH E. PHILLIPS, INC.	CHECKED BY	COLLEGE	
			CIVIL ENGINEERS G. SHUIRMAN & ASSOCIATES HOFFAT & HIGDON			
		DATE DRAWN	REVISIONS			

ASSOCIATED ARCHITECTS :
WILLIAM L. PEREIRA & ASSOCIATES
A. QUINCY JONES-FREDERICK E. EMMONS & ASSOCIATES
BLUROCK ELLERBROCK & ASSOCIATES


URBANUS SQUARE • MACARTHUR BOULEVARD AT FORD ROAD
TELEPHONE 714/675-2640 • CORONA DEL MAR, CALIFORNIA

GOLDEN WEST COLLEGE
HUNTINGTON BEACH, CALIFORNIA
ORANGE COAST JUNIOR COLLEGE DISTRICT

UN I T	G	JOB NO.	100-1
I N T E R I O R		DATE	11 MAY 1966
D E L E V A T I O N S		SCALE	1:100,000

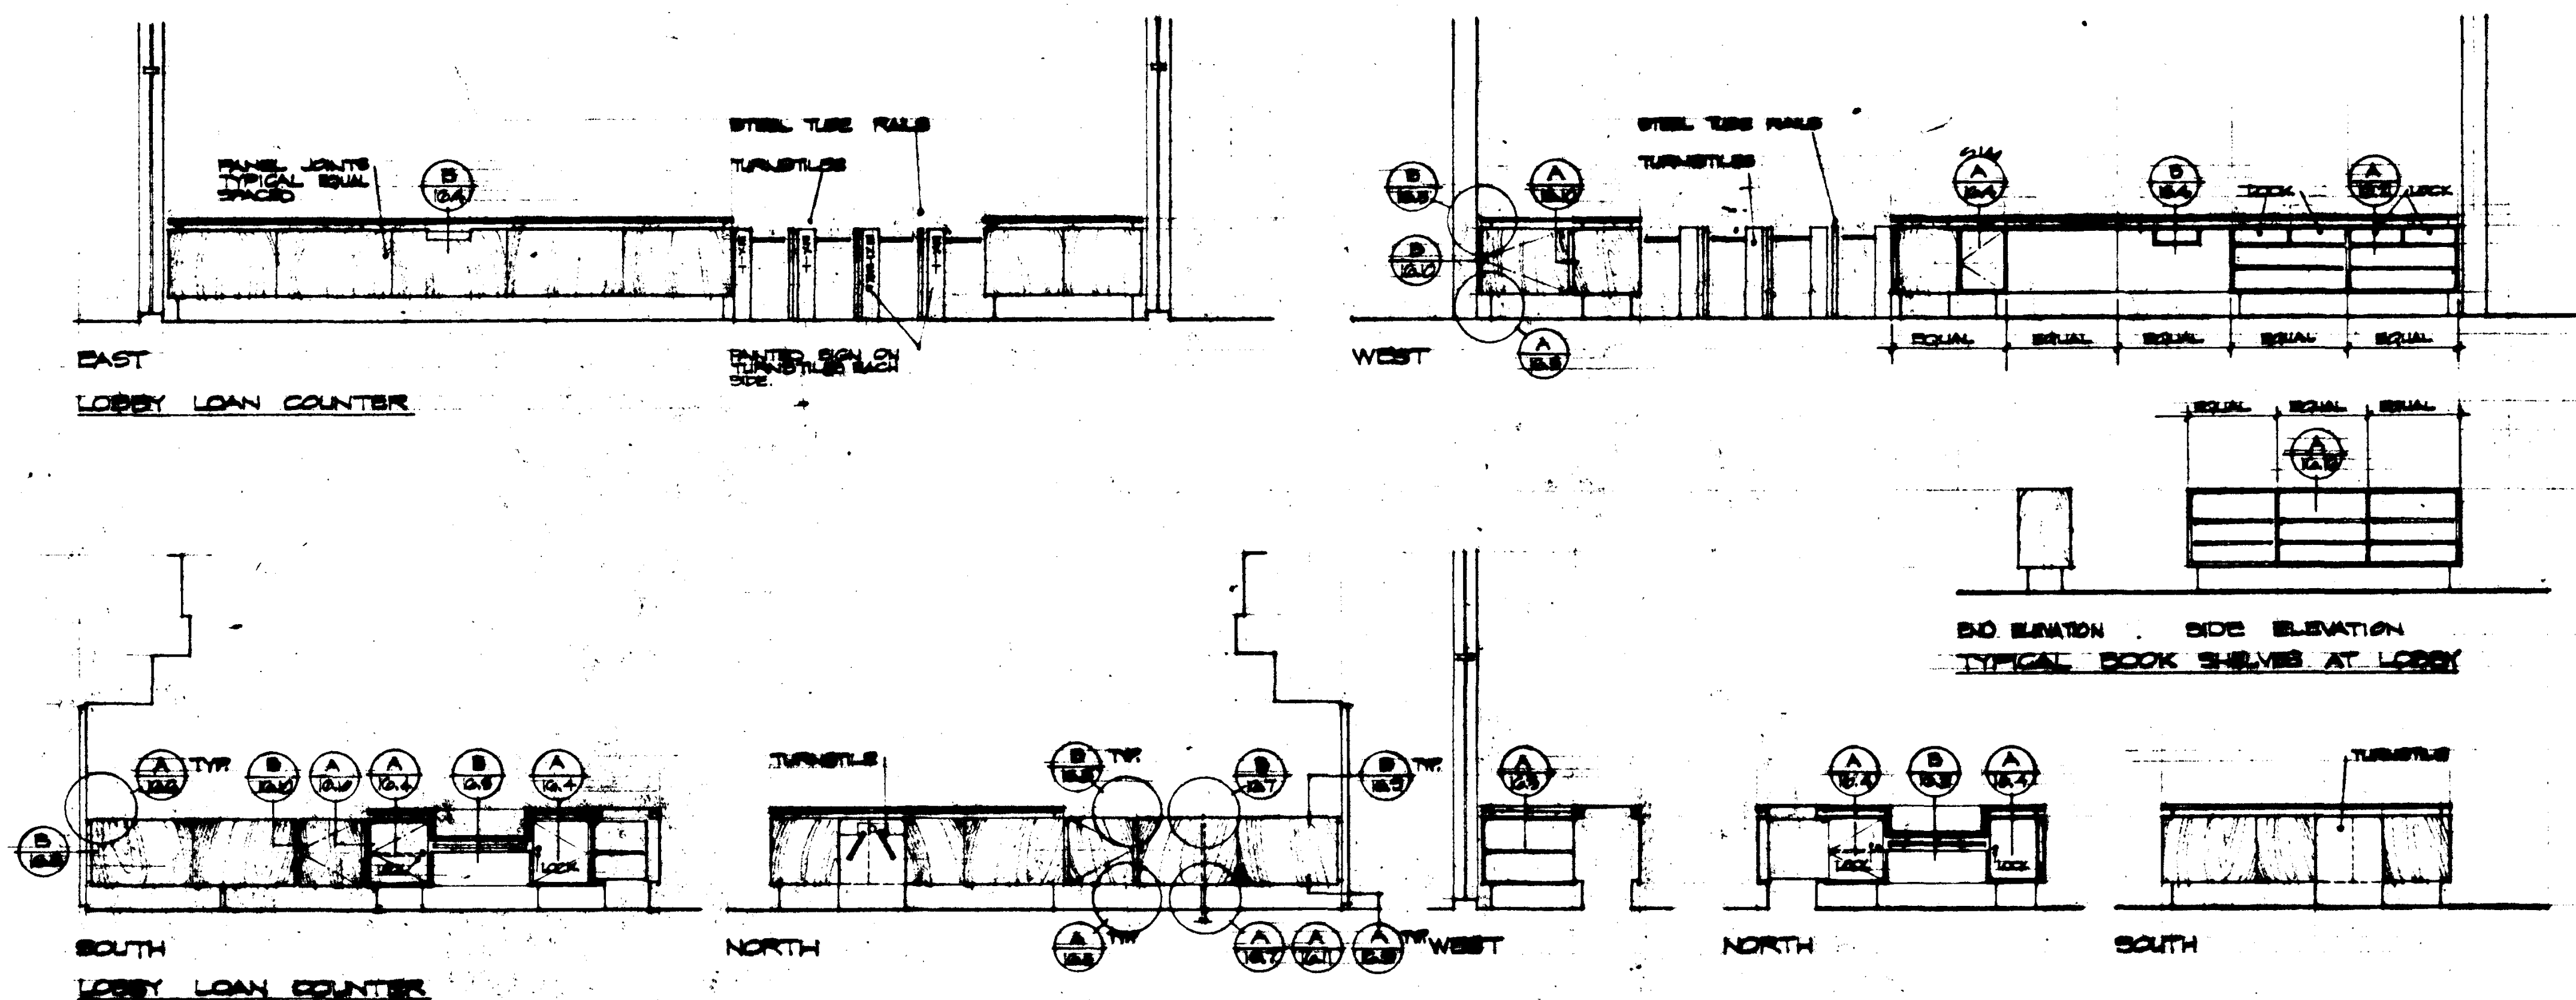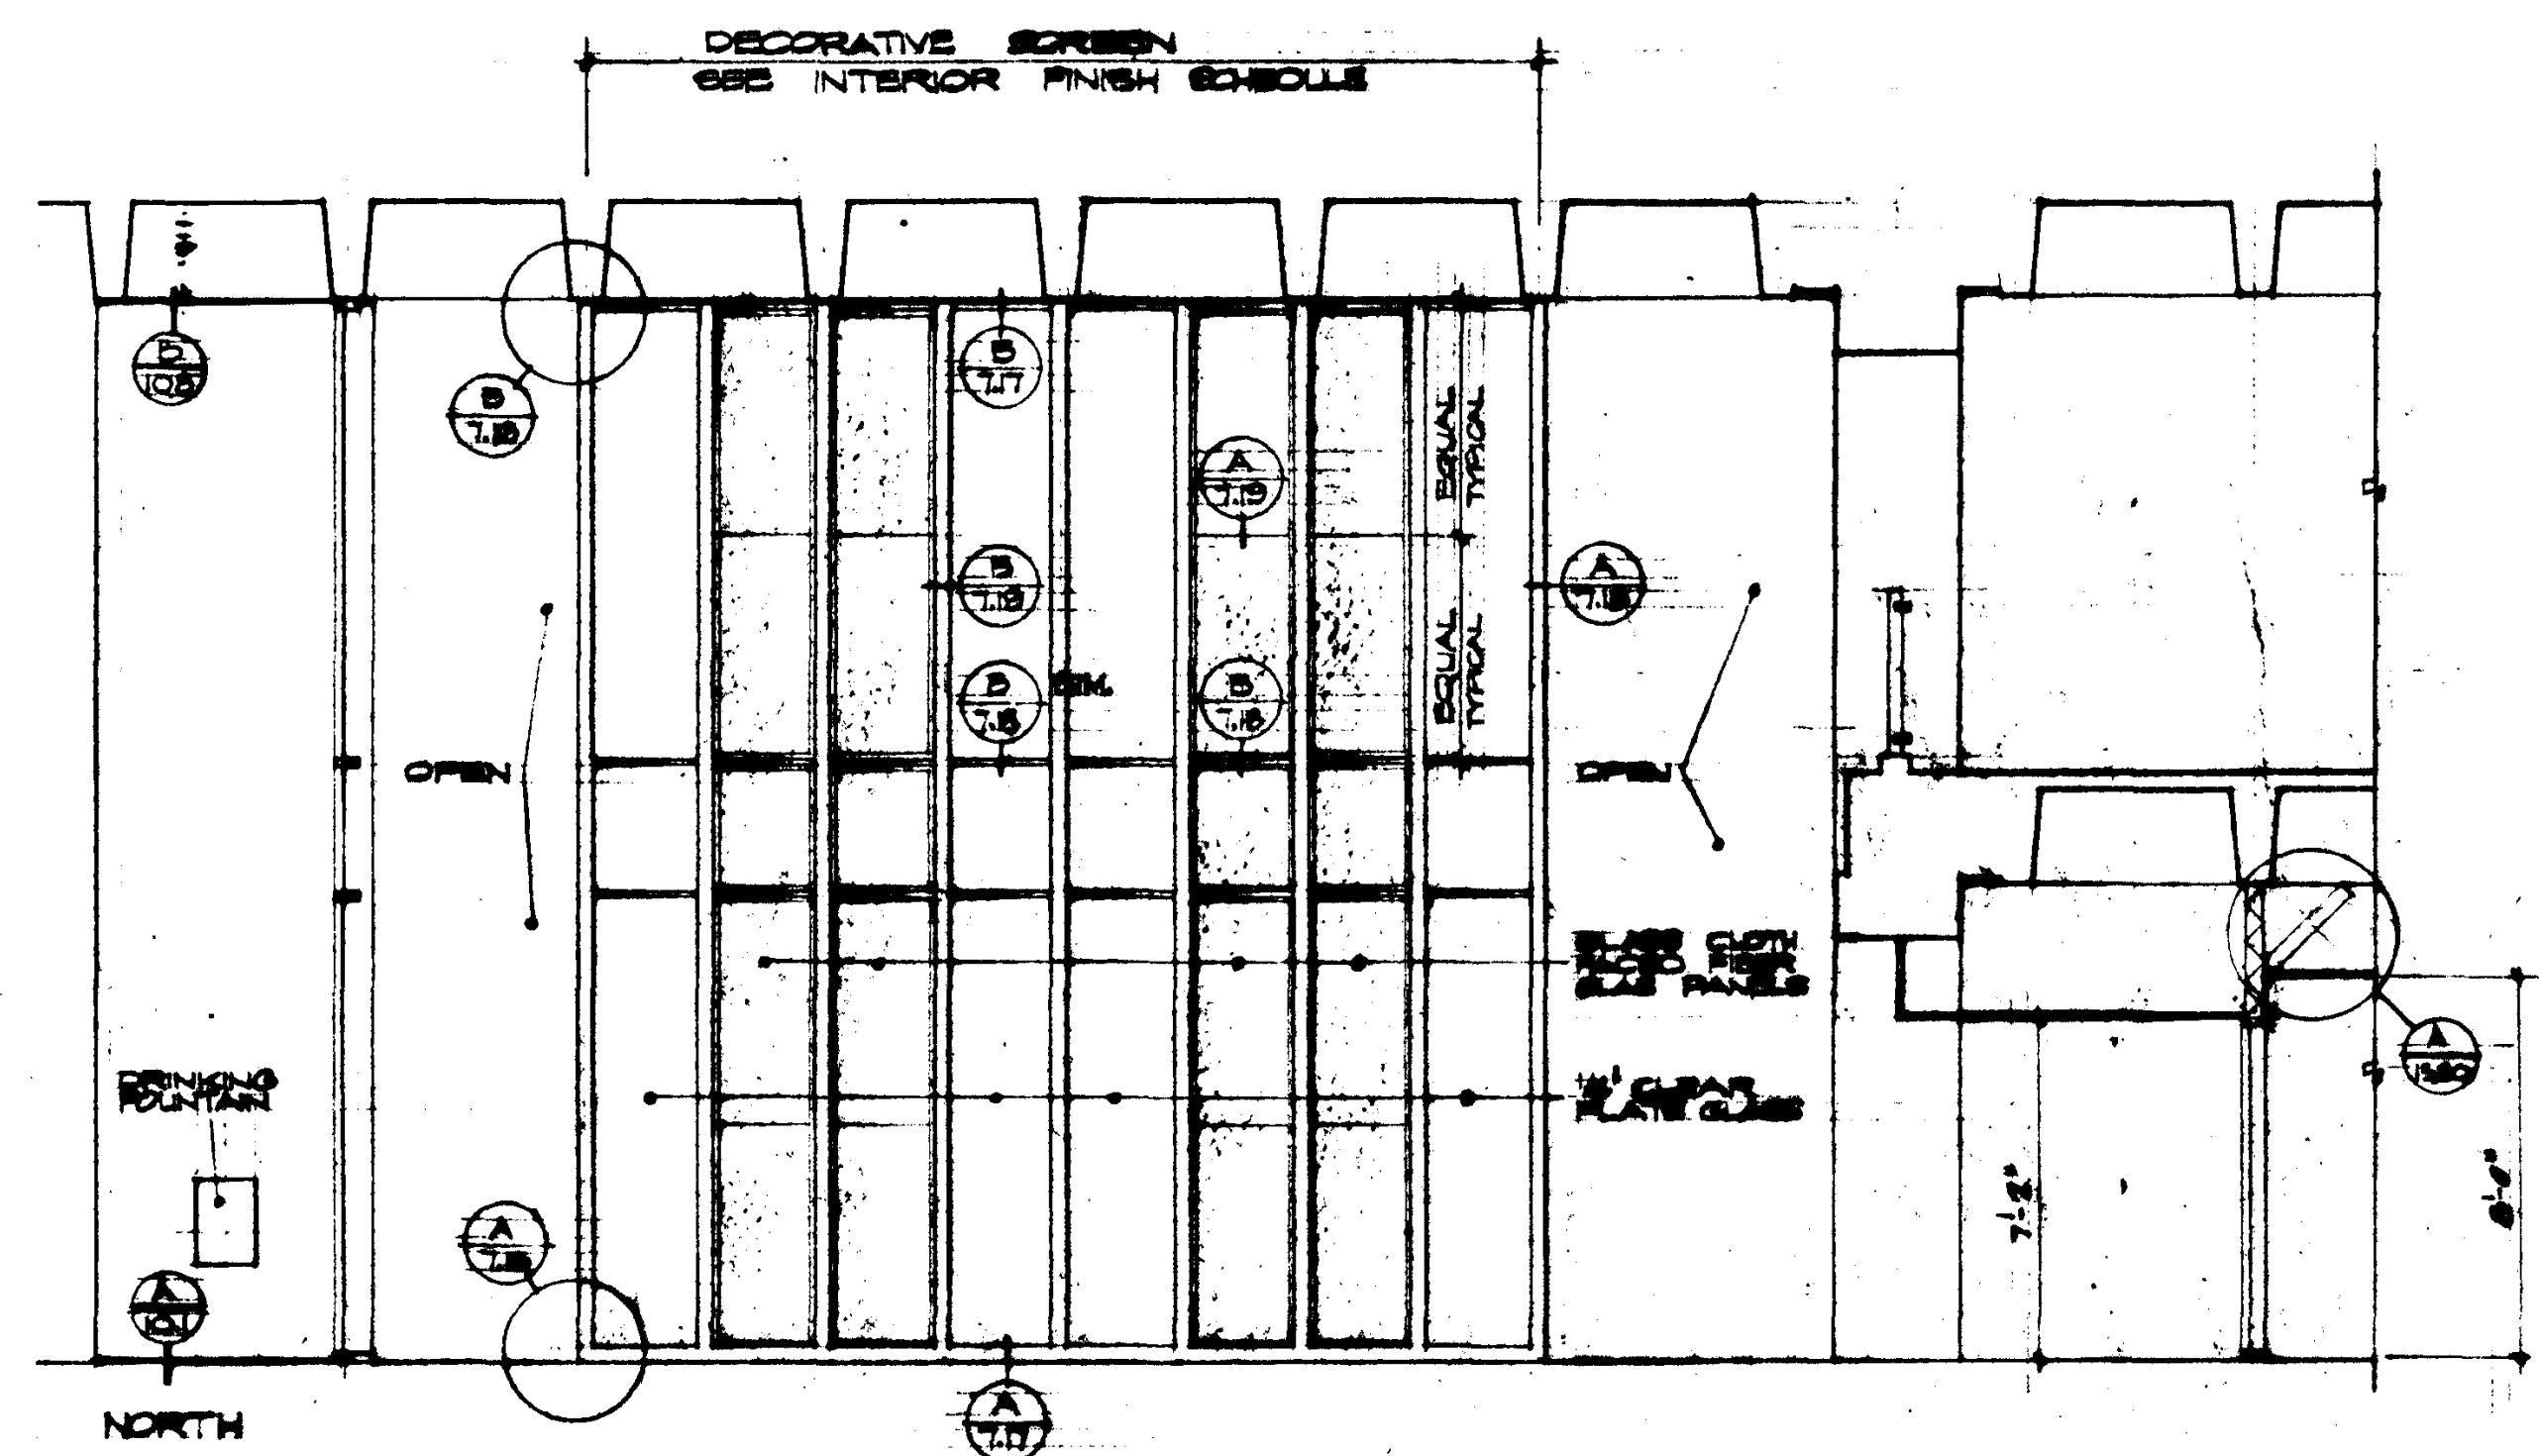


LOBBY 101

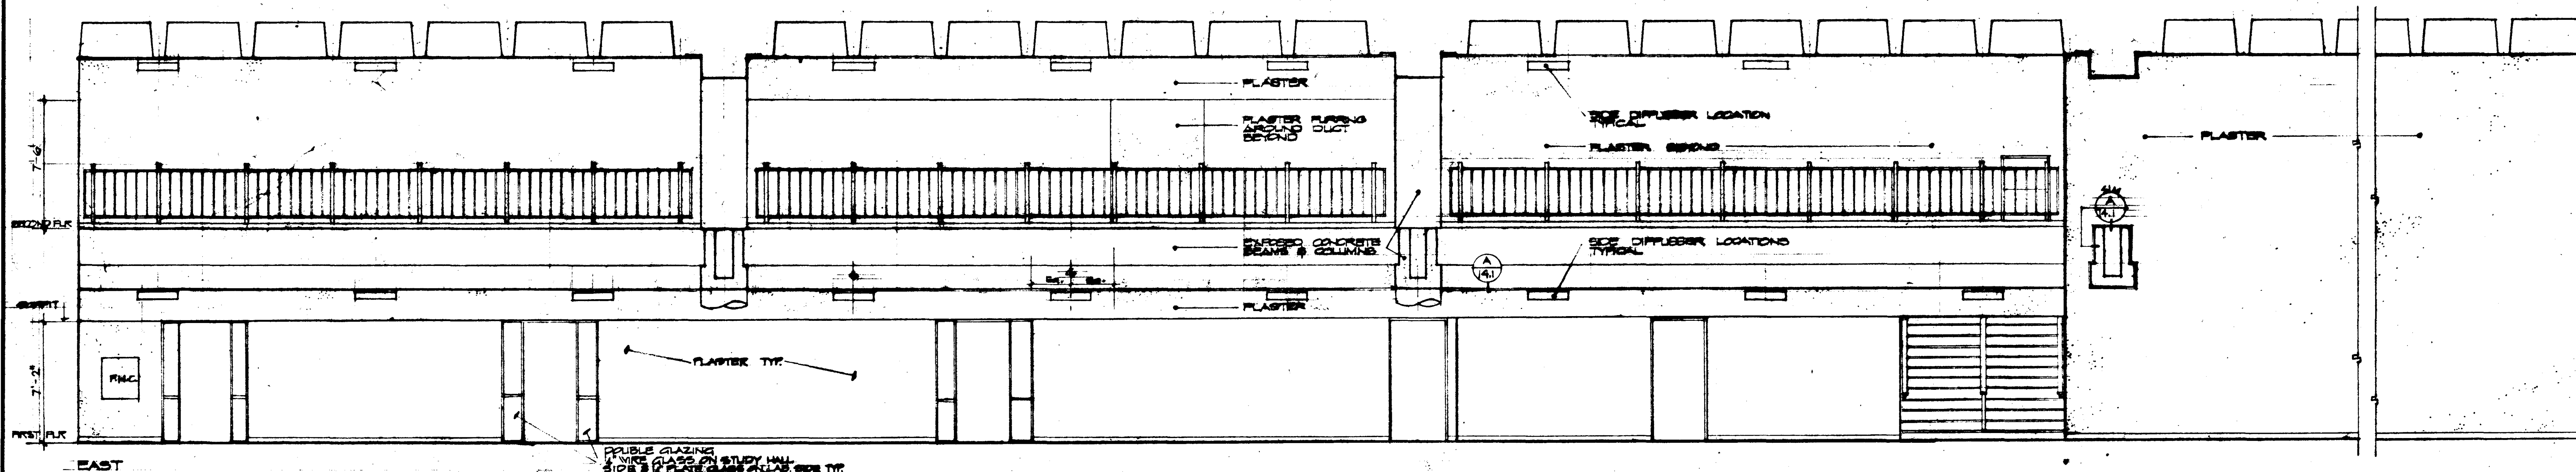


STUDY HALL 123

LOBBY Δ 101


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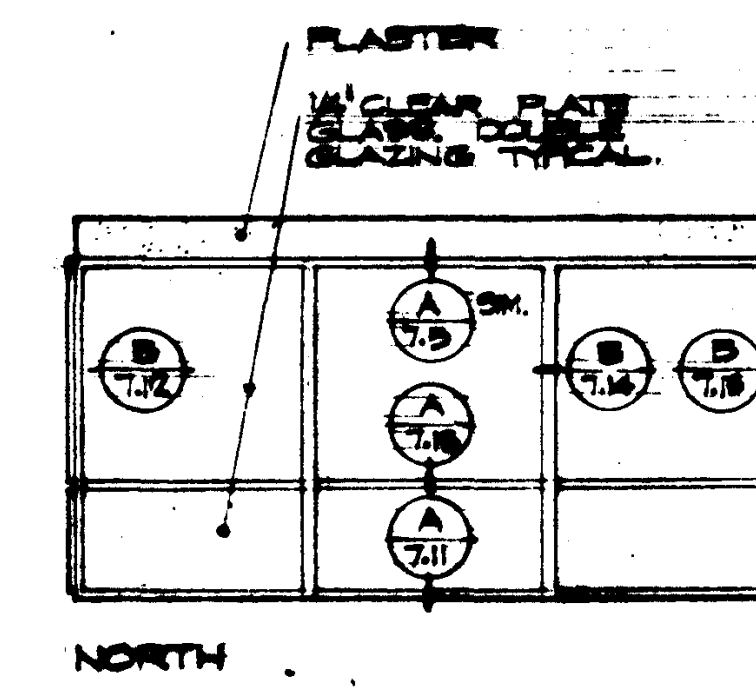
OFFICE 103

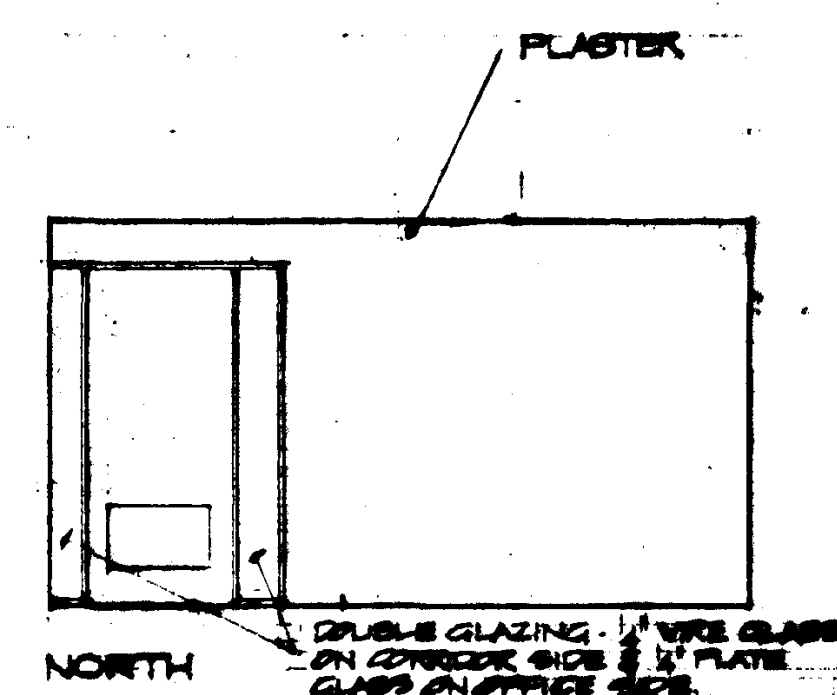

TOILET 105

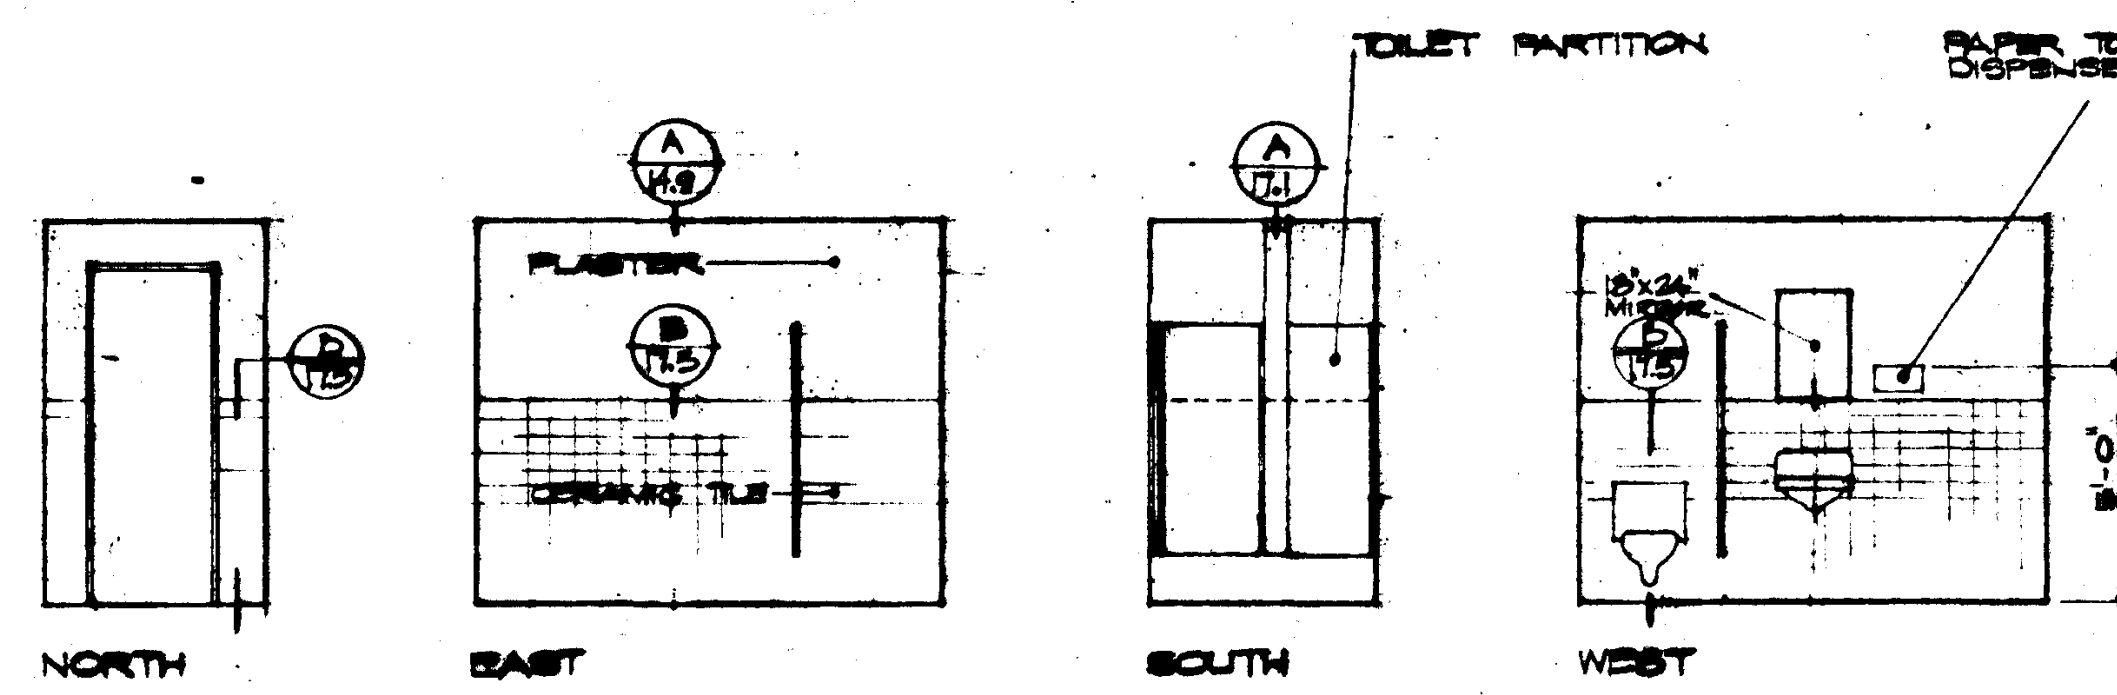


OFFICE Δ 107

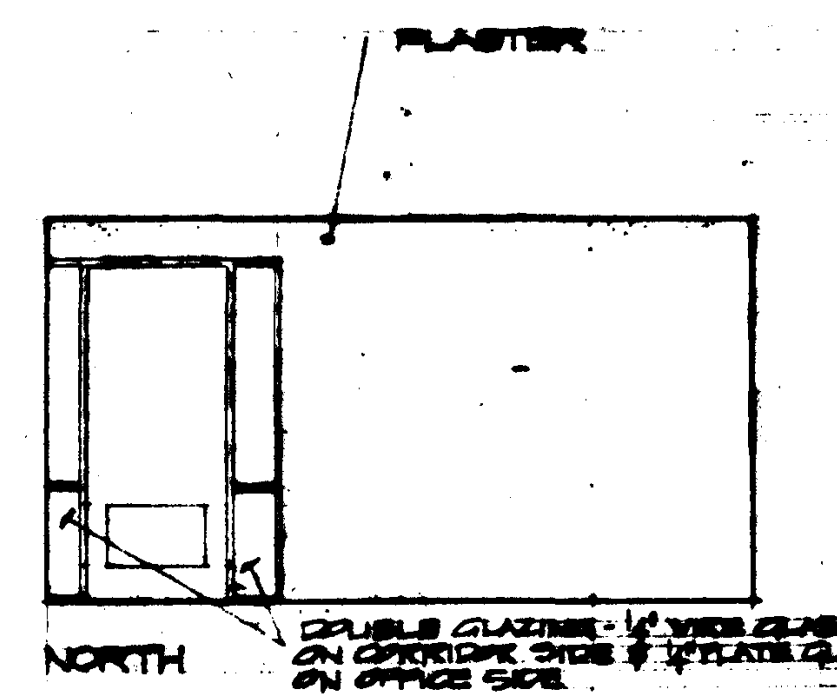


TYPING 108


1	7/26/65	MM	SEE ADDENDUM NO. 2, TURN 2	STRUCTURAL ENGINEERS BEARDOW & JOHNSTON J.A. MARTIN & ASSOCIATES	DESIGNED	ARCHITECT WILLIAM L. FERRERA & ASSOCIATES	APPROVED	ASSOCIATED ARCHITECTS: WILLIAM L. FERRERA & ASSOCIATES A. QUINCY JONES-FREDERICK E. EDMONS & ASSOCIATES BLUROCK ELLERBROCK & ASSOCIATES URBANUS SQUARE • MACARTHUR BOULEVARD AT FORD ROAD TELEPHONE 714/675-2640 • CORONA DEL MAR, CALIFORNIA	GOLDEN WEST COLLEGE HUNTINGTON BEACH; CALIFORNIA ORANGE COAST JUNIOR COLLEGE DISTRICT	UNIT 7 INTERIOR ELEVATIONS	JOB NO. 100-1 18 JUN 1965 SHEET NO. A 83
				MECHANICAL ENGINEERS RALPH E. PHILLIPS, INC.	DRAWN BY	ENGINEER	APPROVED STATE FIRE MARSHAL DATE JUN 21 1965				
				ELECTRICAL ENGINEERS RALPH E. PHILLIPS, INC.	CHECKED BY	COLLEGE	25874 APPROVED JUN 21 1965				
				CIVIL ENGINEERS G. SHUIRMAN & ASSOCIATES MOFFATT & WIGGOL							
				REVISIONS							

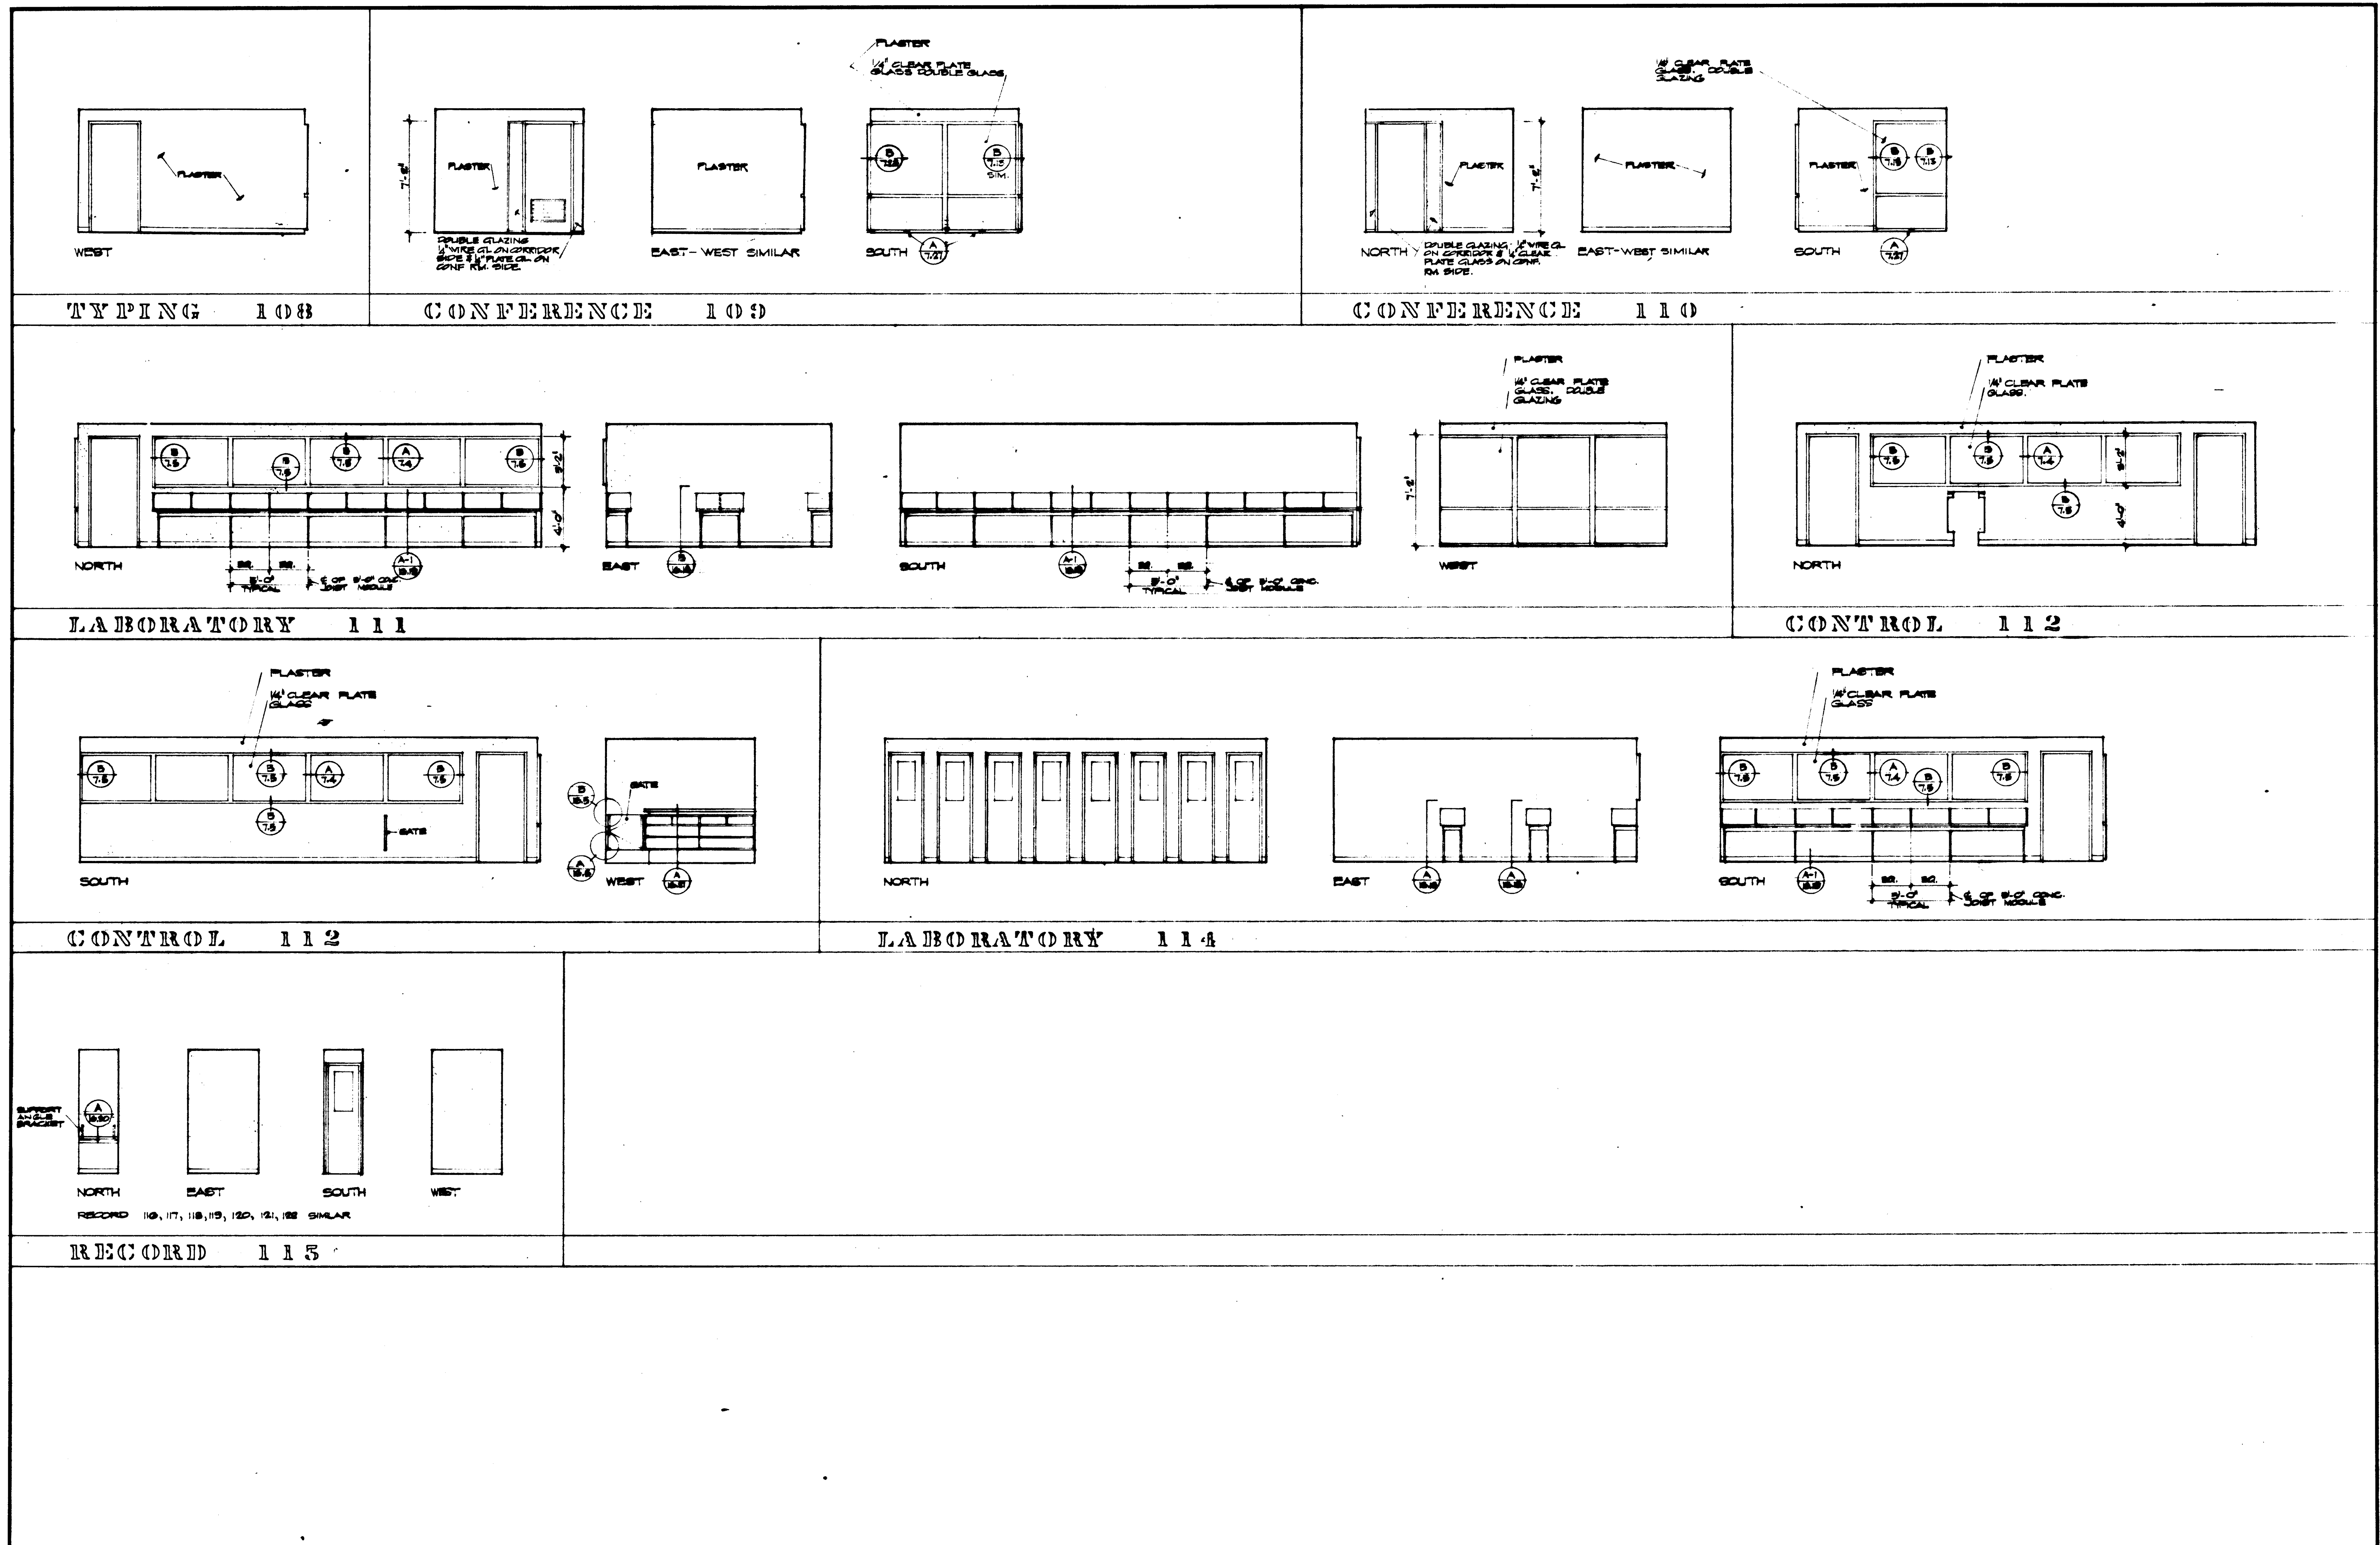


<div> <div>REVISIONS</div> <div>DATE</div> <div>BY</div> </div>	<div>STRUCTURAL ENGINEERS</div> <div>BRANDOW & JOHNSON</div> <div>J. A. MARTIN & ASSOCIATES</div> <div>MECHANICAL ENGINEERS</div> <div>RALPH E. PHILLIPS, INC.</div> <div>ELECTRICAL ENGINEERS</div> <div>RALPH E. PHILLIPS, INC.</div> <div>CIVIL ENGINEERS</div> <div>G. SHUIMAN & ASSOCIATES</div> <div>MOFFATT & NICKOL</div>	<div>DESIGNED</div> <div>DRAWN BY</div> <div>CHECKED BY</div>	<div>ARCHITECT</div> <div>ENGINEER</div> <div>COLLEGE</div>	<div>APPROVED</div> <div>STATE FIRE MARSHAL</div> <div>DATE JUN 21 1965</div> <div>25874</div>	<div>ASSOCIATED ARCHITECTS:</div> <div>WILLIAM L. PEREIRA & ASSOCIATES</div> <div>A. QUINCY JONES-FREDERICK E. EMMONS & ASSOCIATES</div> <div>BLURCK ELLERBROEK & ASSOCIATES</div> <div>URBANUS SQUARE • MACARTHUR BOULEVARD AT FORD ROAD</div> <div>TELEPHONE 714/675-2640 • CORONA DEL MAR, CALIFORNIA</div>	<div>GOLDEN WEST COLLEGE</div> <div>HUNTINGTON BEACH, CALIFORNIA</div> <div>ORANGE COAST JUNIOR COLLEGE DISTRICT</div>	<div>UNIT 7</div> <div>INTERIOR</div> <div>ELEVATIONS</div>	<div>JOB NO. 1004</div> <div>DATE 15</div> <div>SHEET NO. A 83.100</div>
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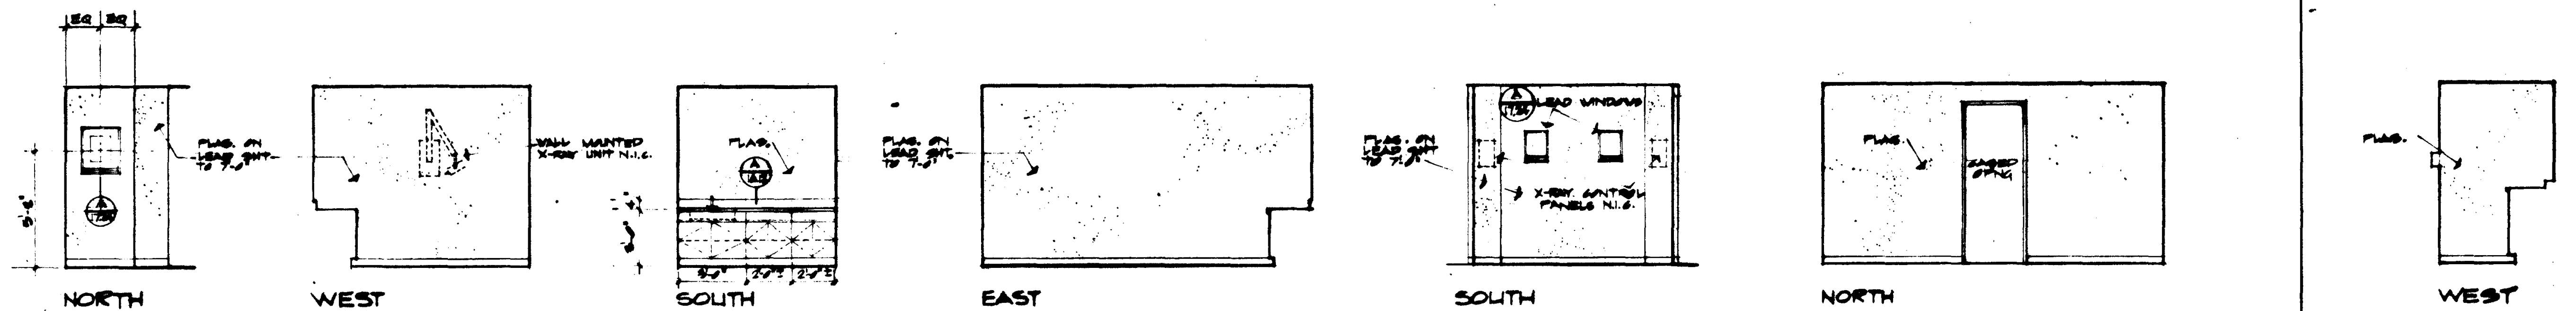
DARK RM. 127 PARK ELEV. 129, 130, SIMILAR

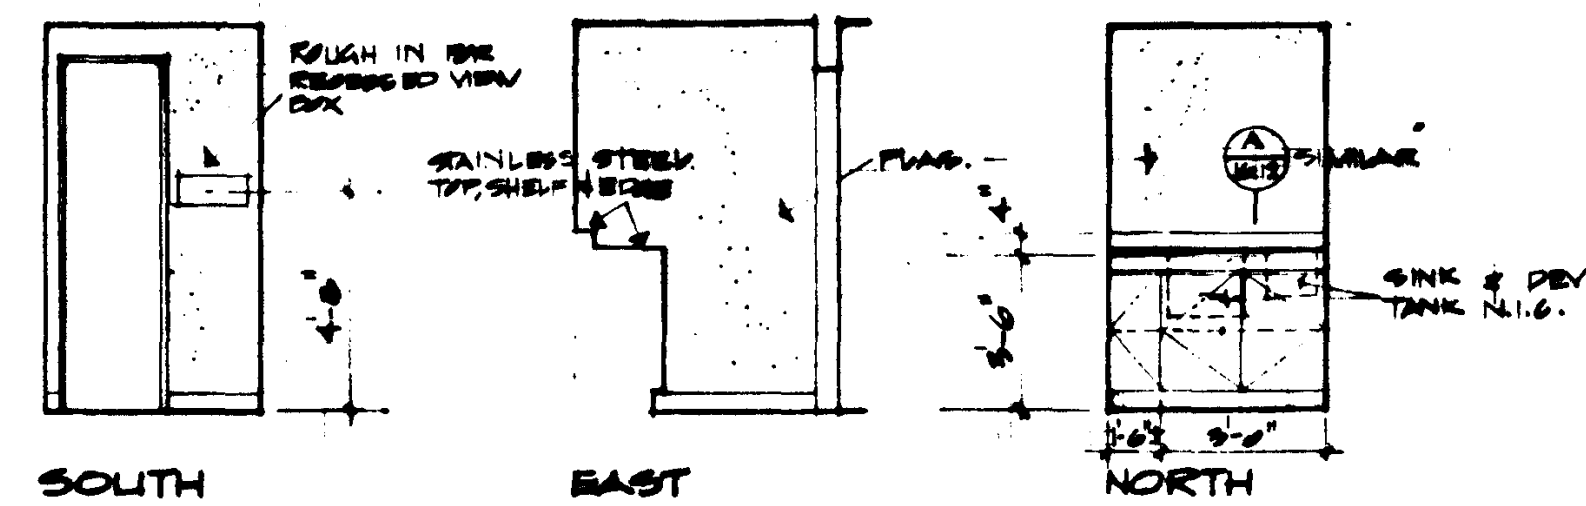

LECTURE 124

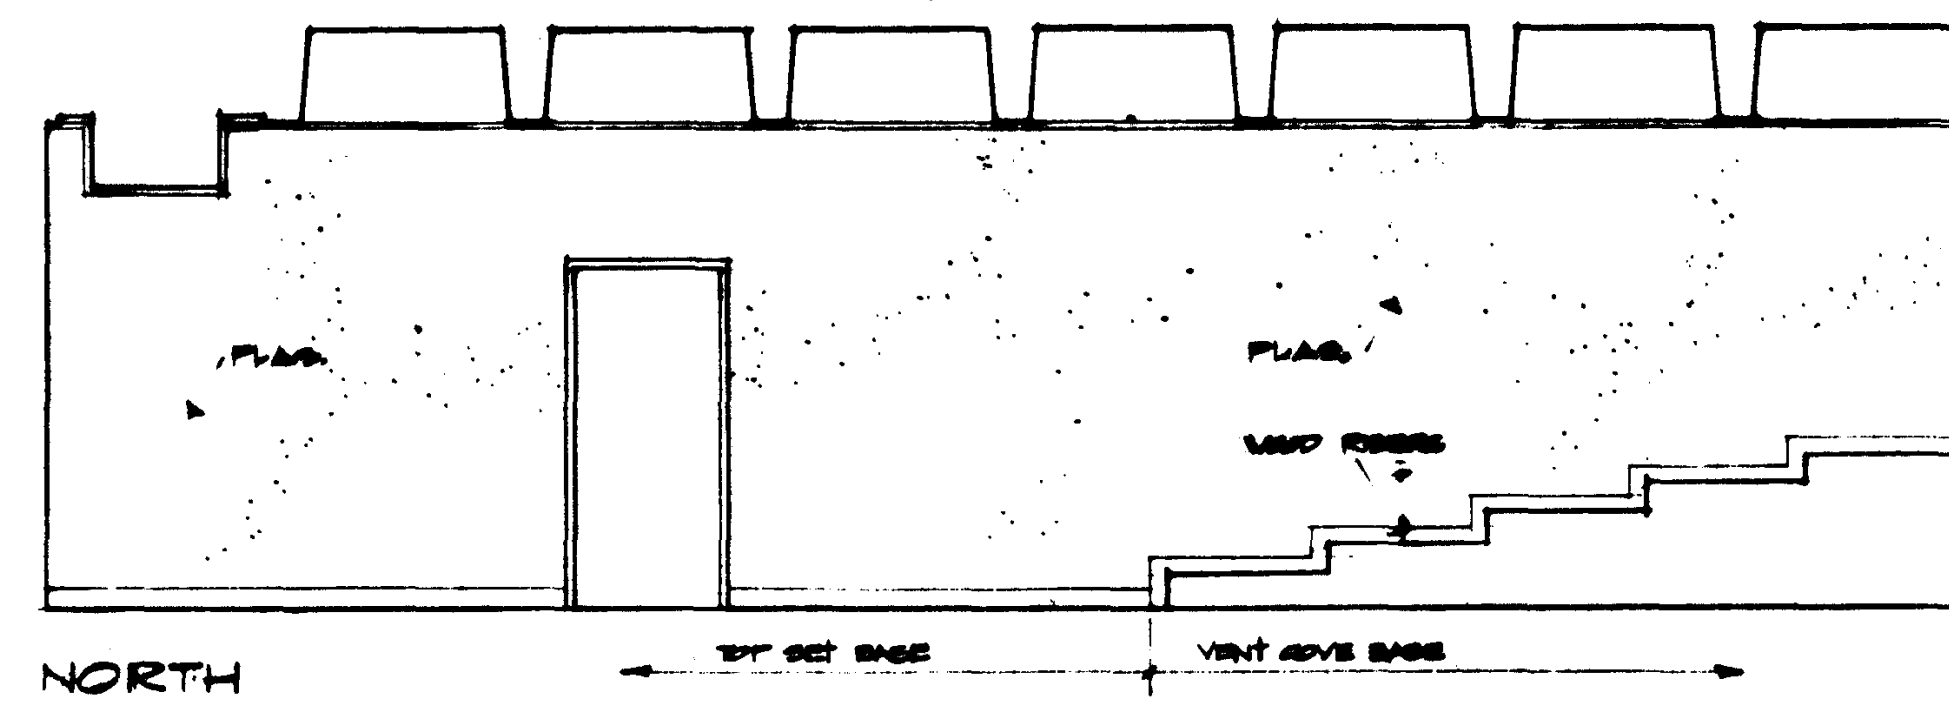


ART 112 WEST ELEV. OF ART 112 IS IDENTICAL

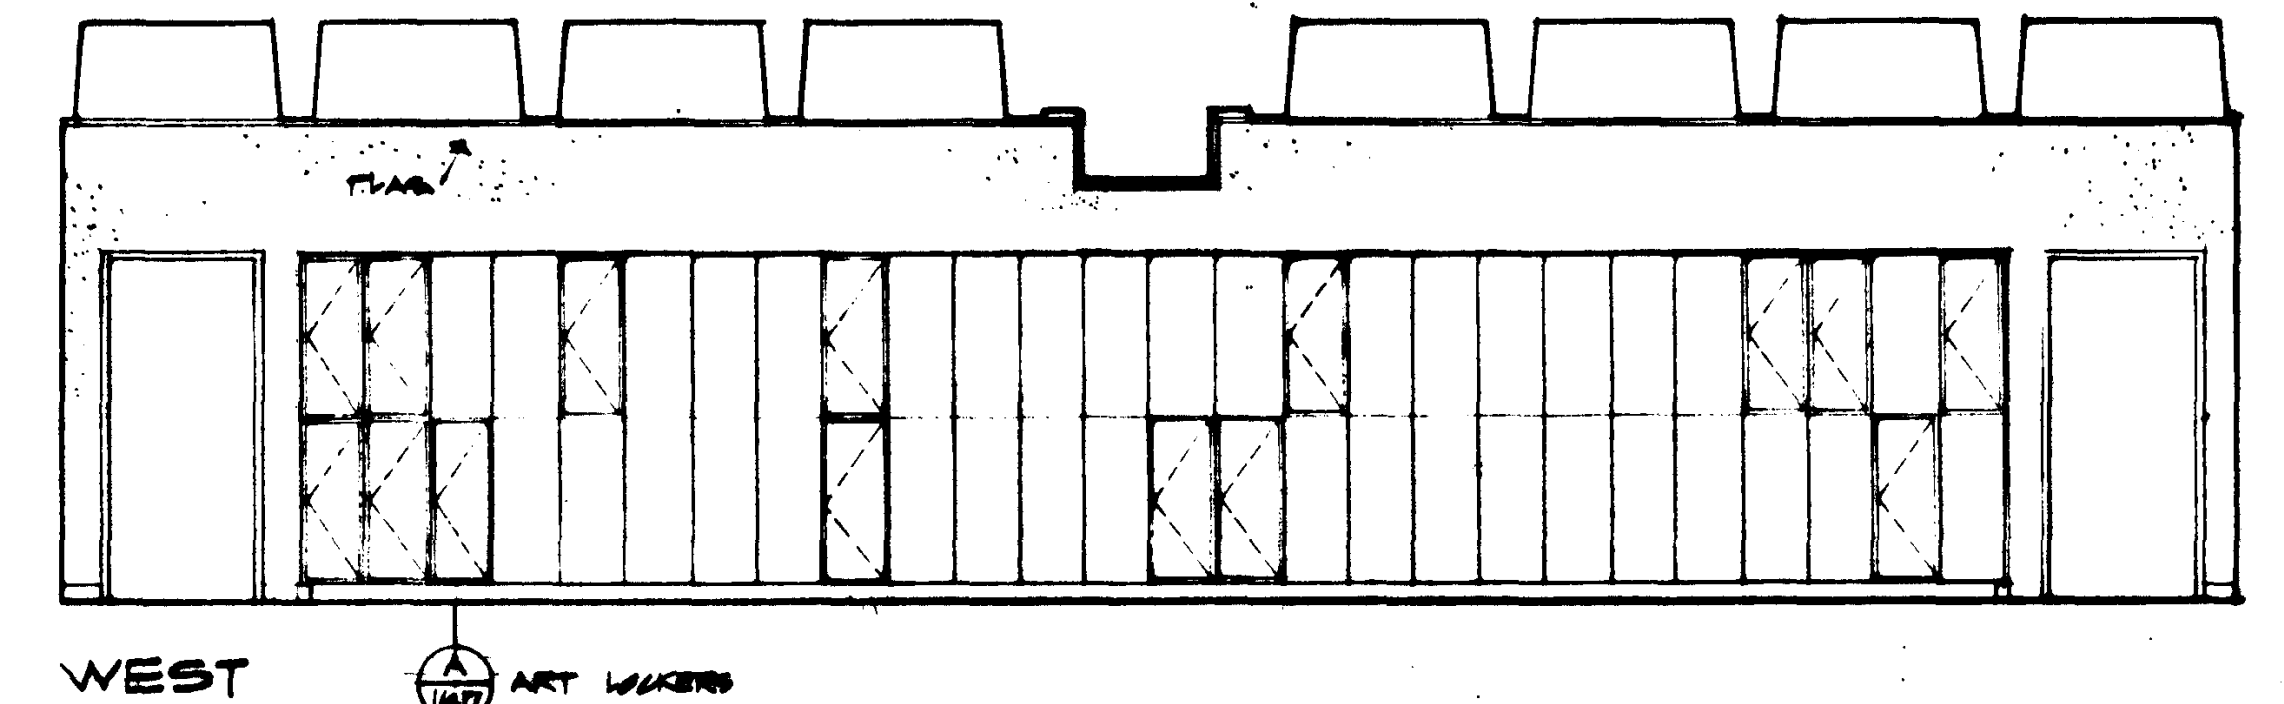


X-RAY 130 X-RAY 131 IDENTICAL


RM. 127

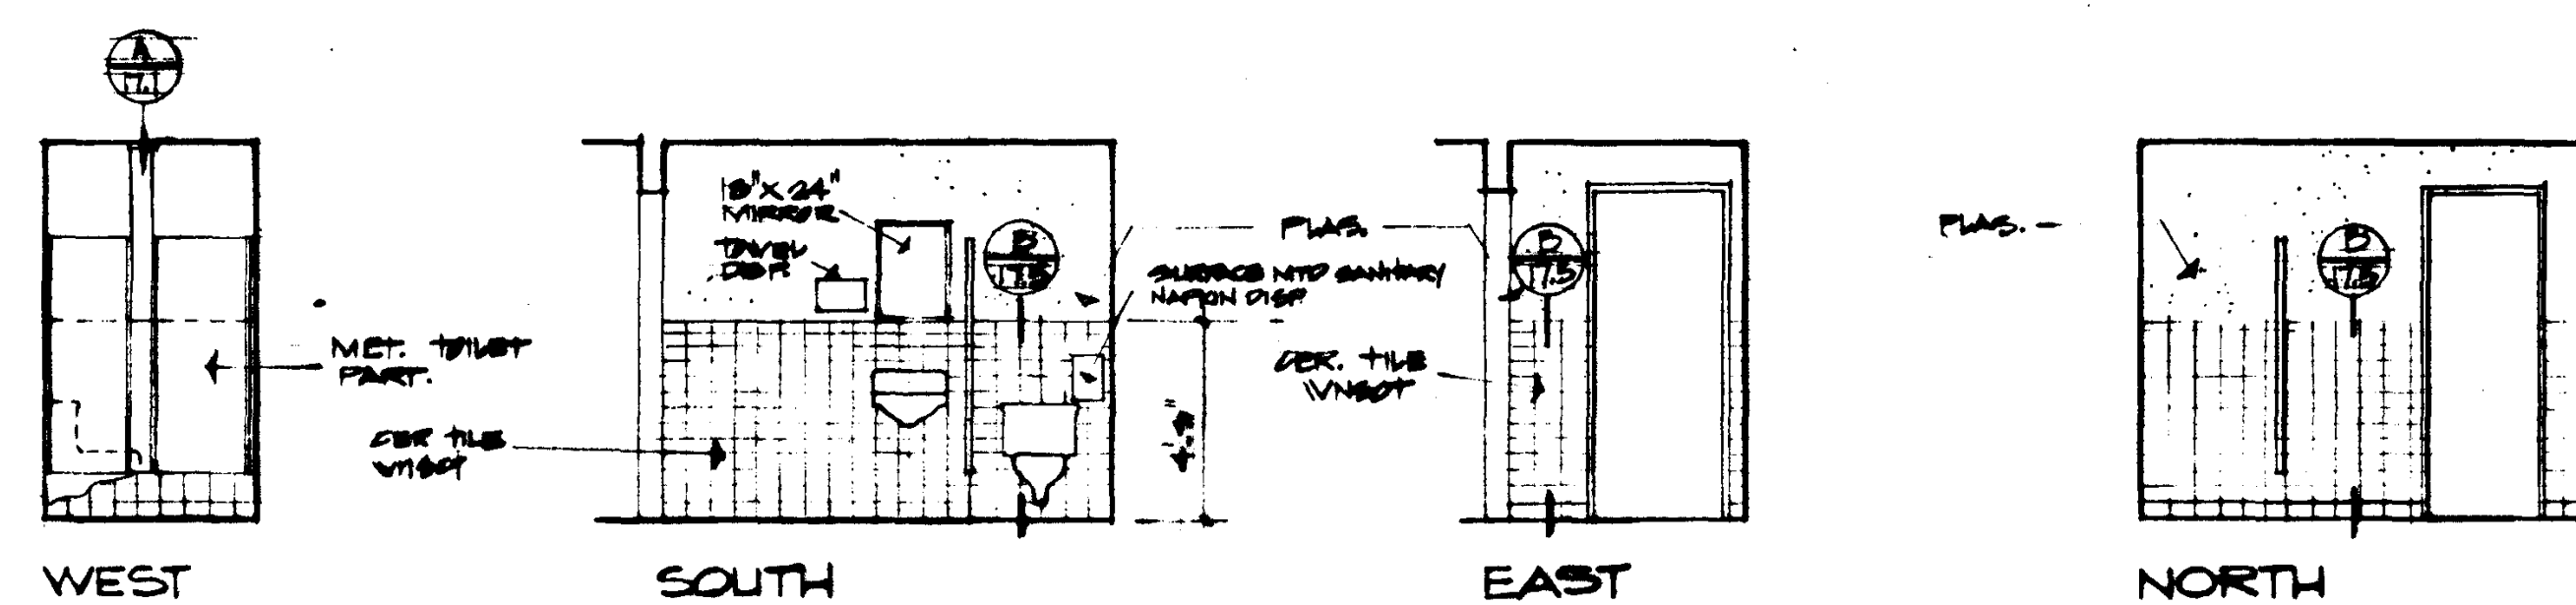


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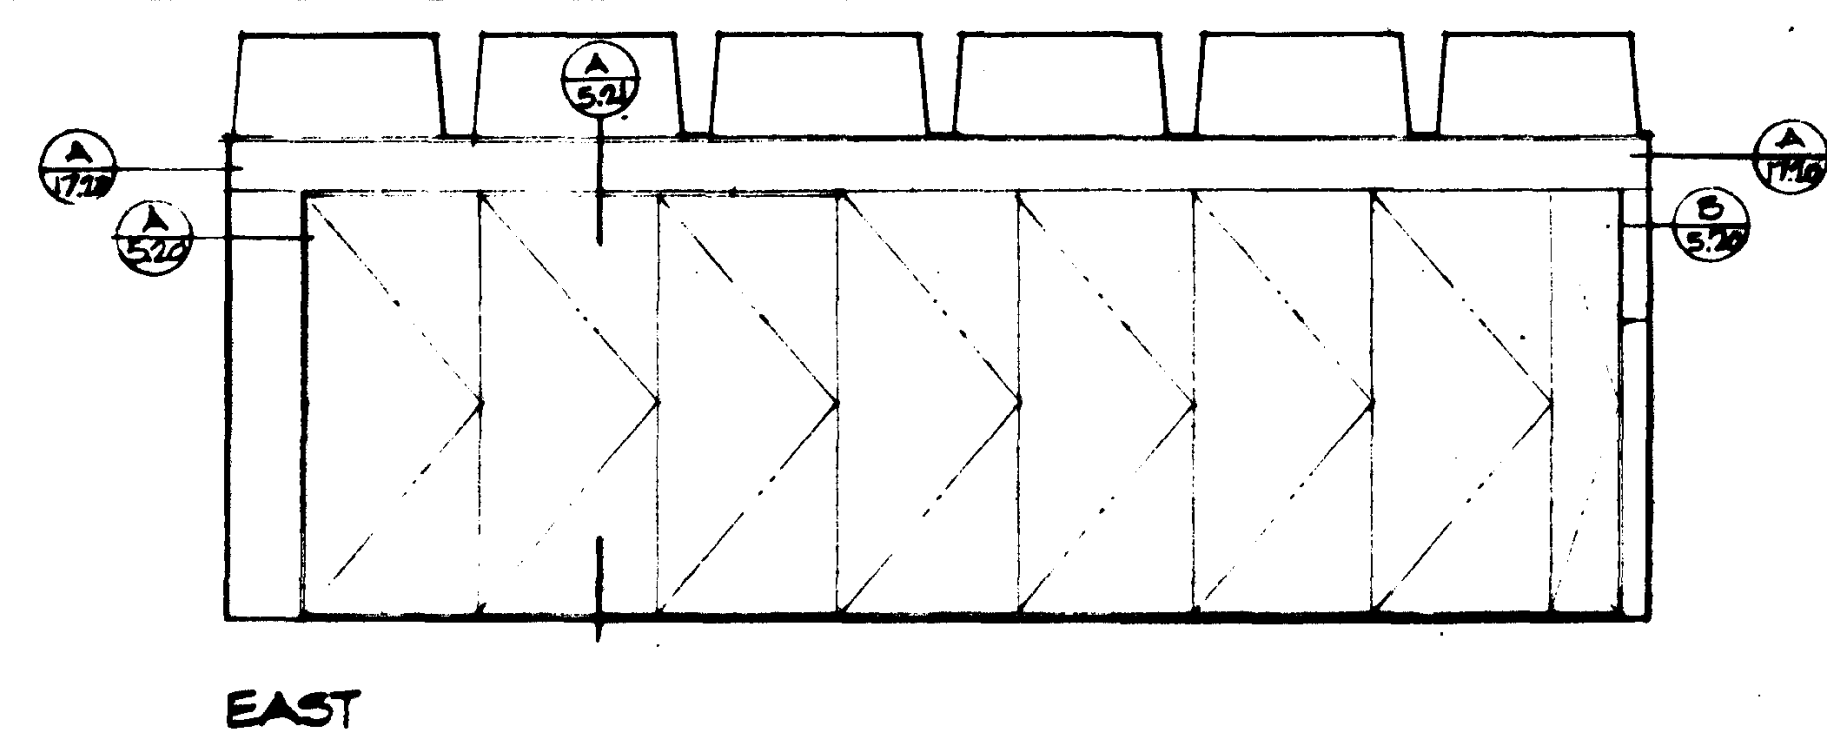
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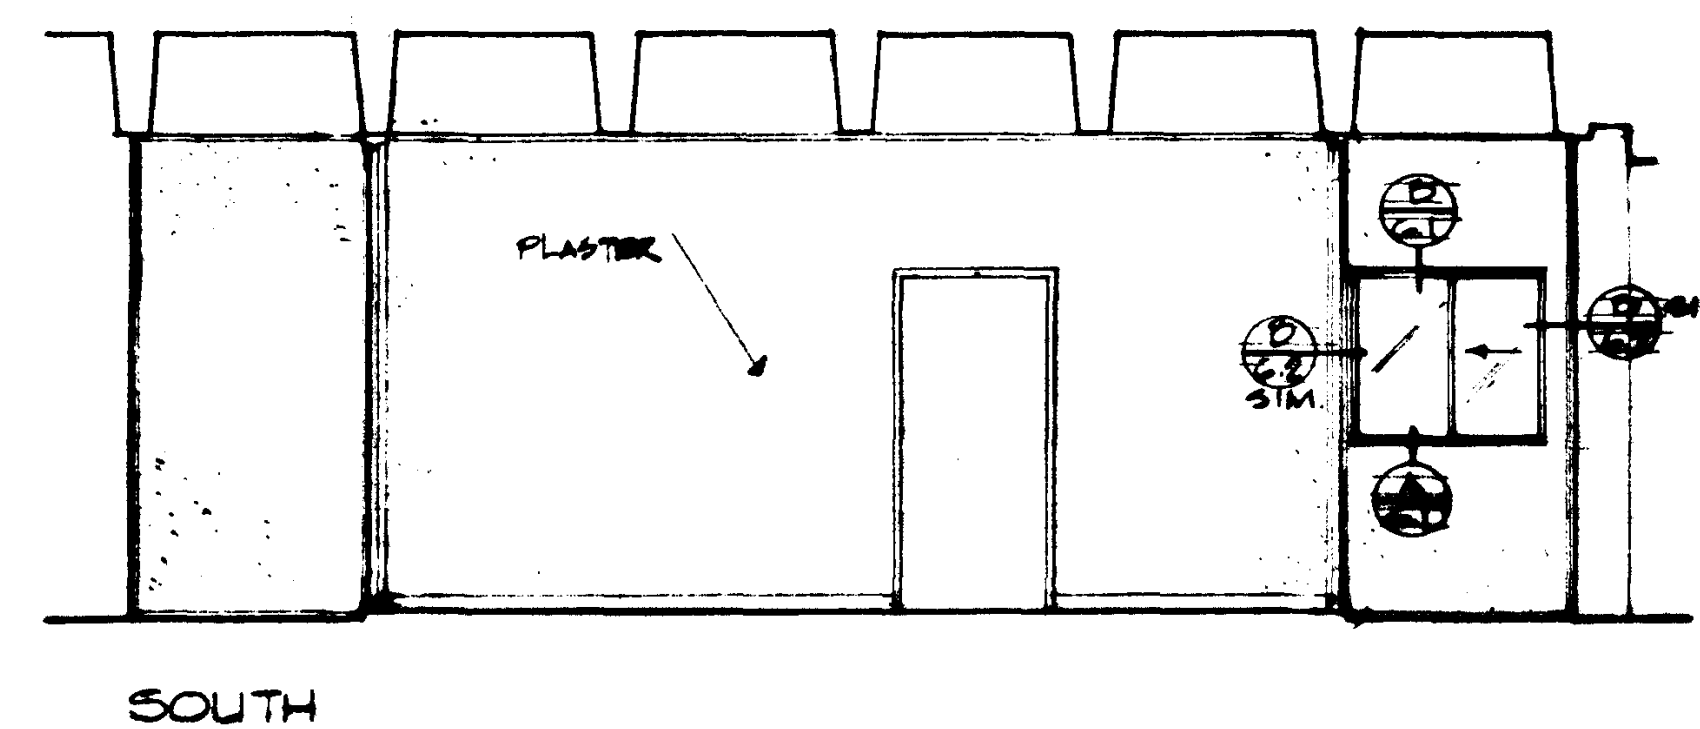
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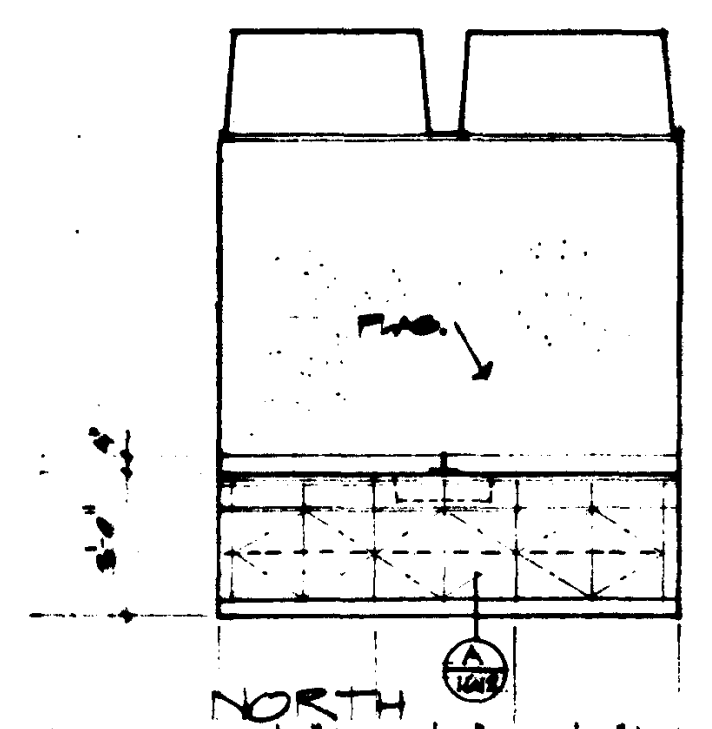
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LAB. 113 LABS 114, 123, 124 SIMILAR

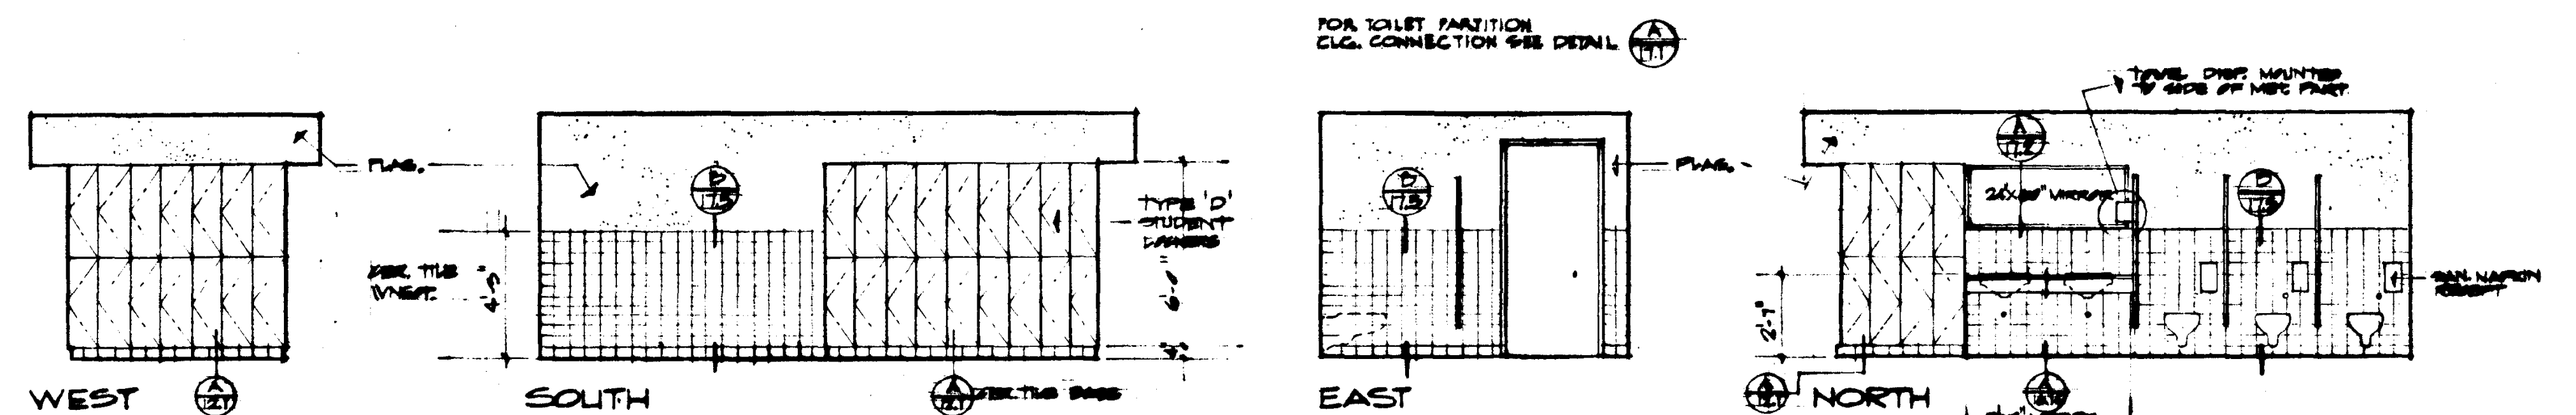


LOBBY 101

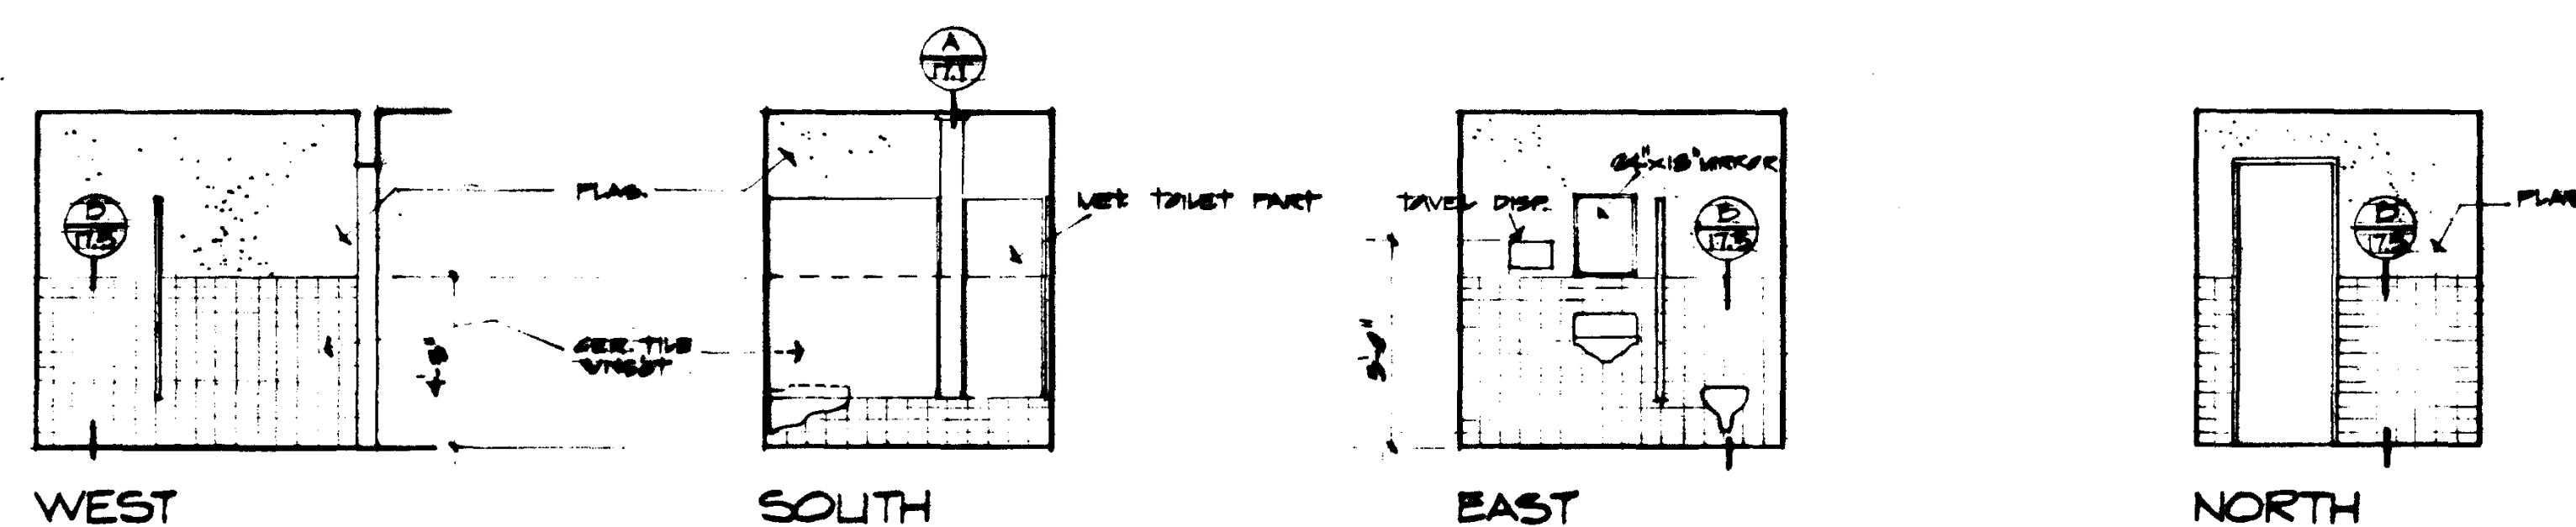


CONF. 106
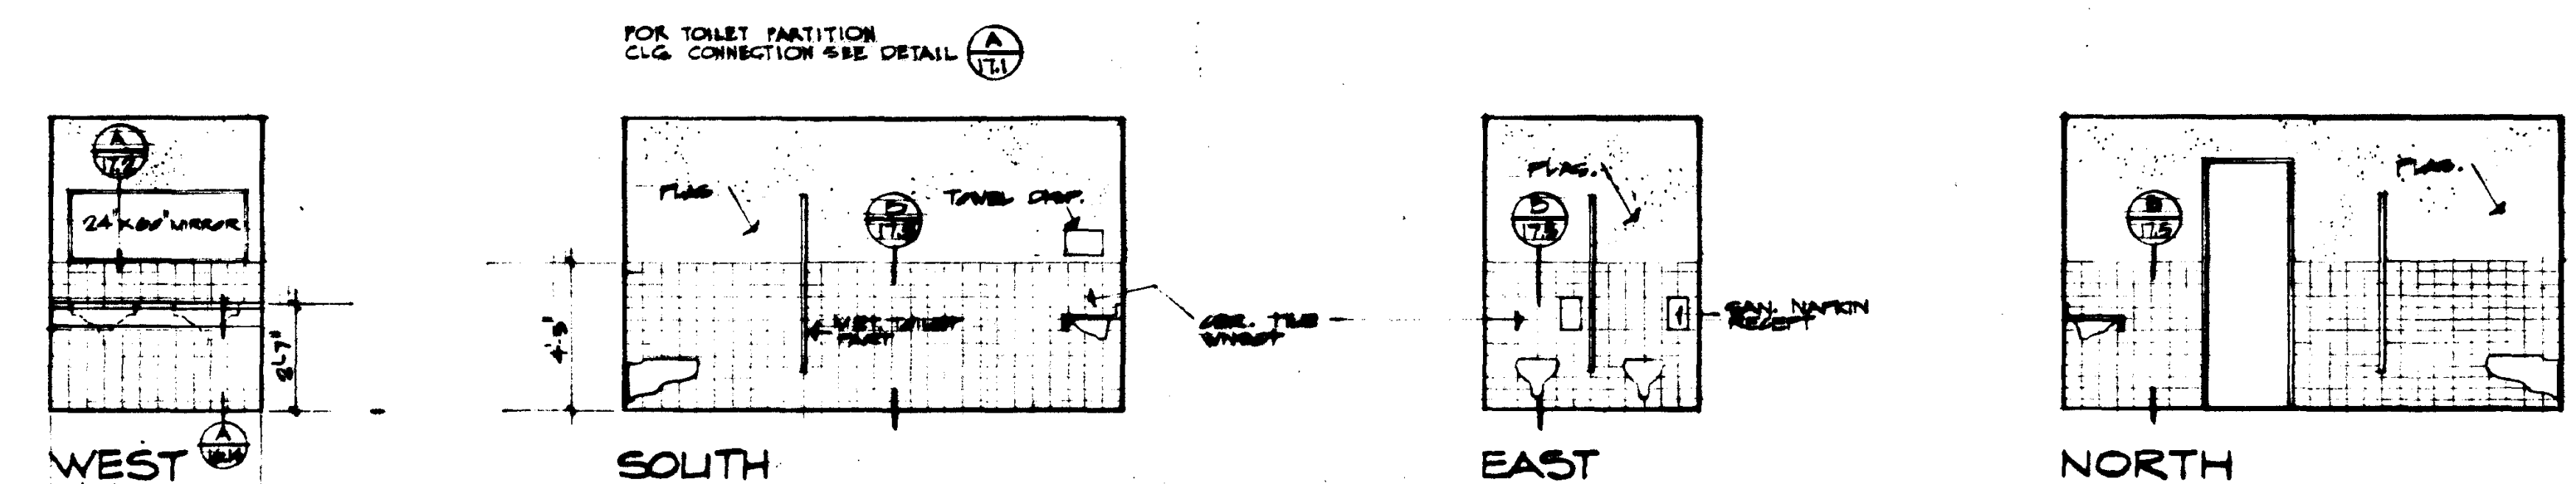
<div> <div>REVISIONS</div> <div> <div>DATE</div> <div>BY</div> </div> </div>	<div> <div>STRUCTURAL ENGINEERS</div> <div>BRANDOW & JOHNSTON</div> <div>J.A. MARTIN & ASSOCIATES</div> <div>MECHANICAL ENGINEERS</div> <div>RALPH E. PHILLIPS, INC.</div> <div>ELECTRICAL ENGINEERS</div> <div>RALPH E. PHILLIPS, INC.</div> <div>CIVIL ENGINEERS</div> <div>G. SHURMAN & ASSOCIATES</div> <div>ROFFATT & NICHOL</div> </div>	<div> <div>DESIGNED</div> <div>BY</div> <div> <div>ARCHITECT</div> <div>WILLIAM L. PEREIRA & ASSOCIATES</div> </div> </div>	<div> <div>APPROVED</div> <div>STATE FIRE MARSHAL</div> <div>STATE OF CALIFORNIA</div> <div>DATE JUN 1 1957</div> </div>	<div> <div>APPROVED</div> <div>STATE FIRE MARSHAL</div> <div>STATE OF CALIFORNIA</div> <div>DATE JUN 1 1957</div> </div>	<div> <div>ASSOCIATED ARCHITECTS:</div> <div>WILLIAM L. PEREIRA & ASSOCIATES</div> <div>QUINCY JONES-FREDERICK E. EMMONS & ASSOCIATES</div> <div>BLUROCK ELLERBROEK & ASSOCIATES</div> <div>URBANUS SQUARE • MACARTHUR BOULEVARD AT FORD ROAD</div> <div>TELEPHONE 714/675-2640 • CORONA DEL MAR, CALIFORNIA</div> </div>	<div> <div>GOLDEN WEST COLLEGE</div> <div>HUNTINGTON BEACH, CALIFORNIA</div> <div>ORANGE COAST JUNIOR COLLEGE DISTRICT</div> </div>	<div> <div>UNIT 33a & 33b</div> <div>DATE 15 JUN 1957</div> <div>SHEET NO. A8.11</div> <div>SCALE: 1/4"</div> </div>
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WEST
LOUNGE 102

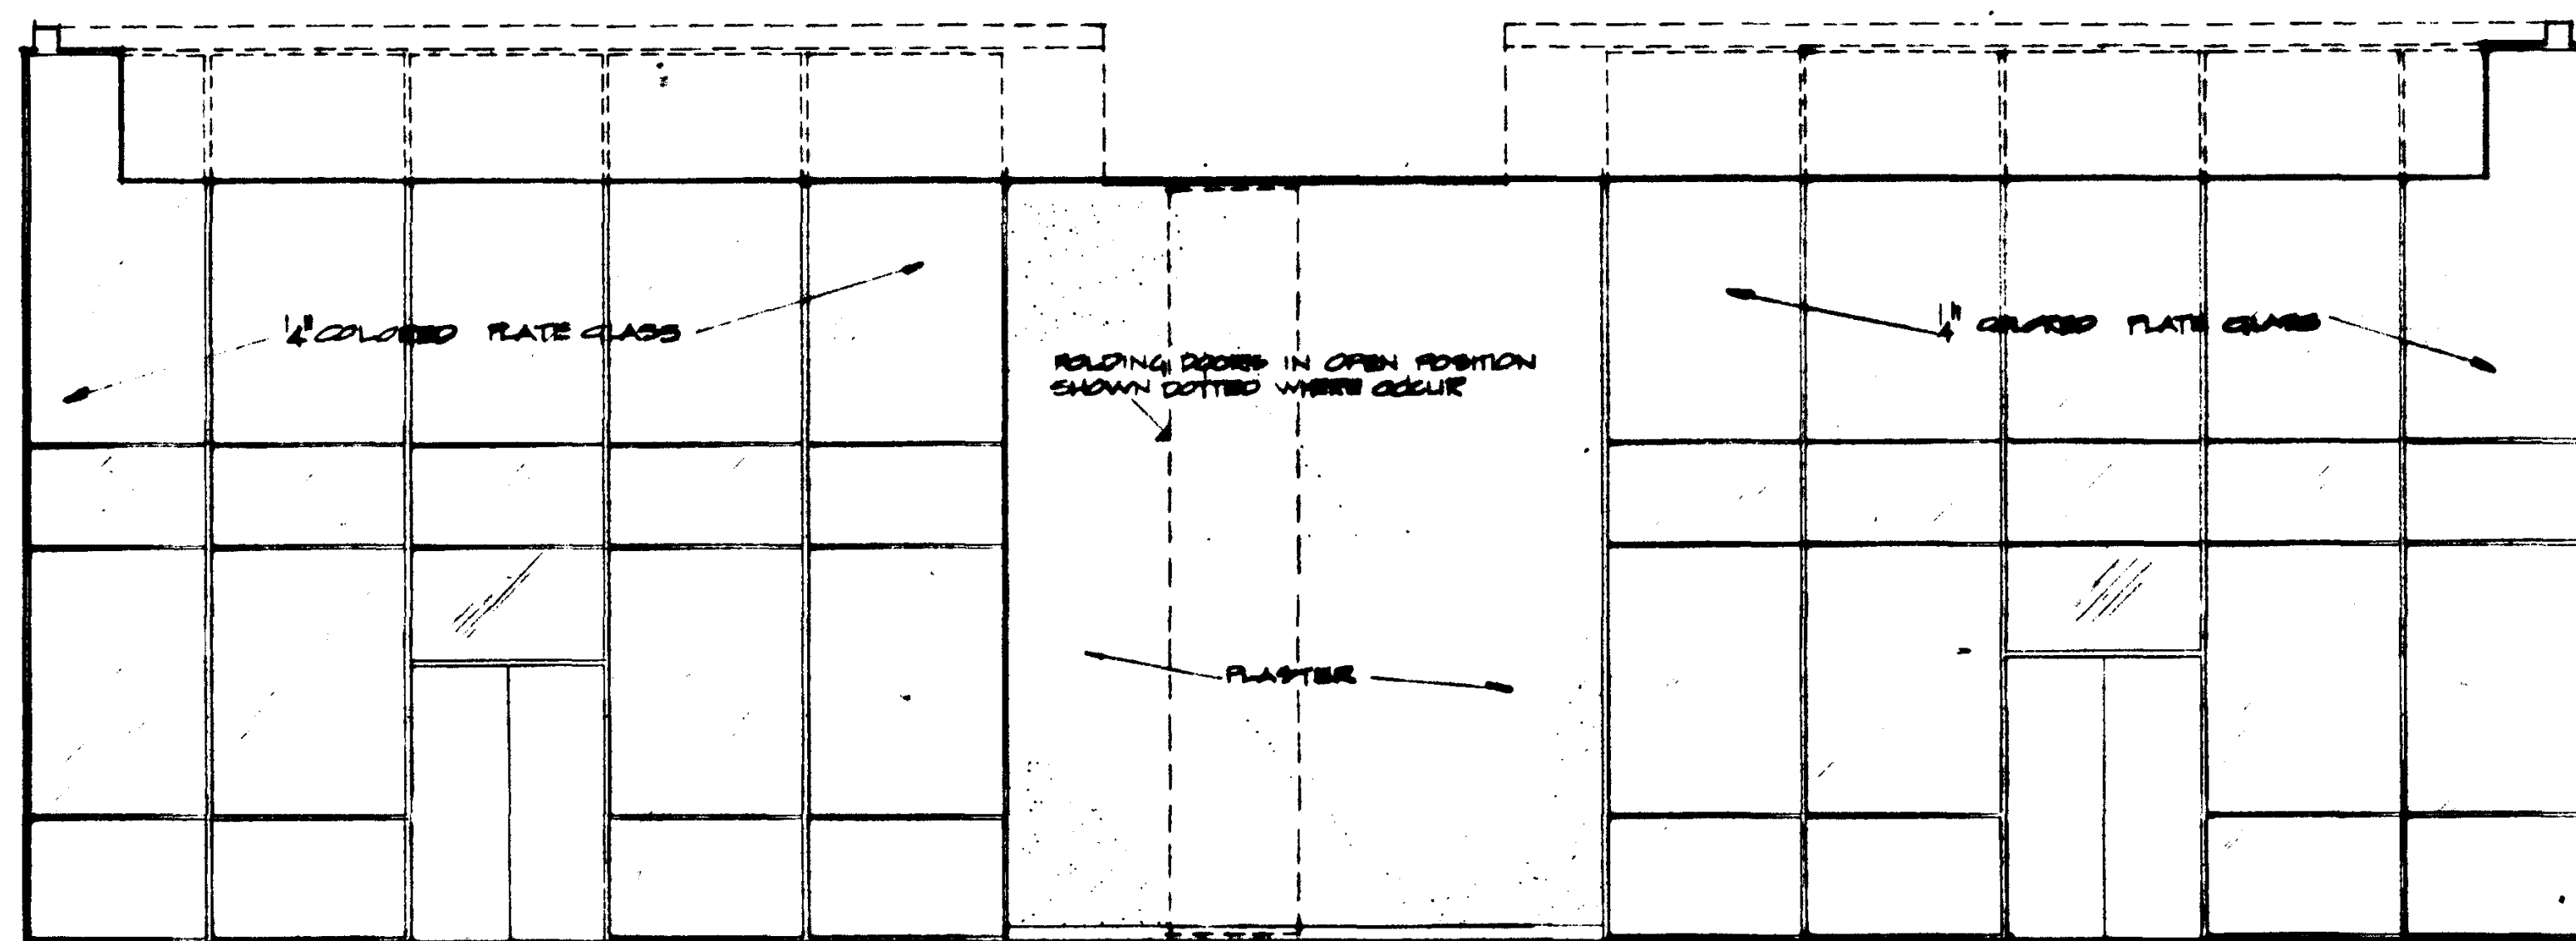FACULTY 102




NORTH

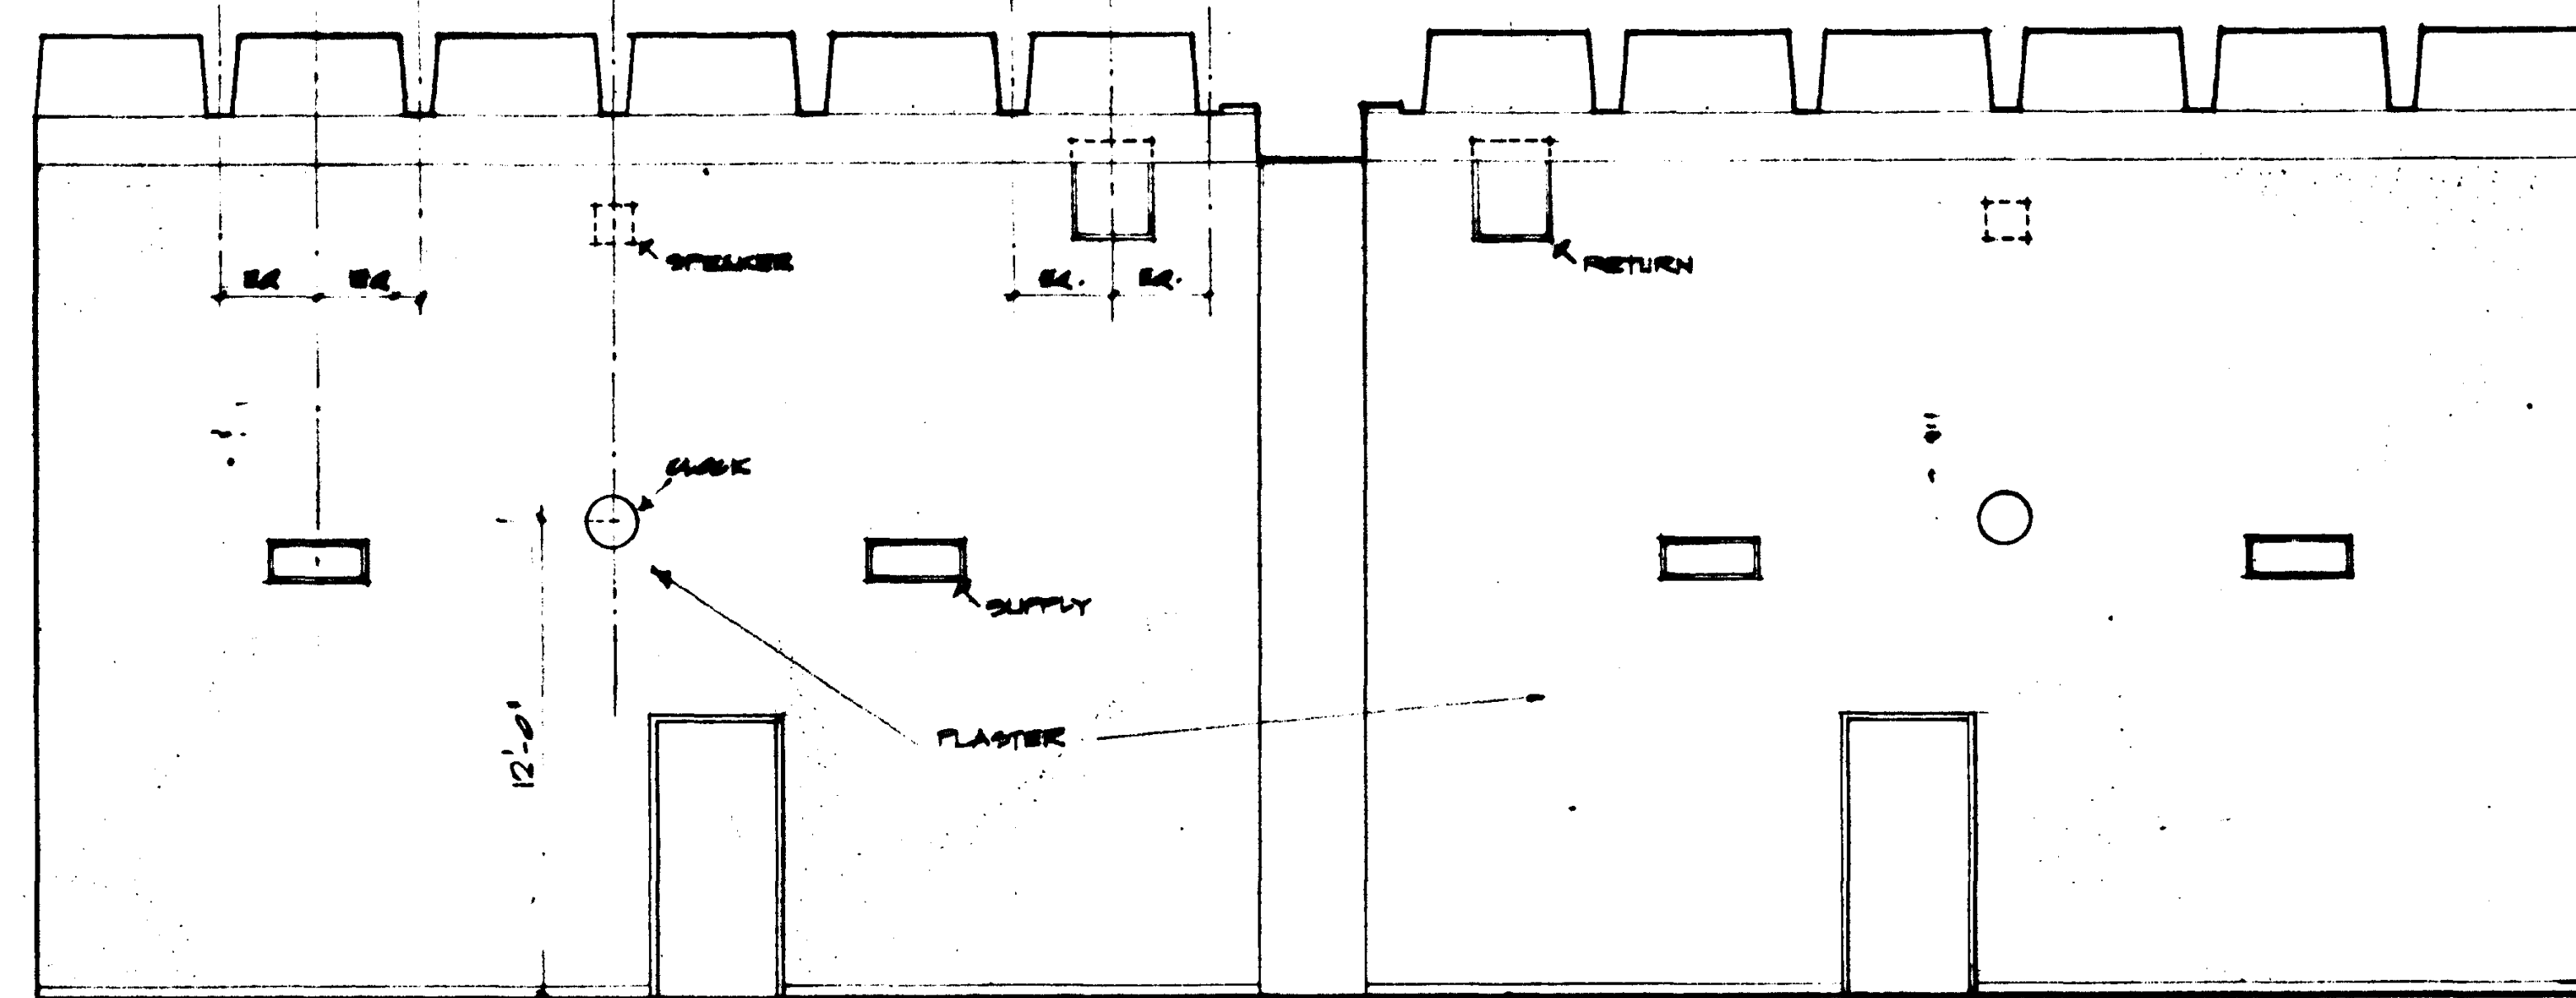MULTI PURPOSE 101


EAST ELEVATION
SIMILAR

BOOKSTORE 101 UNIT 101

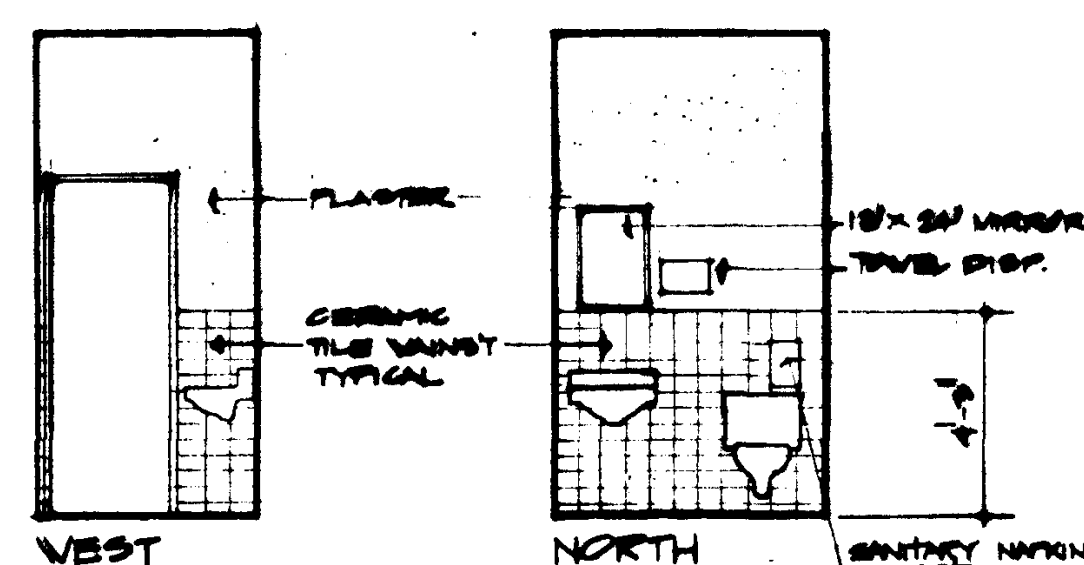

WEST


NORTH

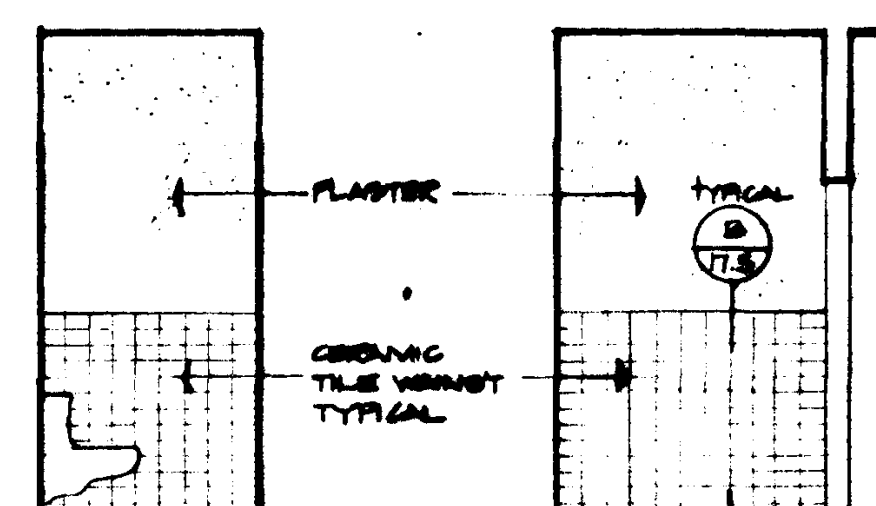

EAST

SOUTH

TOILET 103

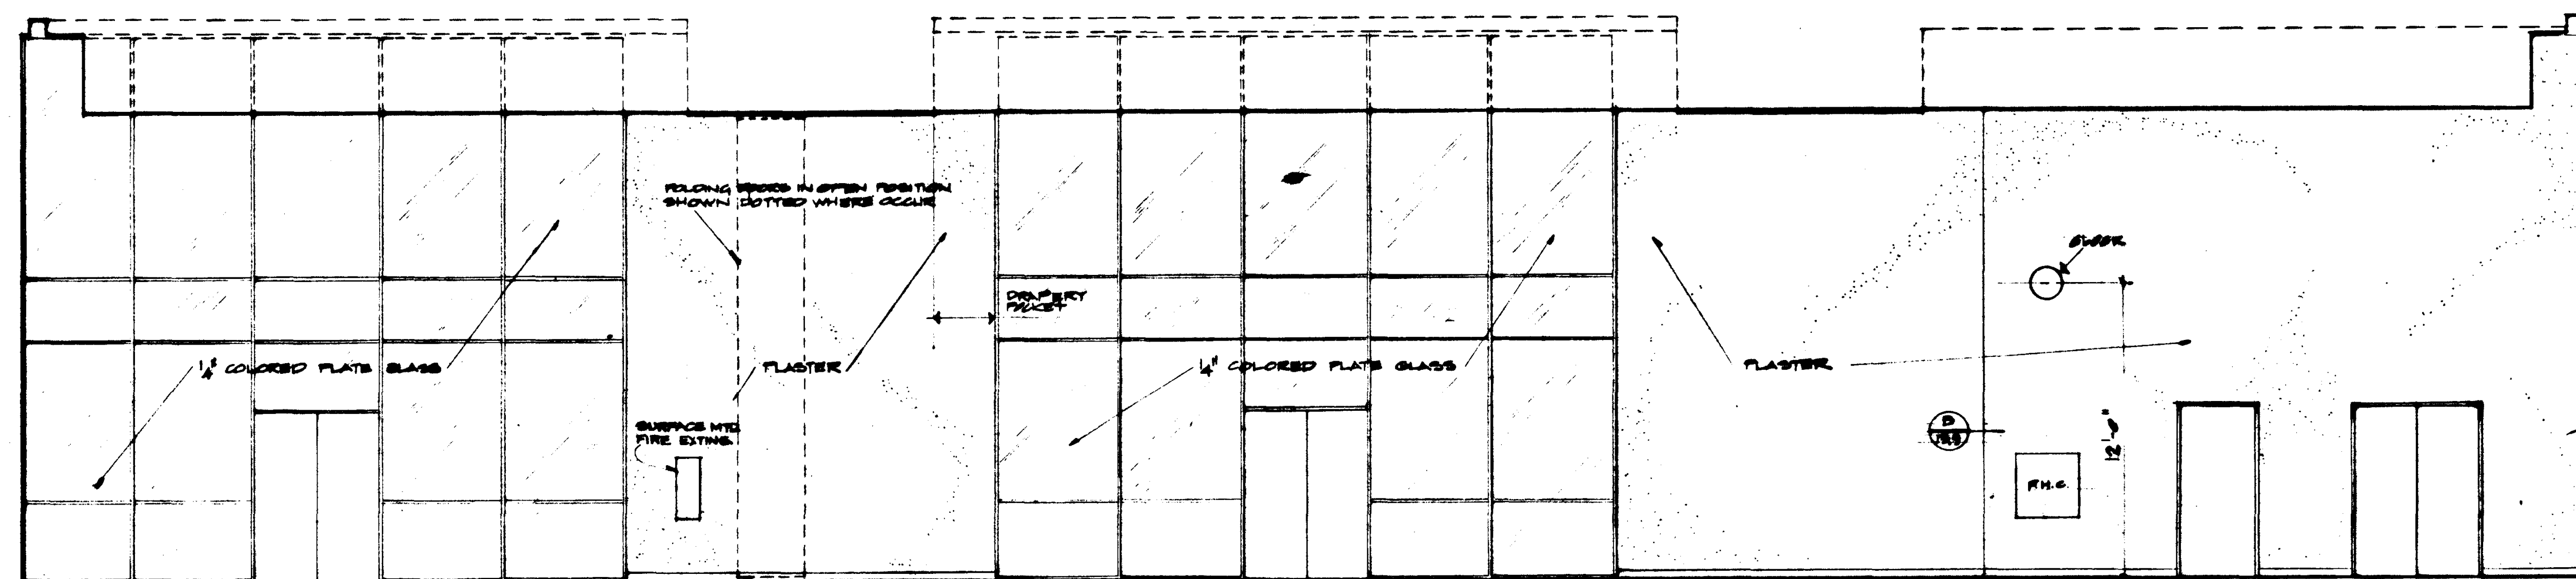


NORTH

FACULTY 103

NORTH

MULTI PURPOSE 101


SOUTH ELEVATION
SIMILAR

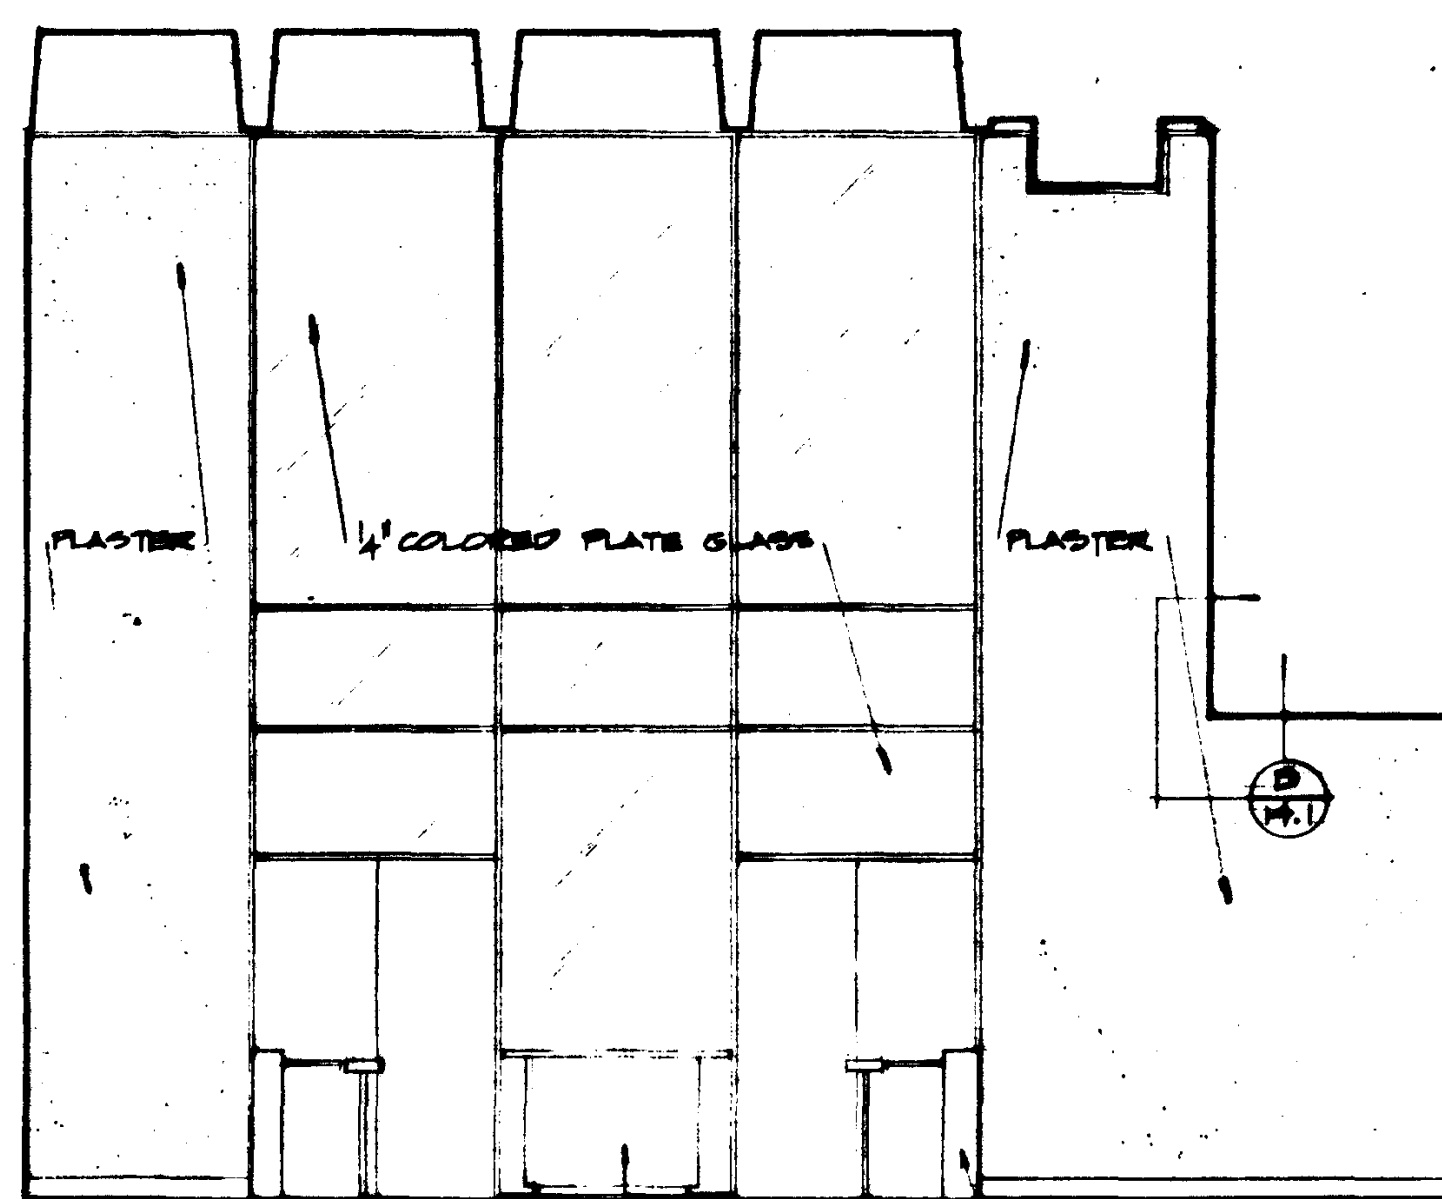

EAST


CASINER'S QUARTER

TURNPILE

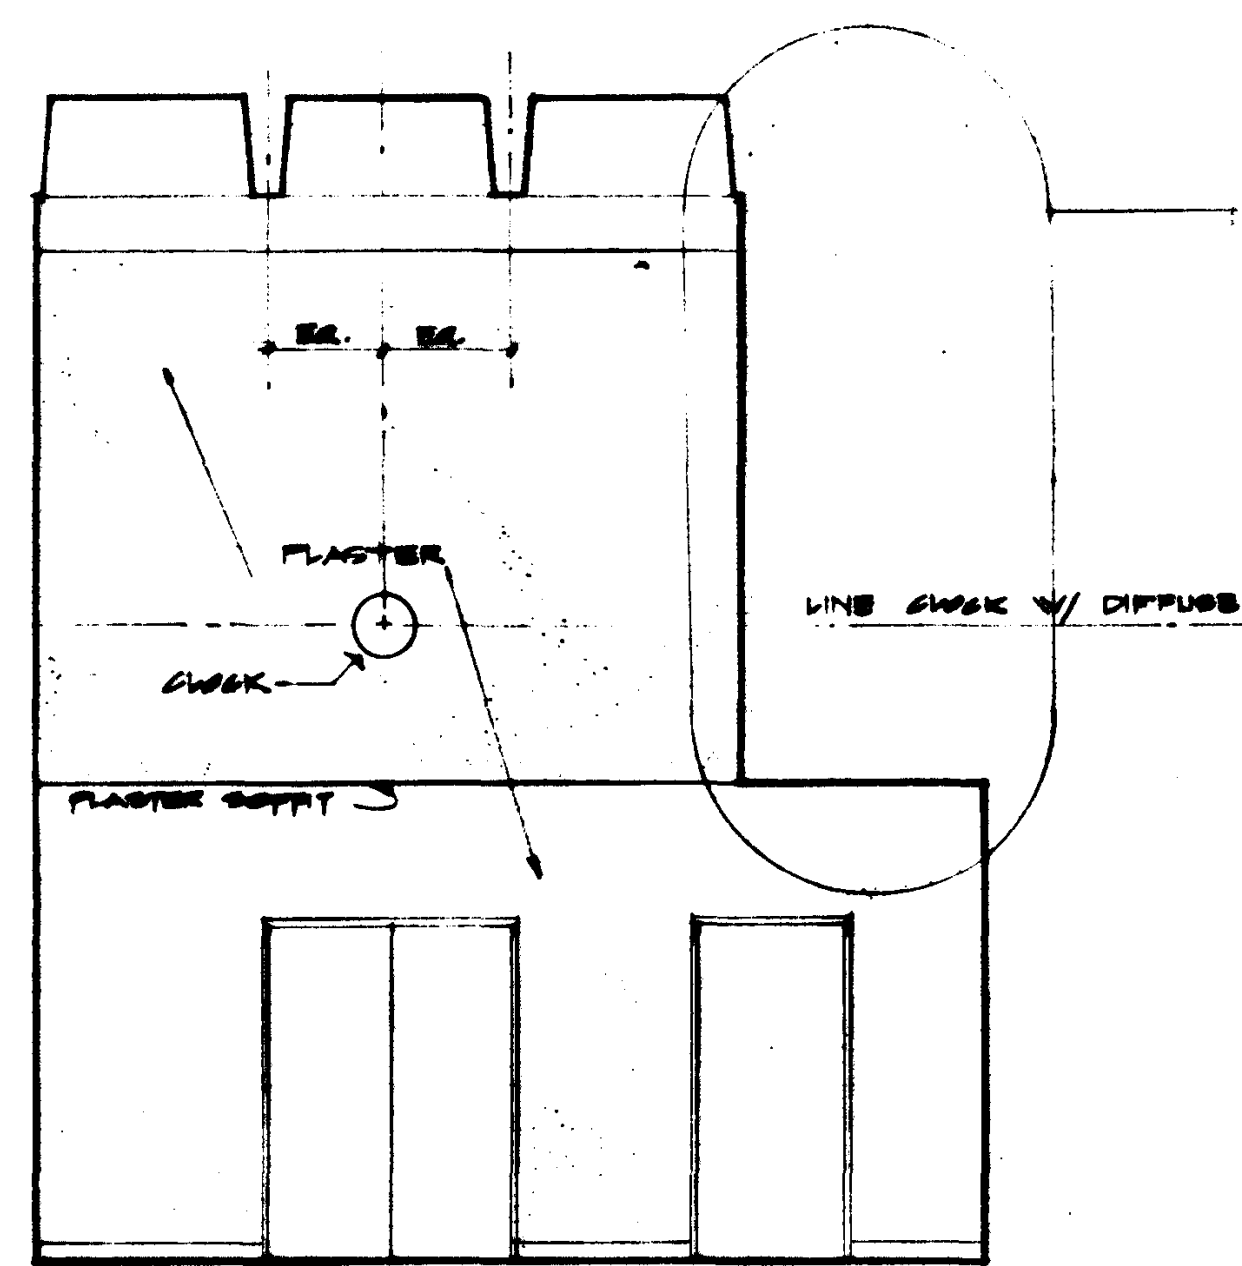


SOUTH

CHANGES AT SOUTH WALL
BULLETIN # 55. C.O. # 30

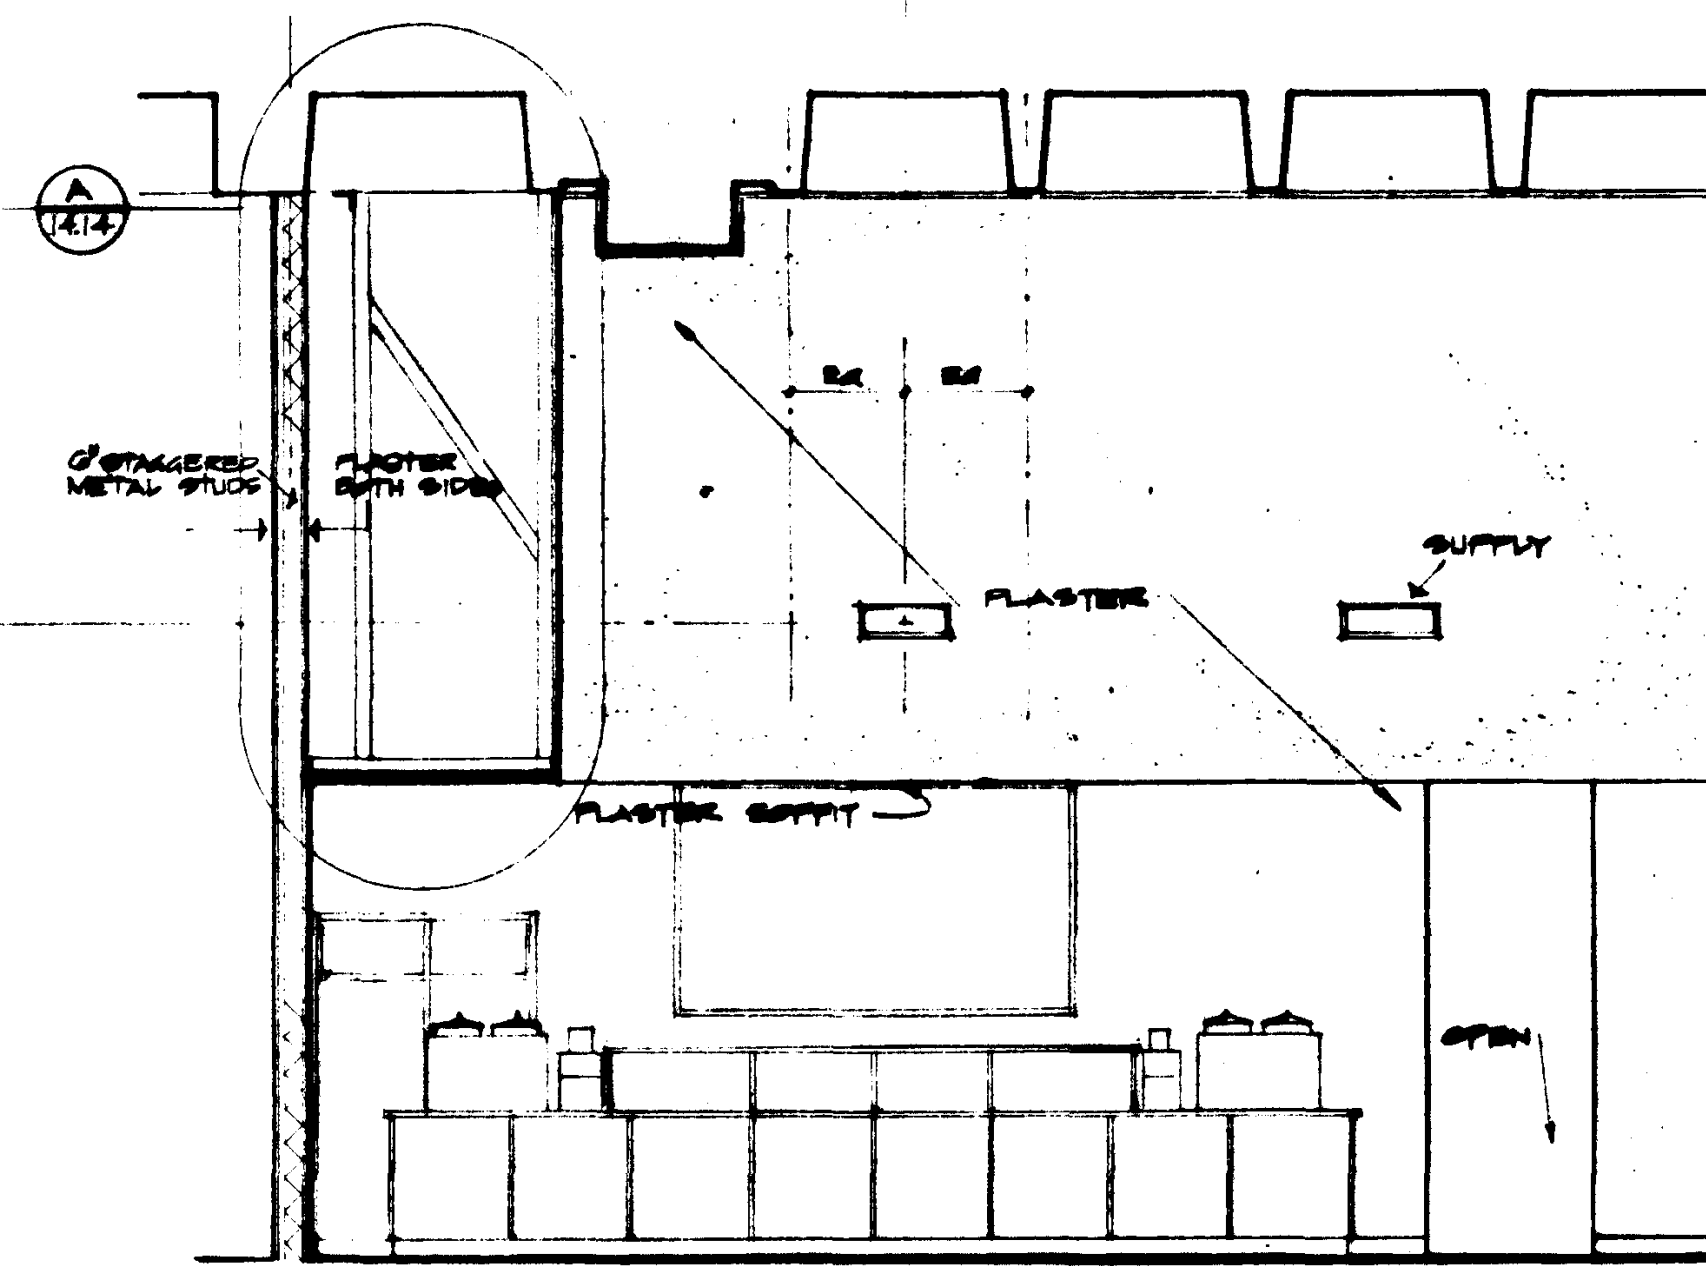

WEST

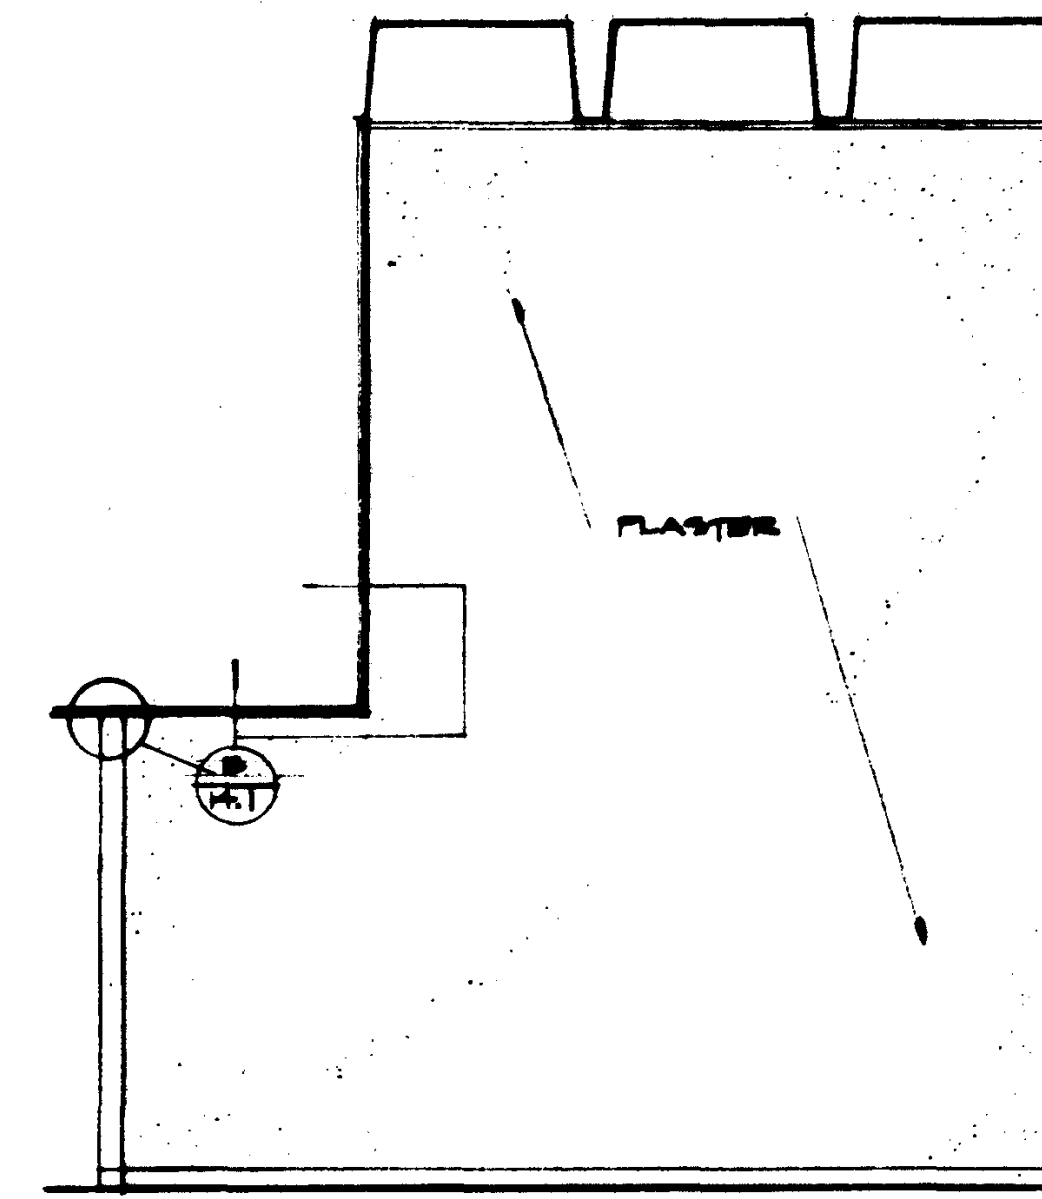

NORTH

SNACK BAR 101

DATE	REVISIONS

STRUCTURAL ENGINEERS BRANDOW & JOHNSON J.A. MARTIN & ASSOCIATES	DESIGNED BY ENGINEER
MECHANICAL ENGINEERS RALPH E. PHILLIPS, INC.	DRAWN BY ENGINEER
ELECTRICAL ENGINEERS RALPH E. PHILLIPS, INC.	CHECKED BY COLLEGE
CIVIL ENGINEERS G. SHUIMAN & ASSOCIATES MOFFATT & NICHOL	


APPROVED STATE FIRE MARSHAL STATE OF CALIFORNIA DATE: JUN 15 1966	APPROVED JUN 21 1966
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ASSOCIATED ARCHITECTS: WILLIAM L. FERREIRA & ASSOCIATES A. QUINCY JONES-FREDERICK E. EMMONS & ASSOCIATES BLUROCK ELLERBROCK & ASSOCIATES	URBANUS SQUARE • MACARTHUR BOULEVARD AT FORD ROAD. TELEPHONE 714/675-2640 • CORONA DEL MAR, CALIFORNIA
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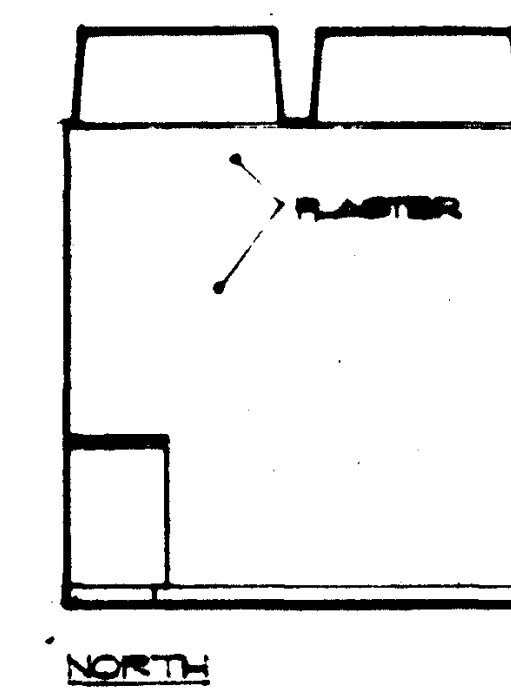
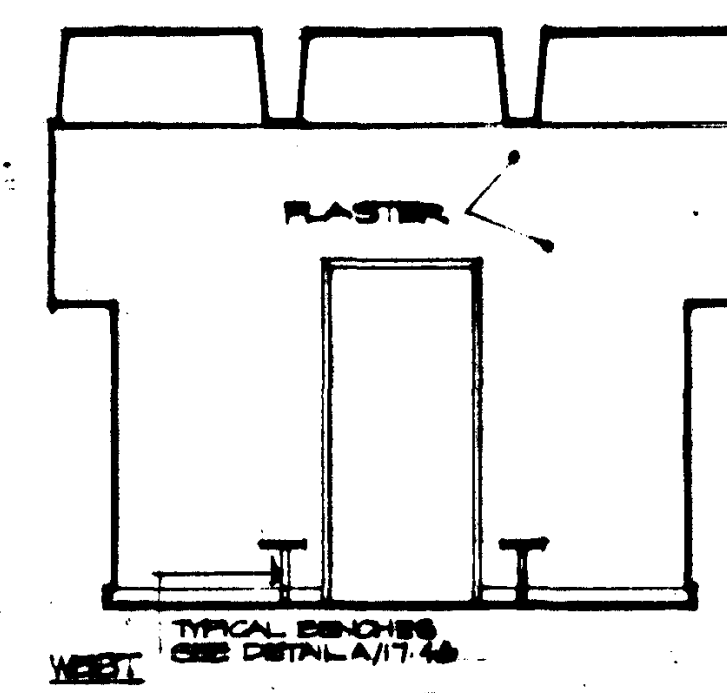
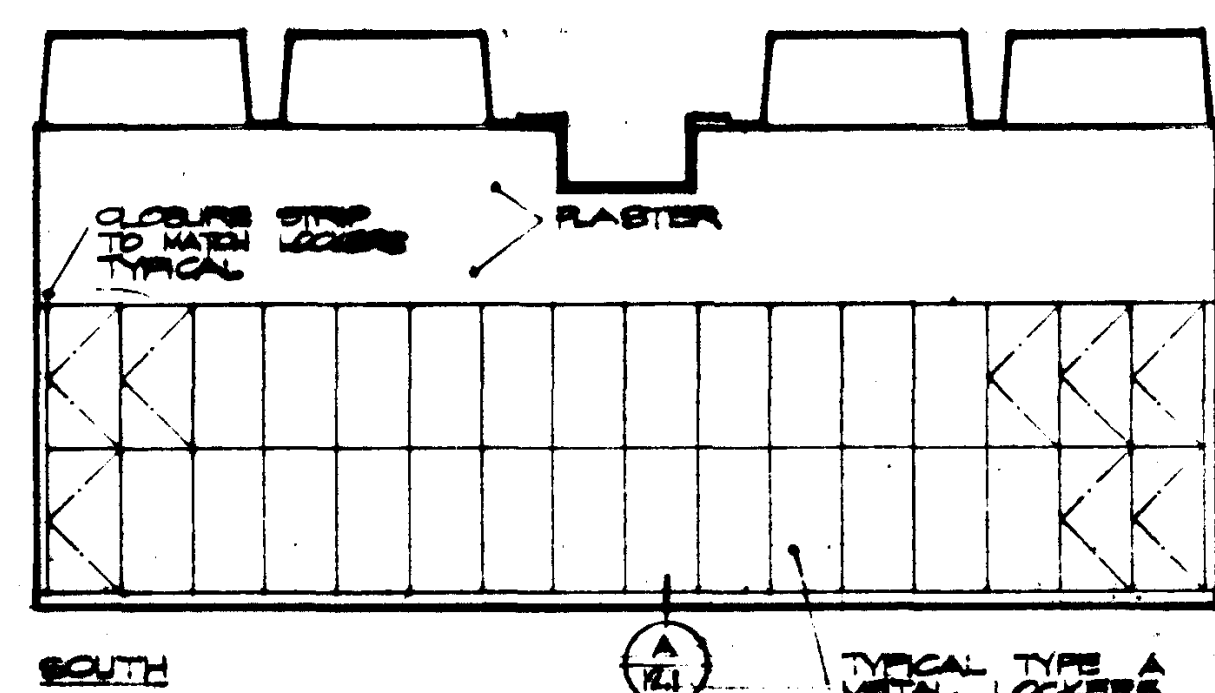
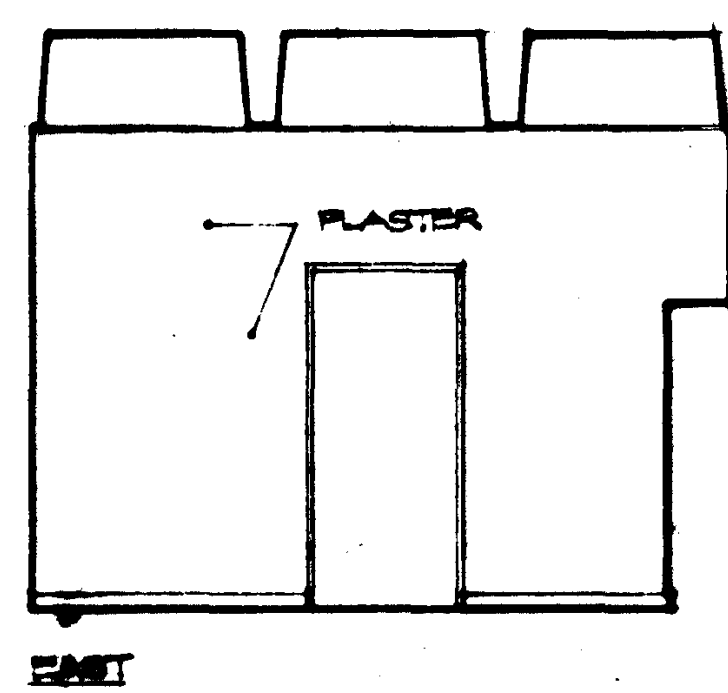
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HUNTINGTON BEACH, CALIFORNIA
ORANGE COAST JUNIOR COLLEGE DISTRICT

UNIT 101 & 102
INTERIOR
ELEVATIONS



JOB NO. 101
DATE 15 JUN 1966
SHEET NO. A3.12







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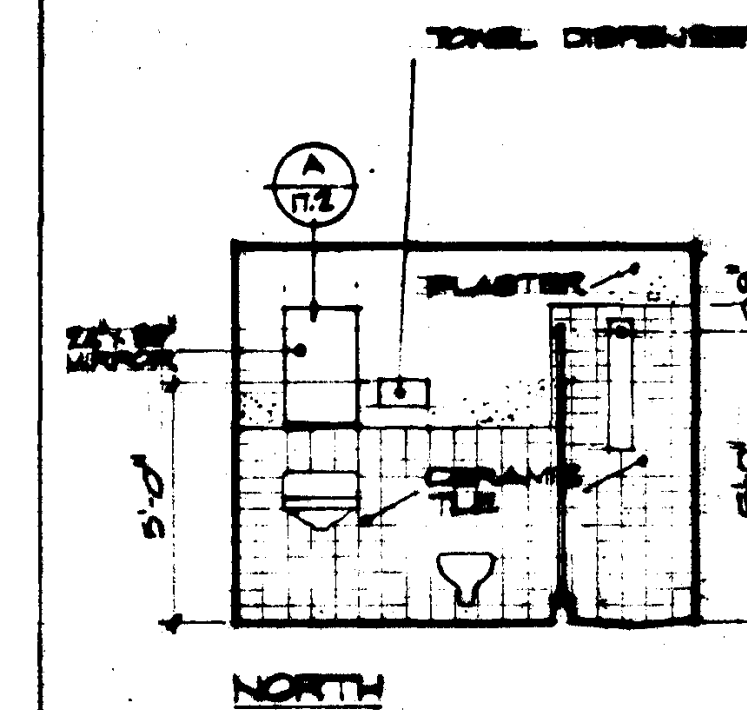
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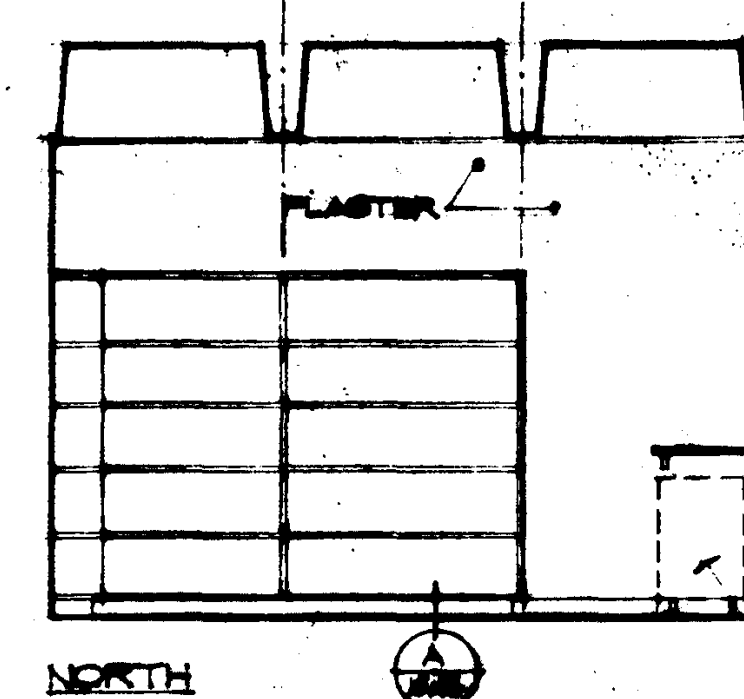
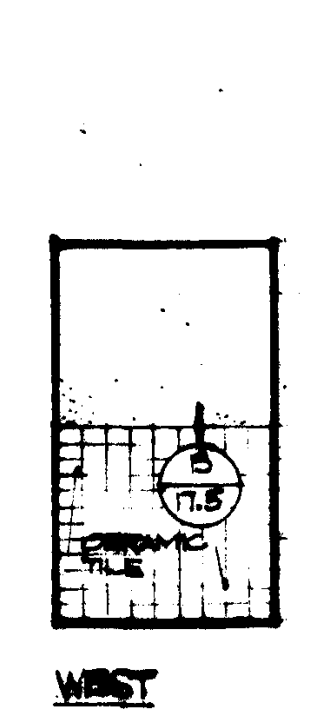
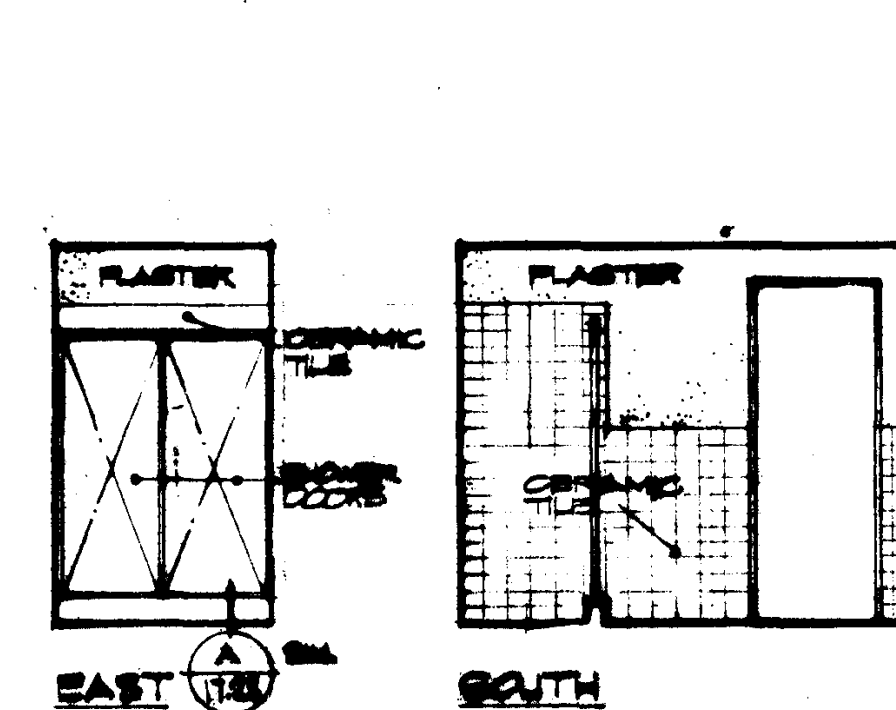
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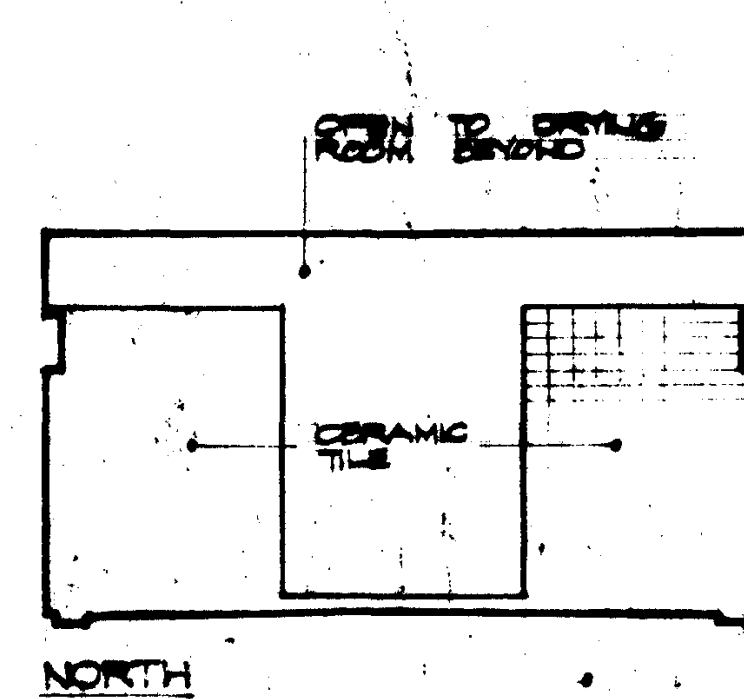
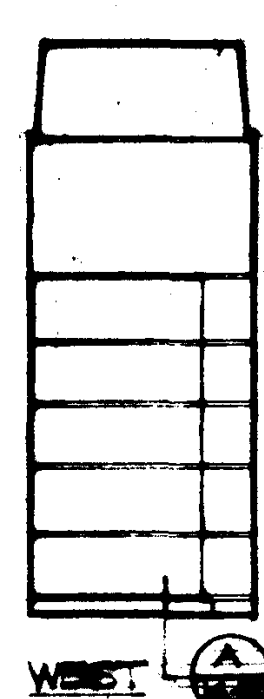
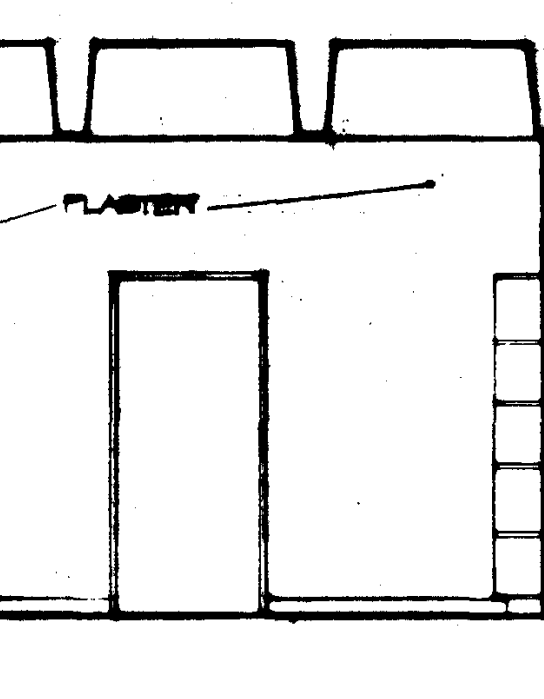
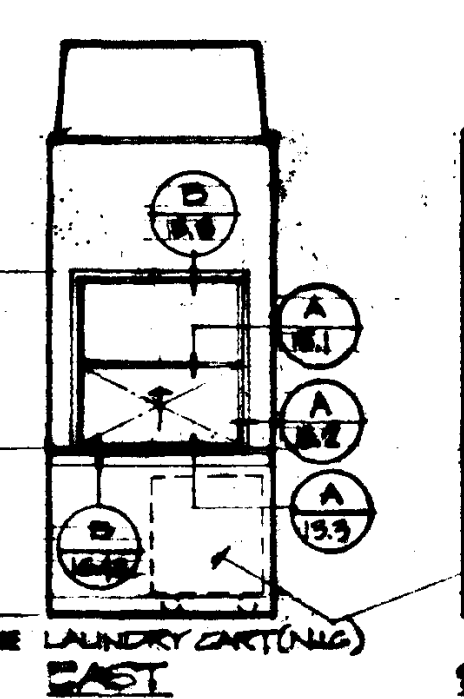
DRESSING 111

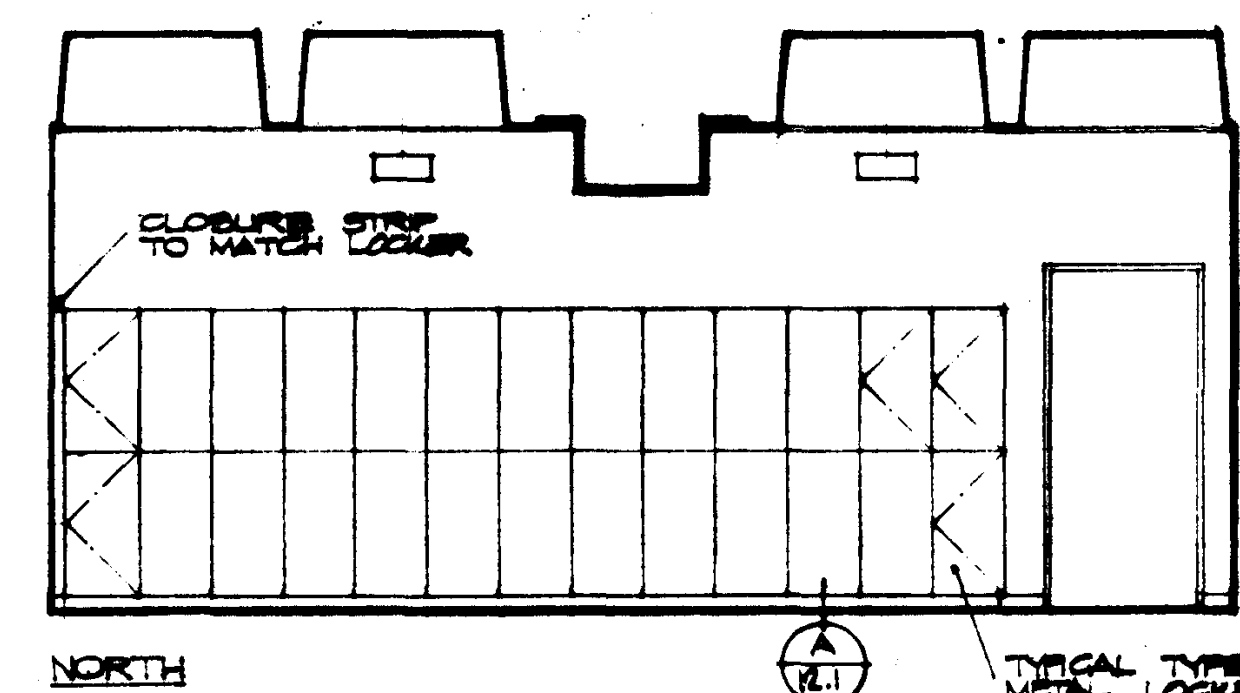





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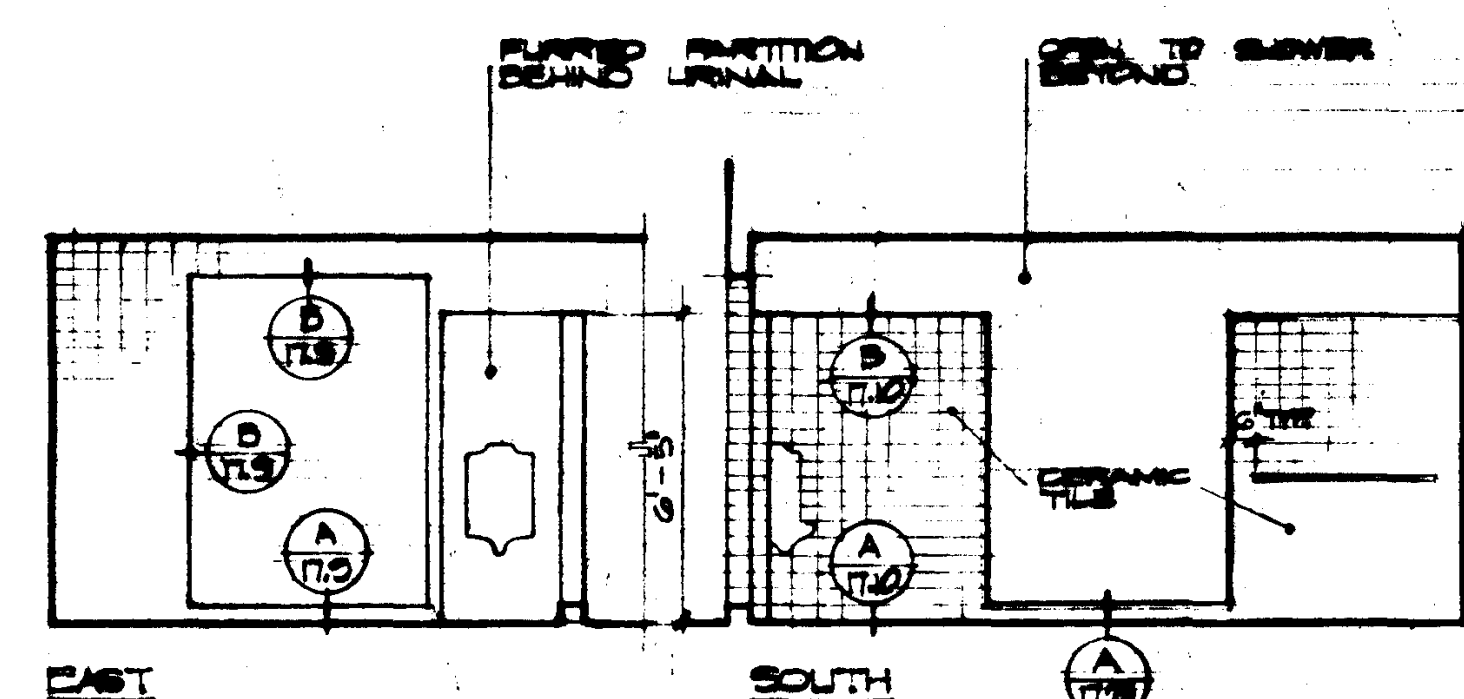
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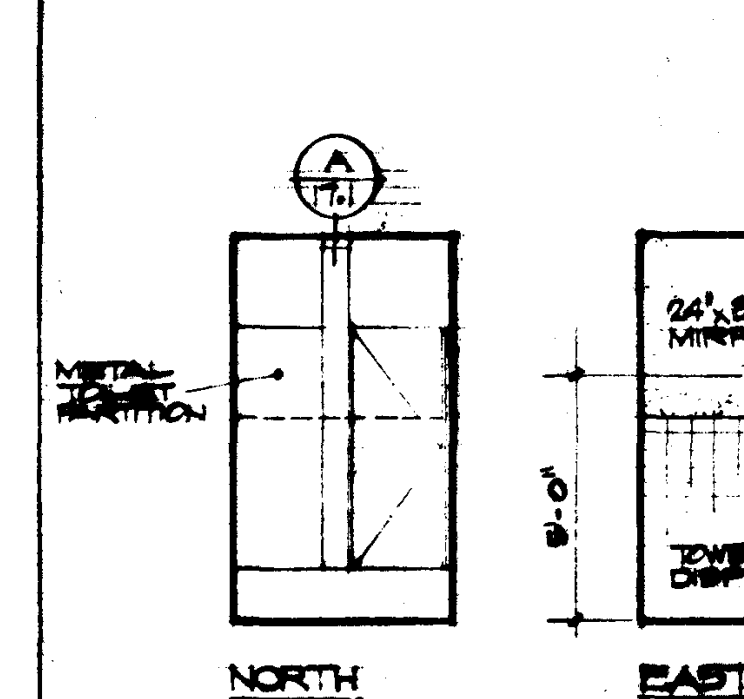
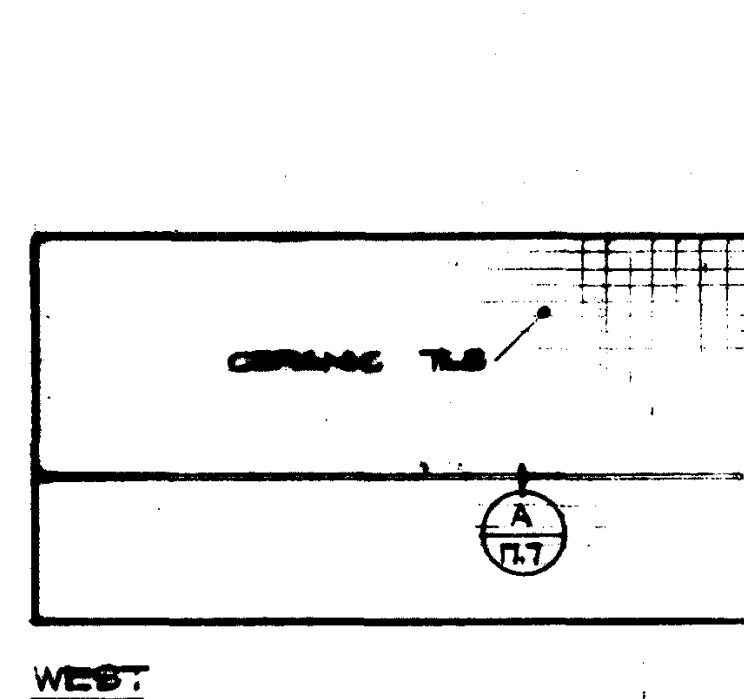
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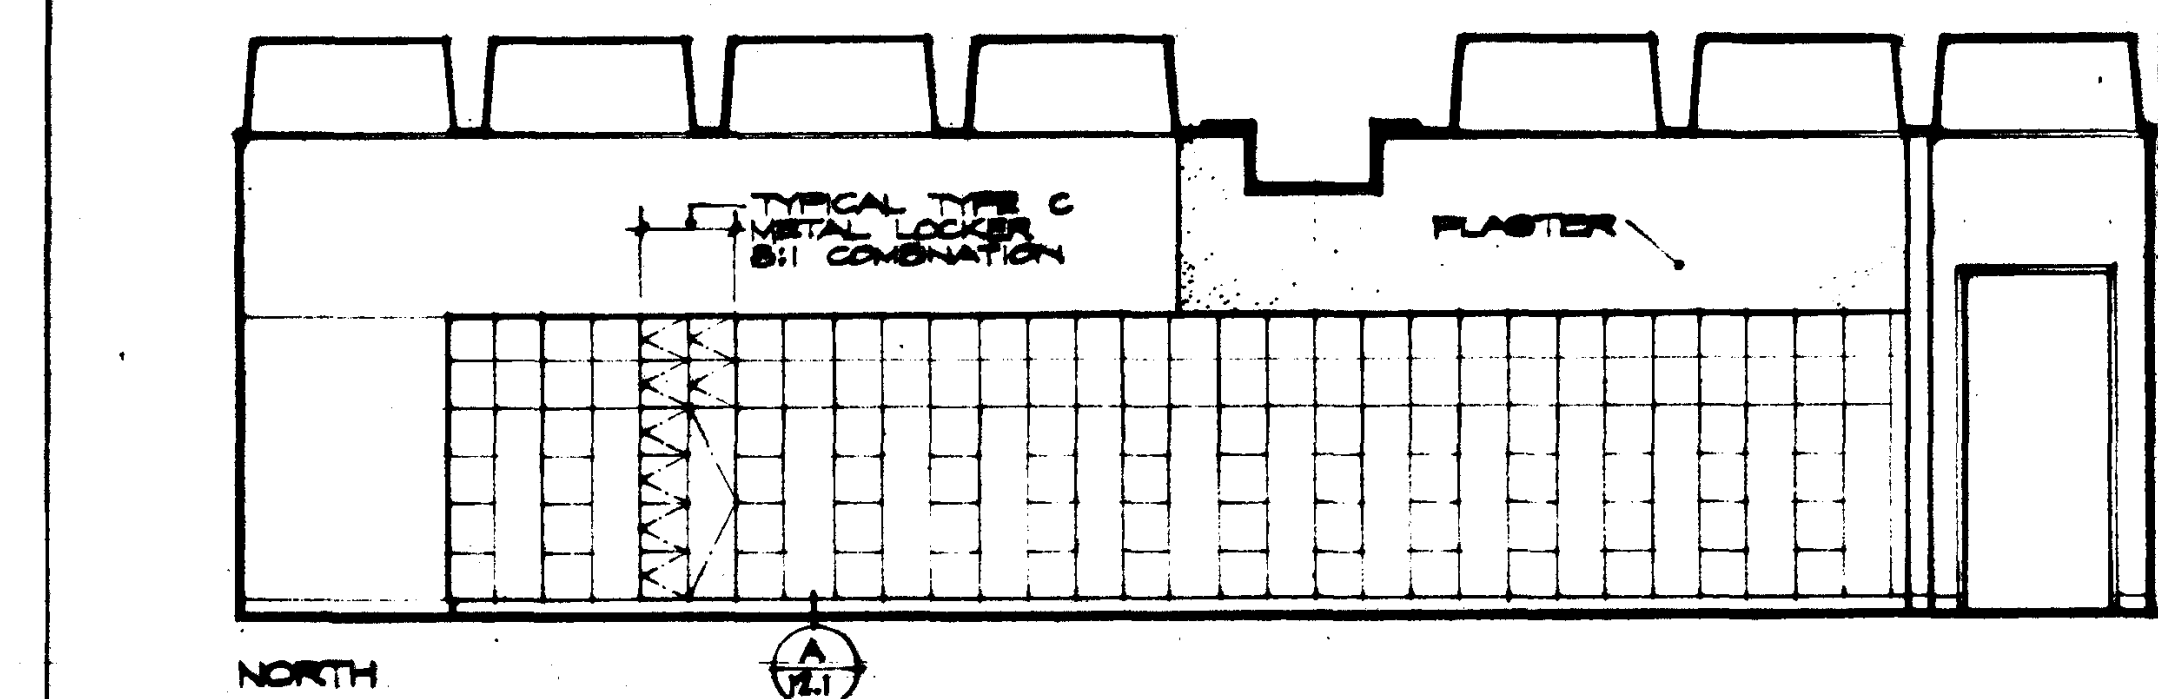
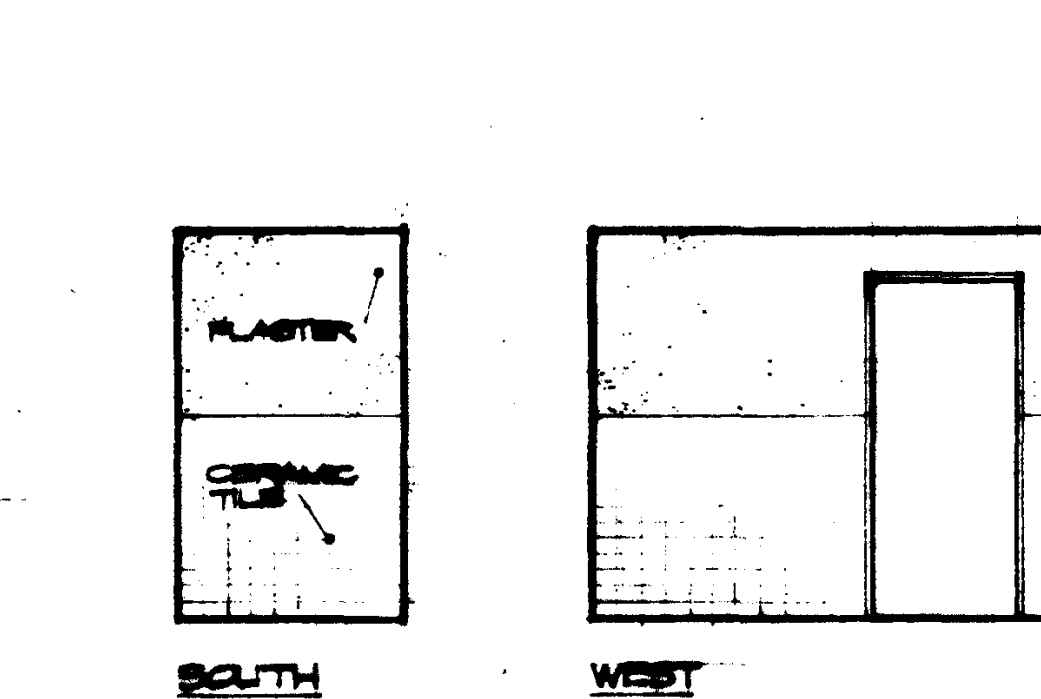
DRYING 115

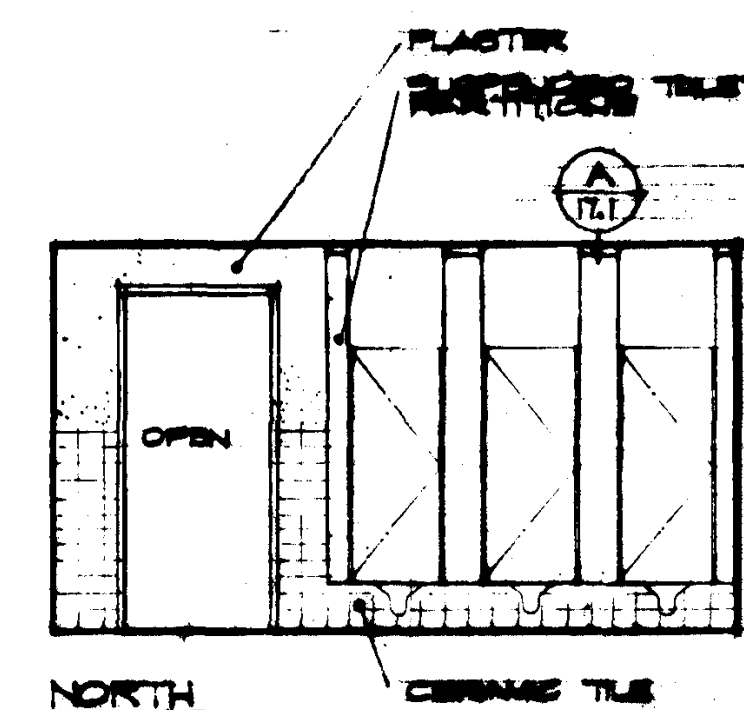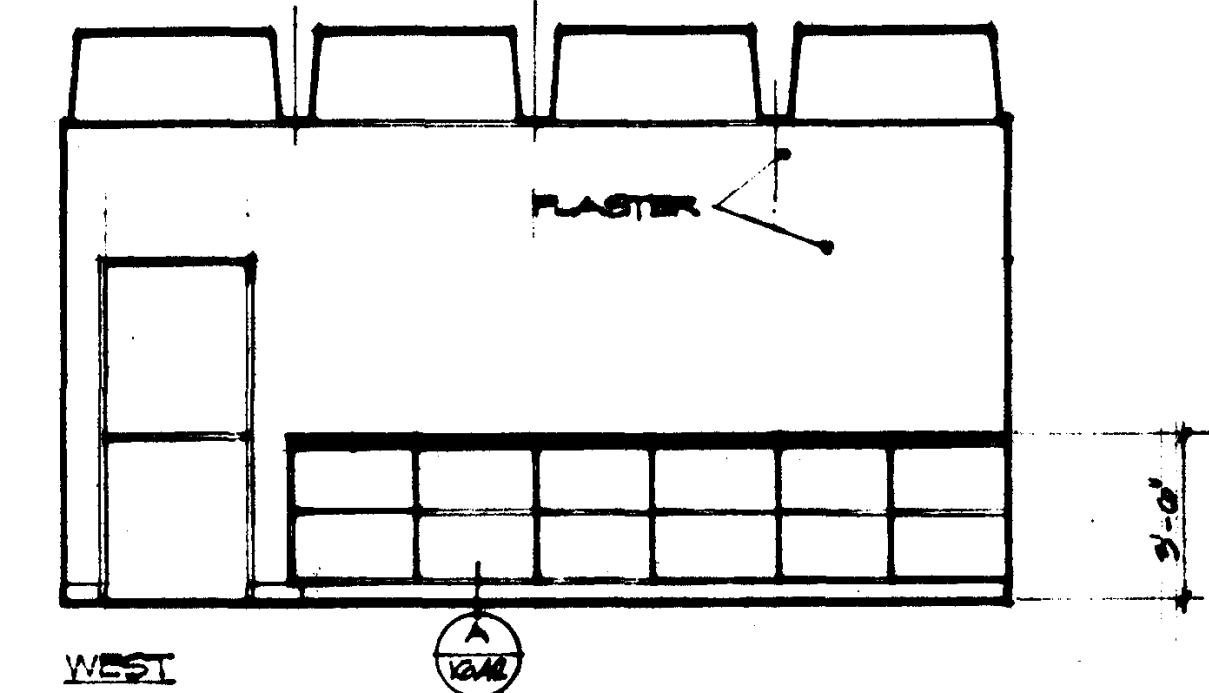

DRYING 116

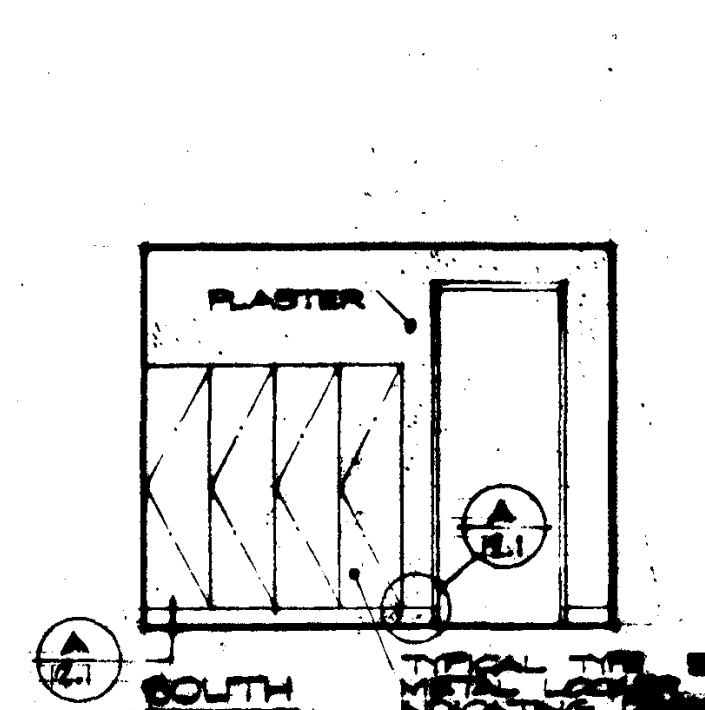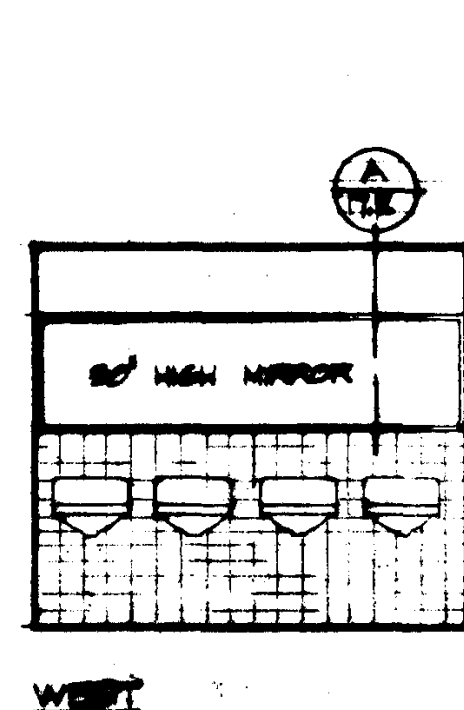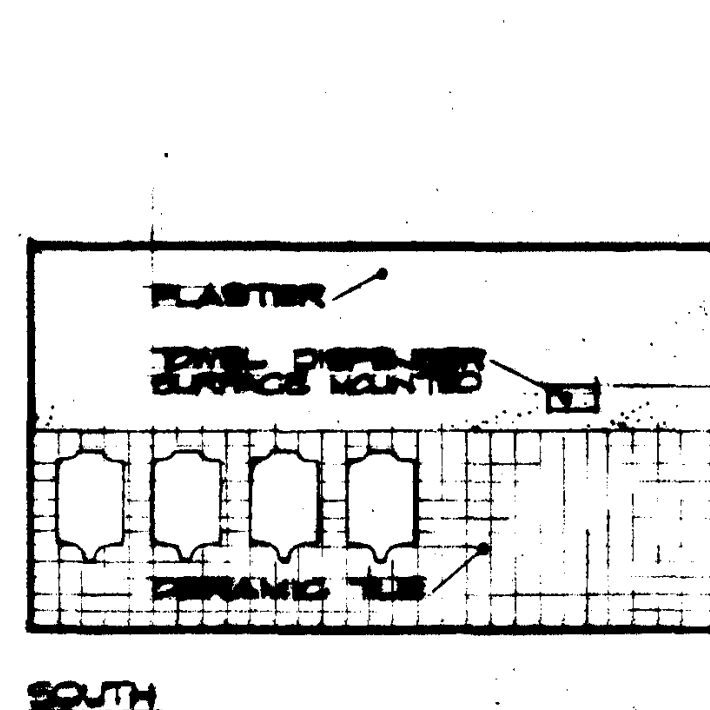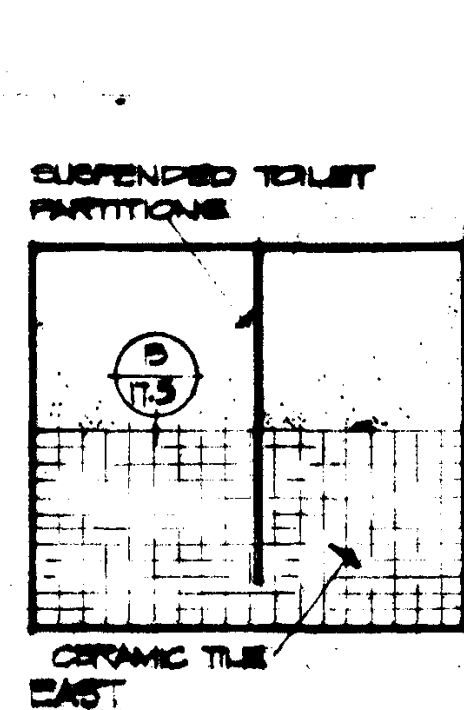


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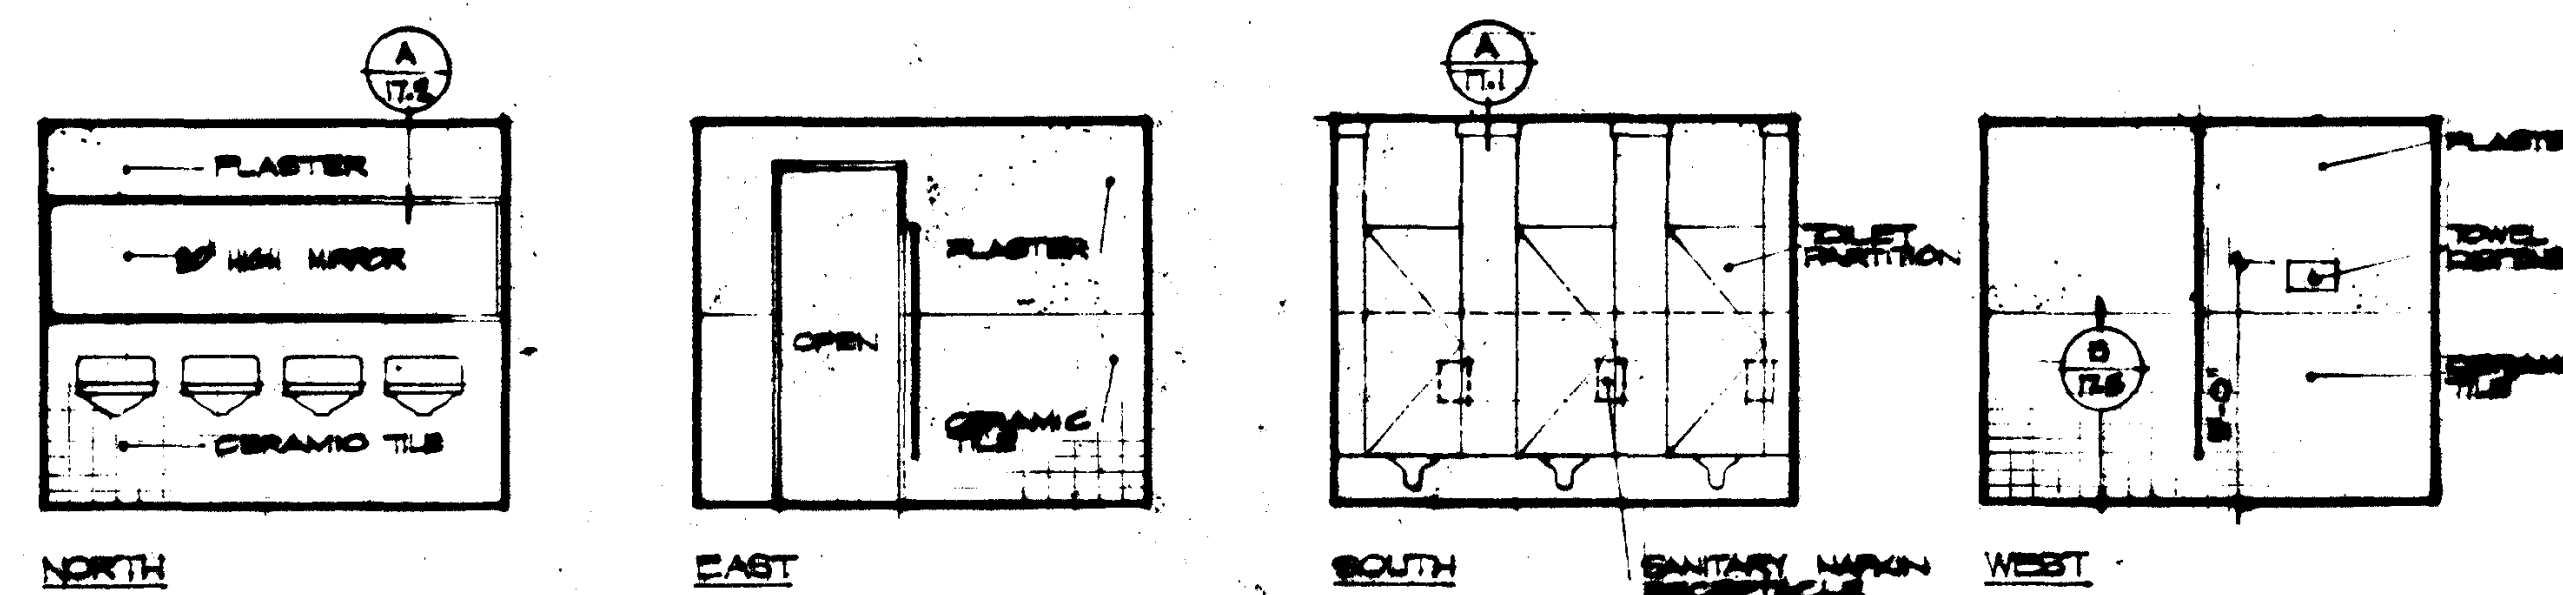


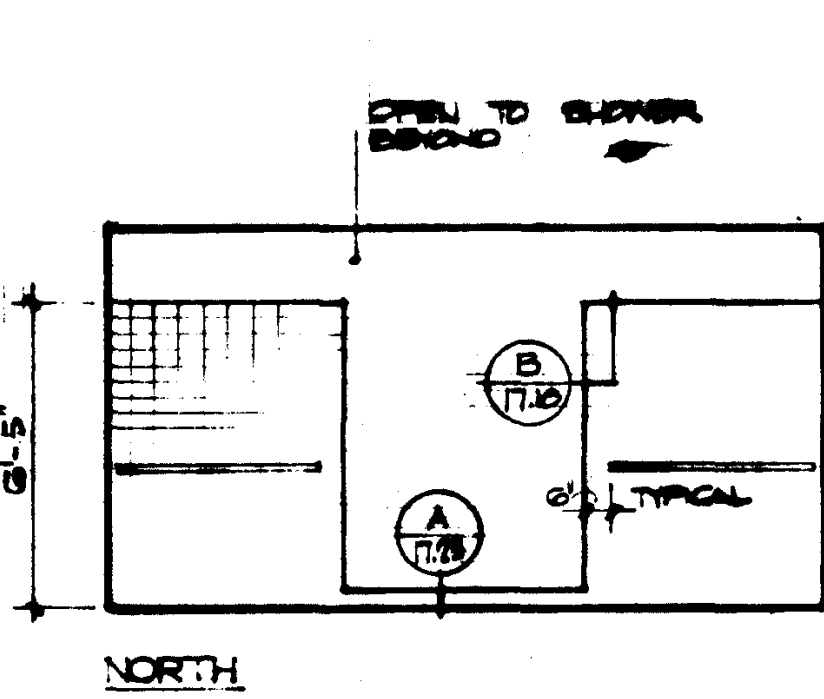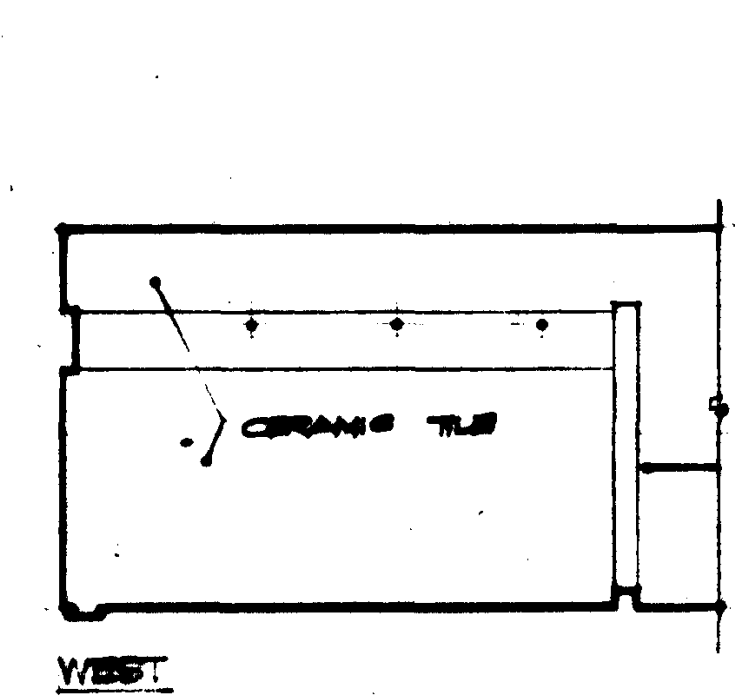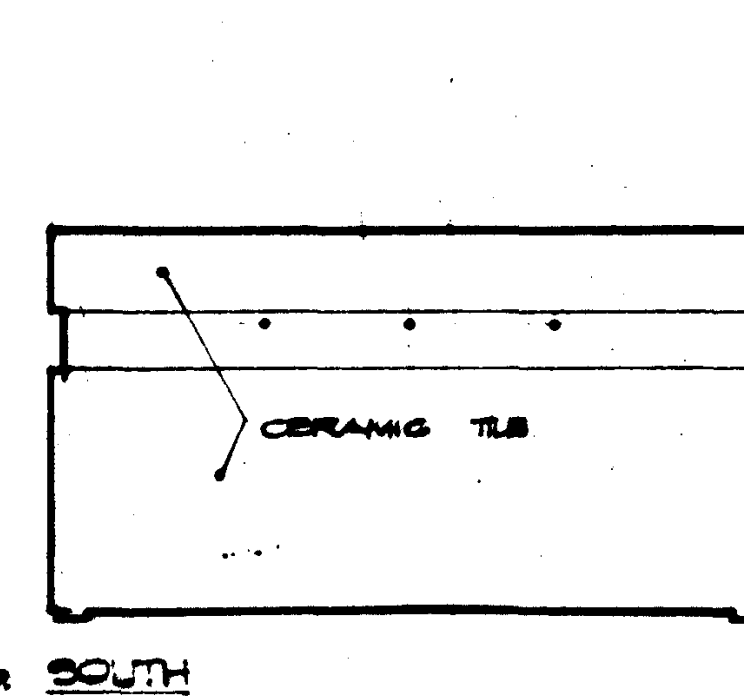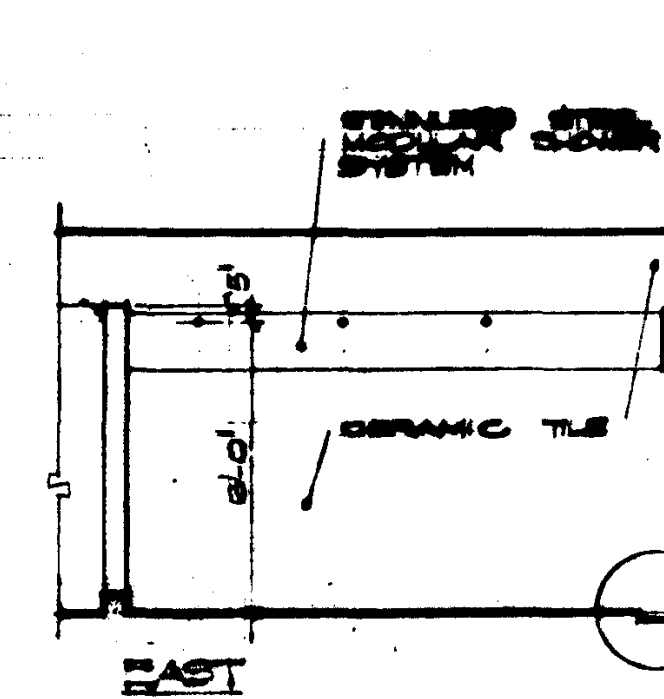LOCKER ROOM 115


REVISIONS	STRUCTURAL ENGINEERS BRANDOW & JOHNSTON J. A. MARTIN & ASSOCIATES	DESIGNED	ARCHITECT WILLIAM L. PEREIRA	APPROVED	ASSOCIATED ARCHITECTS: WILLIAM L. PEREIRA & ASSOCIATES A. QUINCY JONES-FREDERICK E. EMMONS & ASSOCIATES BLUROCK ELLERBROEK & ASSOCIATES URBANUS SQUARE • MACARTHUR BOULEVARD AT FORD ROAD TELEPHONE 714/675-2640 • CORONA DEL MAR, CALIFORNIA	GOLDEN WEST COLLEGE HUNTINGTON BEACH, CALIFORNIA ORANGE COAST JUNIOR COLLEGE DISTRICT	UNIT 10	JOB NO. 1004
	MECHANICAL ENGINEERS RALPH E. PHILLIPS, INC.	DRAWN BY	ENGINEER	APPROVED			DATE 15 JUN 1965	
	ELECTRICAL ENGINEERS RALPH E. PHILLIPS, INC.	CHECKED BY	COLLEGE	STATE FIRE MARSHAL STATE OF CALIFORNIA DATE JUN 21 1965			SHEET NO.	
	CIVIL ENGINEERS G. SHUURMAN & ASSOCIATES MOFFATT & NICHOL			25874 APPROVED JUN 21 1965			A8.13	
	DATE DRAWN							

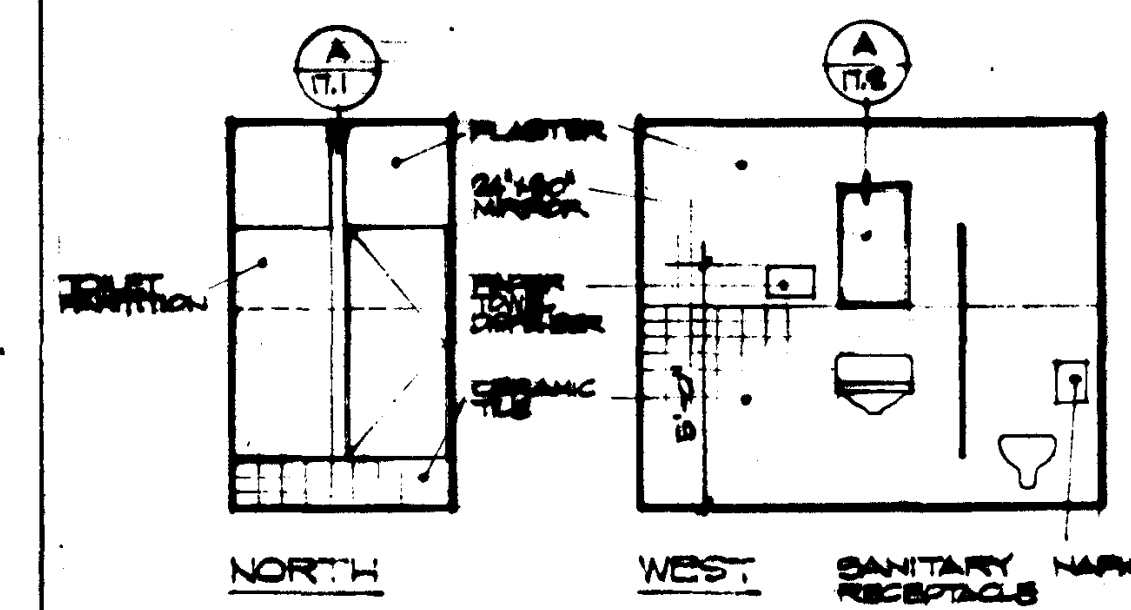

SCALE
1:48




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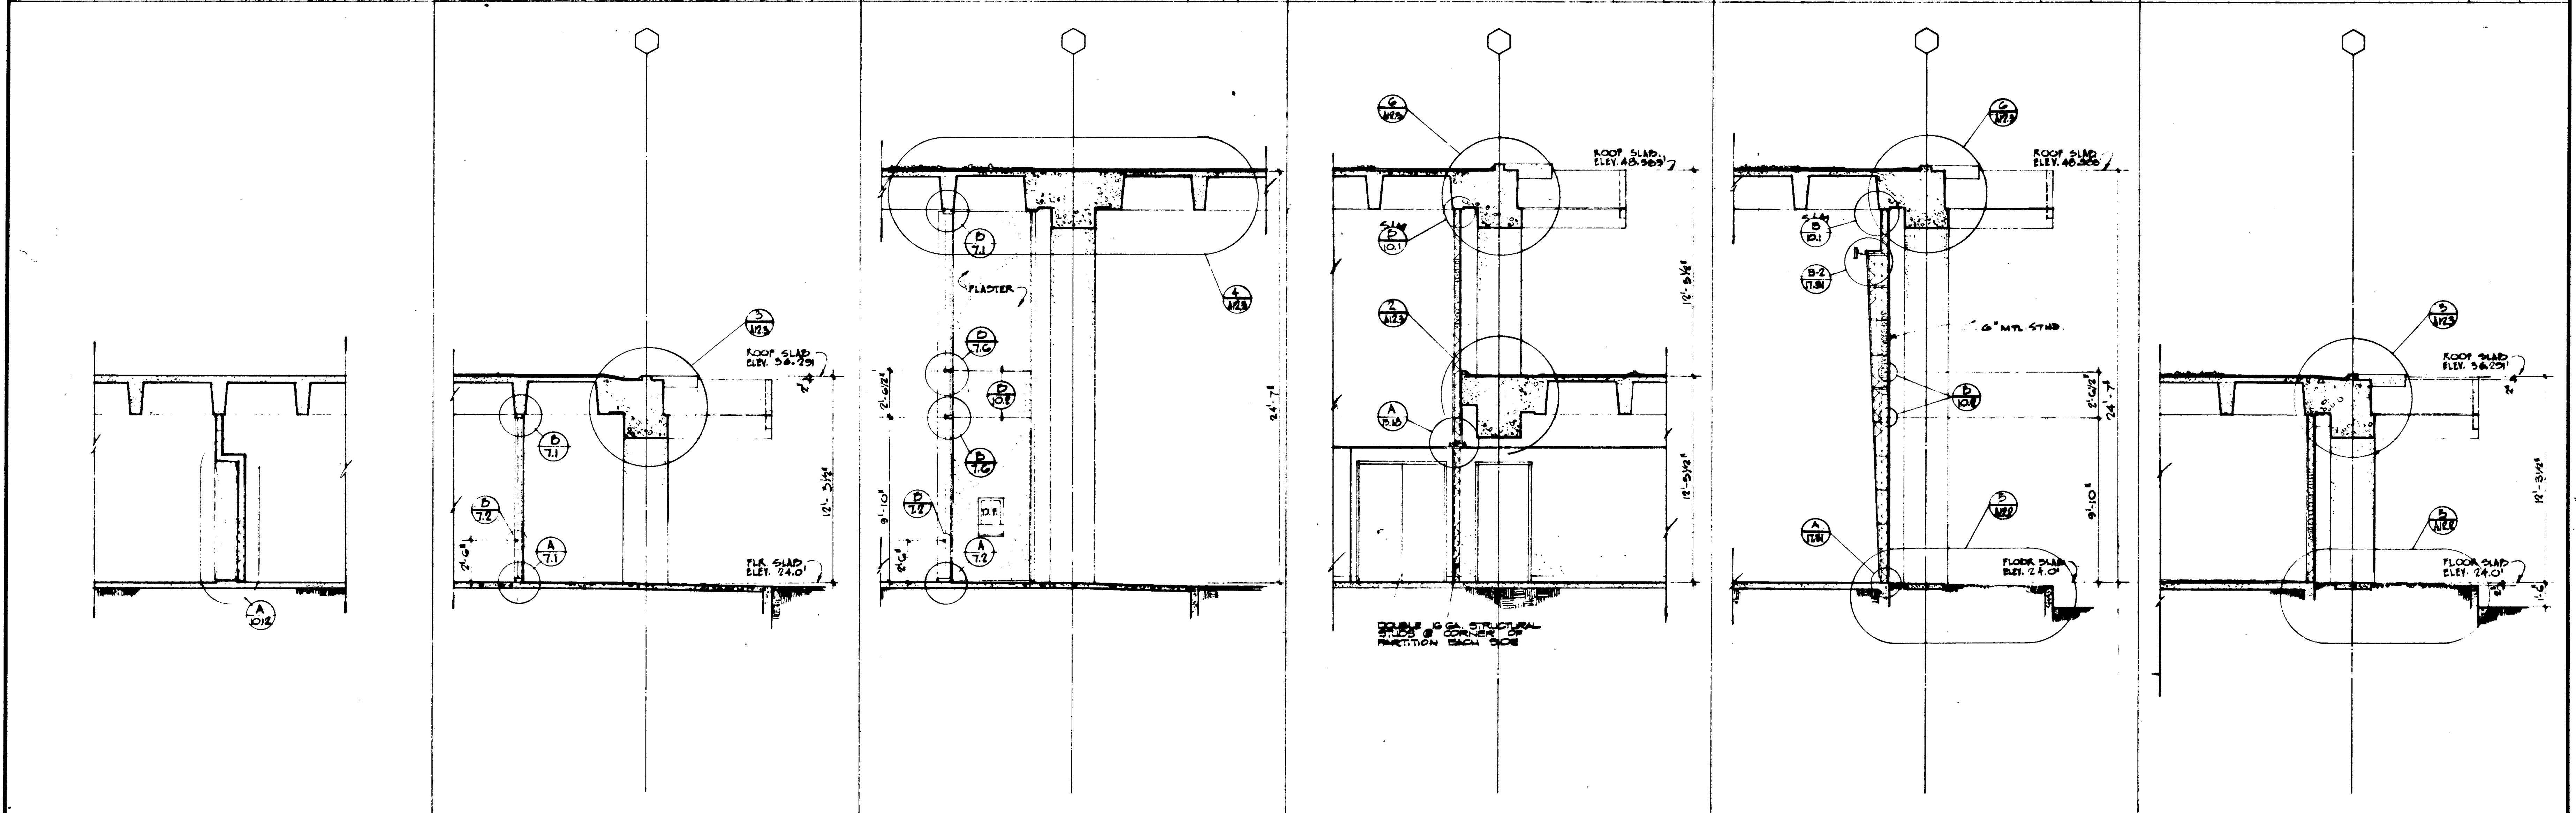


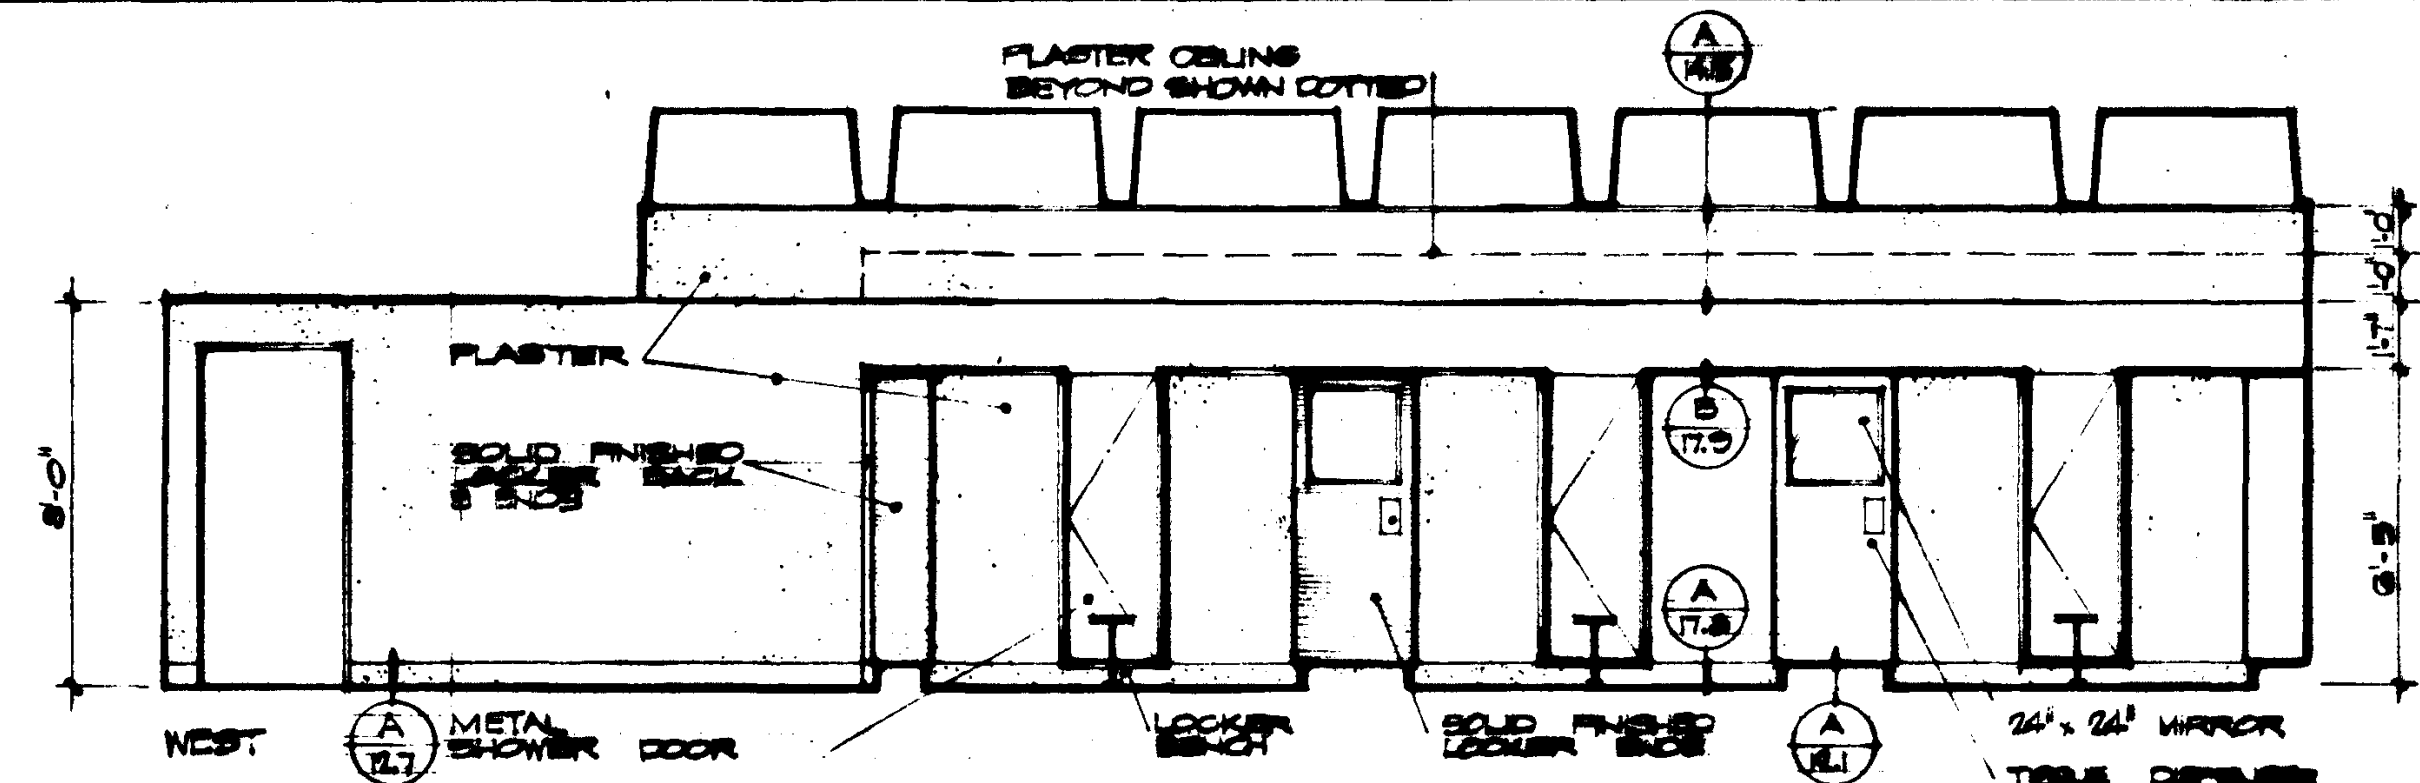LOCKER ROOM 1 1 2

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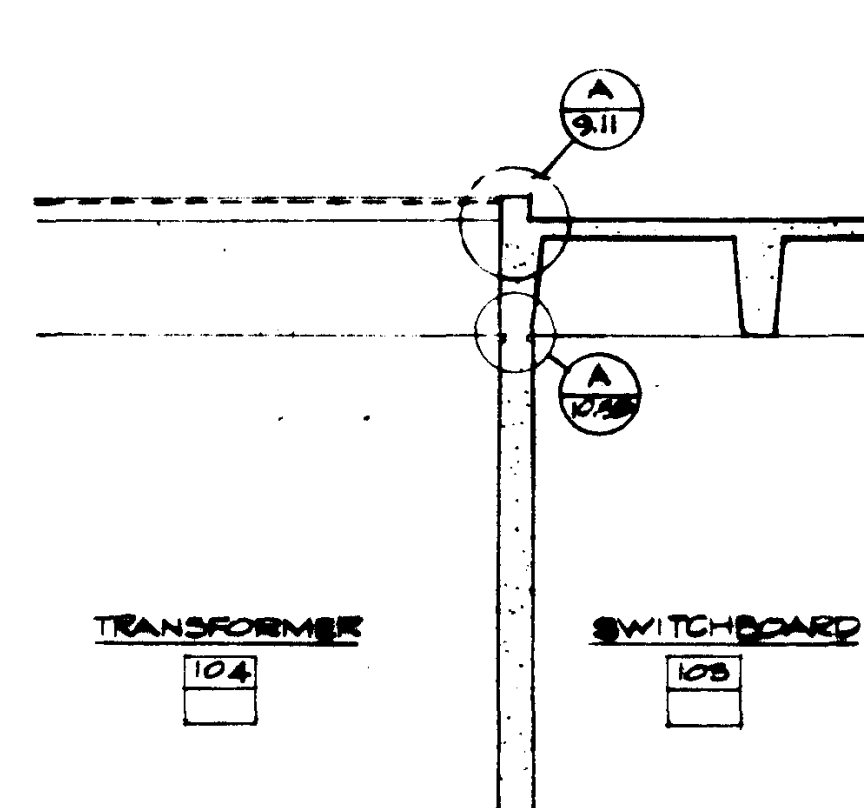


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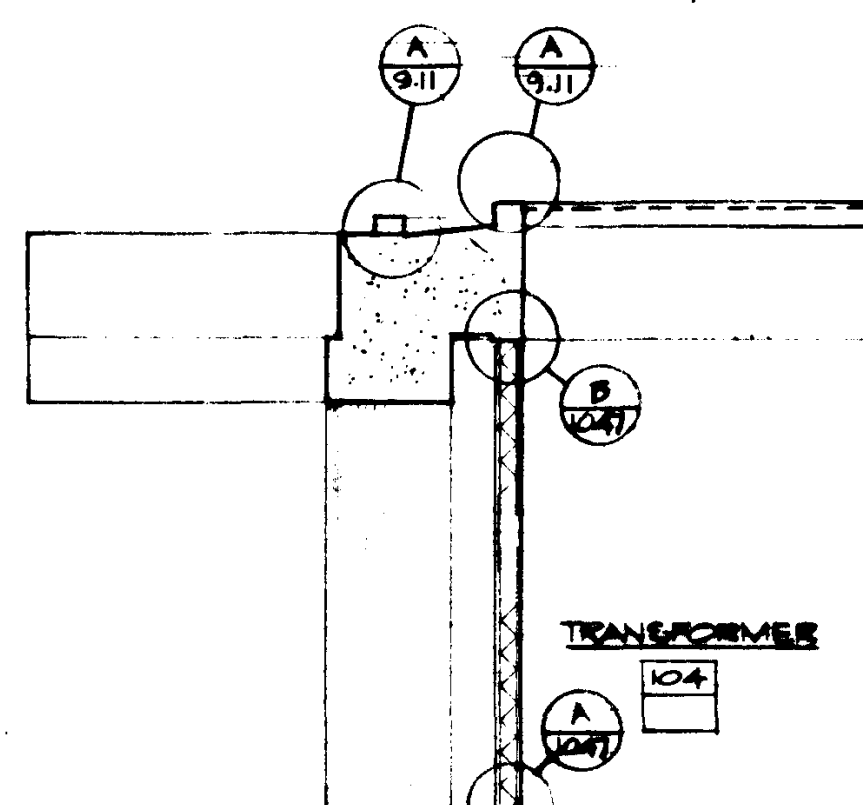
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REVISIONS 1 2 3 100	STRUCTURAL ENGINEERS BRANDOW & JOHNSON J. A. MARTIN & ASSOCIATES MECHANICAL ENGINEERS RALPH E. PHILLIPS, INC. ELECTRICAL ENGINEERS RALPH E. PHILLIPS, INC. CIVIL ENGINEERS G. SHURMAN & ASSOCIATES MOFFATT & NICKOL	DESIGNED DRAWN BY CHECKED BY	ARCHITECT WILLIAM L. FERREIRA ENGINEER COLLEGE	APPROVED STATE ENGINE MARSHAL STATE OF CALIFORNIA DATE: JUN 24 1966 25874	ASSOCIATED ARCHITECTS: WILLIAM L. FERREIRA & ASSOCIATES QUINCY JONES-FREDERICK E. EMMONS & ASSOCIATES BLUROCK ELLERBROEK & ASSOCIATES URBANUS SQUARE • MACARTHUR BOULEVARD AT FORD ROAD TELEPHONE 714/675-2660 • CORONA DEL MAR, CALIFORNIA	GOLDEN WEST COLLEGE HUNTINGTON BEACH, CALIFORNIA ORANGE COAST JUNIOR COLLEGE DISTRICT	WALL SECTIONS	JOB NO. DATE 15 JUN 1966 SHEET NO. A 341
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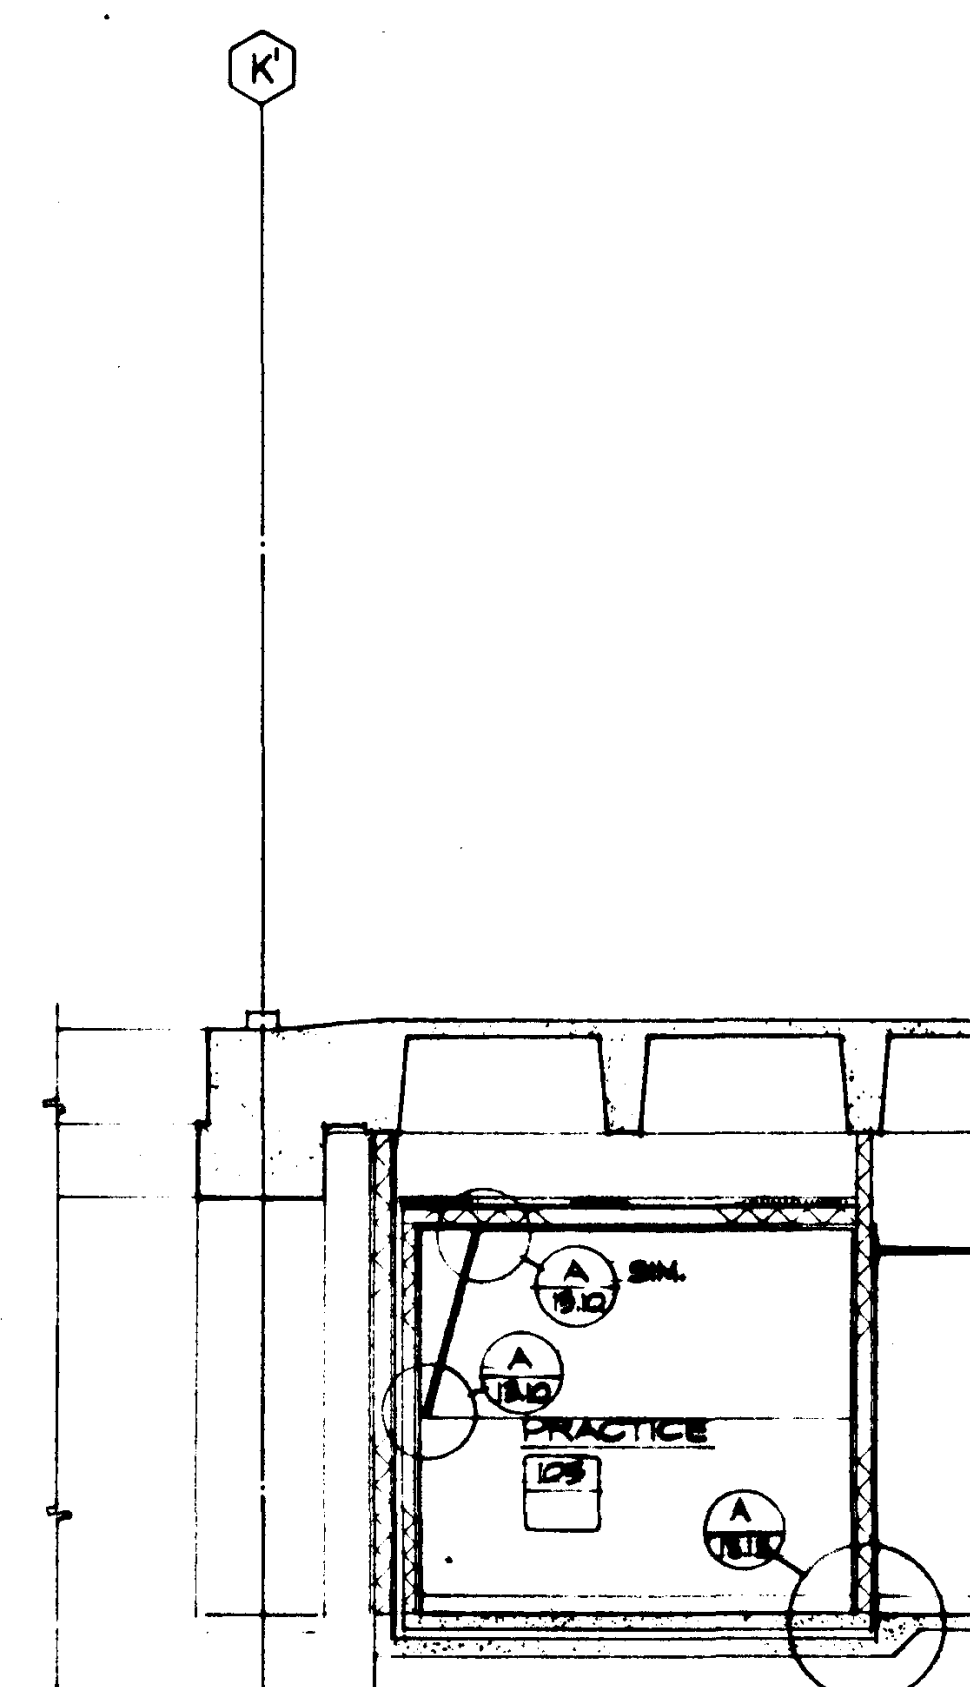
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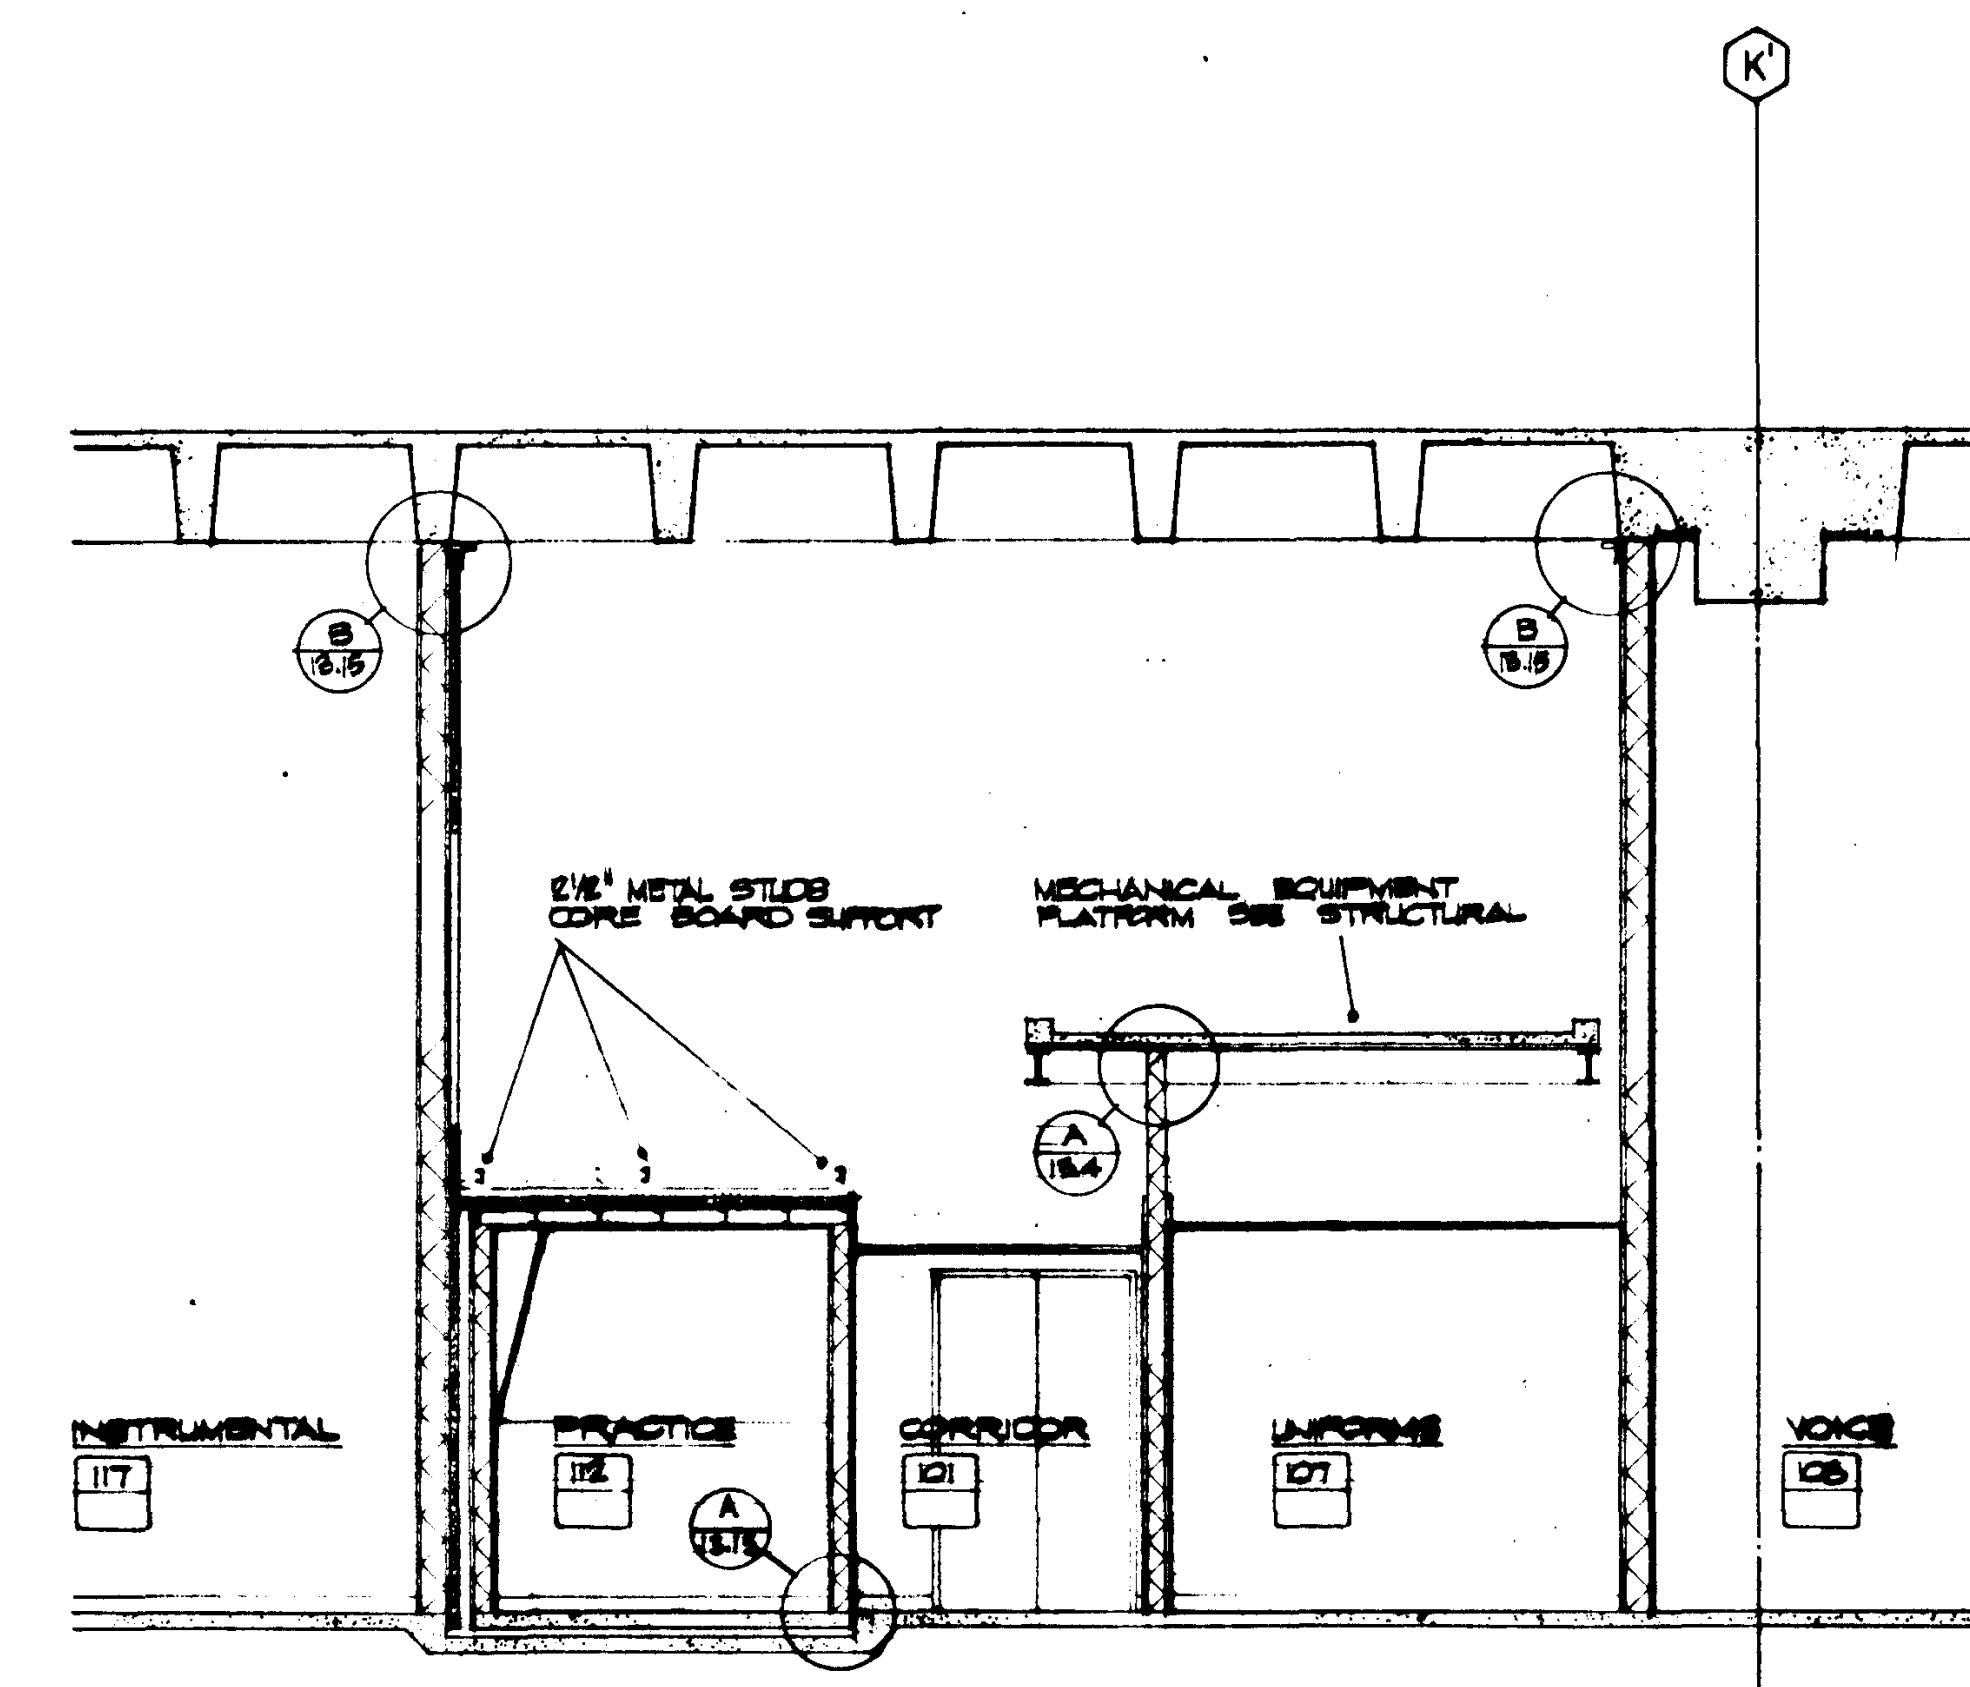
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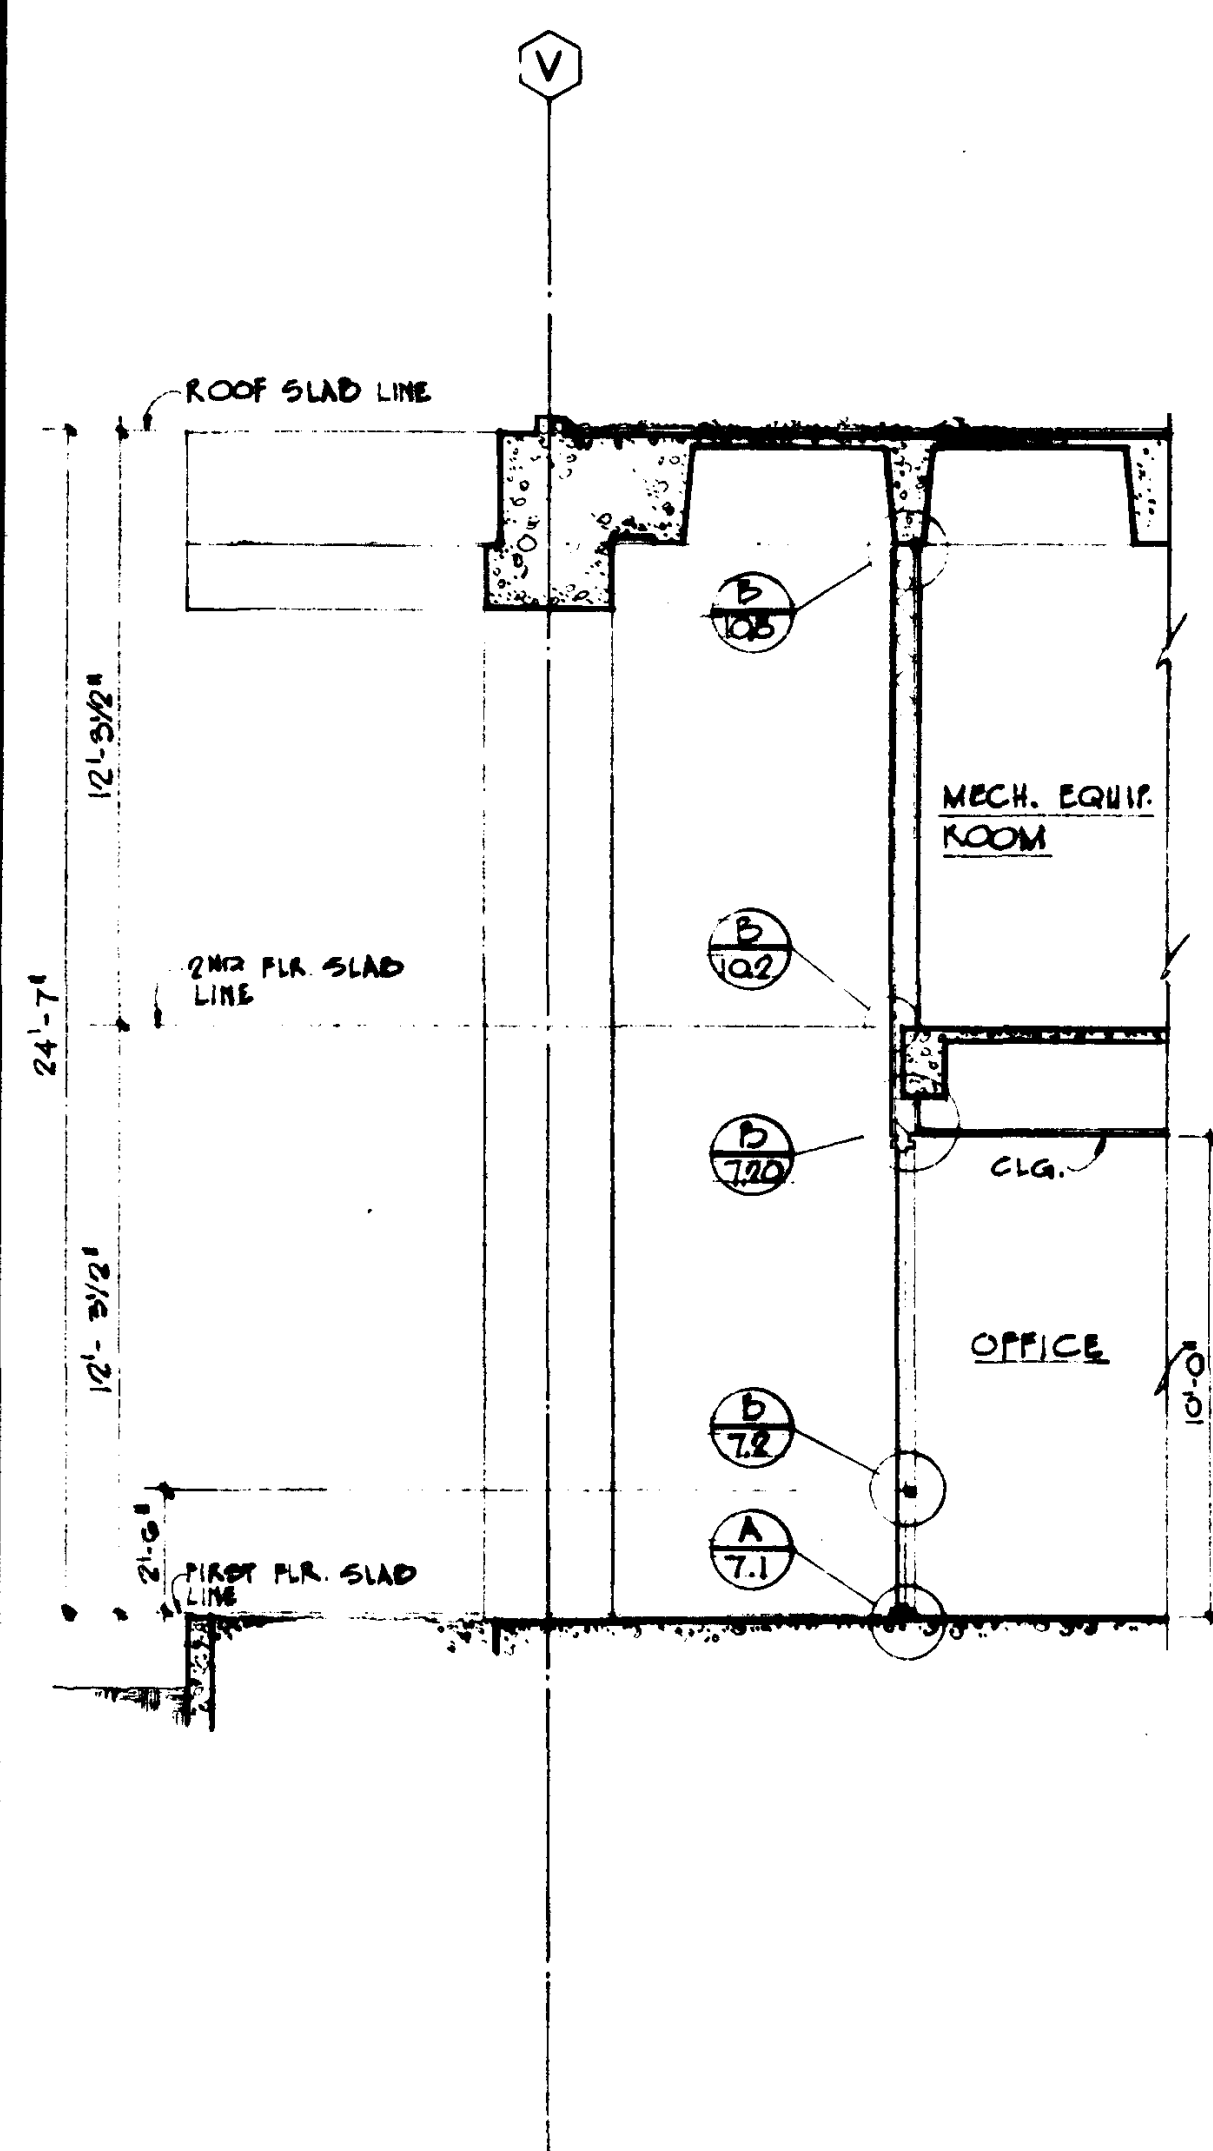
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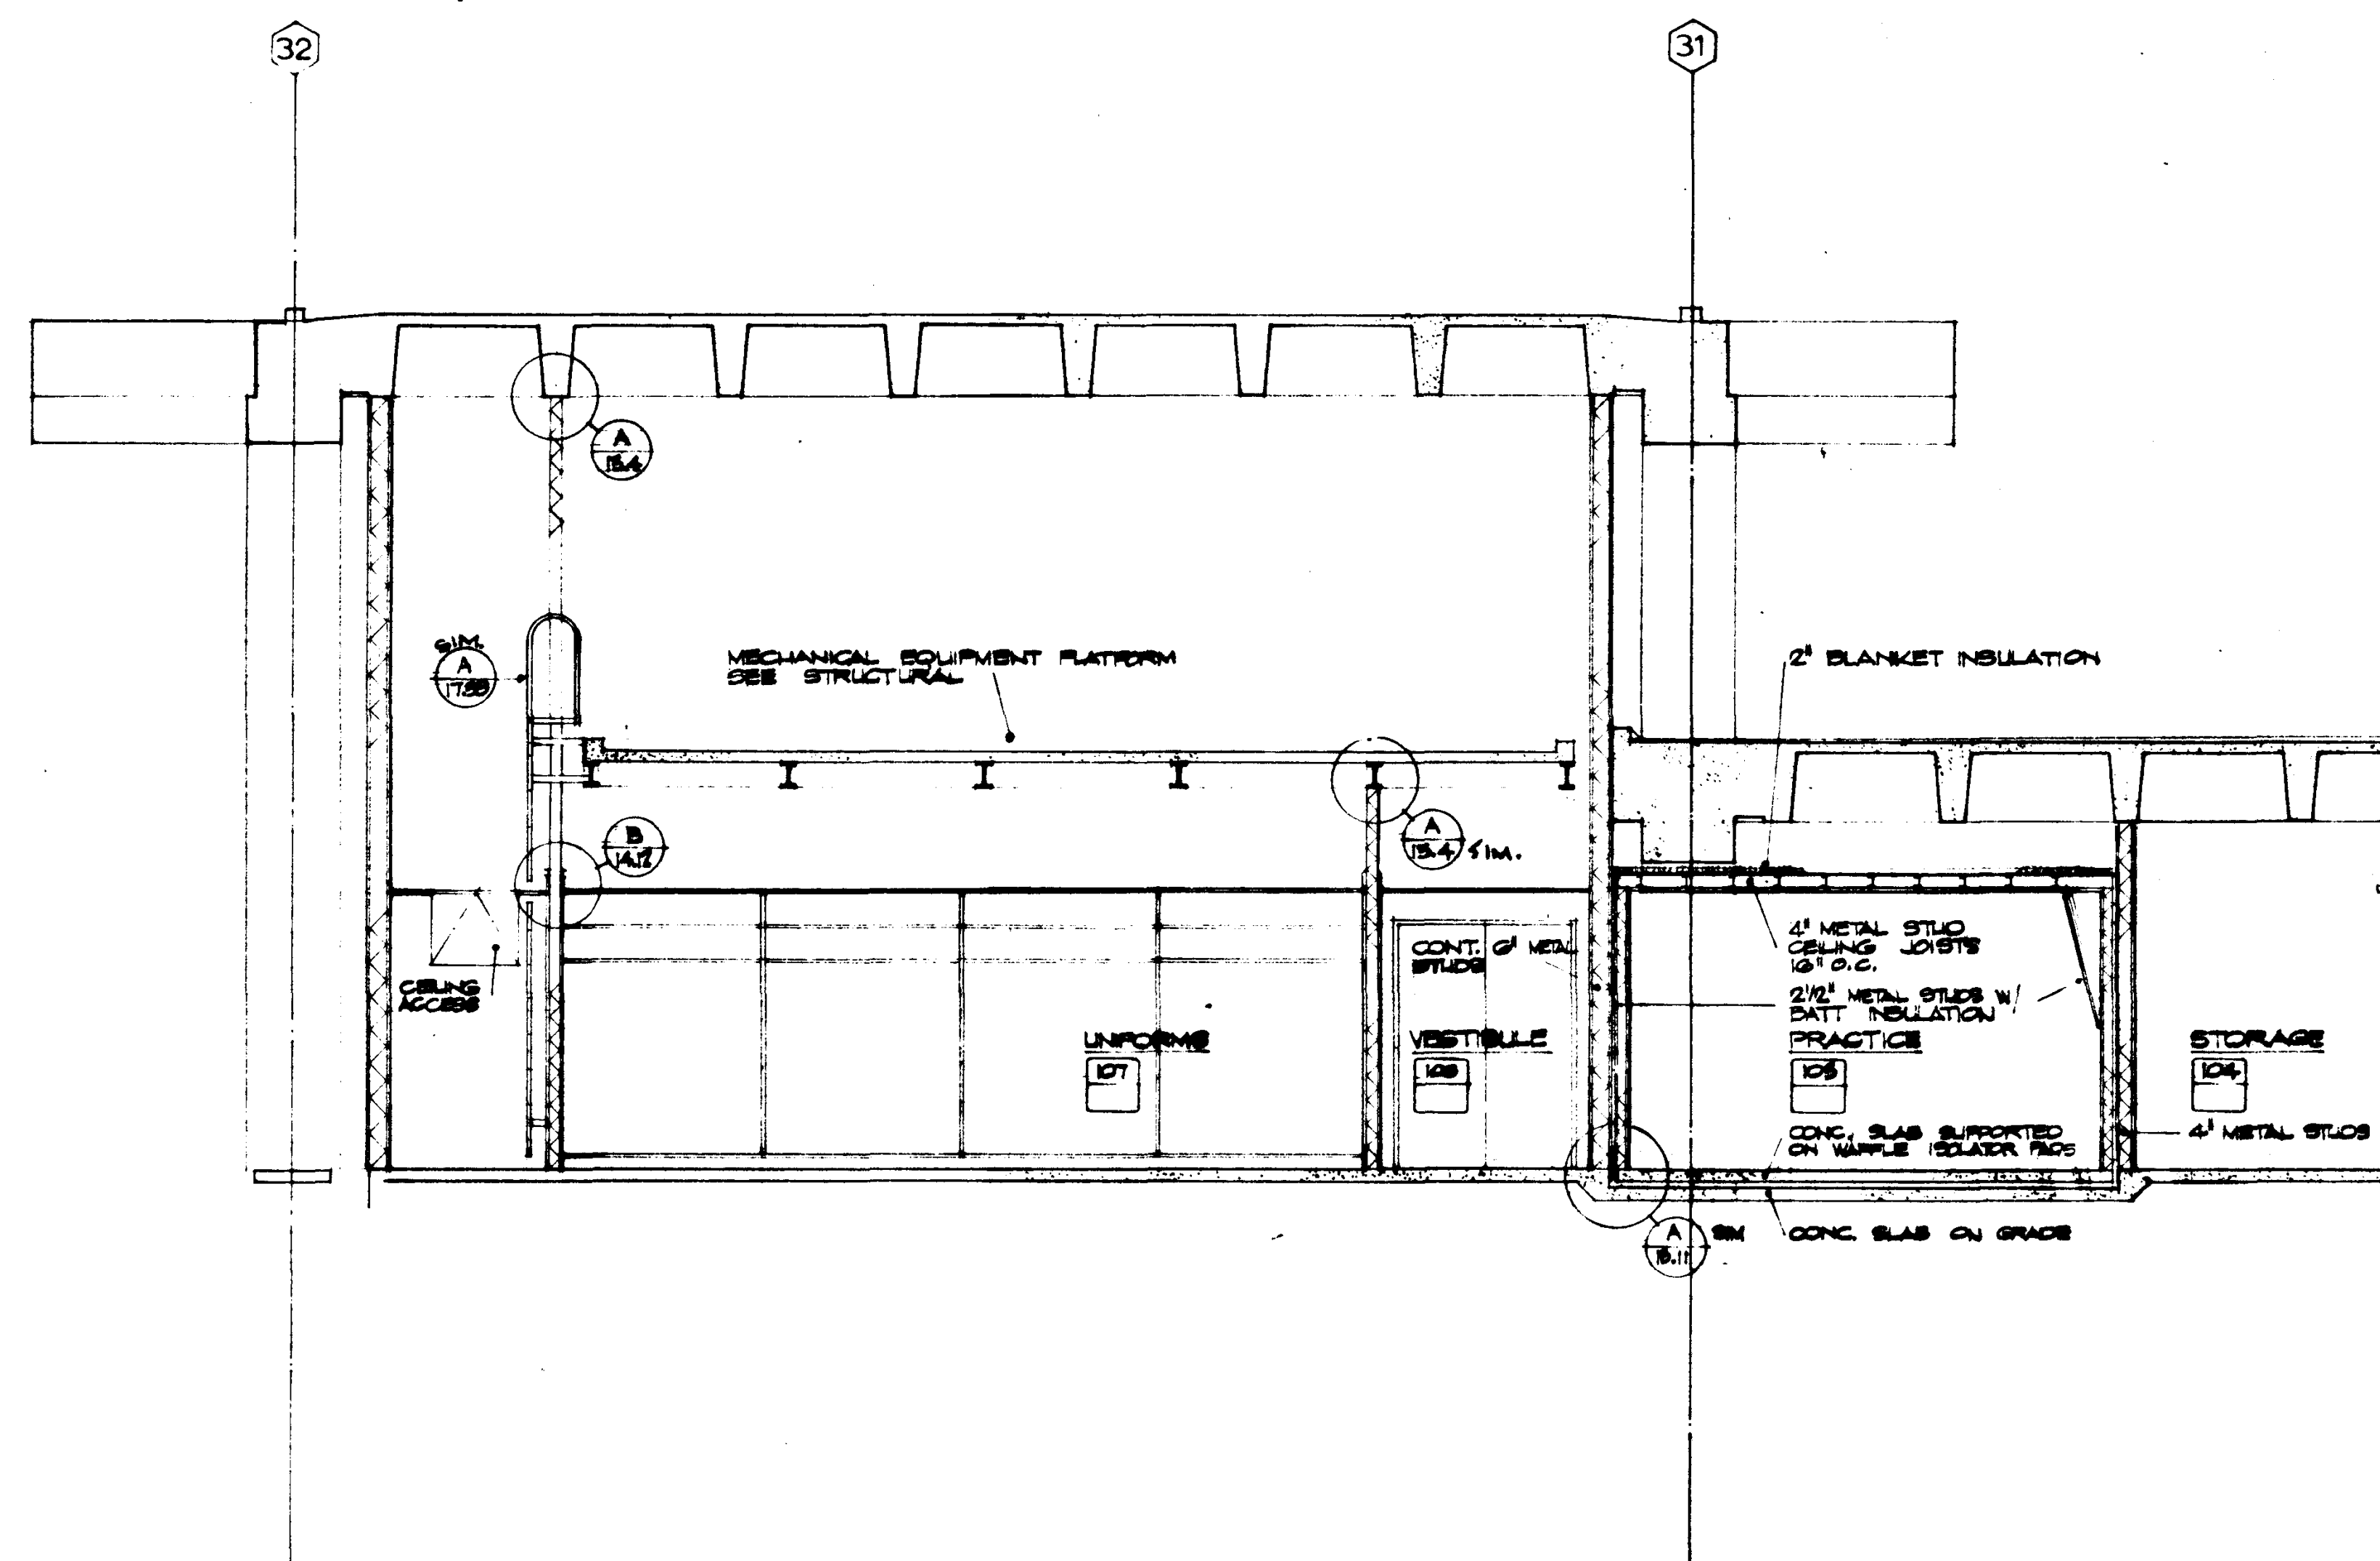
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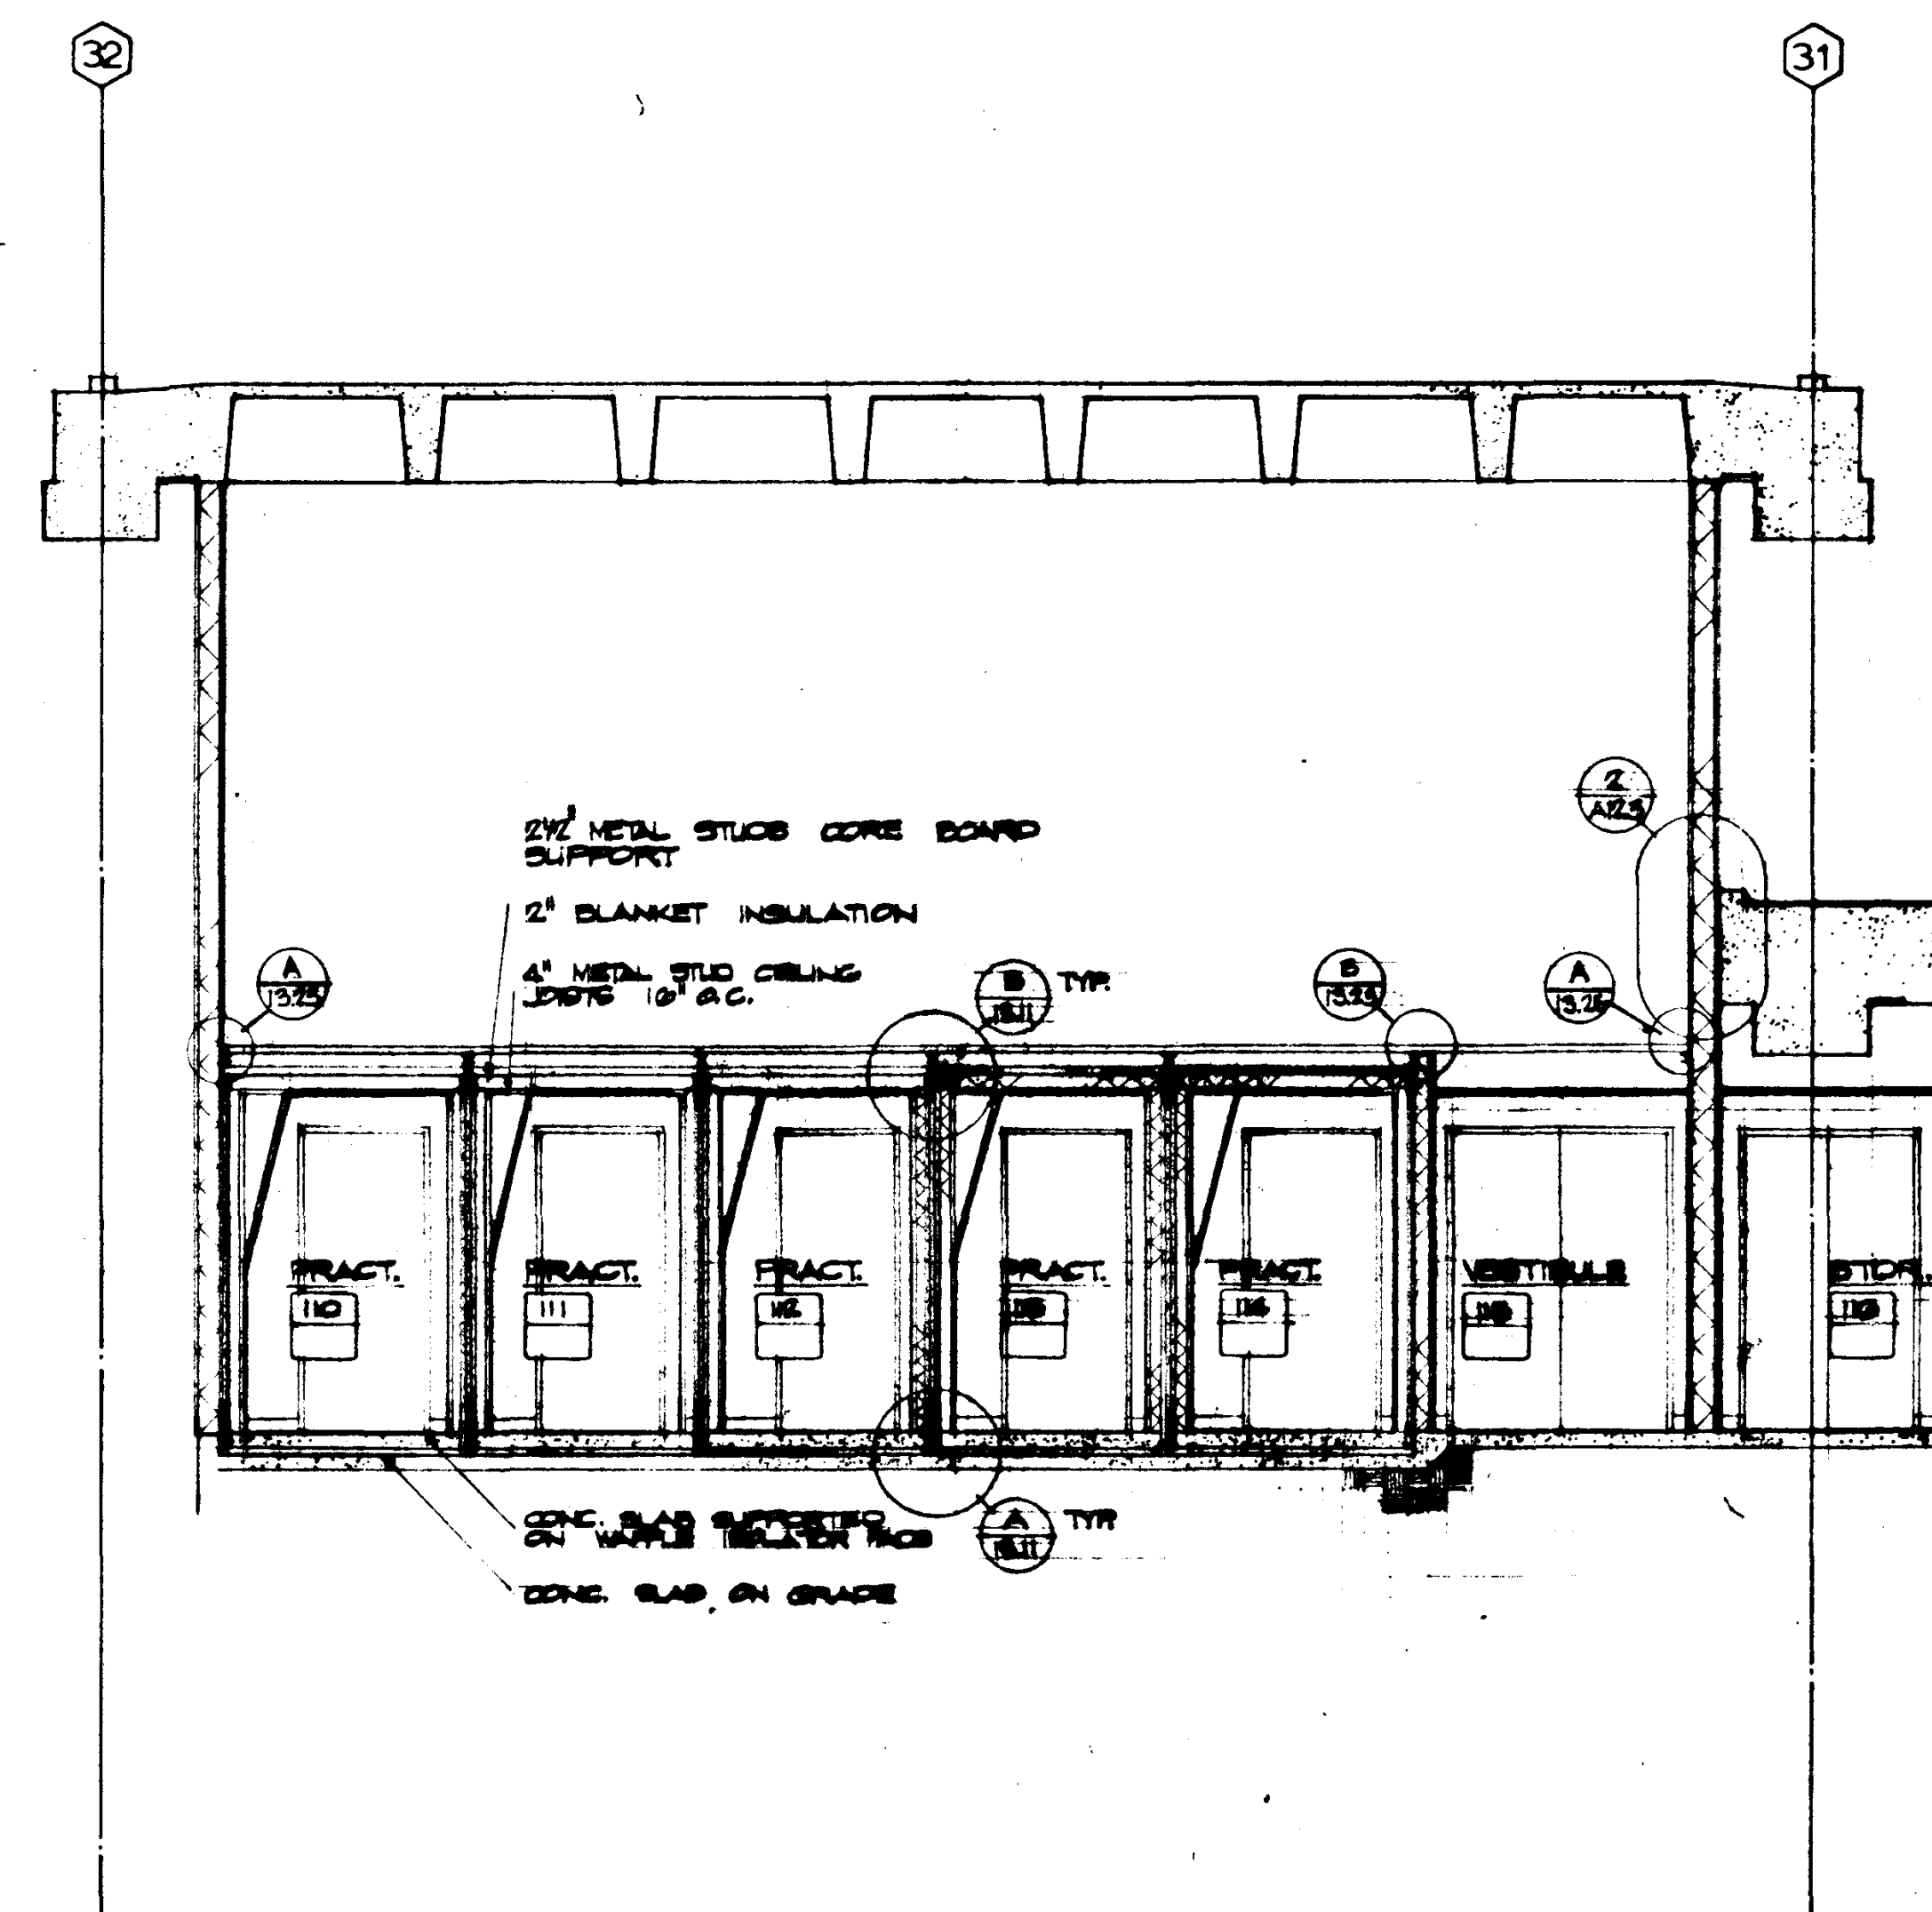
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SCALE 1/4" = 1'

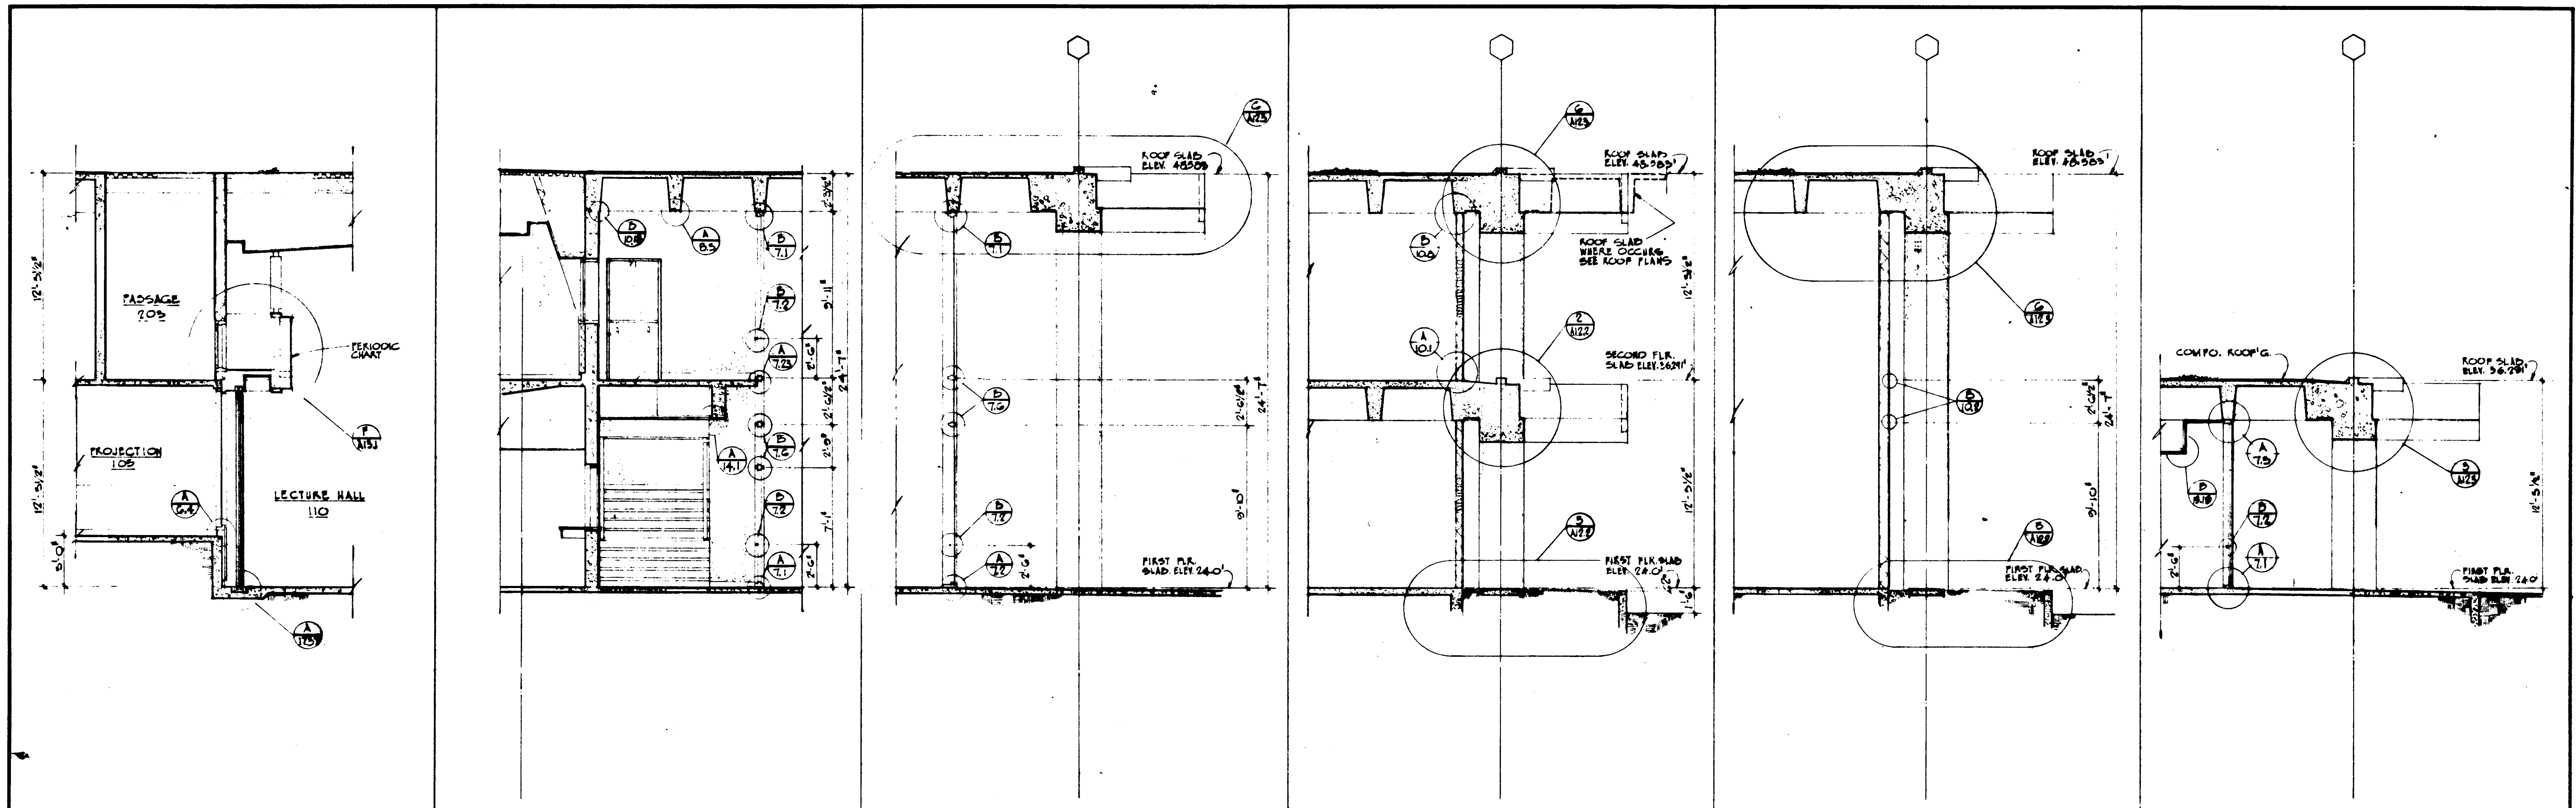

SECTION

SCALE 1/4" = 1'



SECTION

SCALE 1/4" = 1'

DATE	REVISIONS

STRUCTURAL ENGINEERS BRANDOW & JOHNSTON J. A. MARTIN & ASSOCIATES	DESIGNED JUL - M.J.	ARCHITECT WILLIAM L. FERREIRA & ASSOCIATES	APPROVED STATE OF CALIFORNIA DATE JUN 1965
MECHANICAL ENGINEERS RALPH E. PHILLIPS, INC.	DRAWN BY M.M.	ENGINEER	
ELECTRICAL ENGINEERS RALPH E. PHILLIPS, INC.	CHECKED BY	COLLEGE	
CIVIL ENGINEERS G. SHURMAN & ASSOCIATES MOFFATT & NICHOL			

DESIGNED JUL - M.J.	ARCHITECT WILLIAM L. FERREIRA & ASSOCIATES	APPROVED STATE OF CALIFORNIA DATE JUN 1965
DRAWN BY M.M.	ENGINEER	
CHECKED BY	COLLEGE	


APPROVED STATE OF CALIFORNIA DATE JUN 1965	25874

ASSOCIATED ARCHITECTS: WILLIAM L. FERREIRA & ASSOCIATES A. QUINCY JONES-FREDERICK E. EMMONS & ASSOCIATES BLUROCK ELLERSBROEK & ASSOCIATES	URBANUS SQUARE • MACARTHUR BOULEVARD AT FORD ROAD TELEPHONE 714/675-2640 • CORONA DEL MAR, CALIFORNIA
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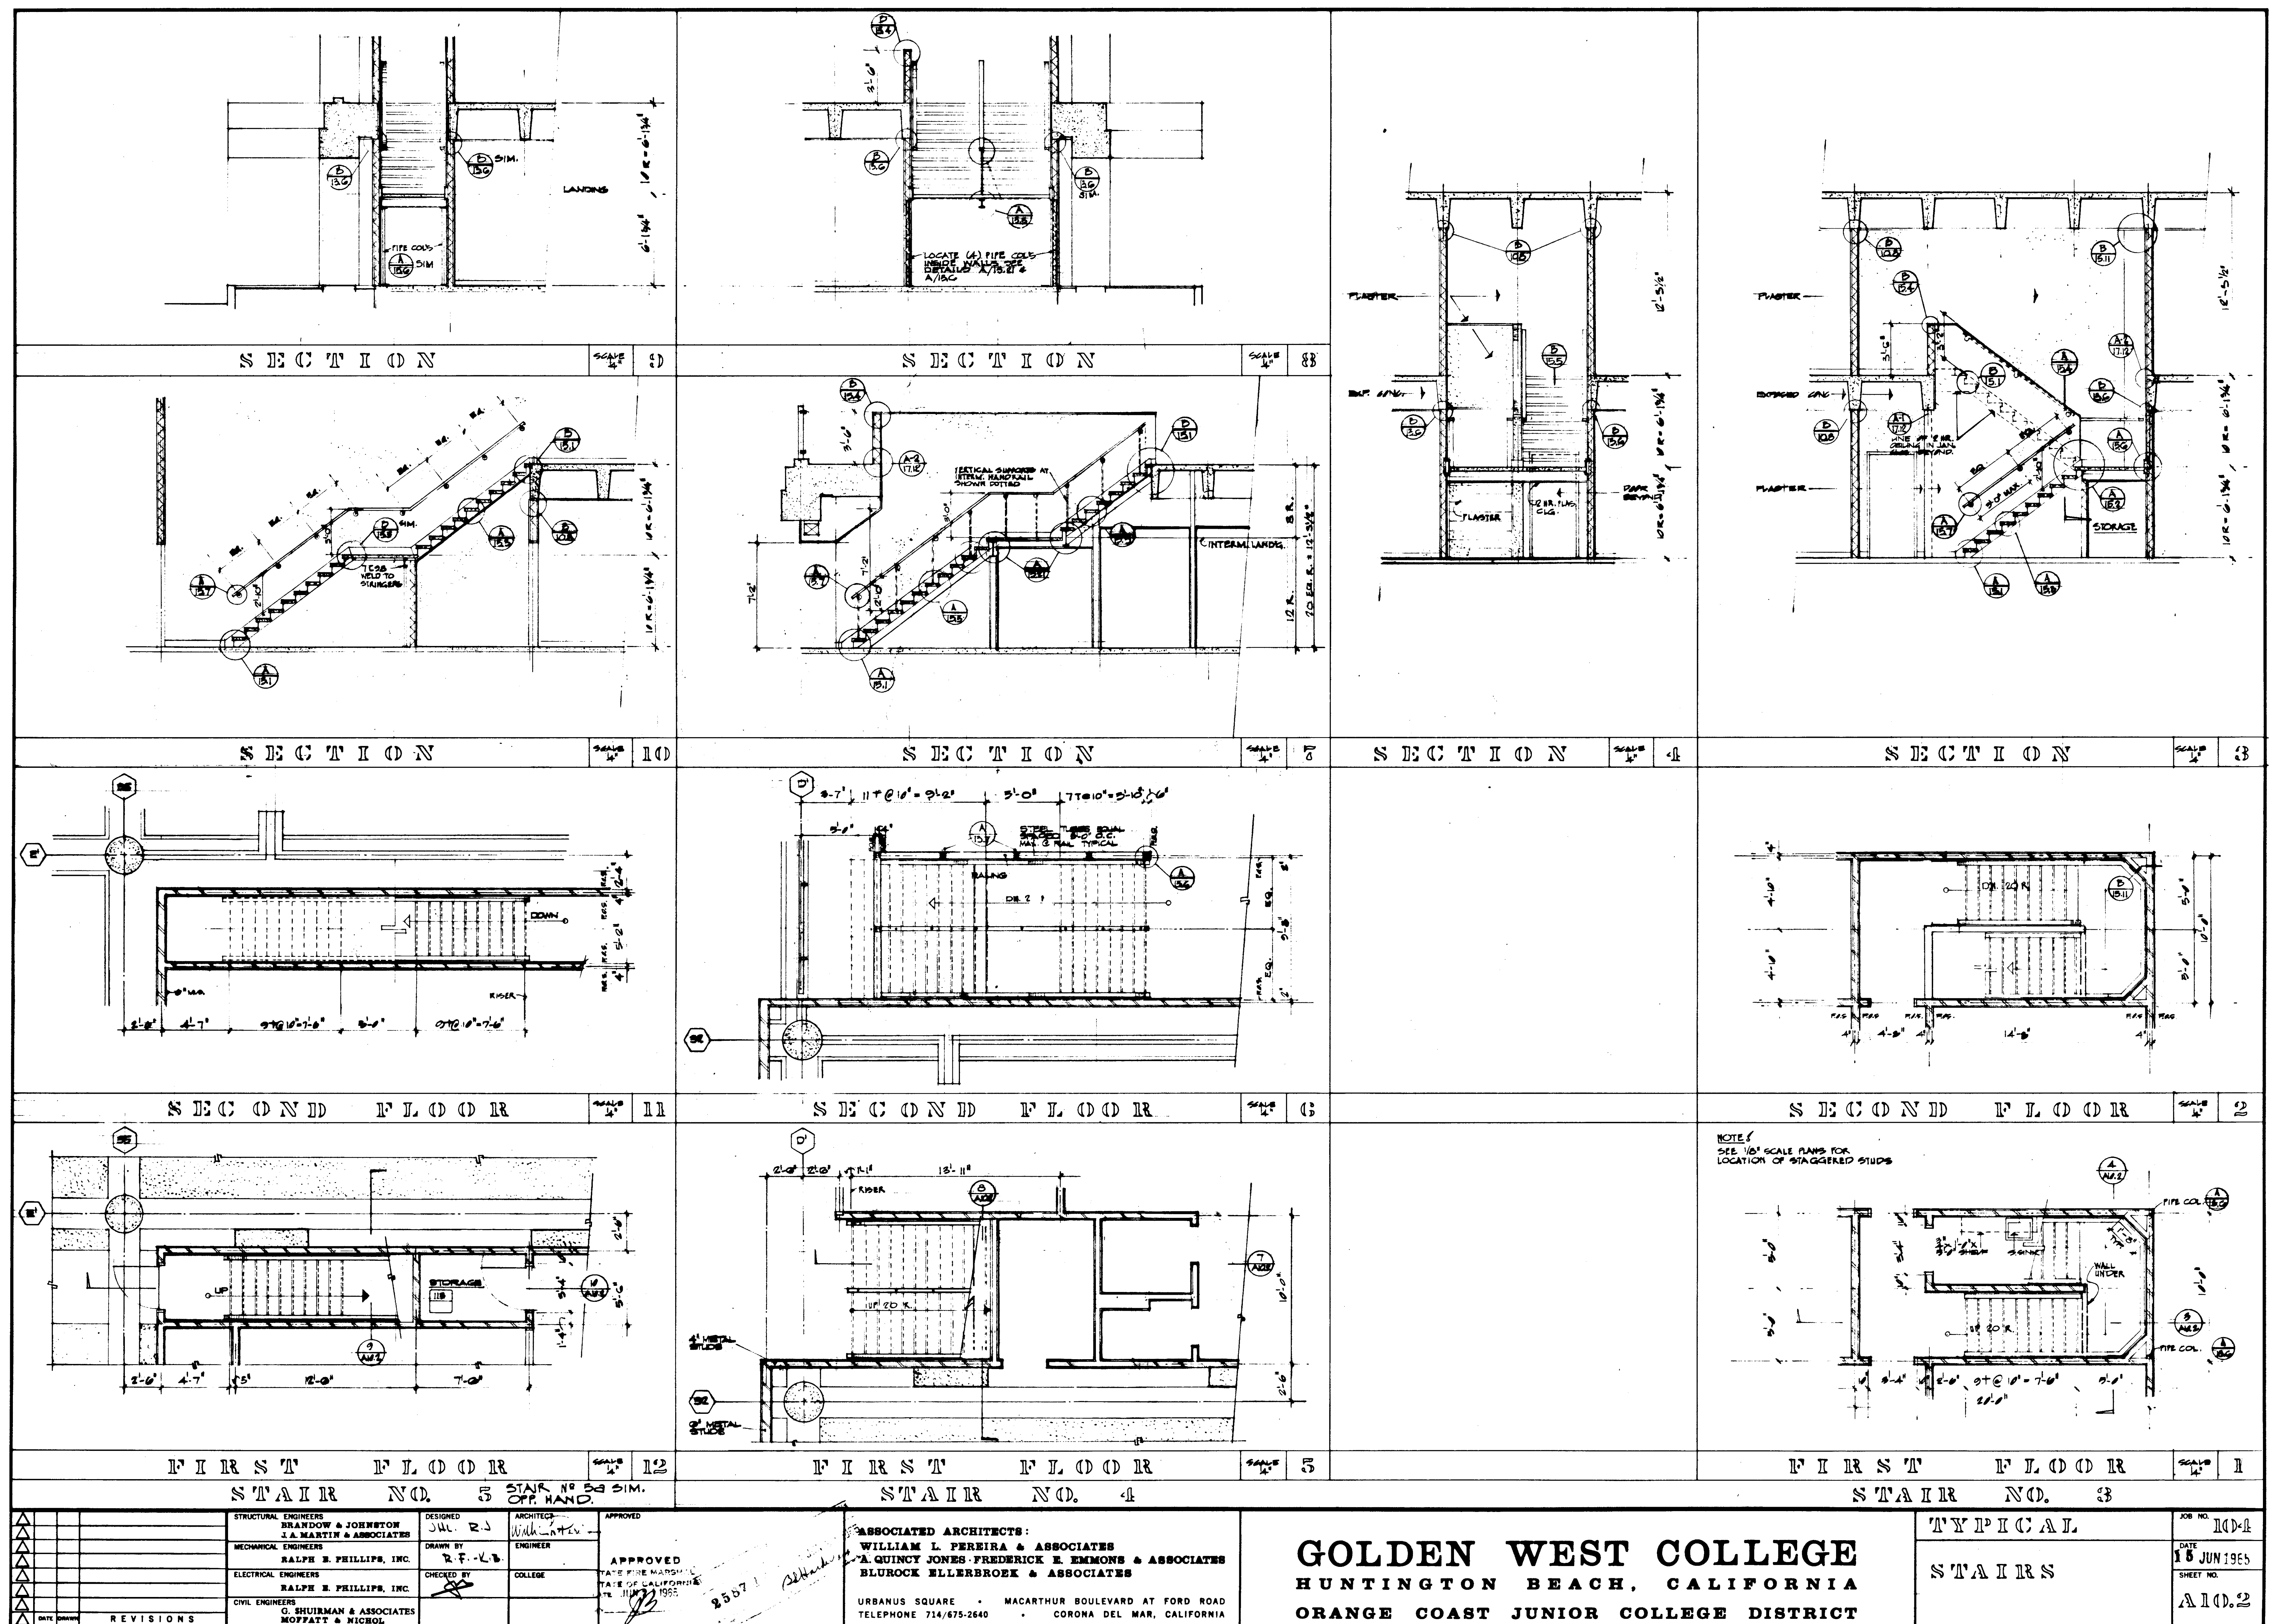
GOLDEN WEST COLLEGE
HUNTINGTON BEACH, CALIFORNIA
ORANGE COAST JUNIOR COLLEGE DISTRICT


WALL
SECTIONS

JOB NO. 100-1
DATE 15 JUN 1965
SHEET NO. A 9.3

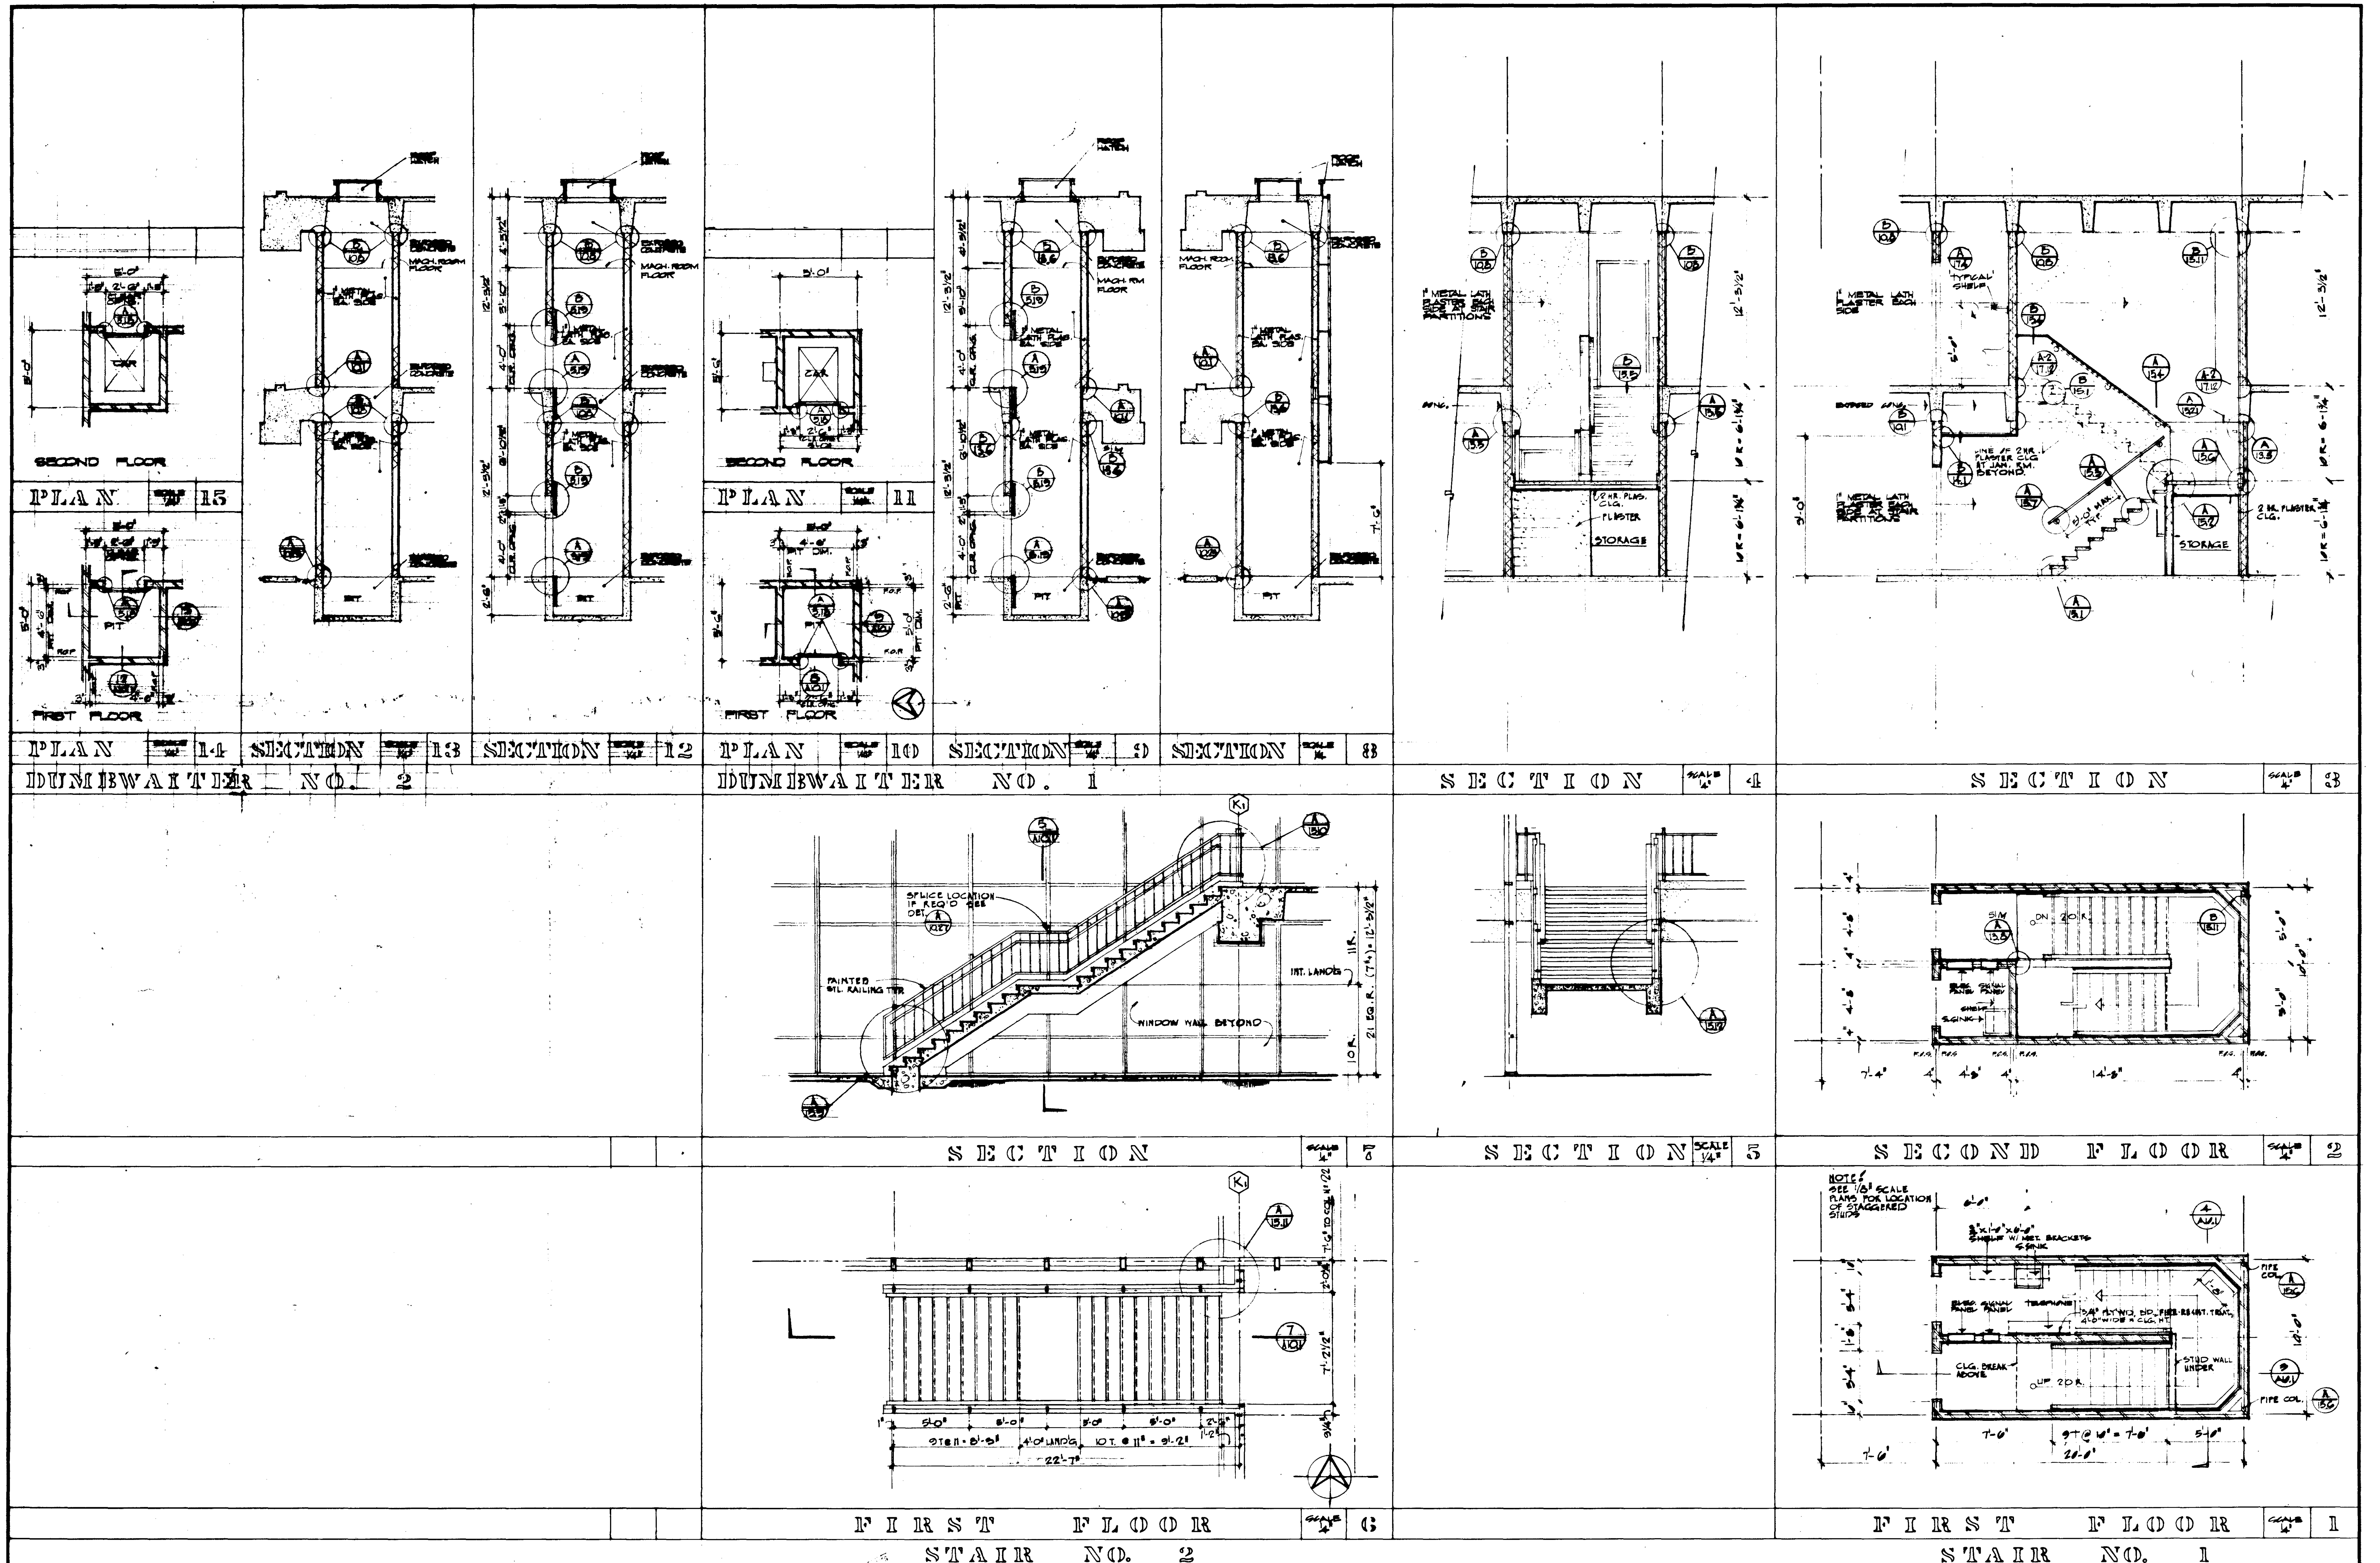


STRUCTURAL ENGINEERS BRANDOW & JOHNSON 11111 1/2 STREET HUNTINGTON BEACH, CALIF. 92648				DESIGNED J.M. D.J. DRAWN BY R.P.F.				ARCHITECTS WILLIAM L. PEREIRA & ASSOCIATES A. QUINCY JONES-FREDERICK E. EMMONS & ASSOCIATES BLUROCK ELLERBROCK & ASSOCIATES				APPROVED STATE FIRE MARSHAL STATE OF CALIFORNIA DATE JUN 11 1965				GOLDEN WEST COLLEGE HUNTINGTON BEACH, CALIFORNIA ORANGE COAST JUNIOR COLLEGE DISTRICT				TYPICAL STAIRS DUNNIBWAITERS AND 1				JOB NO. 10-1 DATE JUN 1965 SHEET NO.			
MECHANICAL ENGINEERS RALPH E. PHILLIPS, INC. 11111 1/2 STREET HUNTINGTON BEACH, CALIF. 92648				ELECTRICAL ENGINEERS RALPH E. PHILLIPS, INC. 11111 1/2 STREET HUNTINGTON BEACH, CALIF. 92648				CIVIL ENGINEERS G. SHUTMAN & ASSOCIATES MOFFATT & MICROL				URBANUS SQUARE • MACARTHUR BOULEVARD AT FORD ROAD TELEPHONE 714/675-2640 • CORONA DEL MAR, CALIFORNIA				35874				REVISIONS				10-1			



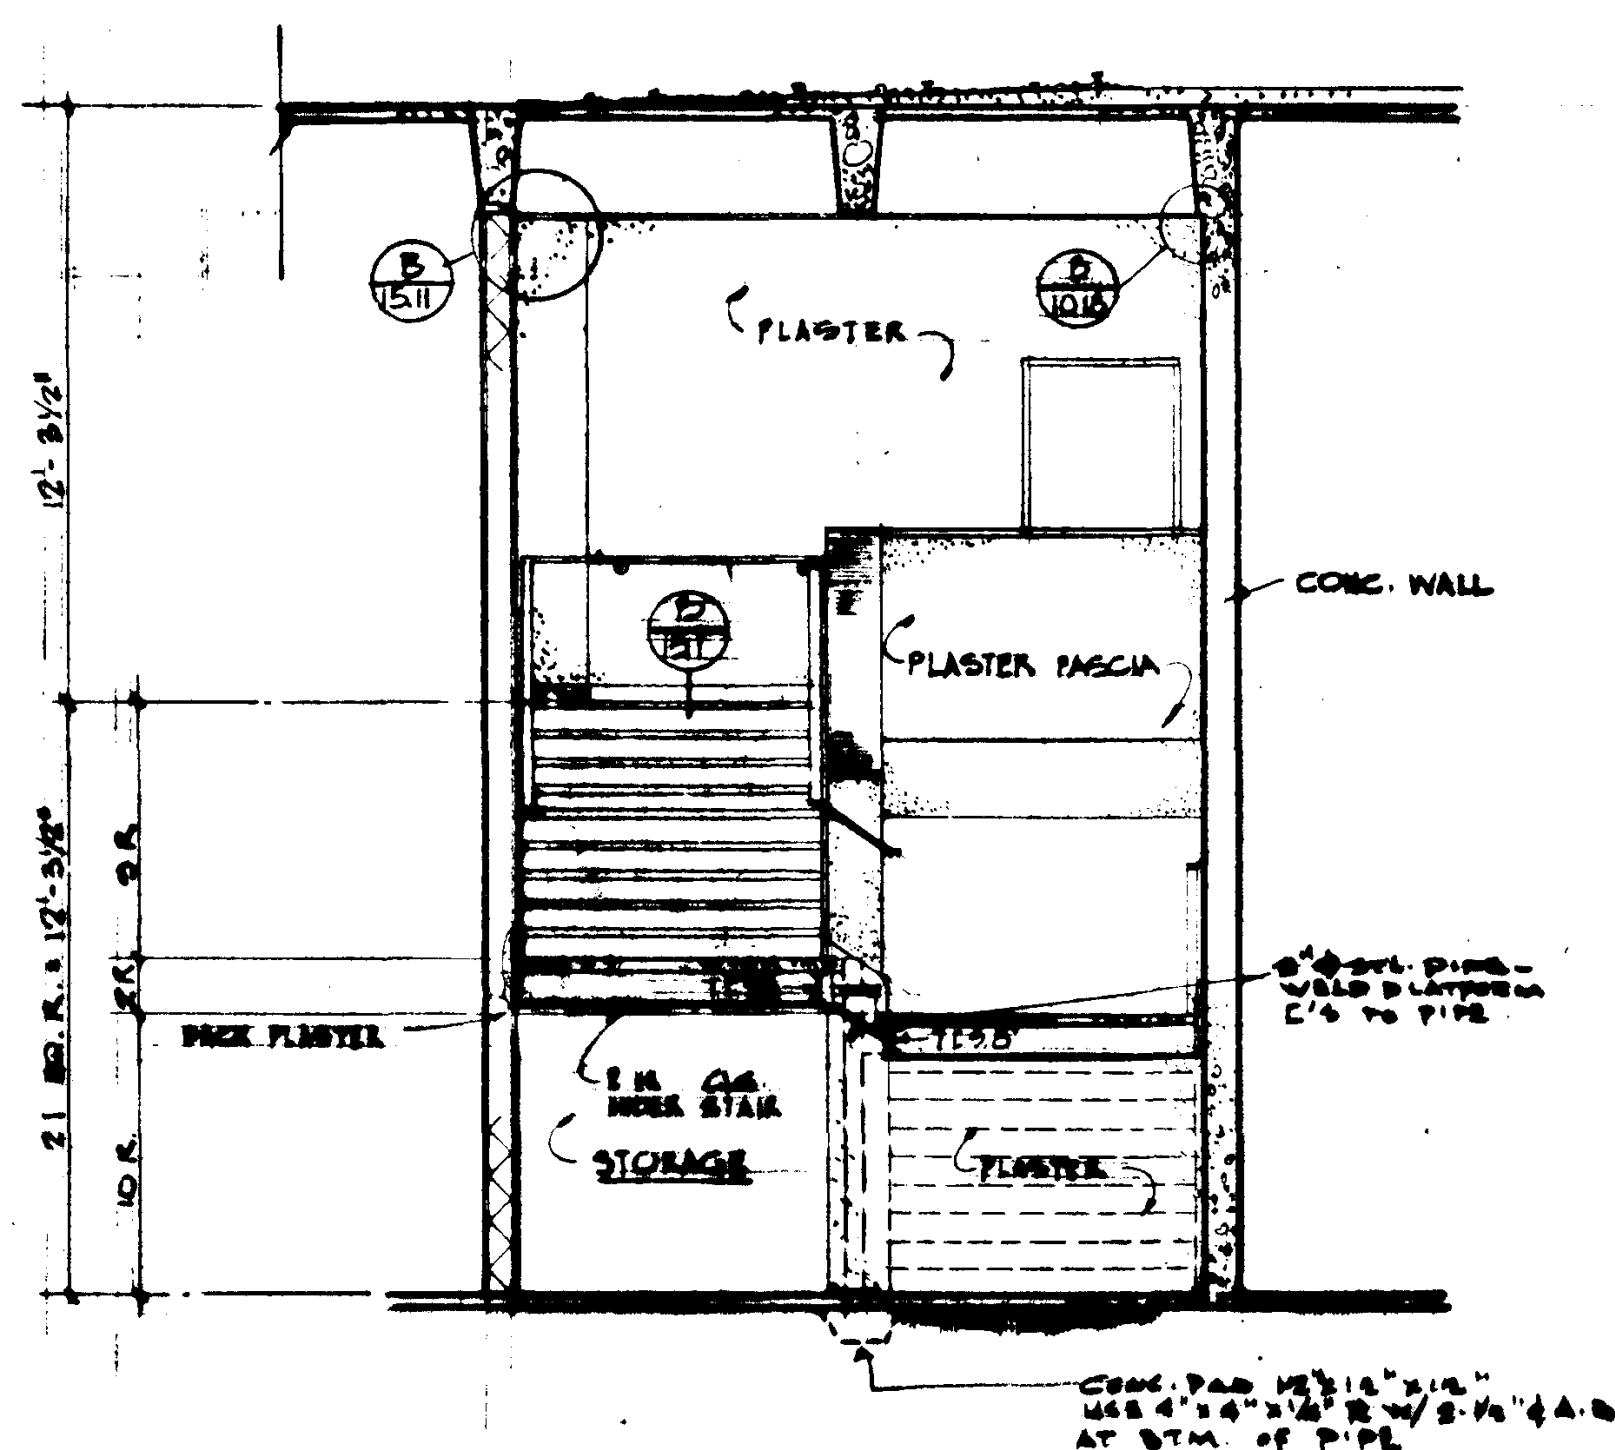


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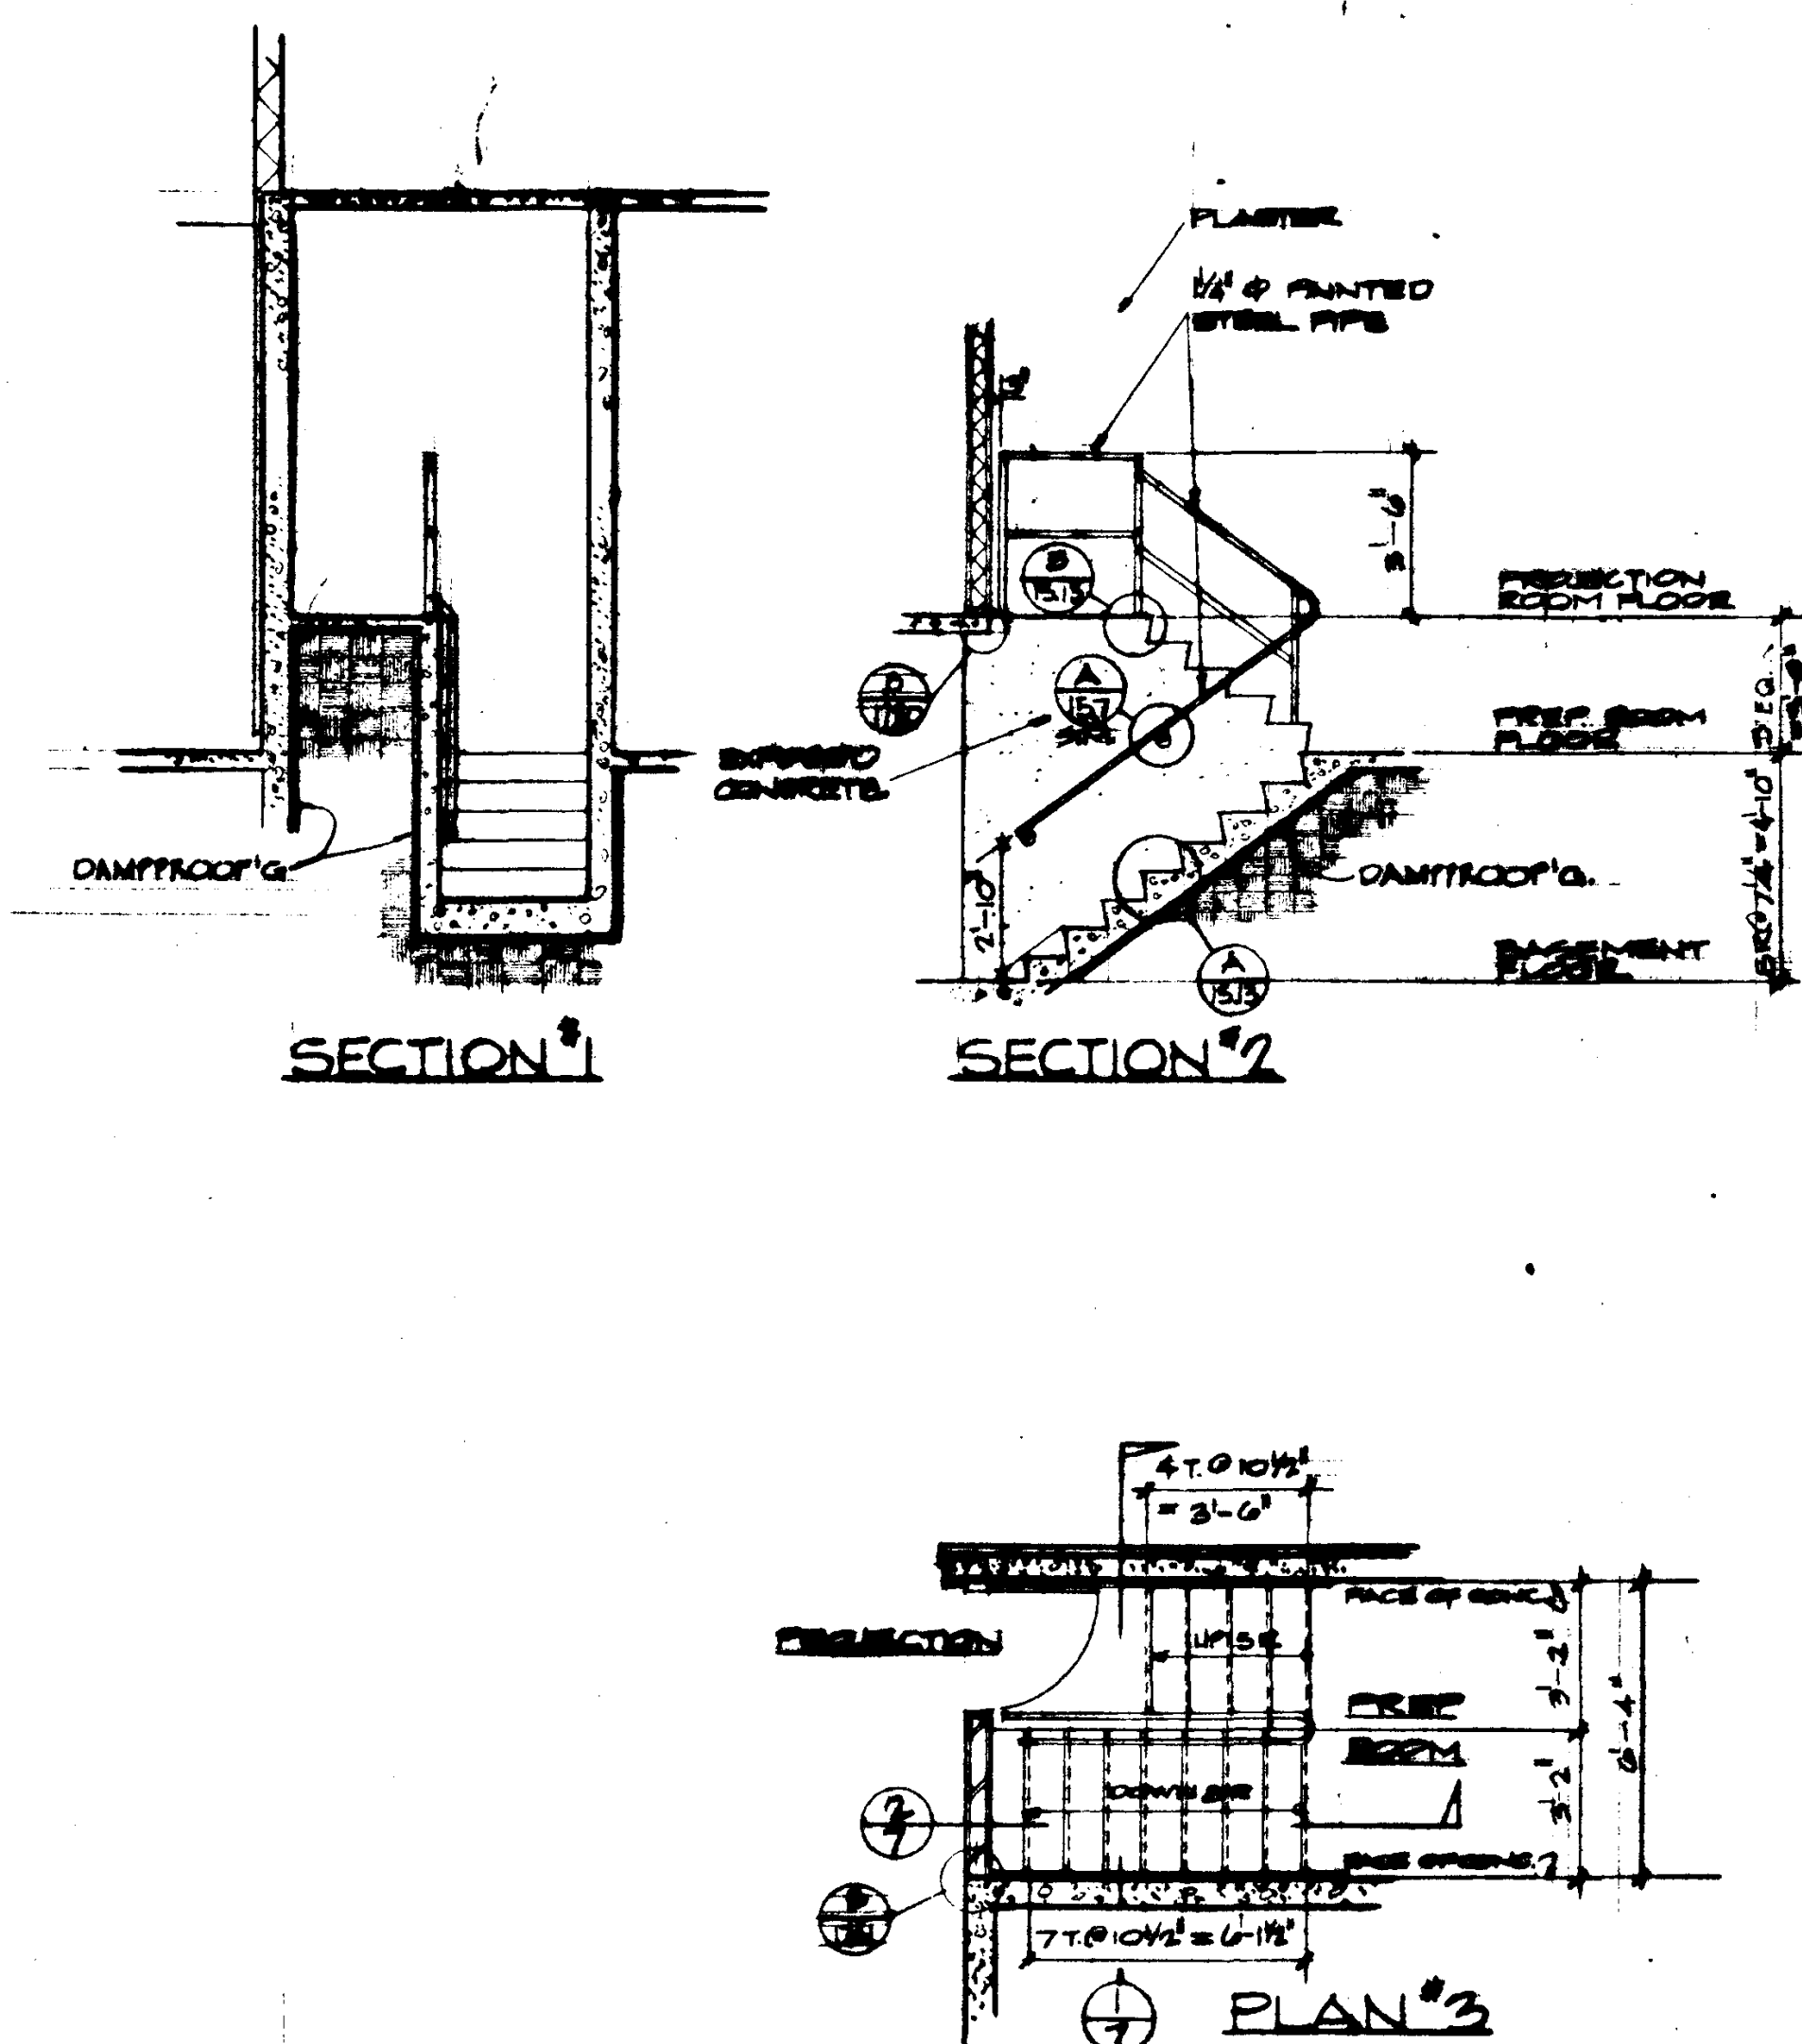
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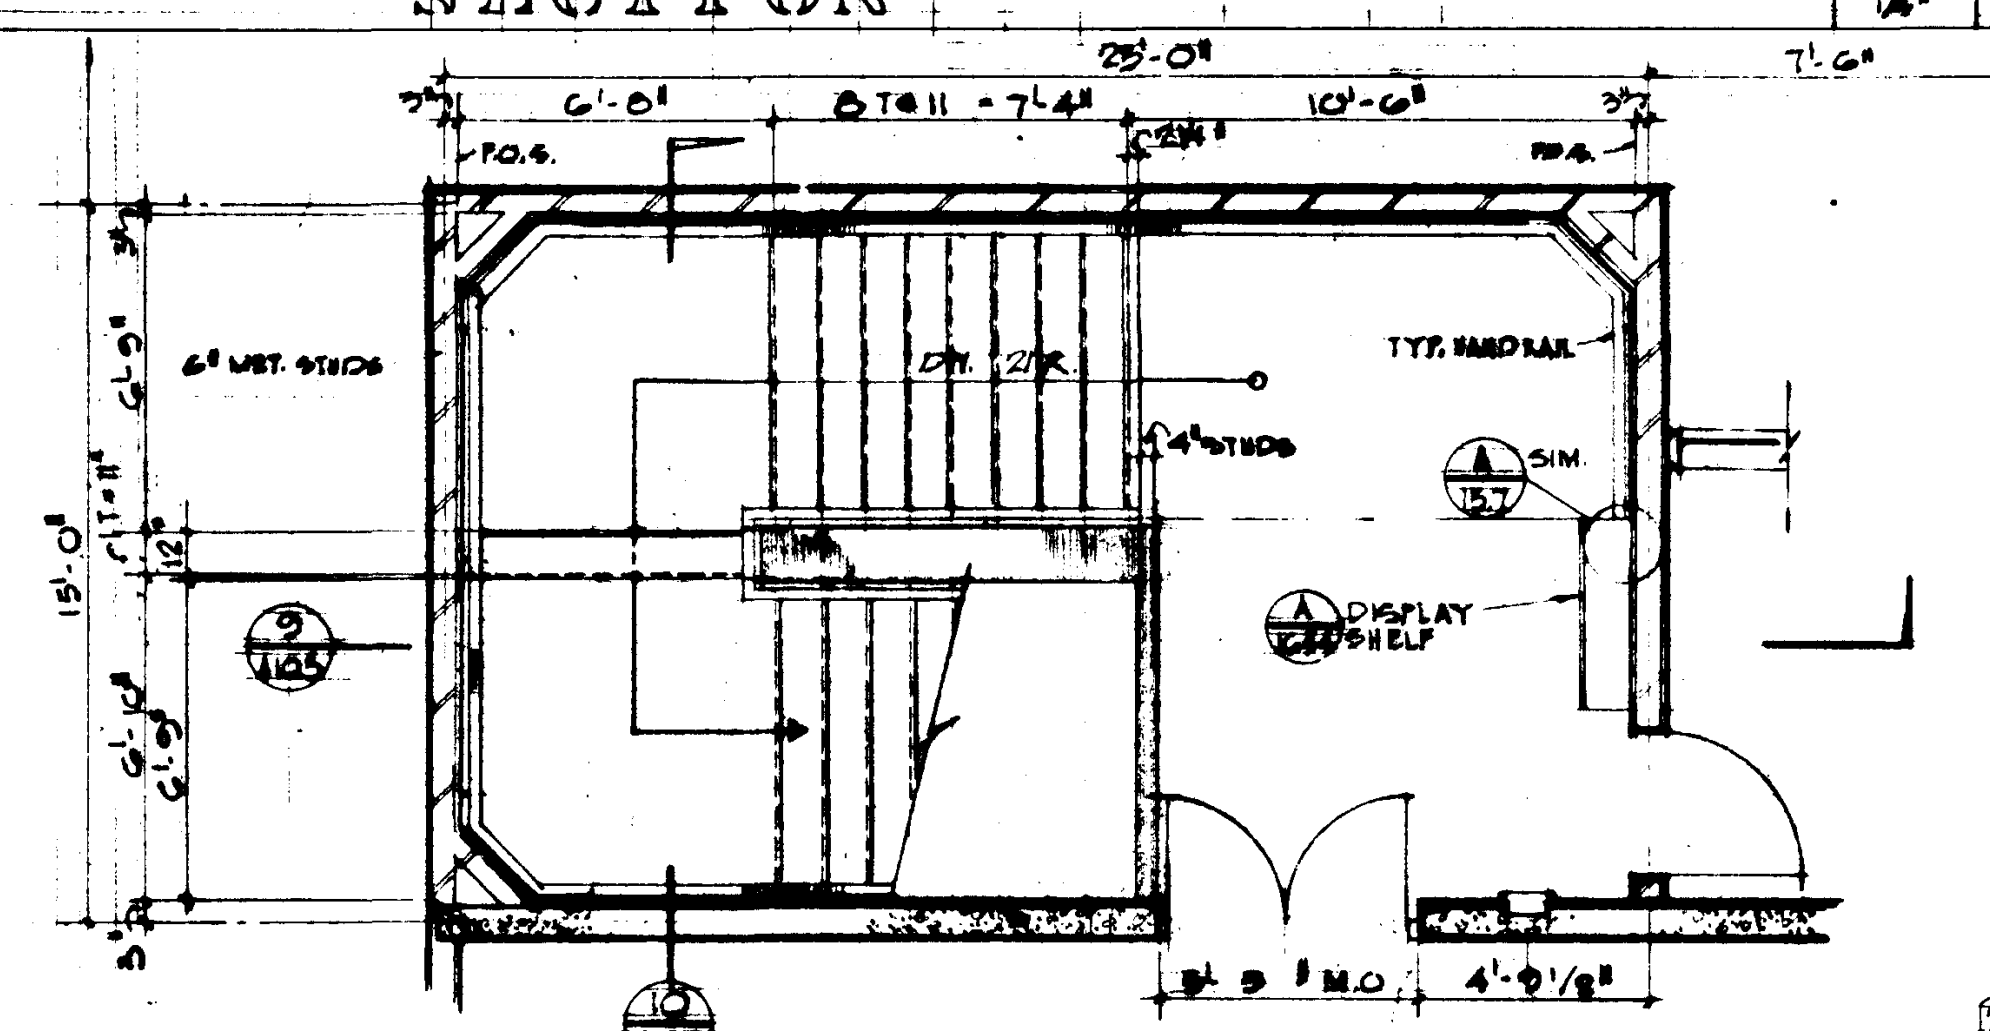
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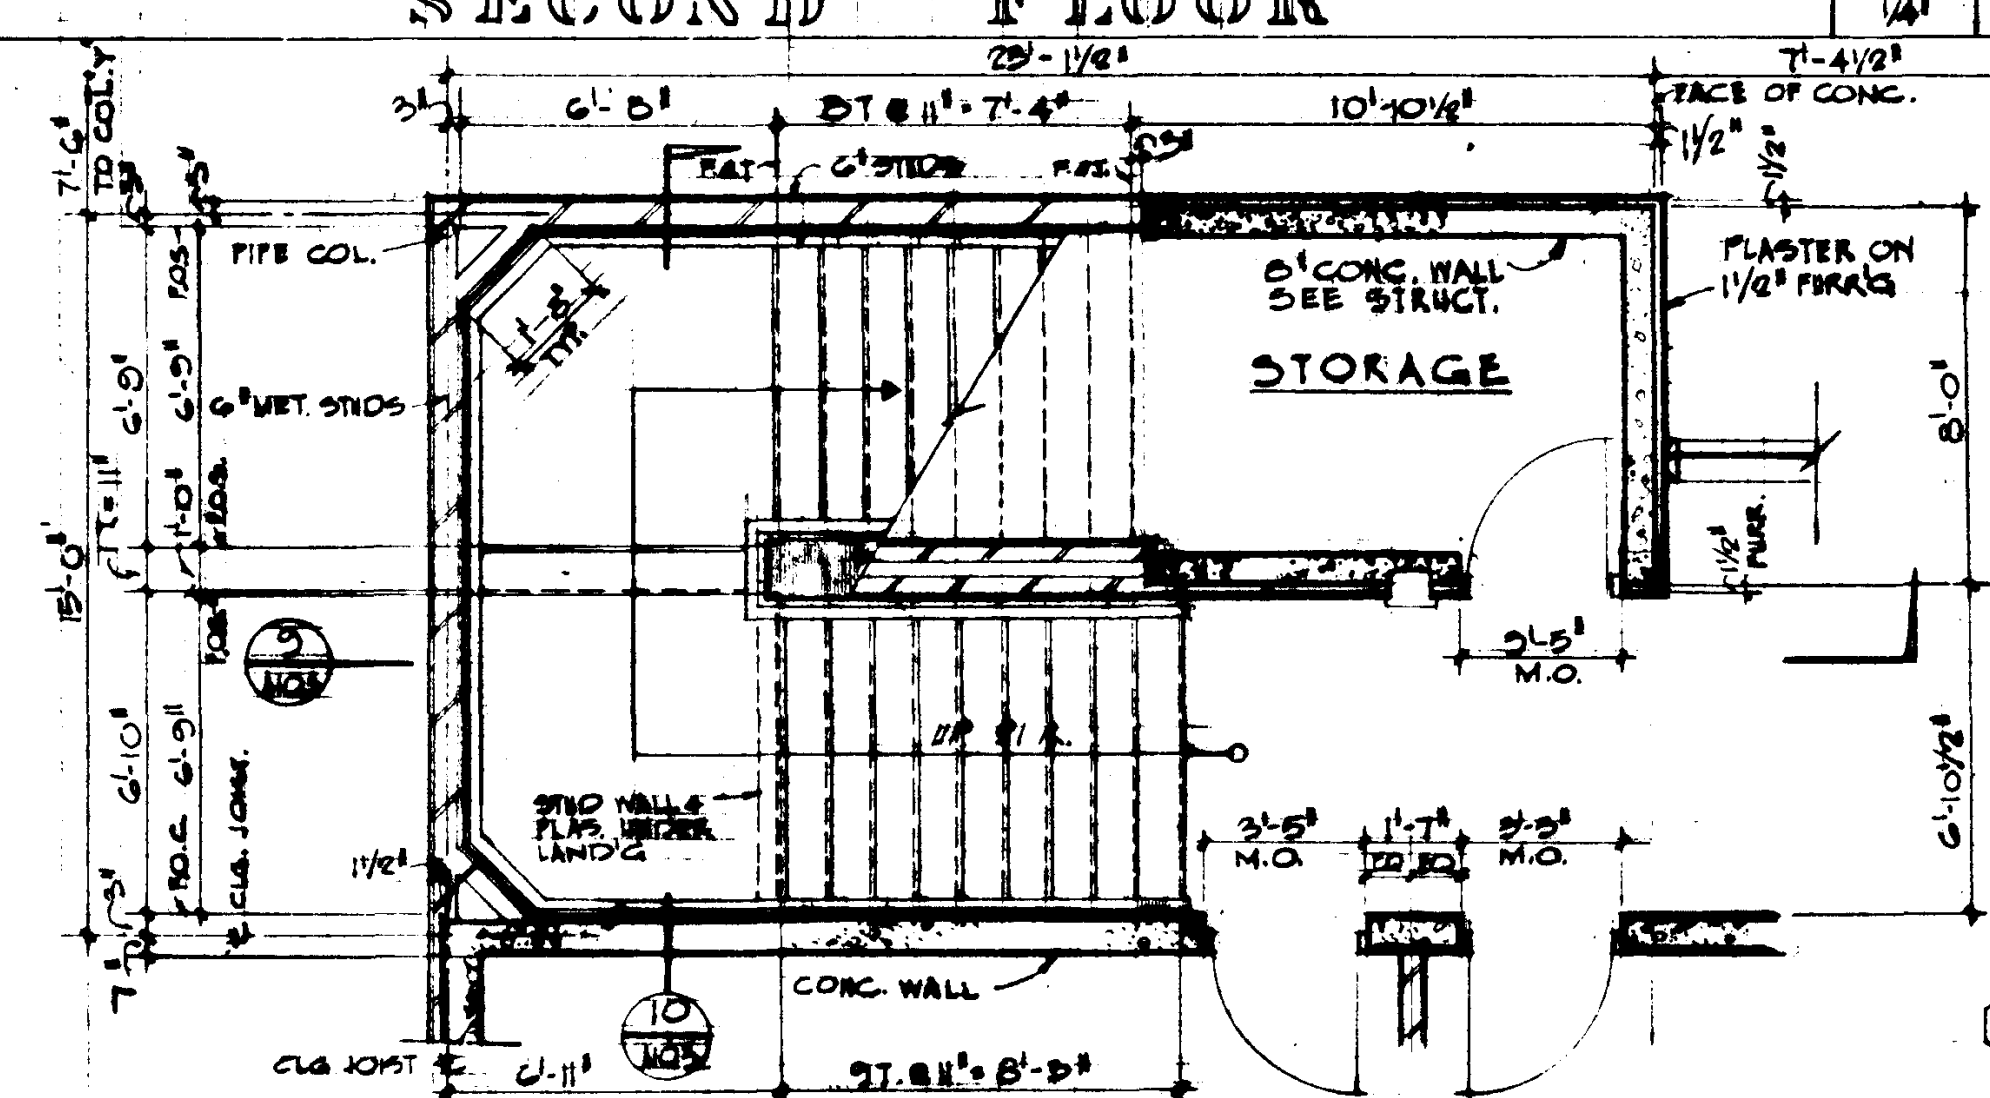
STAIR NO. 8

STAIR 8-A OPPOSITE HAND

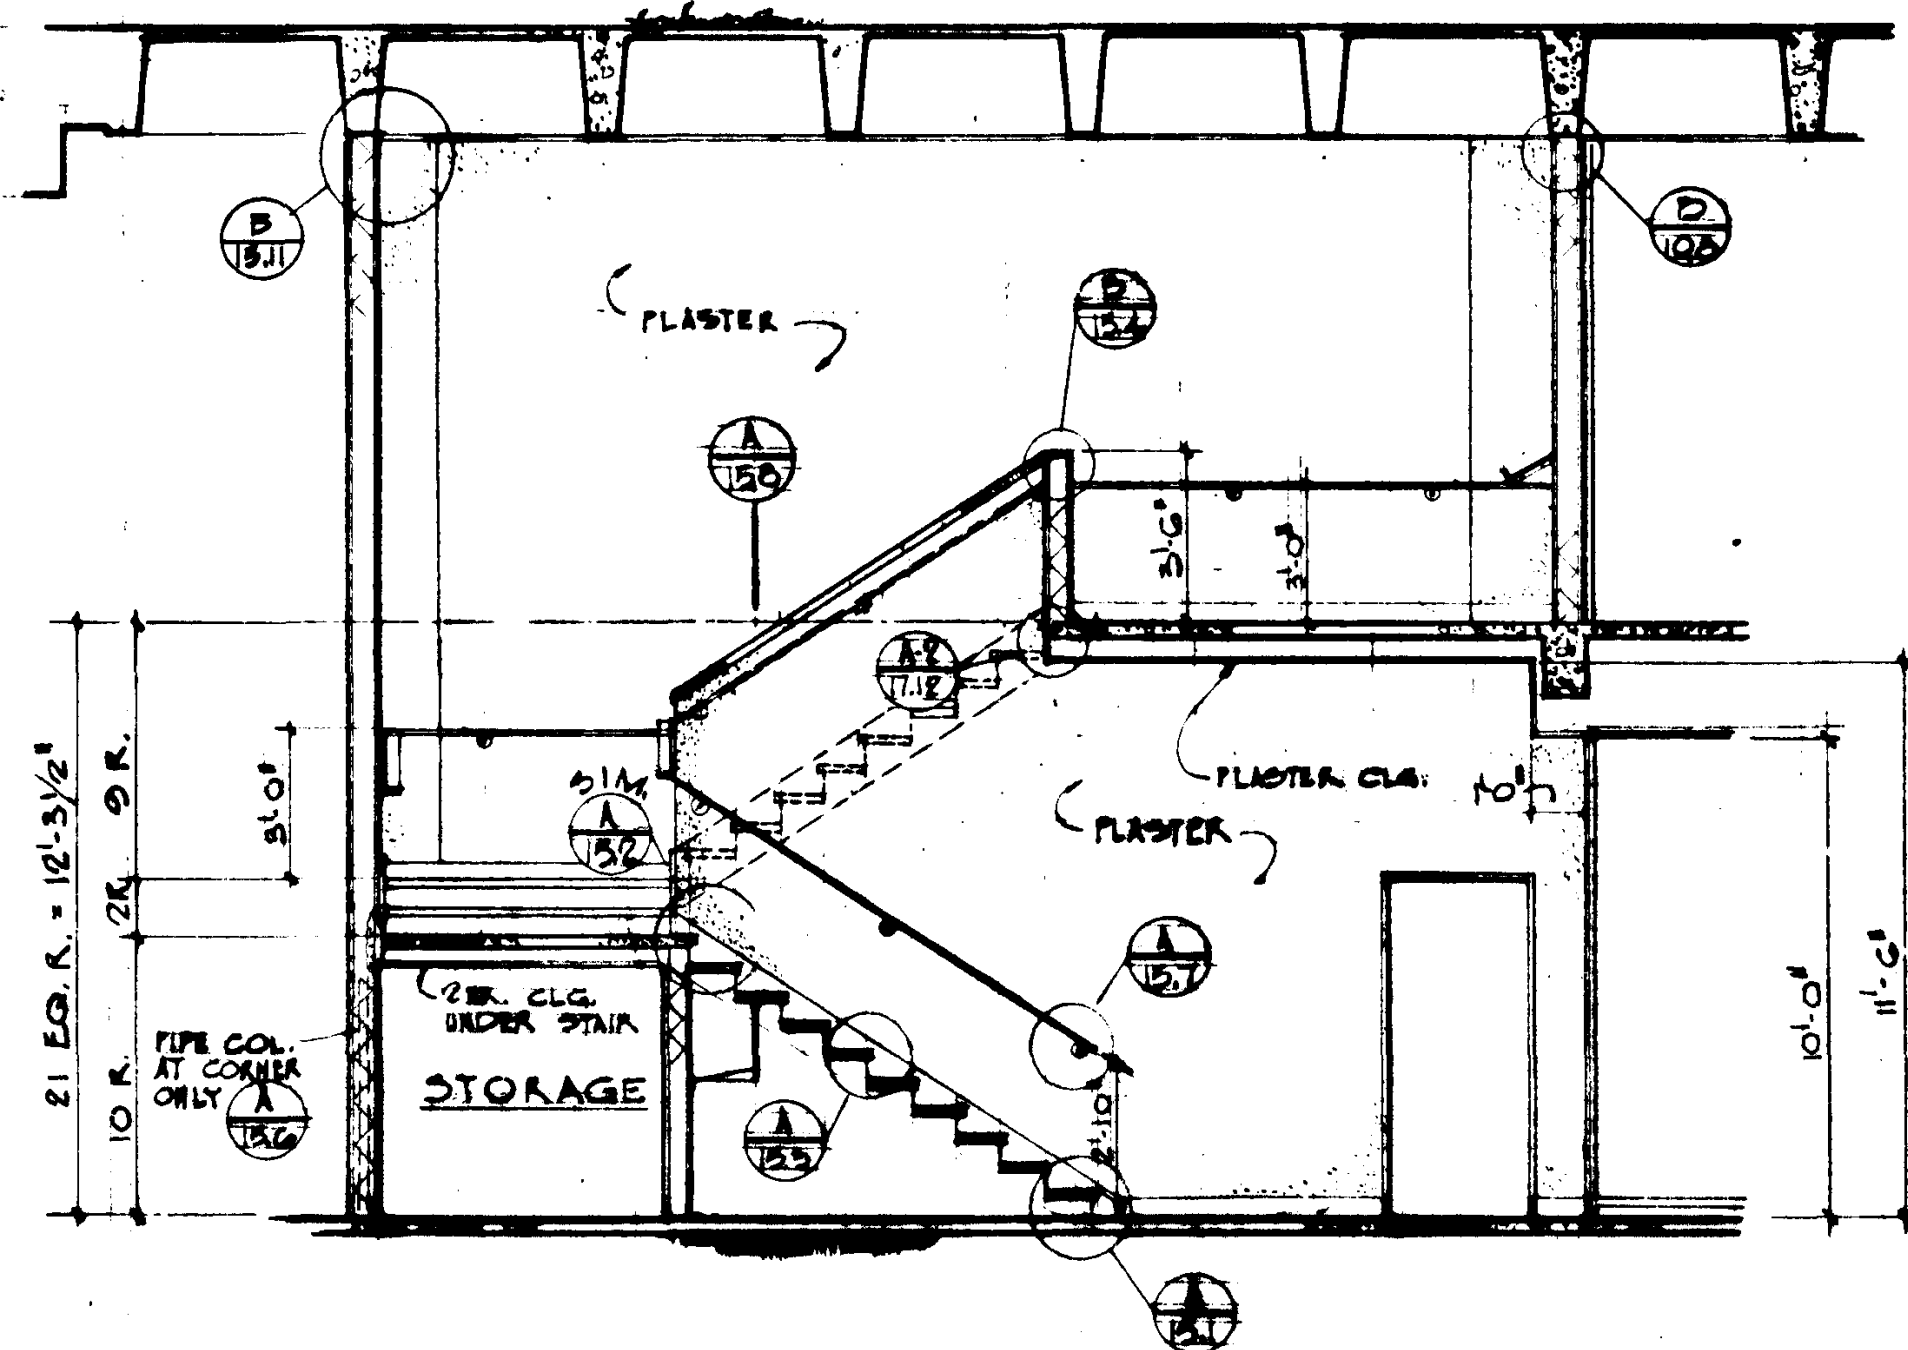


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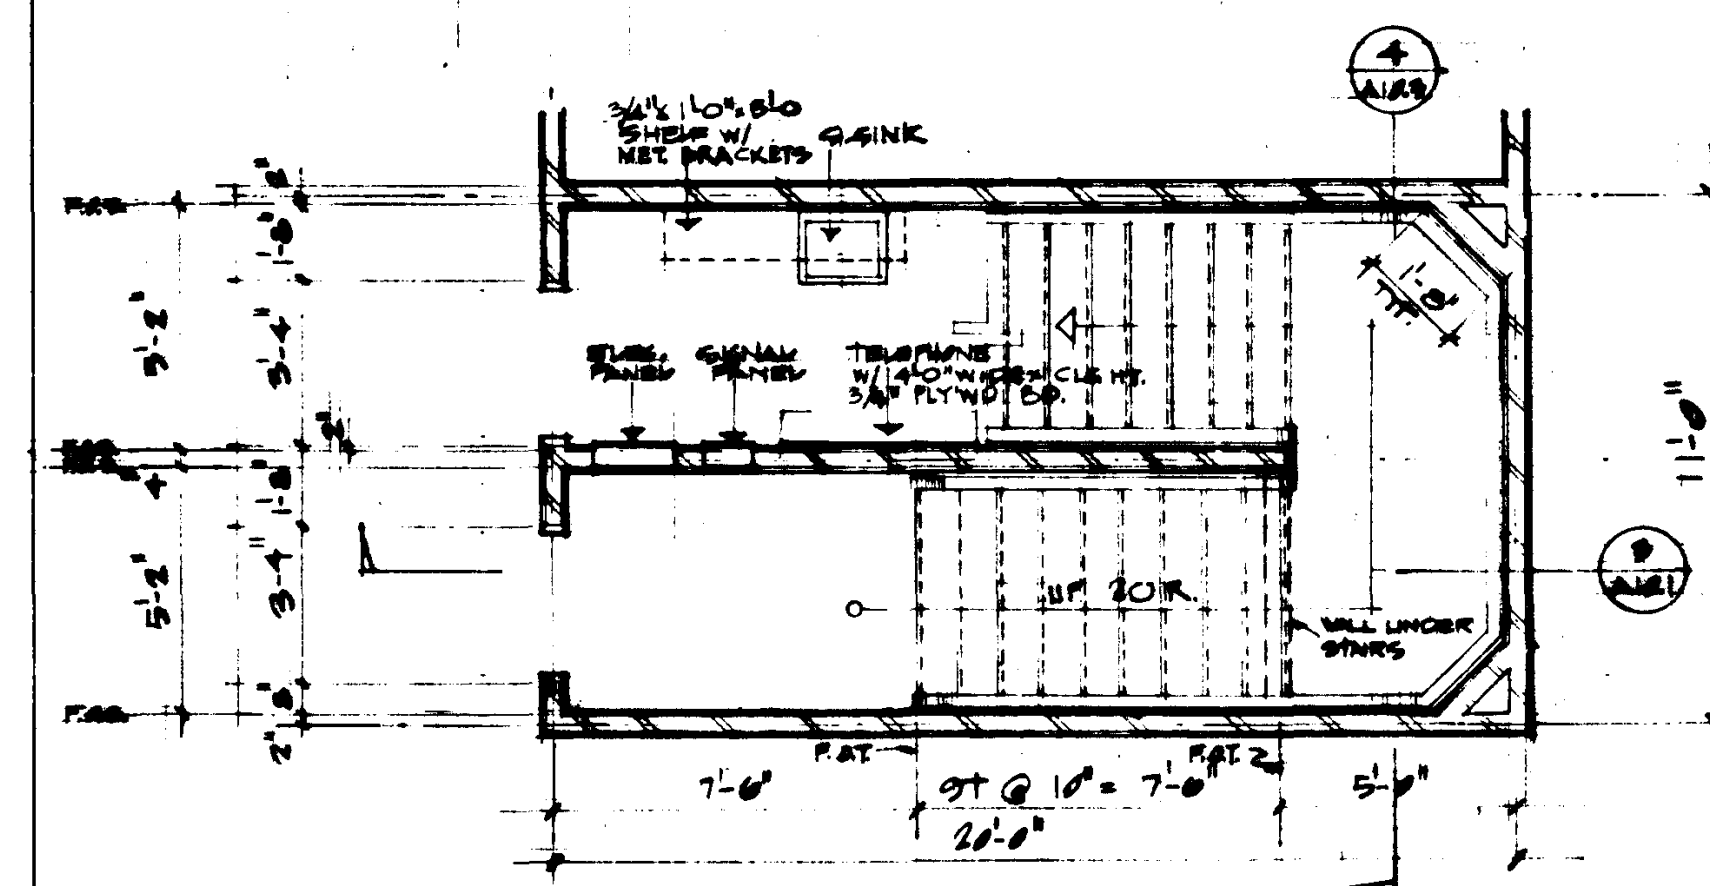
FIRST FLOOR

SCALE: 1/4" = 1'-0"

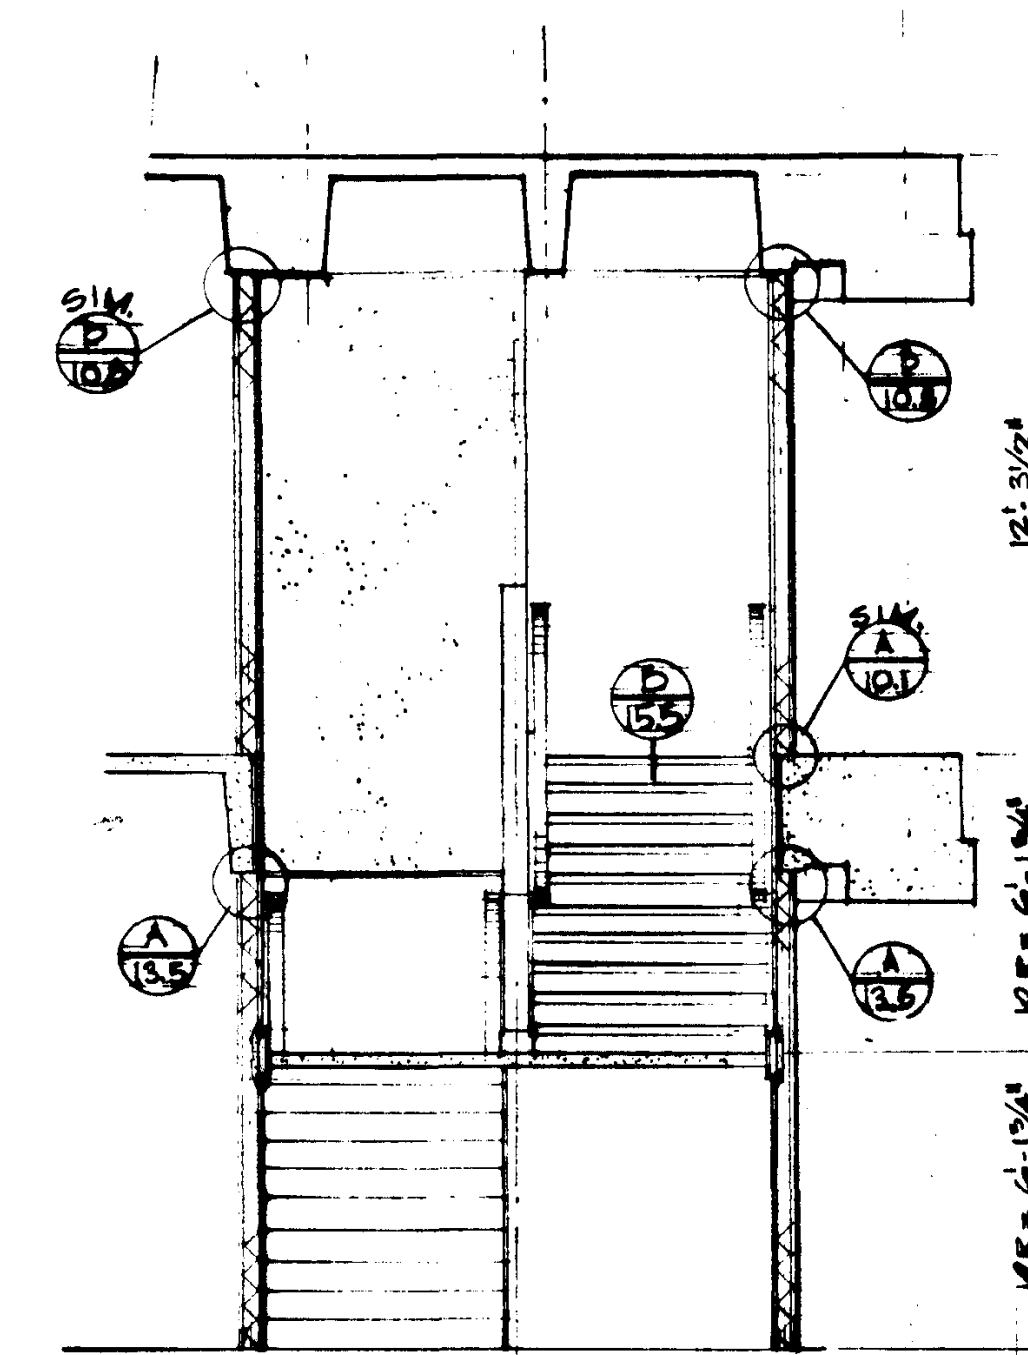

SECOND FLOOR

SCALE: 1/4" = 1'-0"

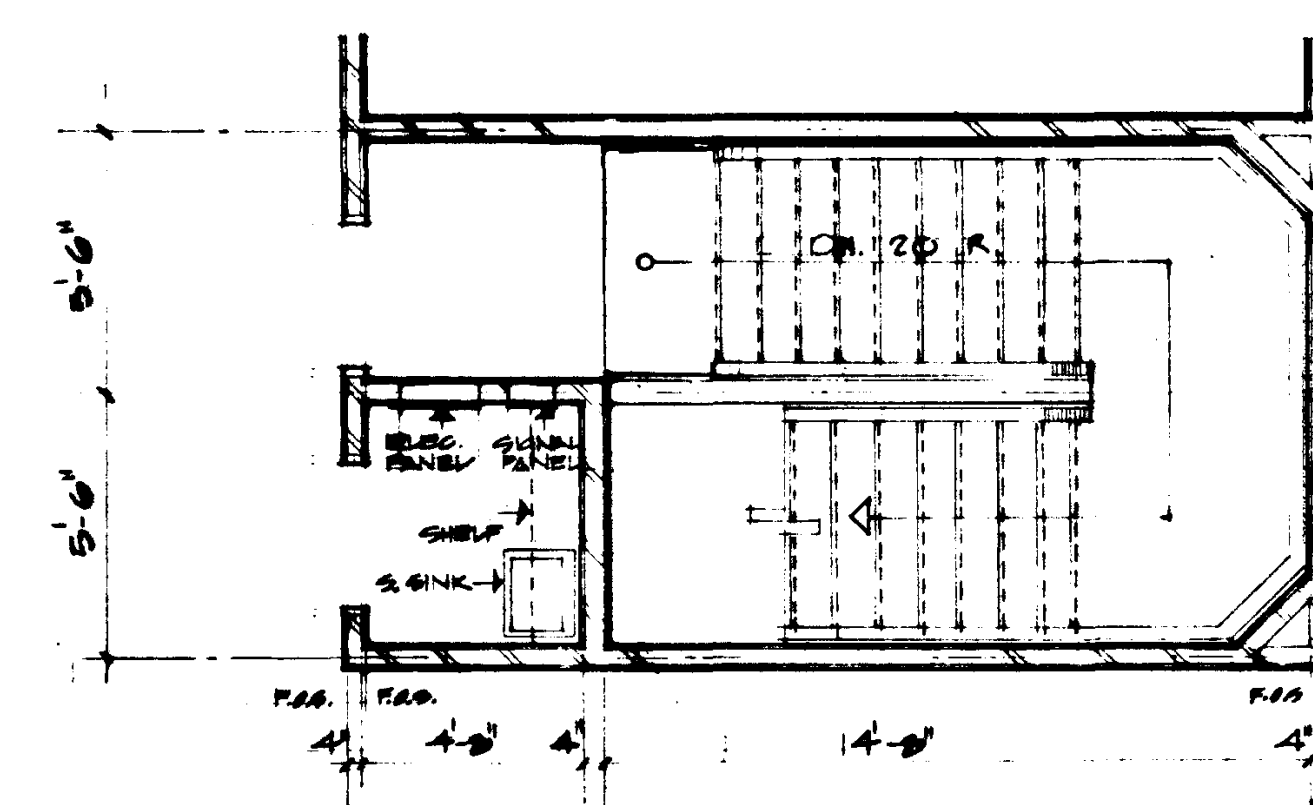

FIRST FLOOR

SCALE: 1/4" = 1'-0"

STAIR NO. 8


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REVISIONS	DATE	BY	REVISIONS


DESIGNED J.M. D.J.	ARCHITECT W.L. PEREIRA	APPROVED STATE FIRE MARSHAL STATE OF CALIFORNIA DATE JUN 21 1965
DRAWN BY K.B.	ENGINEER COLLEGE	APPROVED 55874 APPROVED JUN 21 1965
CHECKED BY R.B.	CIVIL ENGINEER O. SEUTEMAN & ASSOCIATES MOFFATT & NICHOL	ASSOCIATED ARCHITECTS: WILLIAM L. PEREIRA & ASSOCIATES QUINCY JONES-FREDERICK E. EDMONS & ASSOCIATES BLURCK ELLERBROCK & ASSOCIATES
		URBANUS SQUARE • MACARTHUR BOULEVARD AT FORD ROAD TELEPHONE 714/675-2640 • CORONA DEL MAR, CALIFORNIA

GOLDEN WEST COLLEGE
HUNTINGTON BEACH, CALIFORNIA
ORANGE COAST JUNIOR COLLEGE DISTRICT

TYPICAL	JOB NO. 100-1
STAIRS	JUN 1965
	SHEET NO.
	A10.3

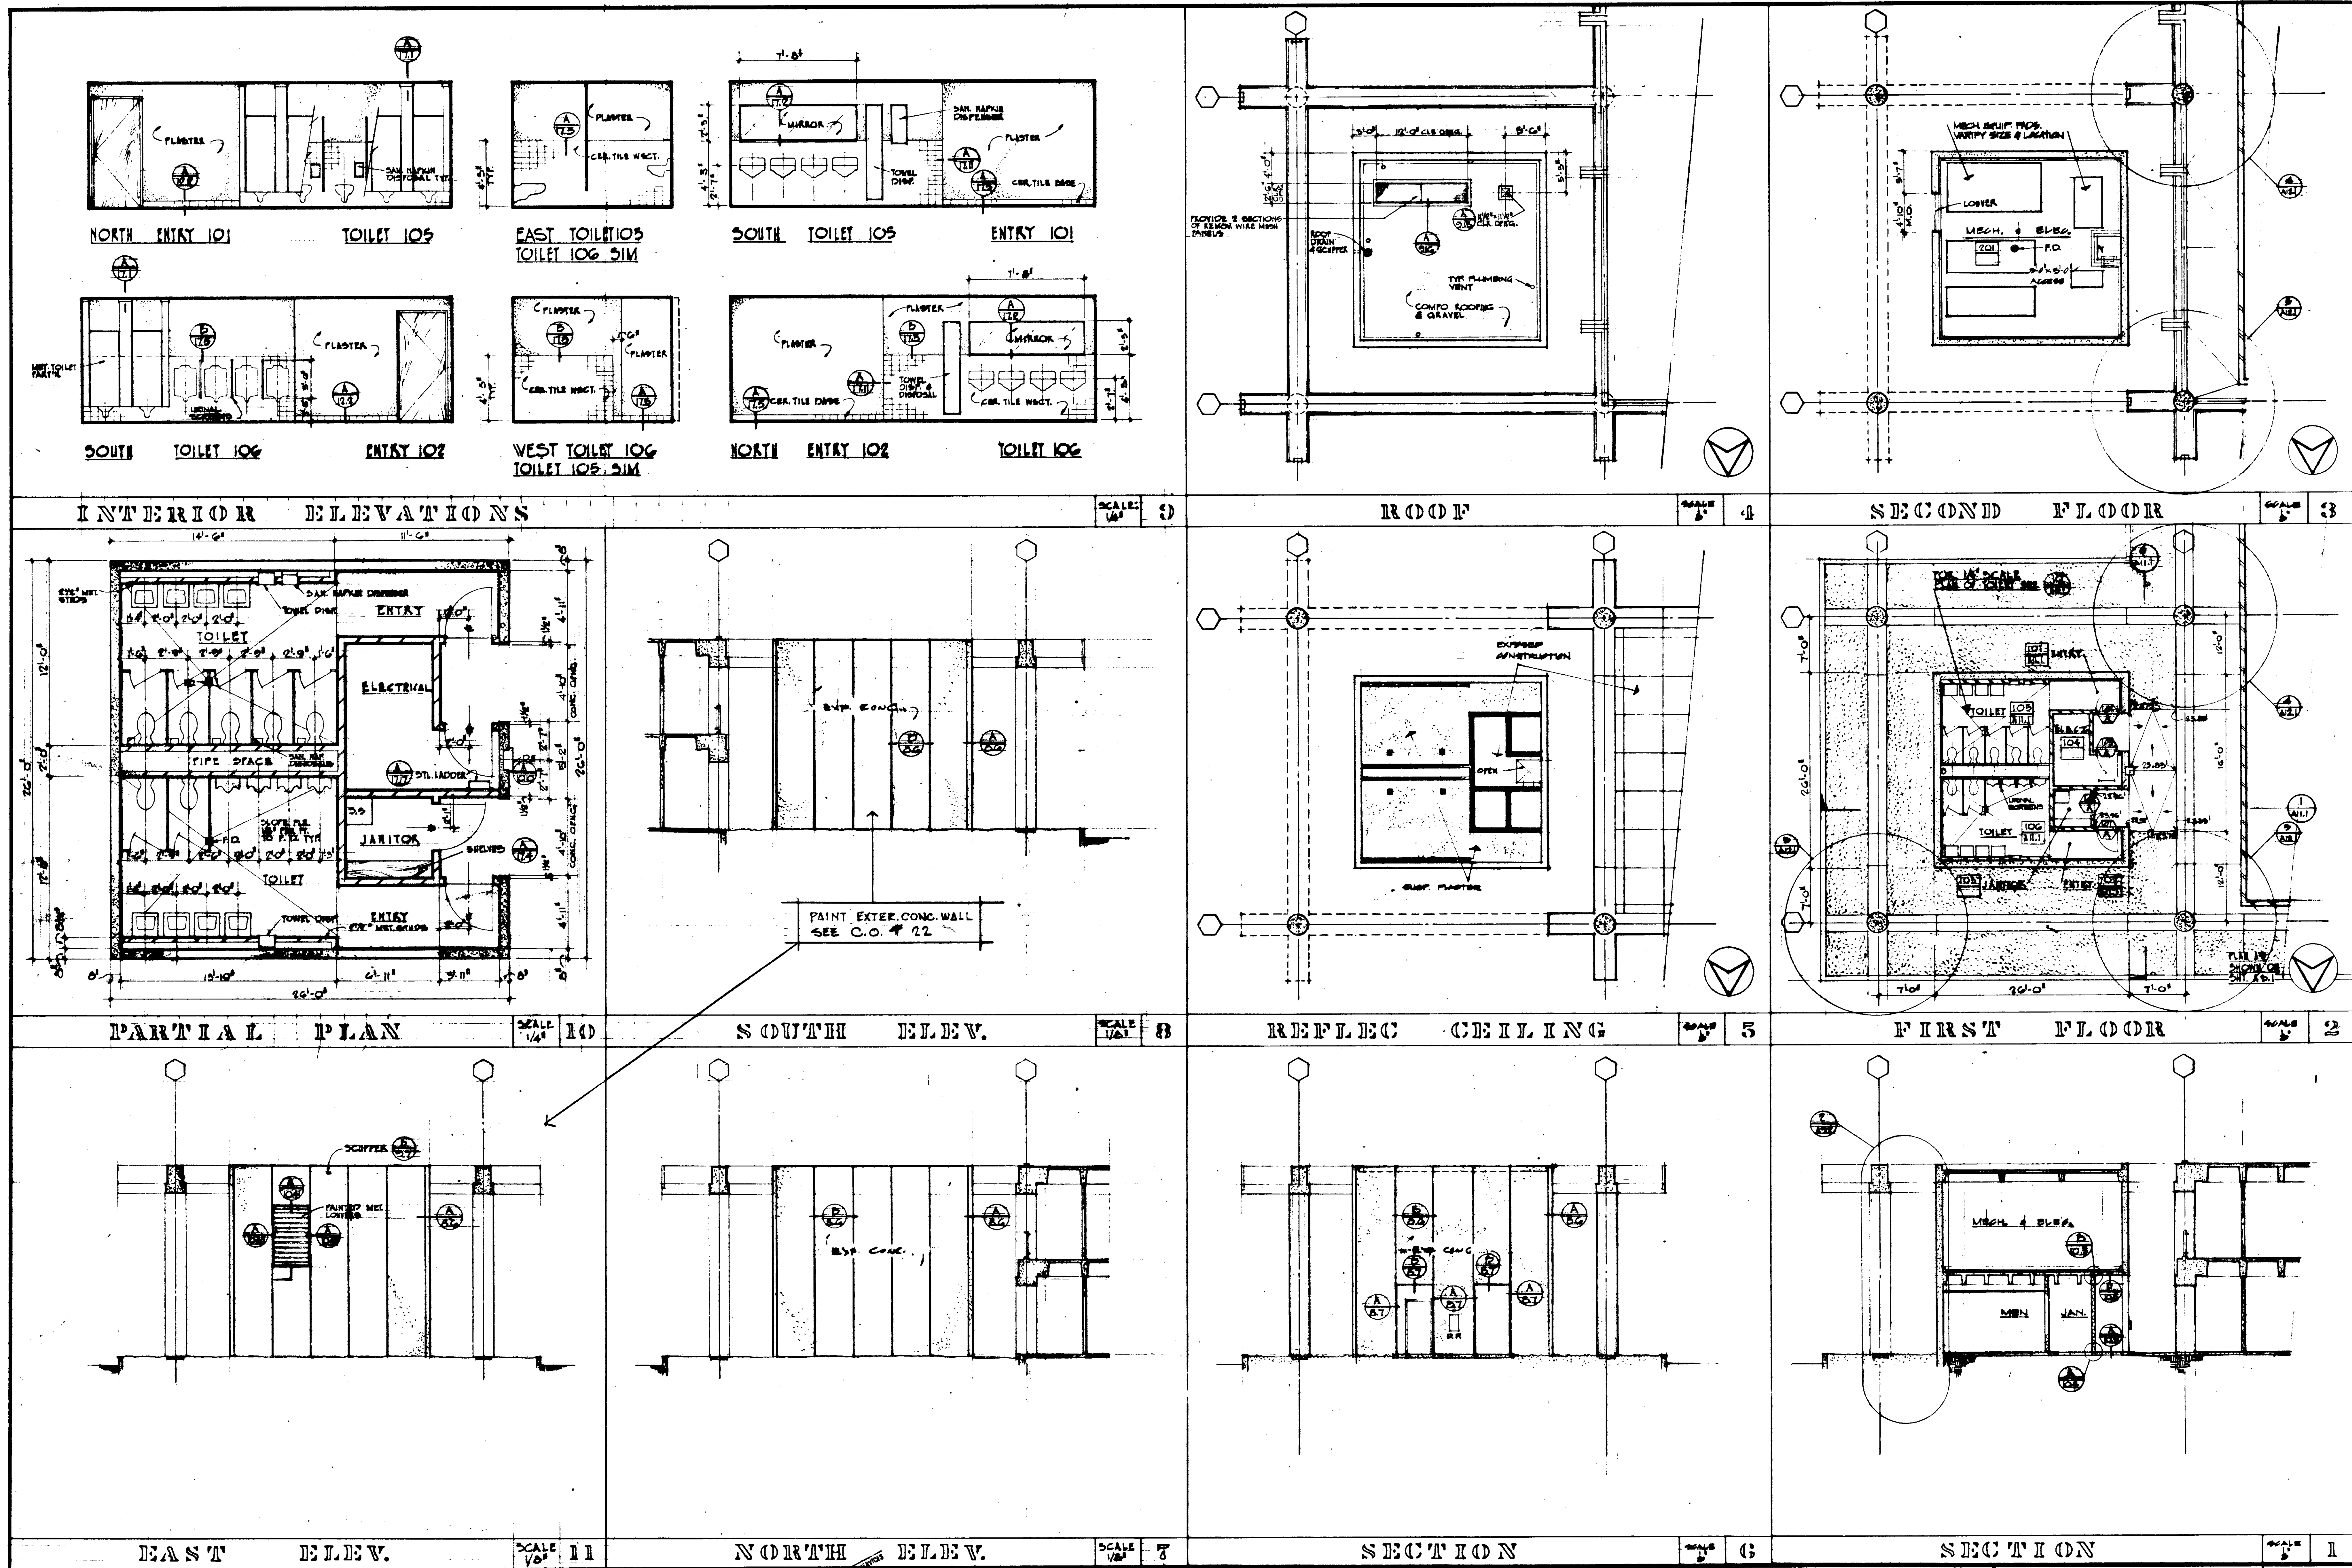


REVISIONS 1. [] 2. [] 3. [] 4. [] 5. [] 6. [] 7. [] 8. [] 9. [] 10. []	STRUCTURAL ENGINEER BEARD & JOHNSON J. A. MARTIN & ASSOCIATES MECHANICAL ENGINEER RALPH E. PHILLIPS, INC. ELECTRICAL ENGINEER RALPH E. PHILLIPS, INC. CIVIL ENGINEER O. STEINMAN & ASSOCIATES MOFFATT & NICHOL	DESIGNED JHL - RJ DRAWN BY K. B. CHECKED BY [Signature] DATE JUN 21 1965	APPROVED STATE FIRE MARSHAL STATE OF CALIFORNIA DATE JUN 21 1965 28874 APPROVED JUN 21 1965	ASSOCIATED ARCHITECTS: WILLIAM L. PEREIRA & ASSOCIATES A. QUINCY JONES-FREDERICK E. EMMONS & ASSOCIATES BLUROCK ELLERBROCK & ASSOCIATES URBANUS SQUARE • MACARTHUR BOULEVARD AT FORD ROAD TELEPHONE 714/675-2640 • CORONA DEL MAR, CALIFORNIA	GOLDEN WEST COLLEGE HUNTINGTON BEACH, CALIFORNIA ORANGE COAST JUNIOR COLLEGE DISTRICT	TYPICAL LOAD CENTER DATE 5 JUN 1965 SHEET NO. ALL
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OUTSIDE CORNER INTERMEDIATE INSIDE CORNER

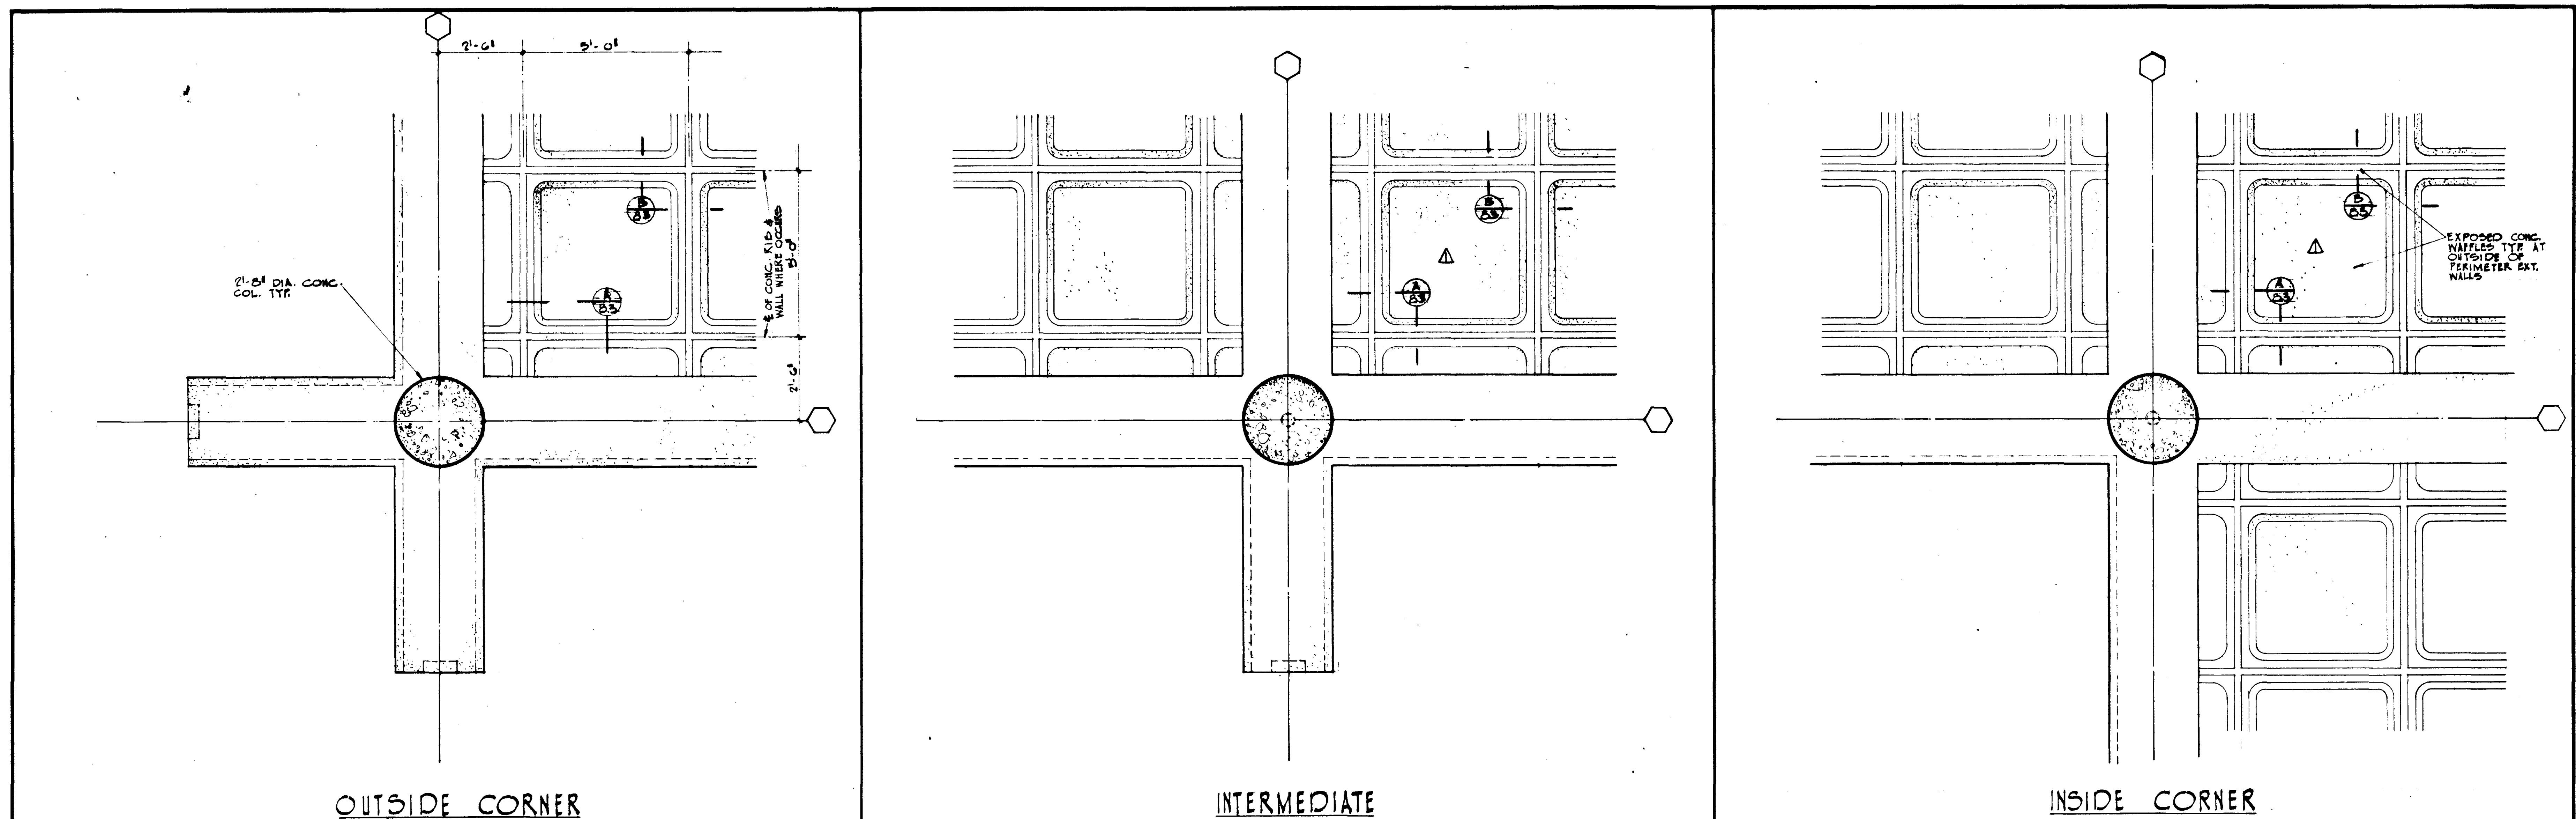COLUMN REFLECTED PLAN COLUMN REFLECTED PLAN COLUMN REFLECTED PLAN

SCALE: 1/2" = 1'-0" SCALE: 1/2" = 1'-0" SCALE: 1/2" = 1'-0"




CONDITION AT 2ND FLOOR (B) CONDITION AT 1ST FLOOR (A) CONDITION AT 2ND FLOOR (B) CONDITION AT 1ST FLOOR (A) CONDITION AT 2ND FLOOR (B) CONDITION AT 1ST FLOOR (A)

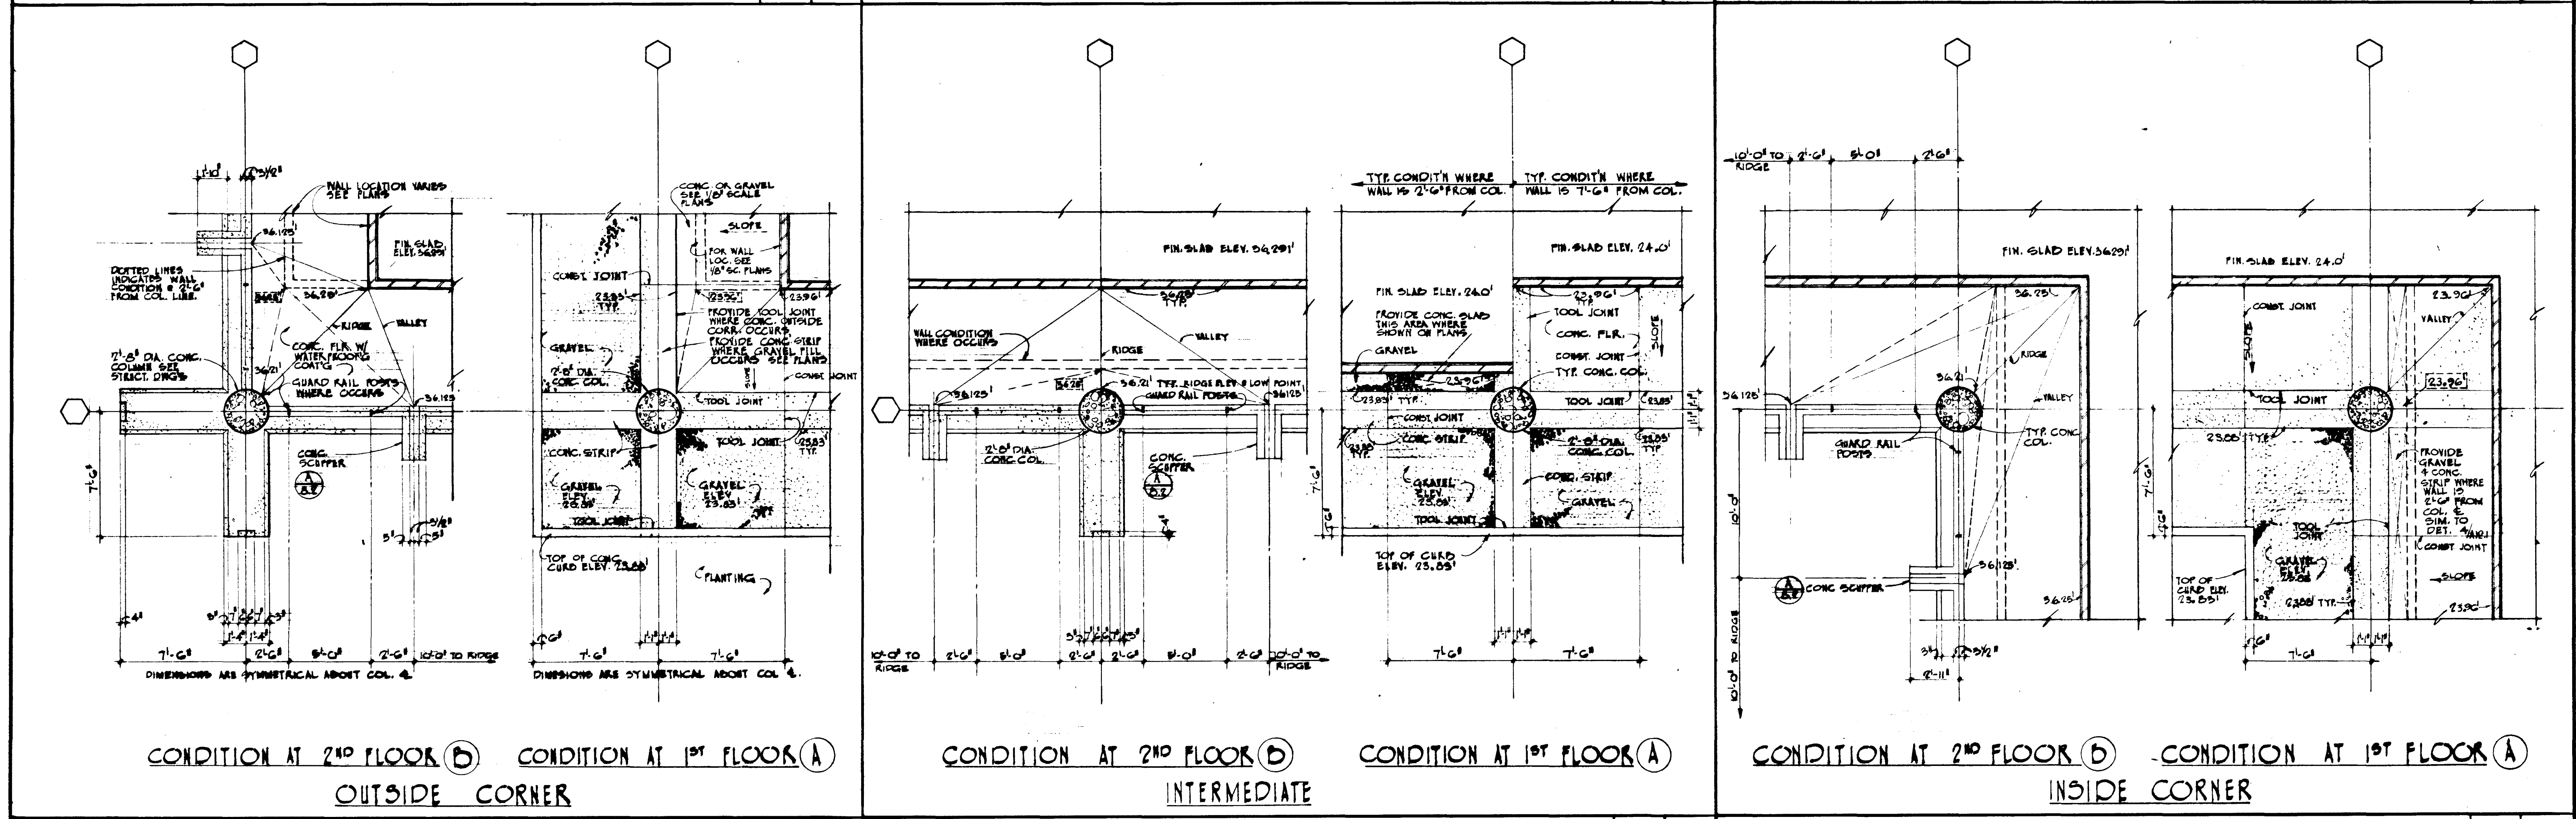OUTSIDE CORNER INTERMEDIATE INSIDE CORNER

COLUMN PLAN COLUMN PLAN COLUMN PLAN


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REVISIONS 1. 11/1/65 2. 11/1/65 3. 11/1/65 4. 11/1/65 5. 11/1/65 6. 11/1/65 7. 11/1/65 8. 11/1/65 9. 11/1/65 10. 11/1/65	STRUCTURAL ENGINEERS RANDOLPH & JOHNSON 1111 1/2 STREET RALPH B. PHILLIPS, INC. ELECTRICAL ENGINEERS RALPH B. PHILLIPS, INC. CIVIL ENGINEERS G. SHUIMAN & ASSOCIATES MOFFATT & MICROL	DESIGNED ARCHITECT DRAWN BY CHECKED BY APPROVED STATE FIRE MARSHAL STATE OF CALIFORNIA DATE: JUN 15 1965 2587 4 JUN 21 1965	ASSOCIATED ARCHITECTS: WILLIAM L. PEREIRA & ASSOCIATES A. QUINCY JONES-FREDERICK E. EMMONS & ASSOCIATES BLUROCK ELLERBROEK & ASSOCIATES URBANUS SQUARE • MACARTHUR BOULEVARD AT FORD ROAD TELEPHONE 714/675-2640 • CORONA DEL MAR, CALIFORNIA	GOLDEN WEST COLLEGE HUNTINGTON BEACH, CALIFORNIA ORANGE COAST JUNIOR COLLEGE DISTRICT	TYPICAL CONCRETE DETAILS JOB NO. 100-1 DATE 15 JUN 1965 SHEET NO. A12.1
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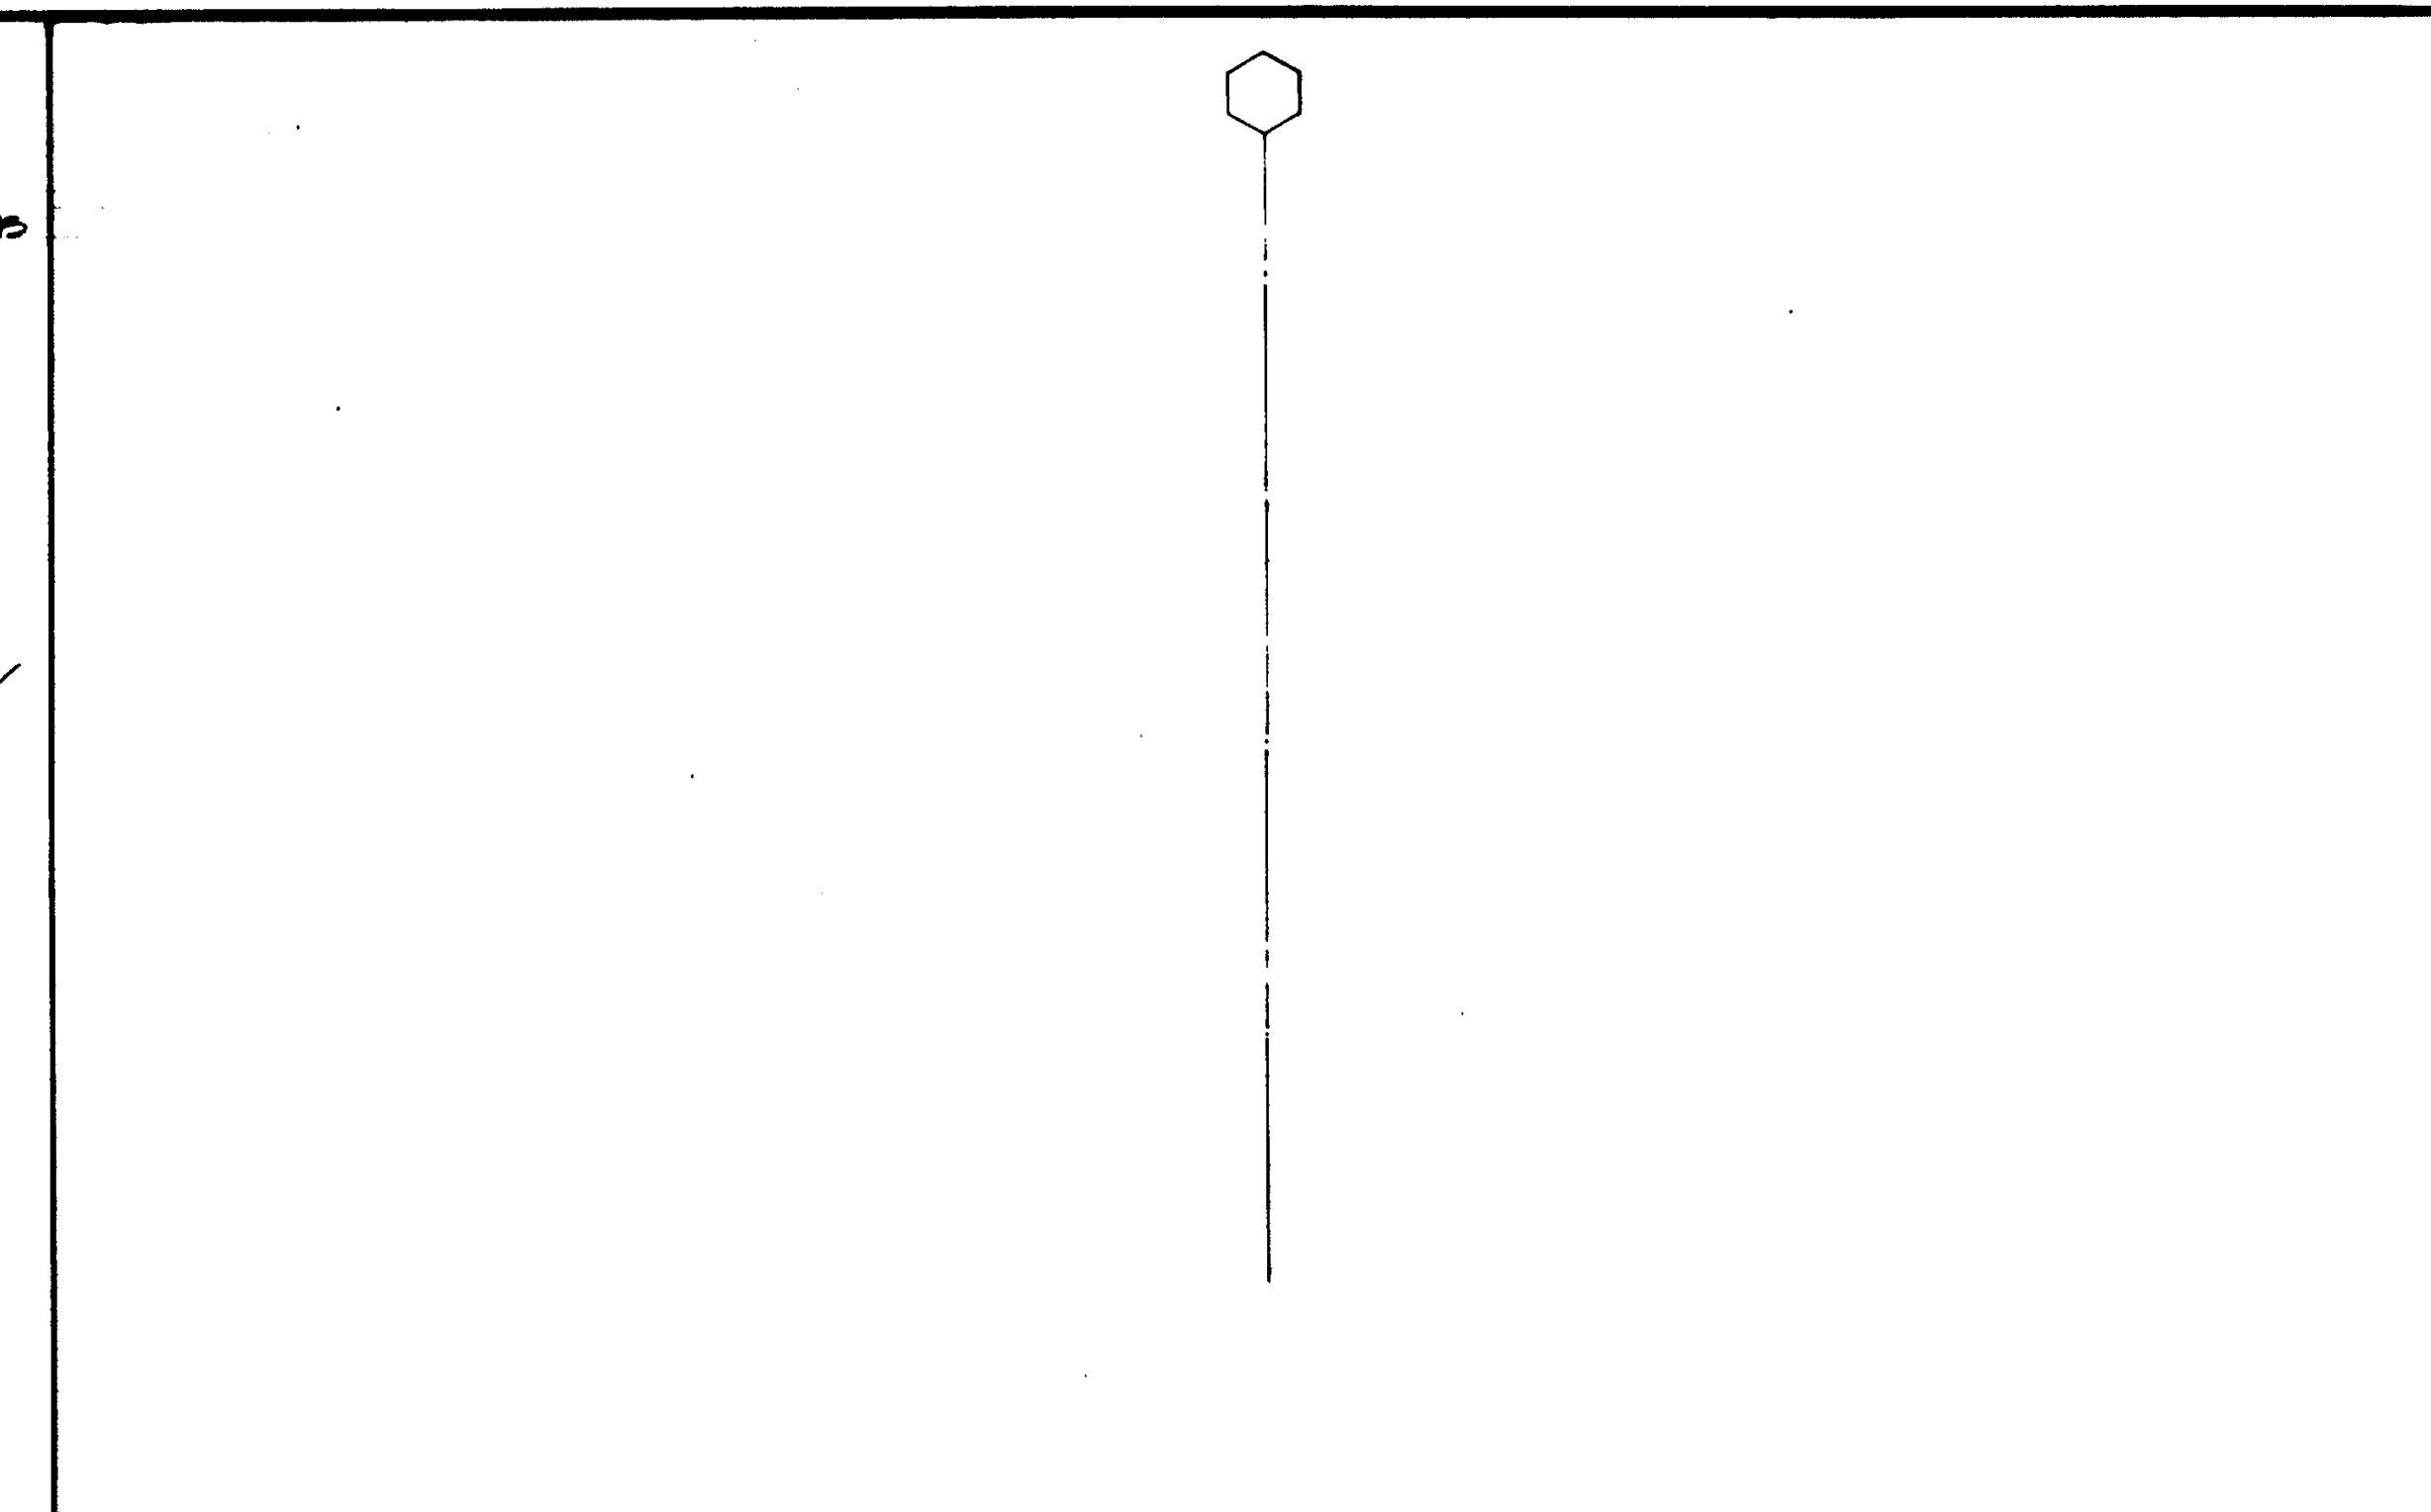
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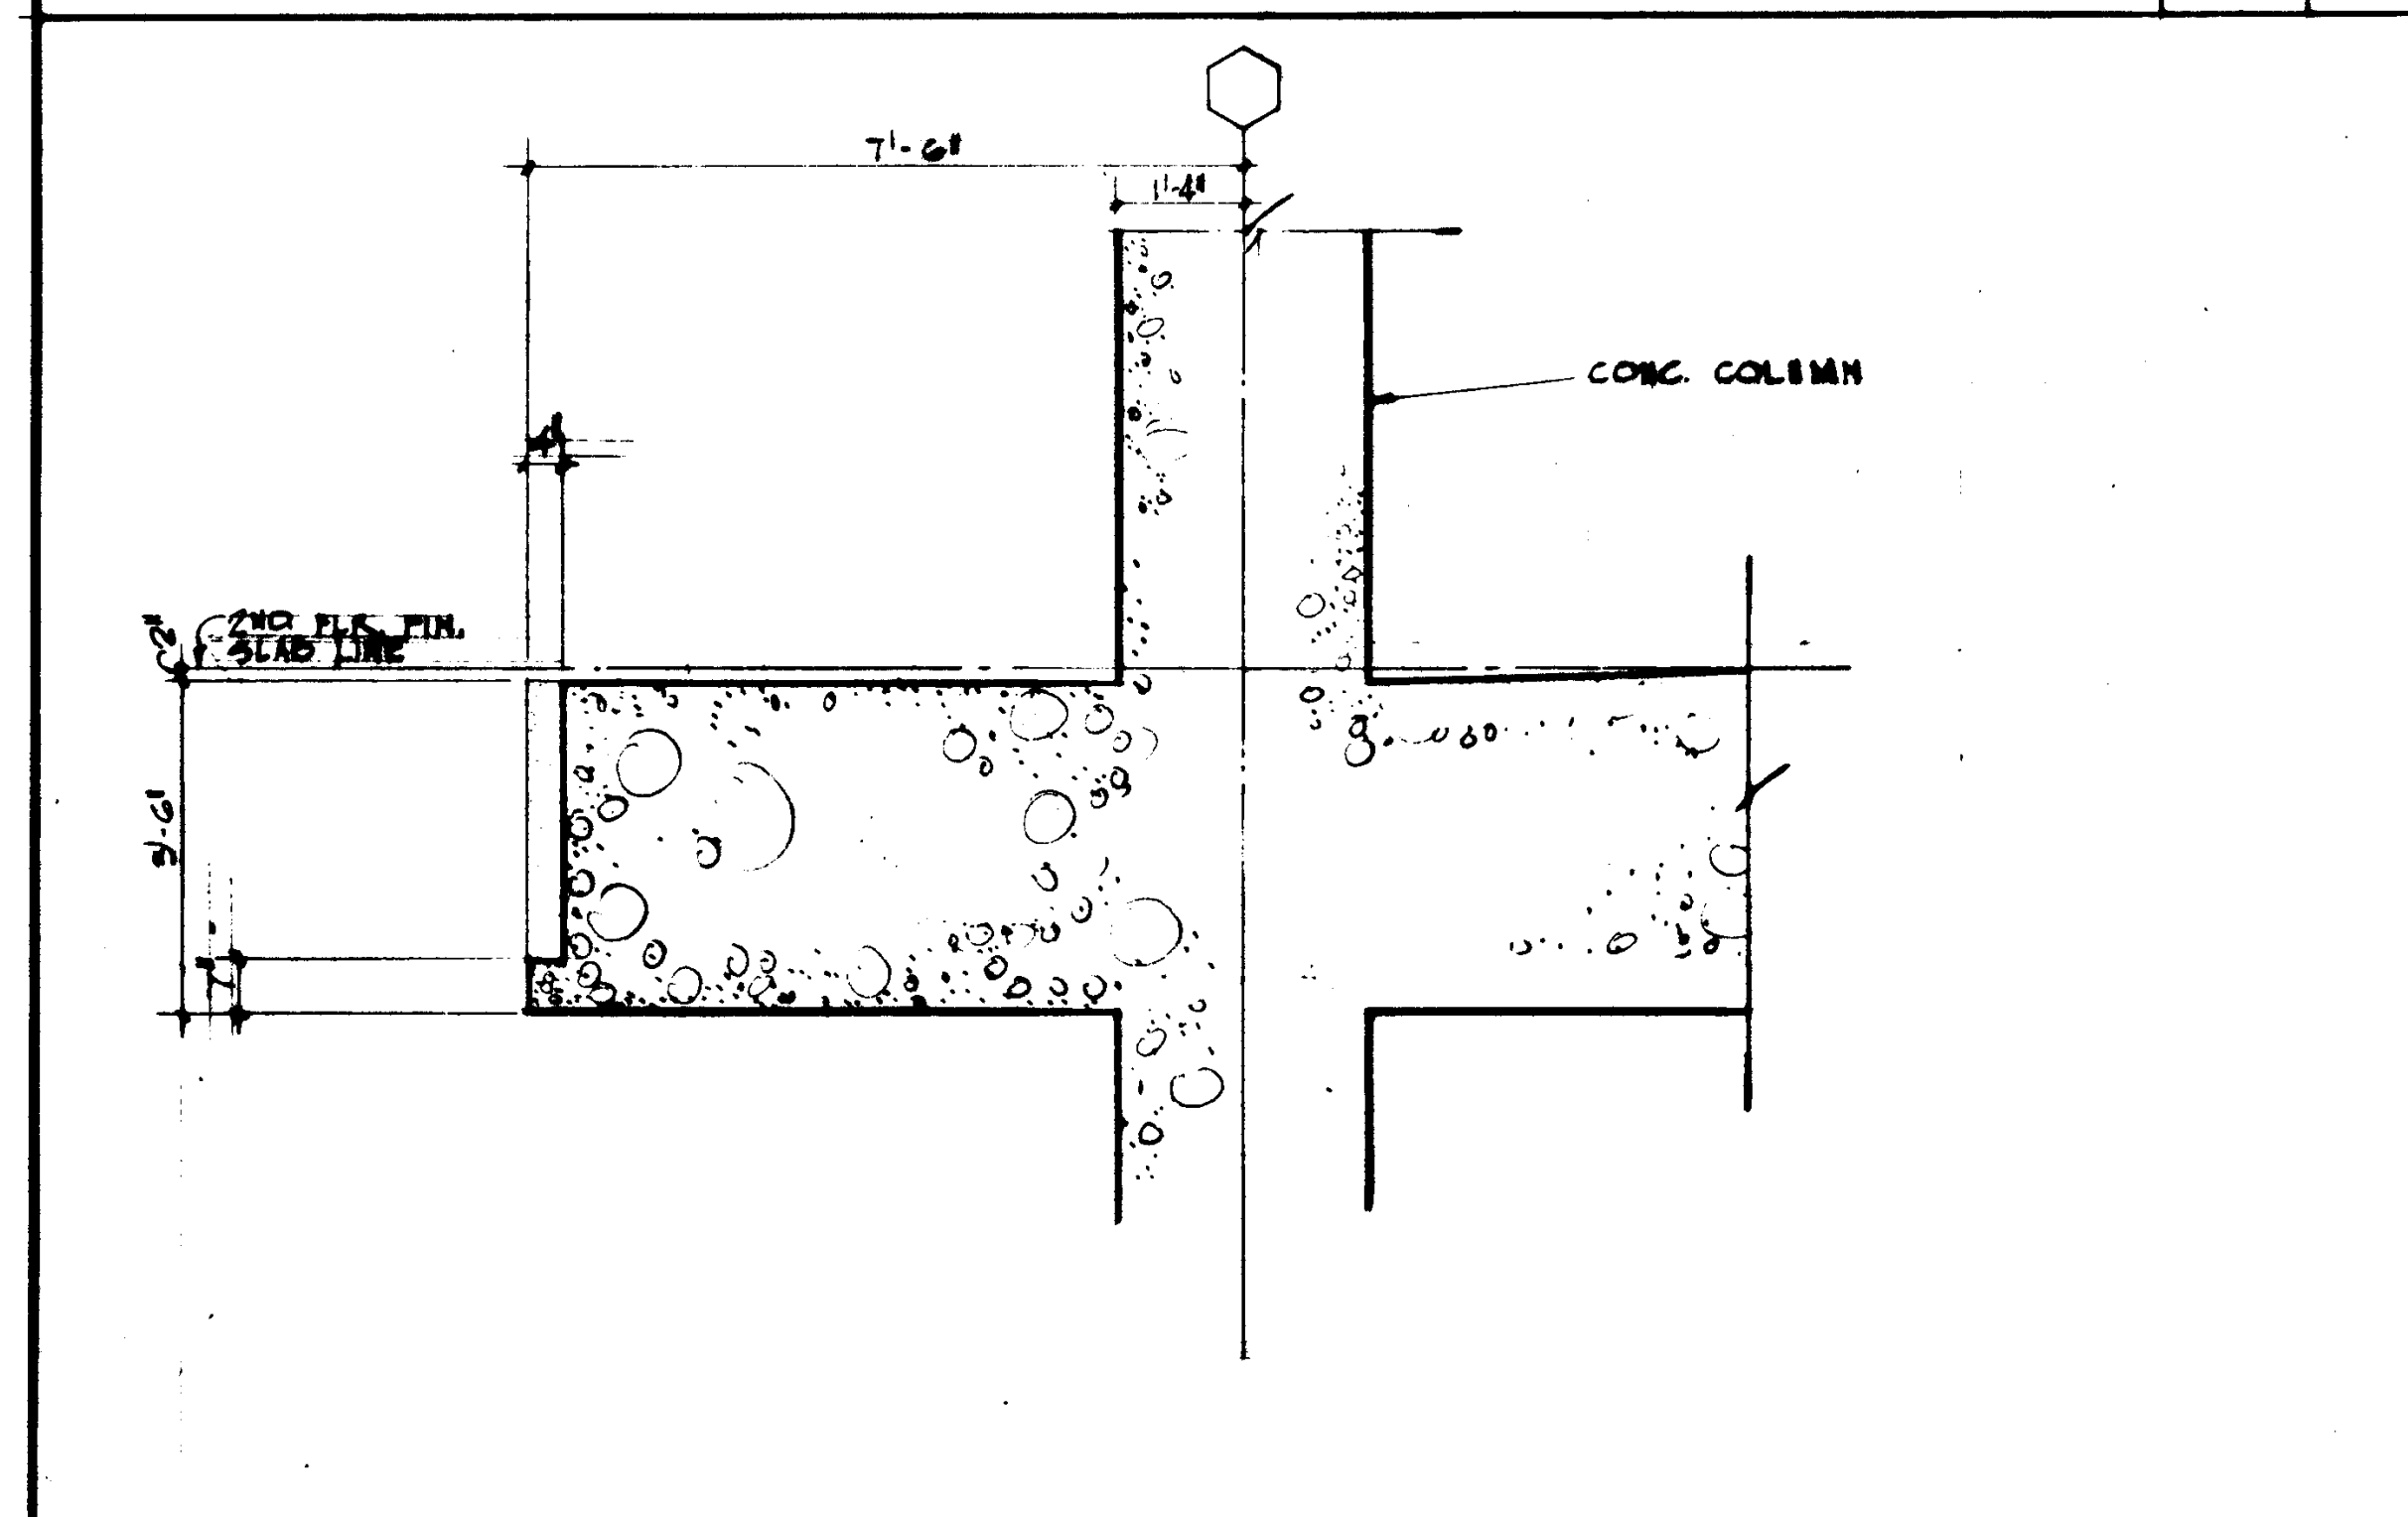
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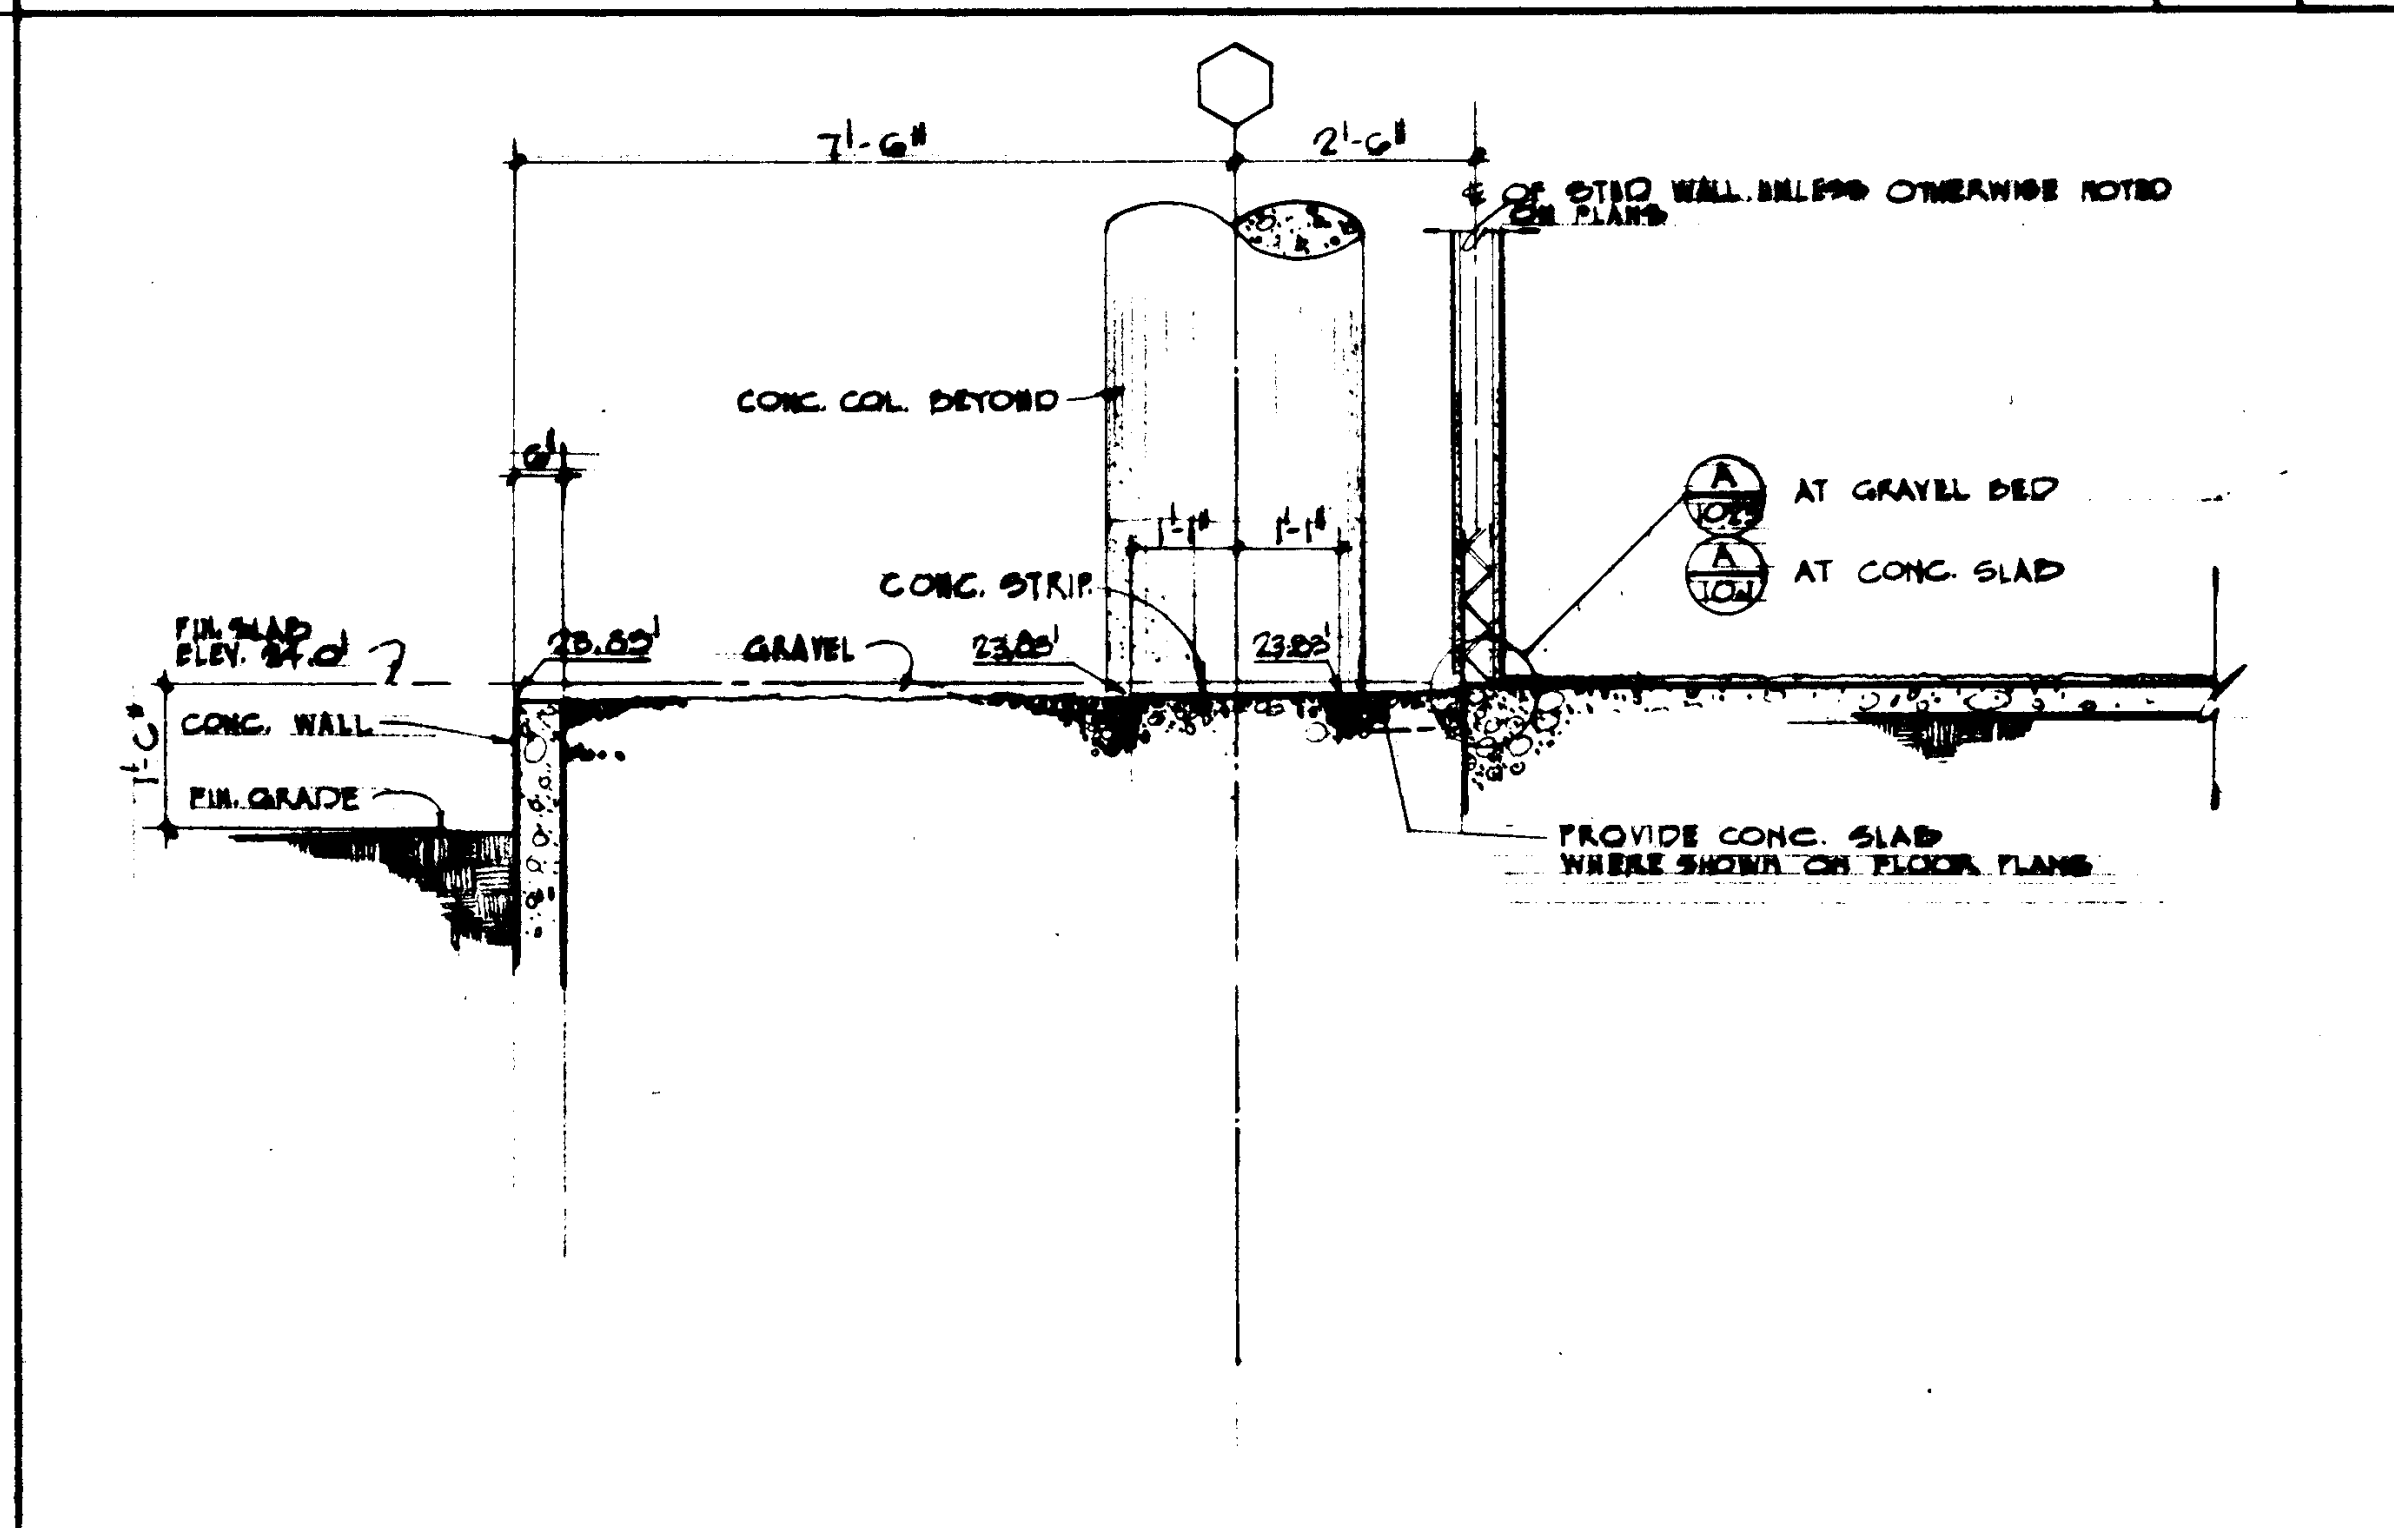
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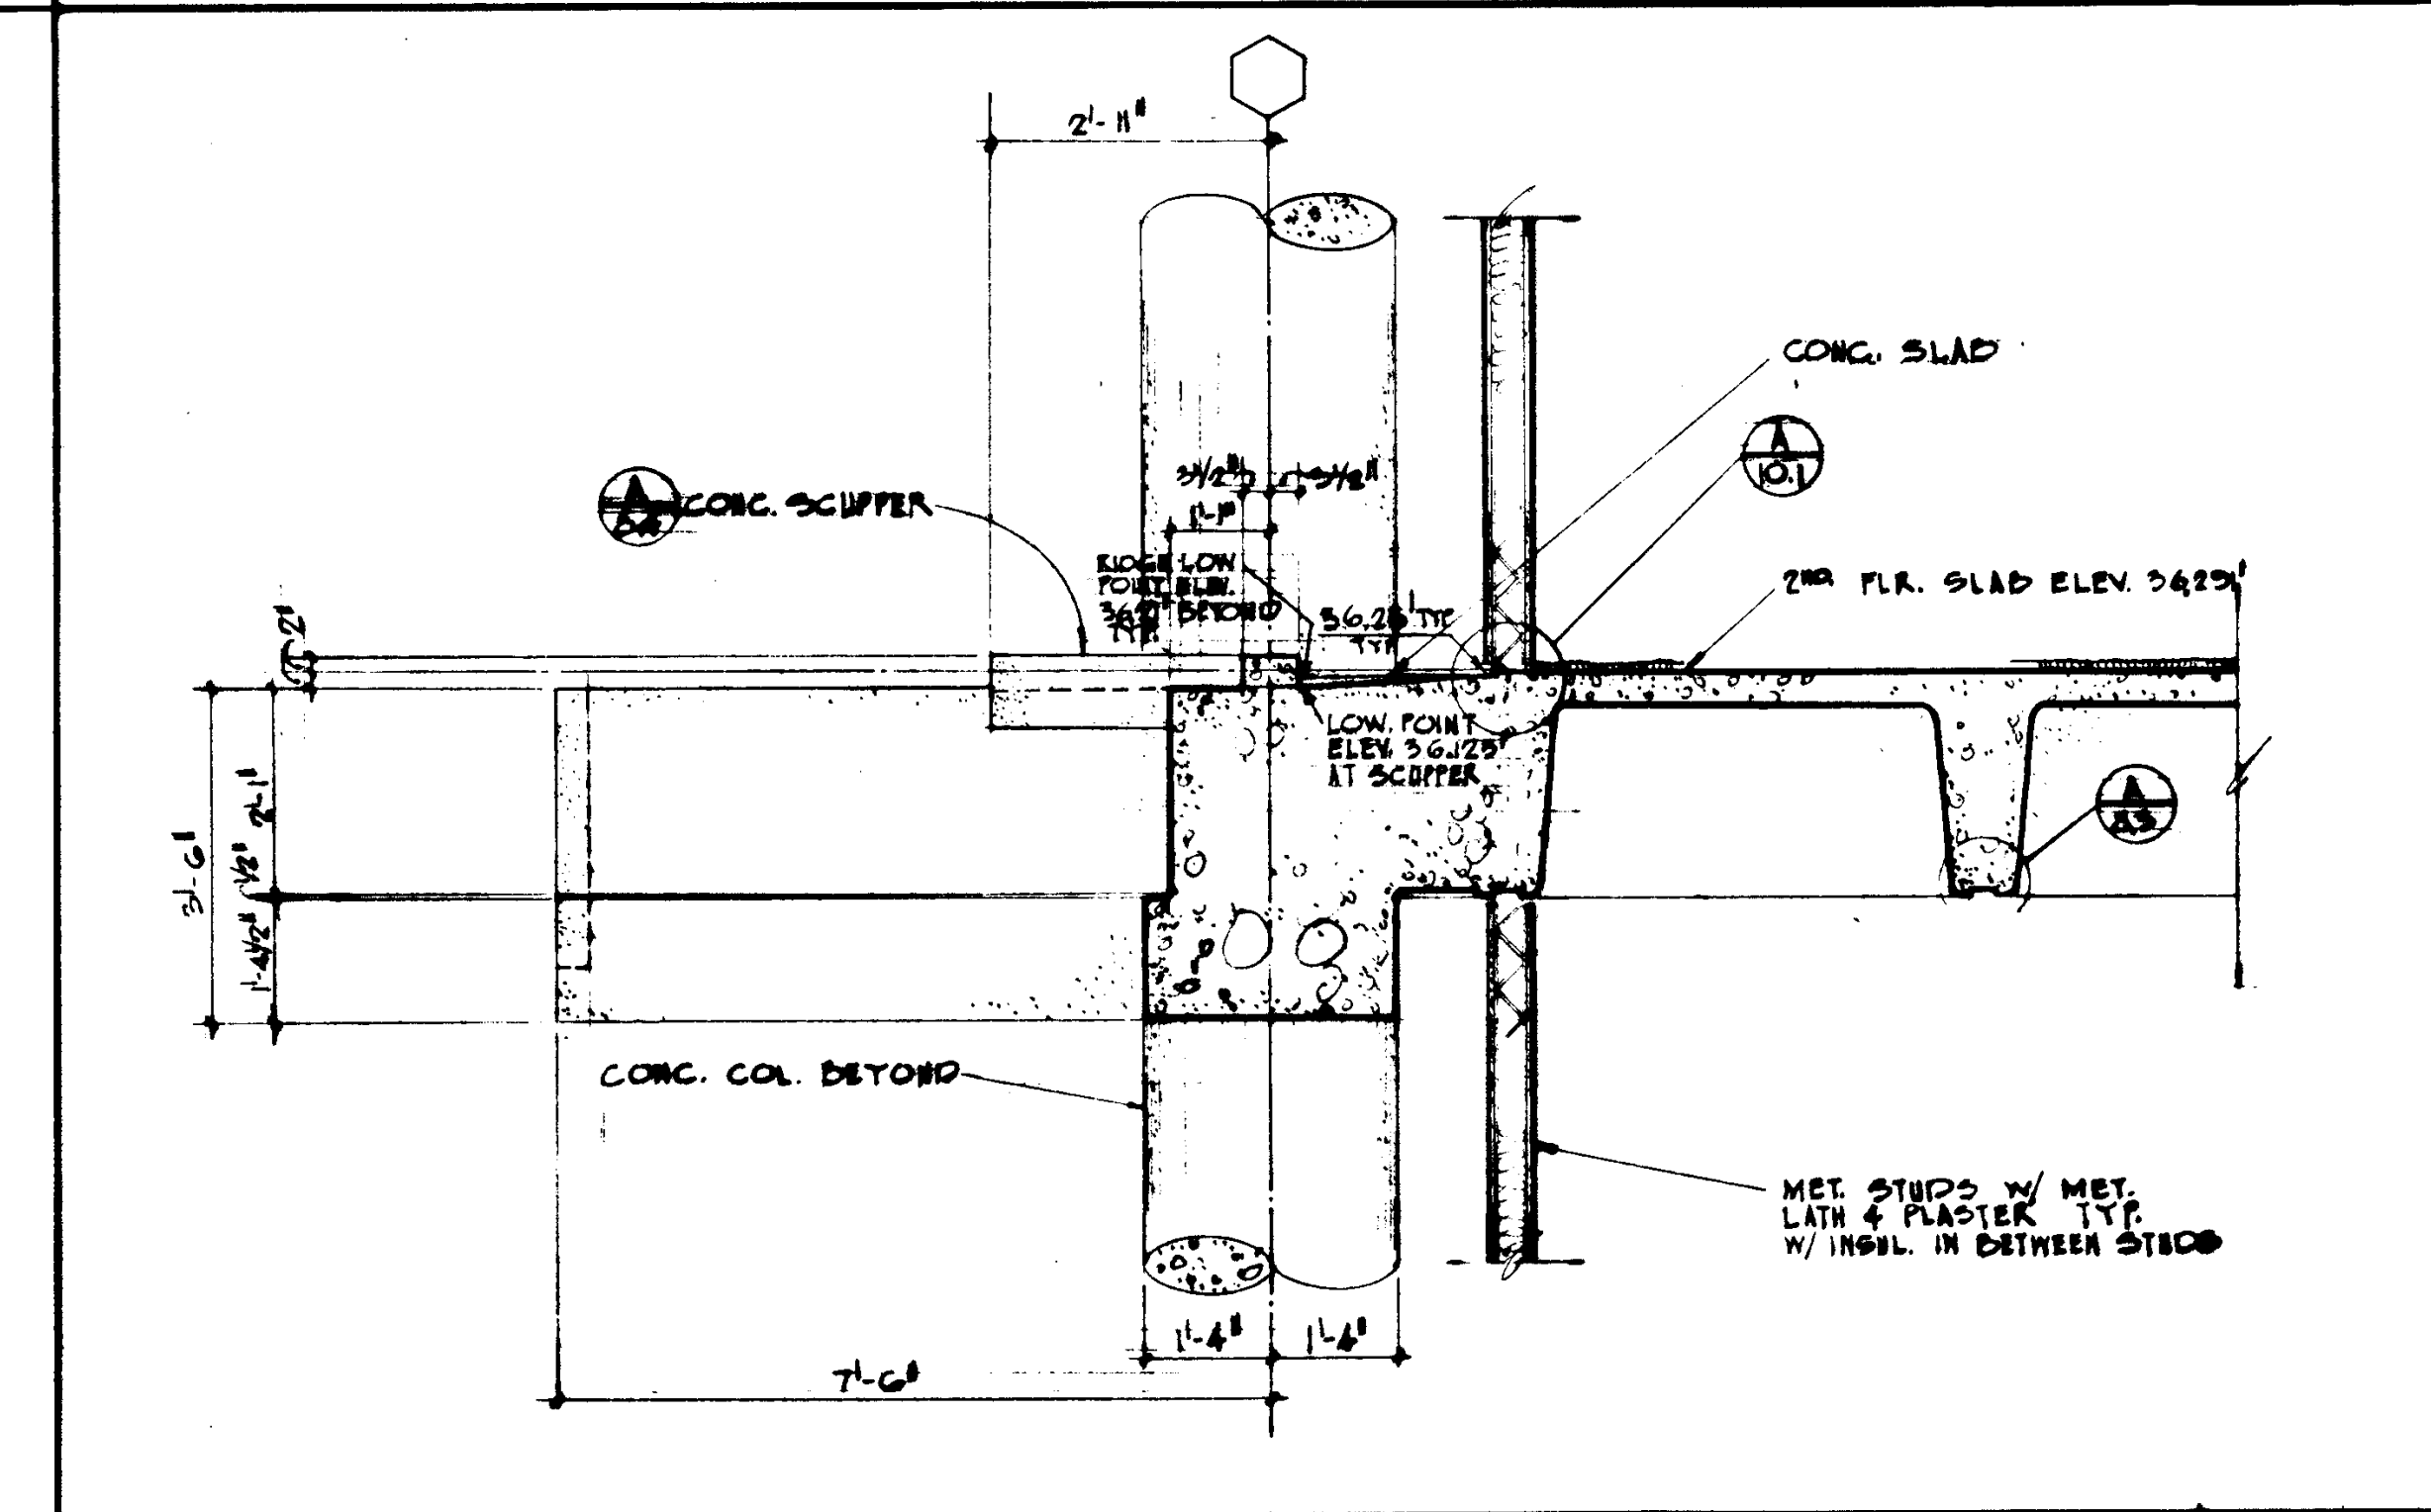
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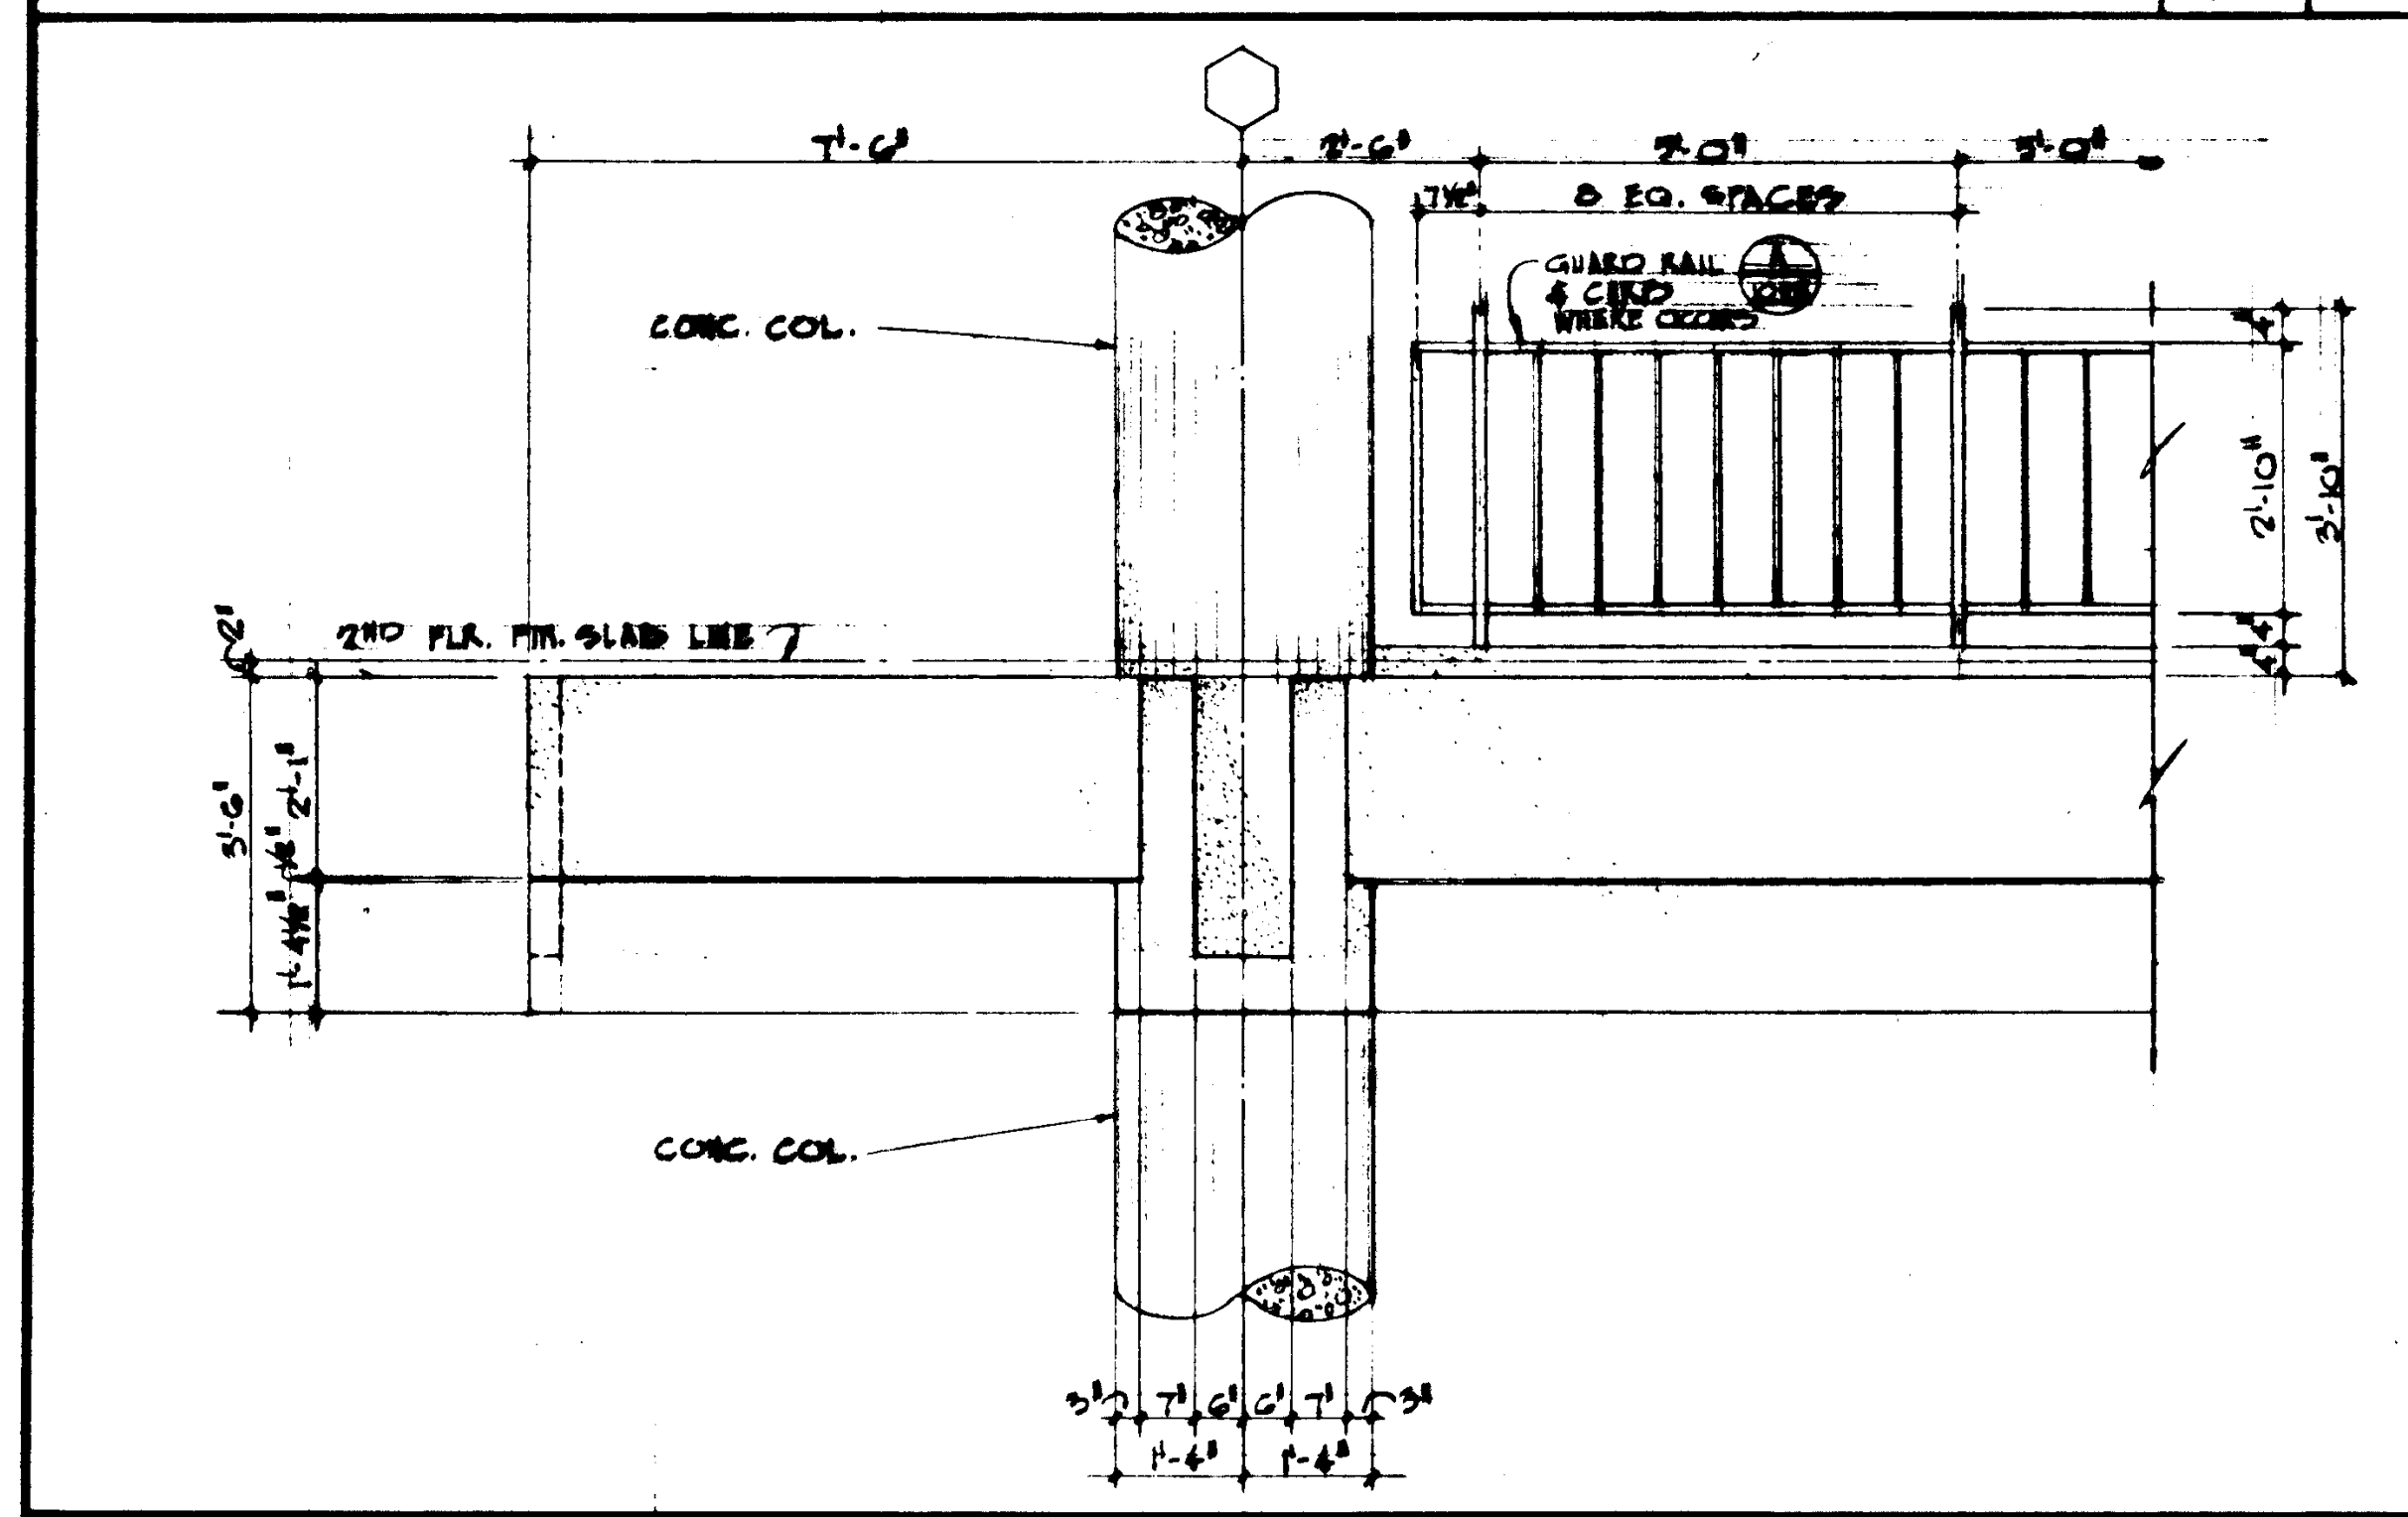
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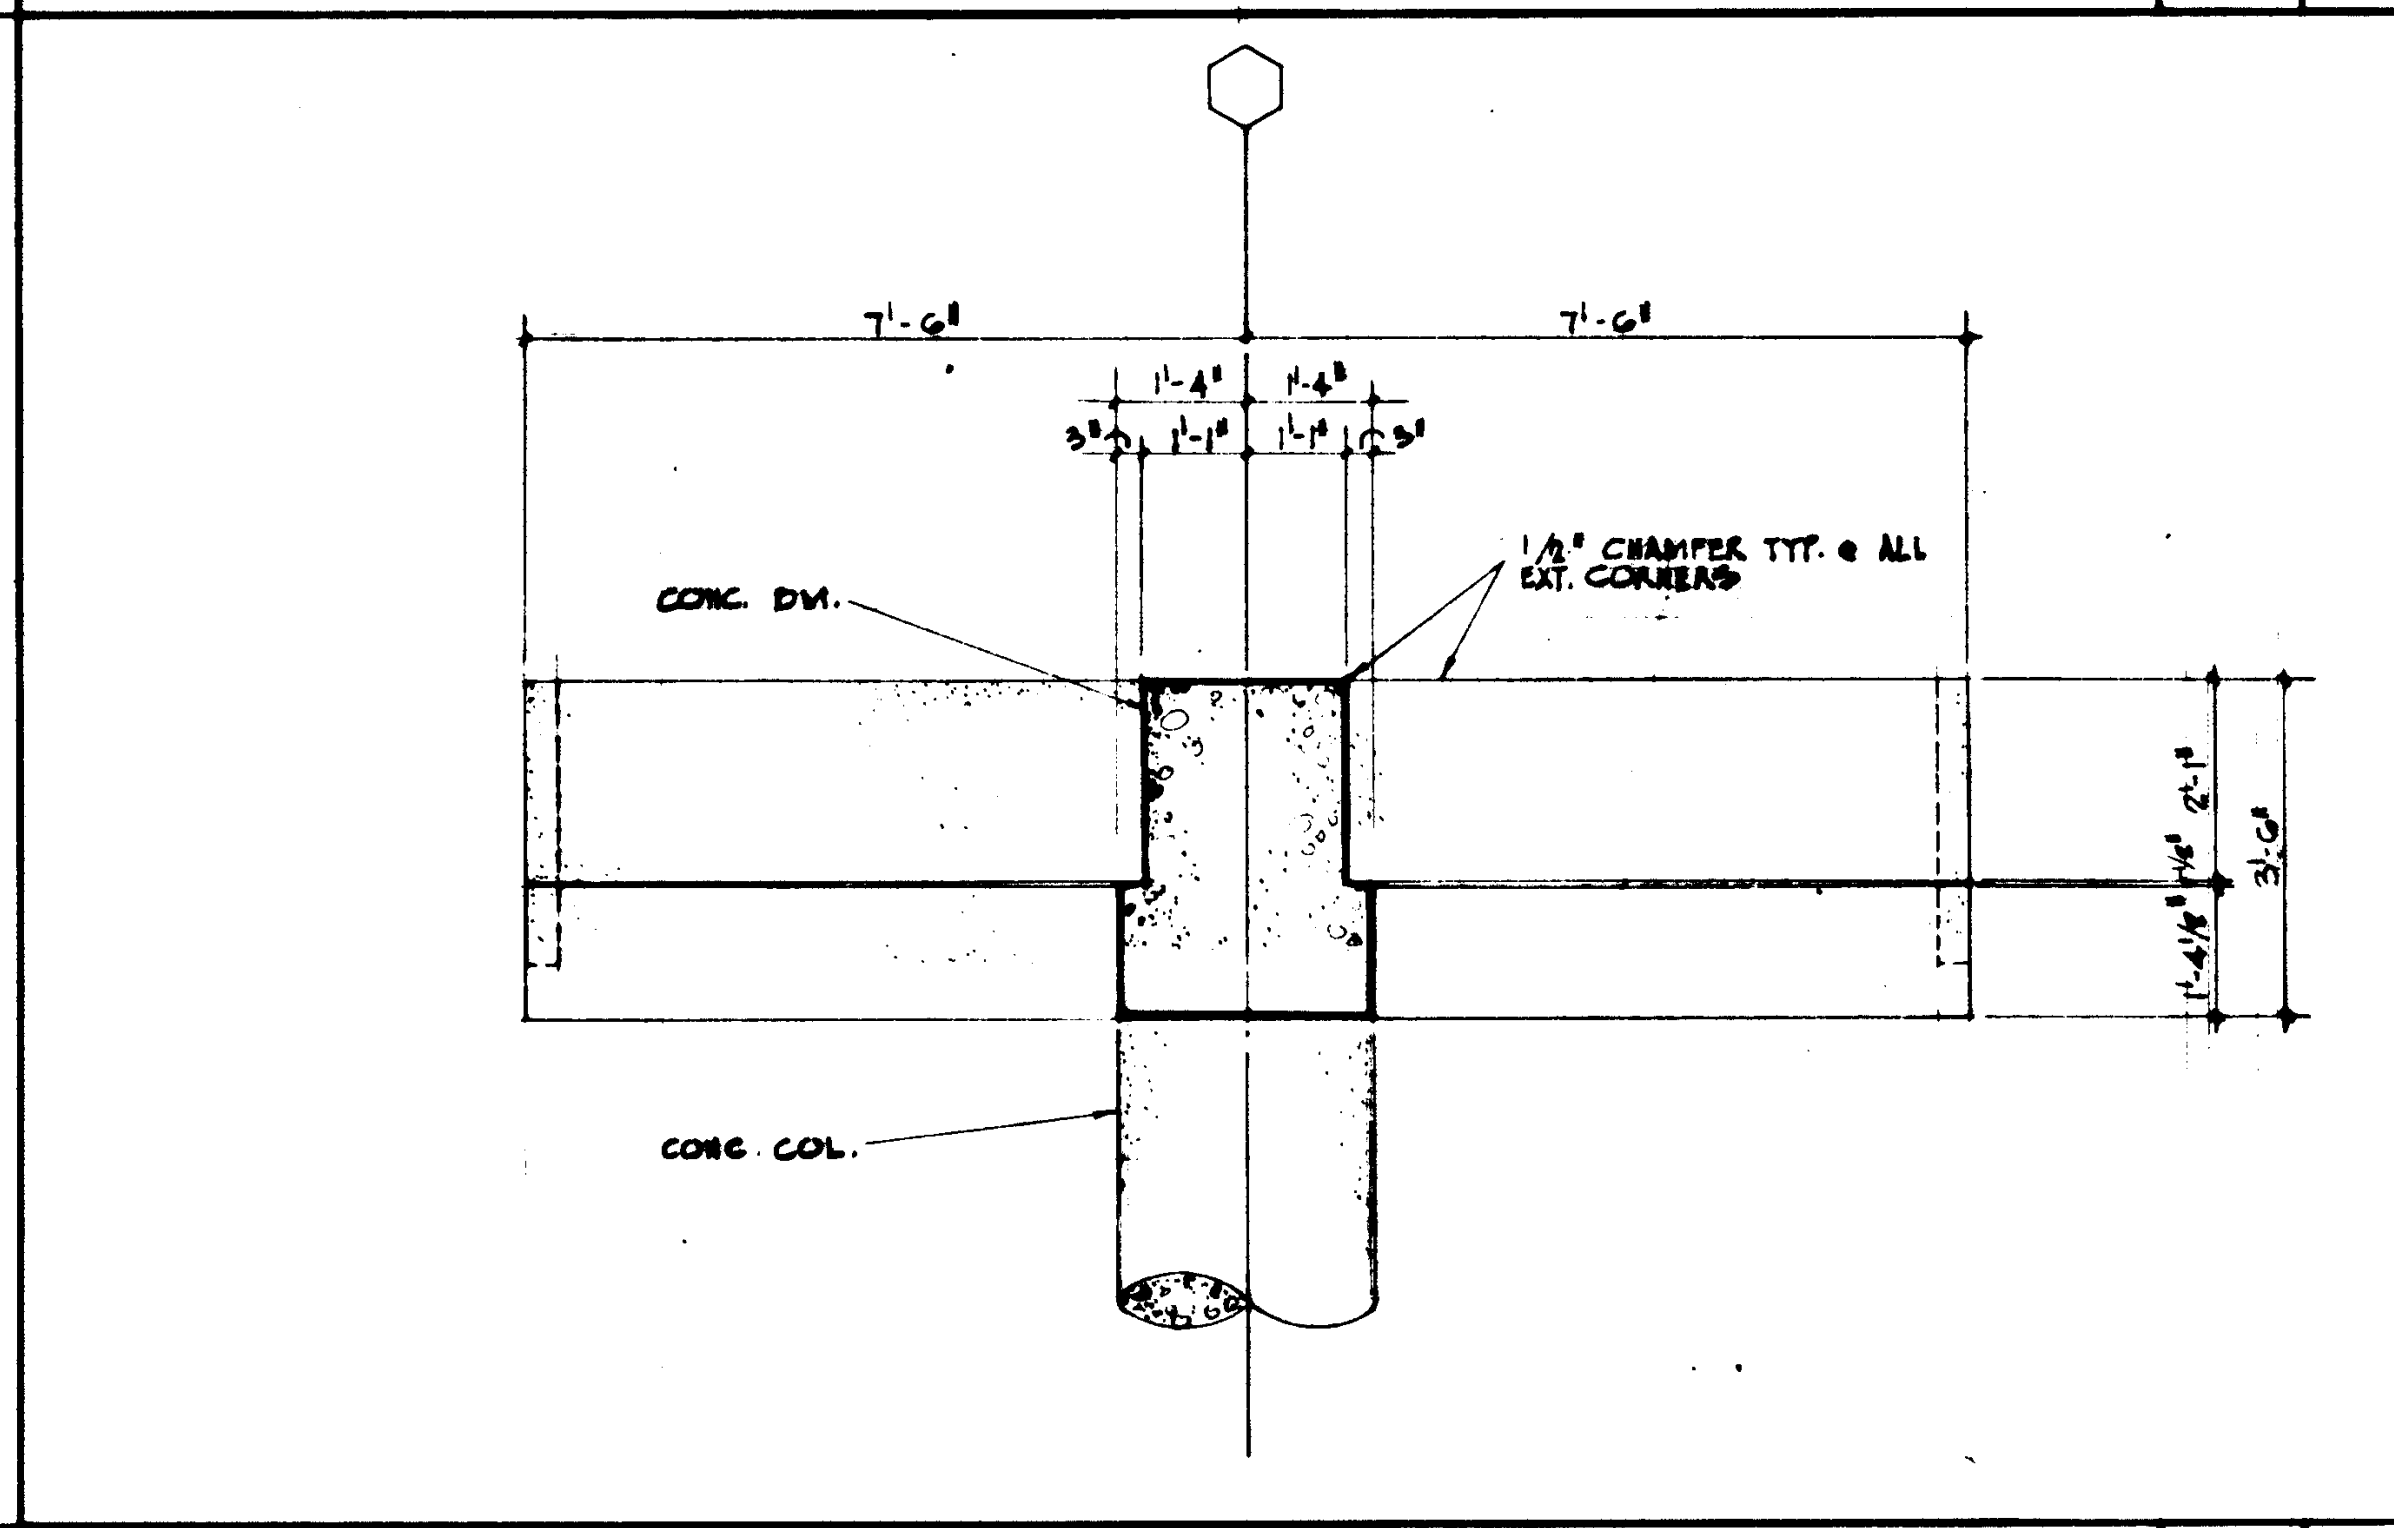
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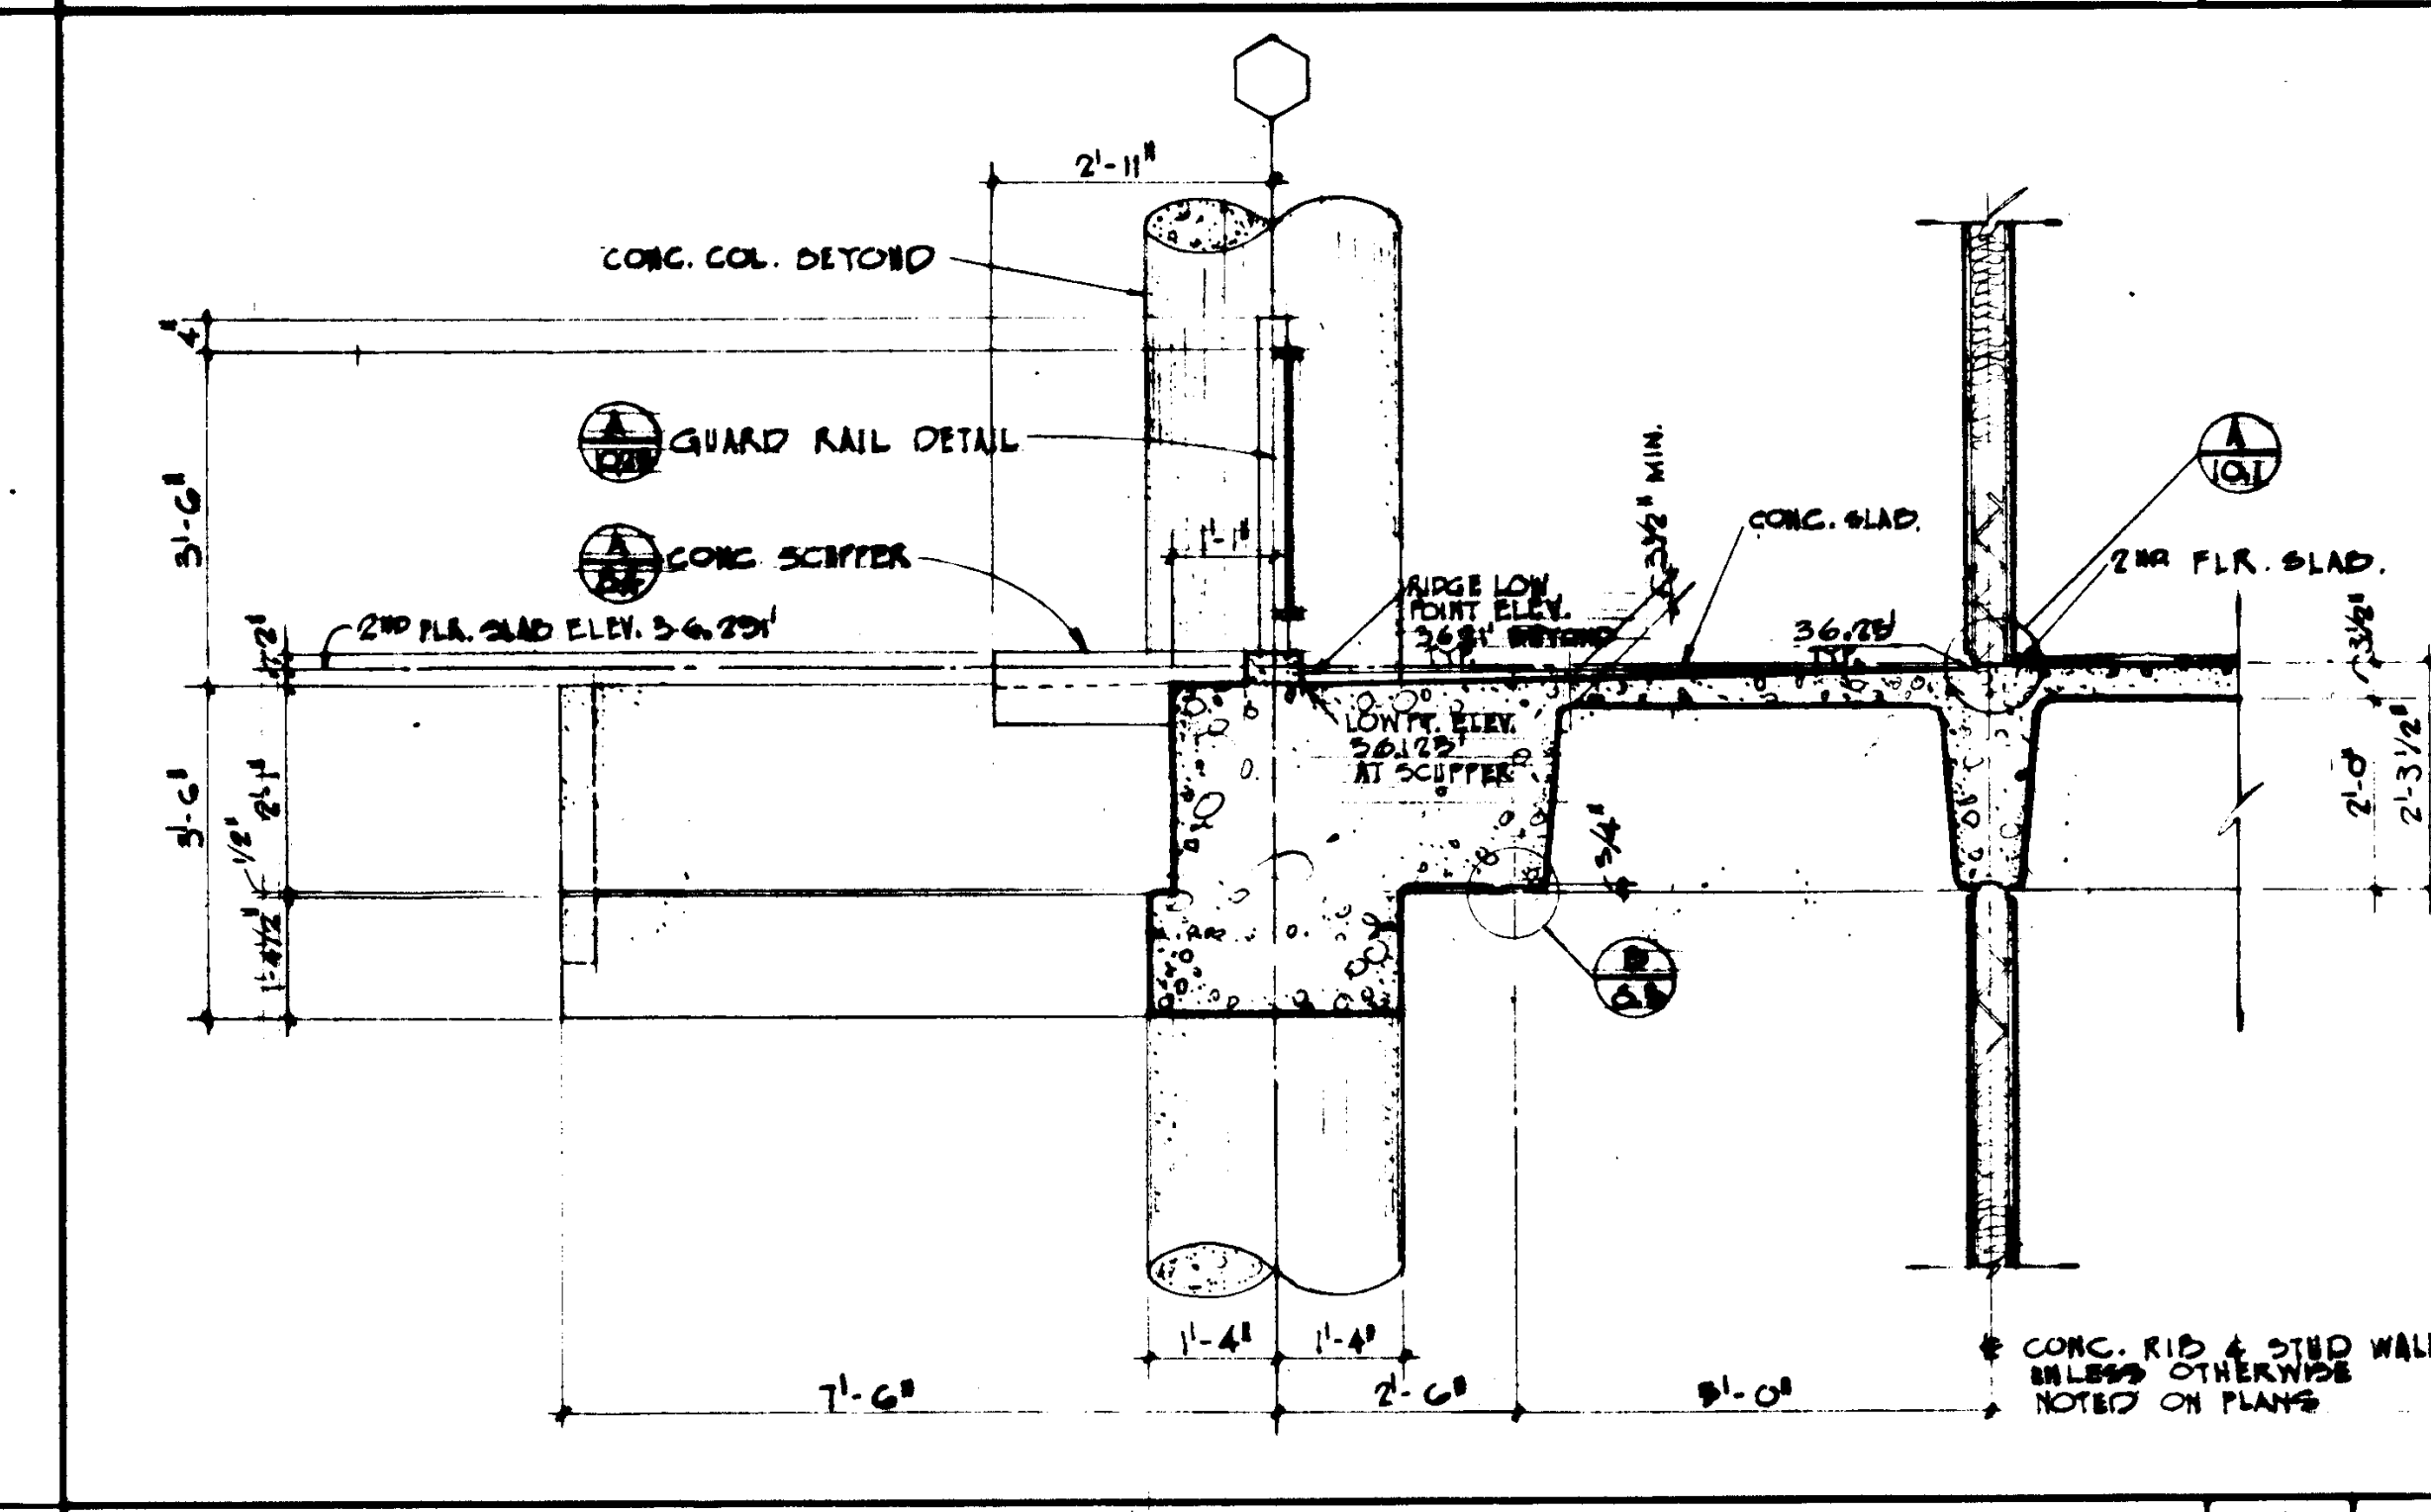
END ELEV.

SCALE: 1/8" = 1'-0"

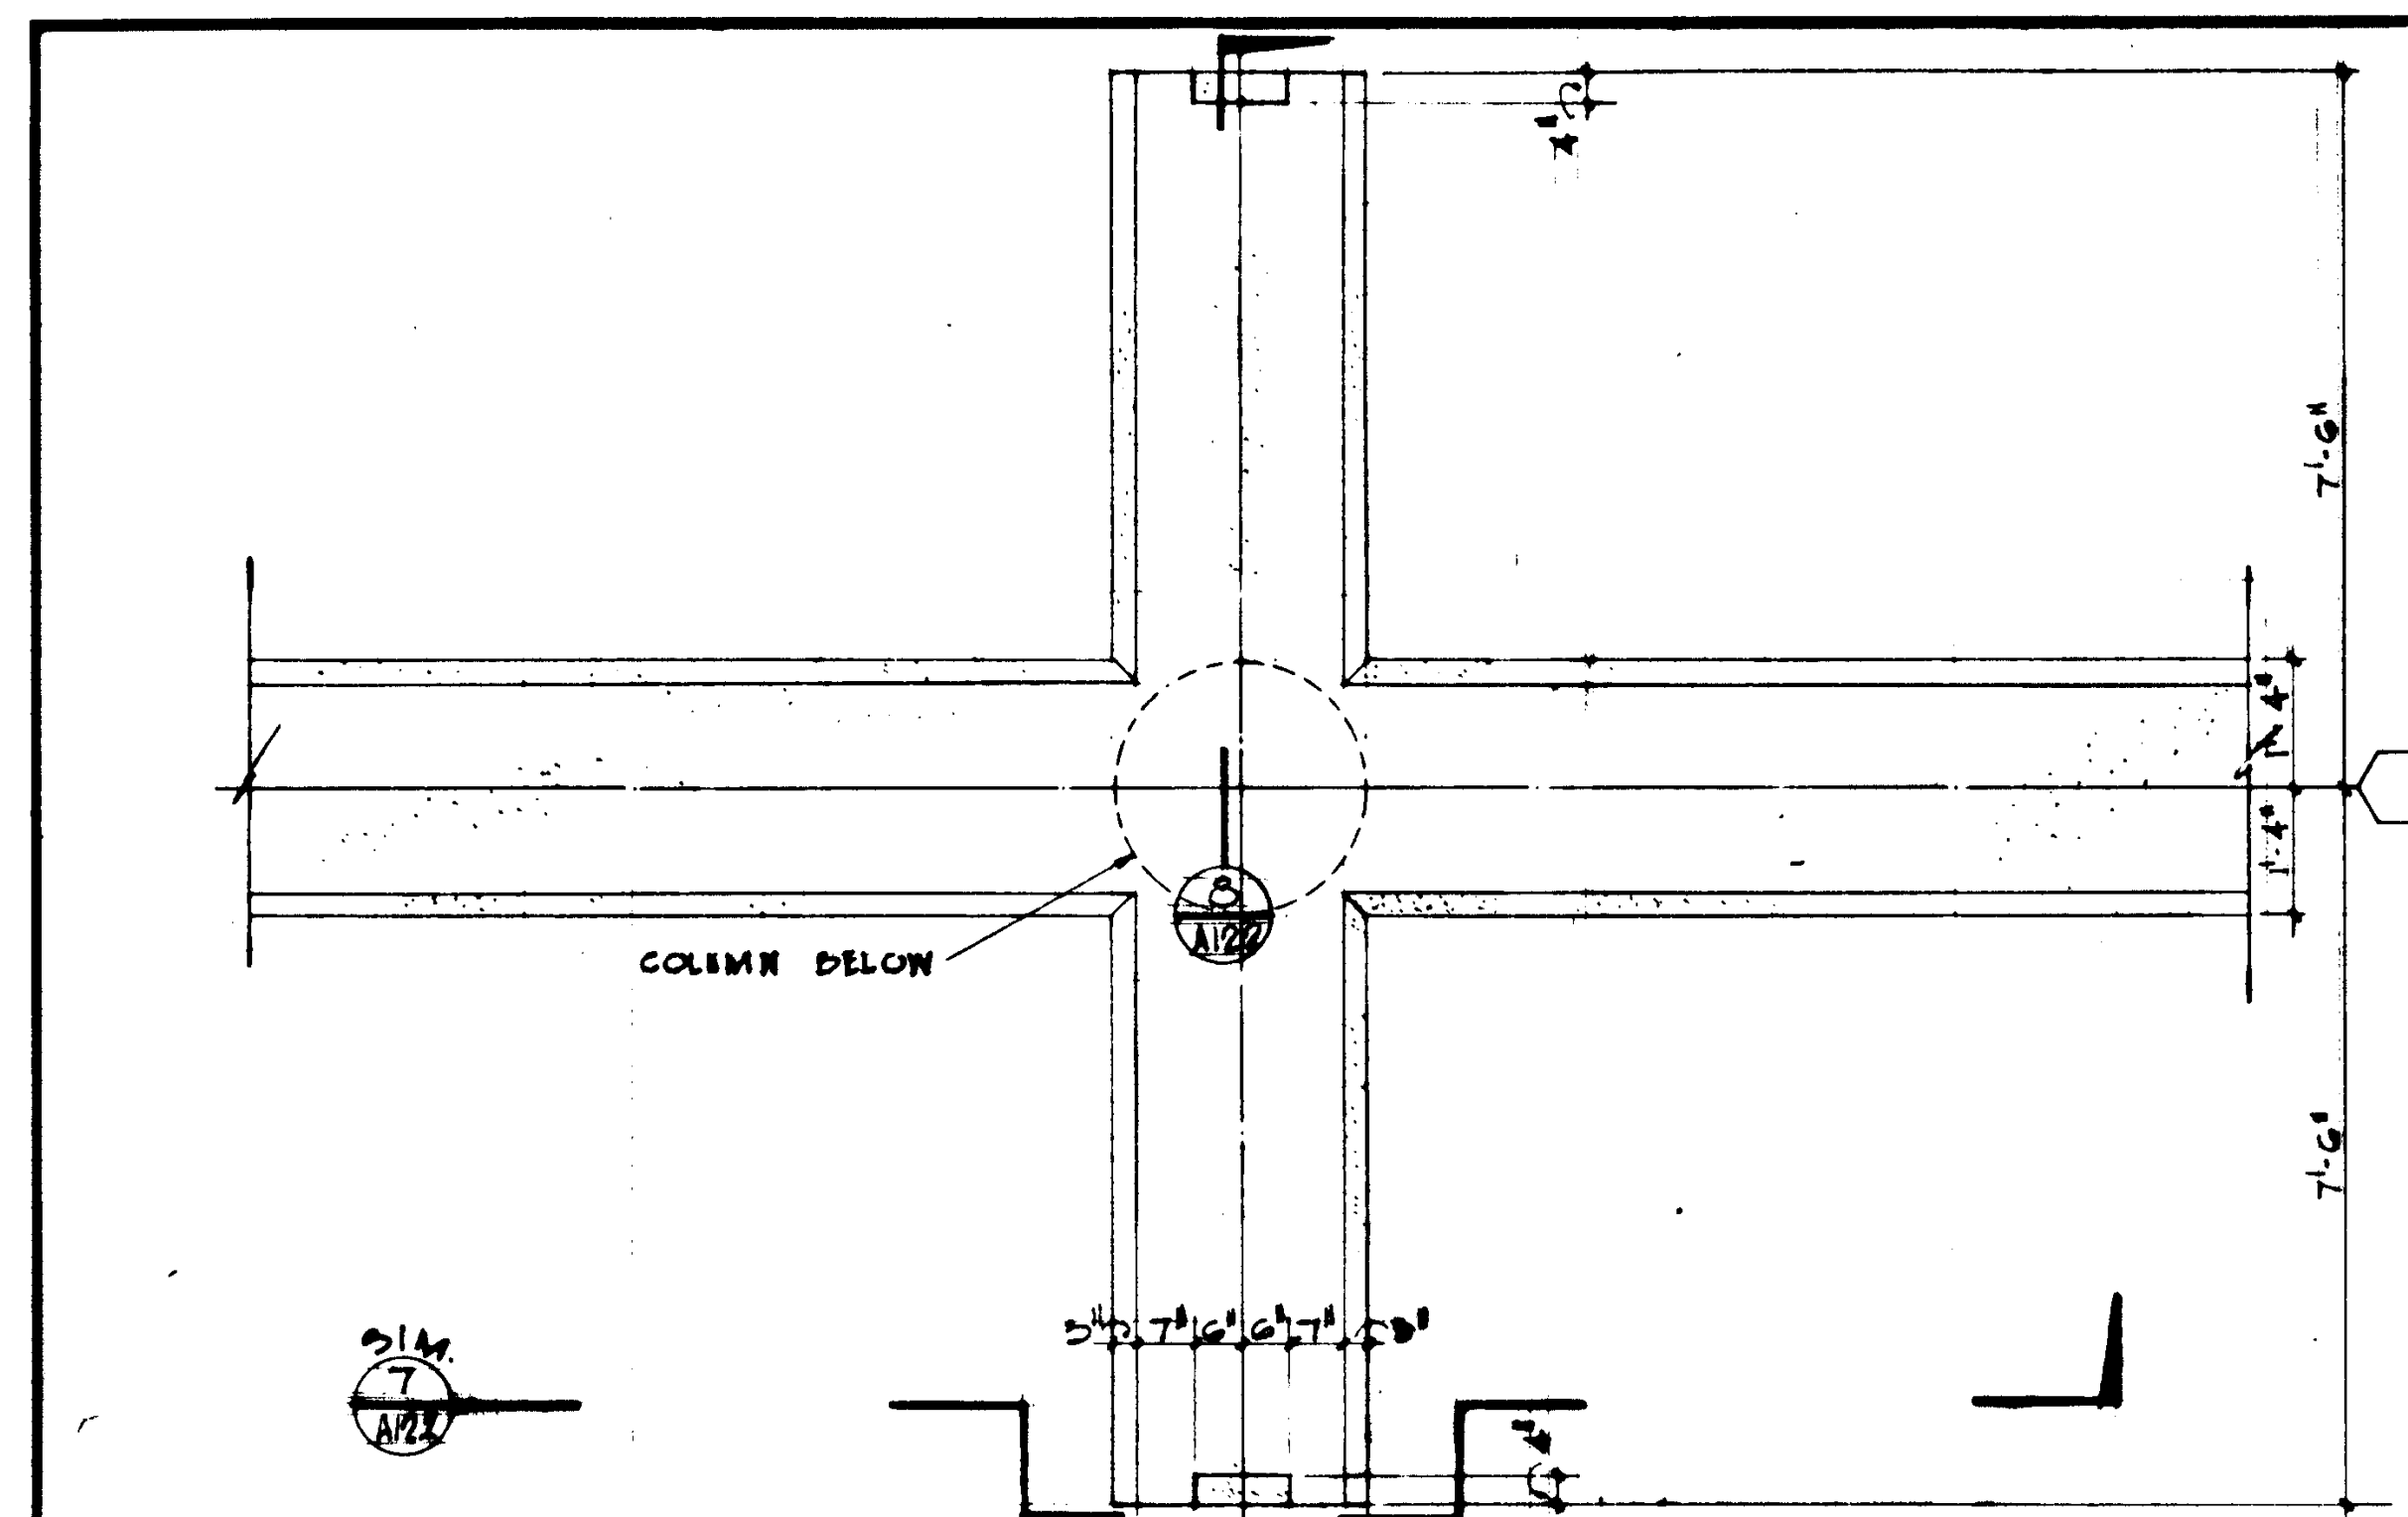

SECTION

SCALE: 1/8" = 1'-0"

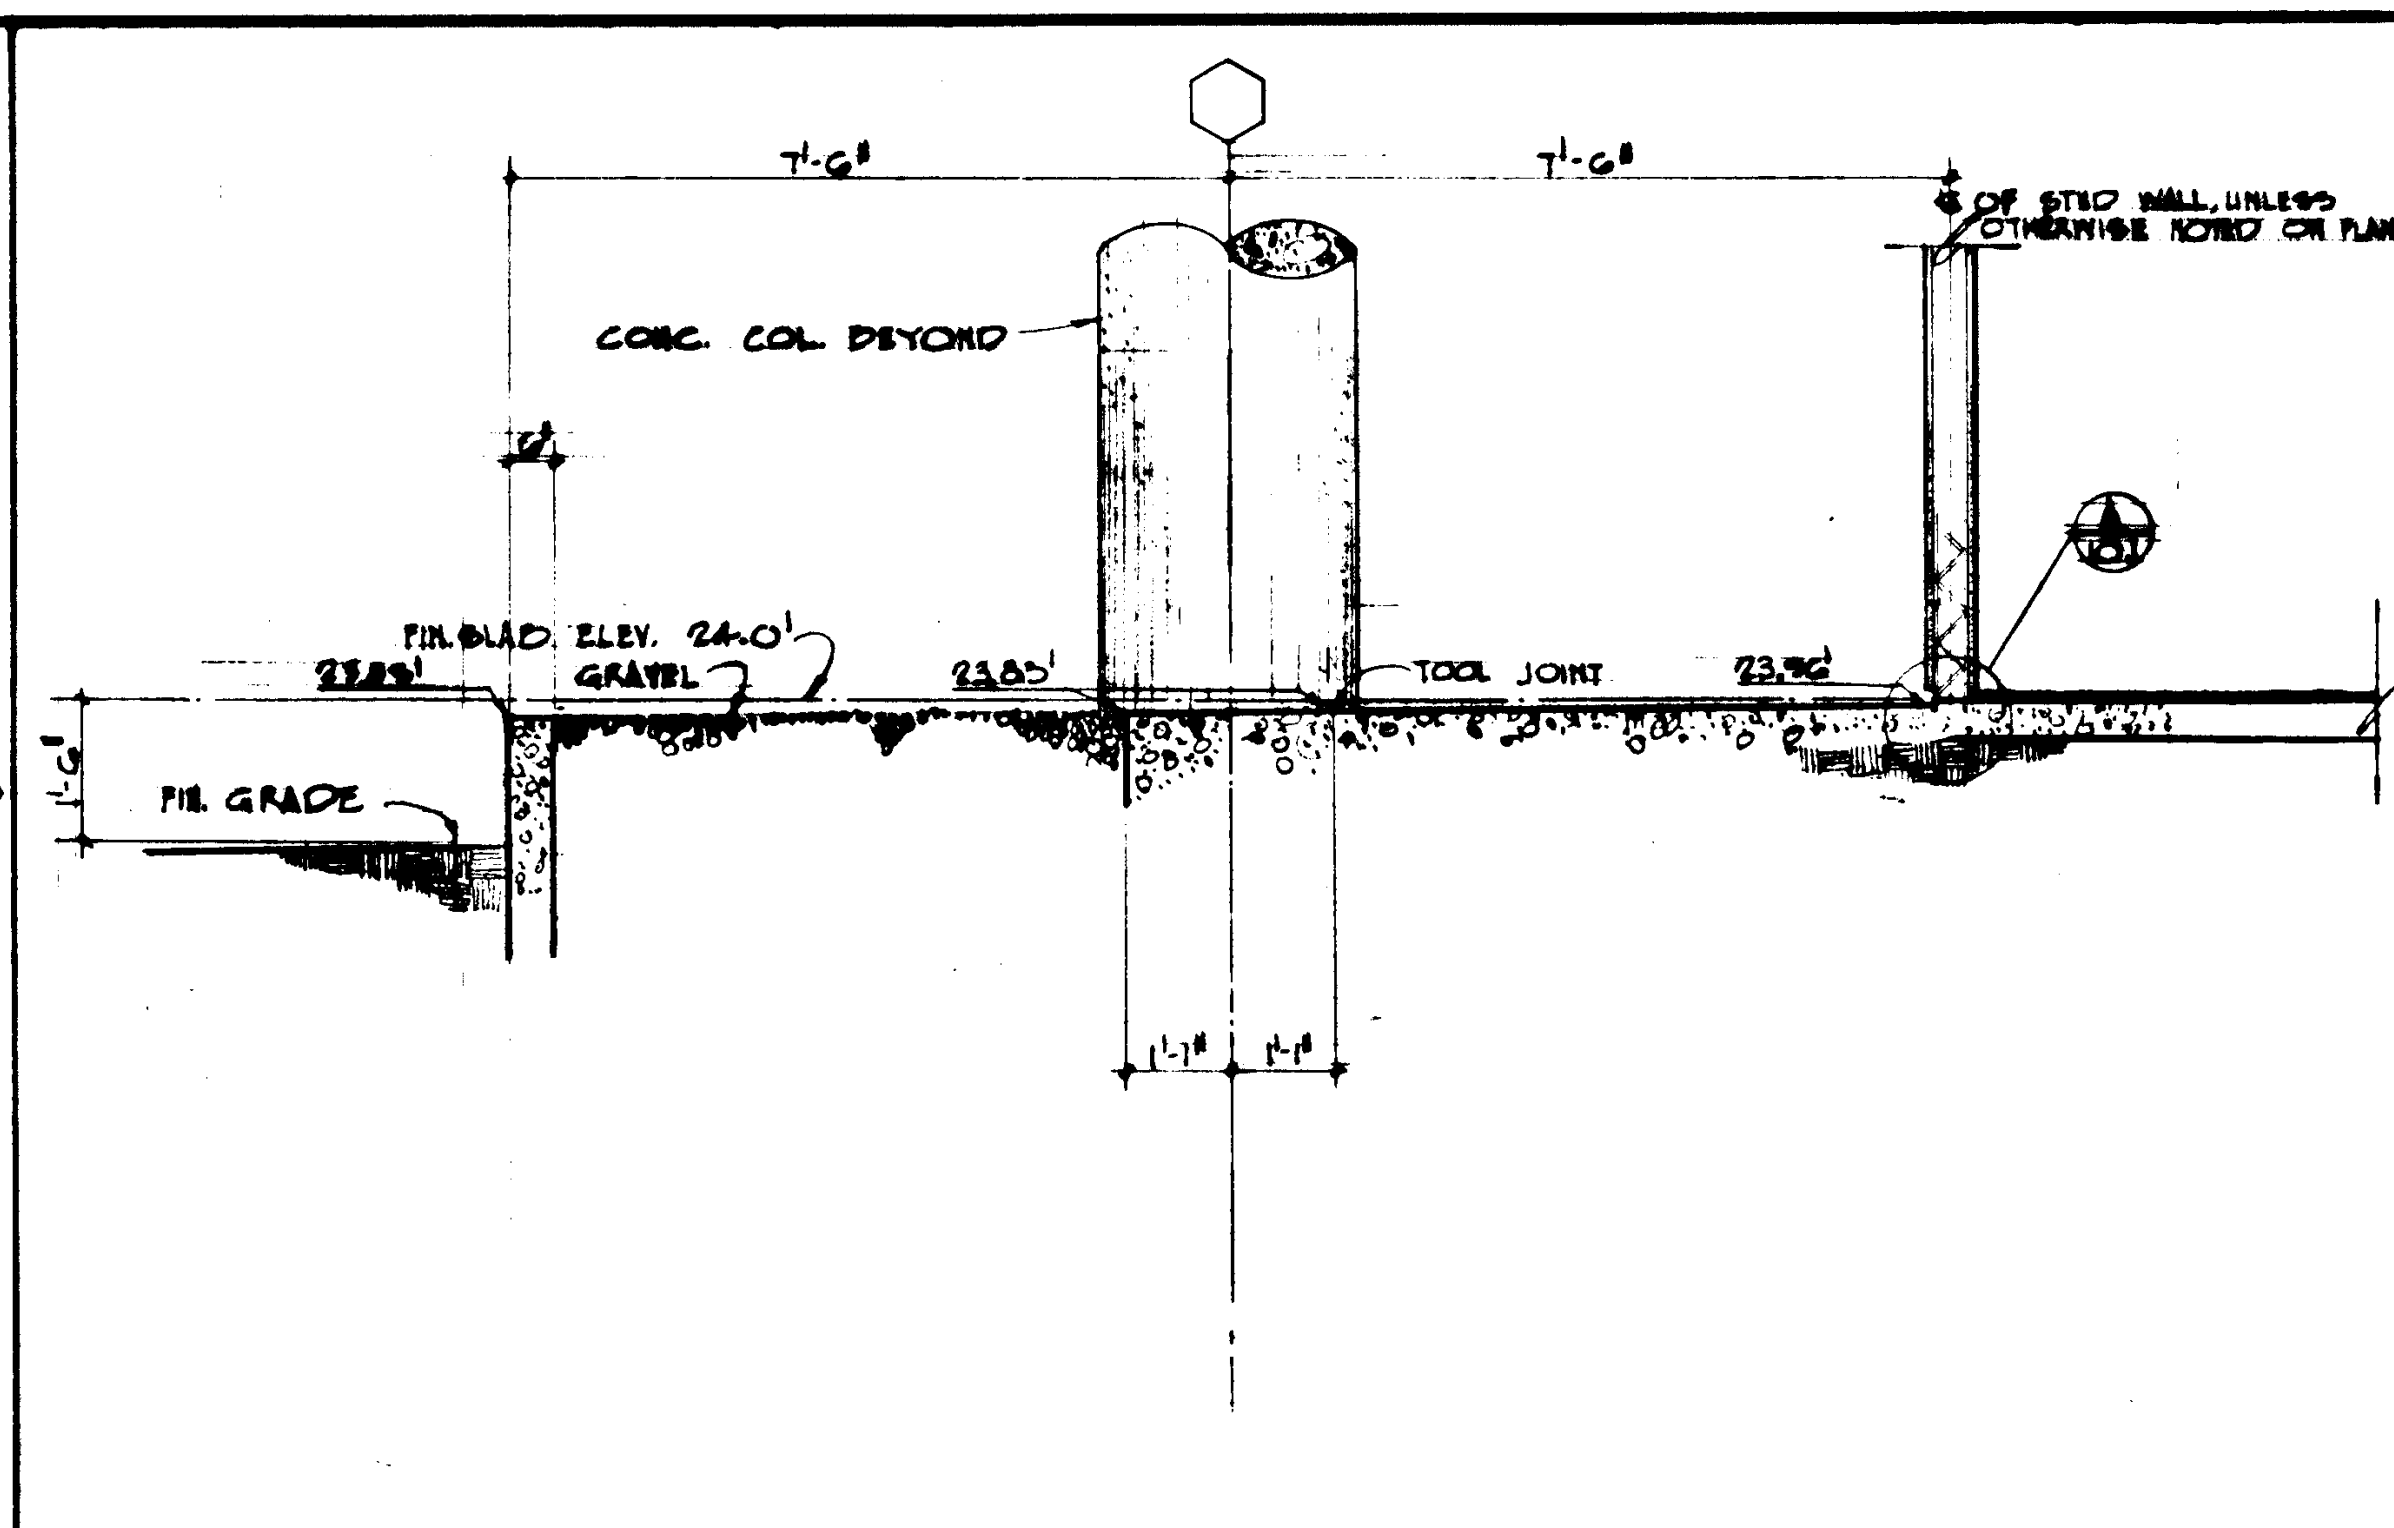

SECTION

SCALE: 1/8" = 1'-0"

REVISIONS	DATE	BY	REVISION


STRUCTURAL ENGINEERS	DESIGNED	ARCHITECT	APPROVED
BRANDON & JOHNSTON J.A. MARTIN & ASSOCIATES	DRAWN BY	ENGINEER	STATE FIRE MARSHAL STATE OF CALIFORNIA DATE JUN 21 1965
Mechanical ENGINEERS RALPH E. PHILLIPS, INC.	CHECKED BY	COLLGE	
ELECTRICAL ENGINEERS RALPH E. PHILLIPS, INC.			
CIVIL ENGINEERS G. BRIDGMAN & ASSOCIATES MOFFATT & MICROL			

ASSOCIATED ARCHITECTS:
WILLIAM L. PEREIRA & ASSOCIATES
A. QUINCY JONES-FREDERICK E. EDMONDS & ASSOCIATES
BLURCK ELLERBROOK & ASSOCIATES

URBANUS SQUARE • MACARTHUR BOULEVARD AT FORD ROAD
TELEPHONE 714/675-2640 • CORONA DEL MAR, CALIFORNIA


GOLDEN WEST COLLEGE
HUNTINGTON BEACH, CALIFORNIA
ORANGE COAST JUNIOR COLLEGE DISTRICT

TYPICAL	JOB NO.
CONCRETE DETAILS	100-4
	DATE 15 JUN 1965
	SHEET NO. A 12.2

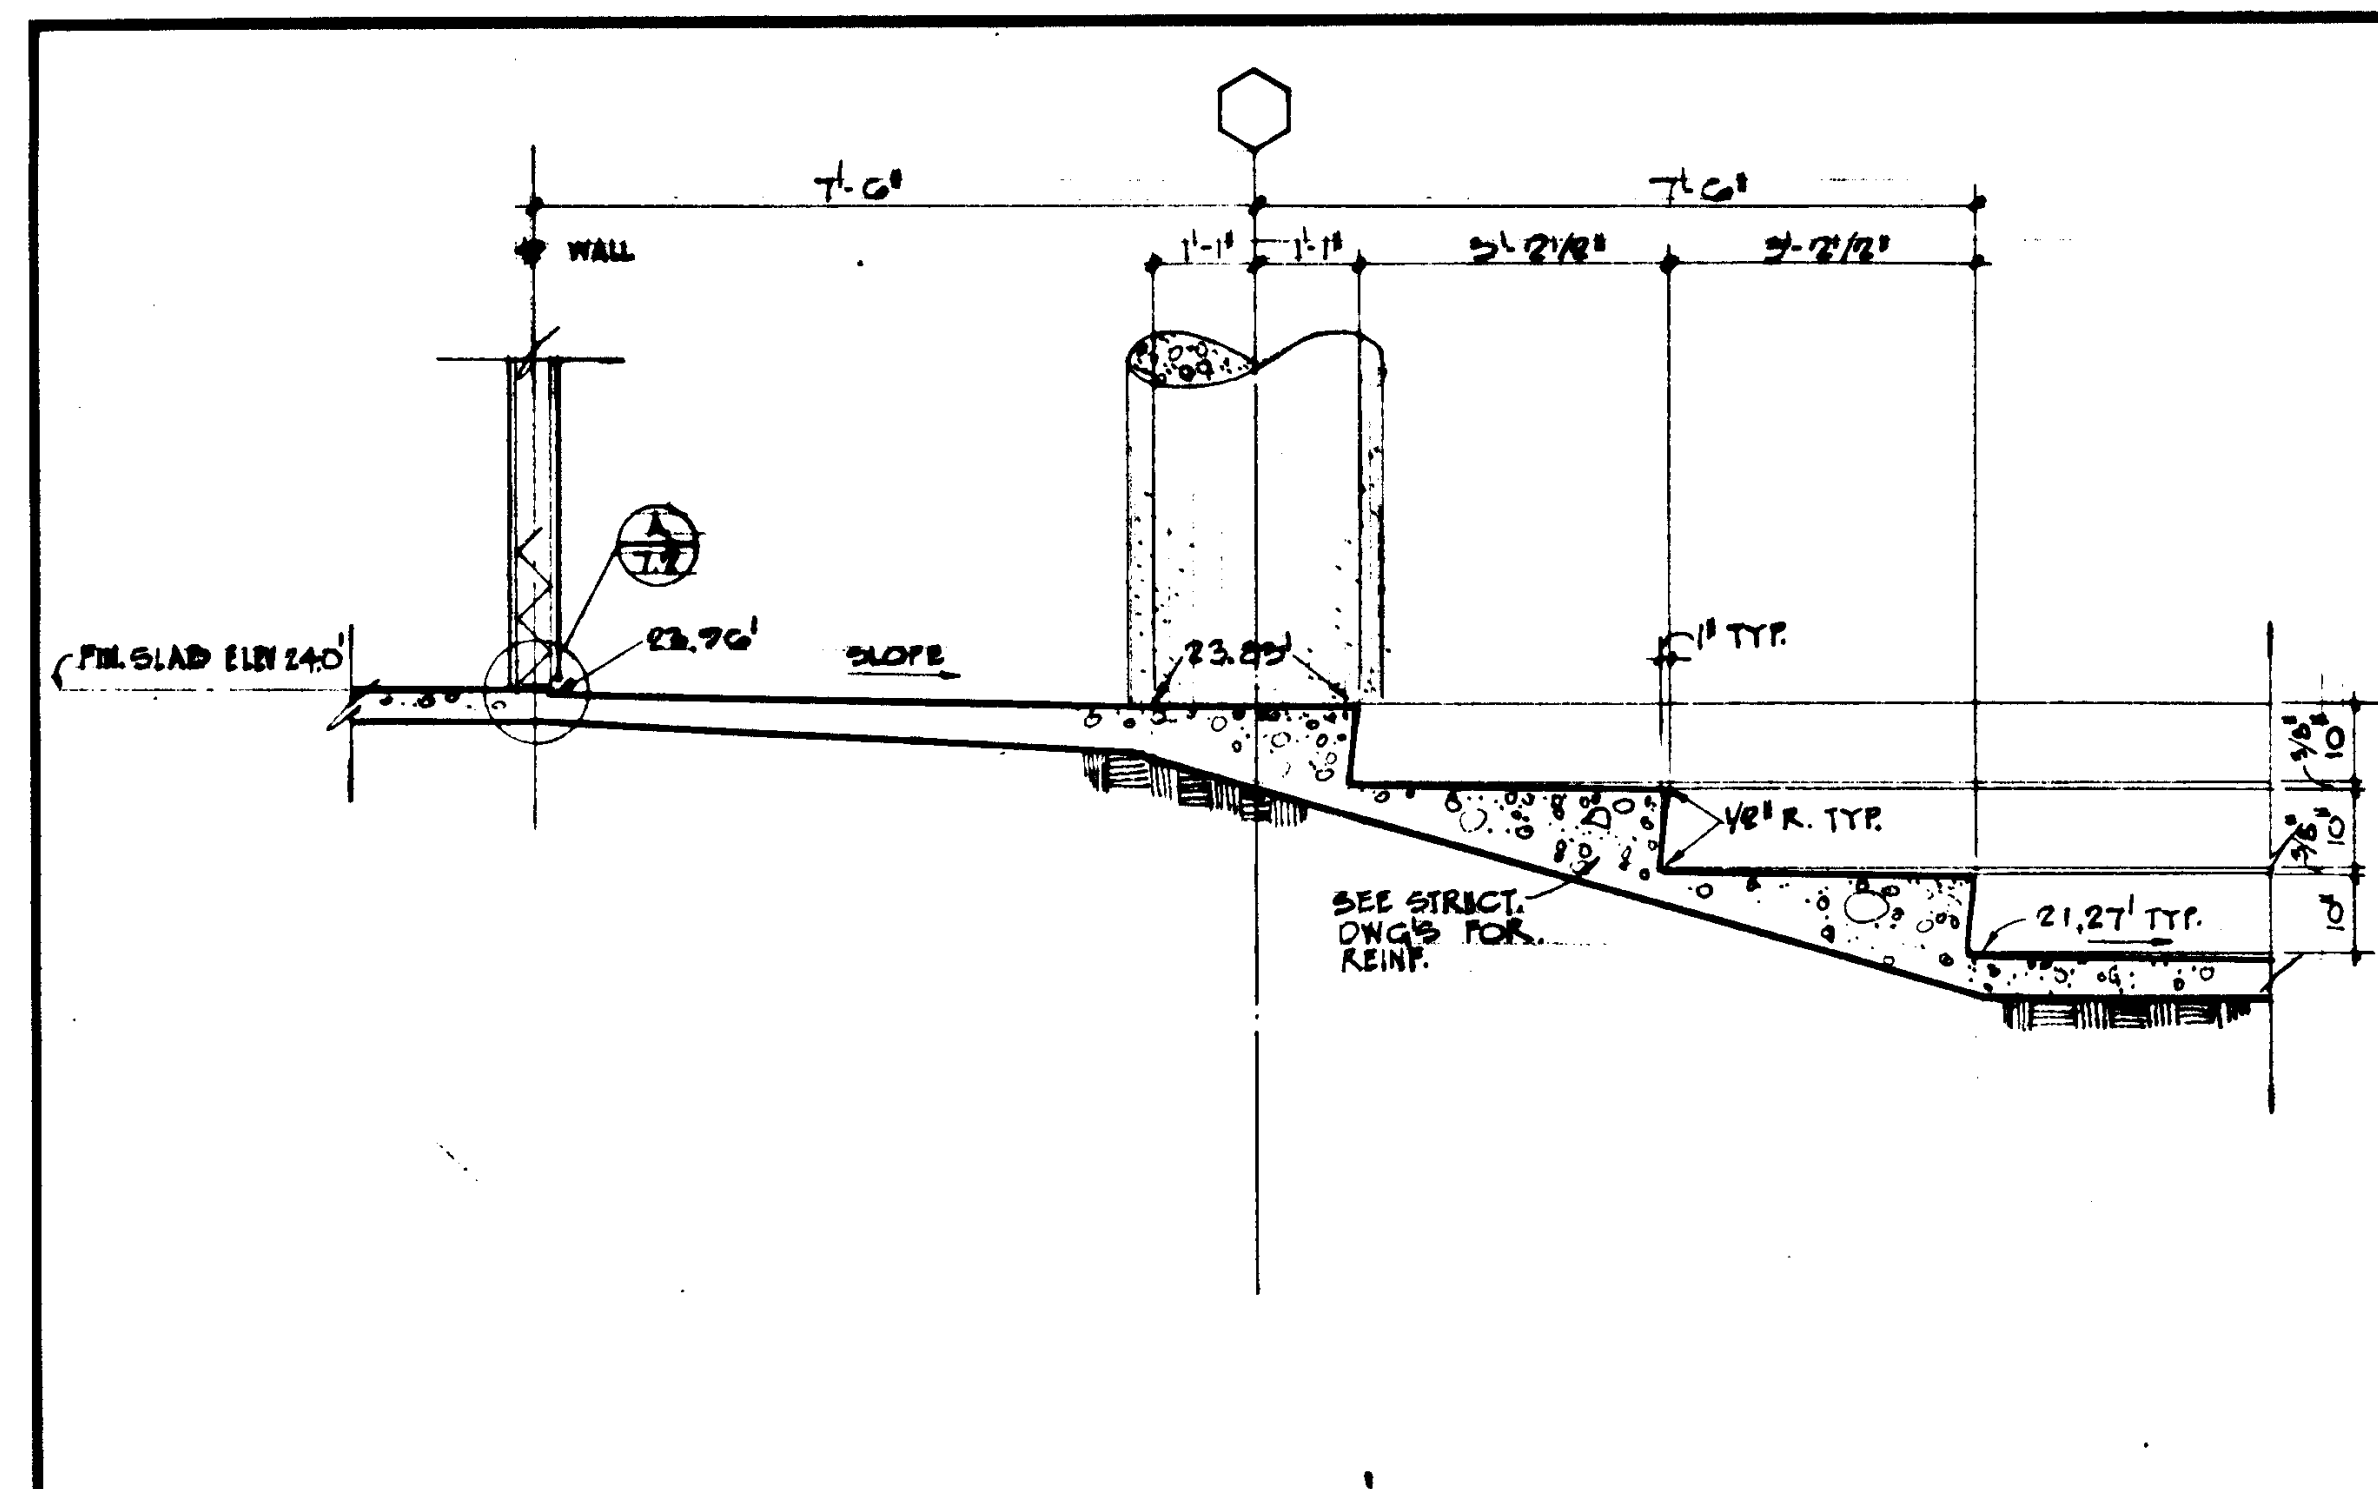


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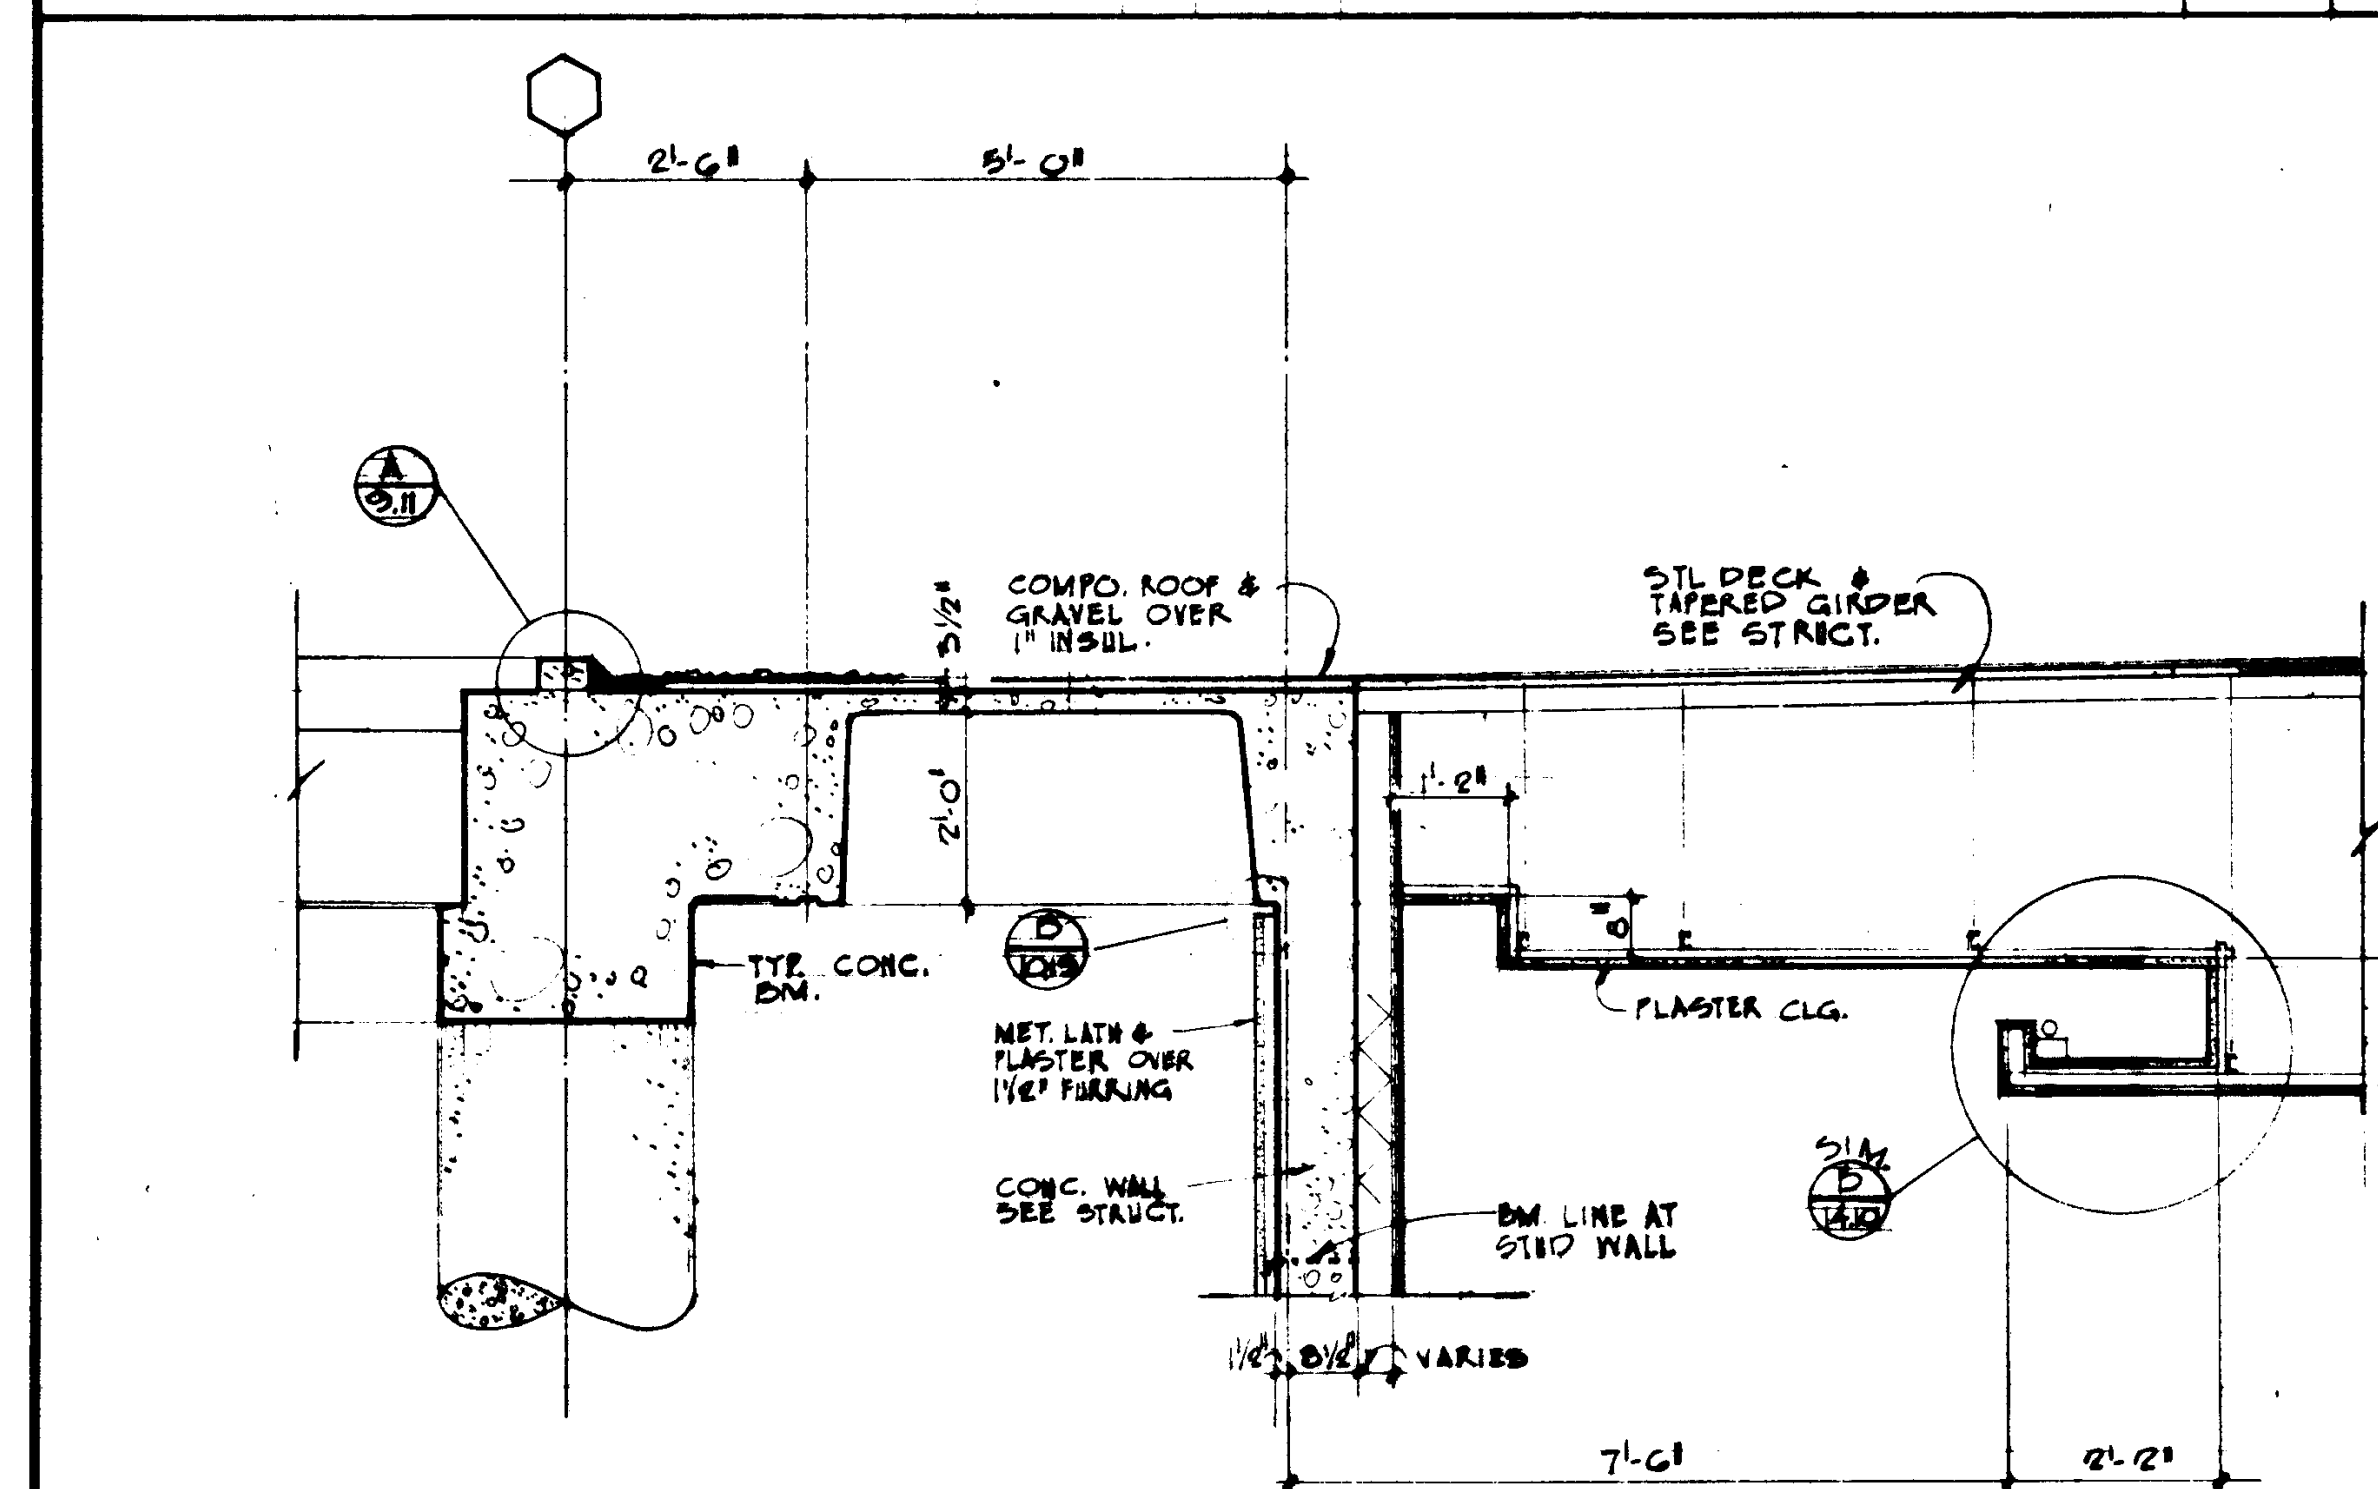
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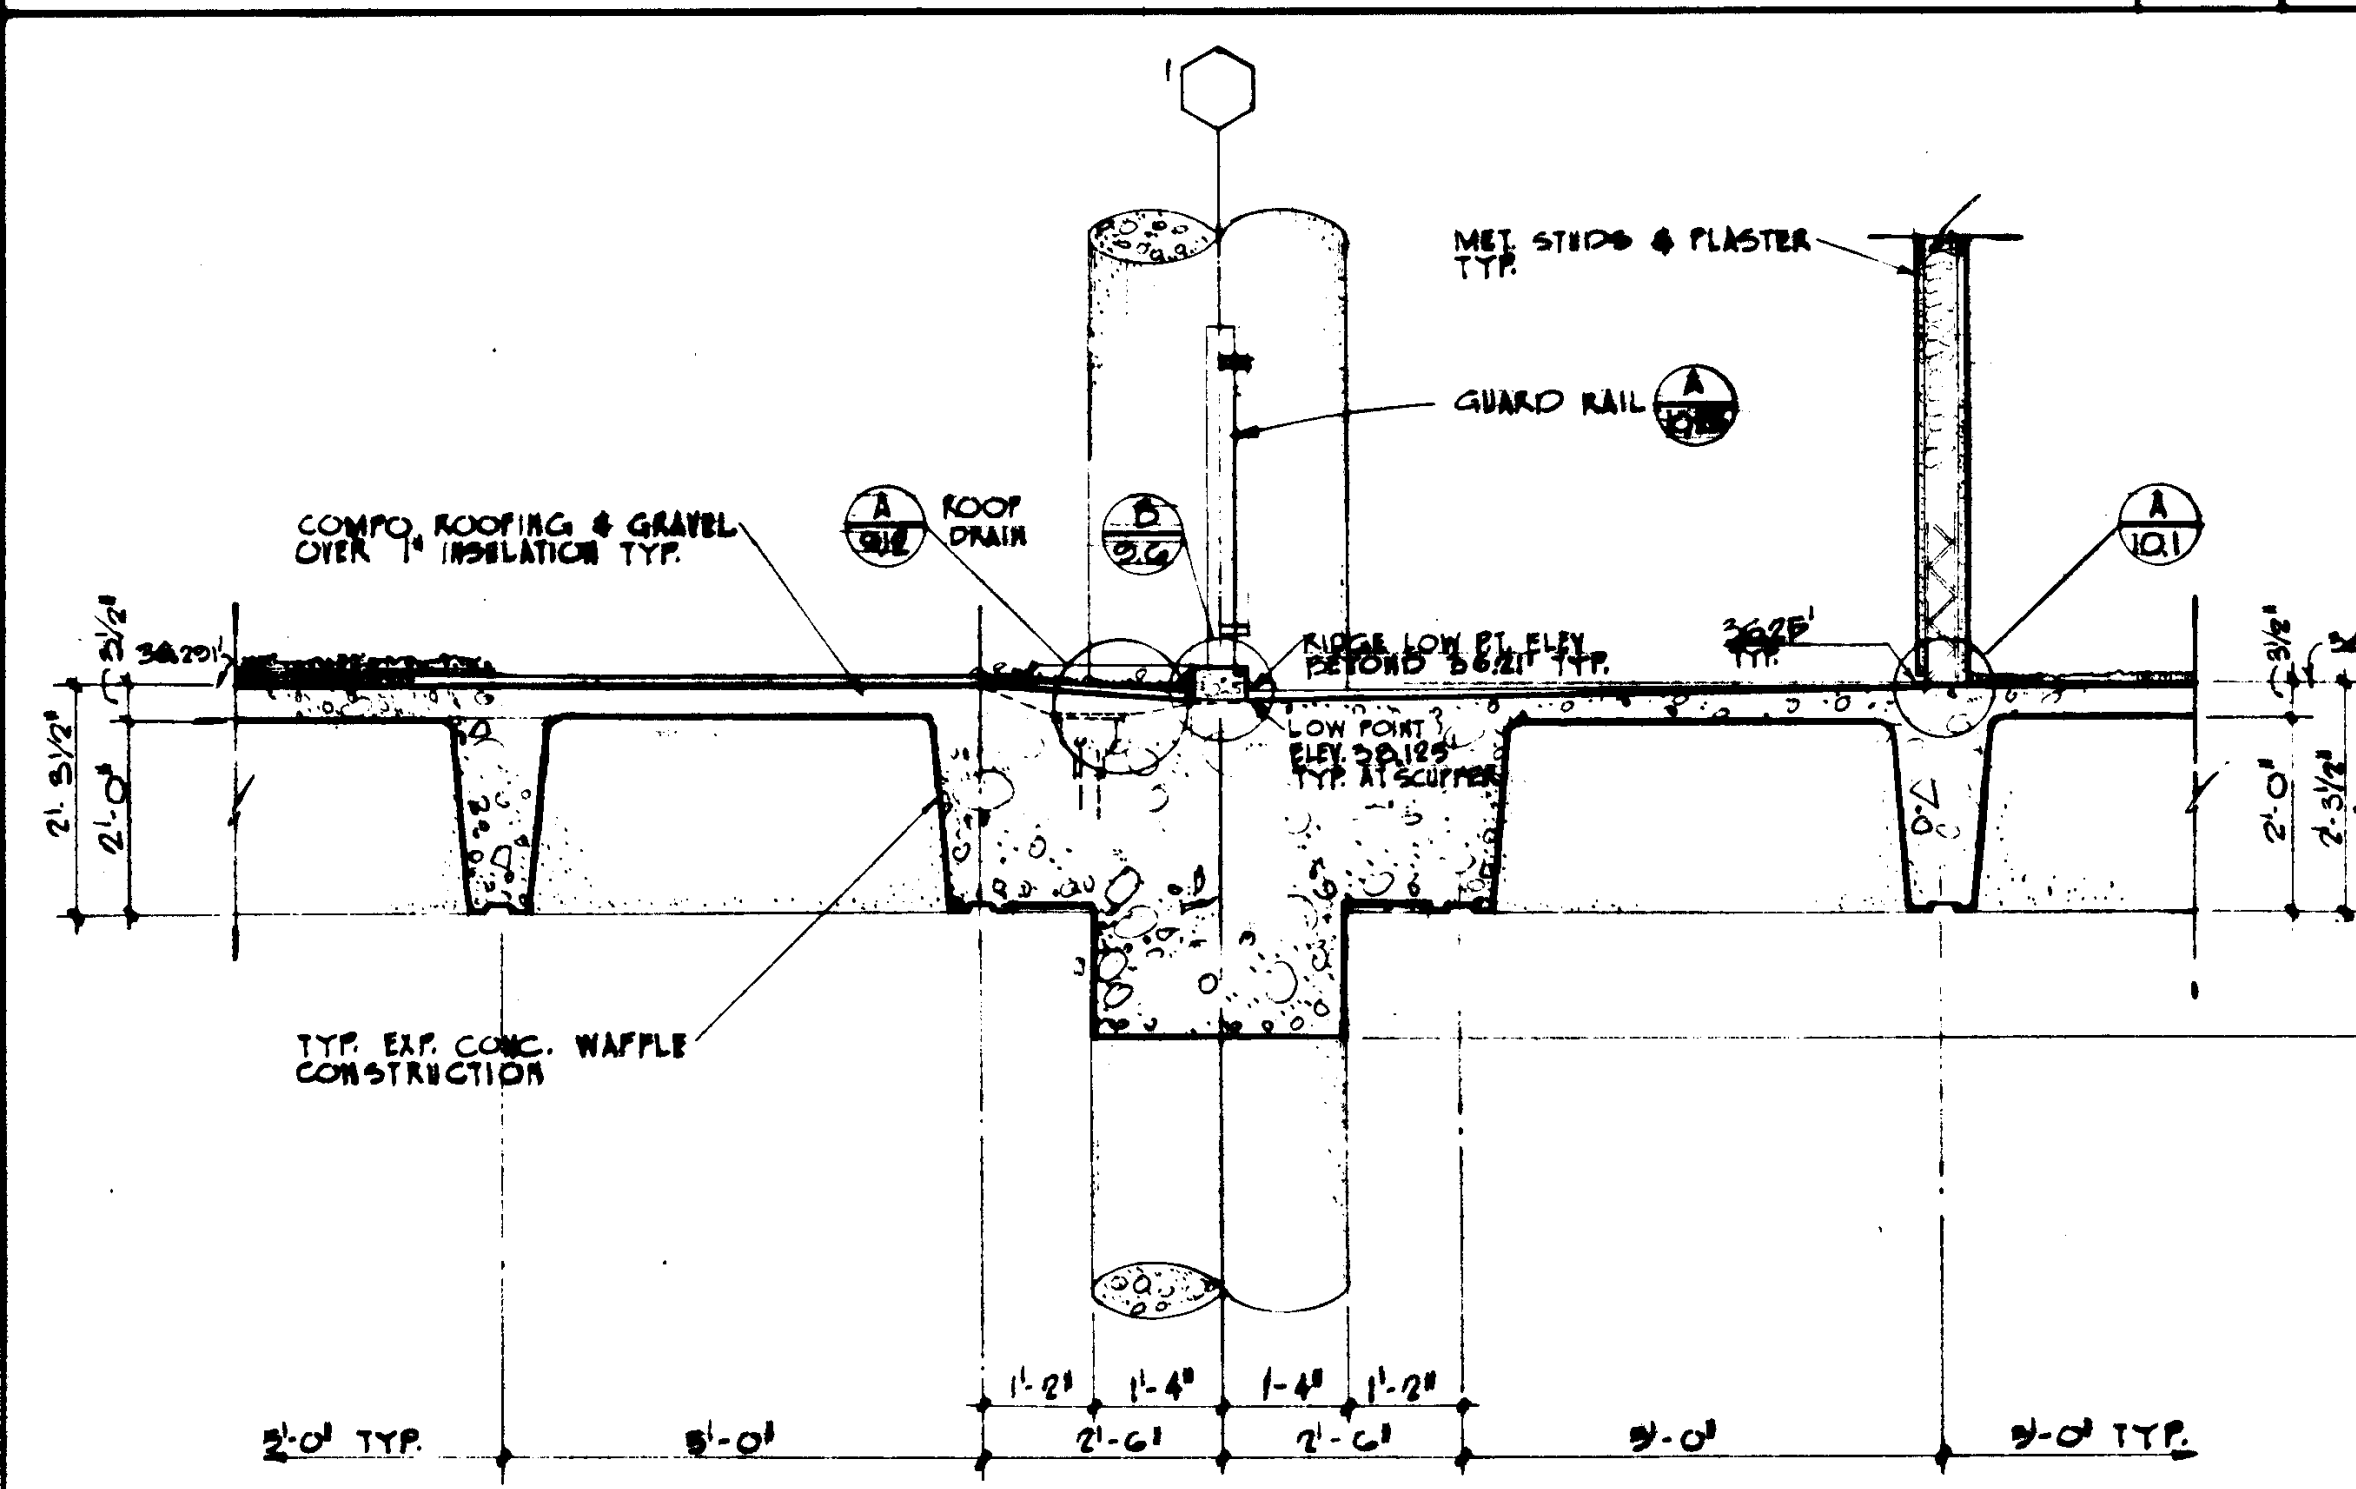
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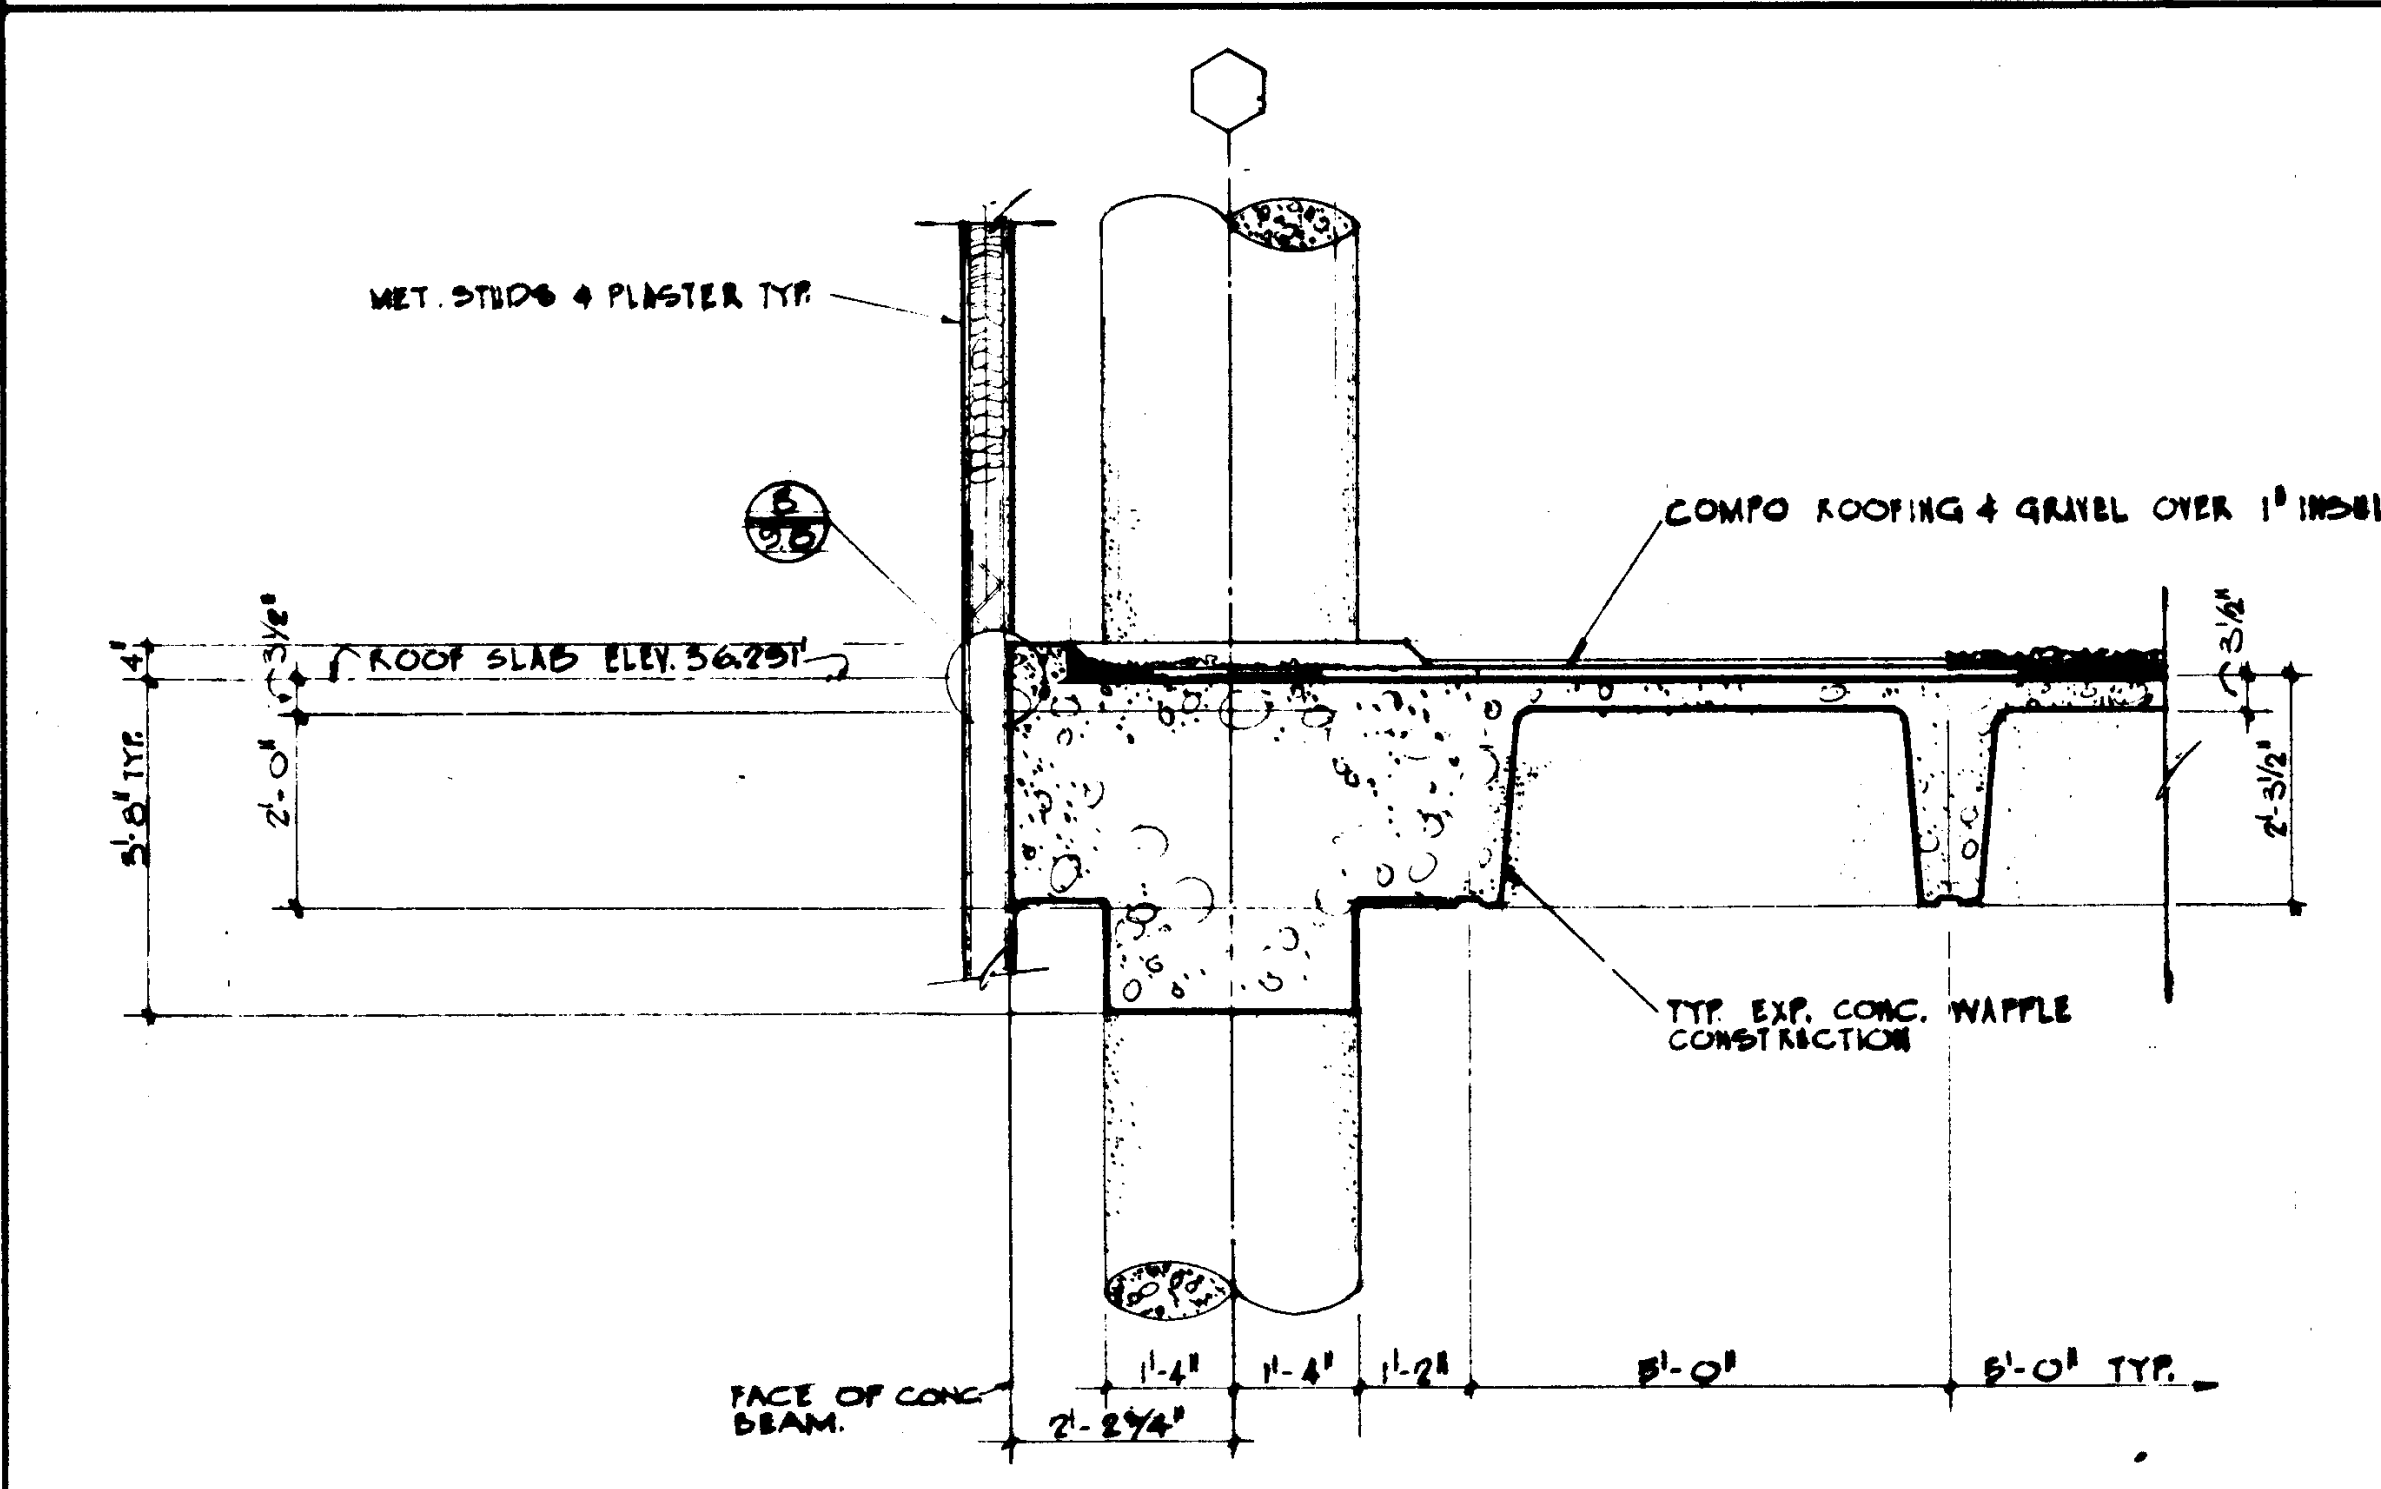
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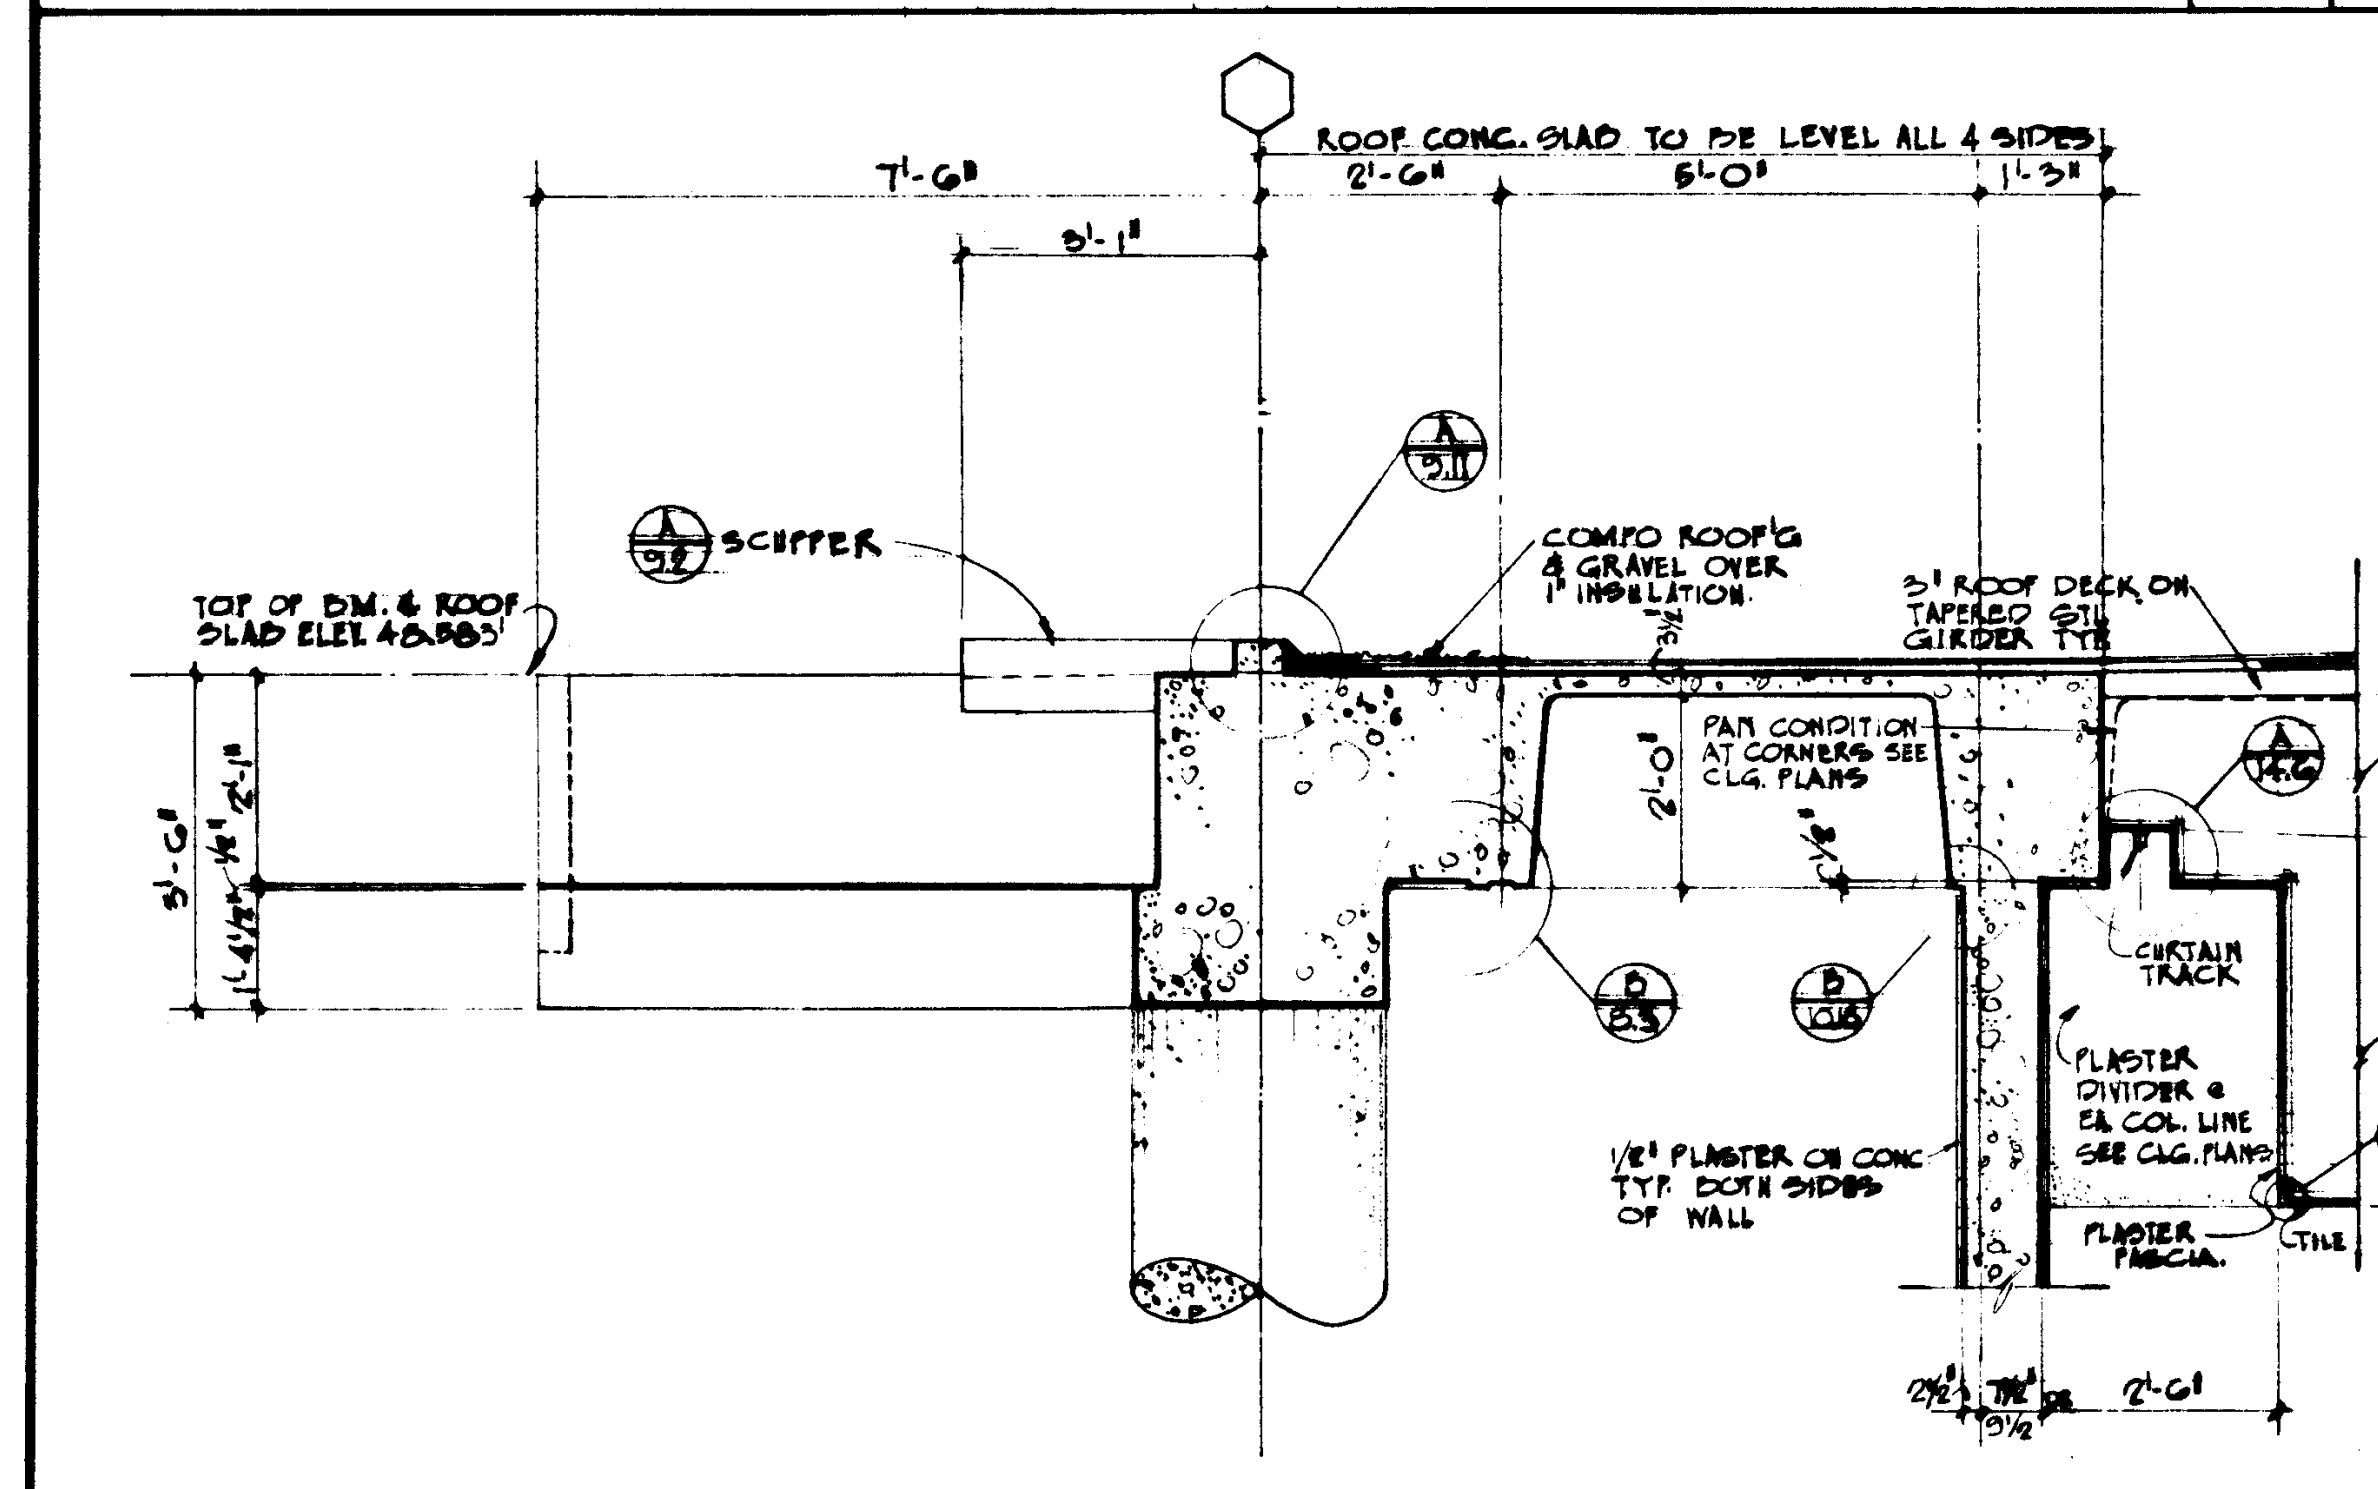
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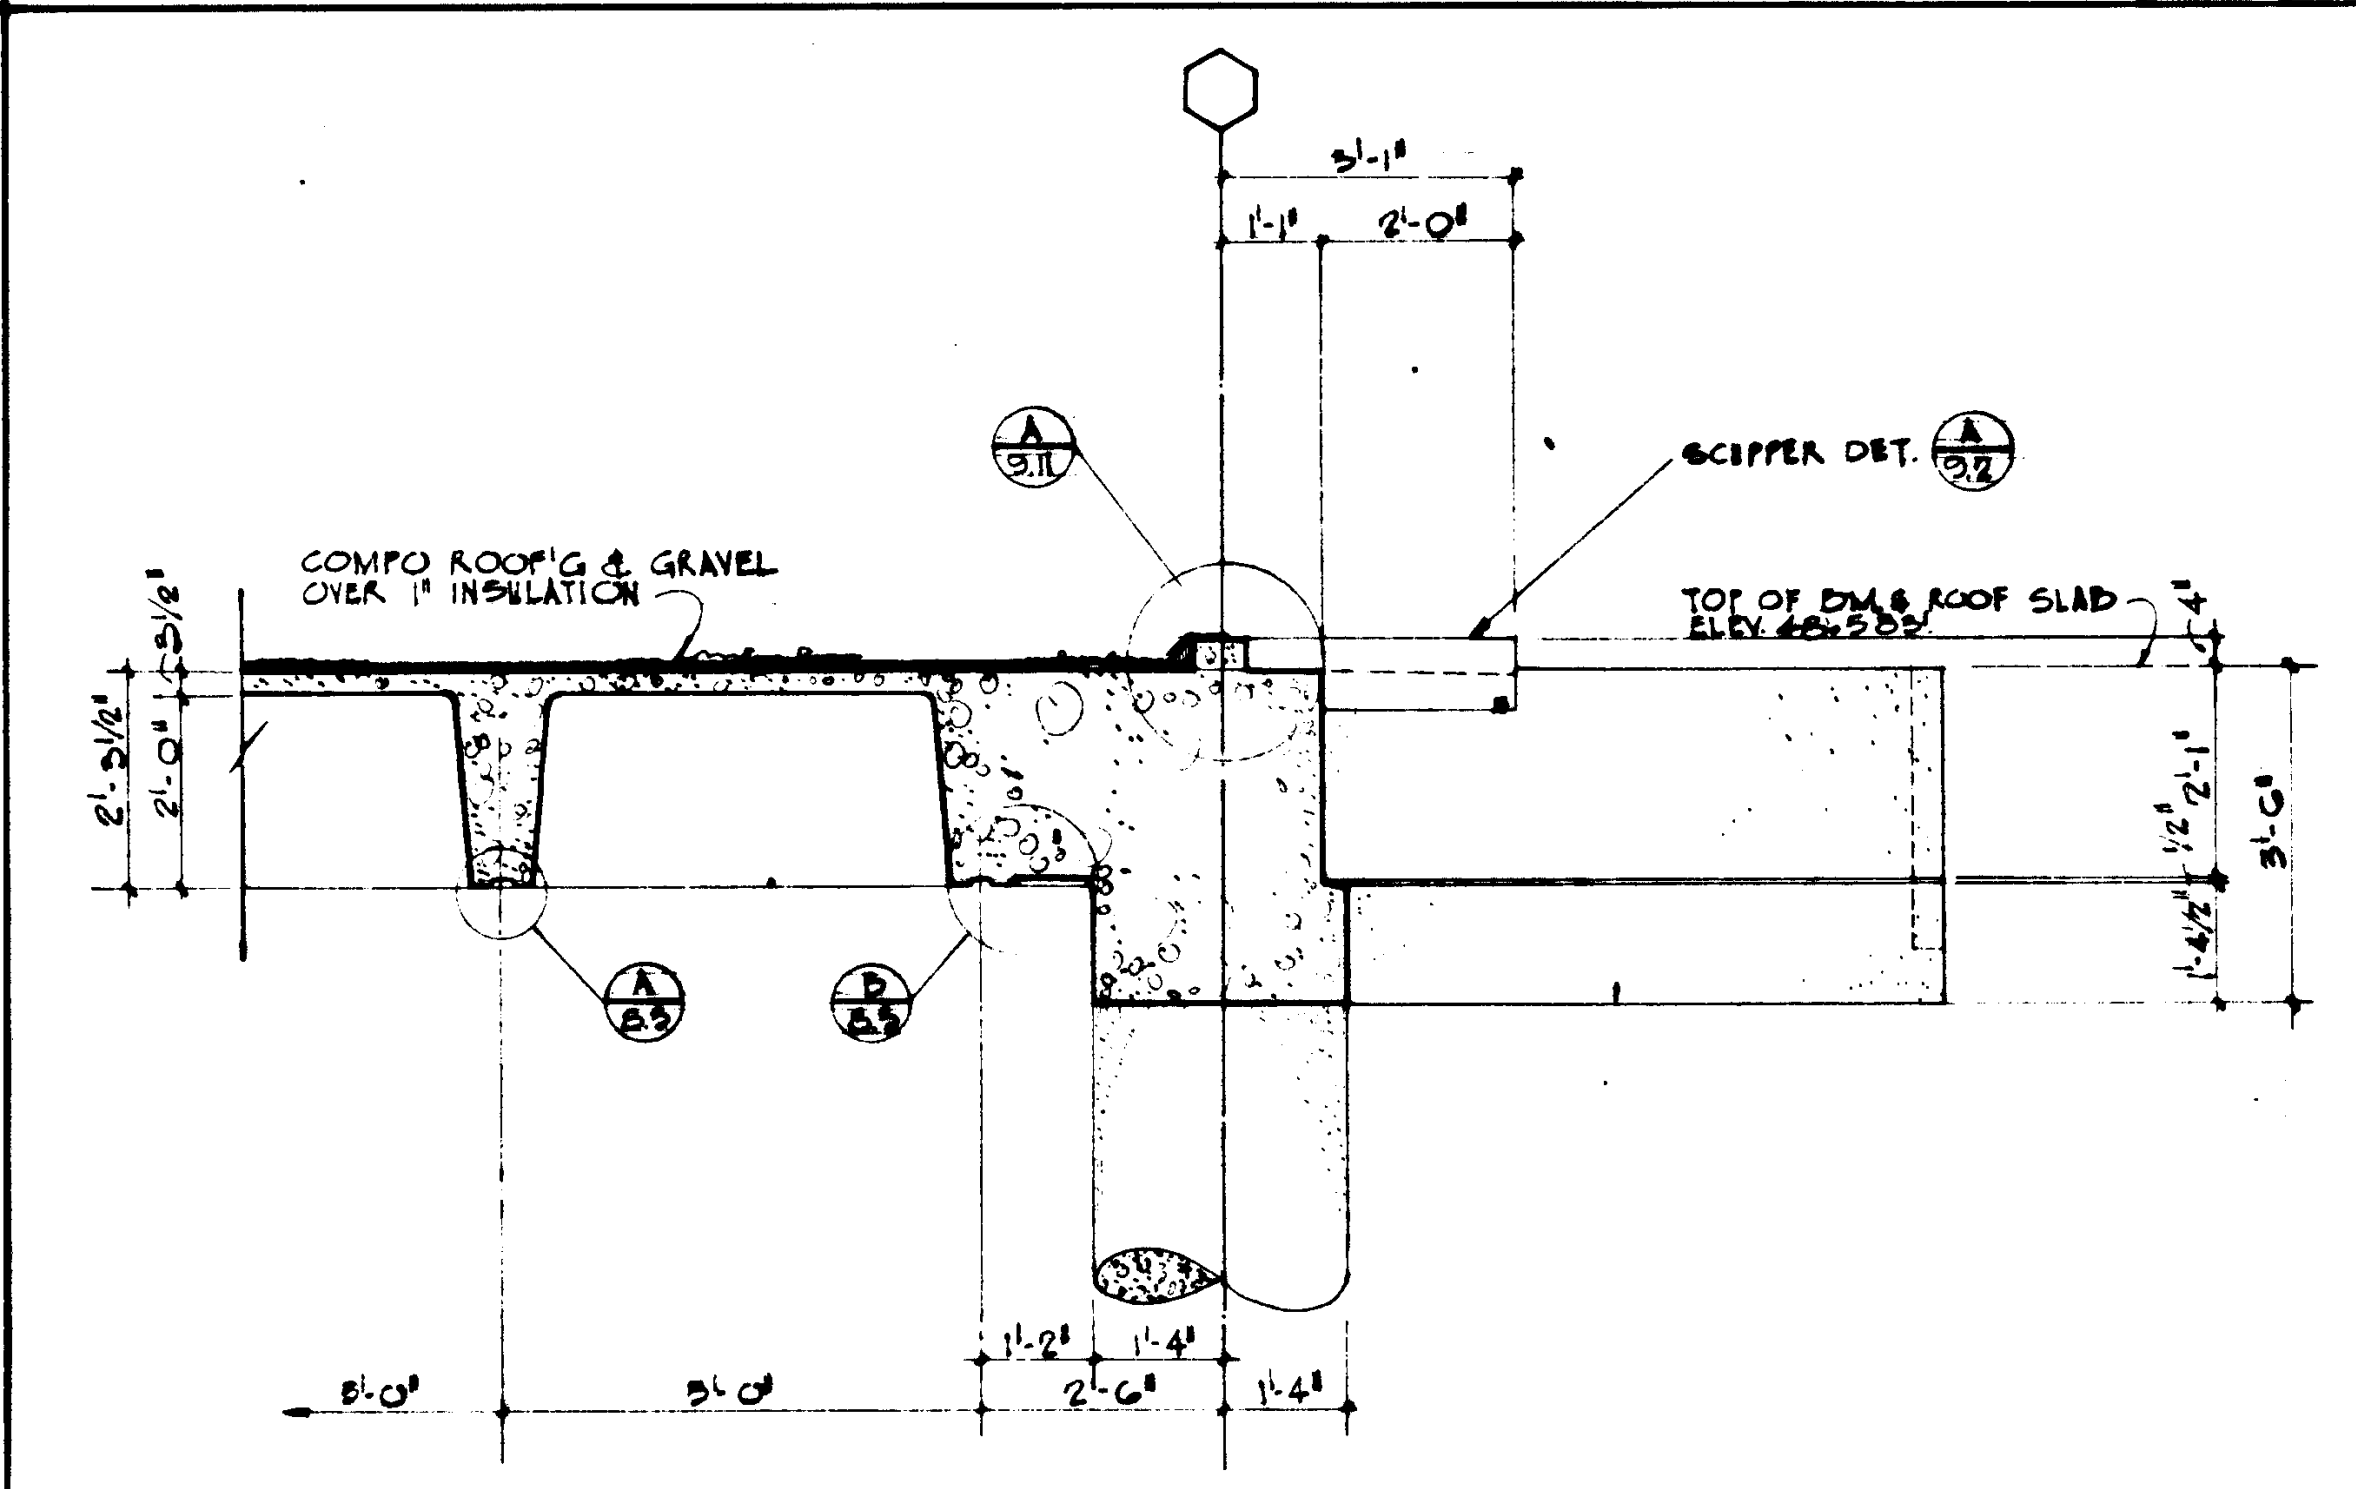
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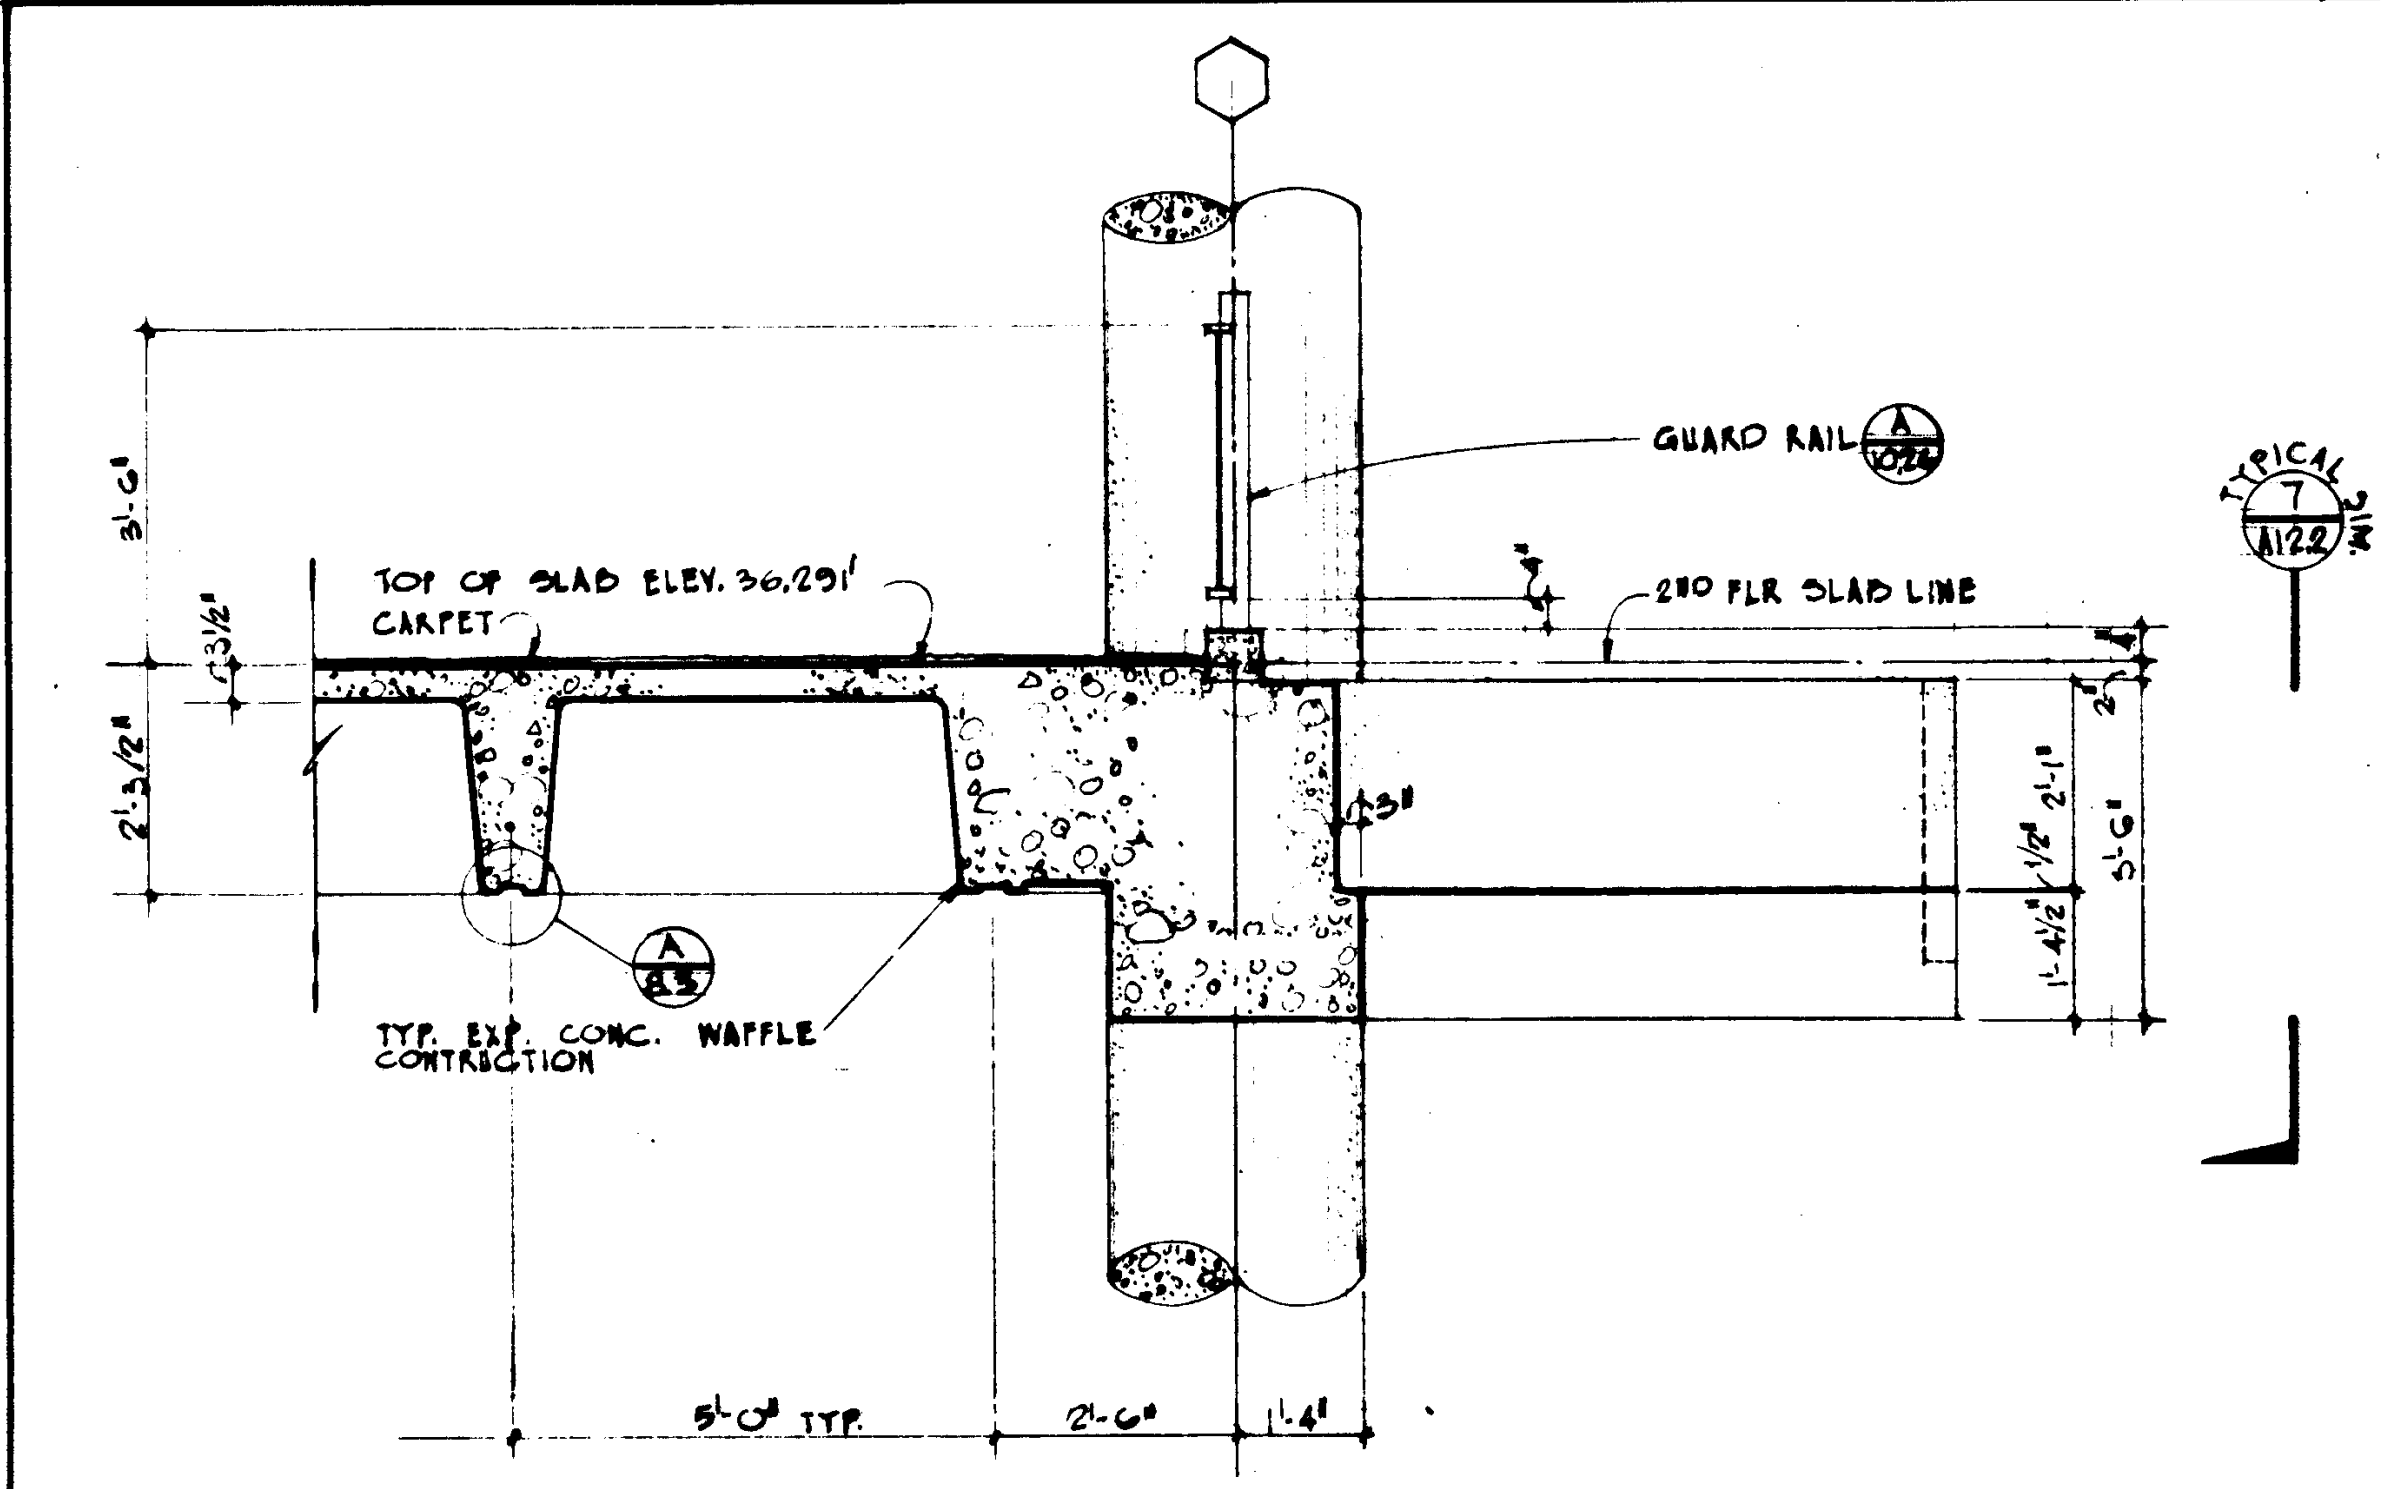
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SCALE: 1/2" = 1'-0"

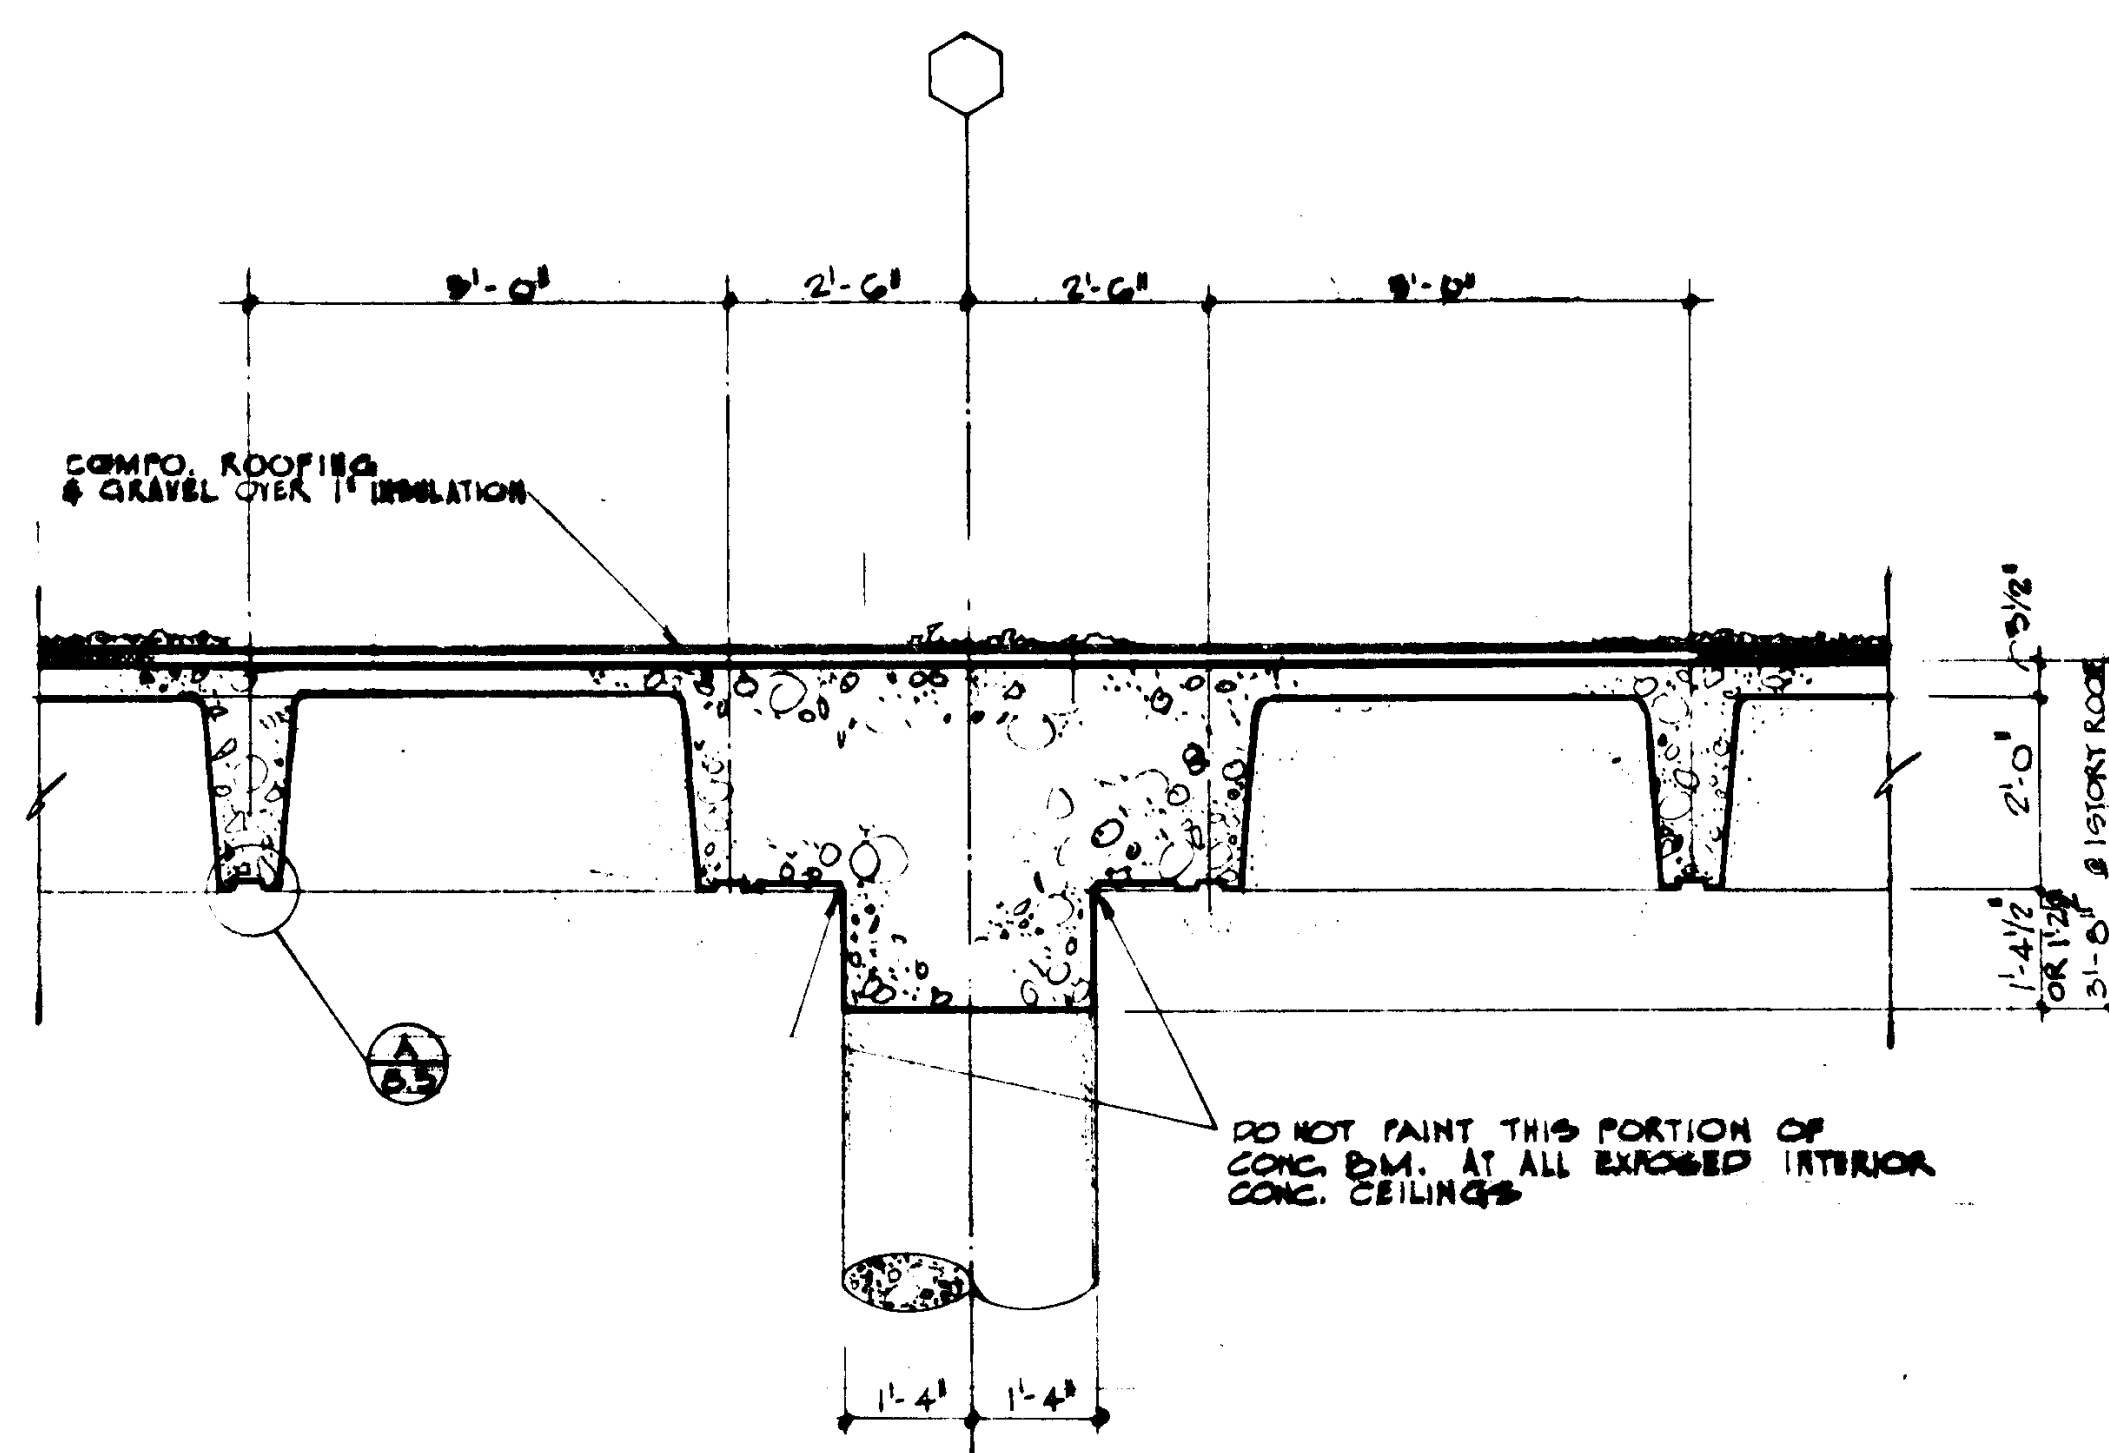

SECTION

SCALE: 1/2" = 1'-0"

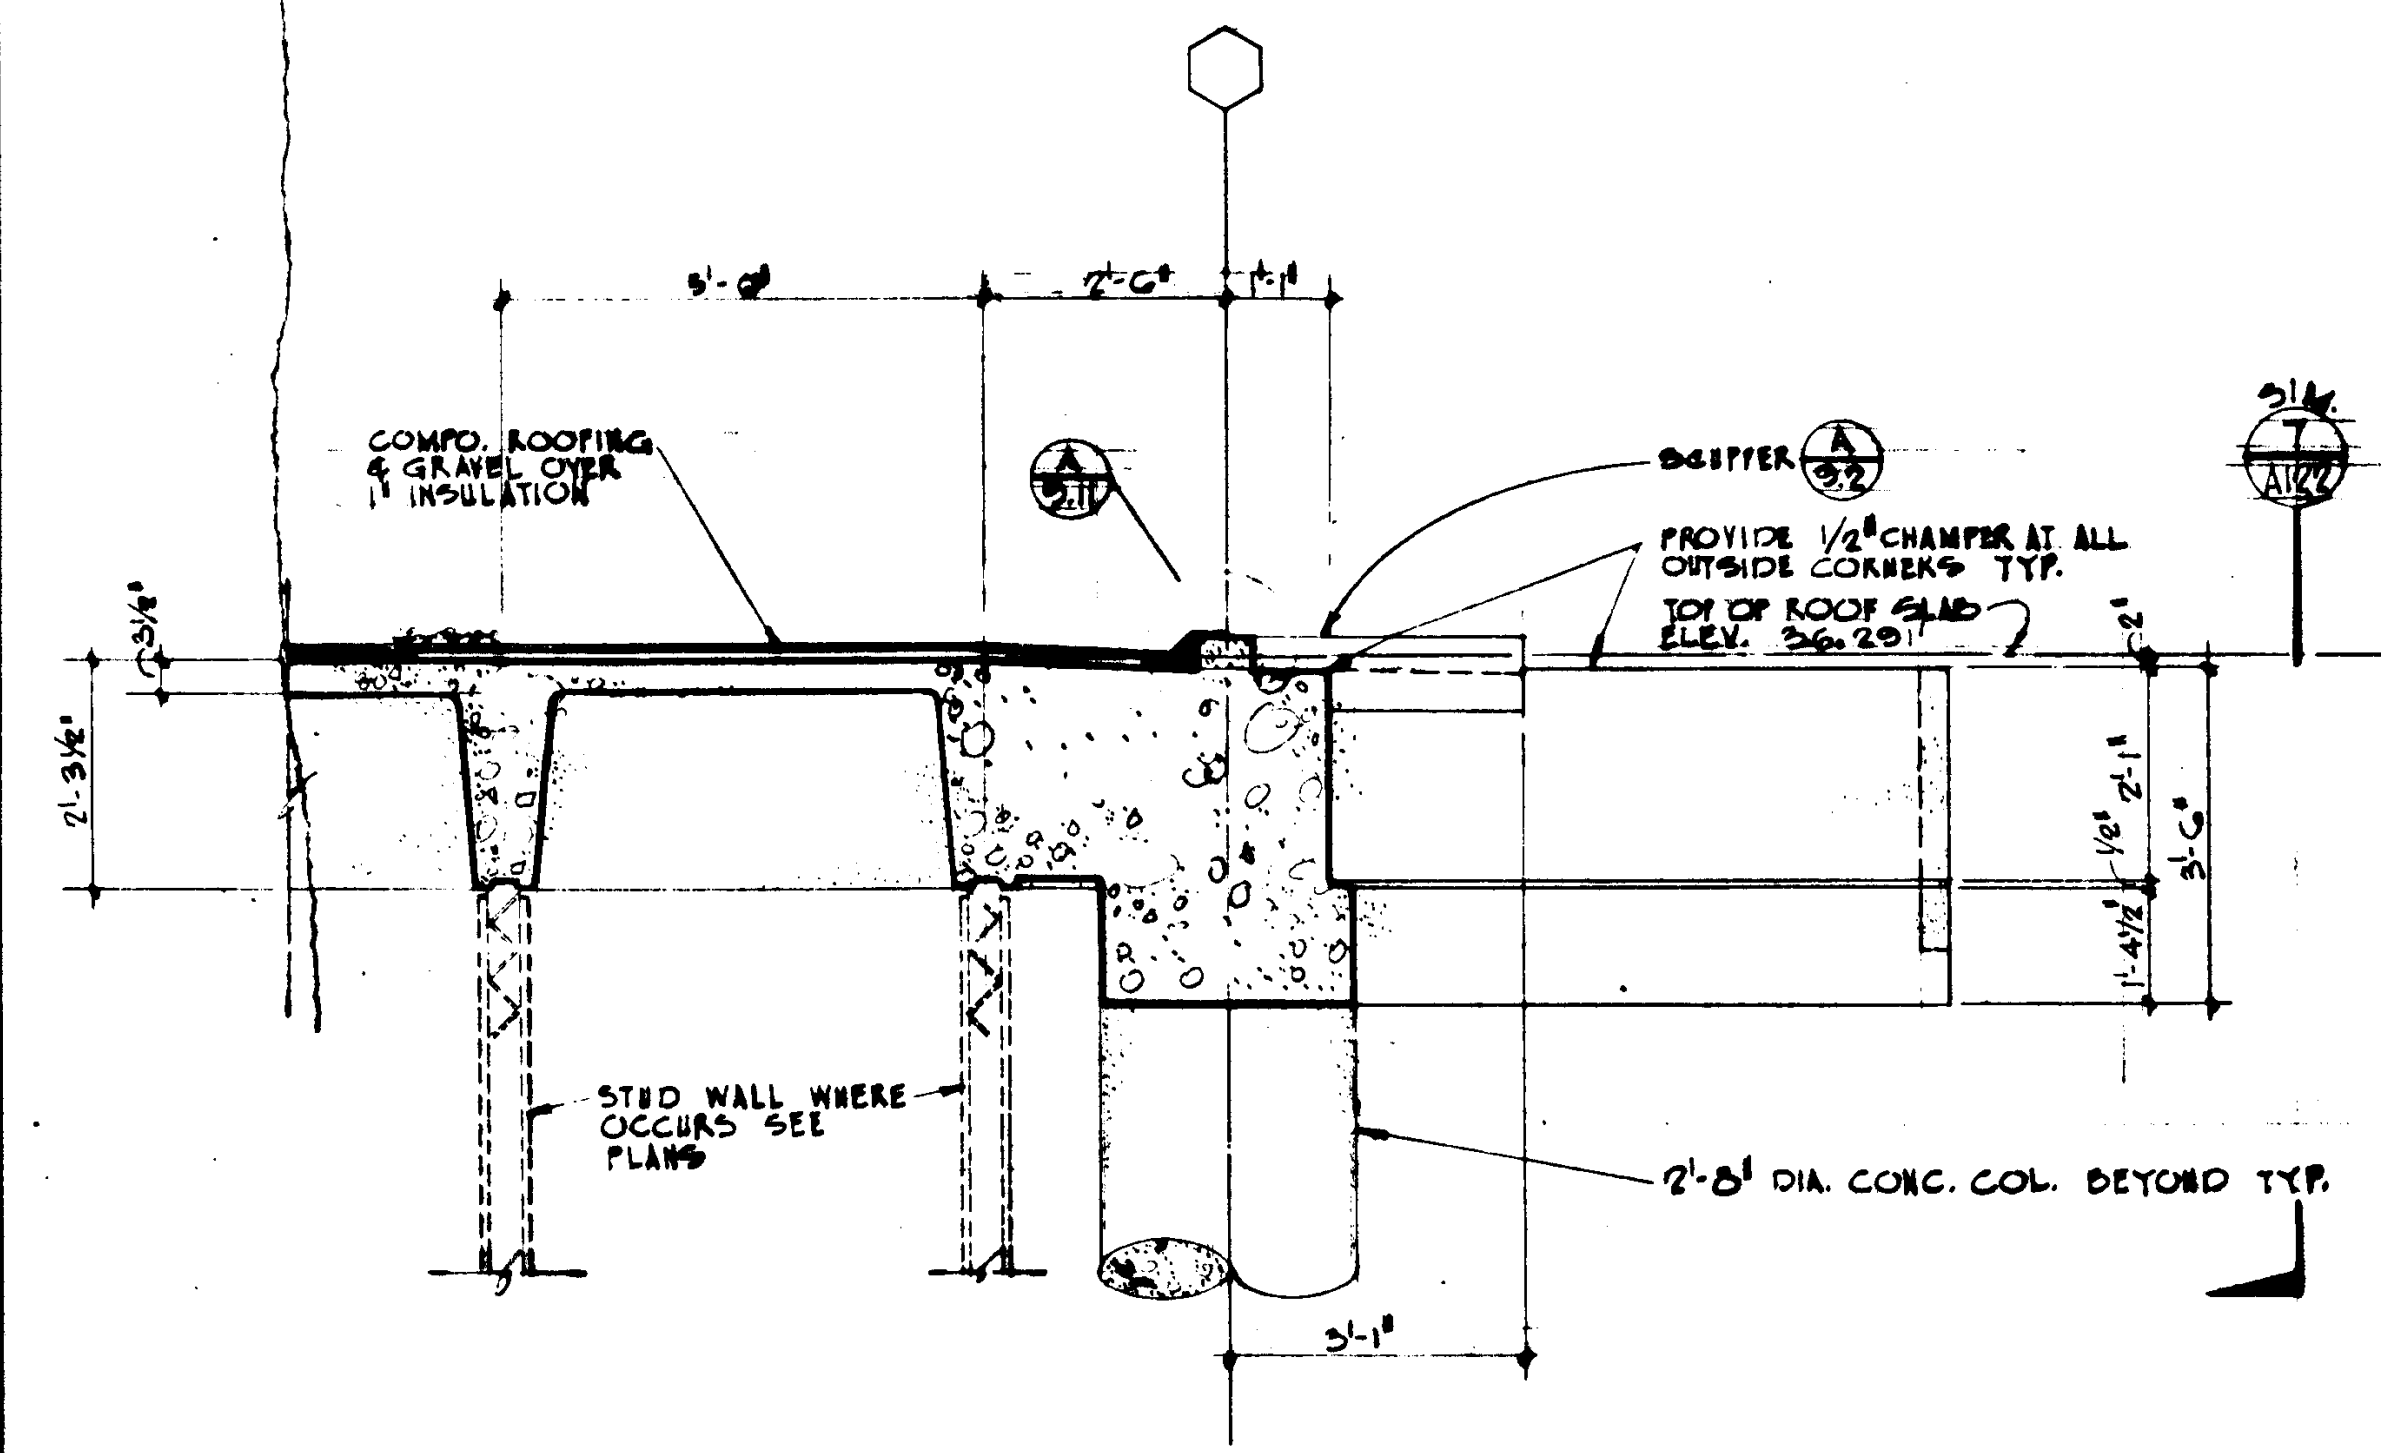

SECTION

SCALE: 1/2" = 1'-0"

DATE	DRAWN	REVISIONS







STRUCTURAL ENGINEERS BRANDOW & JOHNSTON J.A. MARTIN & ASSOCIATES	DESIGNED R.A.L.P.H. E. PHILLIPS, INC.	DRAWN BY R.A.L.P.H. E. PHILLIPS, INC.	CHECKED BY R.A.L.P.H. E. PHILLIPS, INC.	CIVIL ENGINEERS O. SHUURMAN & ASSOCIATES ROFFATT & NICOLAI
APPROVED STATE FIRE MARSHAL STATE OF CALIFORNIA DATE 11/2/1965				

ASSOCIATED ARCHITECTS:
WILLIAM L. PEREIRA & ASSOCIATES
A. QUINCY JONES-FREDERICK E. EMMONS & ASSOCIATES
BLURCK ELLERBROEK & ASSOCIATES

URBANUS SQUARE • MACARTHUR BOULEVARD AT FORD ROAD
TELEPHONE 714/675-2640 • CORONA DEL MAR, CALIFORNIA

TYPICAL	JOB NO. 1001
CONCRETE	DATE 15 JUN 1965
DETAILS	SHEET NO. A 12.3

GOLDEN WEST COLLEGE
HUNTINGTON BEACH, CALIFORNIA
ORANGE COAST JUNIOR COLLEGE DISTRICT

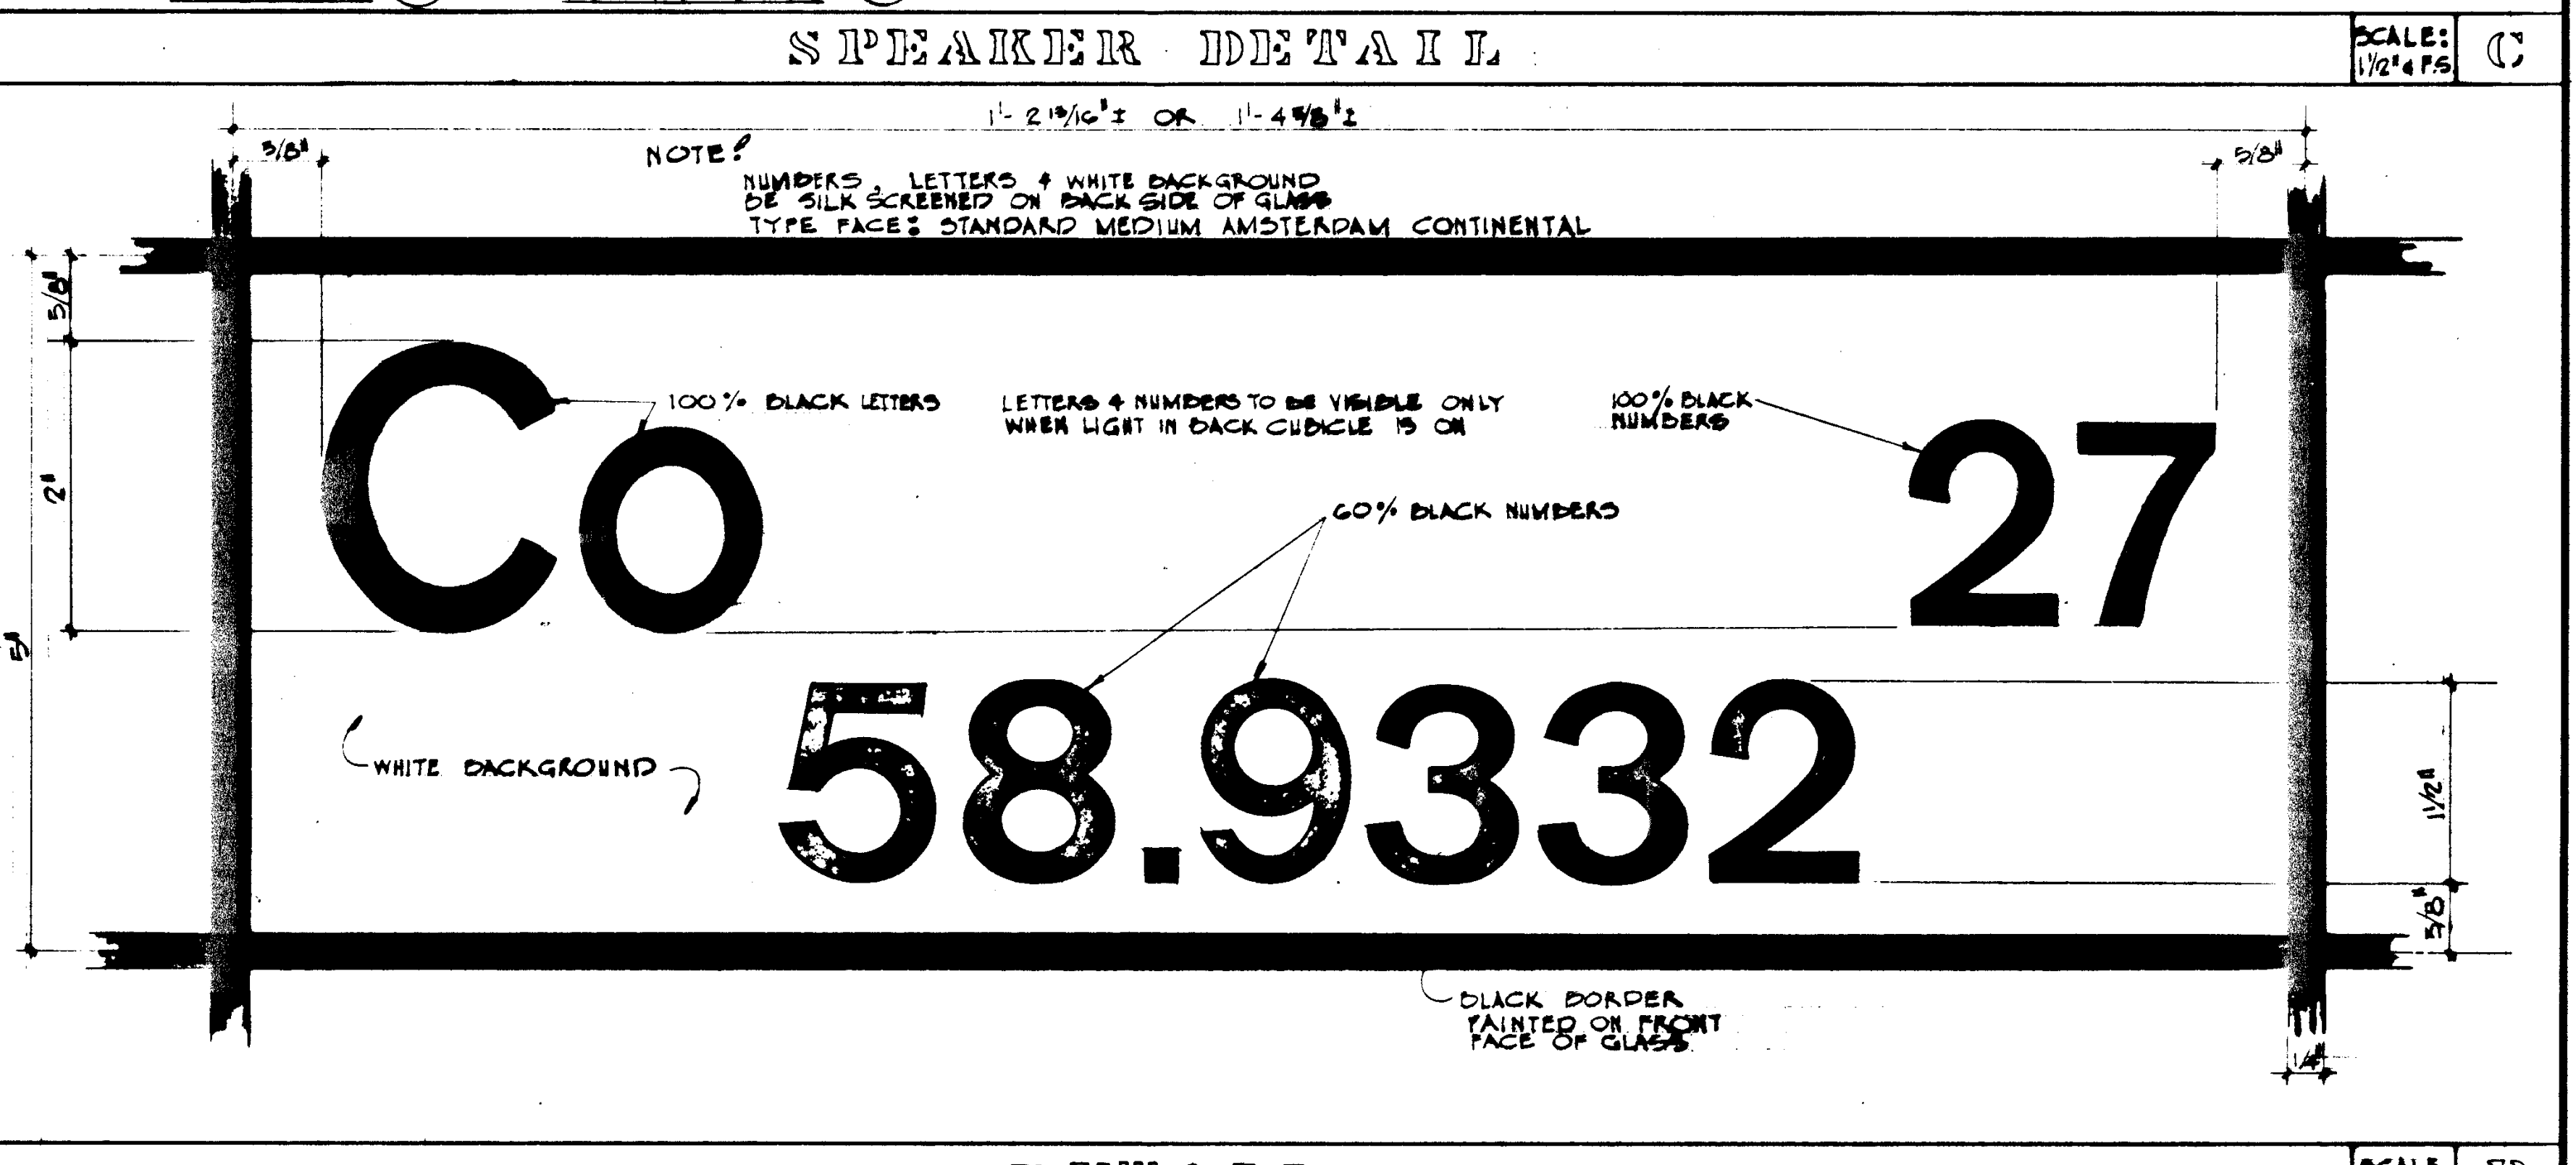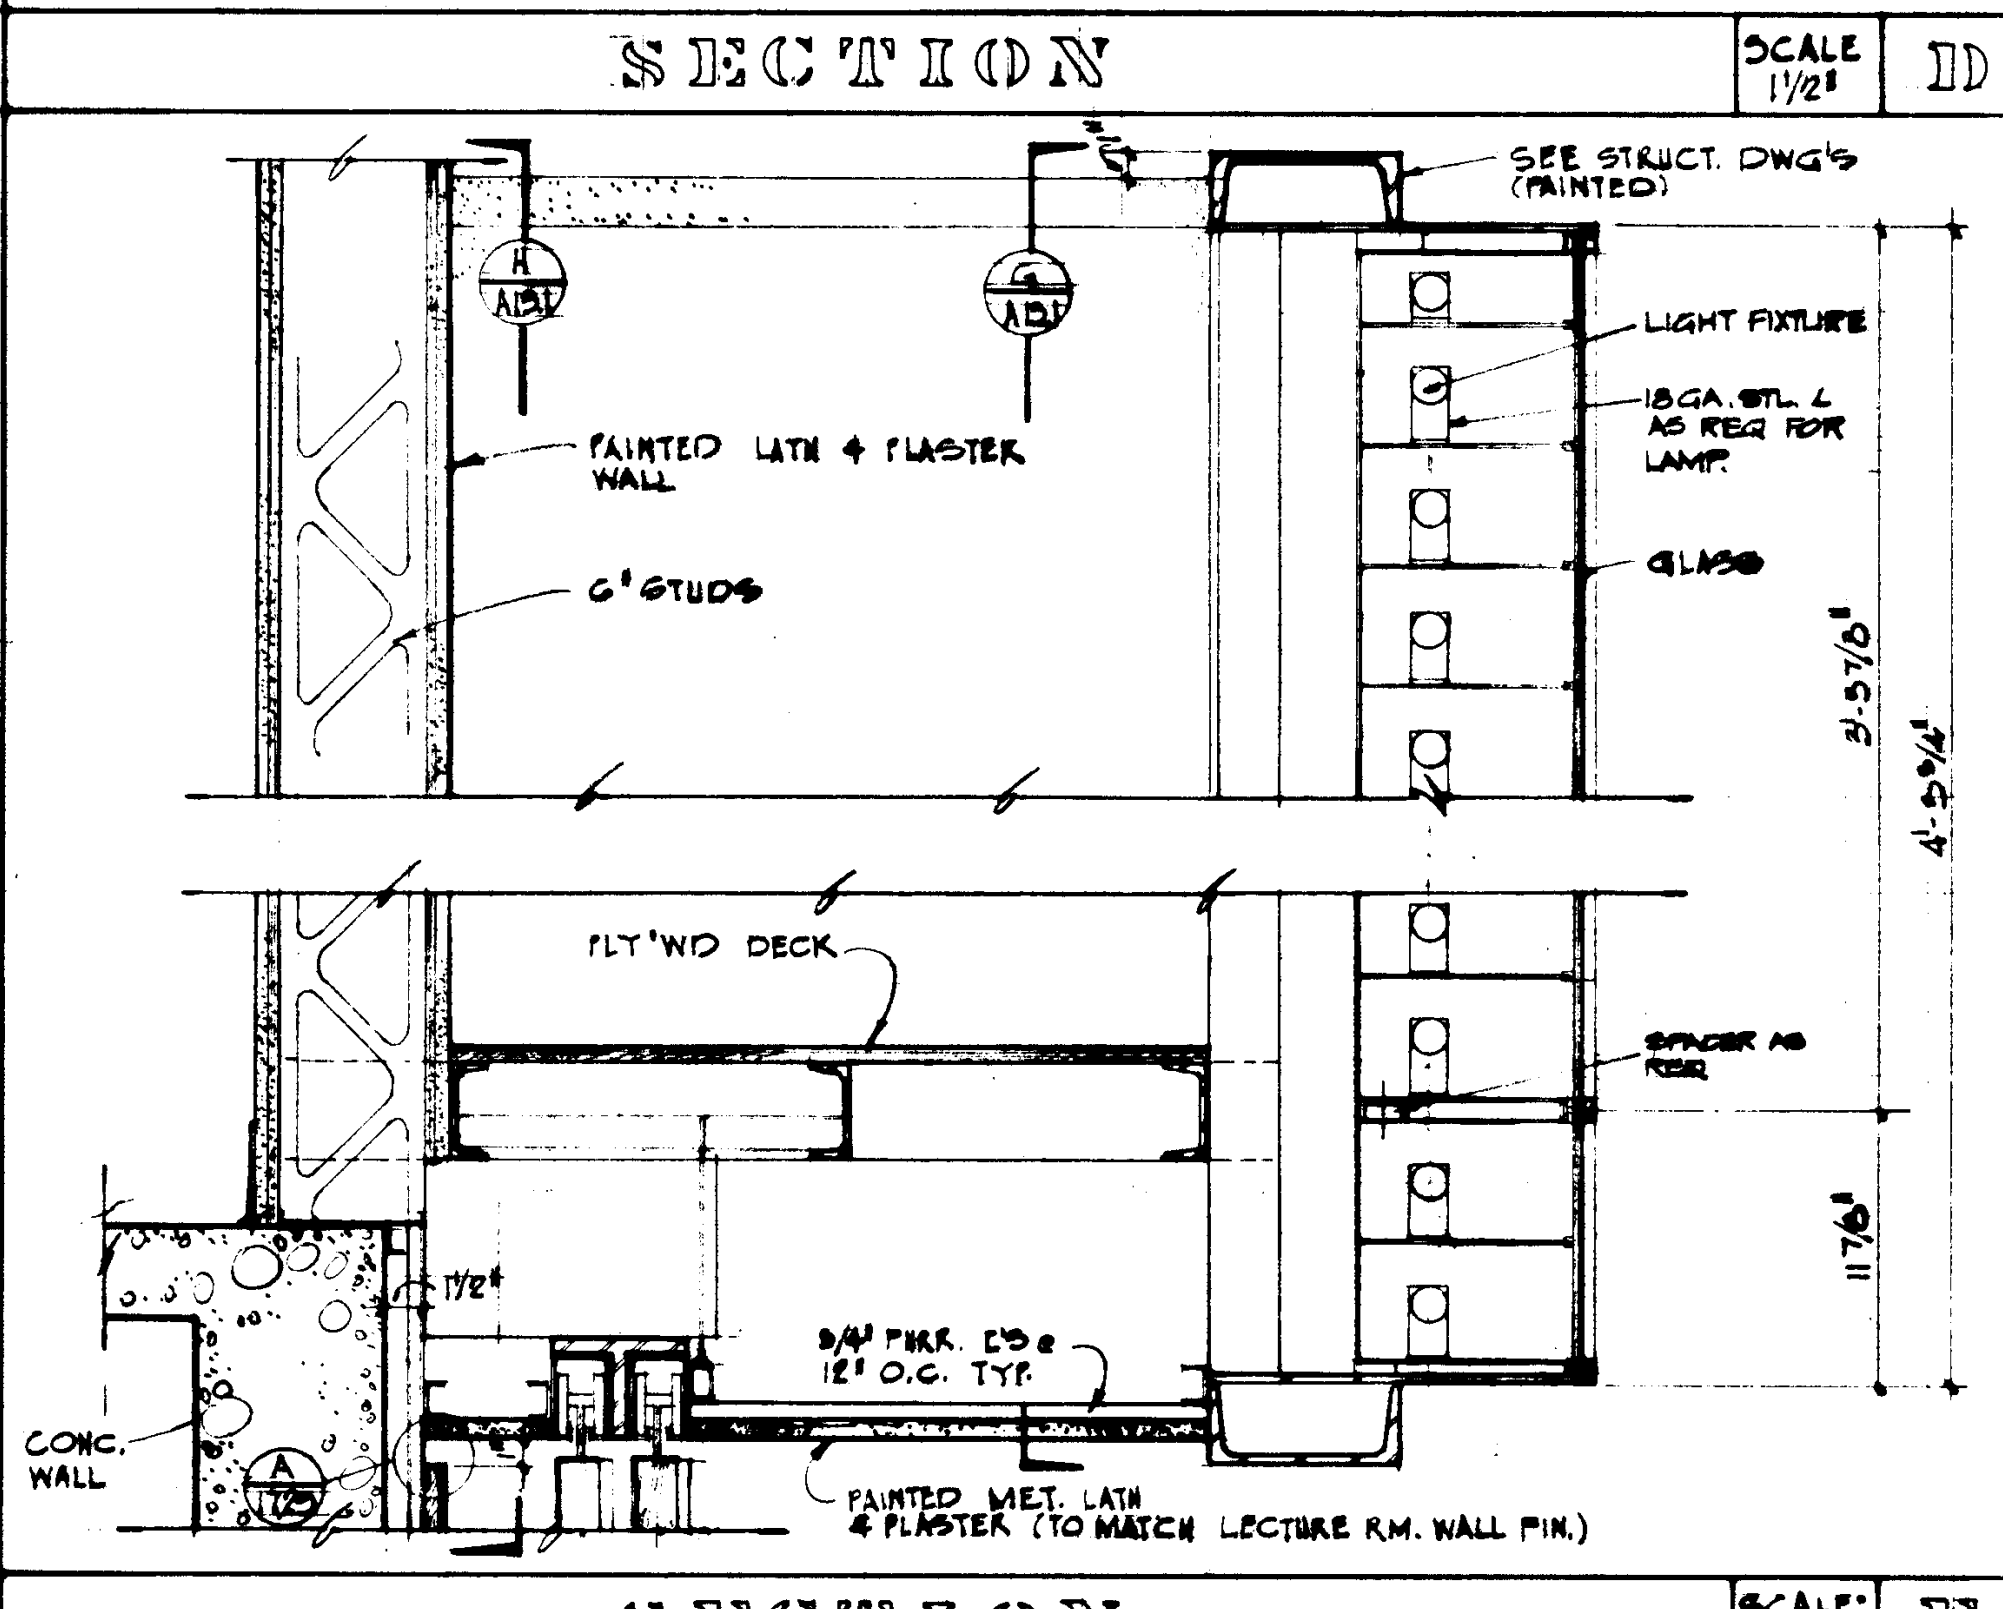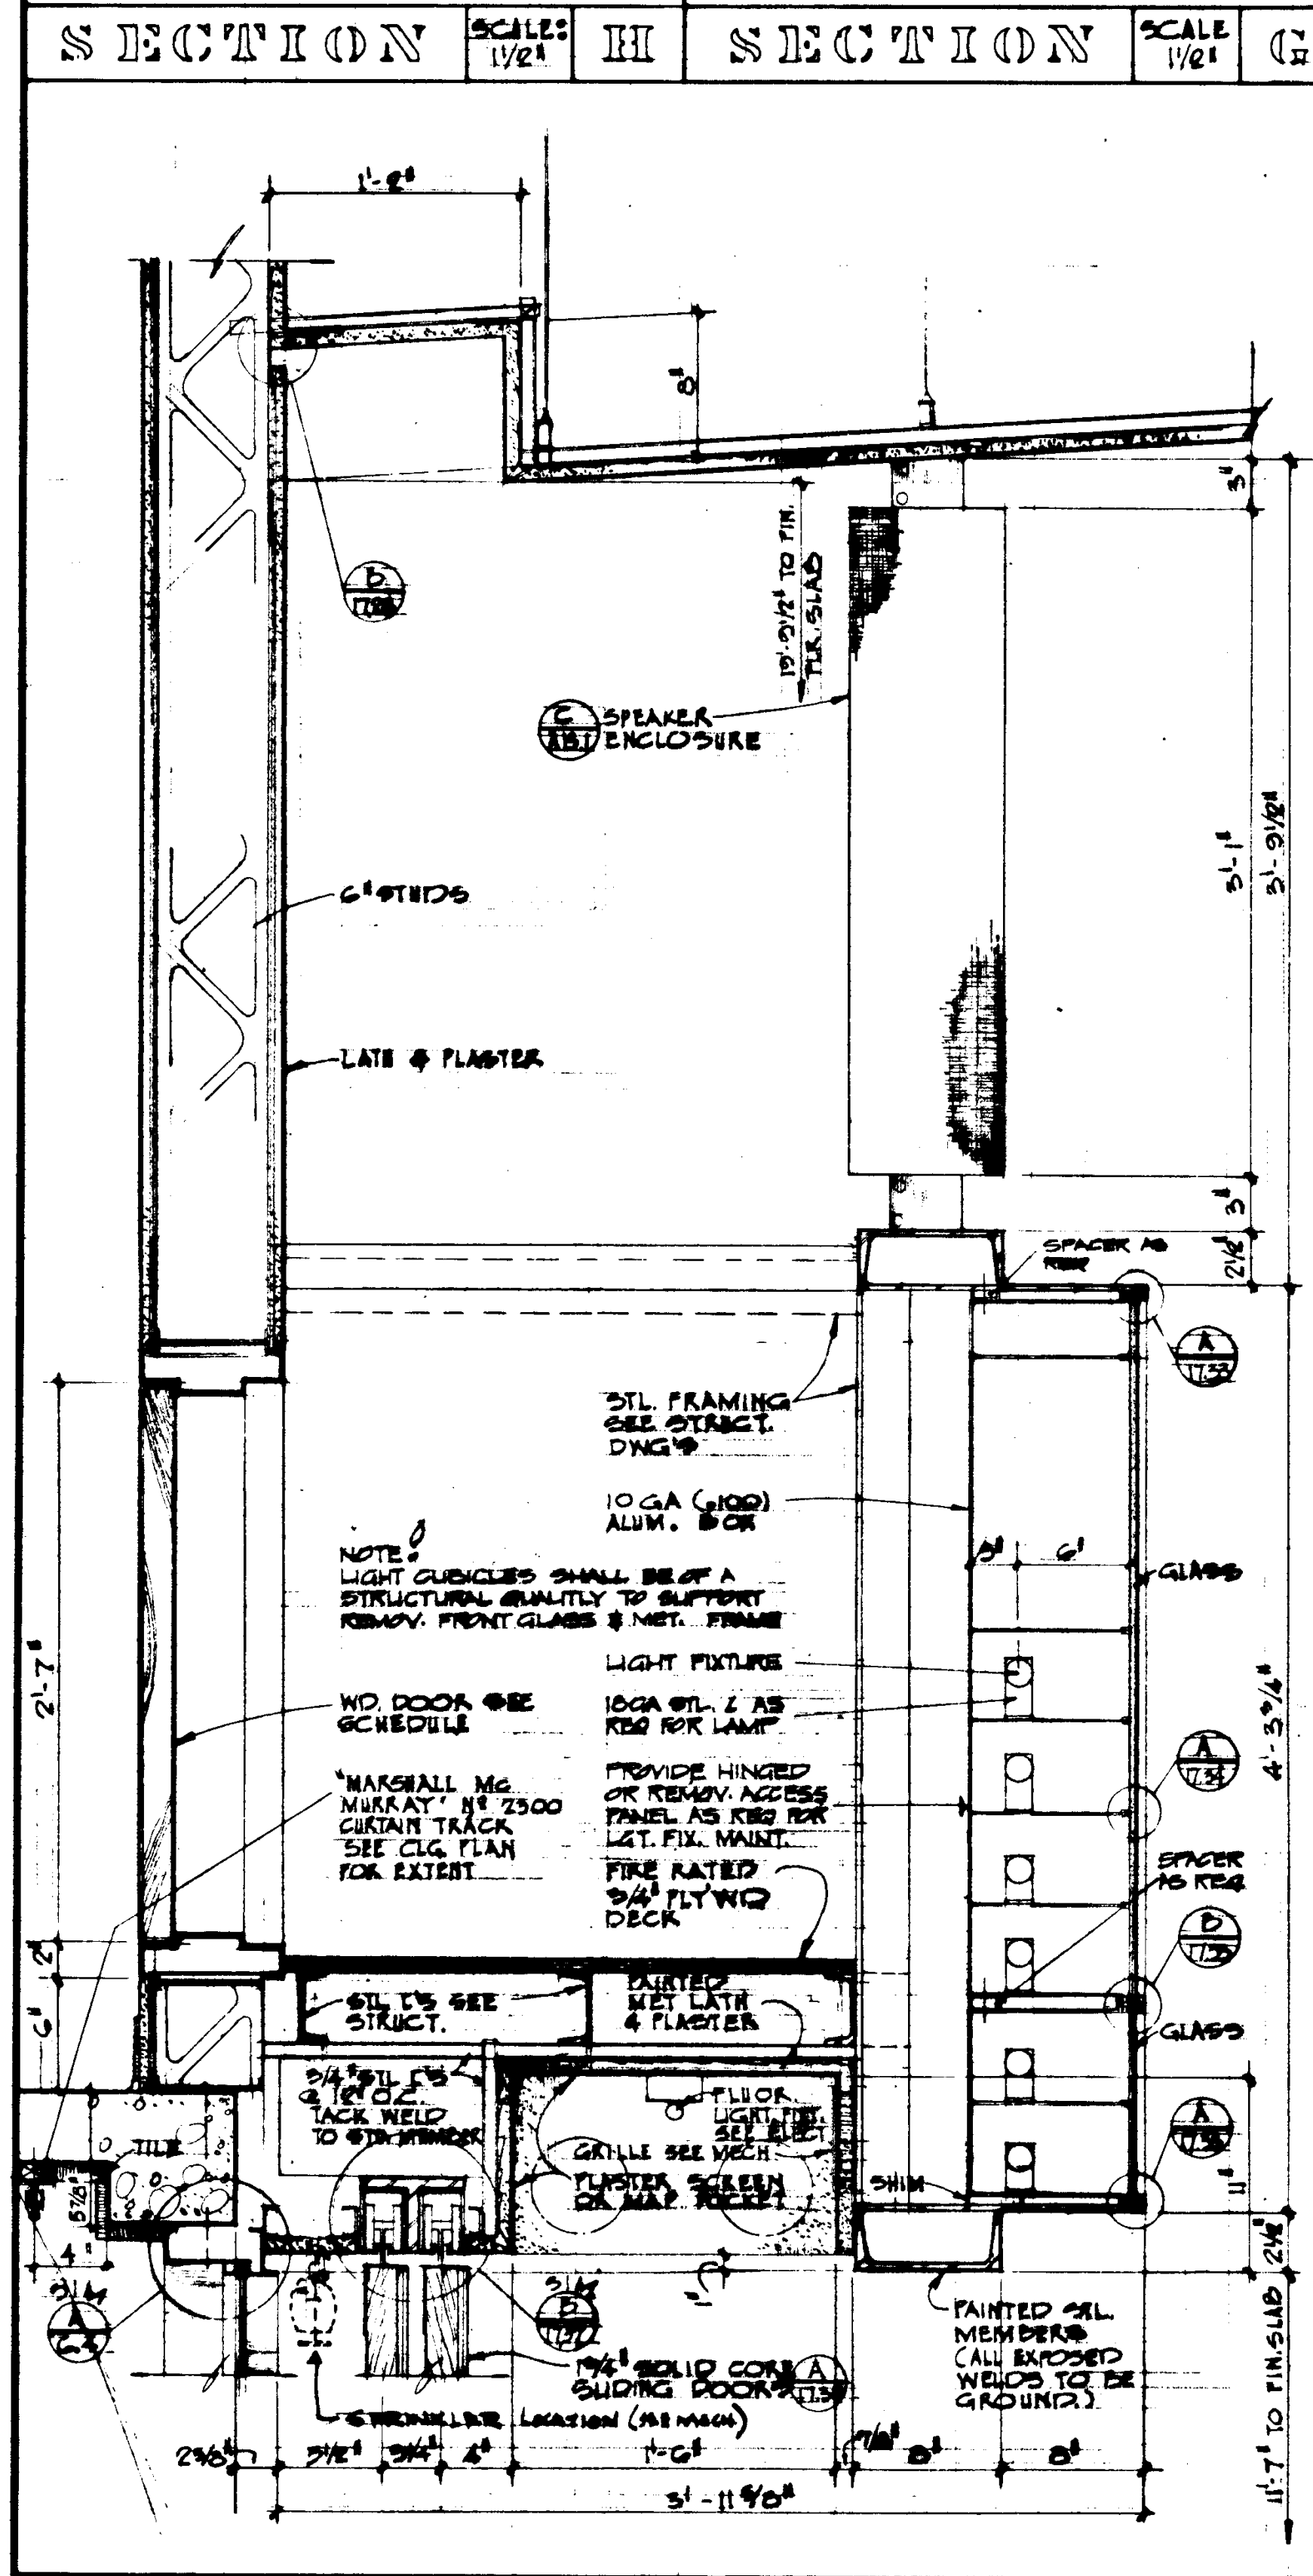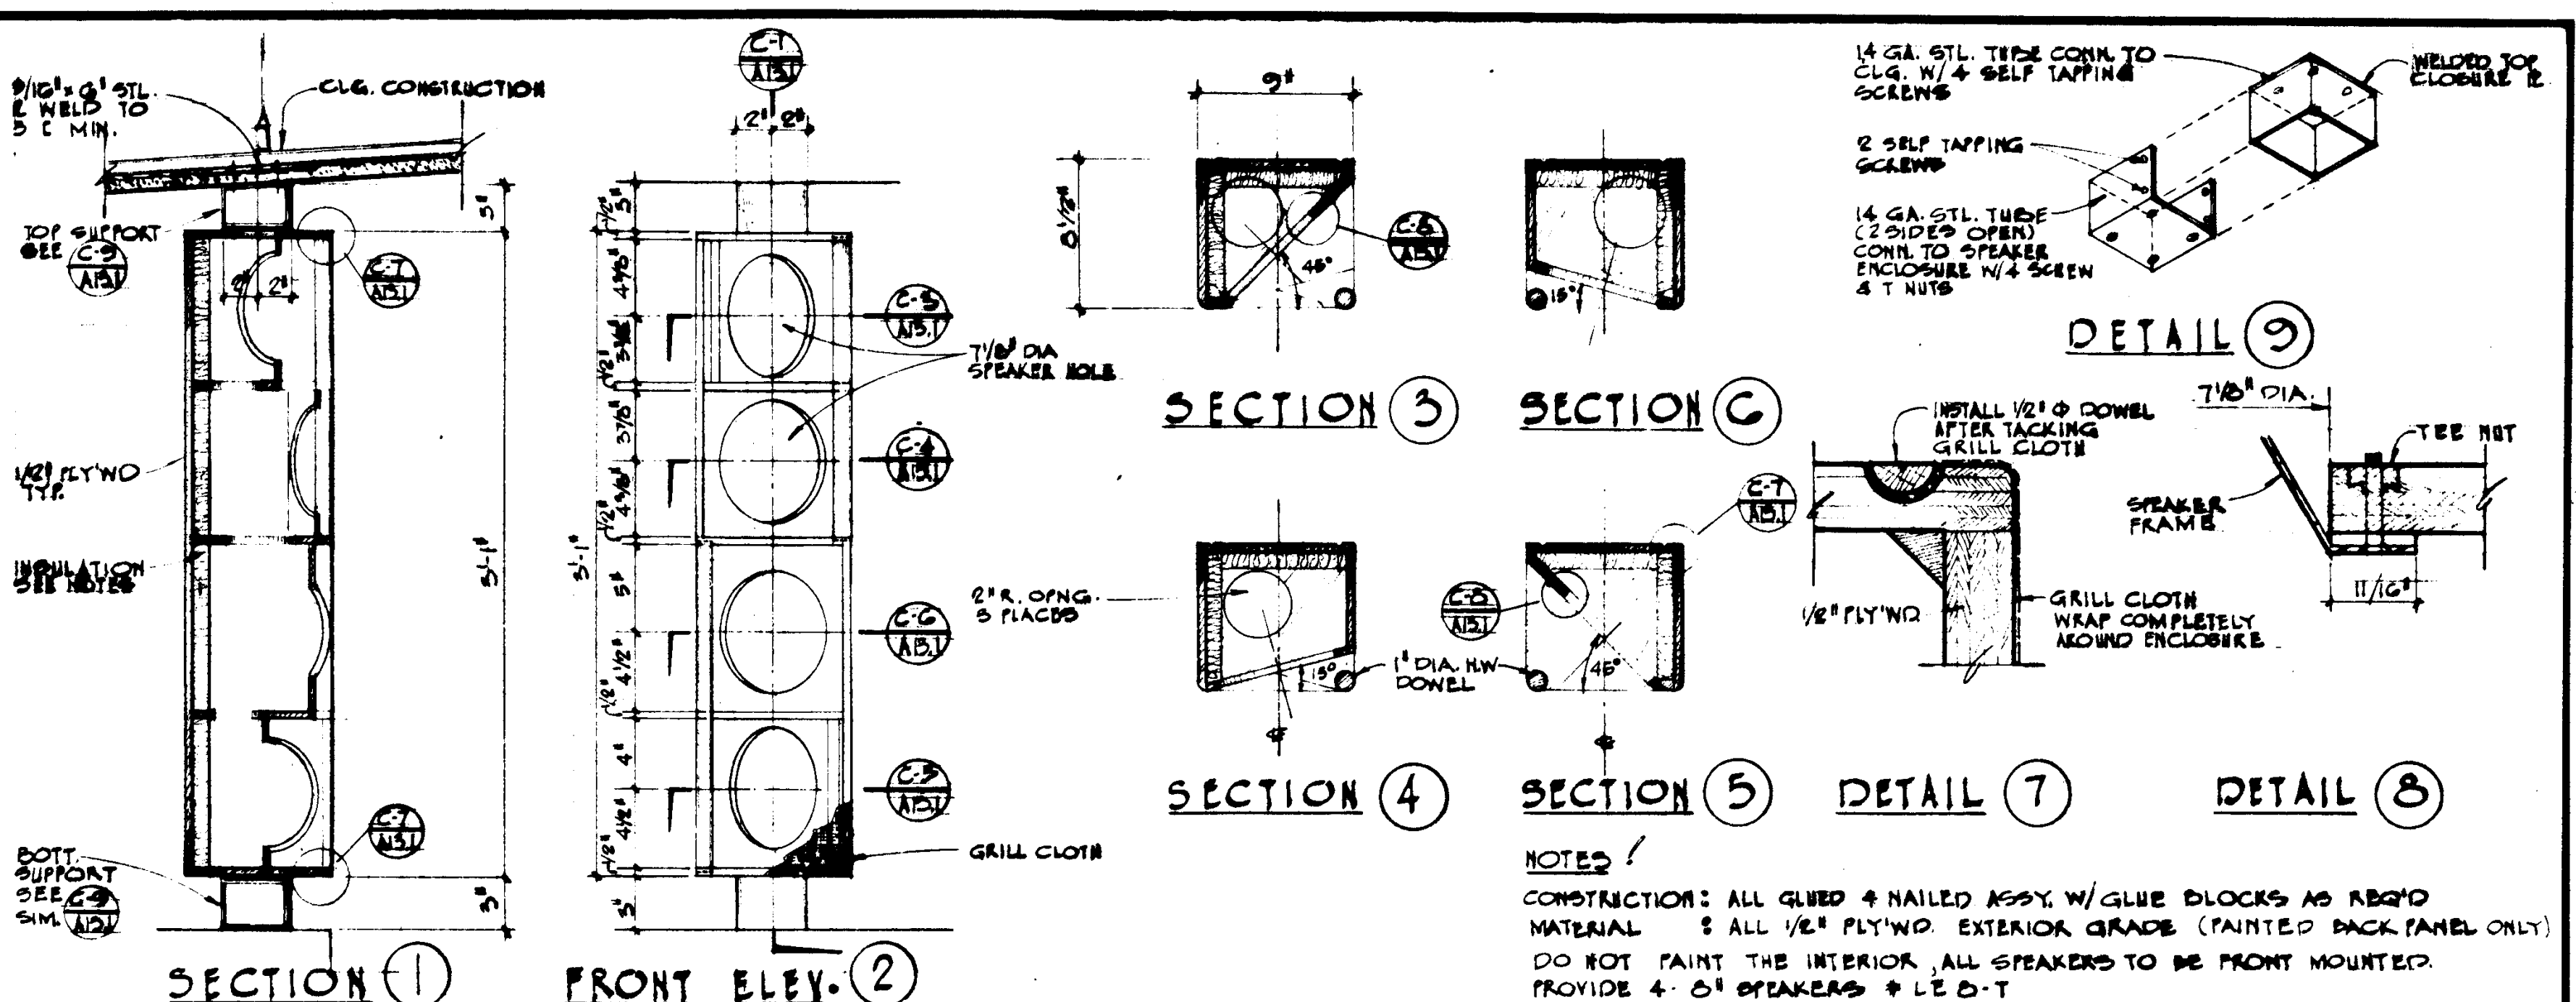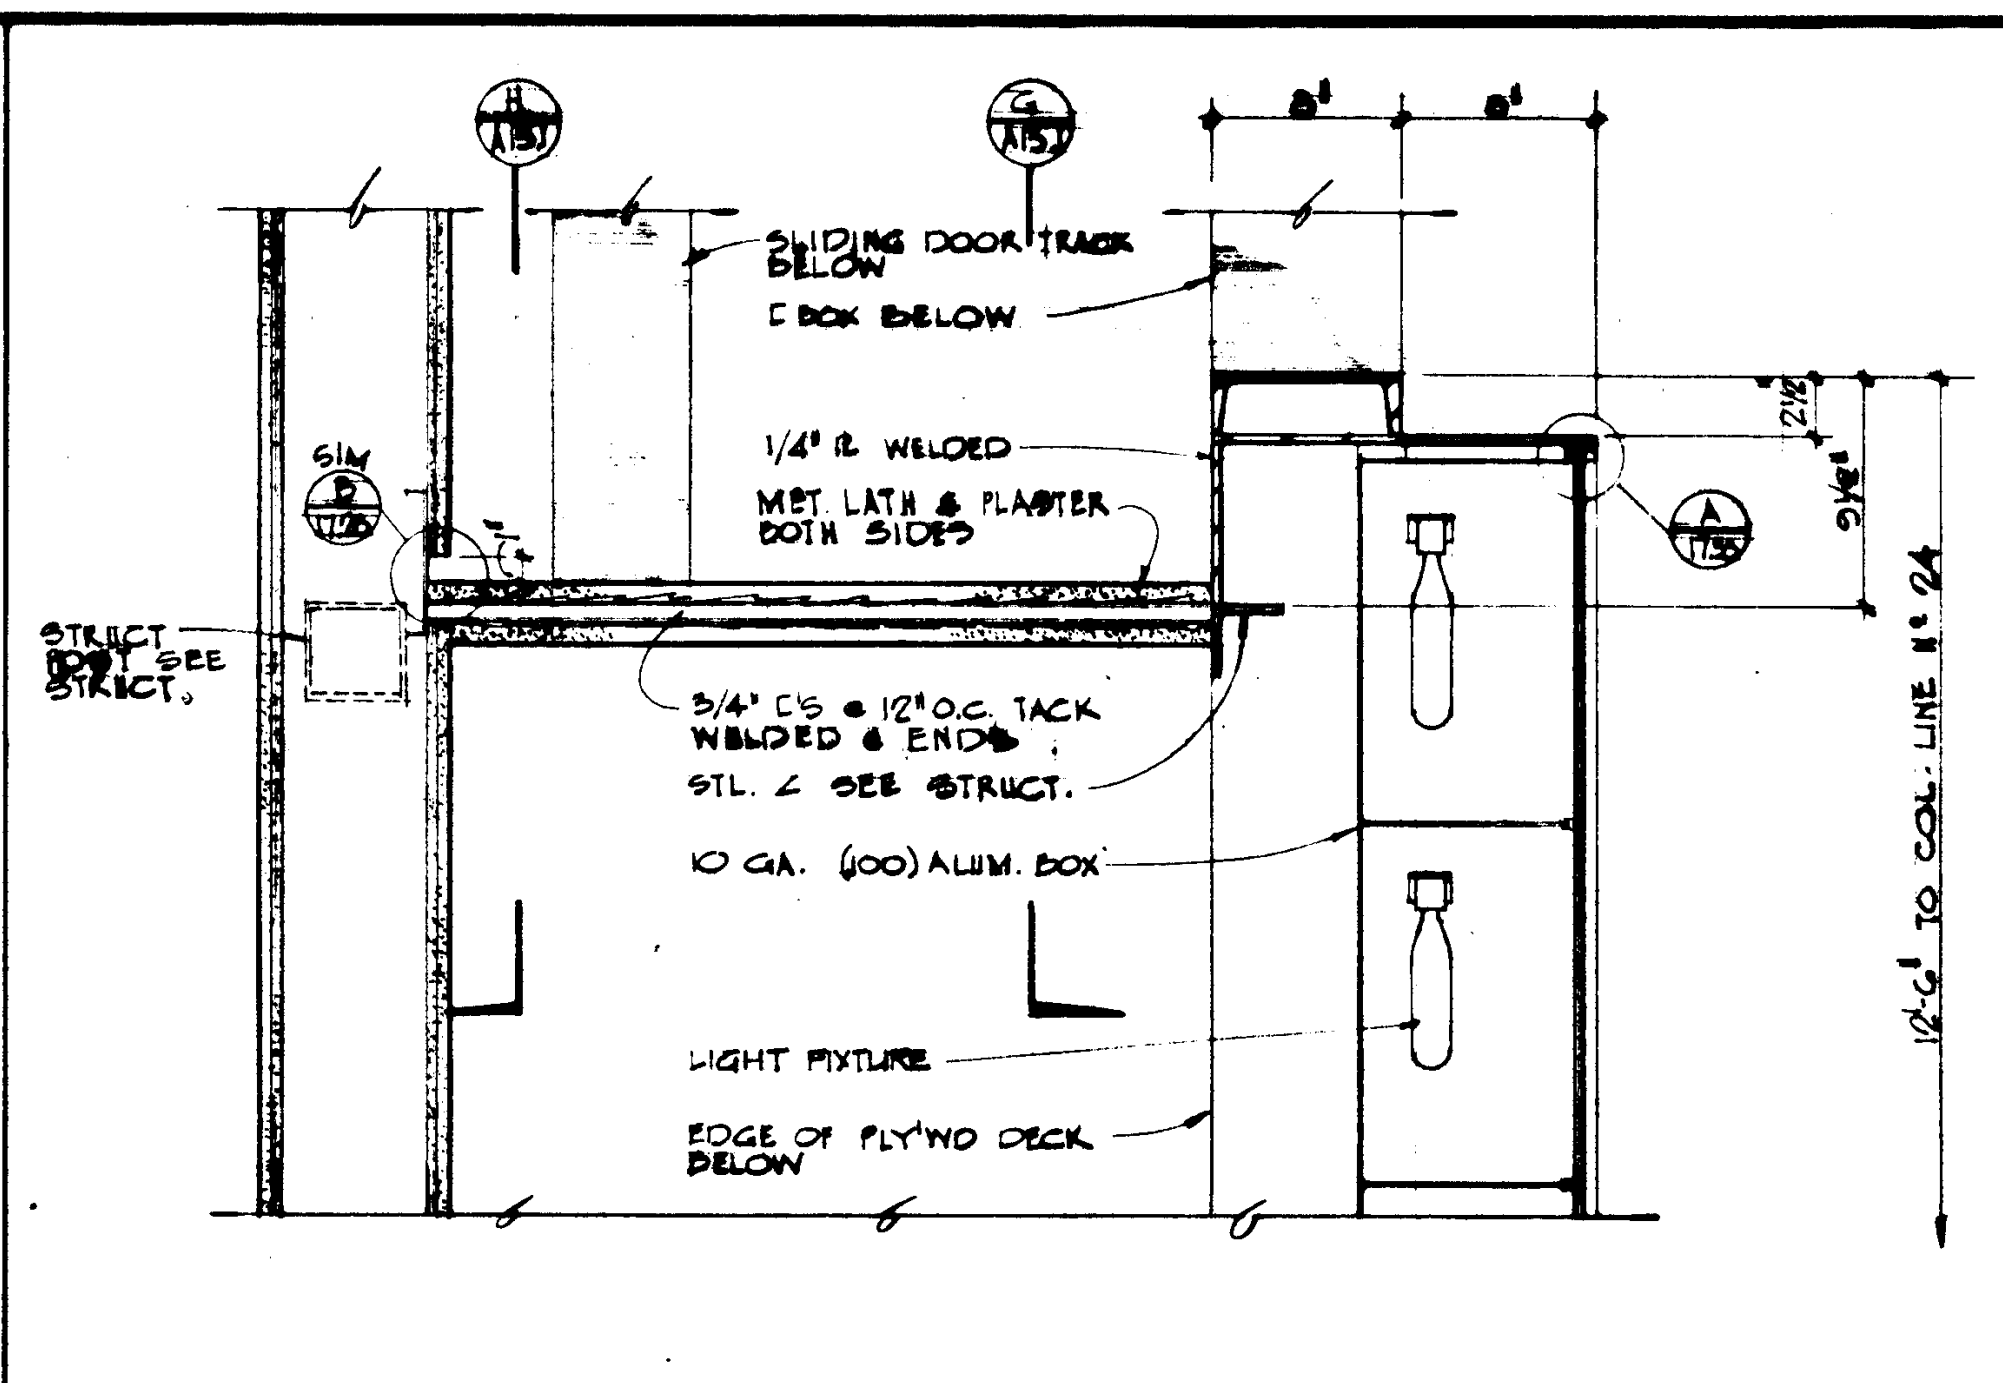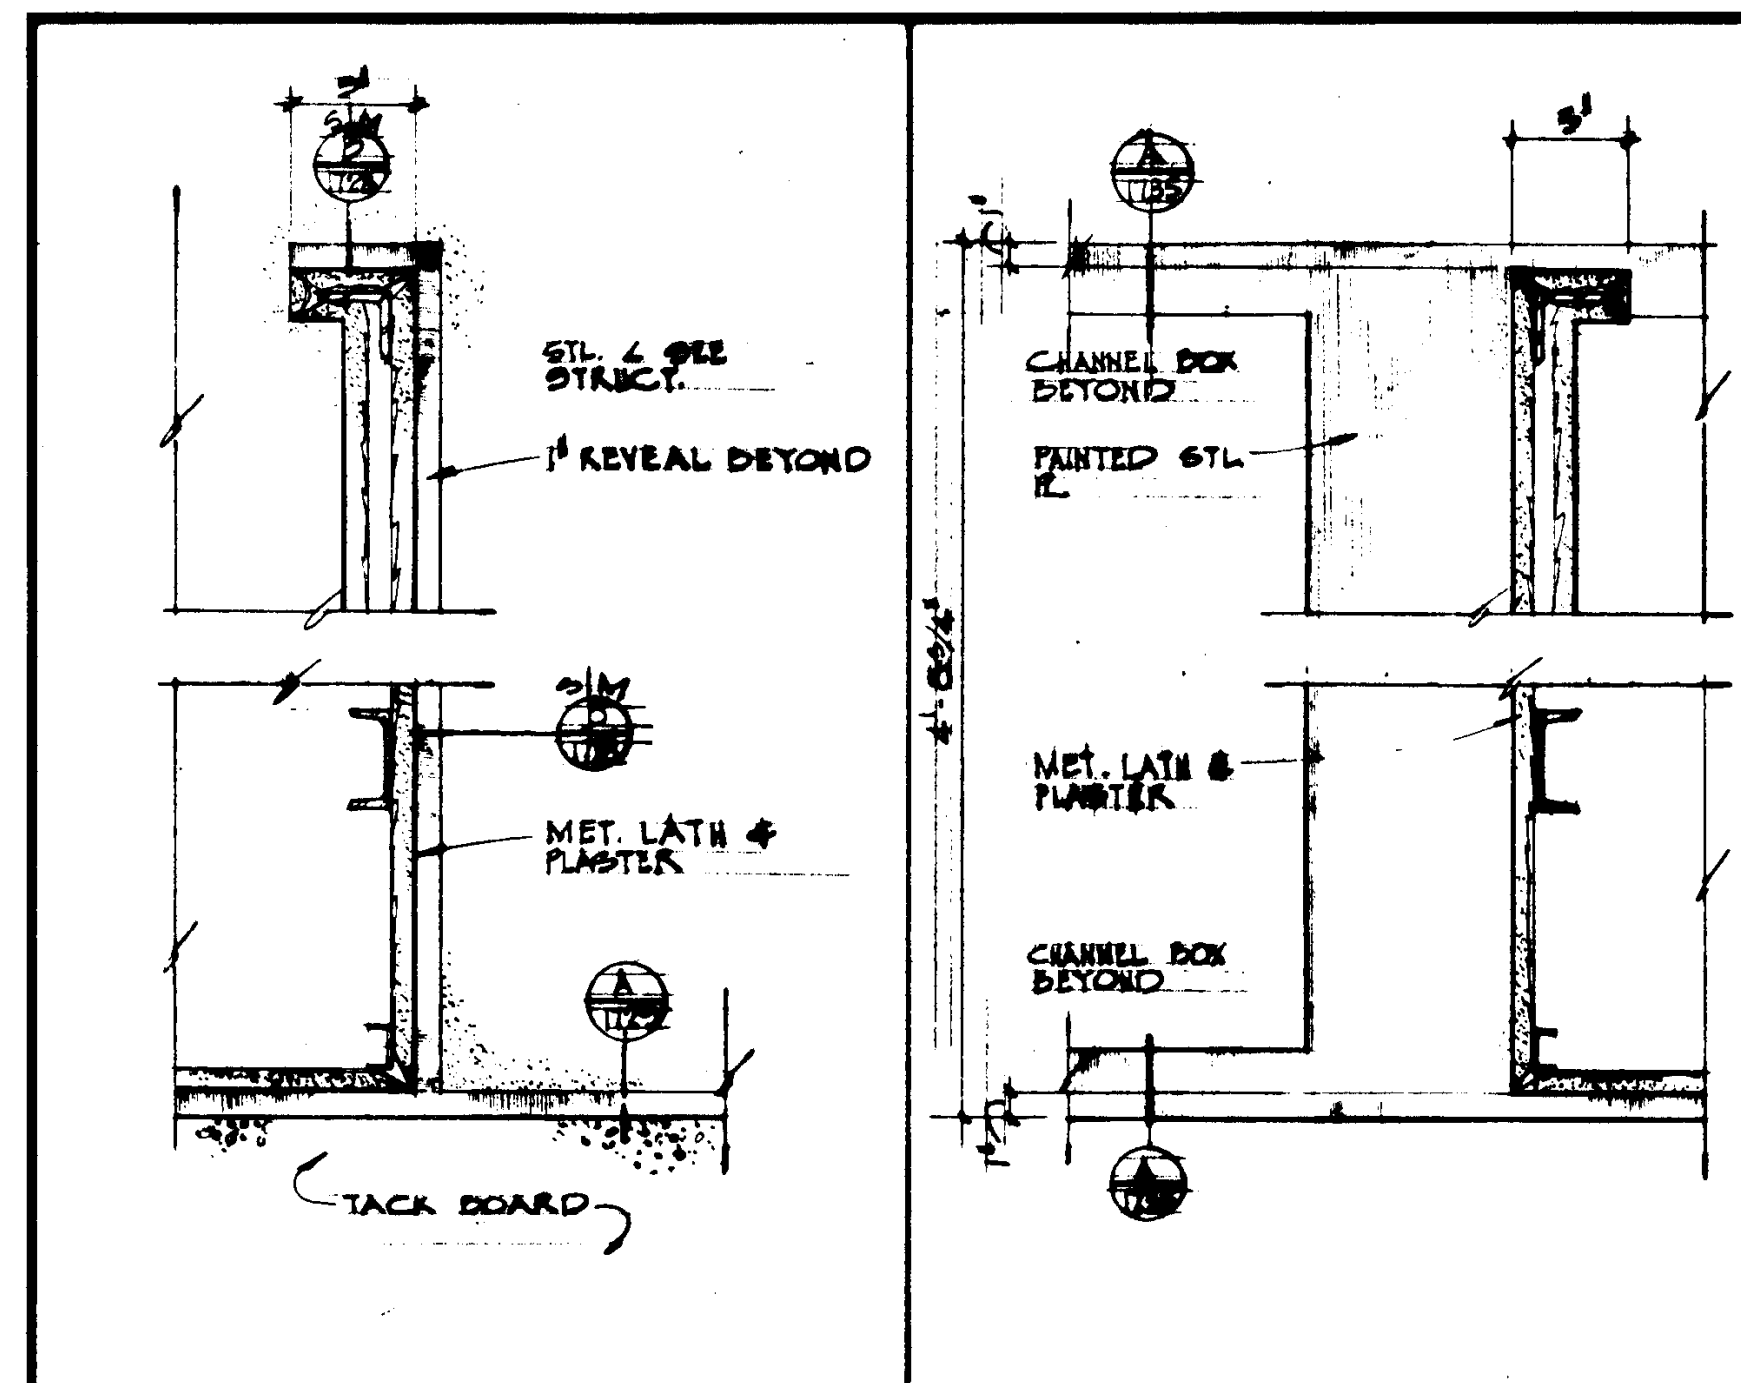

SECTION I

SCALE: 1/2" = 1'-0"

NO.	REVISIONS
1	AS SHOWN

SECTION

SCALE: 1/2" = 1'-0"

STRUCTURAL ENGINEERS BRANDOW & JOHNSON J.A. MARTIN & ASSOCIATES	DESIGNED BY RALPH E. PHILLIPS, INC.	CHECKED BY RALPH E. PHILLIPS, INC.	APPROVED STATE FIRE MARSHAL STATE OF CALIFORNIA DATE: JUN 21 1965
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PERIODIC CHART FRONT ELEV.

SCALE: 1/2" = 1'-0"

UNIT 2

PERIODIC CHART & SPEAKER DETAILS

100-4


18 JUN 1965

A 131


GOLDEN WEST COLLEGE
HUNTINGTON BEACH, CALIFORNIA
ORANGE COAST JUNIOR COLLEGE DISTRICT

WILLIAM L. PERRIRA & ASSOCIATES
A QUINCY JONES-FREDERICK & EMMONS & ASSOCIATES
BLUROCK ELLERBROCK & ASSOCIATES

URBANUS SQUARE • MACARTHUR BOULEVARD AT FORD ROAD
TELEPHONE 714/675-2640 • CORONA DEL MAR, CALIFORNIA

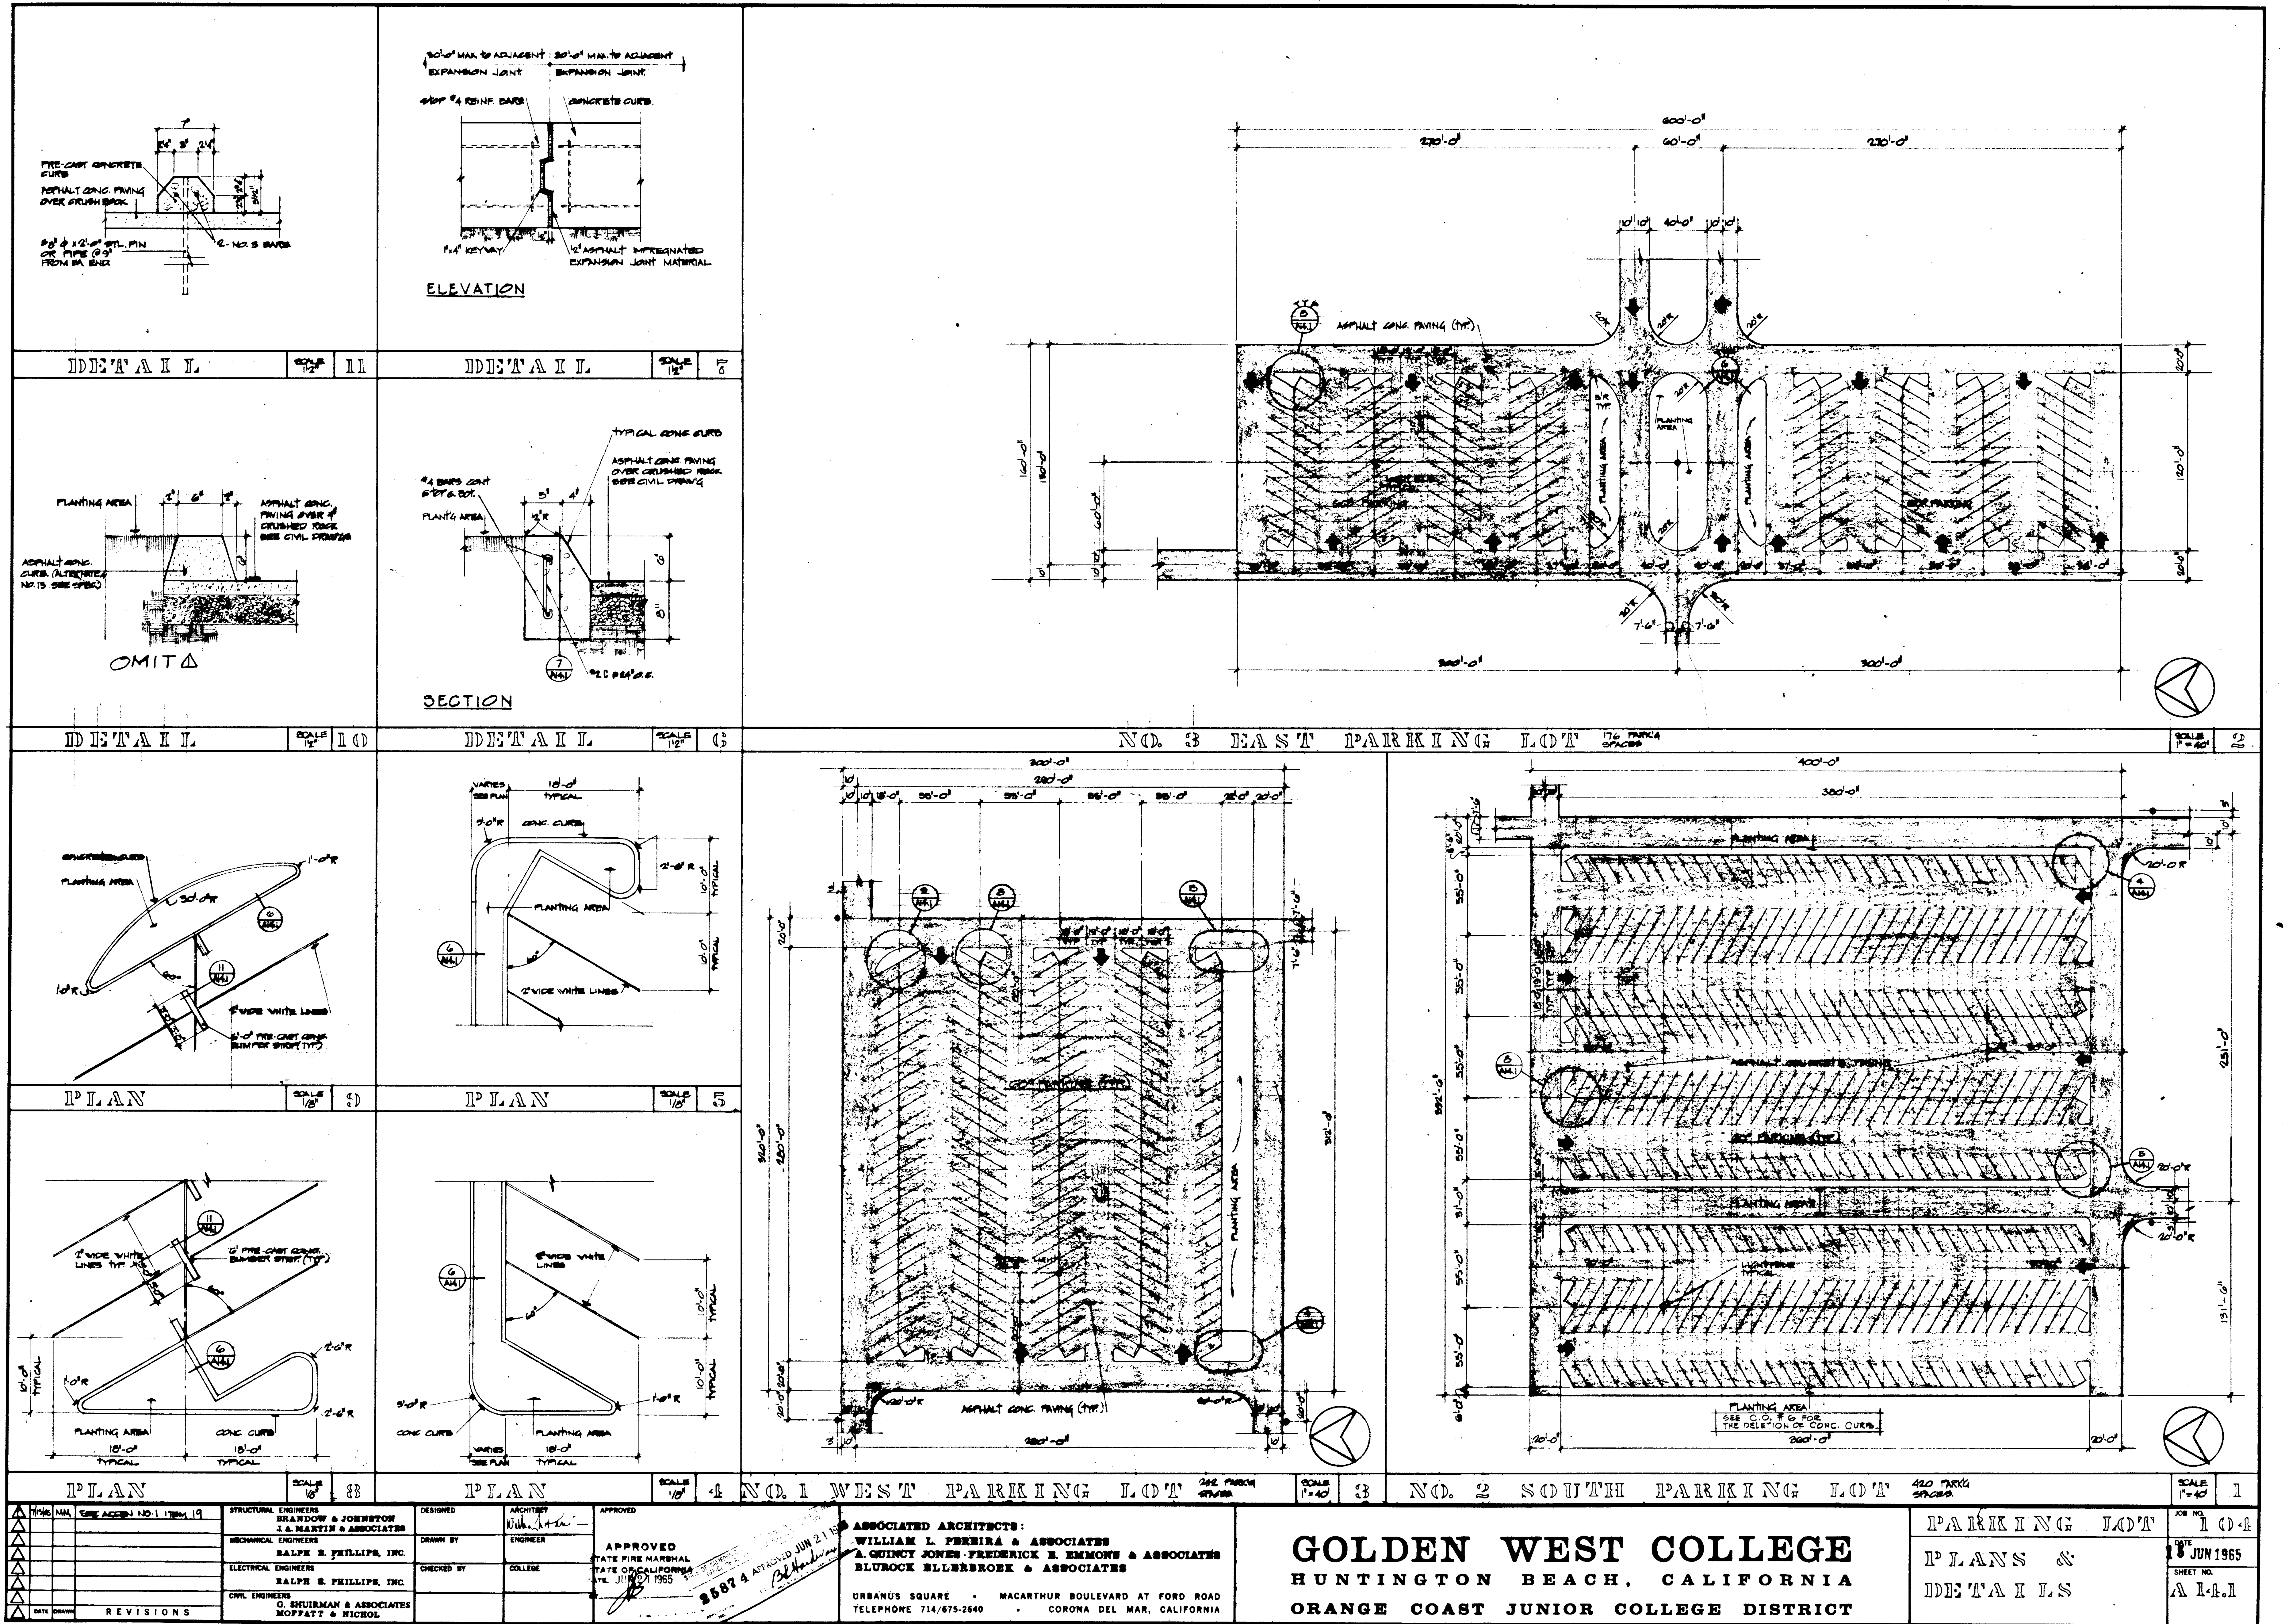


REVISIONS		STRUCTURAL ENGINEERS BRANDOW & JOHNSTON J. A. MARTIN & ASSOCIATES		DESIGNED ARCHITECT WILLIAM L. PEREIRA & ASSOCIATES		APPROVED STATE FIRE MARSHAL STATE OF CALIFORNIA JUL 21 1965		ASSOCIATED ARCHITECTS: WILLIAM L. PEREIRA & ASSOCIATES A. QUINCY JONES, FREDERICK E. EMMONS & ASSOCIATES BLUROCK ELLERBROCK & ASSOCIATES		URBANUS SQUARE • MACARTHUR BOULEVARD AT FORD ROAD TELEPHONE 714/675-2640 • CORONA DEL MAR, CALIFORNIA		GOLDEN WEST COLLEGE HUNTINGTON BEACH, CALIFORNIA ORANGE COAST JUNIOR COLLEGE DISTRICT		PARKING LOT PLANS & DETAILS		JOB NO. 104 DATE JUN 1965 SHEET NO. A14.1	
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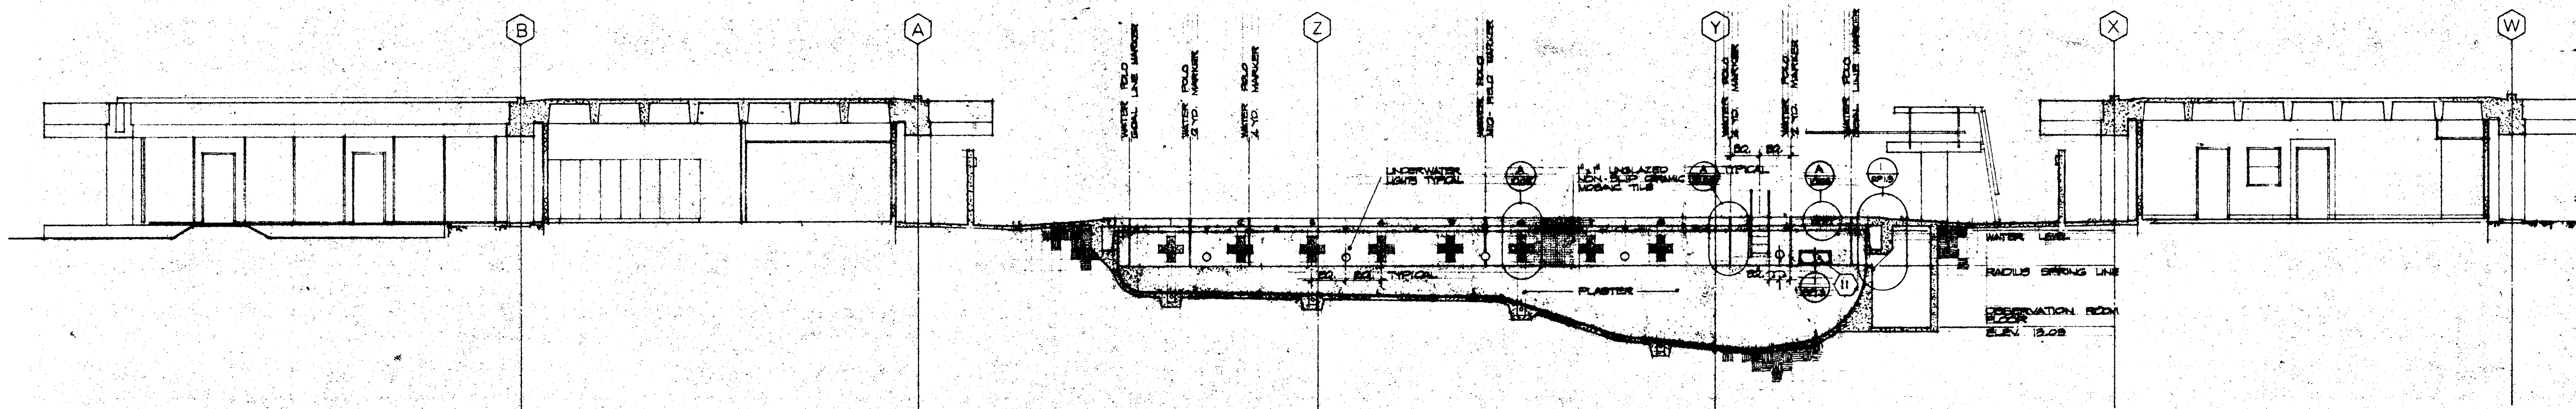
FLOOR PLAN
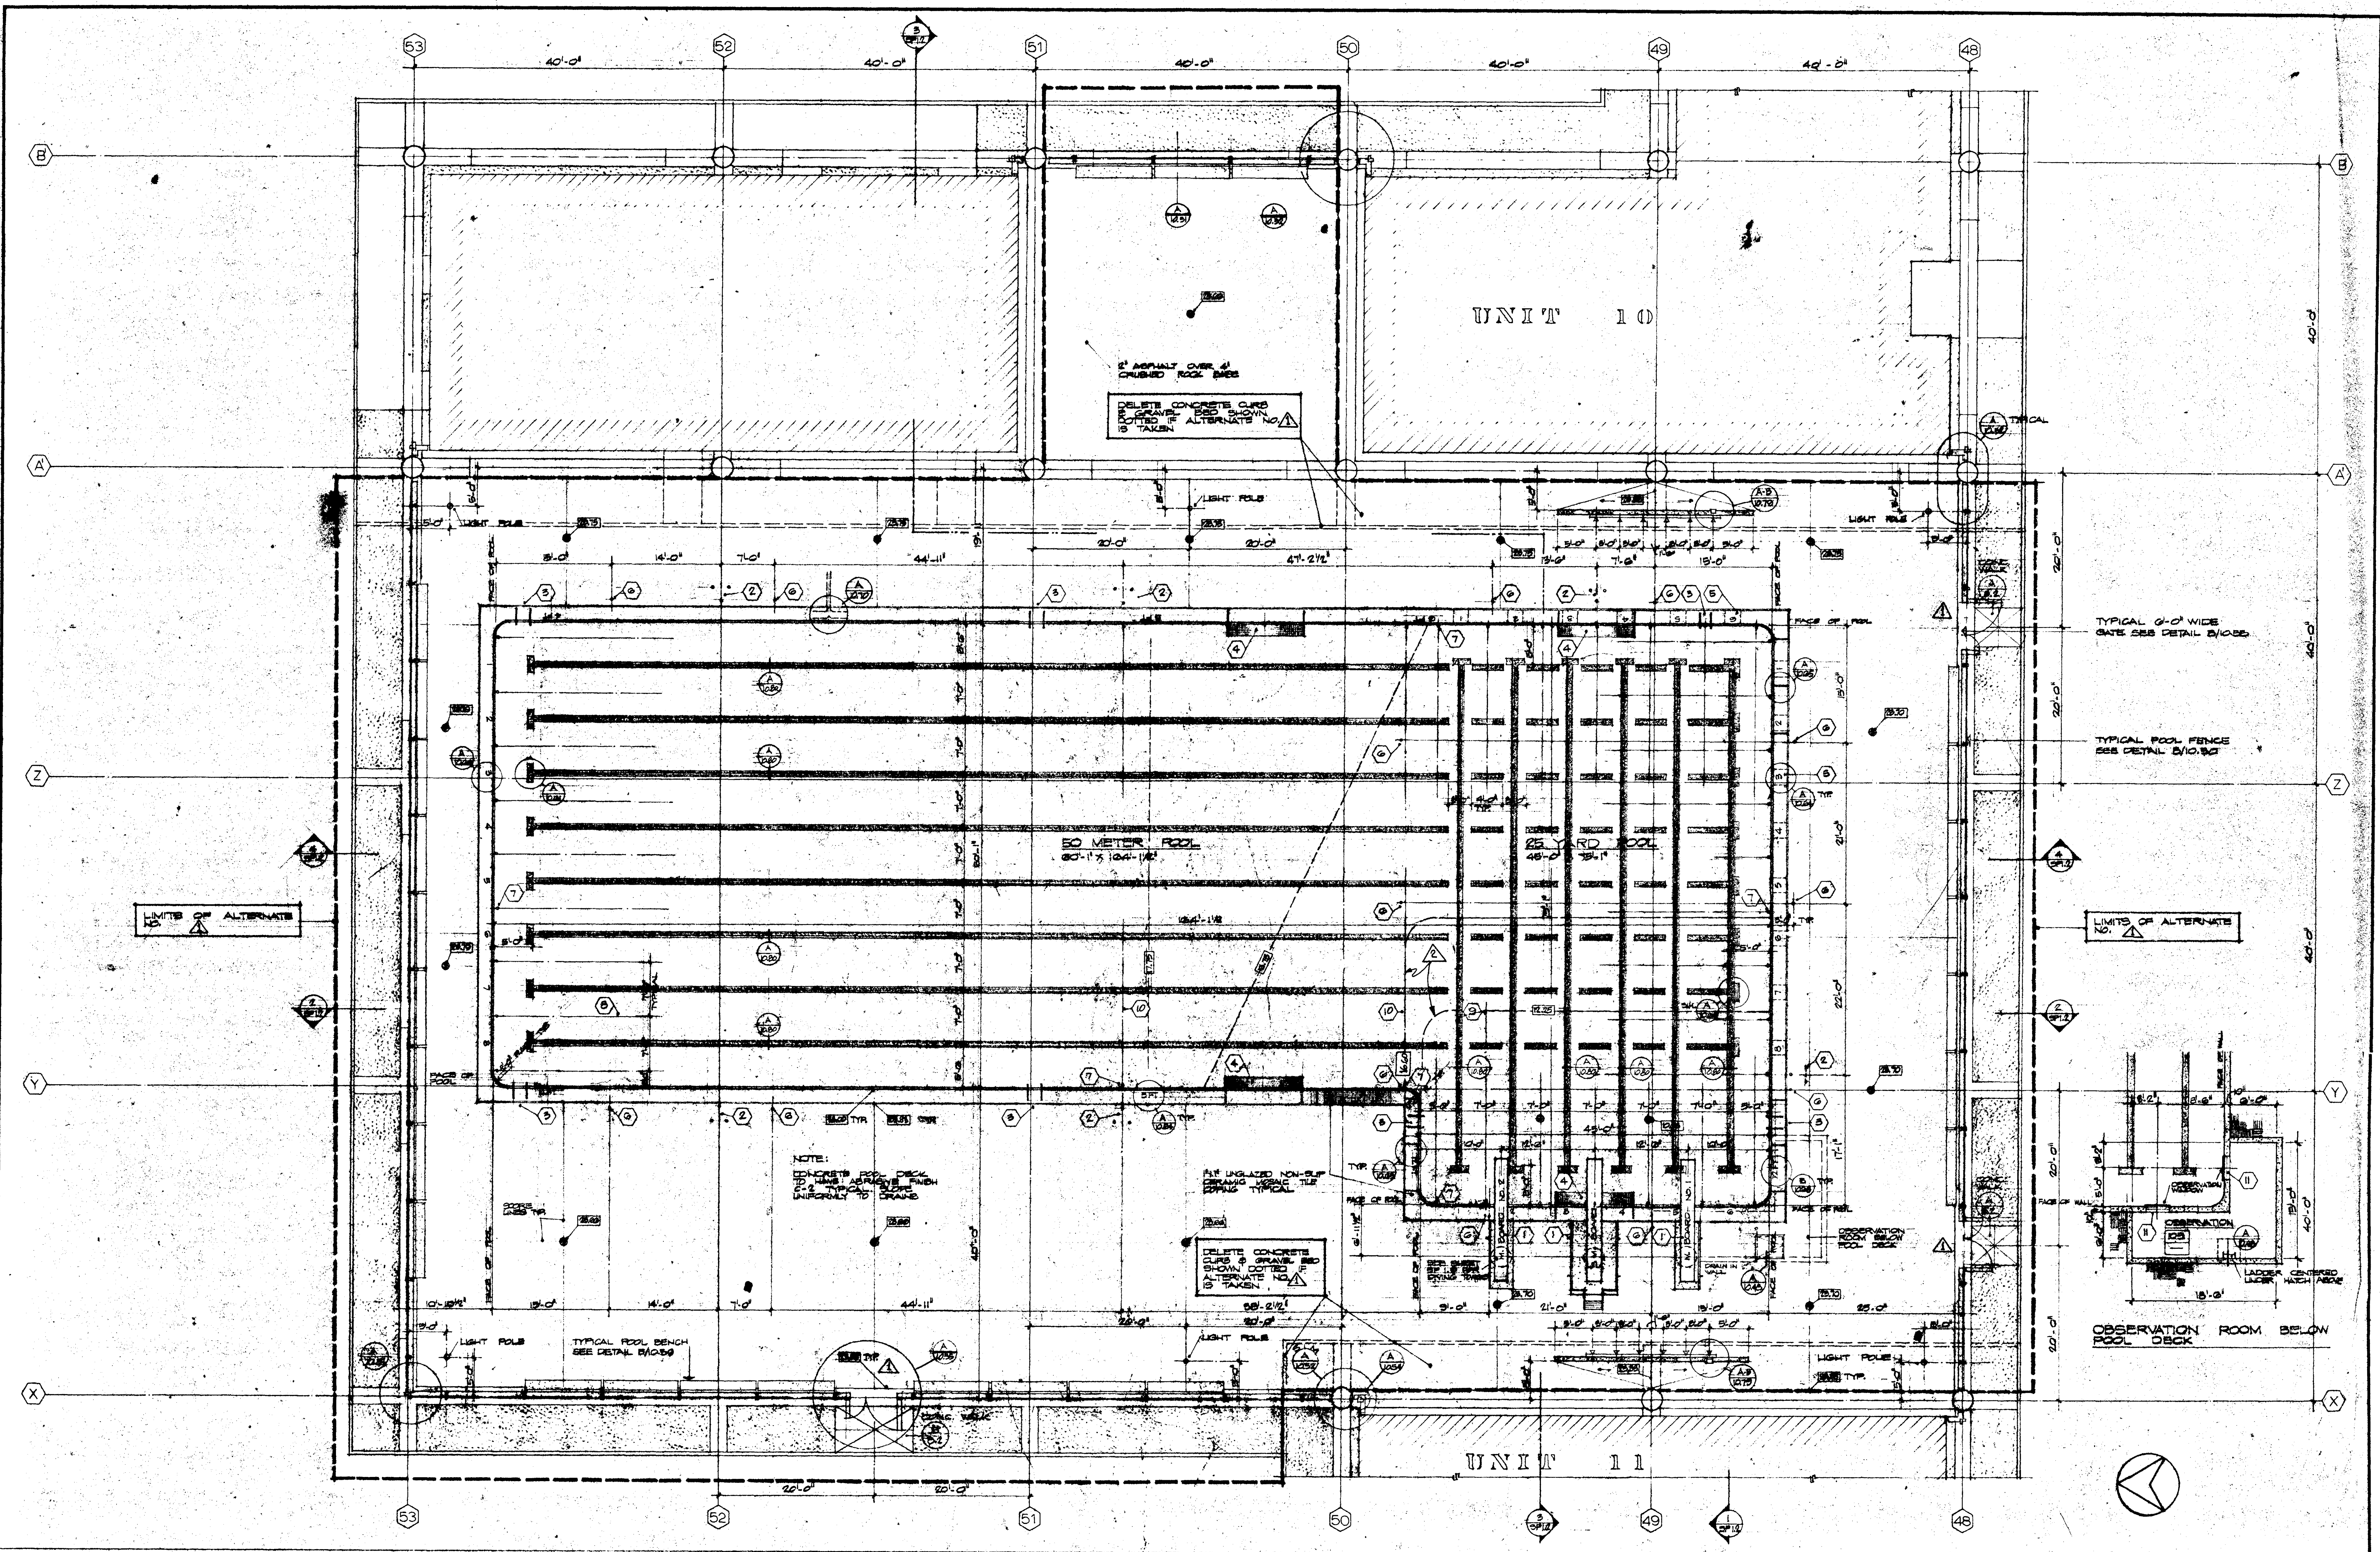
<div>1/16/65 NA SEE ADDENDUM NO. 1 ITEM NO. 200</div> <div>2/16/65 NA SEE ADDENDUM NO. 1 ITEM NO. 200</div> <div>3/16/65 NA ELV. CORRECTIONS APPROVED</div> <div>4/16/65 NA </div> <div>5/16/65 NA </div> <div>6/16/65 NA </div> <div>7/16/65 NA </div> <div>8/16/65 NA </div> <div>9/16/65 NA </div> <div>10/16/65 NA </div> <div>11/16/65 NA </div> <div>12/16/65 NA </div> <div>DATE DRAWN REVISIONS</div>				<div>STRUCTURAL ENGINEERS BRANDOW & JOHNSTON J.A. MARTIN & ASSOCIATES</div> <div>MECHANICAL ENGINEERS RALPH E. PHILLIPS, INC.</div> <div>ELECTRICAL ENGINEERS RALPH E. PHILLIPS, INC.</div> <div>CIVIL ENGINEERS O. SHURMAN & ASSOCIATES MOFFATT & SCHOLZ</div>		<div>DESIGNED</div> <div>DRAWN BY</div> <div>CHECKED BY</div> <div>ARCHITECT ENGINEER</div> <div>COLLEGE</div>		<div>APPROVED</div> <div>DATE FIRE MARSHAL STATE OF CALIFORNIA DATE 11/2/1965</div> <div>2587 A APPROVED 12 JUN 1965</div>		<div>ASSOCIATED ARCHITECTS: WILLIAM L. PEREIRA & ASSOCIATES A. QUINCY JONES-FREDERICK E. EMMONS & ASSOCIATES BLUROCK ELLERBROEK & ASSOCIATES</div> <div>URBANUS SQUARE • MACARTHUR BOULEVARD AT FORD ROAD TELEPHONE 714/675-2640 • CORONA DEL MAR, CALIFORNIA</div>		<div>GOLDEN WEST COLLEGE HUNTINGTON BEACH, CALIFORNIA ORANGE COAST JUNIOR COLLEGE DISTRICT</div>				<div>SWIMMING POOL FLOOR PLAN</div> <div>SCALE 1/8" = 1'-0"</div> <div>JOB NO. 100-4</div> <div>DATE 15 JUN 1965</div> <div>SHEET NO. 1-1</div>	
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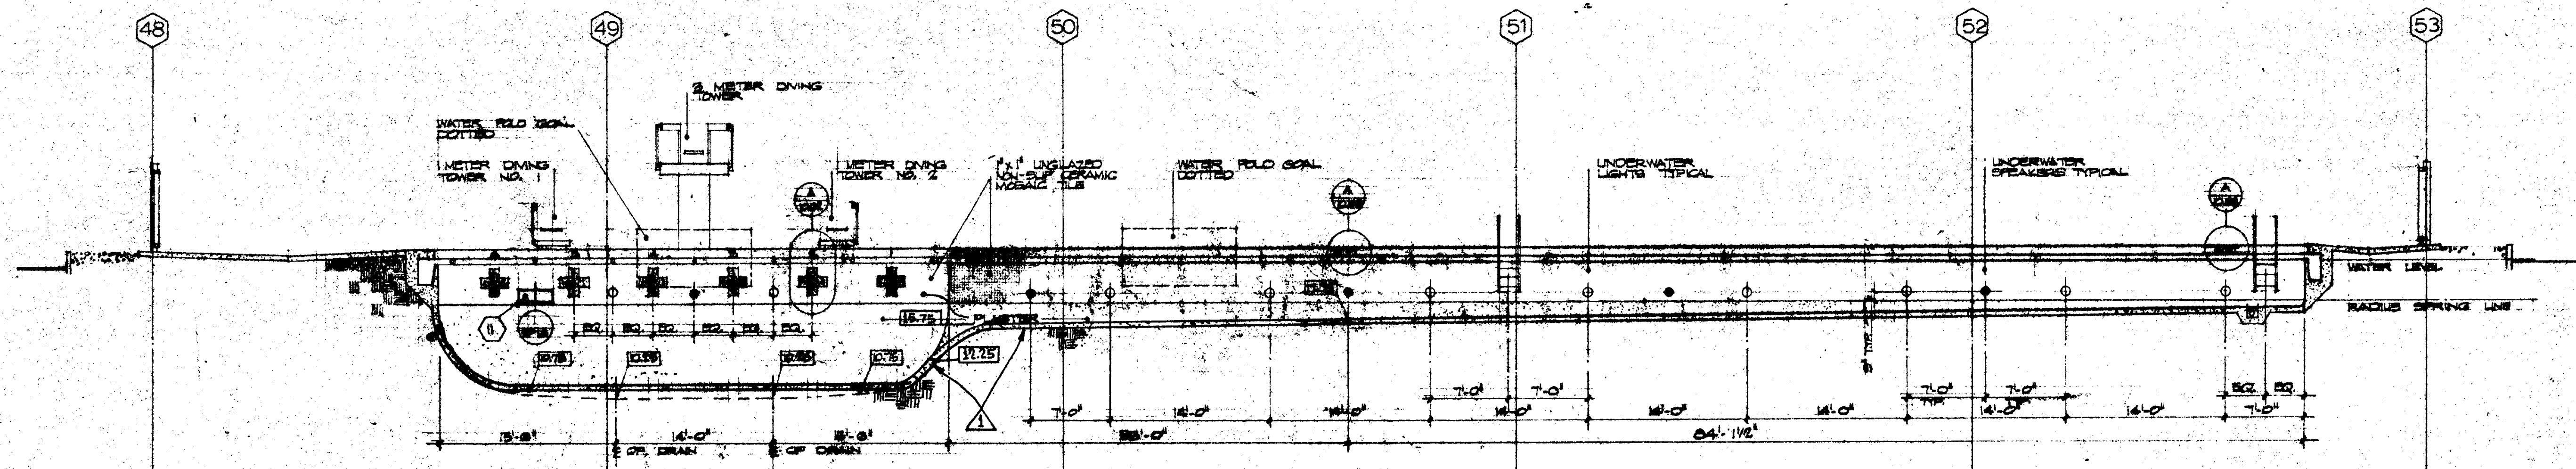
SECTION

SCALE 1/8" = 1'

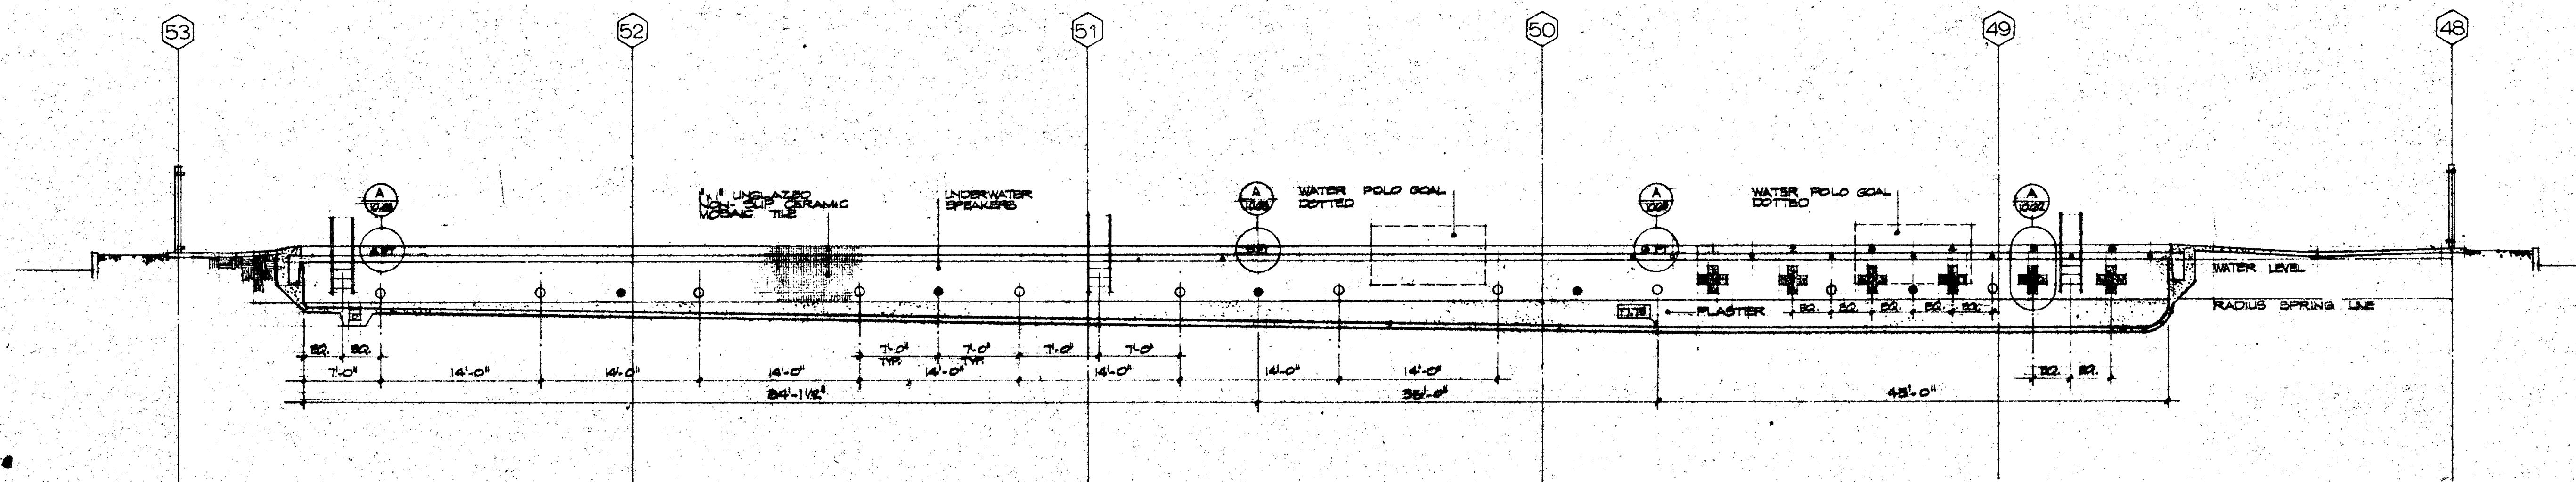


SECTION

SCALE 1/8" = 1'



SECTION

SCALE 1/8" = 1'

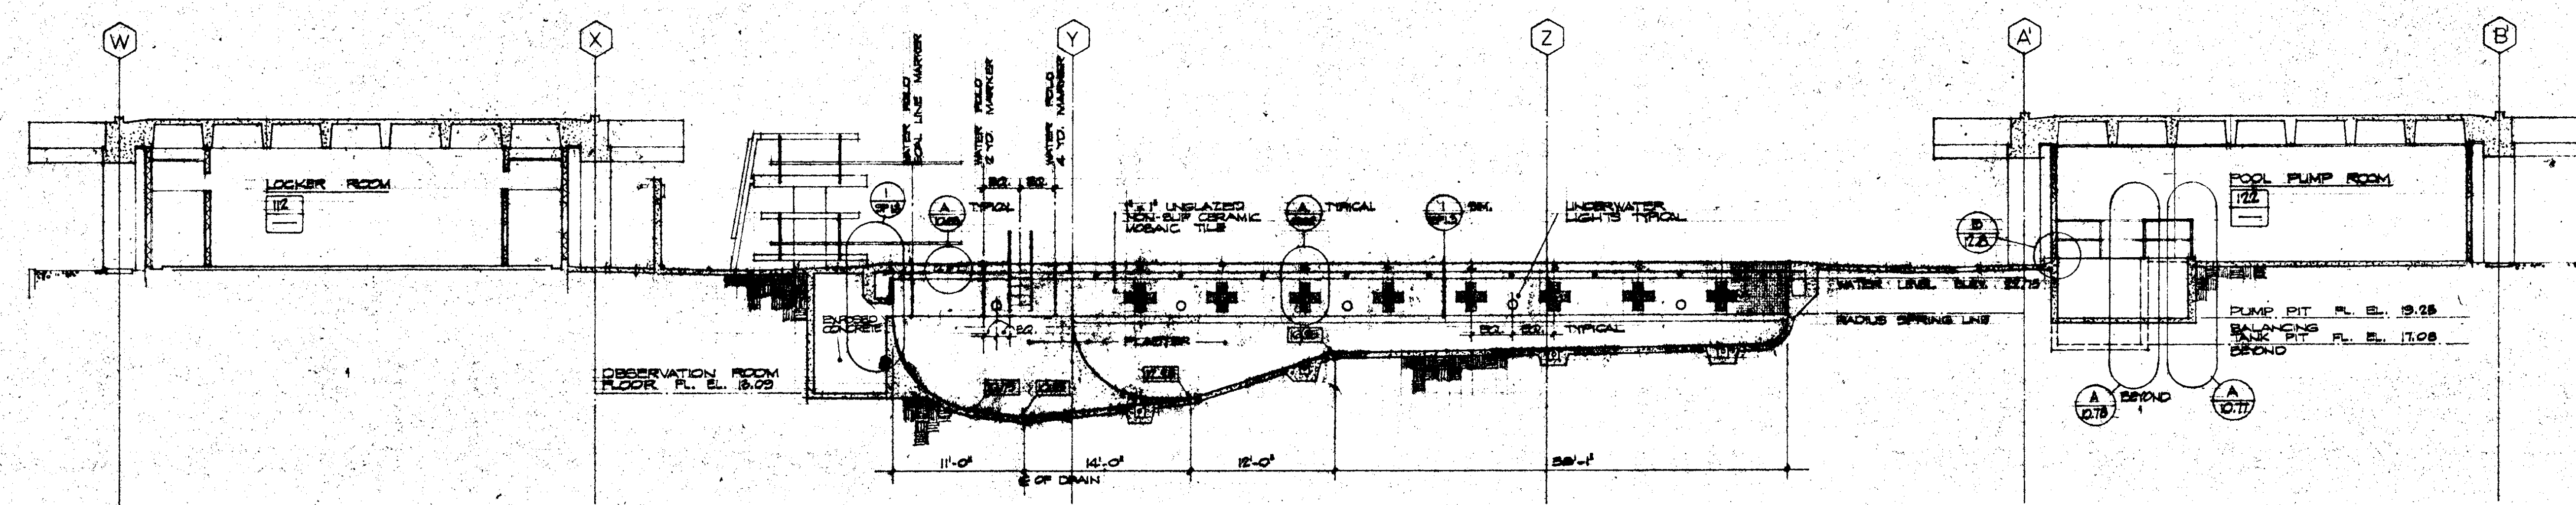

DATE	REVISIONS
1/5/66	1. ELV. CORRECTIONS APPROVED
2/1/66	2. ELV. CORRECTIONS APPROVED
3/1/66	3. ELV. CORRECTIONS APPROVED
4/1/66	4. ELV. CORRECTIONS APPROVED
5/1/66	5. ELV. CORRECTIONS APPROVED
6/1/66	6. ELV. CORRECTIONS APPROVED
7/1/66	7. ELV. CORRECTIONS APPROVED
8/1/66	8. ELV. CORRECTIONS APPROVED
9/1/66	9. ELV. CORRECTIONS APPROVED
10/1/66	10. ELV. CORRECTIONS APPROVED
11/1/66	11. ELV. CORRECTIONS APPROVED
12/1/66	12. ELV. CORRECTIONS APPROVED


STRUCTURAL ENGINEERS BRANDOW & JOHNSTON J.A. MARTIN & ASSOCIATES	DESIGNED BY ARCHITECT WILLIAM L. PEREIRA & ASSOCIATES
MECHANICAL ENGINEERS RALPH E. PHILLIPS, INC.	DRAWN BY ENGINEER WILLIAM L. PEREIRA & ASSOCIATES
ELECTRICAL ENGINEERS RALPH E. PHILLIPS, INC.	CHECKED BY COLLEGE STATE OF CALIFORNIA
CIVIL ENGINEERS O. SHURMAN & ASSOCIATES MOFFATT & MICHAEL	APPROVED STATE FIRE MARSHAL STATE OF CALIFORNIA DATE JUN 21 1965

APPROVED STATE FIRE MARSHAL STATE OF CALIFORNIA DATE JUN 21 1965	APPROVED STATE FIRE MARSHAL STATE OF CALIFORNIA DATE JUN 21 1965
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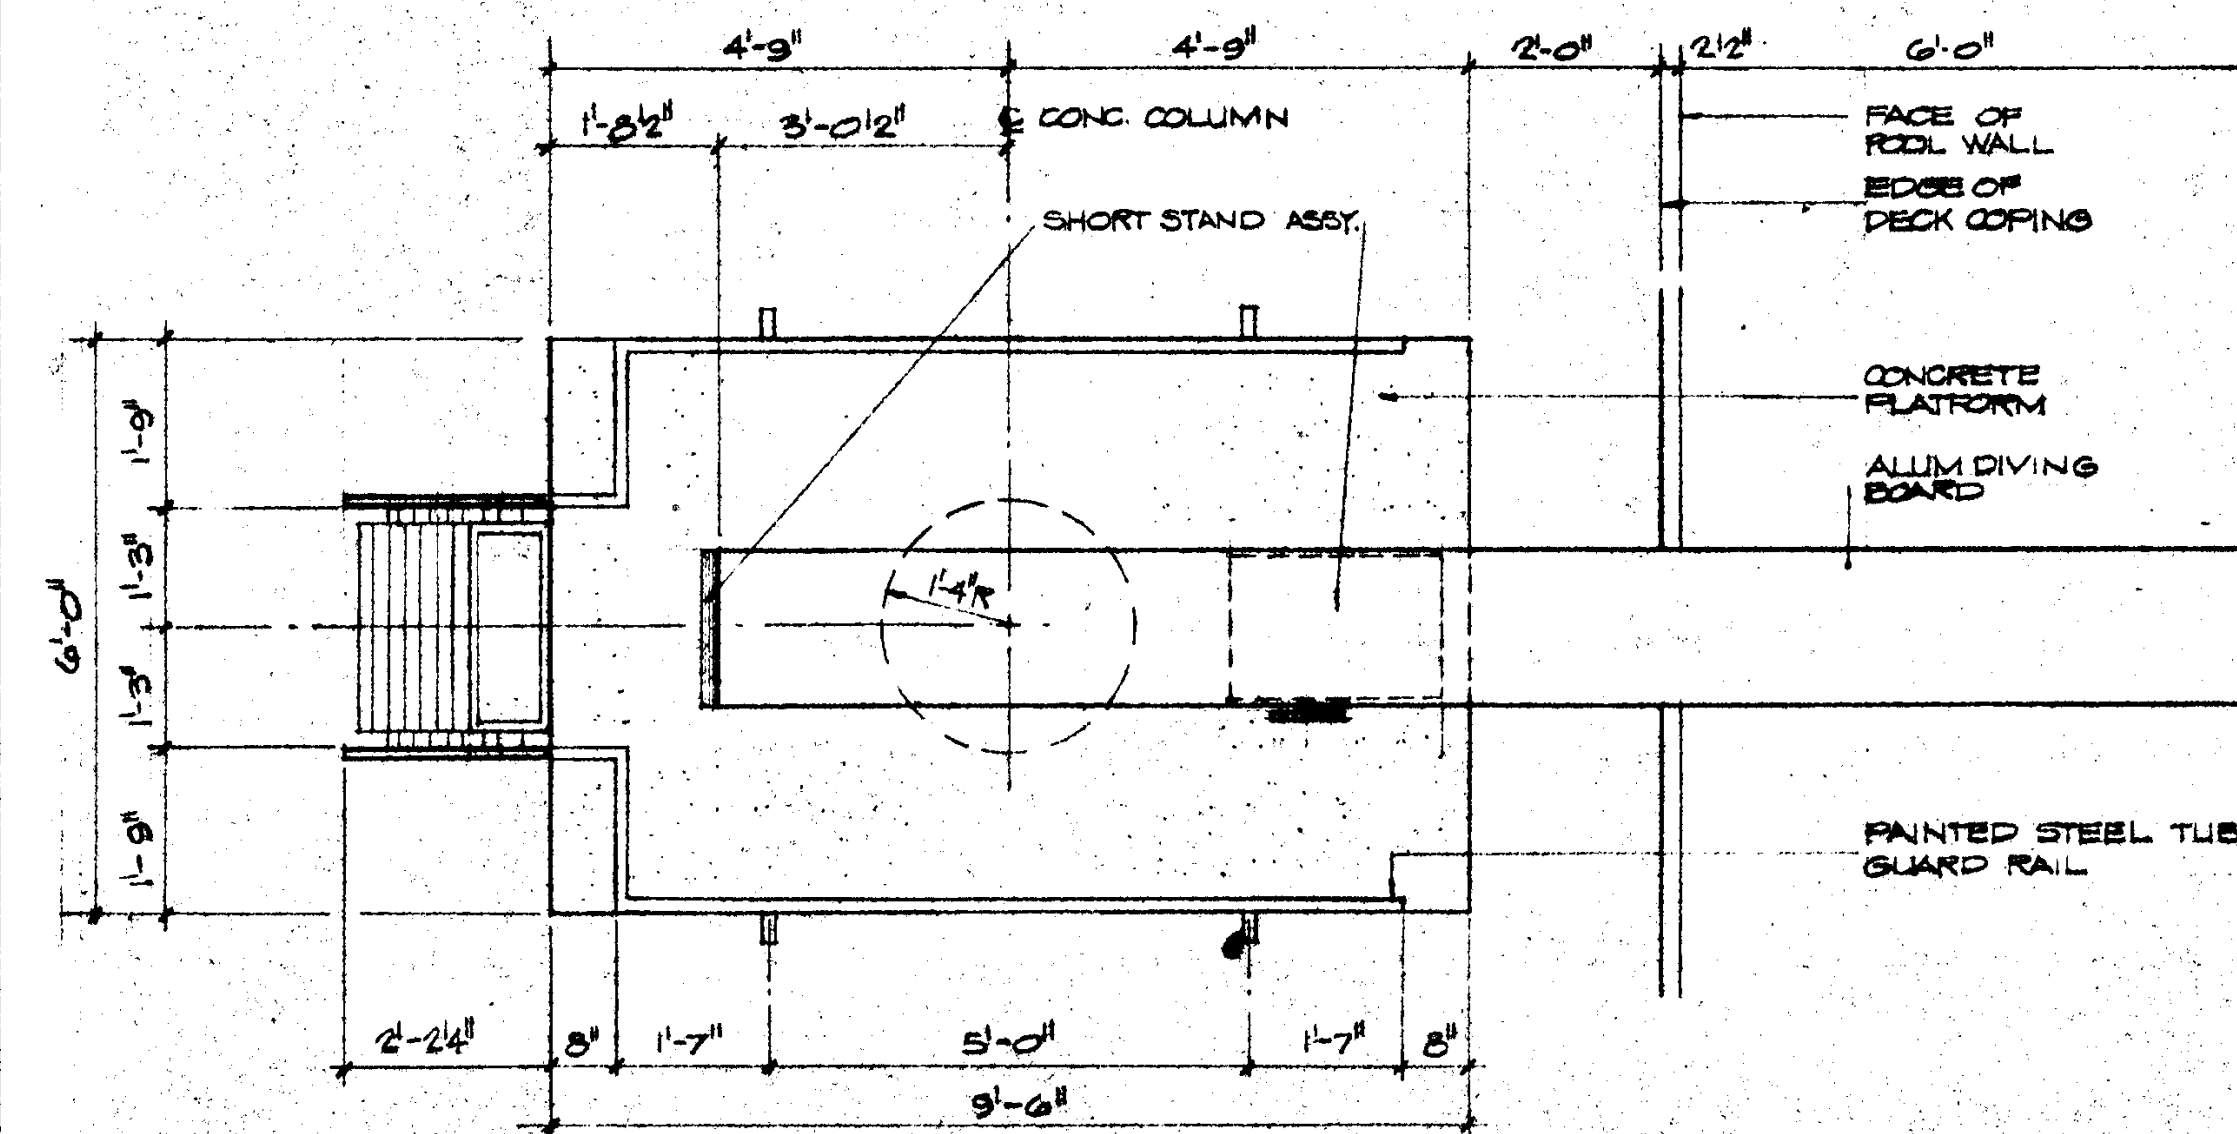
ASSOCIATED ARCHITECTS:
WILLIAM L. PEREIRA & ASSOCIATES
A QUINCY JONES FREDERICK E. EMMONS & ASSOCIATES
BLUROCK ELLERBROEK & ASSOCIATES
URBANUS SQUARE • MACARTHUR BOULEVARD AT FORD ROAD
TELEPHONE 714/675-2640 • CORDA DEL MAR, CALIFORNIA

GOLDEN WEST COLLEGE
HUNTINGTON BEACH, CALIFORNIA
ORANGE COAST JUNIOR COLLEGE DISTRICT


SWIMMING POOL	JOB NO. 100-1
BUILDING SECTIONS	DATE 15 JUN 1965
	SHEET NO. 12

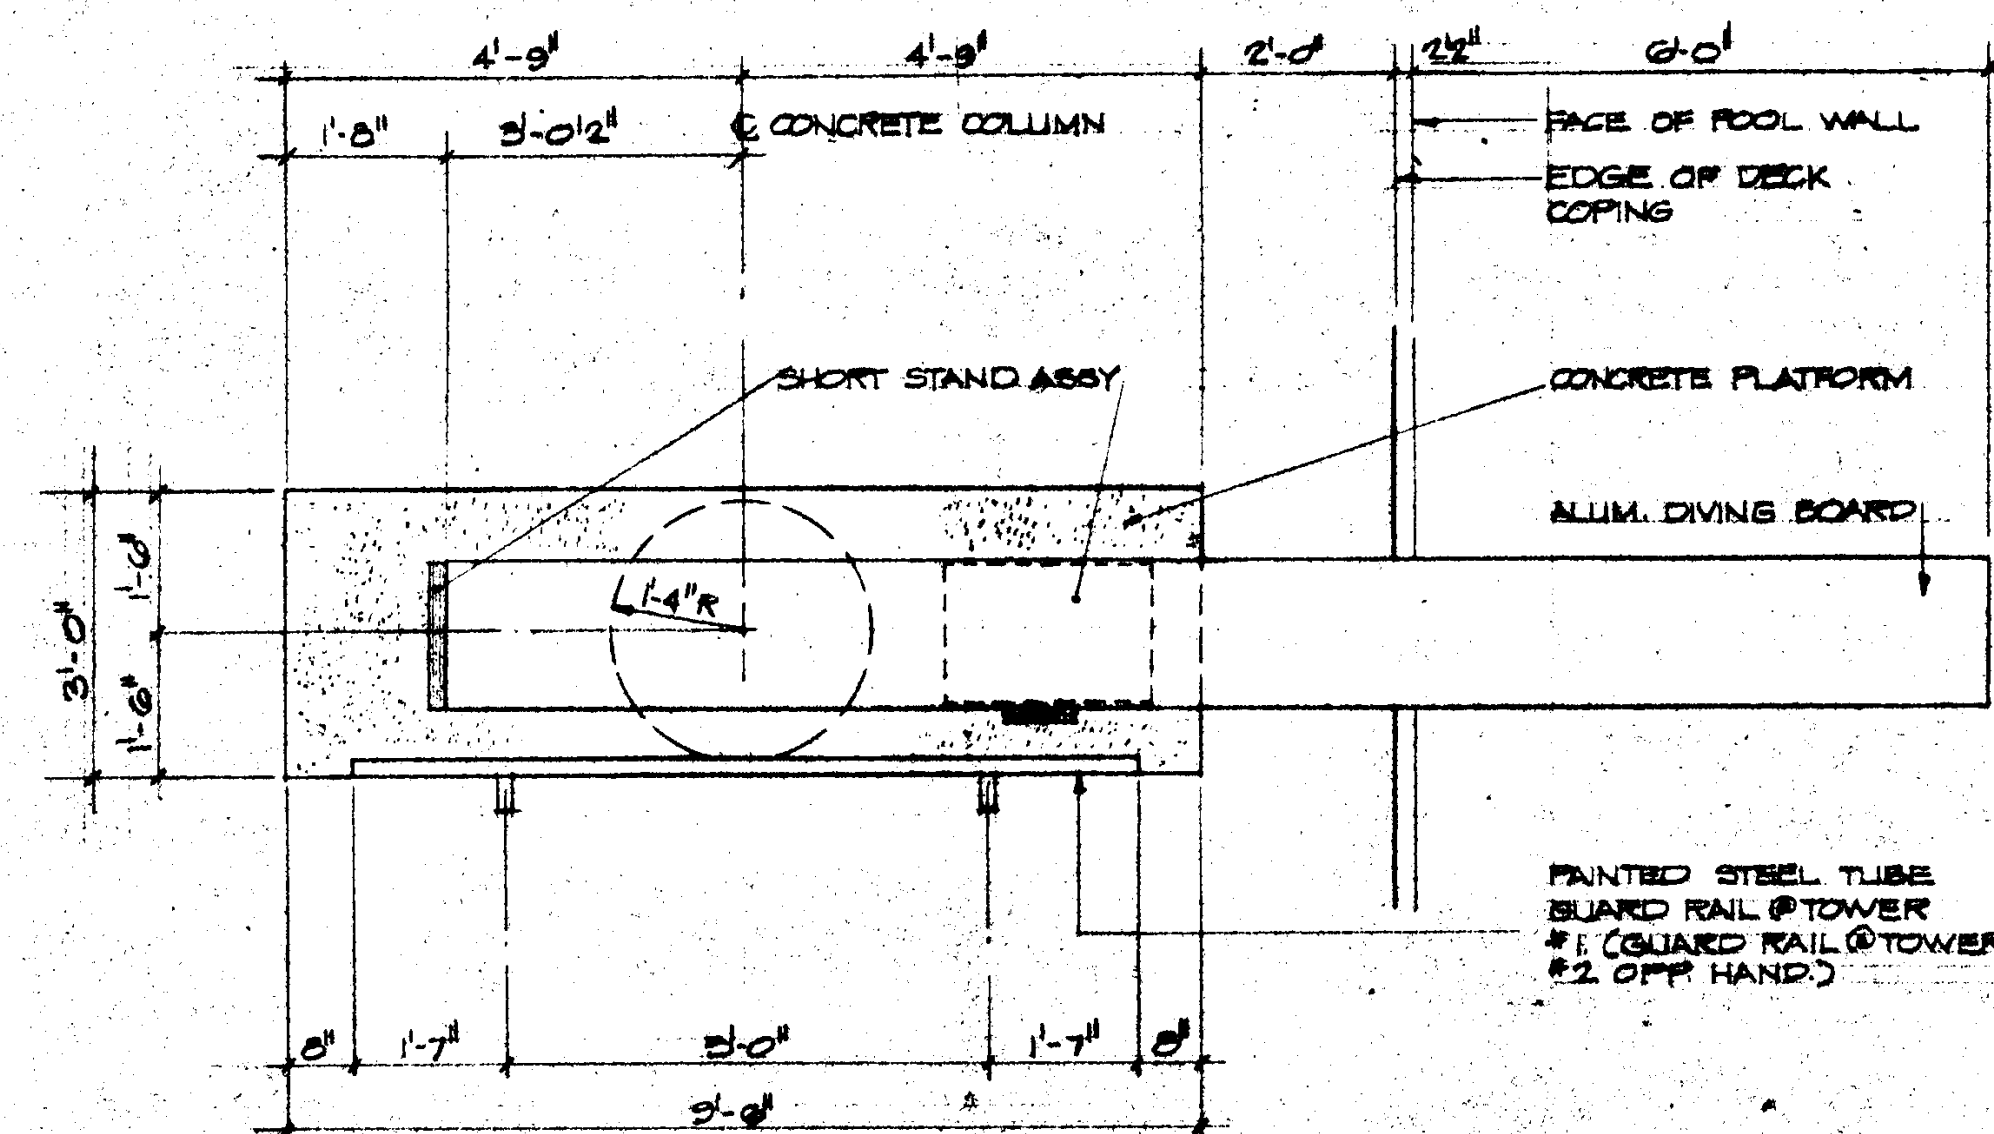


PLAN 1 METER TOWER




PLAN 3 METER TOWER

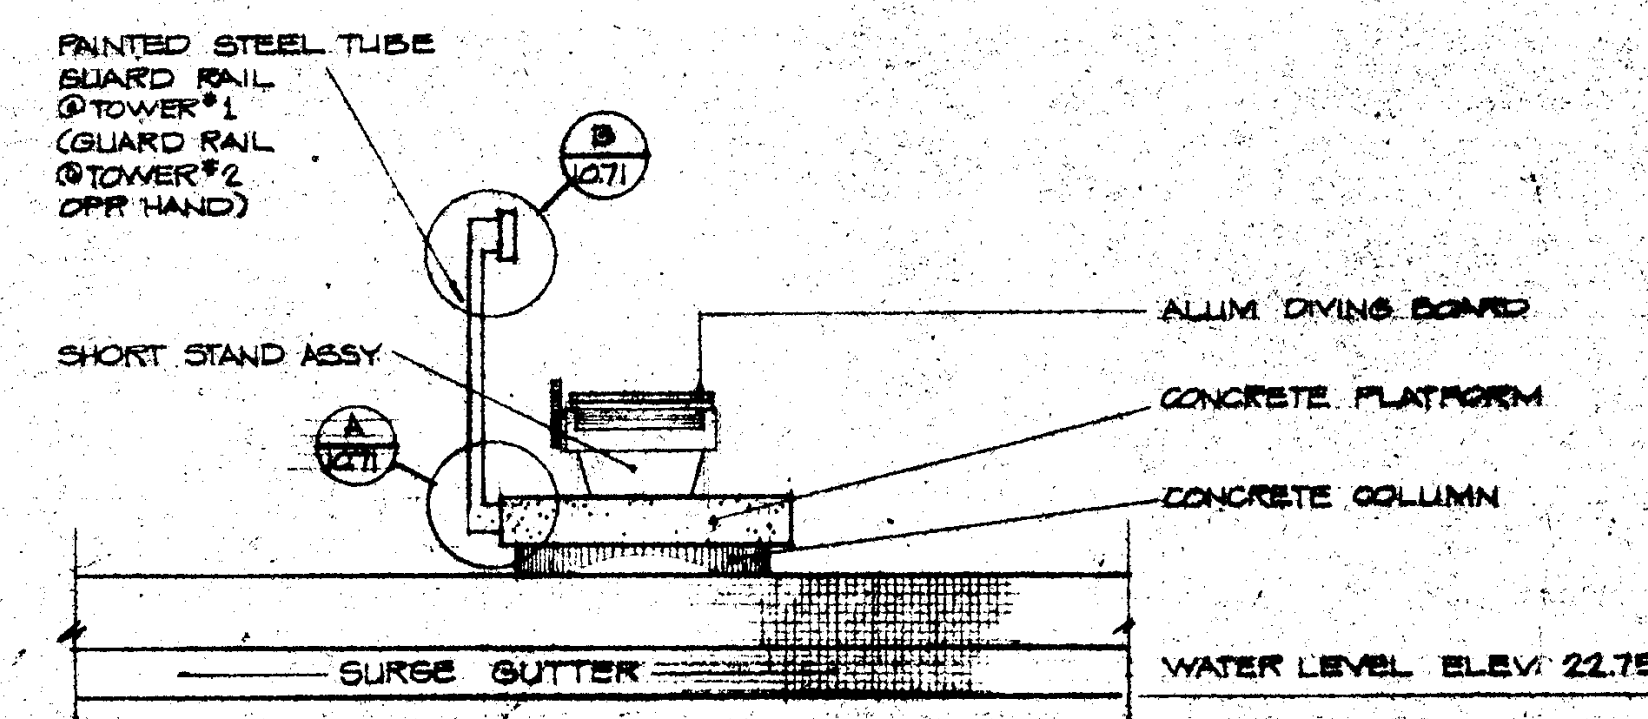


ELEVATION 1 METER TOWER

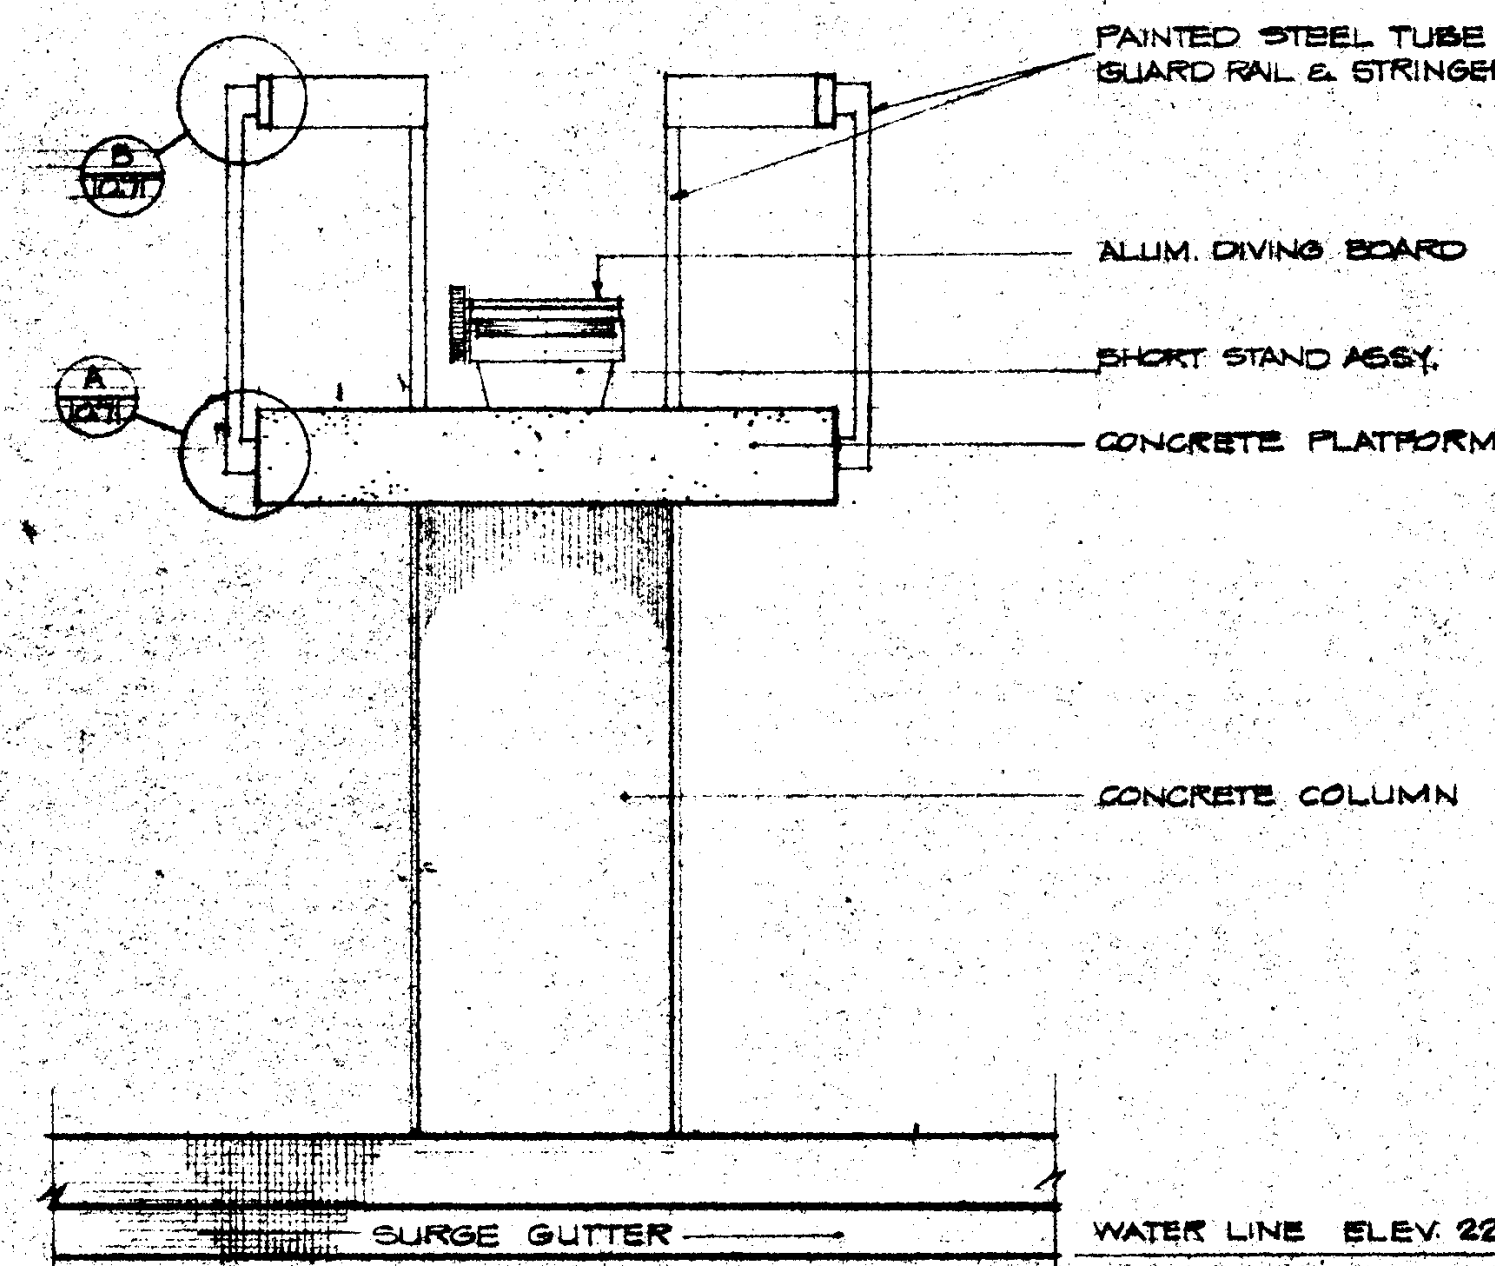


ELEVATION 3 METER TOWER

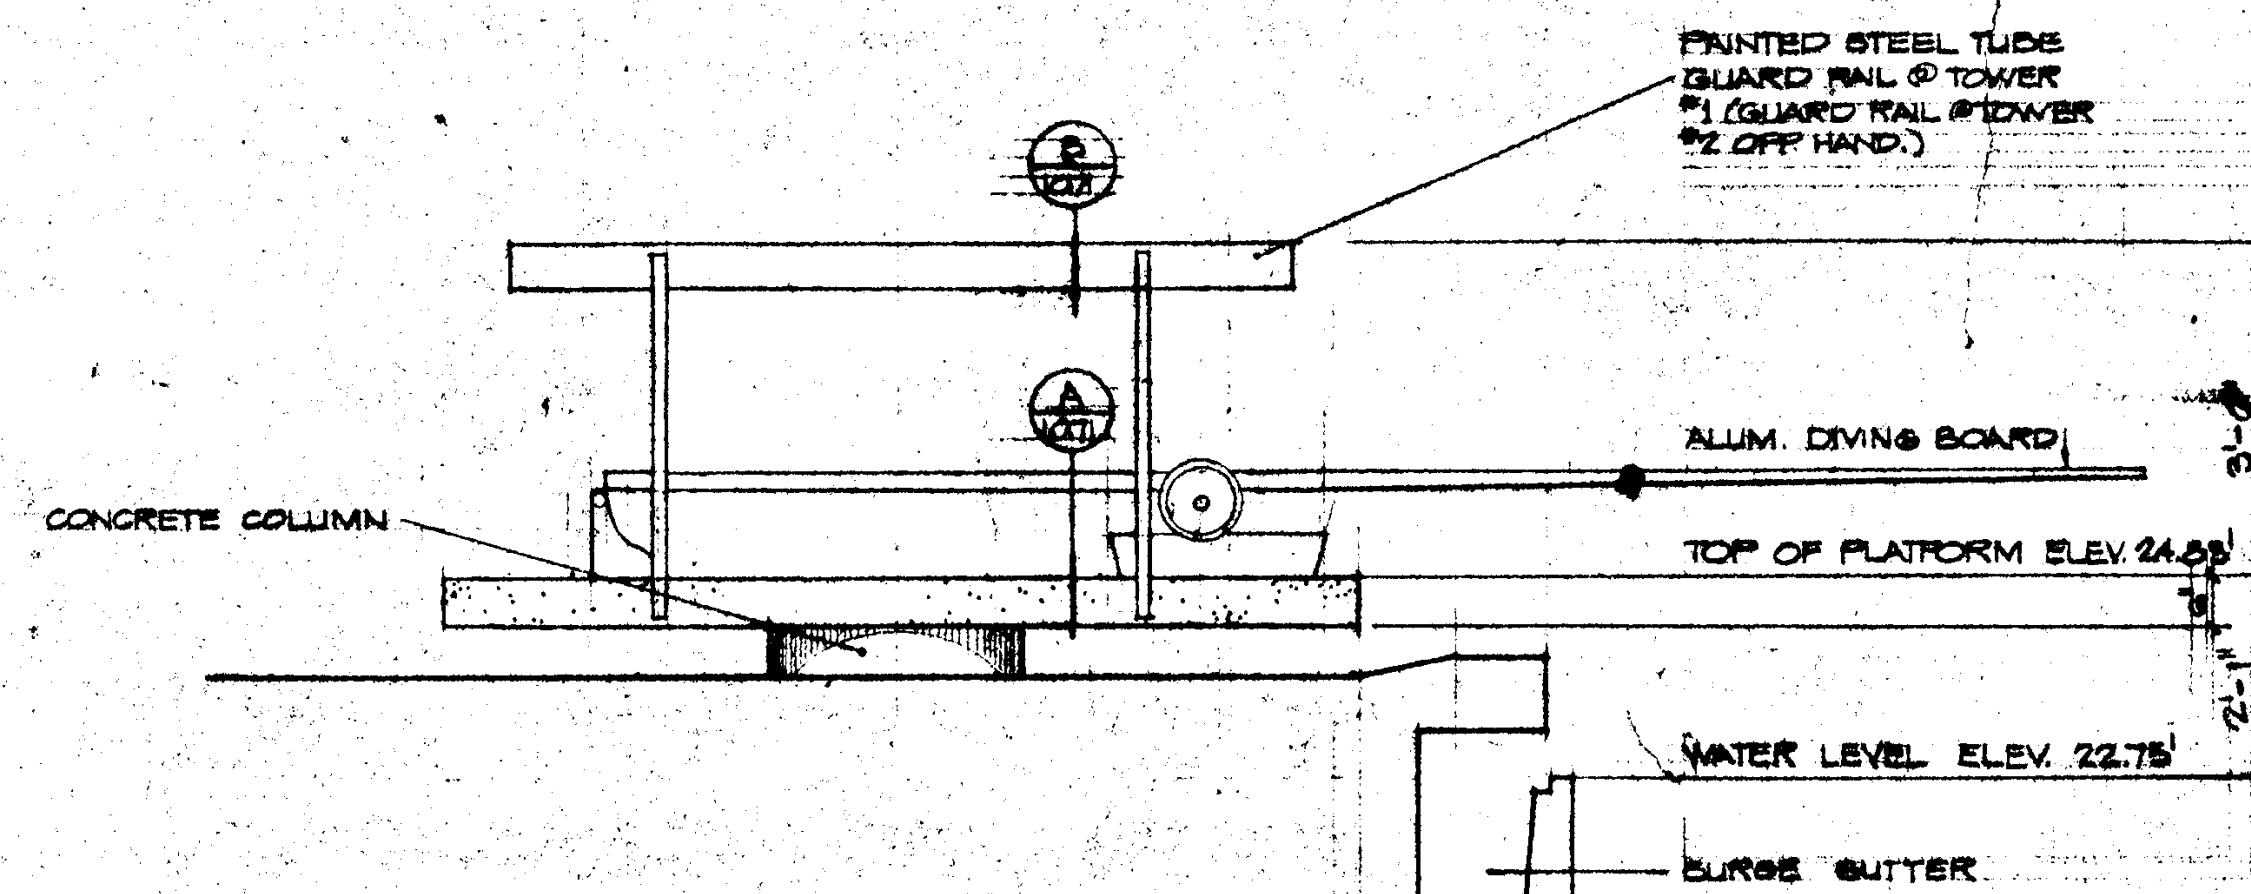

ELEVATION 1 METER TOWER

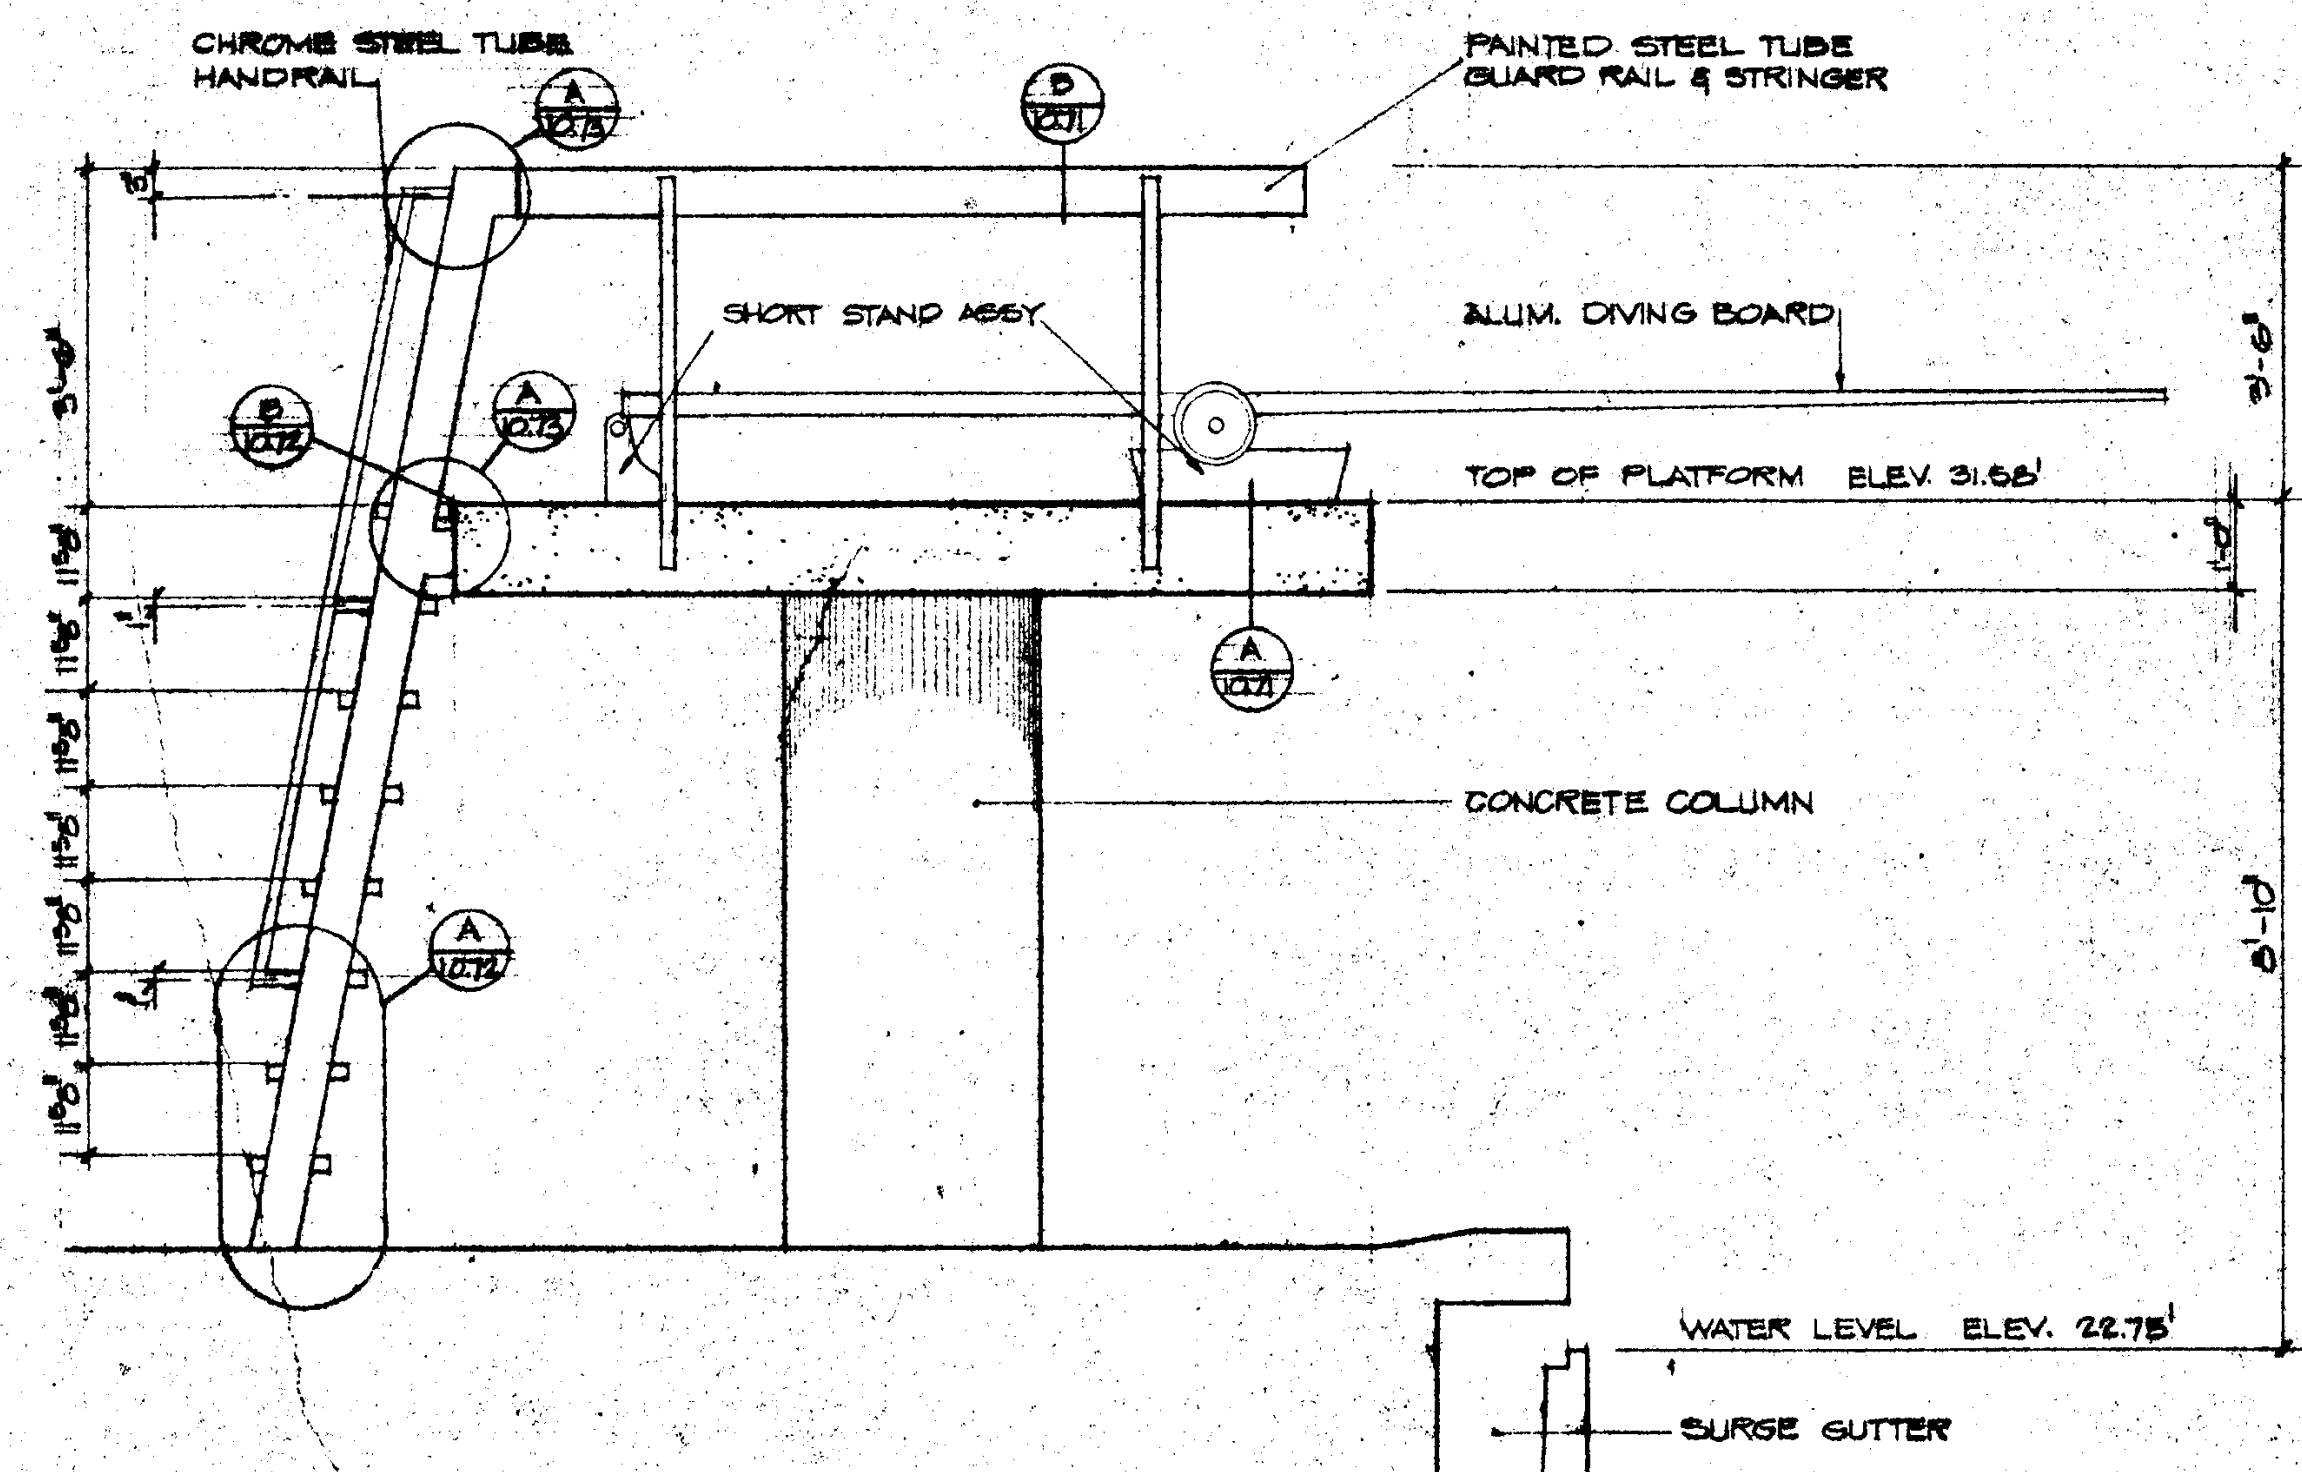


ELEVATION 3 METER TOWER

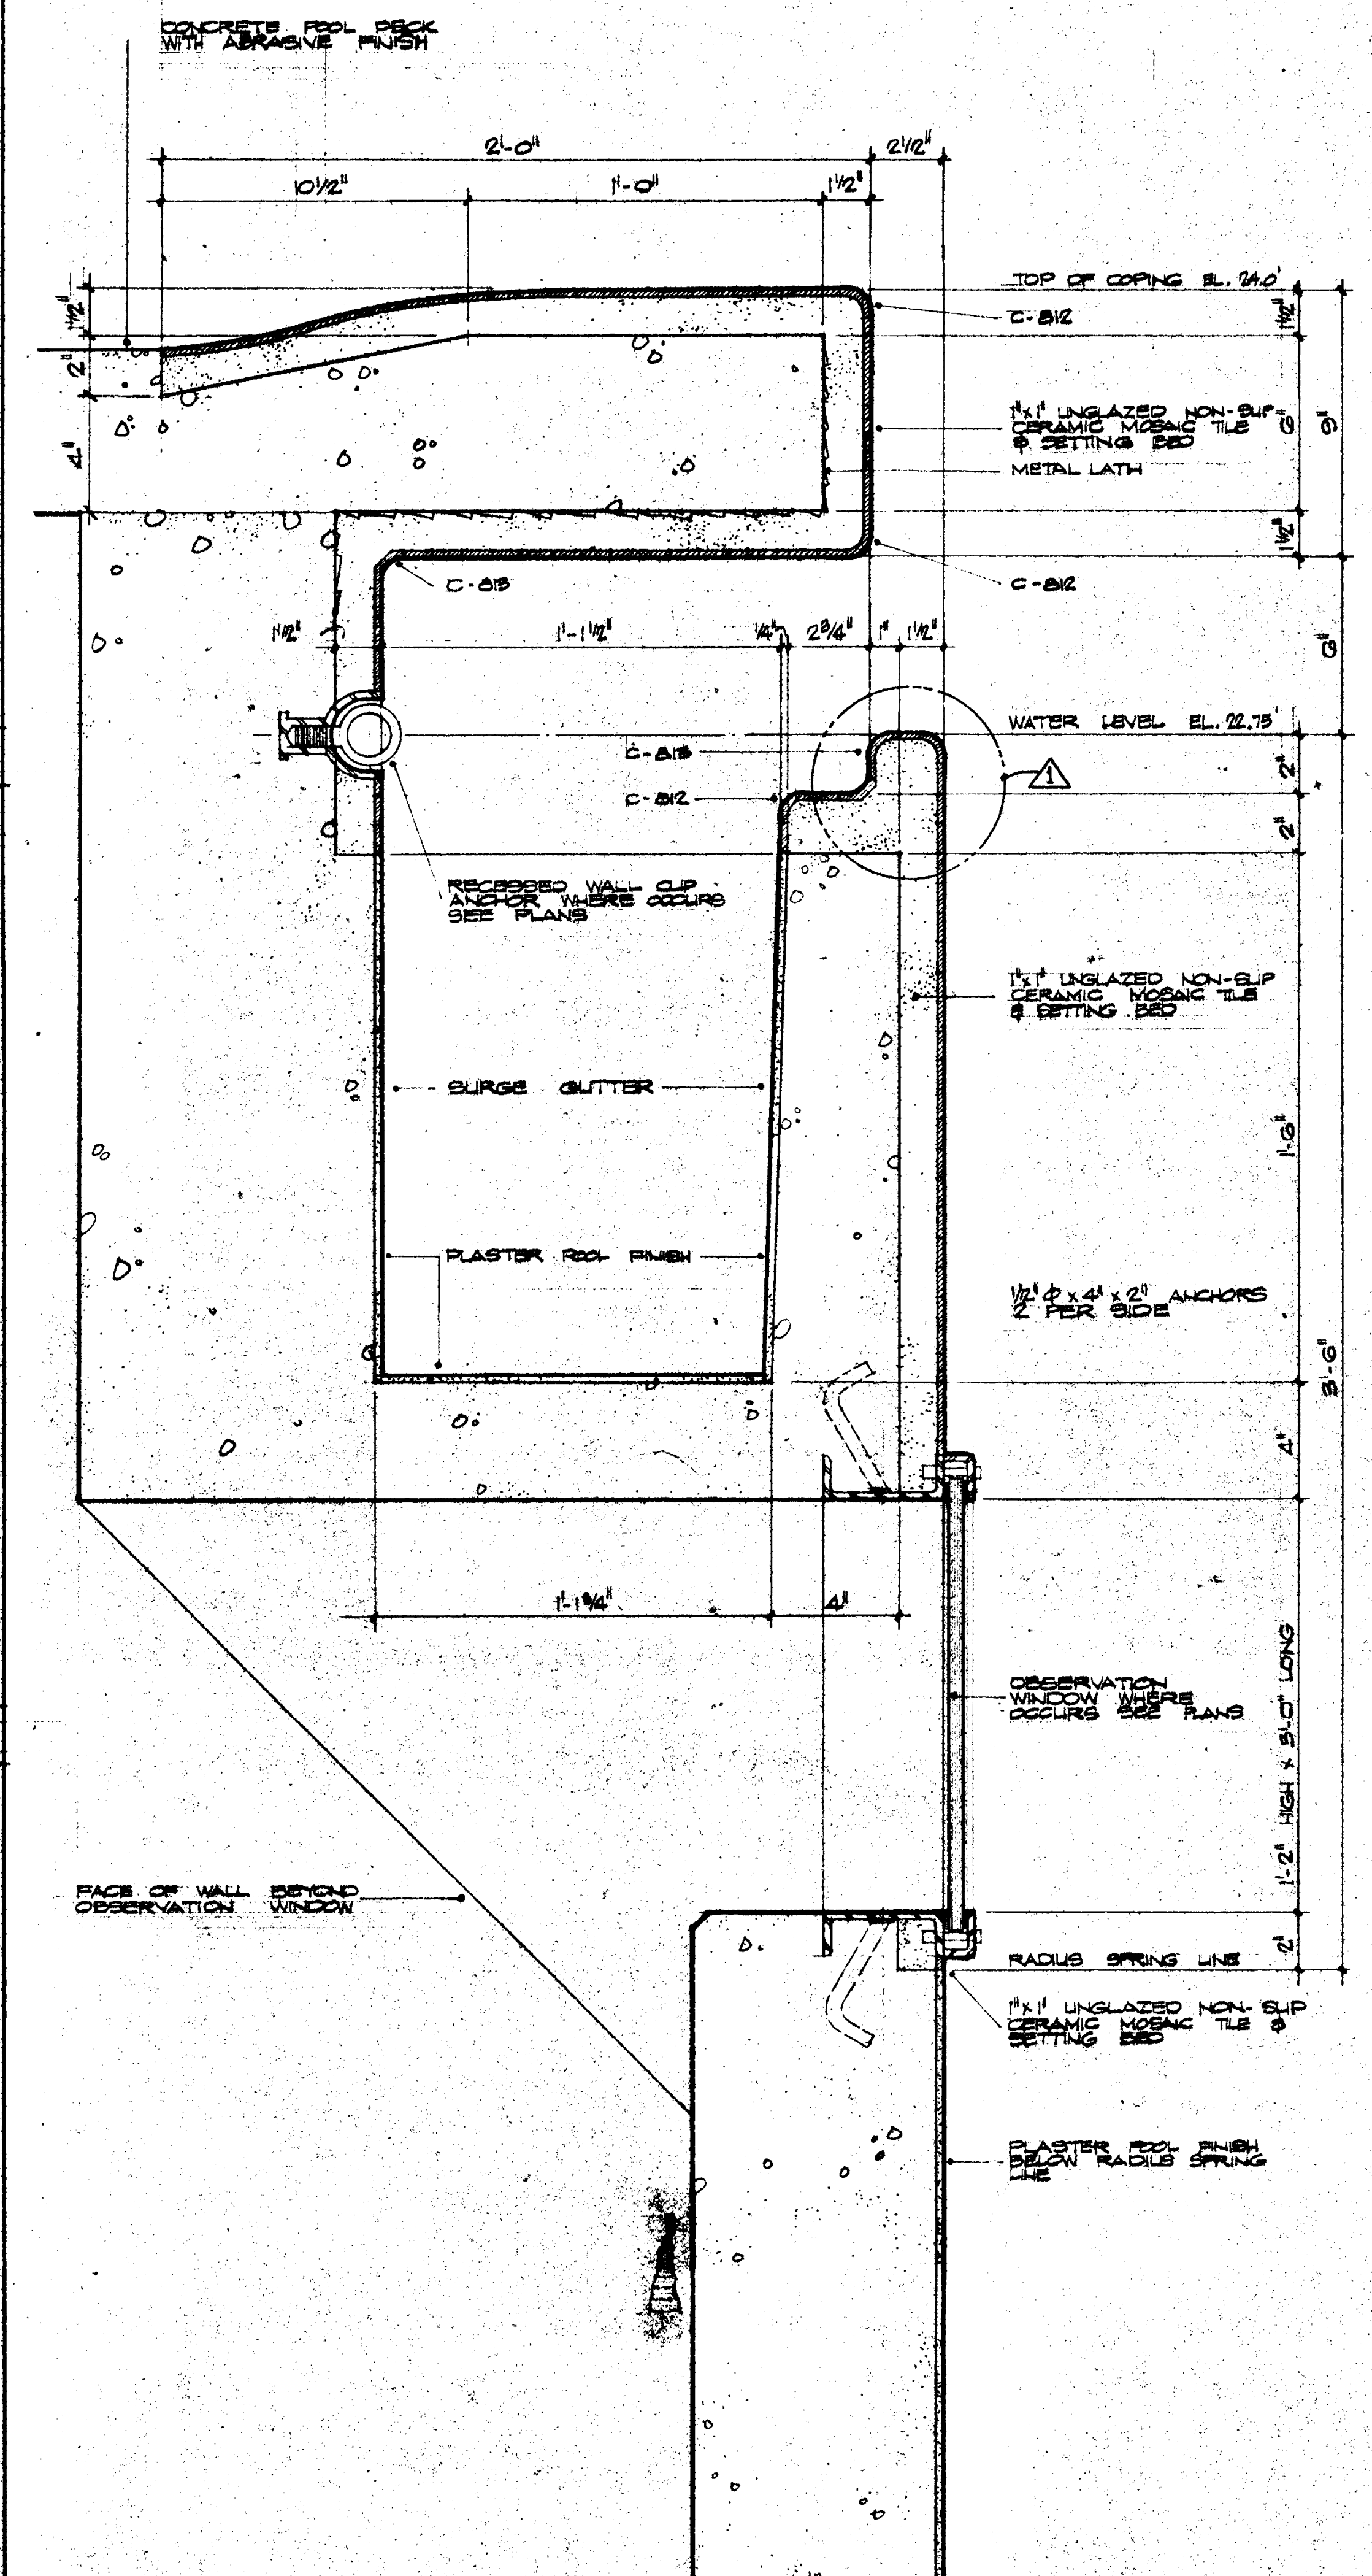

POOL COPING & GUTTER

<p>BULLETIN #43</p> <p>DATE: 11/1/65</p> <p>REVISIONS:</p>	<p>STRUCTURAL ENGINEERS: RANDOLPH & JOHNSTON, J.A. MARTIN & ASSOCIATES</p> <p>MECHANICAL ENGINEERS: RALPH E. PHILLIPS, INC.</p> <p>ELECTRICAL ENGINEERS: RALPH E. PHILLIPS, INC.</p> <p>CIVIL ENGINEERS: G. SHURMAN & ASSOCIATES, MOFFATT & NICOL</p>	<p>DESIGNED BY: [Signature]</p> <p>DRAWN BY: [Signature]</p> <p>CHECKED BY: [Signature]</p>	<p>APPROVED: [Signature]</p> <p>STATE FIRE MARSHAL: [Signature]</p> <p>DATE: 11/1/65</p> <p>25874 APPROVED JUN 21 1966</p>	<p>ASSOCIATED ARCHITECTS:</p> <p>WILLIAM L. PEREIRA & ASSOCIATES</p> <p>QUINCY JONES-FREDERICK E. EMMONS & ASSOCIATES</p> <p>BLURCK ELLERBROEK & ASSOCIATES</p> <p>URBANUS SQUARE • MACARTHUR BOULEVARD AT FORD ROAD</p> <p>TELEPHONE 714/675-2640 • CORONA DEL MAR, CALIFORNIA</p>	<p>GOLDEN WEST COLLEGE</p> <p>HUNTINGTON BEACH, CALIFORNIA</p> <p>ORANGE COAST JUNIOR COLLEGE DISTRICT</p>	<p>SWIMMING POOL</p> <p>POOL DETAILS</p>	<p>JOB NO. 1004</p> <p>DATE: 15 JUN 1965</p> <p>SHEET NO. SP1.3</p>
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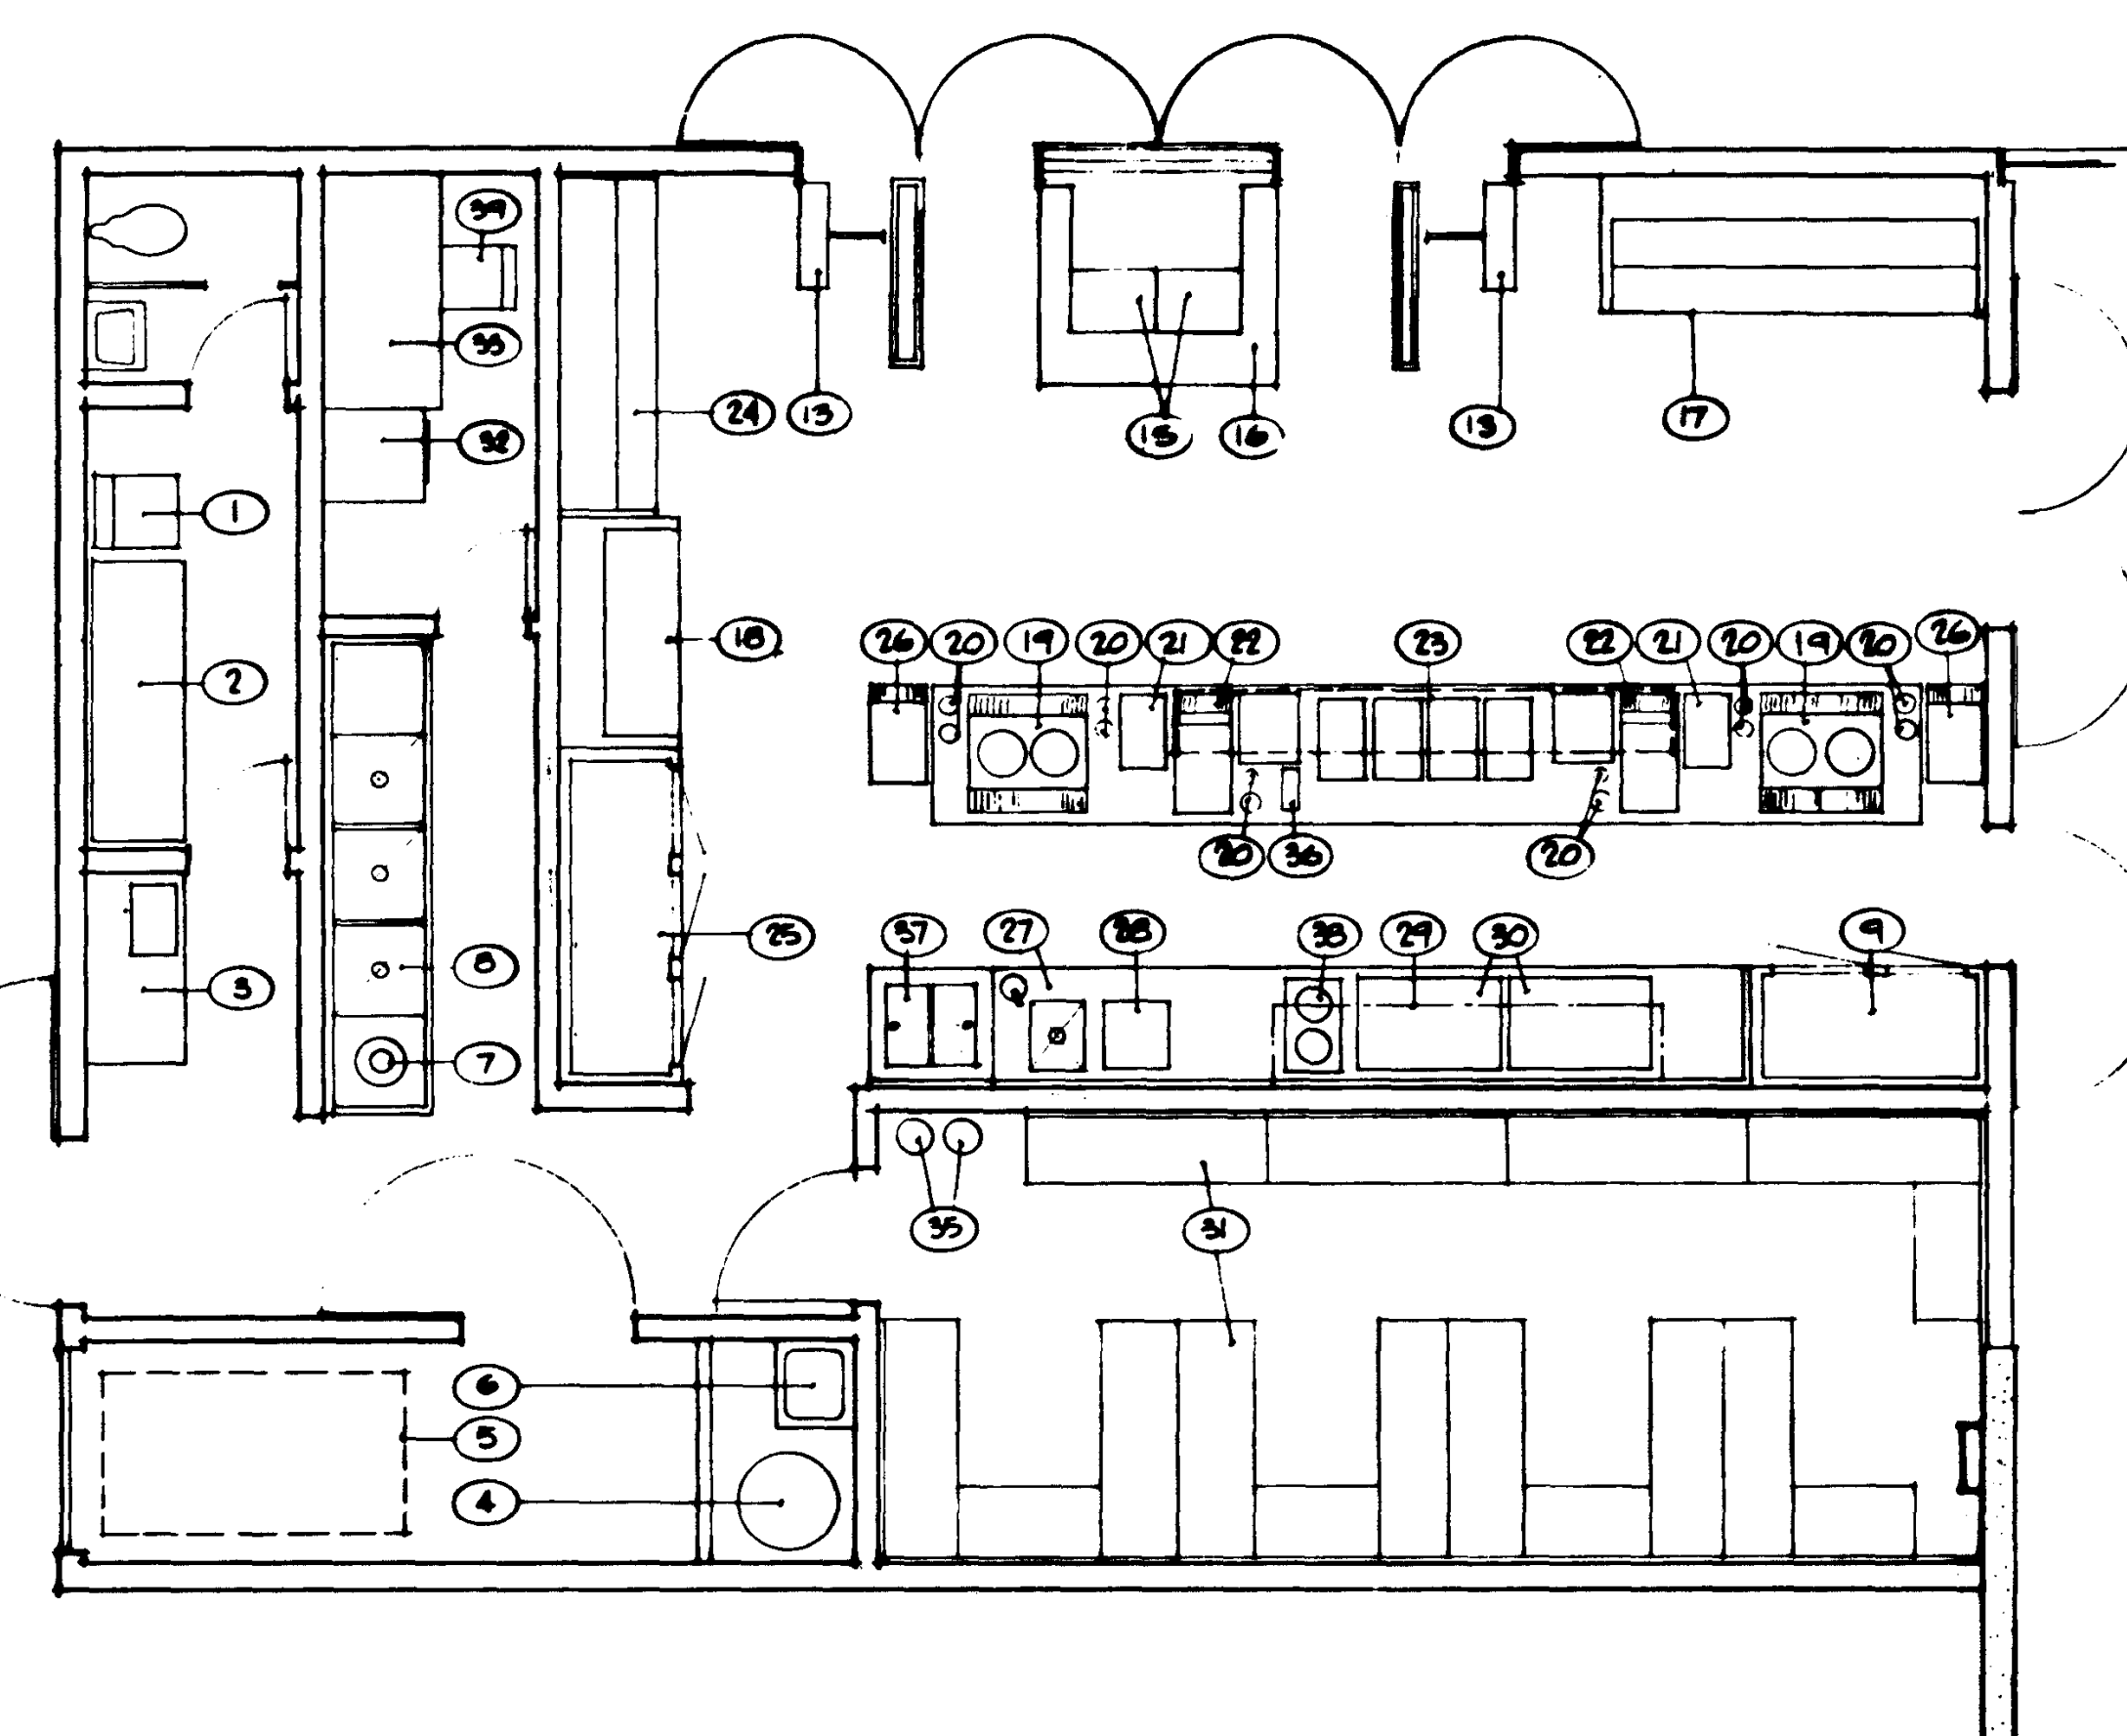


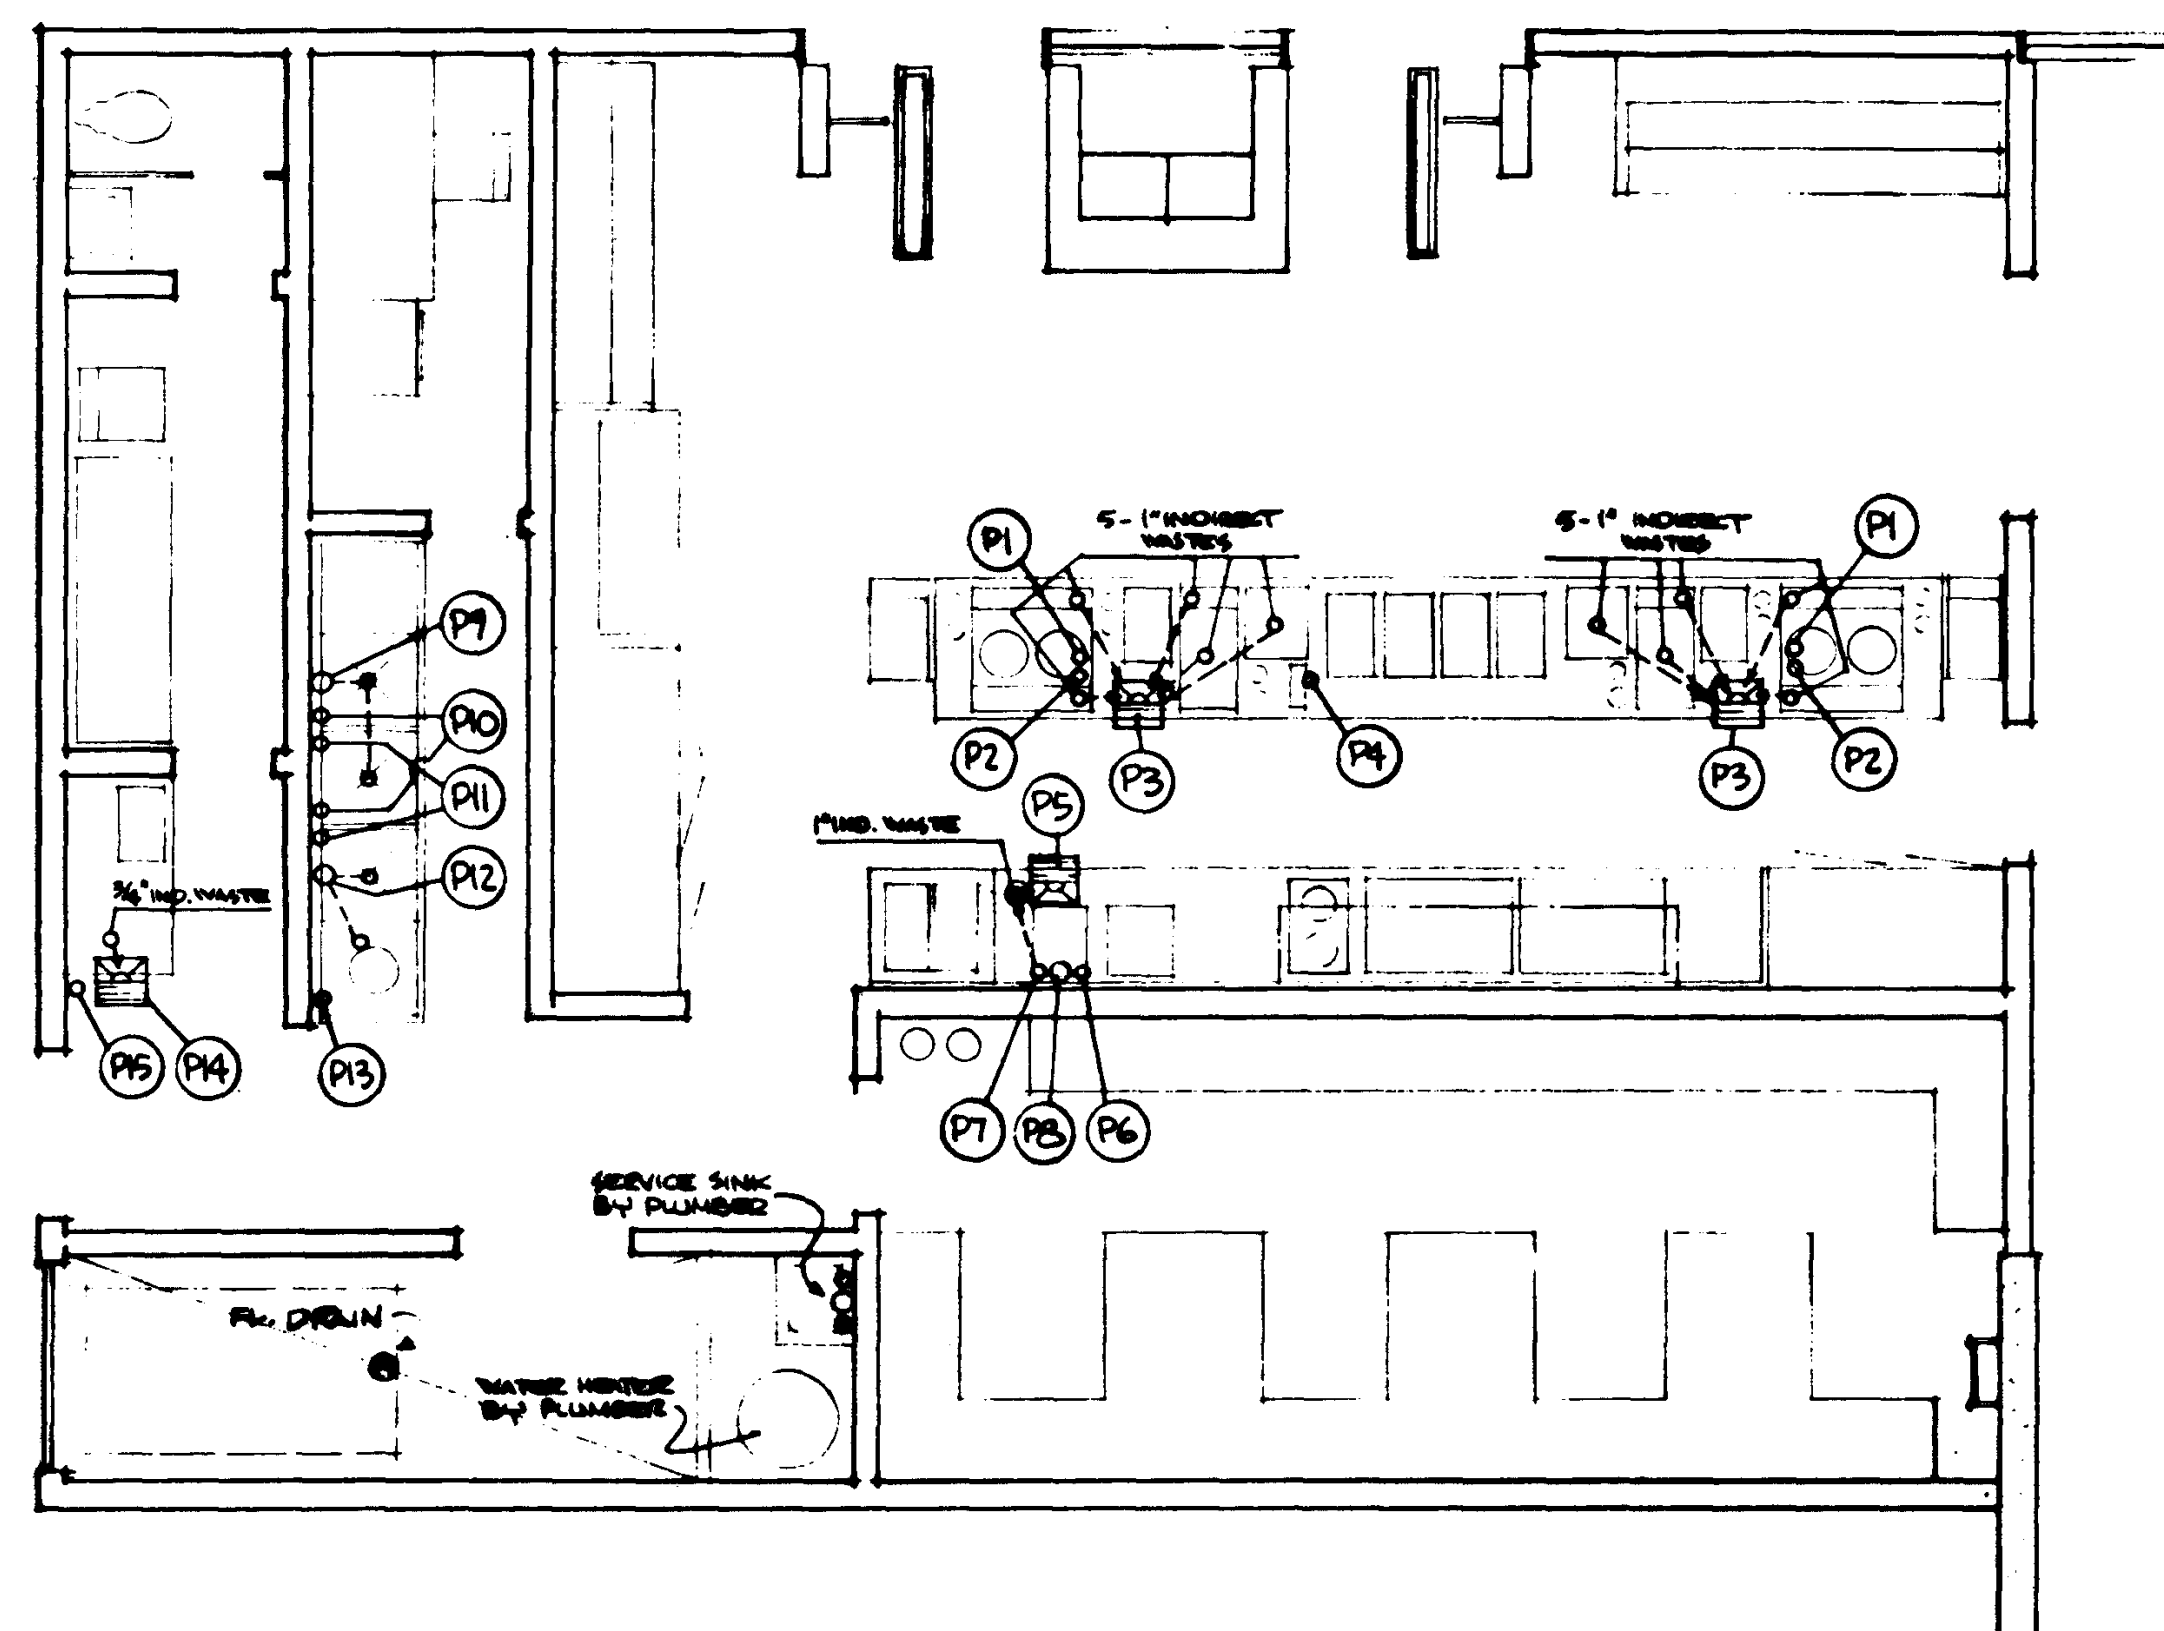PLUMBING PLANS

PLUMBING SCHEDULE						
NO.	SIZE	DESCRIPTION	LOCN.	HT.	SERVICE TO :	REMARKS
D1	3/4"	COLD	FUR.	+8"	COPPER WREN	THP. 2 PLACES
P2	1/4"	HOT	FUR.	+8"	DRINK SYSTEM SINK	THP. 2 PLACES - SEE NOTE # 4
P3		FUR. SINK		+10"	INDIRECT WASTES	THP. 2 PLACES - HALF GRATED
D4	1/4"	COLD	FUR.	+8"	TEA MAKER	SEE NOTE # 4
P5		FUR. SINK		+5"	DISMISWELL DRAIN	HALF GRATED
P6	1/2"	COLD	WALL	+18"	SINK FAUCET	10 GPH.
P7	3/4"	COLD	WALL	+18"	SINK FAUCET	TEK TO DISMISWELL
RD	2"	WASTE	WALL	+16"	SINK DRAIN	
P8	2"	WASTE	WALL	+14"	2- SINK DRAINS	
P9	1/2"	COLD	WALL	+16"	SINK FAUCET	THP. 2 PLACES
D10	1/2"	HOT	WALL	+16"	SINK FAUCET	THP. 2 PLACES - 60 GPH. TEK
D11	2"	WASTE	WALL	+14"	SINK & DISPOSER DENS.	
P12	3/4"	COLD	WALL	+18"	DISPOSER	
P13		FUR. SINK		+5"	ICE MAKER DRAIN	HALF GRATED
P14	1/4"	COLD	WALL	+15"	ICE MAKER	

PLUMBING NOTES.


1. PLUMBING CONTRACTOR SHALL INSTALL ALL INTERCONNECTING PIPING AT DISPOSER, INCLUDING SOUNDCOIL (SOUNDCOIL PUMP-UP/SEPOD).
2. PLUMBING CONTRACTOR SHALL FURNISH & INSTALL SHUT-OFF VALVES AT EACH PIECE OF EQUIPMENT.
3. DRAIN VENTS & FLUENTS ON ALL SINKS ARE FURNISHED WITH SINKS. PLUMBER SHALL INSTALL ALL DRAINS & FLUENTS, & FURNISH & INSTALL INDOOR WASTE LINES, & SINK DRAIN LINES FROM ICE BANS SHALL BE INSULATED TO PREVENT CONDENSATION.
4. PLUMBING CONTRACTOR SHALL FURNISH & INSTALL, AT EACH HOT CHOCOLATE & TEA MAKER, AN 1/2" LENGTH OF 1/2" COPPER TUBING, TERMINATING IN A 2-WAY SHUT-OFF COUPLING. PLUMBER, AS REQUIRED BY THE MANUFACTURER'S COUPLING & 3/4" ALL FITTINGS BEING TO ATTACH COUPLING TO TUBING & UNIT. INSTALL ALL COUPLING ON UNIT.
5. WATER PRESSURE SHALL NOT EXCEED 90 PSI.



DEQU II P'NIDEN'T P'PLAN

[illegible]

SCALE	$\frac{1}{4}"$
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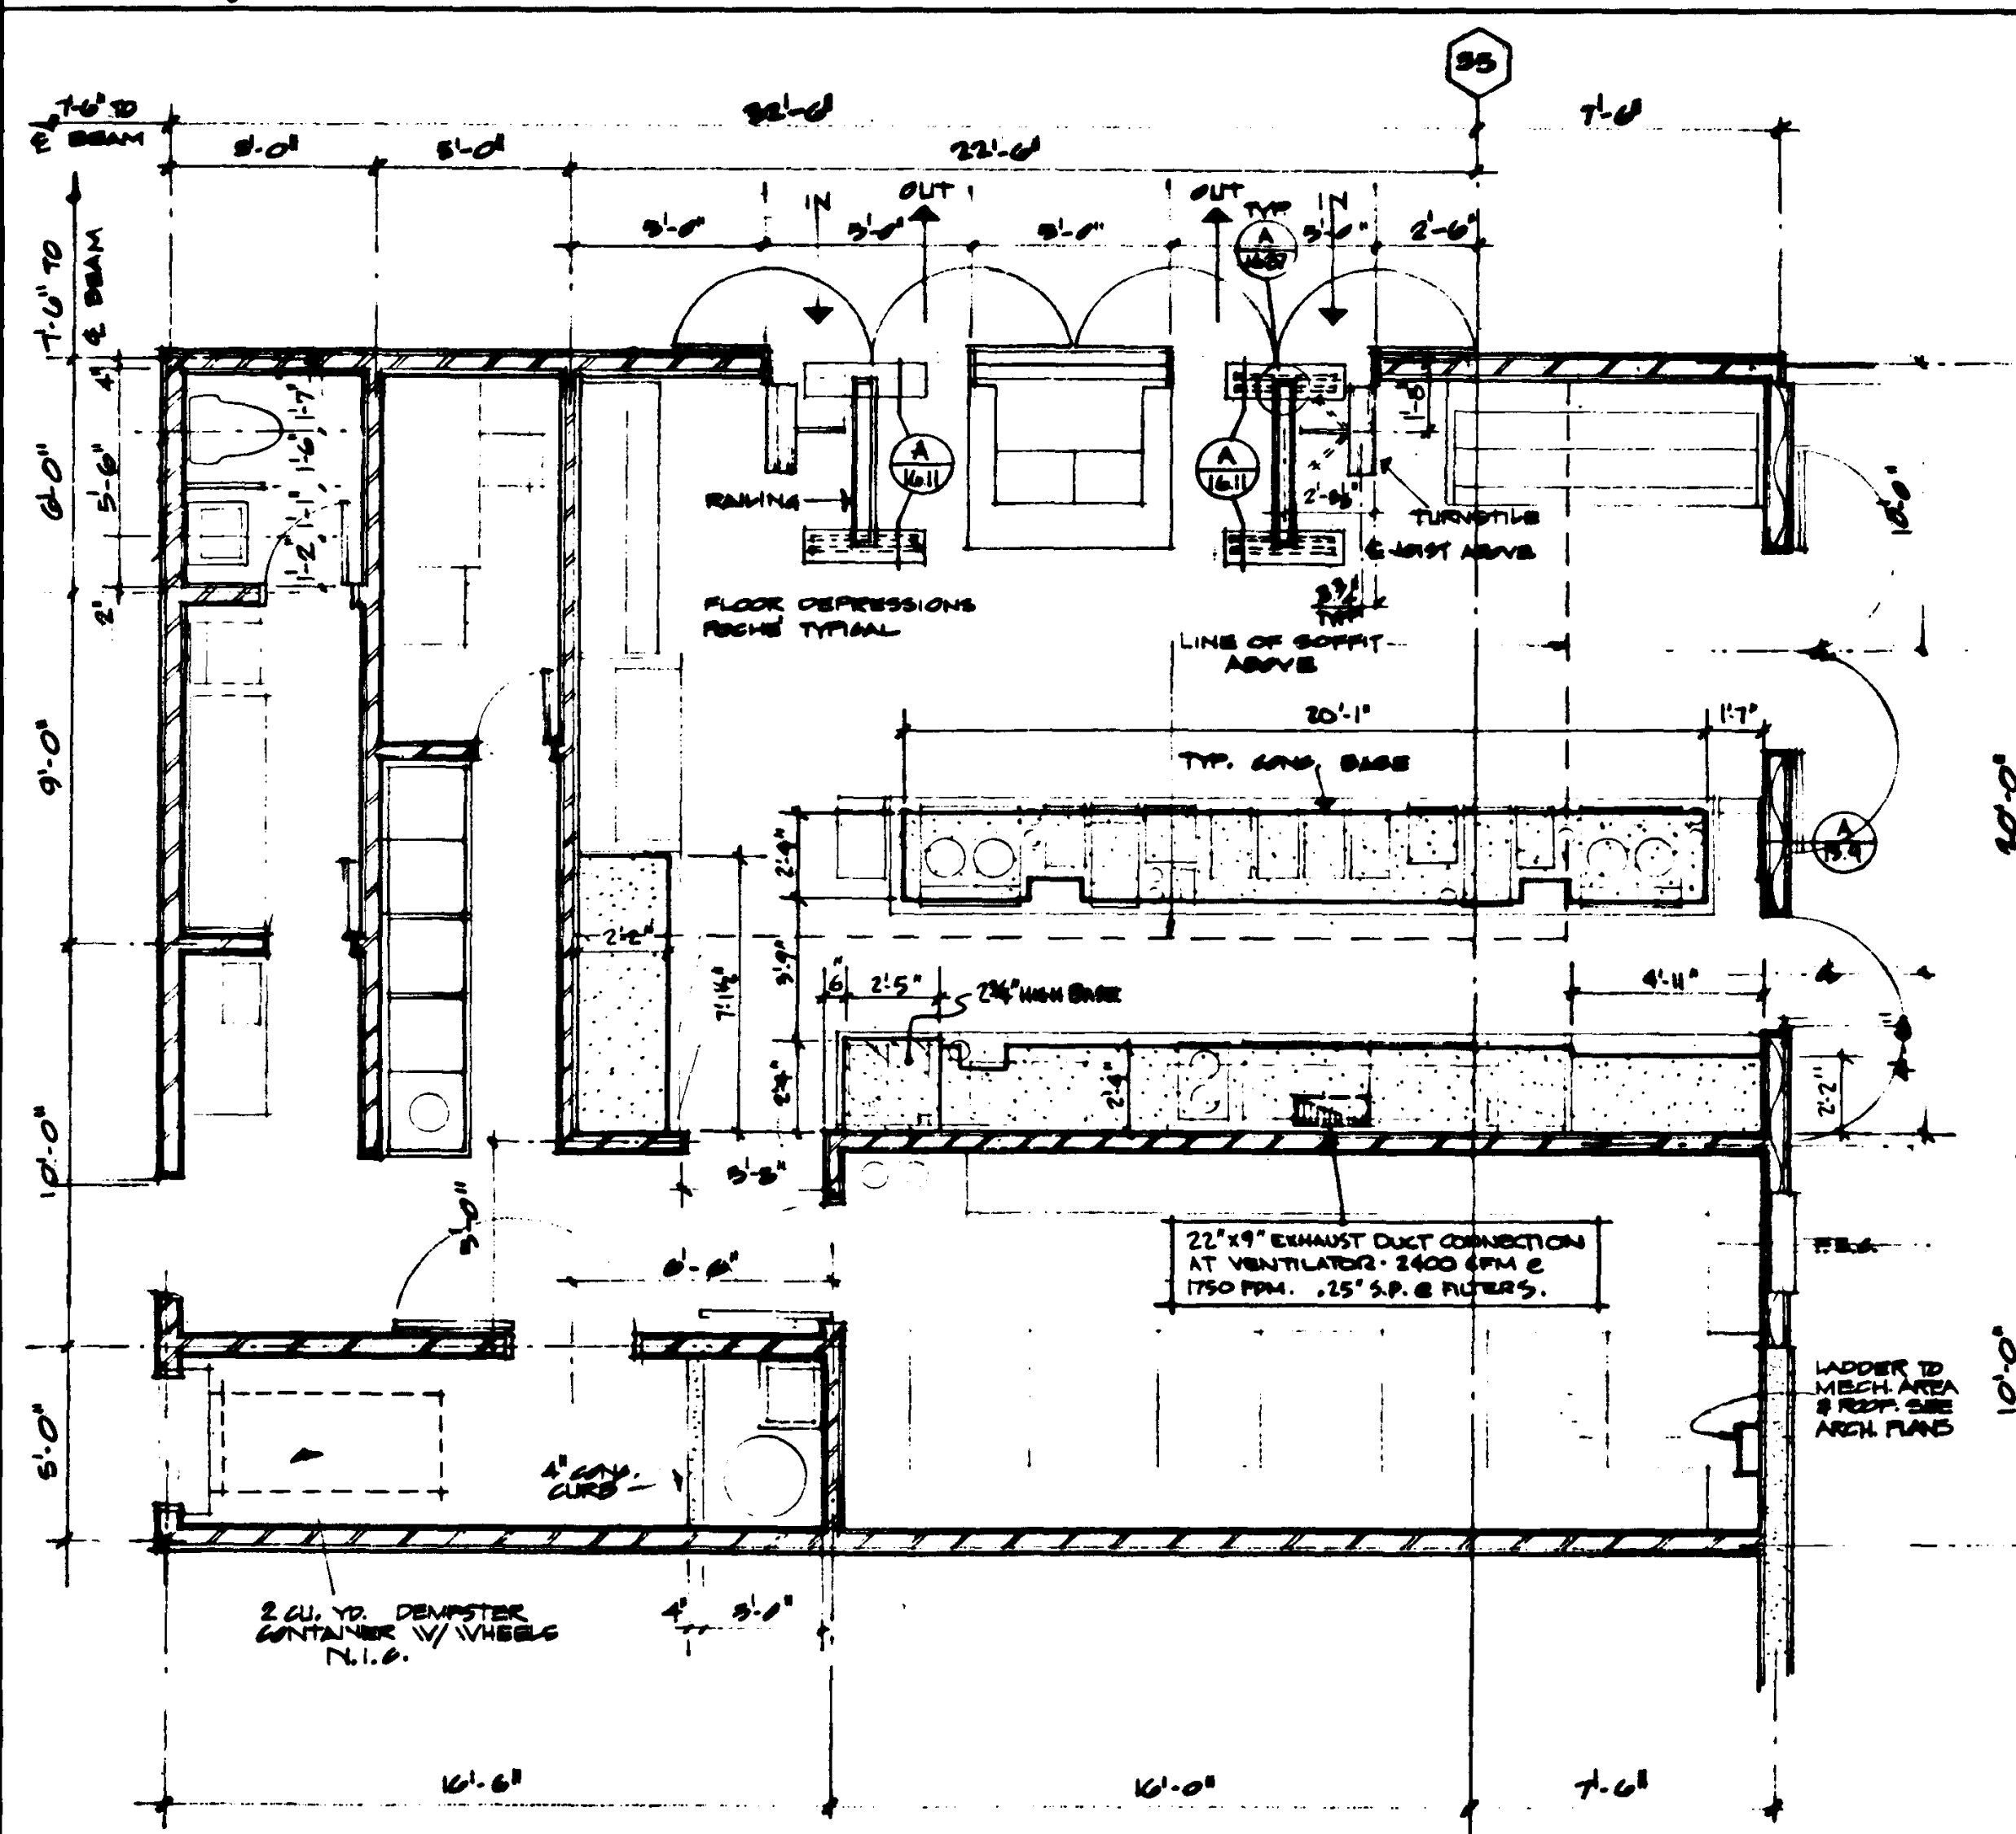


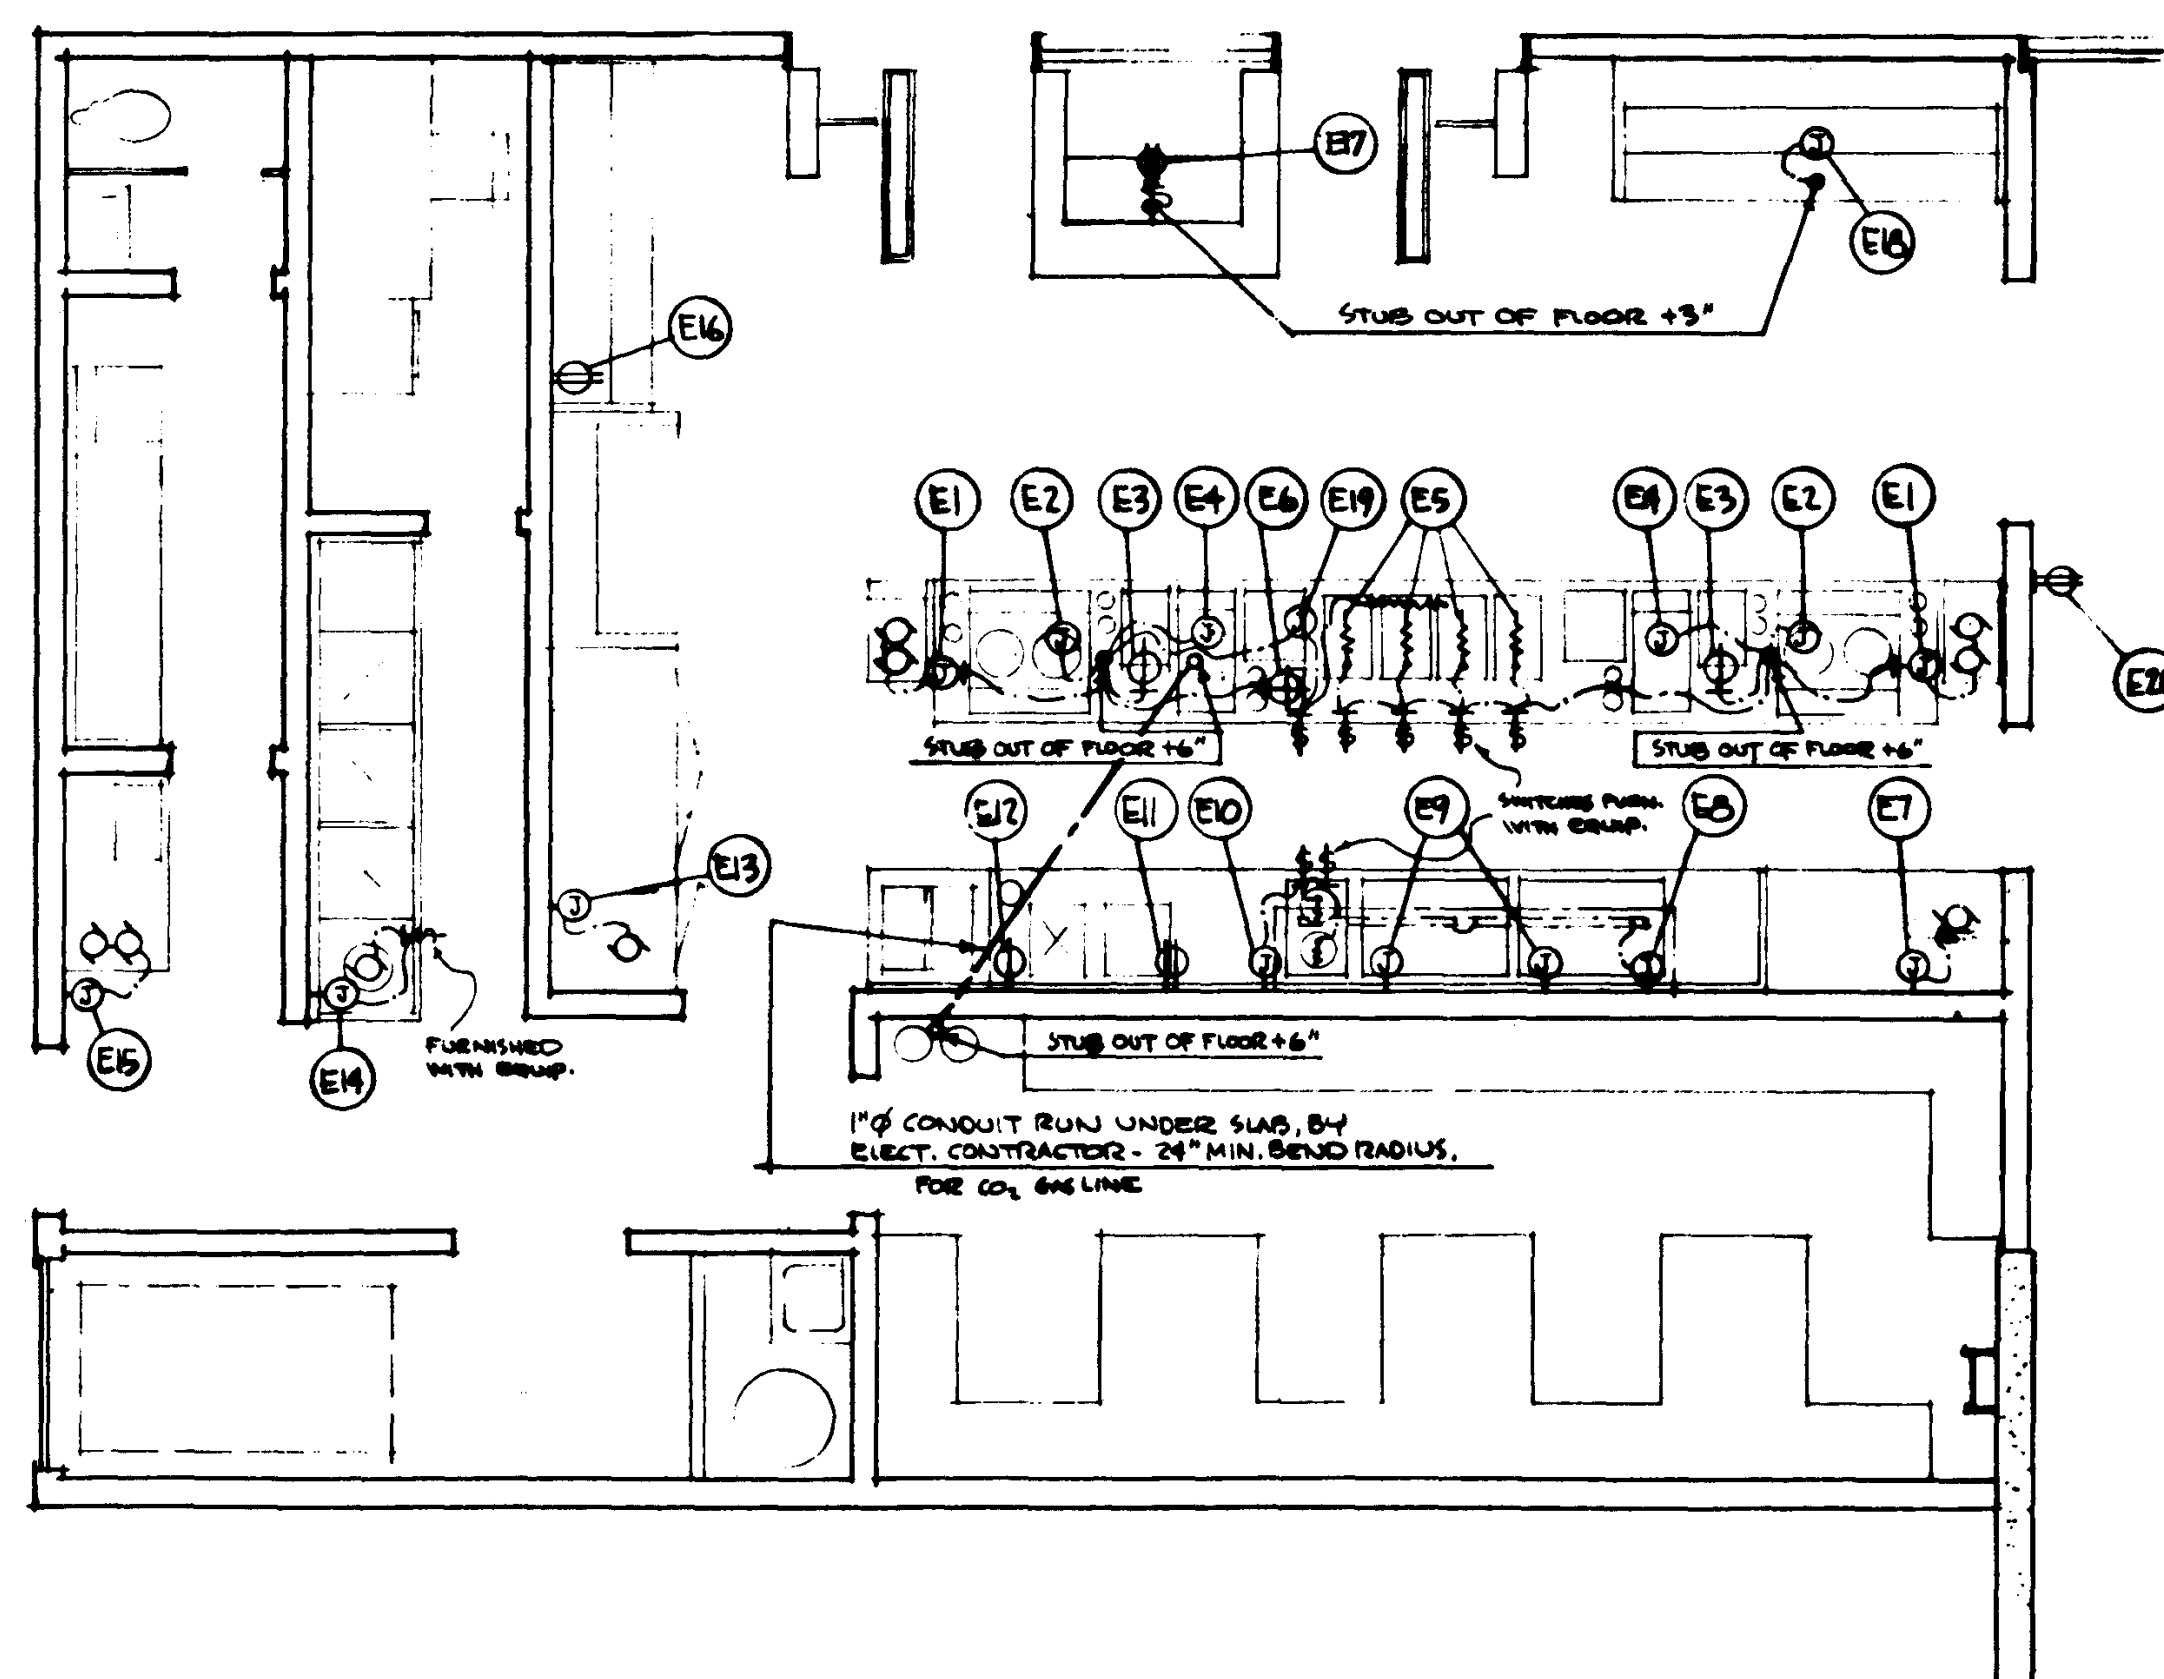DELECTORIAL PLAN


ELECTRICAL SCHEDULE								
NO.	VOLTS	Ø	DESCRIPTION	LOCN.	HT.	SERVICED TO:	ZANTING	REMARKS
E1	220V	1"	T-BOK	FITURE	112"	WATERMANGER	160 AMP.	EXTEND FROM THE LINE TYP. 8 PHASES
E2	220V	1"	T-BOK	"	"	OFFICE LIGHT	6 KW.	" "
E3	120V	1"	SINGLE REC.	"	134"	WASHING MACH.	10 KW.	" "
E4	120V	1"	T-BOK	"	124"	SCHEMATIC & LABORATORY	100 HP.	" "
E5	220V	1"	HEATER	"	124"	HOT PIPED IN	1 KW.	EXTEND FROM THE LINE TYP. 8 PHASES
E6	120V	1"	SINGLE REC.	"	134"	TEA MAKER	3 KW.	EXTEND FROM STUD
E7	120V	1"	T-BOK	WALL	476"	REFRIG.	15 KW.	"
E8	120V	1"	T-BOK	GROUND	"	HOTD LINES	1 KW.	"
E9	220V	3"	T-BOK	WALL	118"	GRIDDLE	12 KW.	"
E10	220V	1"	T-BOK	WALL	118"	HOT PLATE	5.7 KW.	"
E11	120V	1"	DUPLEX REC.	WALL	134"	COMMERCIAL	60 HP.	"
E12	120V	1"	SINGLE REC.	WALL	112"	ICE CREAM QBT.	14 KW.	"
E13	120V	1"	T-BOK	WALL	176"	REFRIG.	12 HP.	"
E14	220V	3"	T-BOK	WALL	124"	DISPOSER	1 HP.	"
E15	120V	1"	T-BOK	WALL	124"	ICE MAKER & CUBER UNIT	16 HP & 10 HP	"
E16	120V	1"	DUPLEX REC.	WALL	112"	PERMEEUSE & CUBER UNIT	16 HP & 10 HP	"
E17	120V	1"	DUPLEX REC.	FITURE	124"	CASH REC.	60 KW.	EXTEND FROM STUD
E18	120V	1"	T-BOK	FITURE	118"	REFRIG. CASE	11 KW.	EXTEND FROM STUD
E19	220V	1"	HEATER	FITURE	118"	HOTVED CASE	1 KW.	EXTEND FROM STUD
E20	120V	1"	DUPLEX REC.	WALL	130"	CAN. REAGS.	60 KW.	"

ELECTRICAL NOTES:

1. ELECTRICAL CONTRACTOR SHALL INSTALL & CONNECT ALL LOOSE SWITCHES, & WIRE DISORDER SWITCH THRU SOUNDDO AS REQ'D.
2. ELECTRICAL CONTRACTOR SHALL FURNISH & INSTALL TRANSITE OR ORANGEBURG CONDUIT UNDER S&B WHERE SHOWN, FOR CO₂ LINE.



ARCH. & VENTILATION PLAN

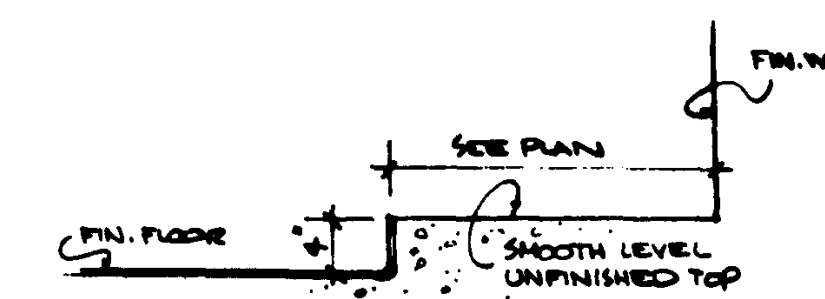

SECTION THRU TYPICAL
MASONRY BASE NO SCALE

SCALE	1/4"
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<div><div>1</div><div>2</div><div>3</div><div>4</div><div>100</div></div>	DATE	REVISIONS	STRUCTURAL ENGINEERS RANDOW & JOHNSTON J.A. MARTIN & ASSOCIATES MECHANICAL ENGINEERS RALPH E. PHILLIPS, INC. ELECTRICAL ENGINEERS RALPH E. PHILLIPS, INC. CIVIL ENGINEERS G. SHUERMAN & ASSOCIATES MOFFATT, HUNTER	DESIGNED DRAWN BY CHECKED BY	ARCHITECT ENGINEER COLLEGE	APPROVED APPROVED STATE FIRE MARSHAL STATE OF CALIFORNIA DATE 1955 BY
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ASSOCIATED ARCHITECTS:
WILLIAM L. PEREIRA & ASSOCIATES
A. GUINCY JONES · FREDERICK R. HEMMONS & ASSOCIATES
BLUROCK ELLERBROOK & ASSOCIATES




URBANUS SQUARE • MACARTHUR BOULEVARD AT FORD ROAD
TELEPHONE 714/675-2640 • CORONA DEL MAR, CALIFORNIA

GOLDEN WEST COLLEGE
HUNTINGTON BEACH, CALIFORNIA
ORANGE COAST JUNIOR COLLEGE DISTRICT

AUBREY DEVINE, JR. AND ASSOCIATES
FOOD SERVICE PLANNING • DESIGNING • ENGINEERING


IN T'CHU. DEQUU H H
PLANS

JOB NO.	100-1
DATE	15 JUN 1964
SHEET, NO.	IIK II.1

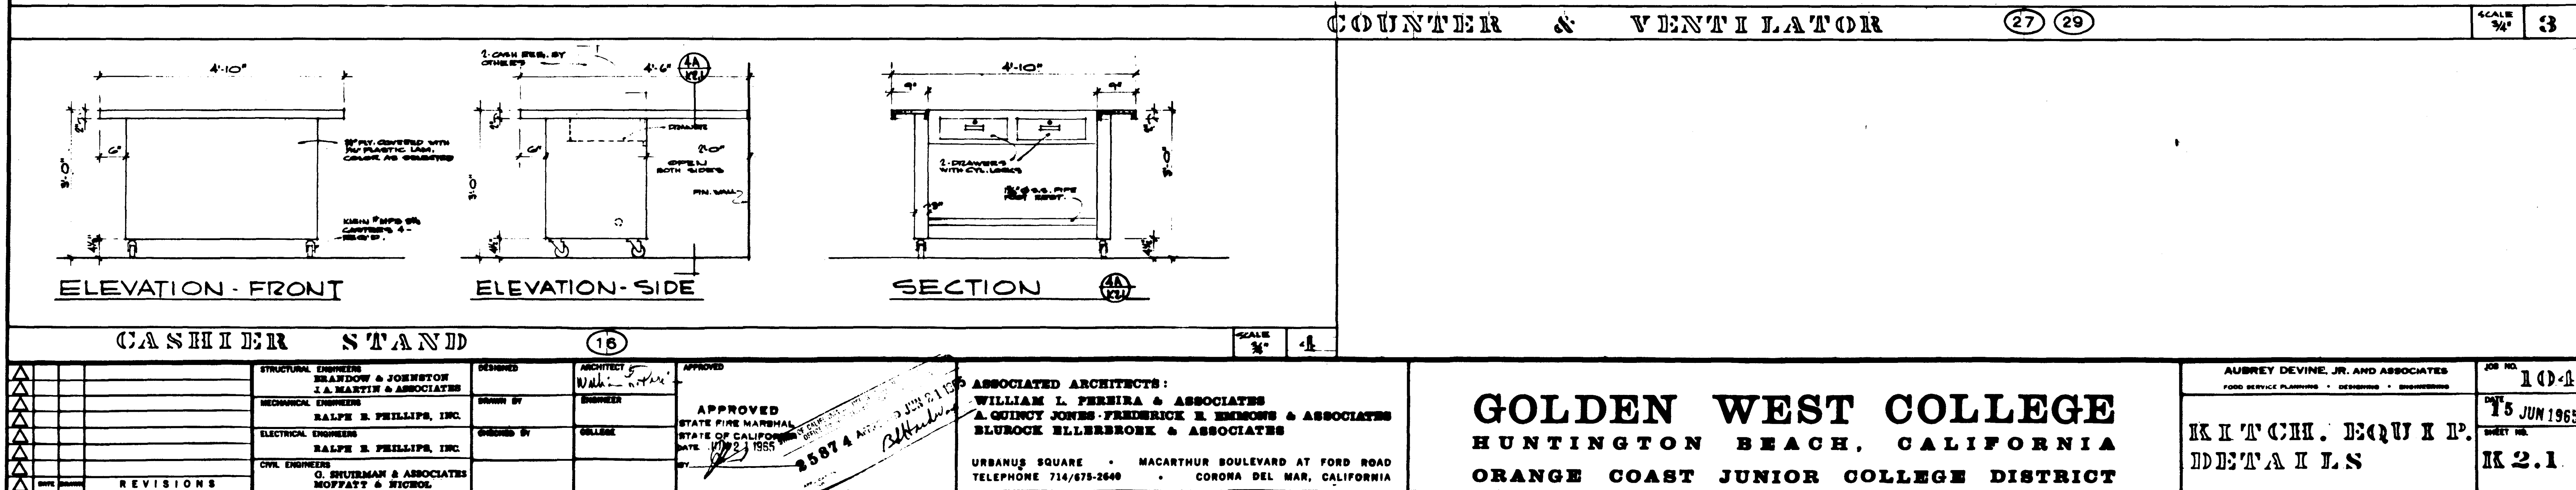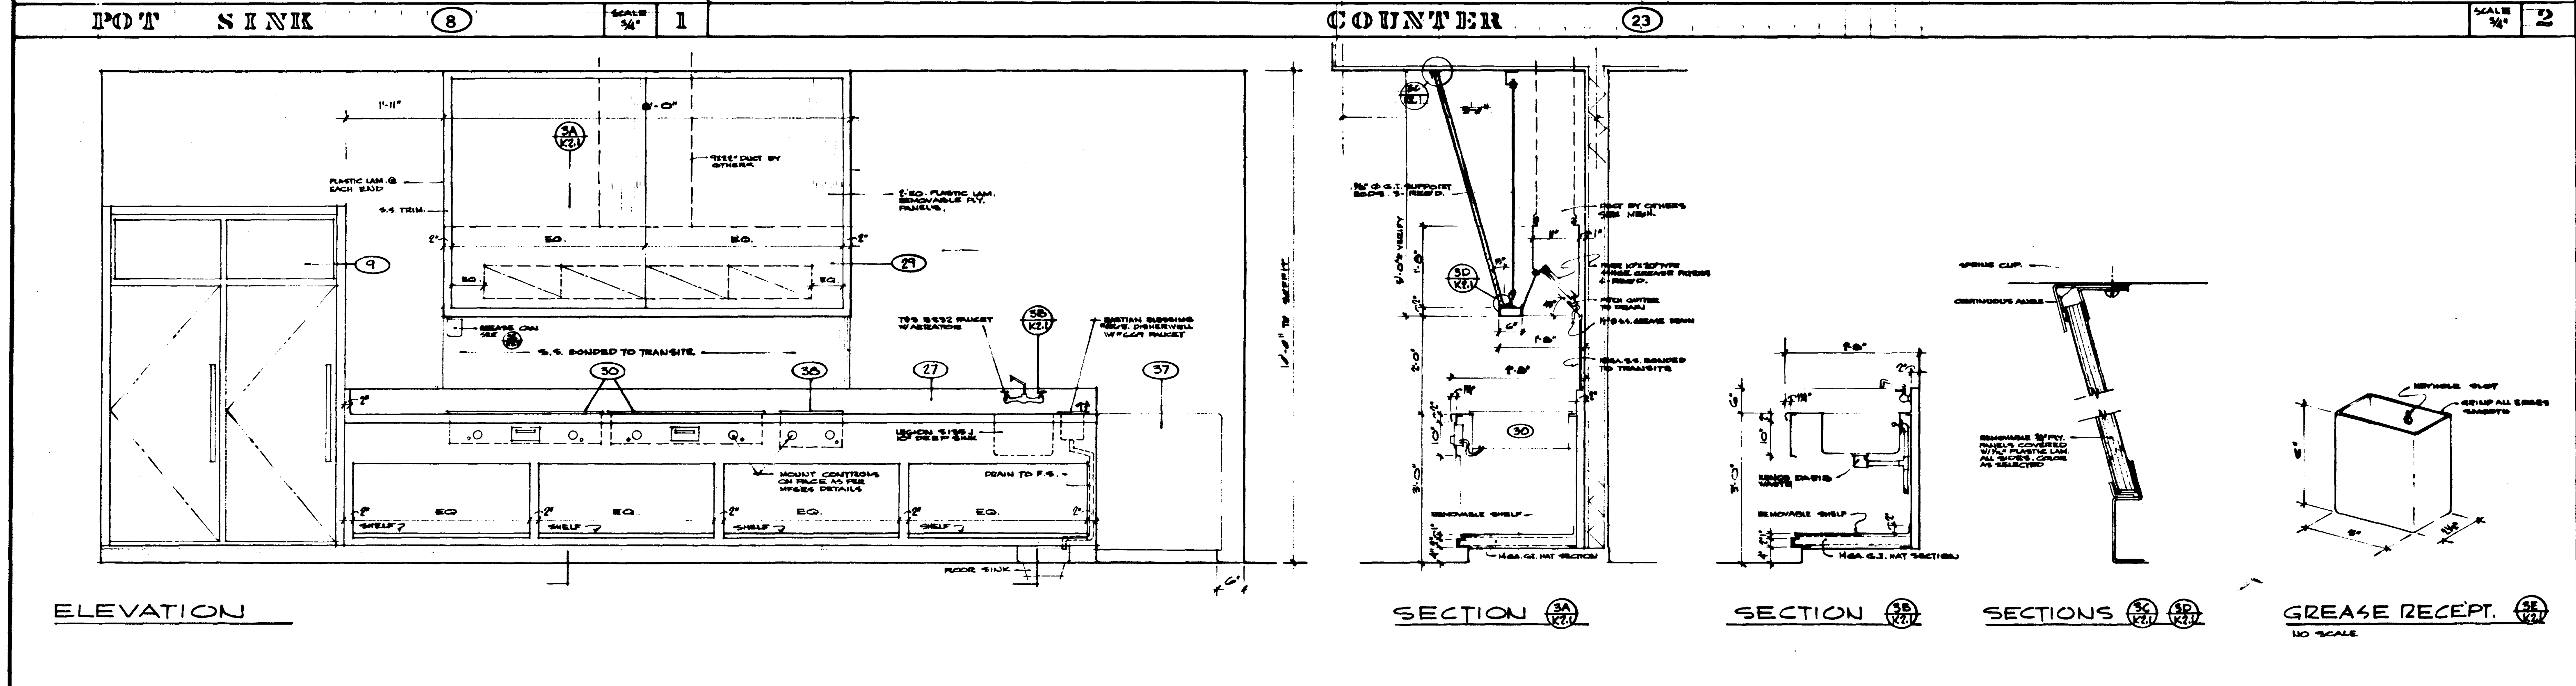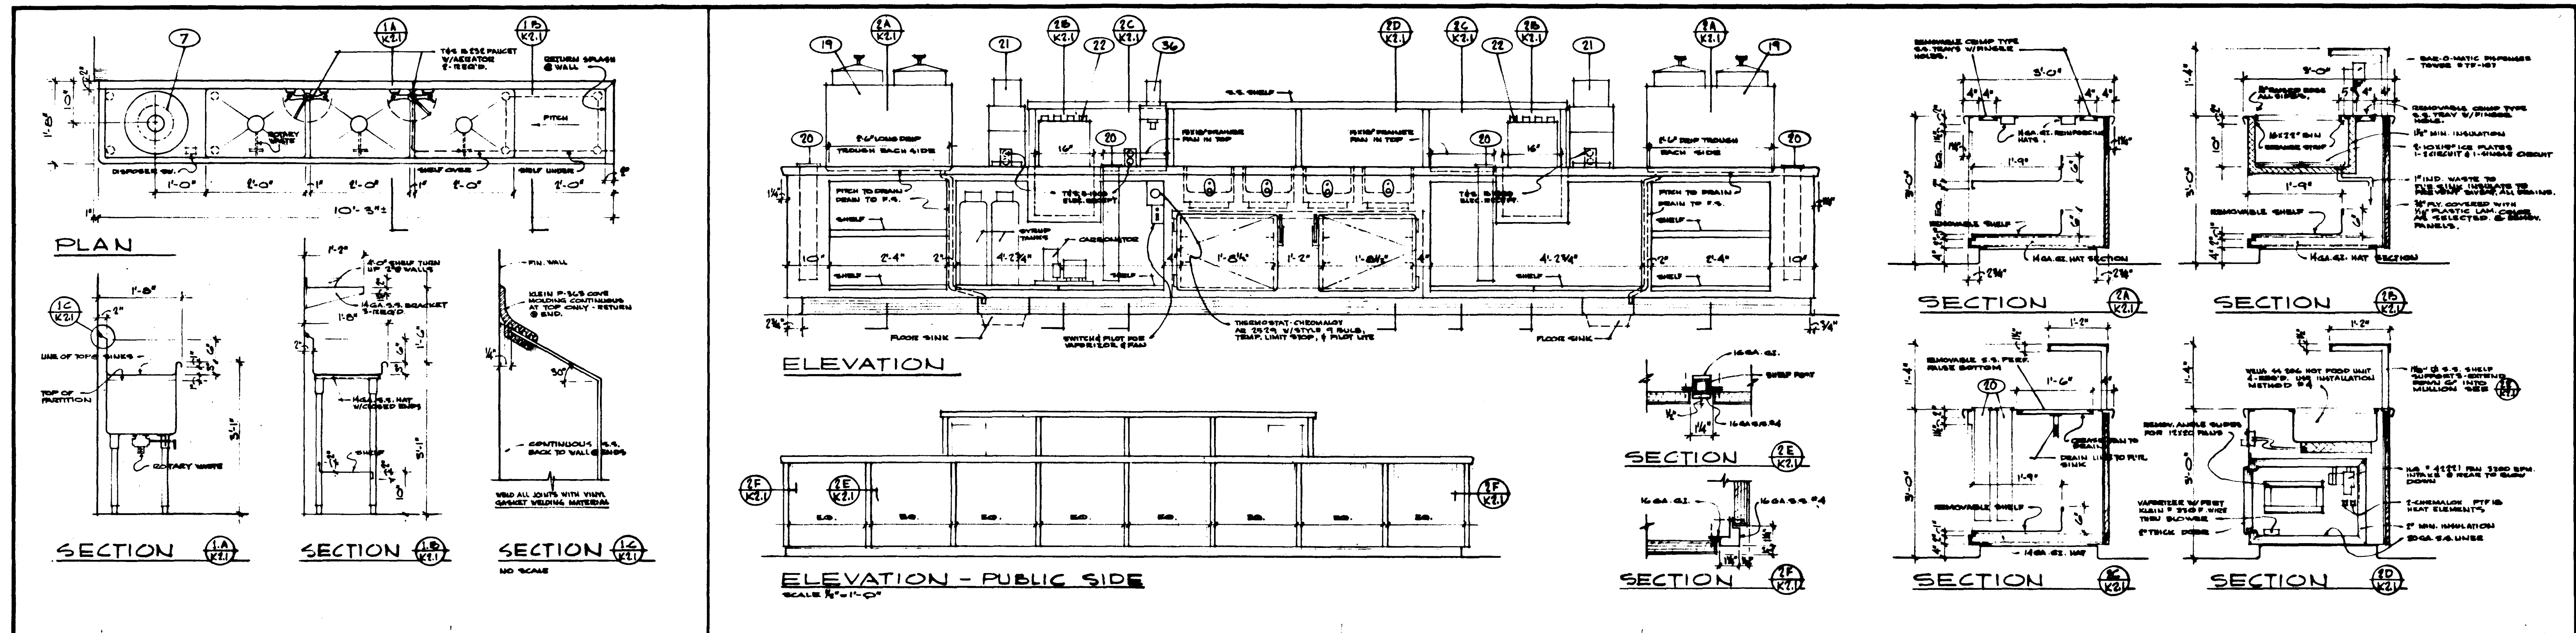

GENERAL NOTES

1. BEARINGS AND GRID LINES SHOWN HEREON ARE BASED ON THE CENTER LINE OF GOLDENWEST ST. HAVING A BEARING NORTH.
2. THE FOLLOWING WORK IS NOT IN THE CONTRACT AND SHALL BE CON-
STRUCTED UNDER AGREEMENT
DISTRICT NO. 6401. PLANS FOR
THIS WORK HAVE BEEN PREPARED
BY THE CITY OF HUNTINGTON BEACH.
(A) STREET IMPROVEMENT WORK
ON MC FADDEN AVE., GOLDENWEST
ST., EDINGER AVE. AND GOTHARD ST.
(B) MAIN LINE STORM DRAIN THRU
THE SITE AS INDICATED HEREON.
(C) SEWER EXTENSION ALONG
GOLDENWEST ST. TO THE SCHOOL
PROPERTY LINE AS INDICATED HEREON.
3. ROUGH GRADING OF SITE HAS
BEEN DONE UNDER SEPARATE
CONTRACT. SURVEY WILL BE
ISSUED CONFIRMING EXACT ELEV-
ATIONS AND CONFIGURATION BY
GRADING CONTRACTORS.

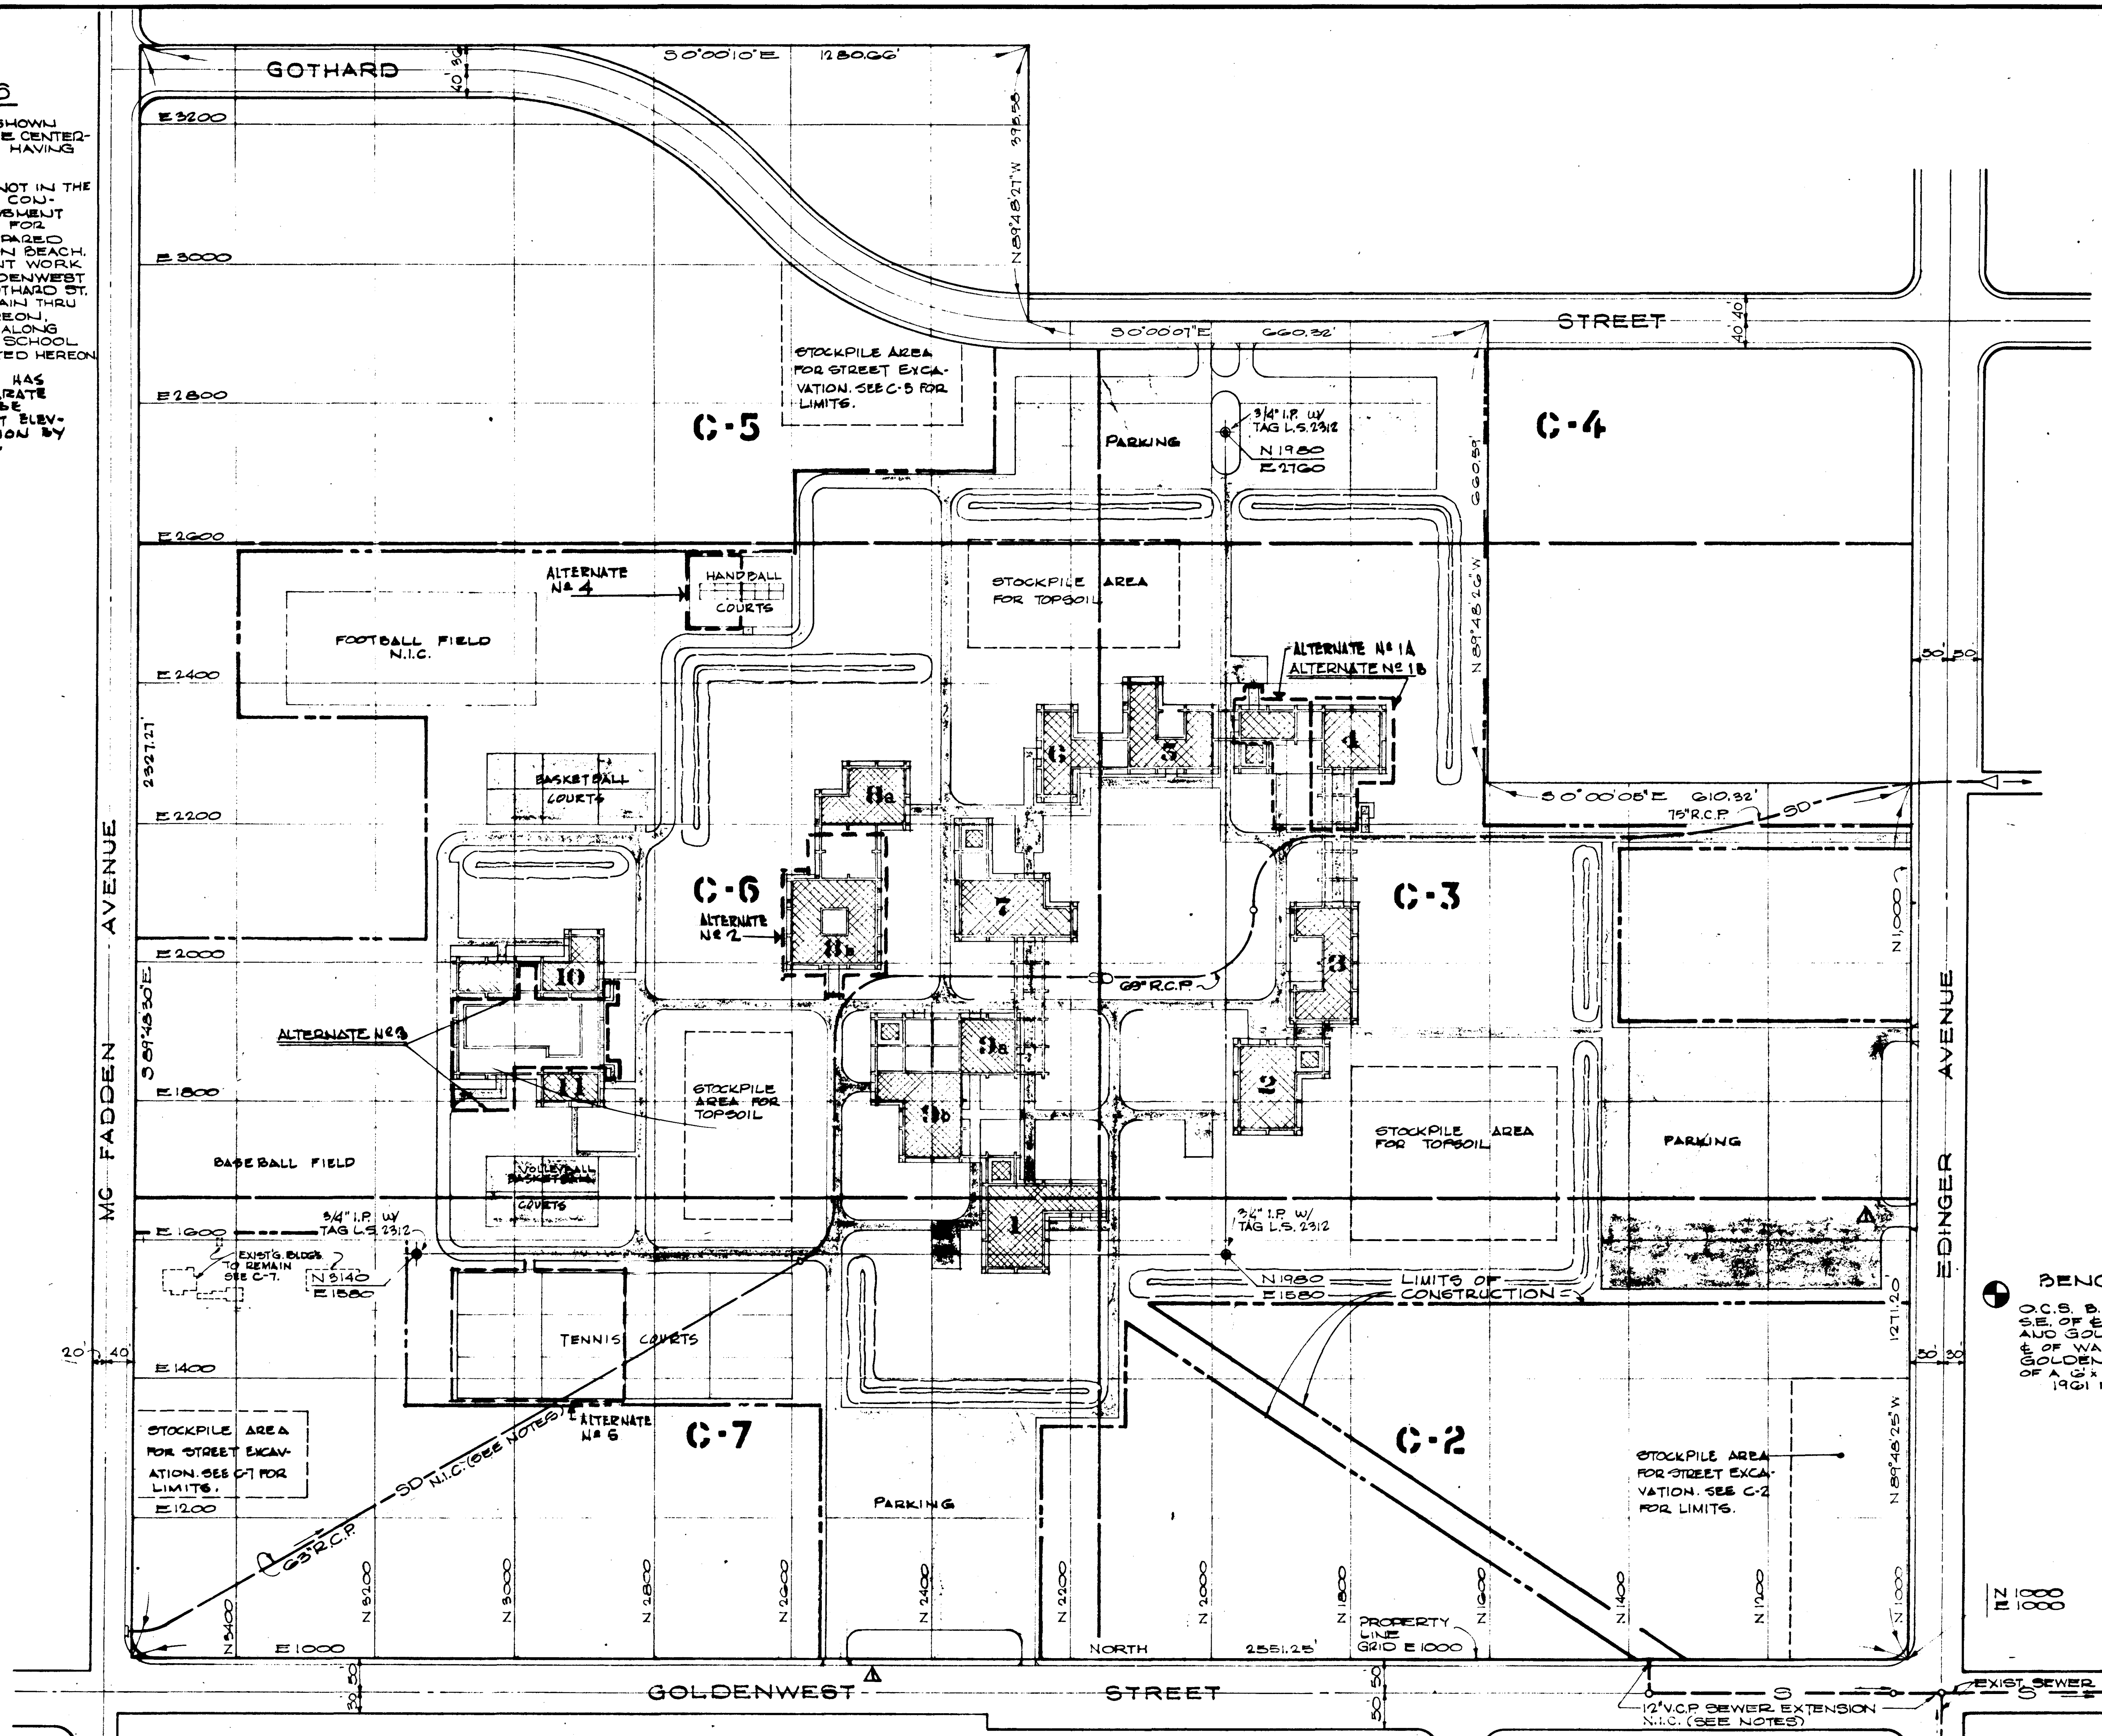

DATE	BY	REVISIONS


STRUCTURAL ENGINEERS BRADY & JOHNSON J.A. MARTIN & ASSOCIATES	DESIGNED J.H.	ARCHITECT WILLIAM L. PEREIRA	APPROVED STATE OF CALIFORNIA DATE JUN 2 1963
MECHANICAL ENGINEERS RALPH E. PHILLIPS, INC.	DRAWN BY J.H.	ENGINEER WILLIAM L. PEREIRA	
ELECTRICAL ENGINEERS RALPH E. PHILLIPS, INC.	CHECKED BY P.A.	COLLEGE	
CIVIL ENGINEERS O. SHUIMAN & ASSOCIATES MOFFATT & NICOL			

APPROVED STATE OF CALIFORNIA DATE JUN 2 1963	25874 APPROVED JUN 2 1963
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ASSOCIATED ARCHITECTS: WILLIAM L. PEREIRA & ASSOCIATES A. QUINCY JONES-FREDERICK E. EMMONS & ASSOCIATES BLUROCK ELLERBROCK & ASSOCIATES	URBANUS SQUARE • MACARTHUR BOULEVARD AT FORD ROAD TELEPHONE 714/675-2640 • CORONA DEL MAR, CALIFORNIA
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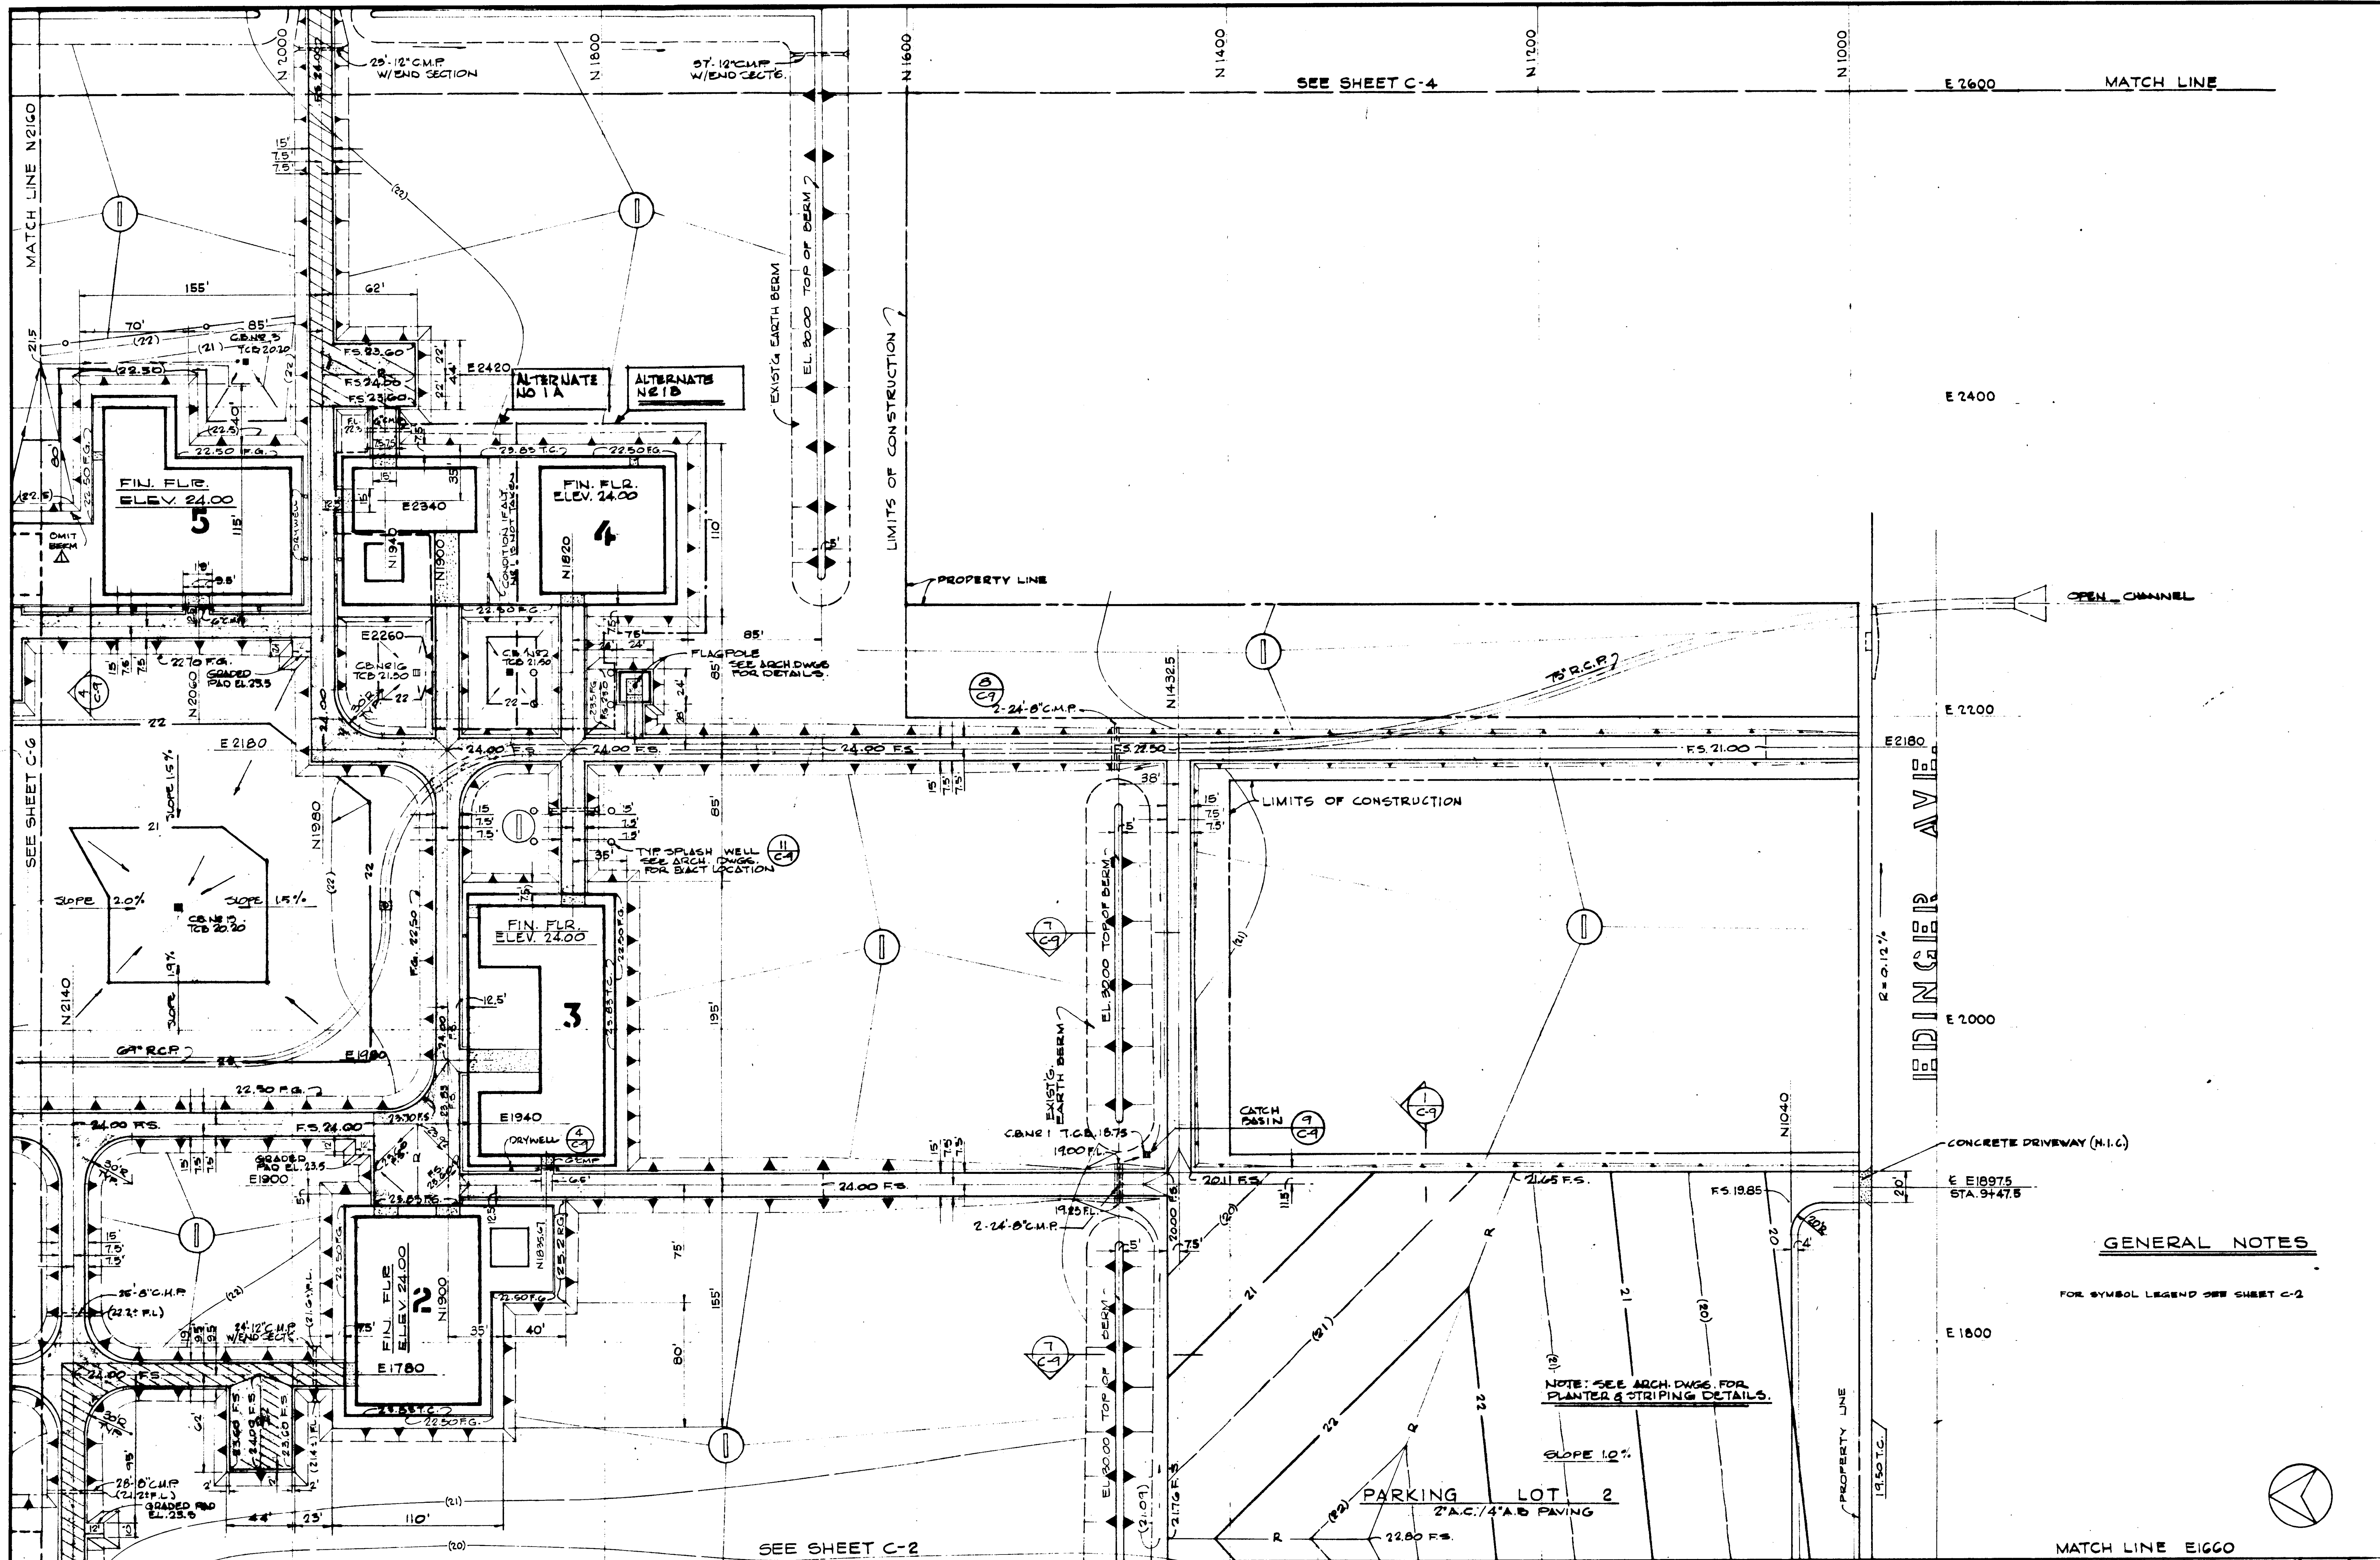
GOLDEN WEST COLLEGE
HUNTINGTON BEACH, CALIFORNIA
ORANGE COAST JUNIOR COLLEGE DISTRICT

KEY MAP	JOB NO. 104
GRADING PLANS	DATE 6-15-65
	SHEET NO. C-1



- LEGEND**
- (21) EXISTING CONTOUR LINE
 - NEW SANITARY SEWER
 - NEW STORM DRAIN
 - FINISH GRADE CONTOUR LINE
 - TOP EMBANKMENT
 - R RIDGE LINE
 - ASPHALTIC CONCRETE PAVING
 - CEMENT CONCRETE PAVING
 - FS FINISH SURFACE
 - R.G. ROUGH GRADE
 - ASPHALTIC CONCRETE PAVING, HEAVY DUTY, ROADS
 - INDICATES AREA WHERE NO GRADING IS PERFORMED.
 - 3 BUILDING LINE & NUMBER
 - FG. FINISH GRADE
 - T.C. TOP OF CURB
 - A.B. AGGREGATE BASE
 - C.M.P. CORRUGATED METAL PIPE
 - R.C.P. REINFORCED CONCRETE PIPE
 - A.C.P. ASBESTOS CEMENT PIPE
 - C.P. CONCRETE PIPE
 - V.C.P. VITRIFIED CLAY PIPE
 - T.C.B. TOP OF CATCH BASIN

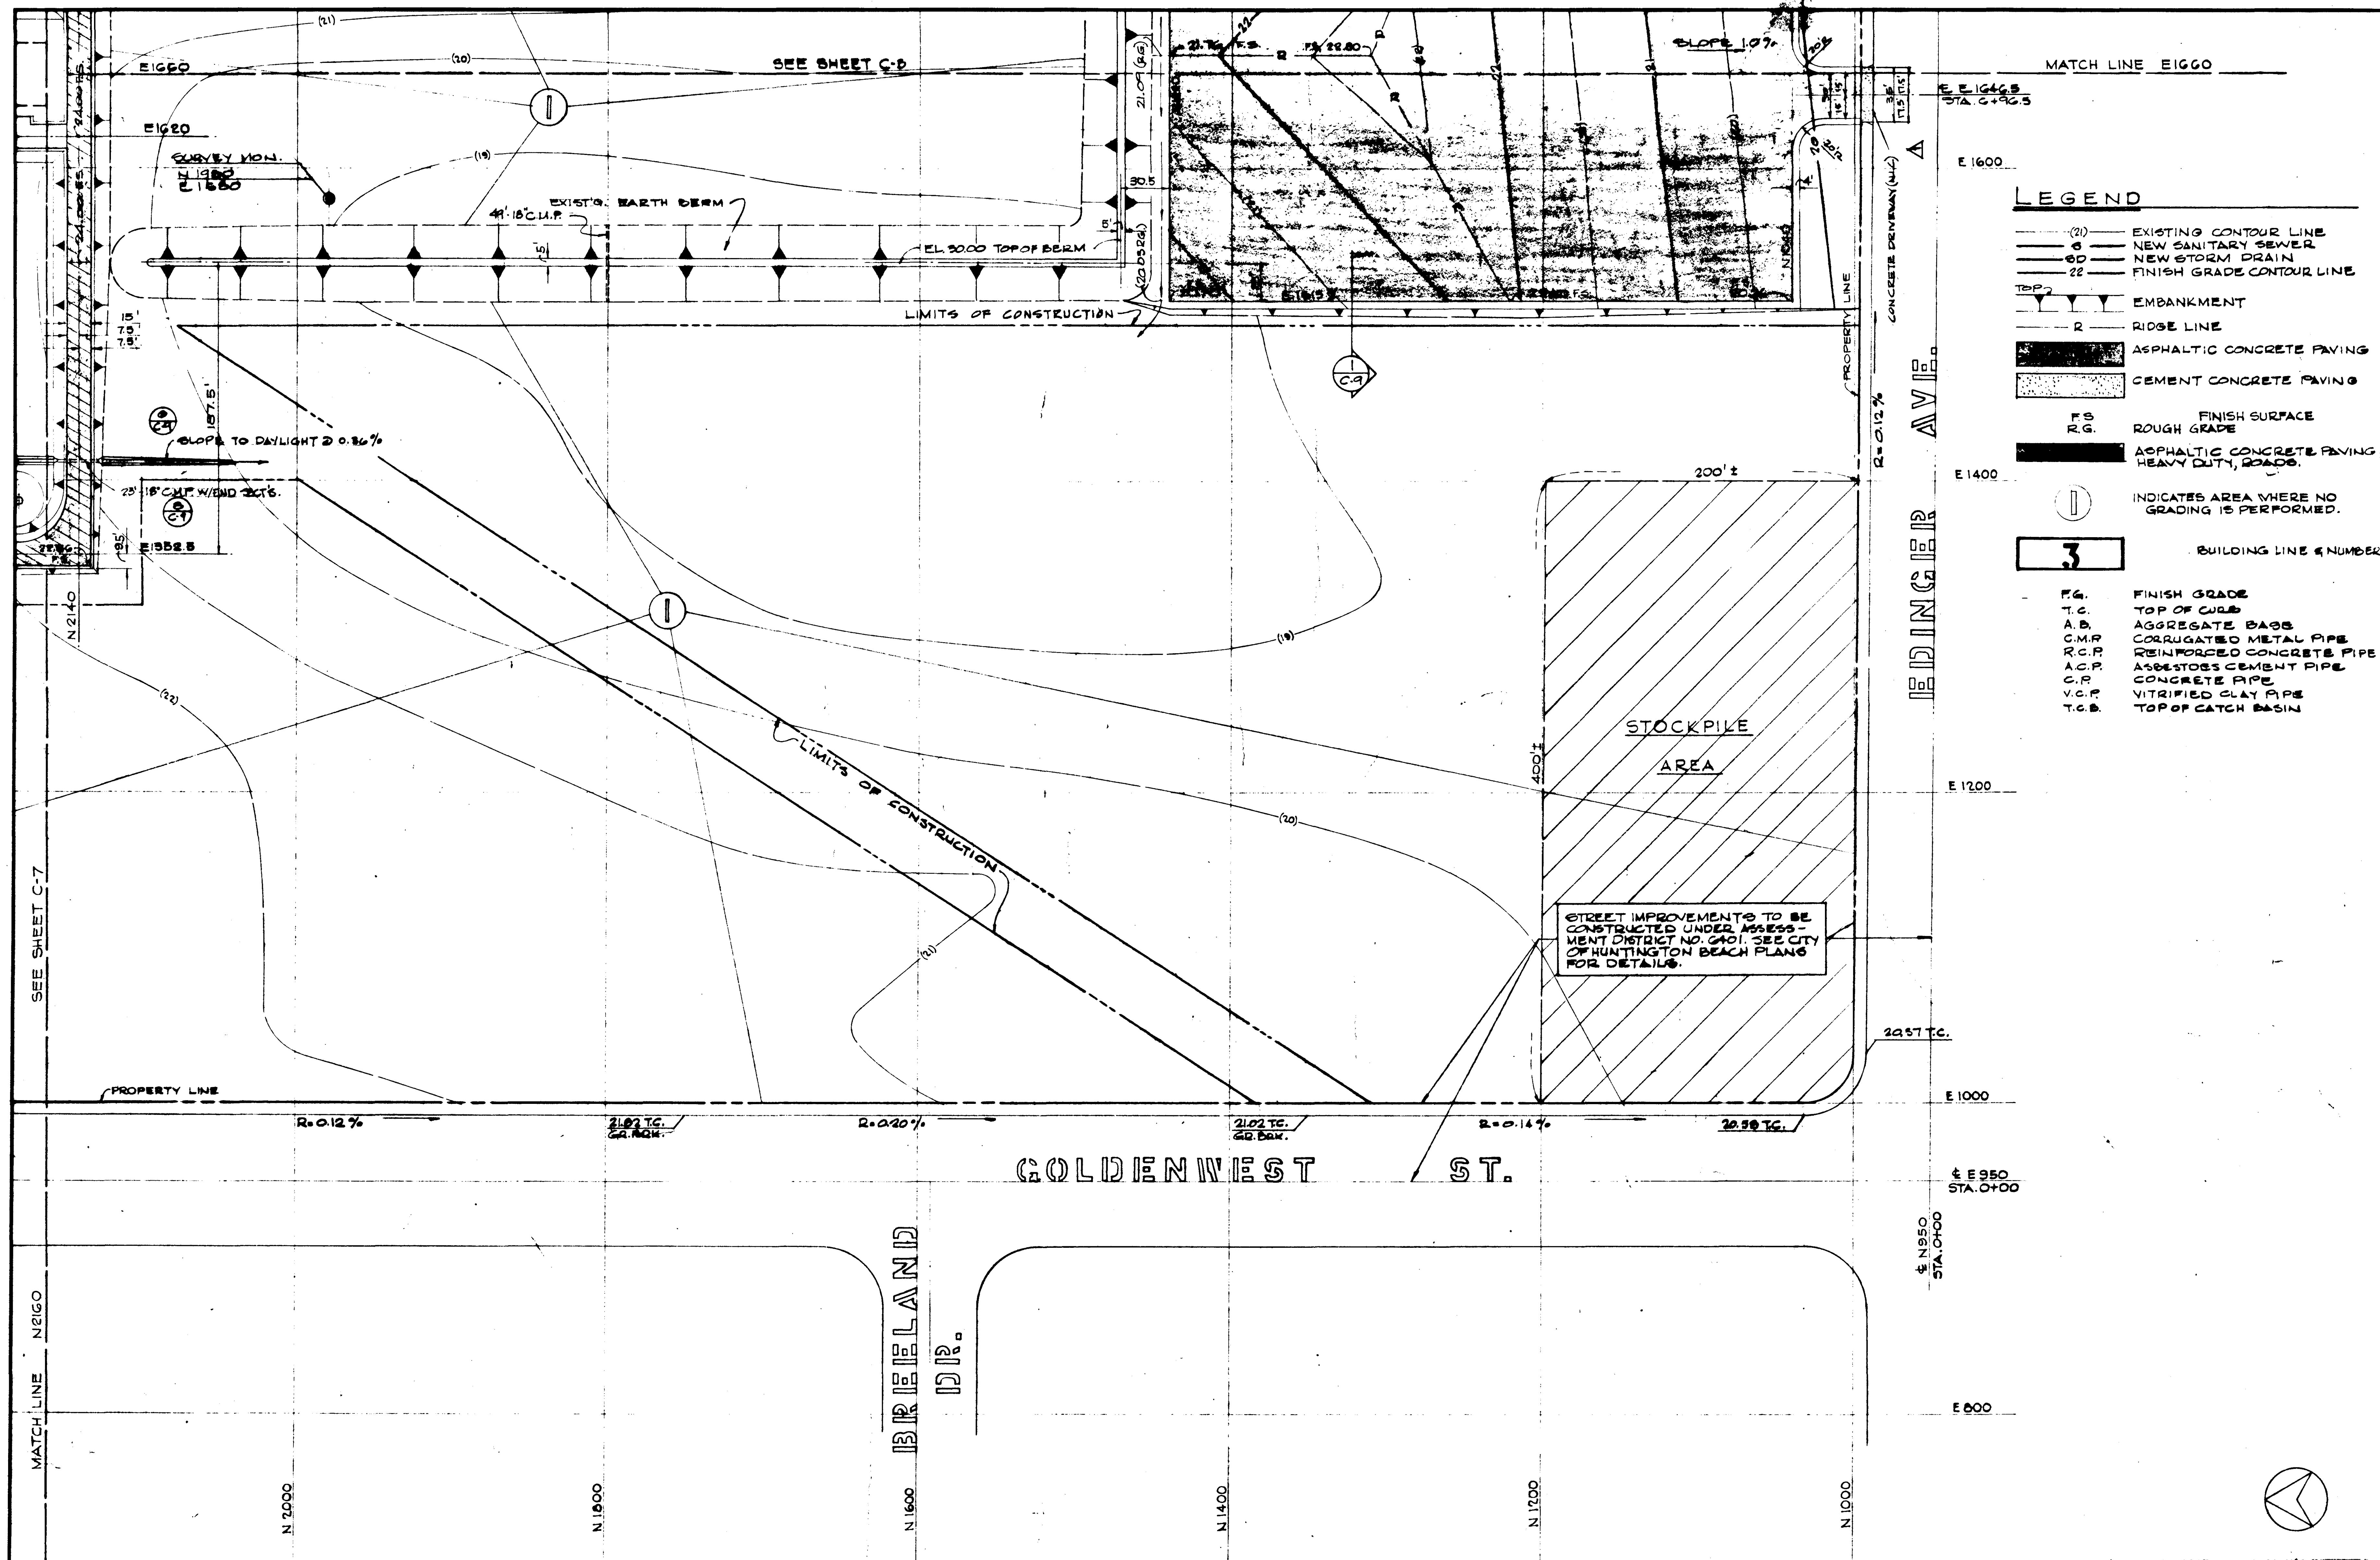REVISIONS DATE DRAWN DATE CHECKED DATE APPROVED		STRUCTURAL ENGINEERS BRANDON & JOHNSON J.A. MARTIN & ASSOCIATES MECHANICAL ENGINEERS RALPH E. PHILLIPS, INC. ELECTRICAL ENGINEERS RALPH E. PHILLIPS, INC. CIVIL ENGINEERS SHUTMAN & ASSOCIATES MOFFATT & NICHOL		DESIGNED PA DRAWN BY J.R. CHECKED BY J.H.		ARCHITECT WILLIAM L. FERRERA & ASSOCIATES ENGINEER WILLIAM L. FERRERA & ASSOCIATES A. QUINCY JONES, FREDERICK E. HEMMONS & ASSOCIATES BLURCK ELLERBROOK & ASSOCIATES		APPROVED STATE FIRE MARSHAL STATE OF CALIFORNIA DATE JUN 21 1965 25874 APPROVED JUN 21 1965		GOLDEN WEST COLLEGE HUNTINGTON BEACH, CALIFORNIA ORANGE COAST JUNIOR COLLEGE DISTRICT		AREA 2 GRADING PLANS		JOB NO. 104 DATE 6-15-65 SHEET NO. C-2	
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GENERAL NOTES

FOR SYMBOL LEGEND SEE SHEET C-2

NOTE: SEE ARCH. DWG. FOR PLANTING & STRIPING DETAILS.

SLOPE 1.0%

PARKING LOT 2
2' AC/4' AB PAVING

MATCH LINE E1600

NO.	DATE	REVISIONS
1	6-15-65	AS SHOWN


STRUCTURAL ENGINEERS BRANDON & JOHNSON J.A. MARTIN & ASSOCIATES	DESIGNED P.A.	APPROVED WILLIAM L. PEREIRA
MECHANICAL ENGINEERS RALPH E. PHILLIPS, INC.	DRAWN BY J.R.	ENGINEER WILLIAM L. PEREIRA
ELECTRICAL ENGINEERS RALPH E. PHILLIPS, INC.	CHECKED BY J.A.H.	COLLEGE
CIVIL ENGINEERS O. SHURMAN & ASSOCIATES MOTTATT & NICOL		

APPROVED STATE OF CALIFORNIA DATE JUN 21 1965 25874 APPROVED JUN 21 1965

ASSOCIATED ARCHITECTS: WILLIAM L. PEREIRA & ASSOCIATES A. QUINCY JONES-FREDERICK E. EMMONS & ASSOCIATES BLUROCK ELLERBROOK & ASSOCIATES
URBANUS SQUARE • MACARTHUR BOULEVARD AT FORD ROAD TELEPHONE 714/675-2640 • CORONA DEL MAR, CALIFORNIA

GOLDEN WEST COLLEGE
HUNTINGTON BEACH, CALIFORNIA
ORANGE COAST JUNIOR COLLEGE DISTRICT


AREA 3	JOB NO. 104
GRADING PLANS	DATE 6-15-65
	SHEET NO. C-3

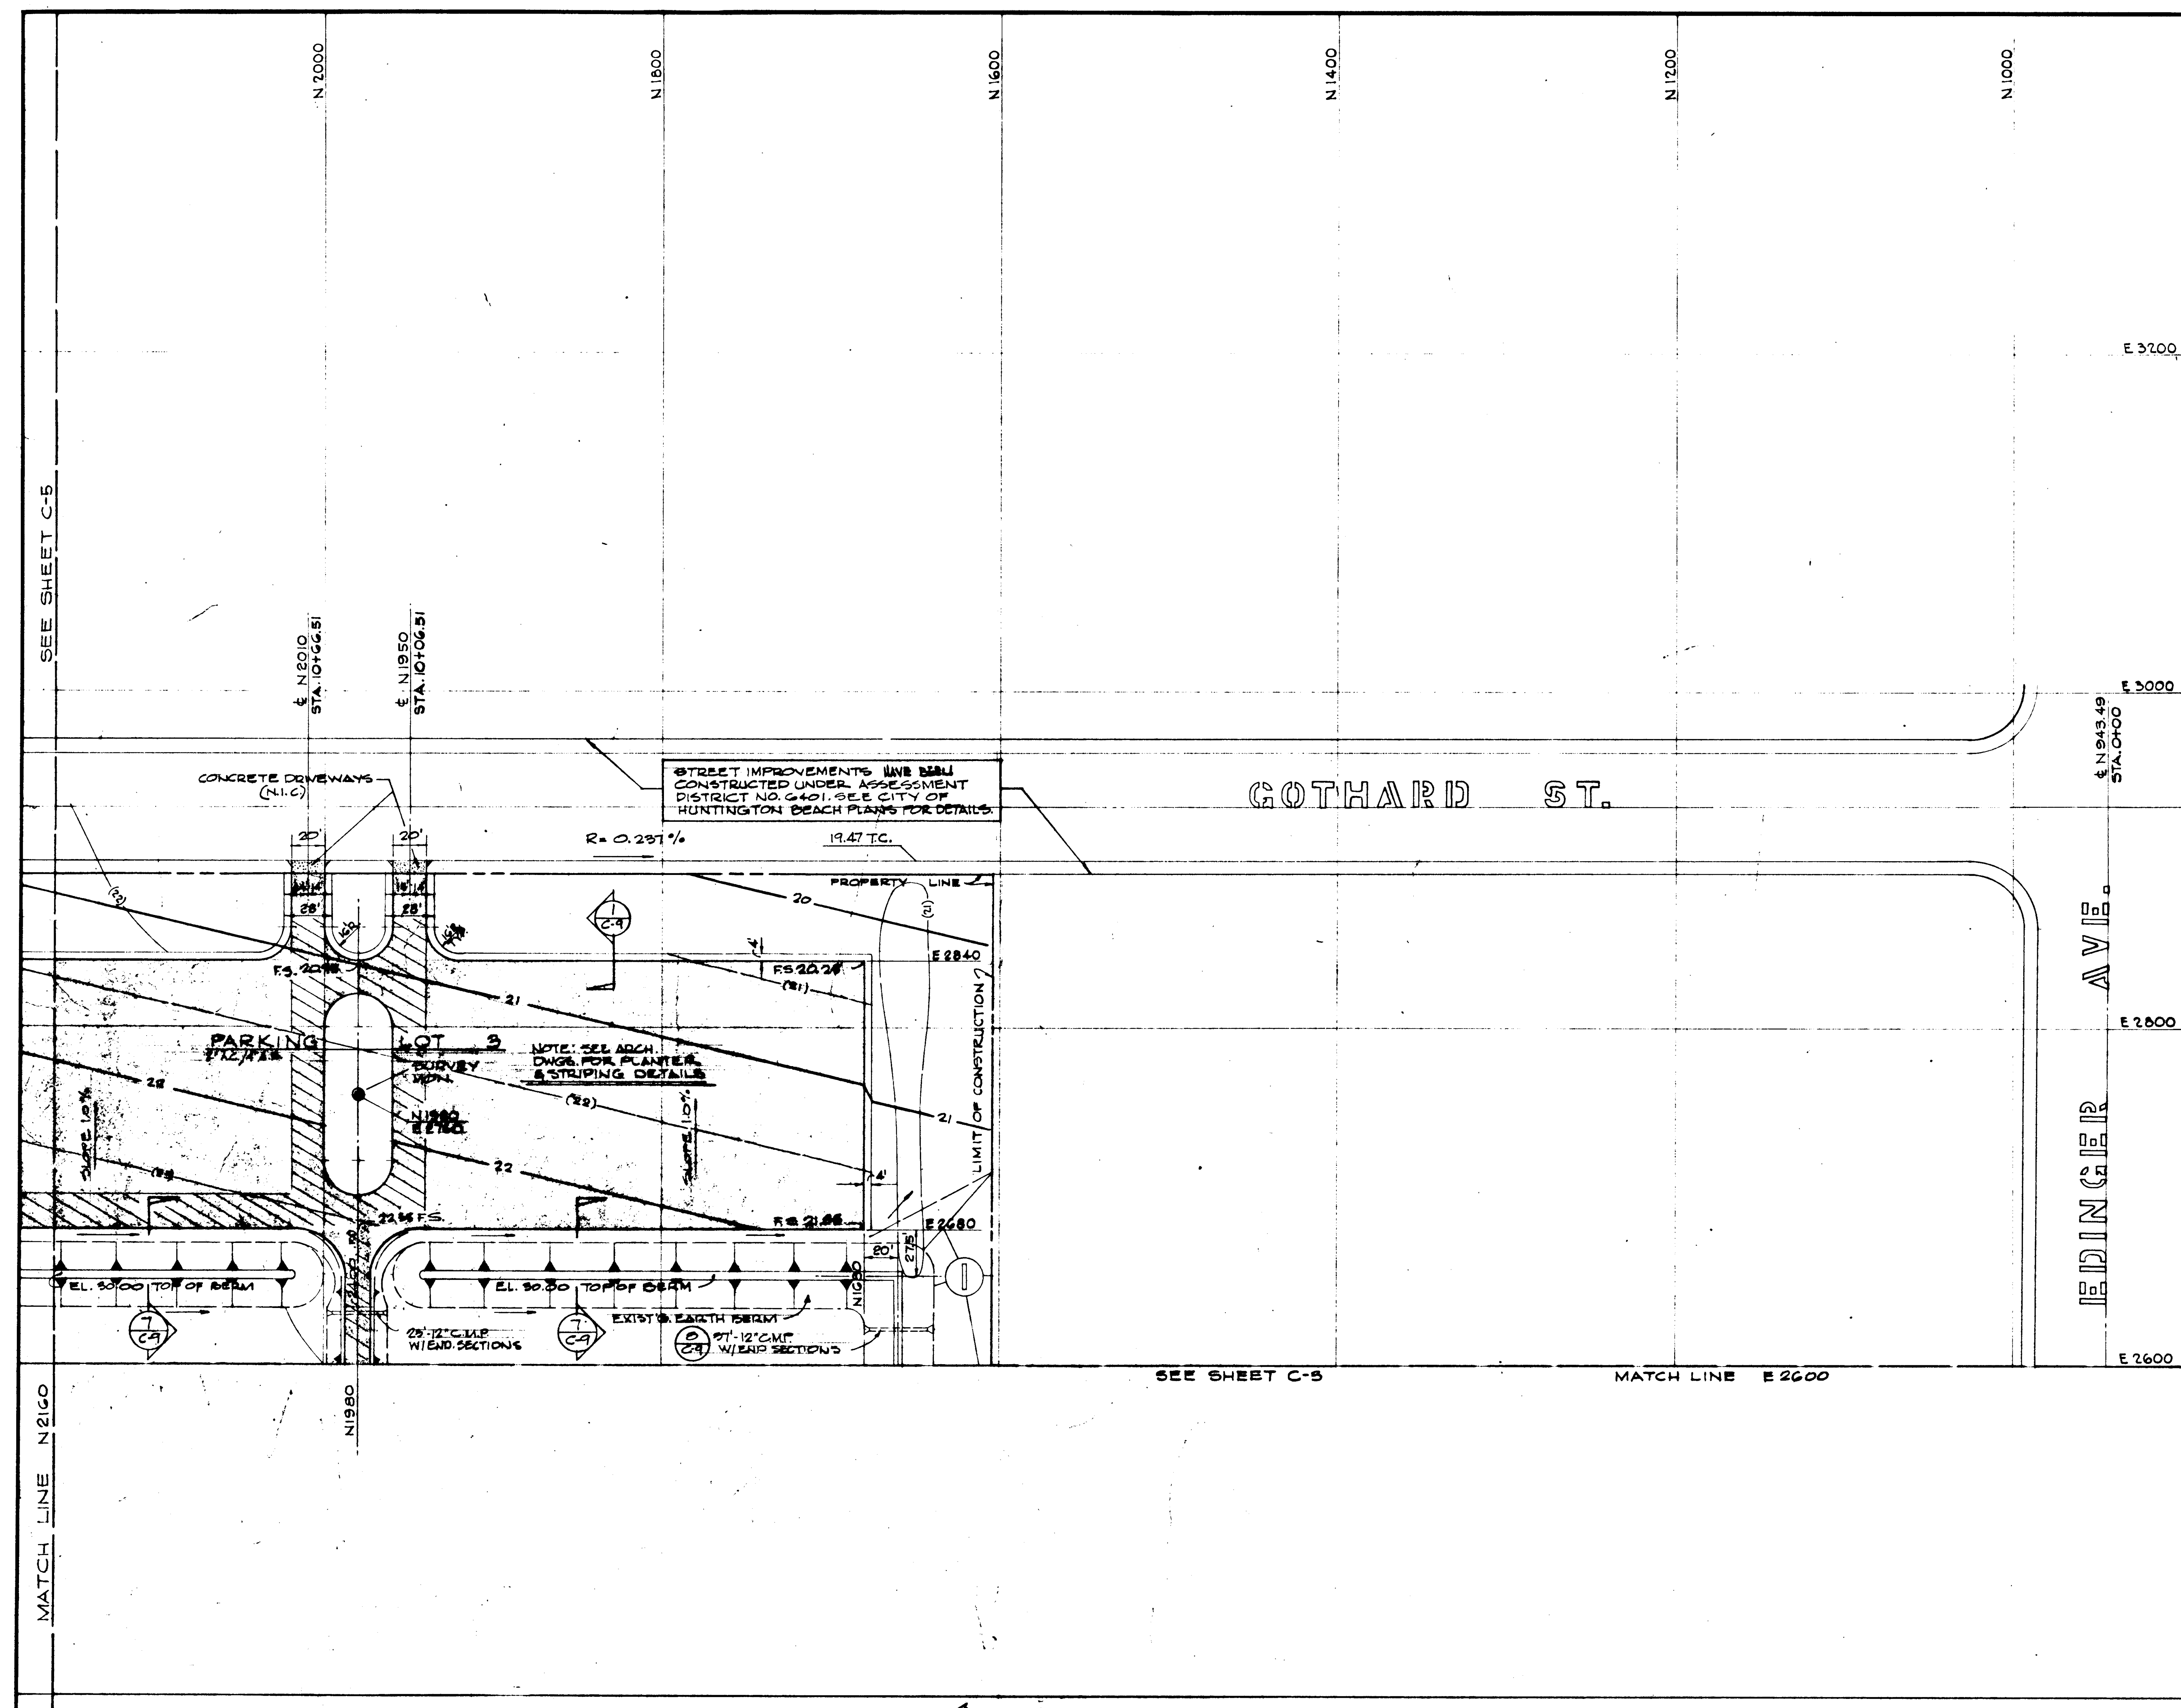

GENERAL NOTES

FOR SYMBOL LEGEND SEE SHEET C-2

DATE DESIGNED BY DRAWN BY CHECKED BY REVISIONS	STRUCTURAL ENGINEERS	DESIGNED	ARCHITECT	APPROVED	ASSOCIATED ARCHITECTS: WILLIAM L. PEREIRA & ASSOCIATES A. QUINCY JONES, FREDERICK R. EMMONS & ASSOCIATES BLUROCK ELLERBROOK & ASSOCIATES URBANUS SQUARE • MACARTHUR BOULEVARD AT FORD ROAD TELEPHONE 714/675-2640 • CORONA DEL MAR, CALIFORNIA	AREA - 4 GRADING PLANS SCALE: 1" = 40' JOB NO. 10- DATE 6-16-64 SHEET NO. C-1
	HEADROW & JOHNSTON	J.H.	<i>[Signature]</i>			
	MECHANICAL ENGINEERS	DRAWN BY	ENGINEER			
	RALPH B. PHILLIPS, INC.	J.R.	<i>[Signature]</i>			
	ELECTRICAL ENGINEERS	CHECKED BY	COLLEGE			
	RALPH B. PHILLIPS, INC.	P.A.				
	CIVIL ENGINEERS	G. SHIRMAN & ASSOCIATES				
	MOFFATT & NICHOLO					

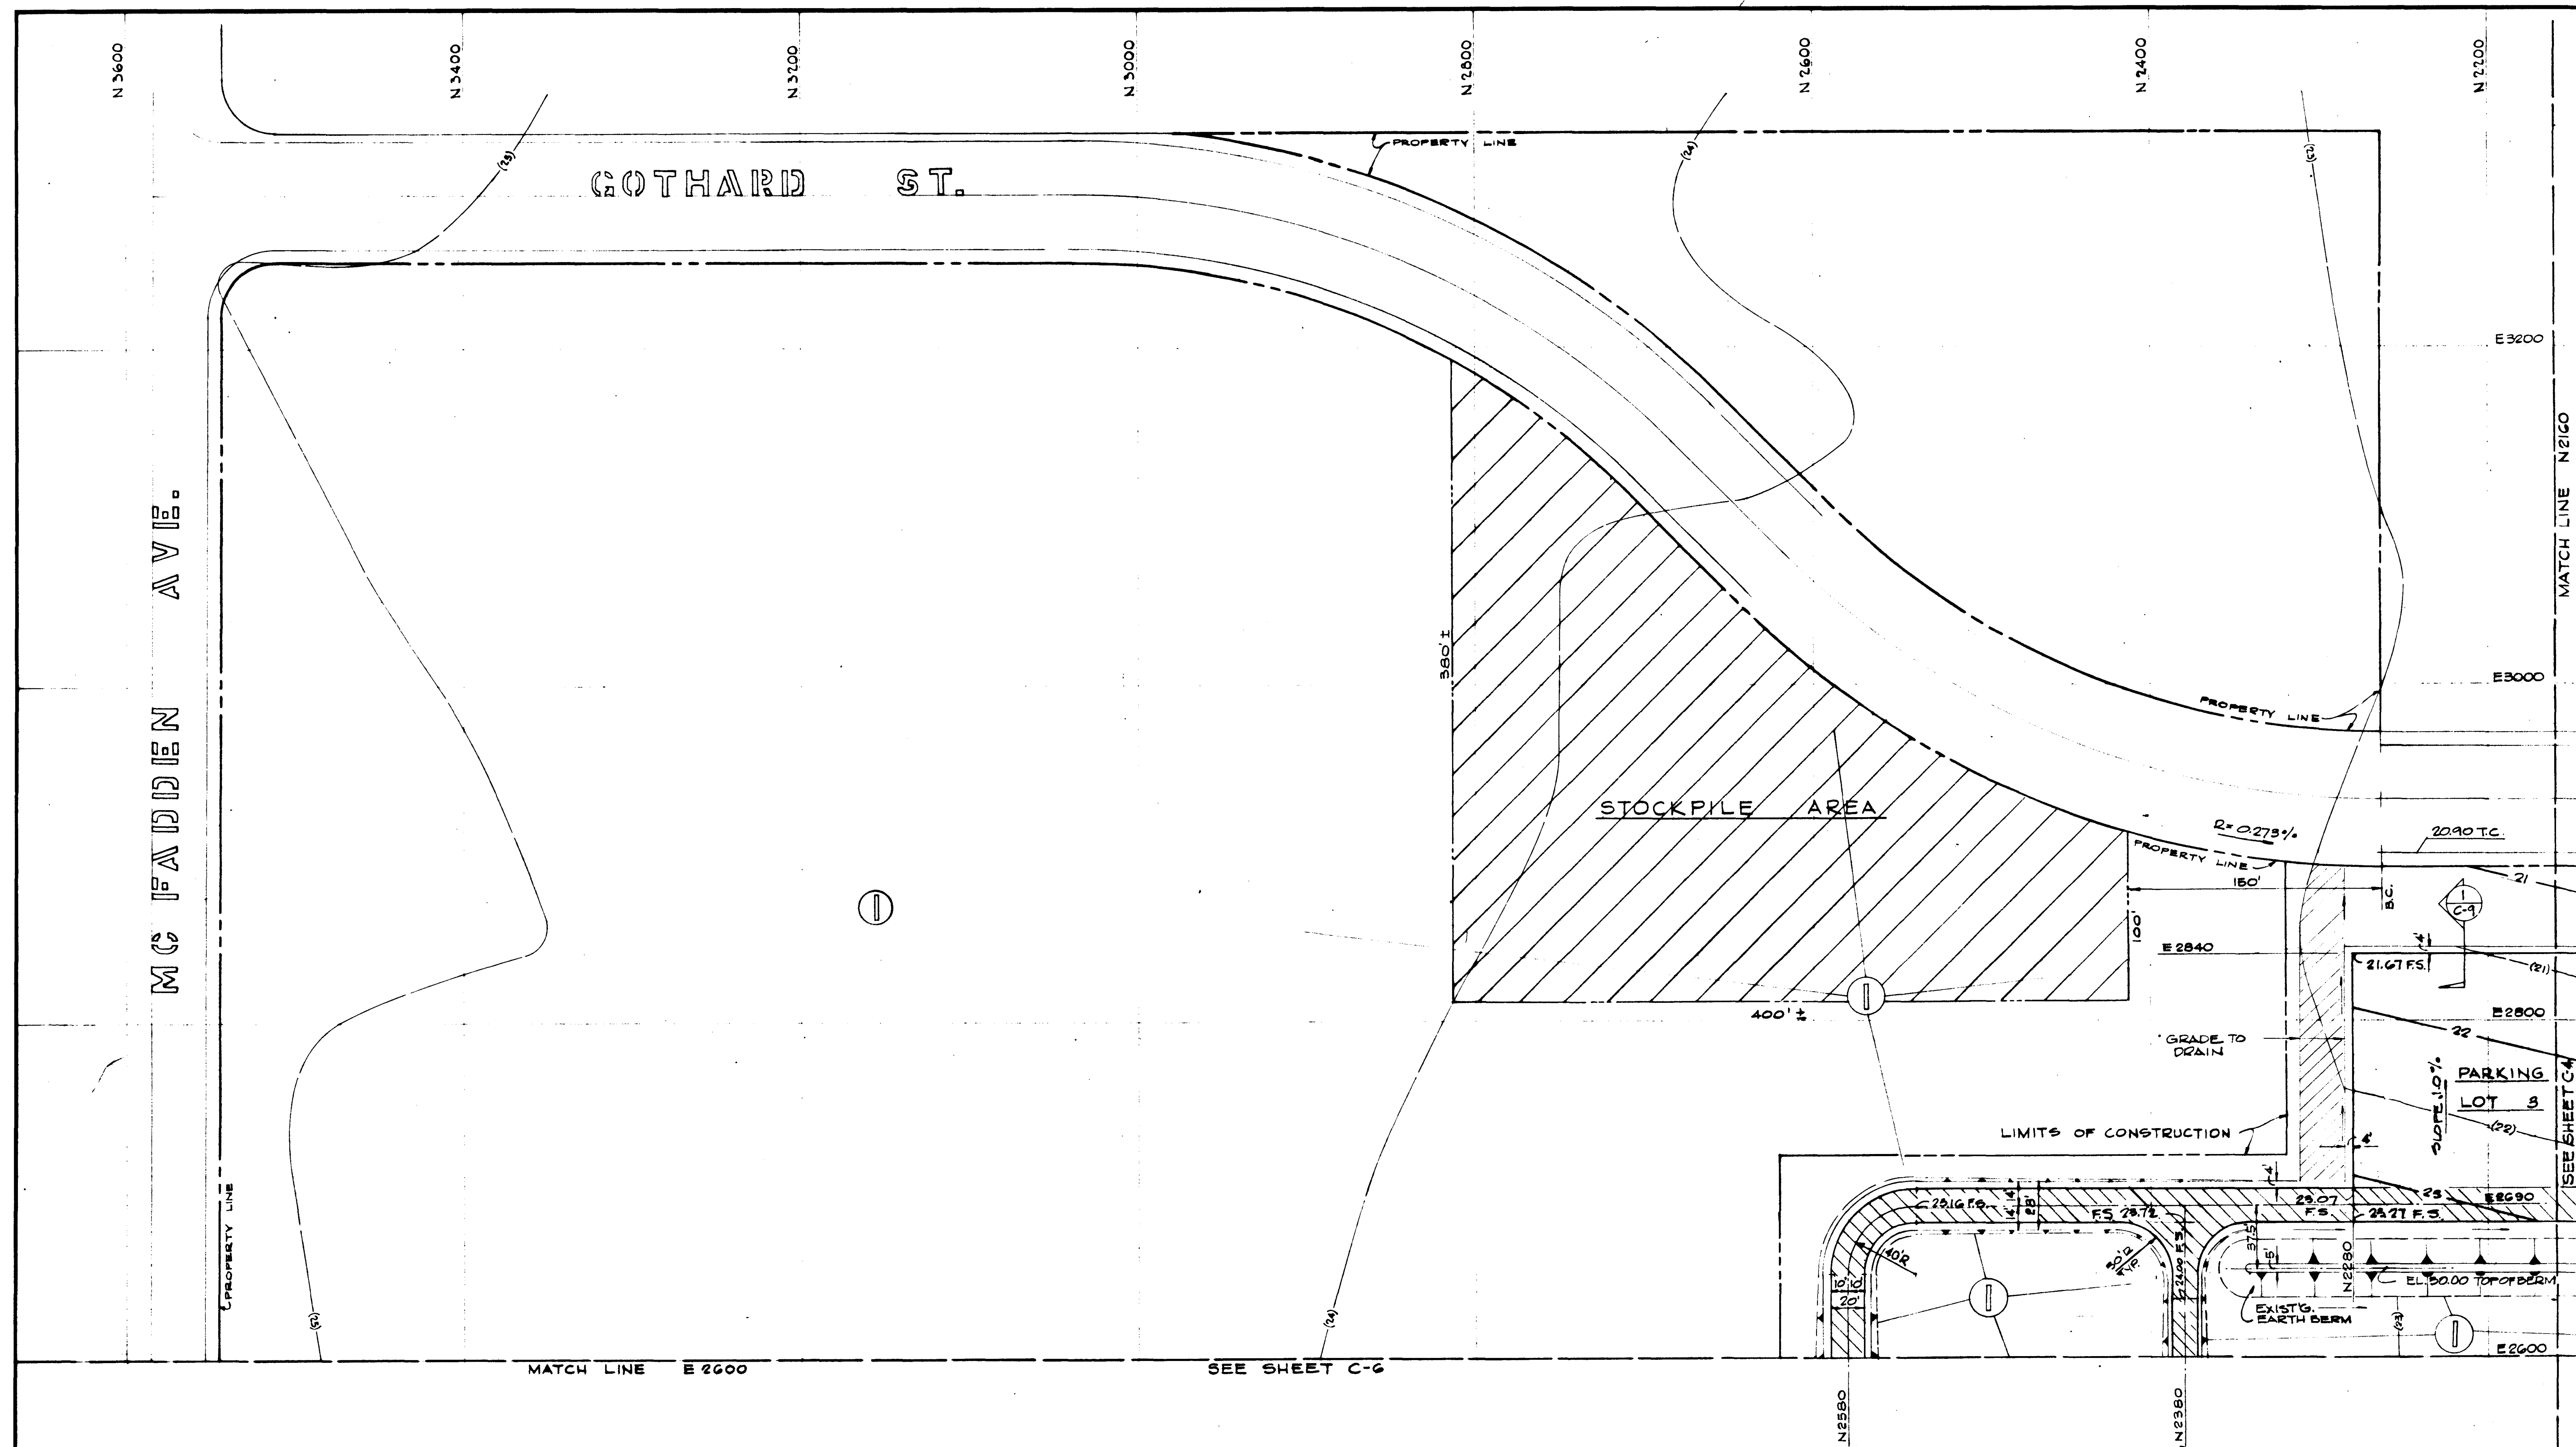

GENERAL NOTES

FOR SYMBOL LEGEND SEE SHEET C-2

DATE	REVISIONS


STRUCTURAL ENGINEERS BRANDOW & JOHNSON J.A. MARTIN & ASSOCIATES	DESIGNED L.H.	ARCHITECT W.L. PEREIRA	APPROVED
MECHANICAL ENGINEERS RALPH R. PHILLIPS, INC.	DRAWN BY L.R.	ENGINEER Ralph R. Phillips	APPROVED
ELECTRICAL ENGINEERS RALPH R. PHILLIPS, INC.	CHECKED BY R.A.	COLLEGE	STATE FIRE MARSHAL STATE OF CALIFORNIA JUN 21 1965
CIVIL ENGINEERS O. SHURMAN & ASSOCIATES MOFFATT & NICOL			

ASSOCIATED ARCHITECTS:
 WILLIAM L. PEREIRA & ASSOCIATES
 A. QUINCY JONES-FREDERICK E. EMMONS & ASSOCIATES
 BLUROCK ELLERBROEK & ASSOCIATES


URBANUS SQUARE • MACARTHUR BOULEVARD AT FORD ROAD
 TELEPHONE 714/675-2640 • CORONA DEL MAR, CALIFORNIA

GOLDEN WEST COLLEGE
 HUNTINGTON BEACH, CALIFORNIA
 ORANGE COAST JUNIOR COLLEGE DISTRICT

AREA 5	JOB NO. 10-1
GRADING PLANS	DATE 6-15-65
	SHEET NO. C-5

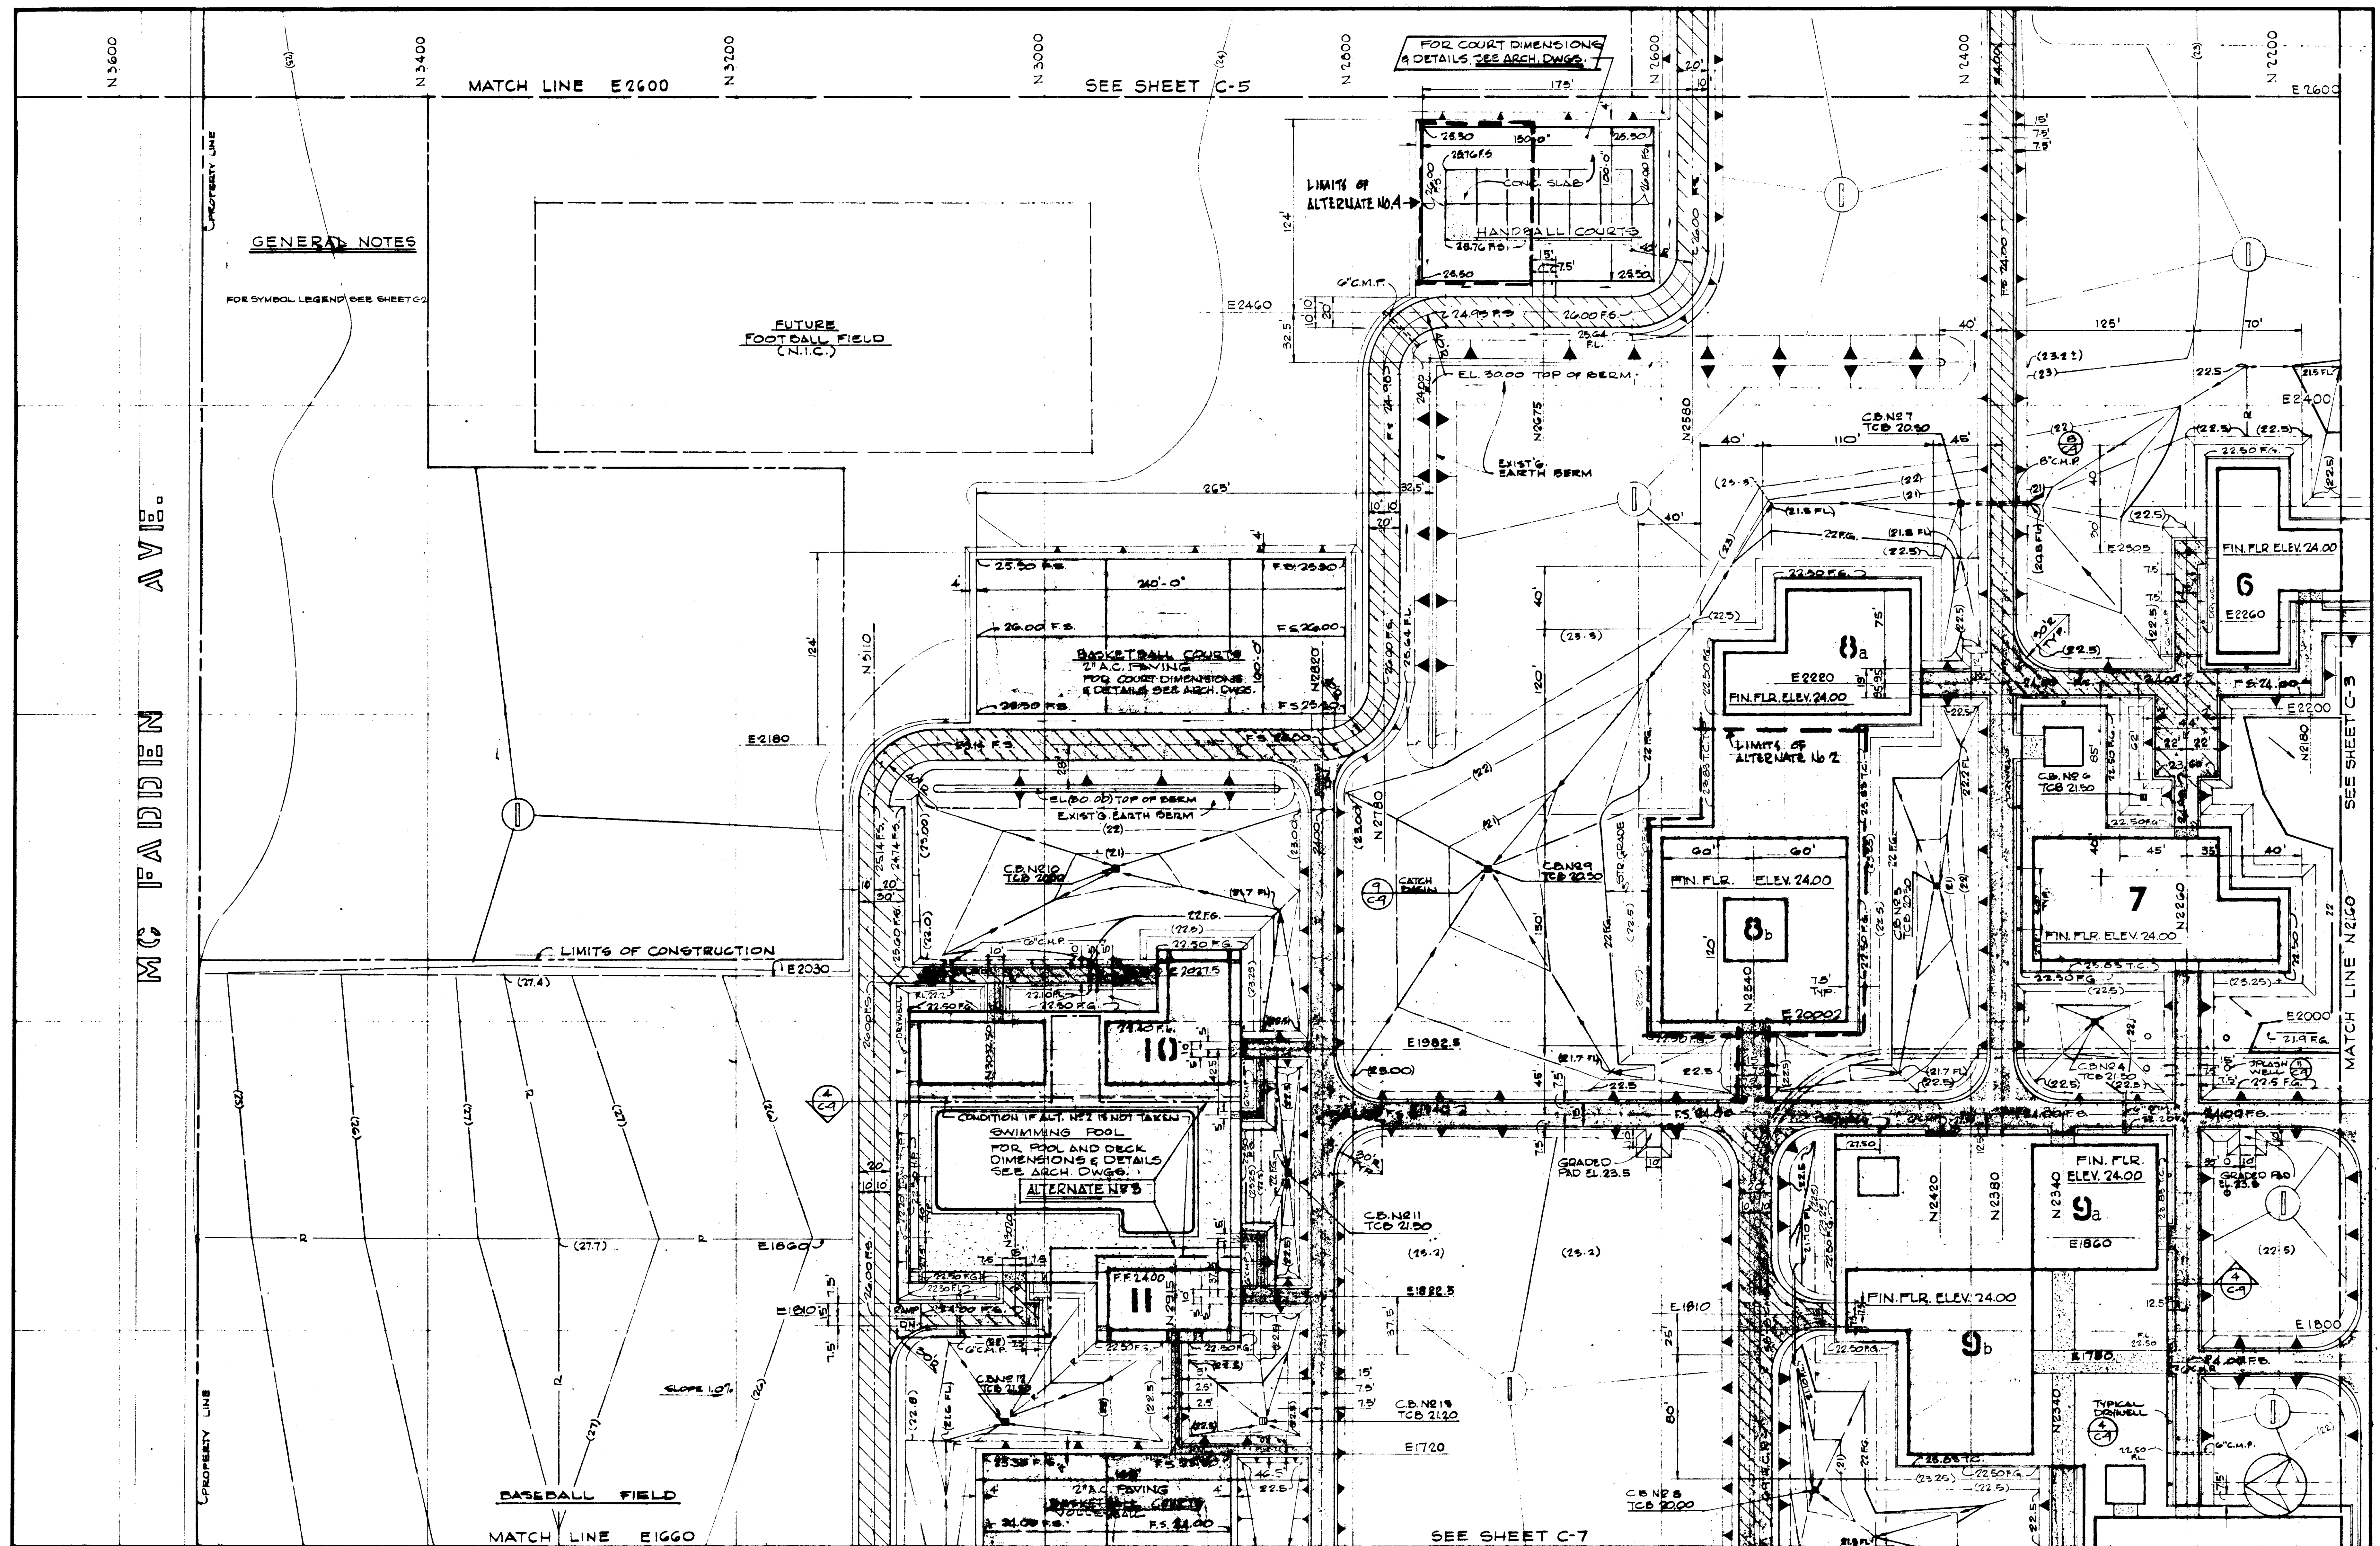

<p>DATE DRAWN</p> <p>REVISIONS</p>	<p>STRUCTURAL ENGINEERS BRANDOW & JOHNSON J.A. MARTIN & ASSOCIATES</p> <p>MECHANICAL ENGINEERS RALPH E. PHILLIPS, INC.</p> <p>ELECTRICAL ENGINEERS RALPH E. PHILLIPS, INC.</p> <p>CIVIL ENGINEERS O. SHUIMAN & ASSOCIATES MOFFATT & NICOL</p>	<p>DESIGNED FA</p> <p>DRAWN BY L.R.</p> <p>CHECKED BY L.H.</p>	<p>ARCHITECT WILLIAM L. PEREIRA & ASSOCIATES ENGINEER JAMES J. JOHNSON COLLEGE</p> <p>APPROVED STATE OF CALIFORNIA JUN 3 1955</p> <p>35874</p>	<p>ASSOCIATED ARCHITECTS: WILLIAM L. PEREIRA & ASSOCIATES A. QUINCY JONES-FREDERICK E. EMMONS & ASSOCIATES BLUROCK ELLERBROCK & ASSOCIATES</p> <p>URBANUS SQUARE • MACARTHUR BOULEVARD AT FORD ROAD TELEPHONE 714/675-2640 • CORONA DEL MAR, CALIFORNIA</p>	<p>GOLDEN WEST COLLEGE HUNTINGTON BEACH, CALIFORNIA ORANGE COAST JUNIOR COLLEGE DISTRICT</p>	<p>AREA C</p> <p>GRADING PLANS</p> <p>JOB NO. 104</p> <p>DATE 6-15-66</p> <p>SHEET NO. C-6</p>
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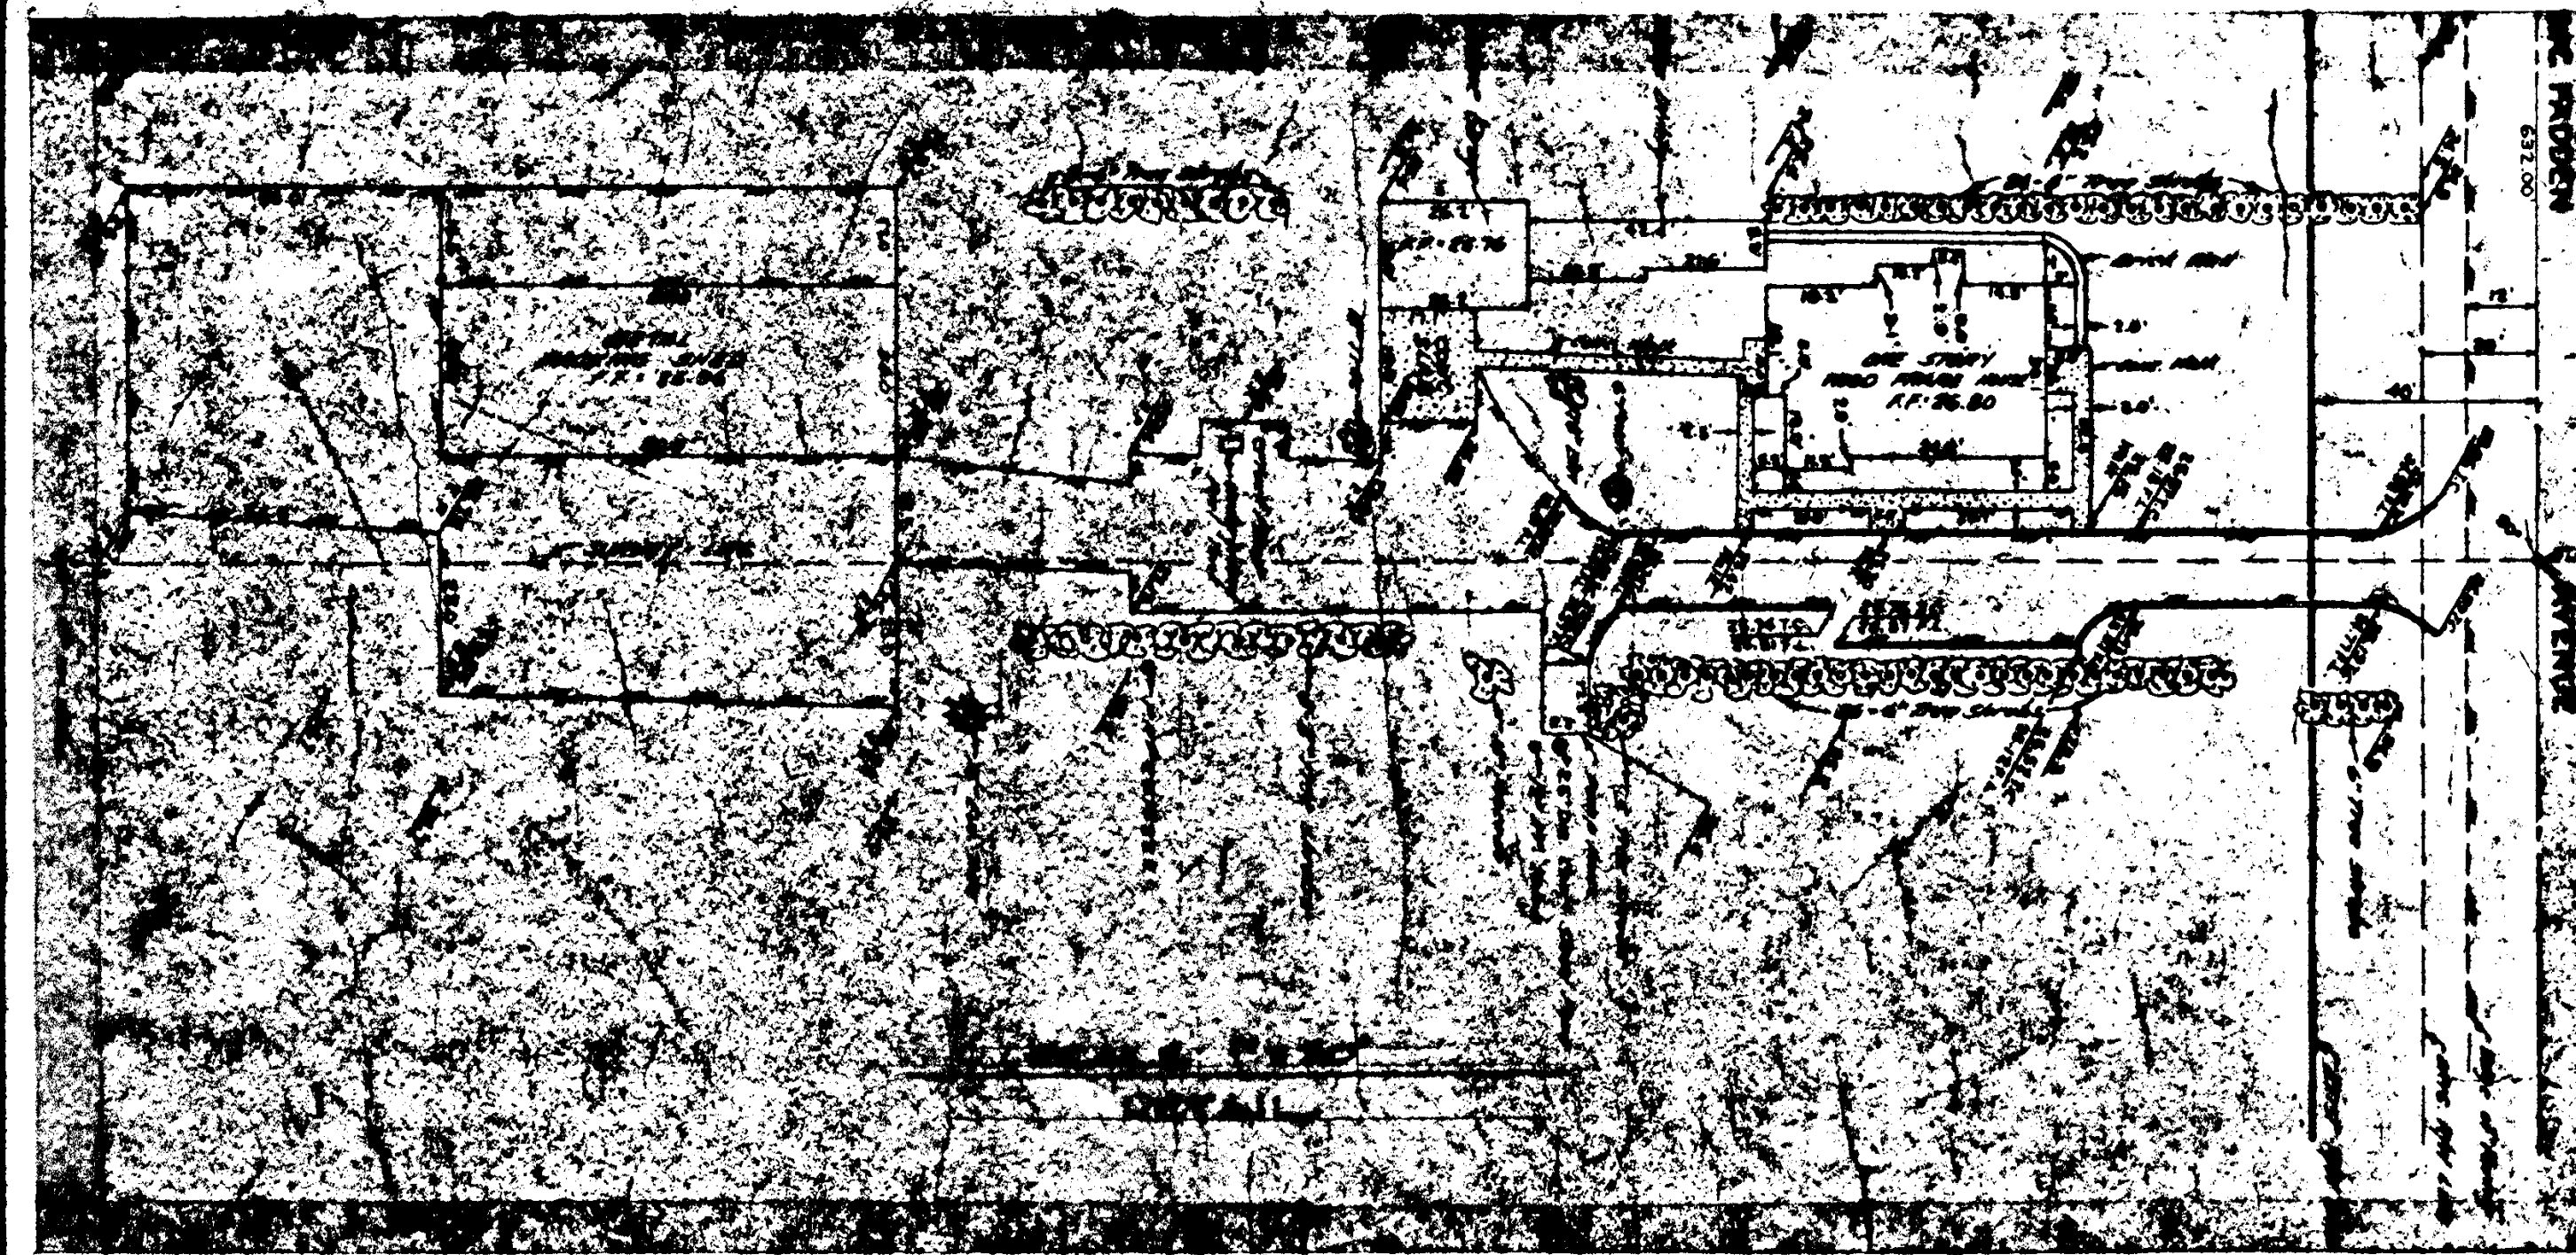
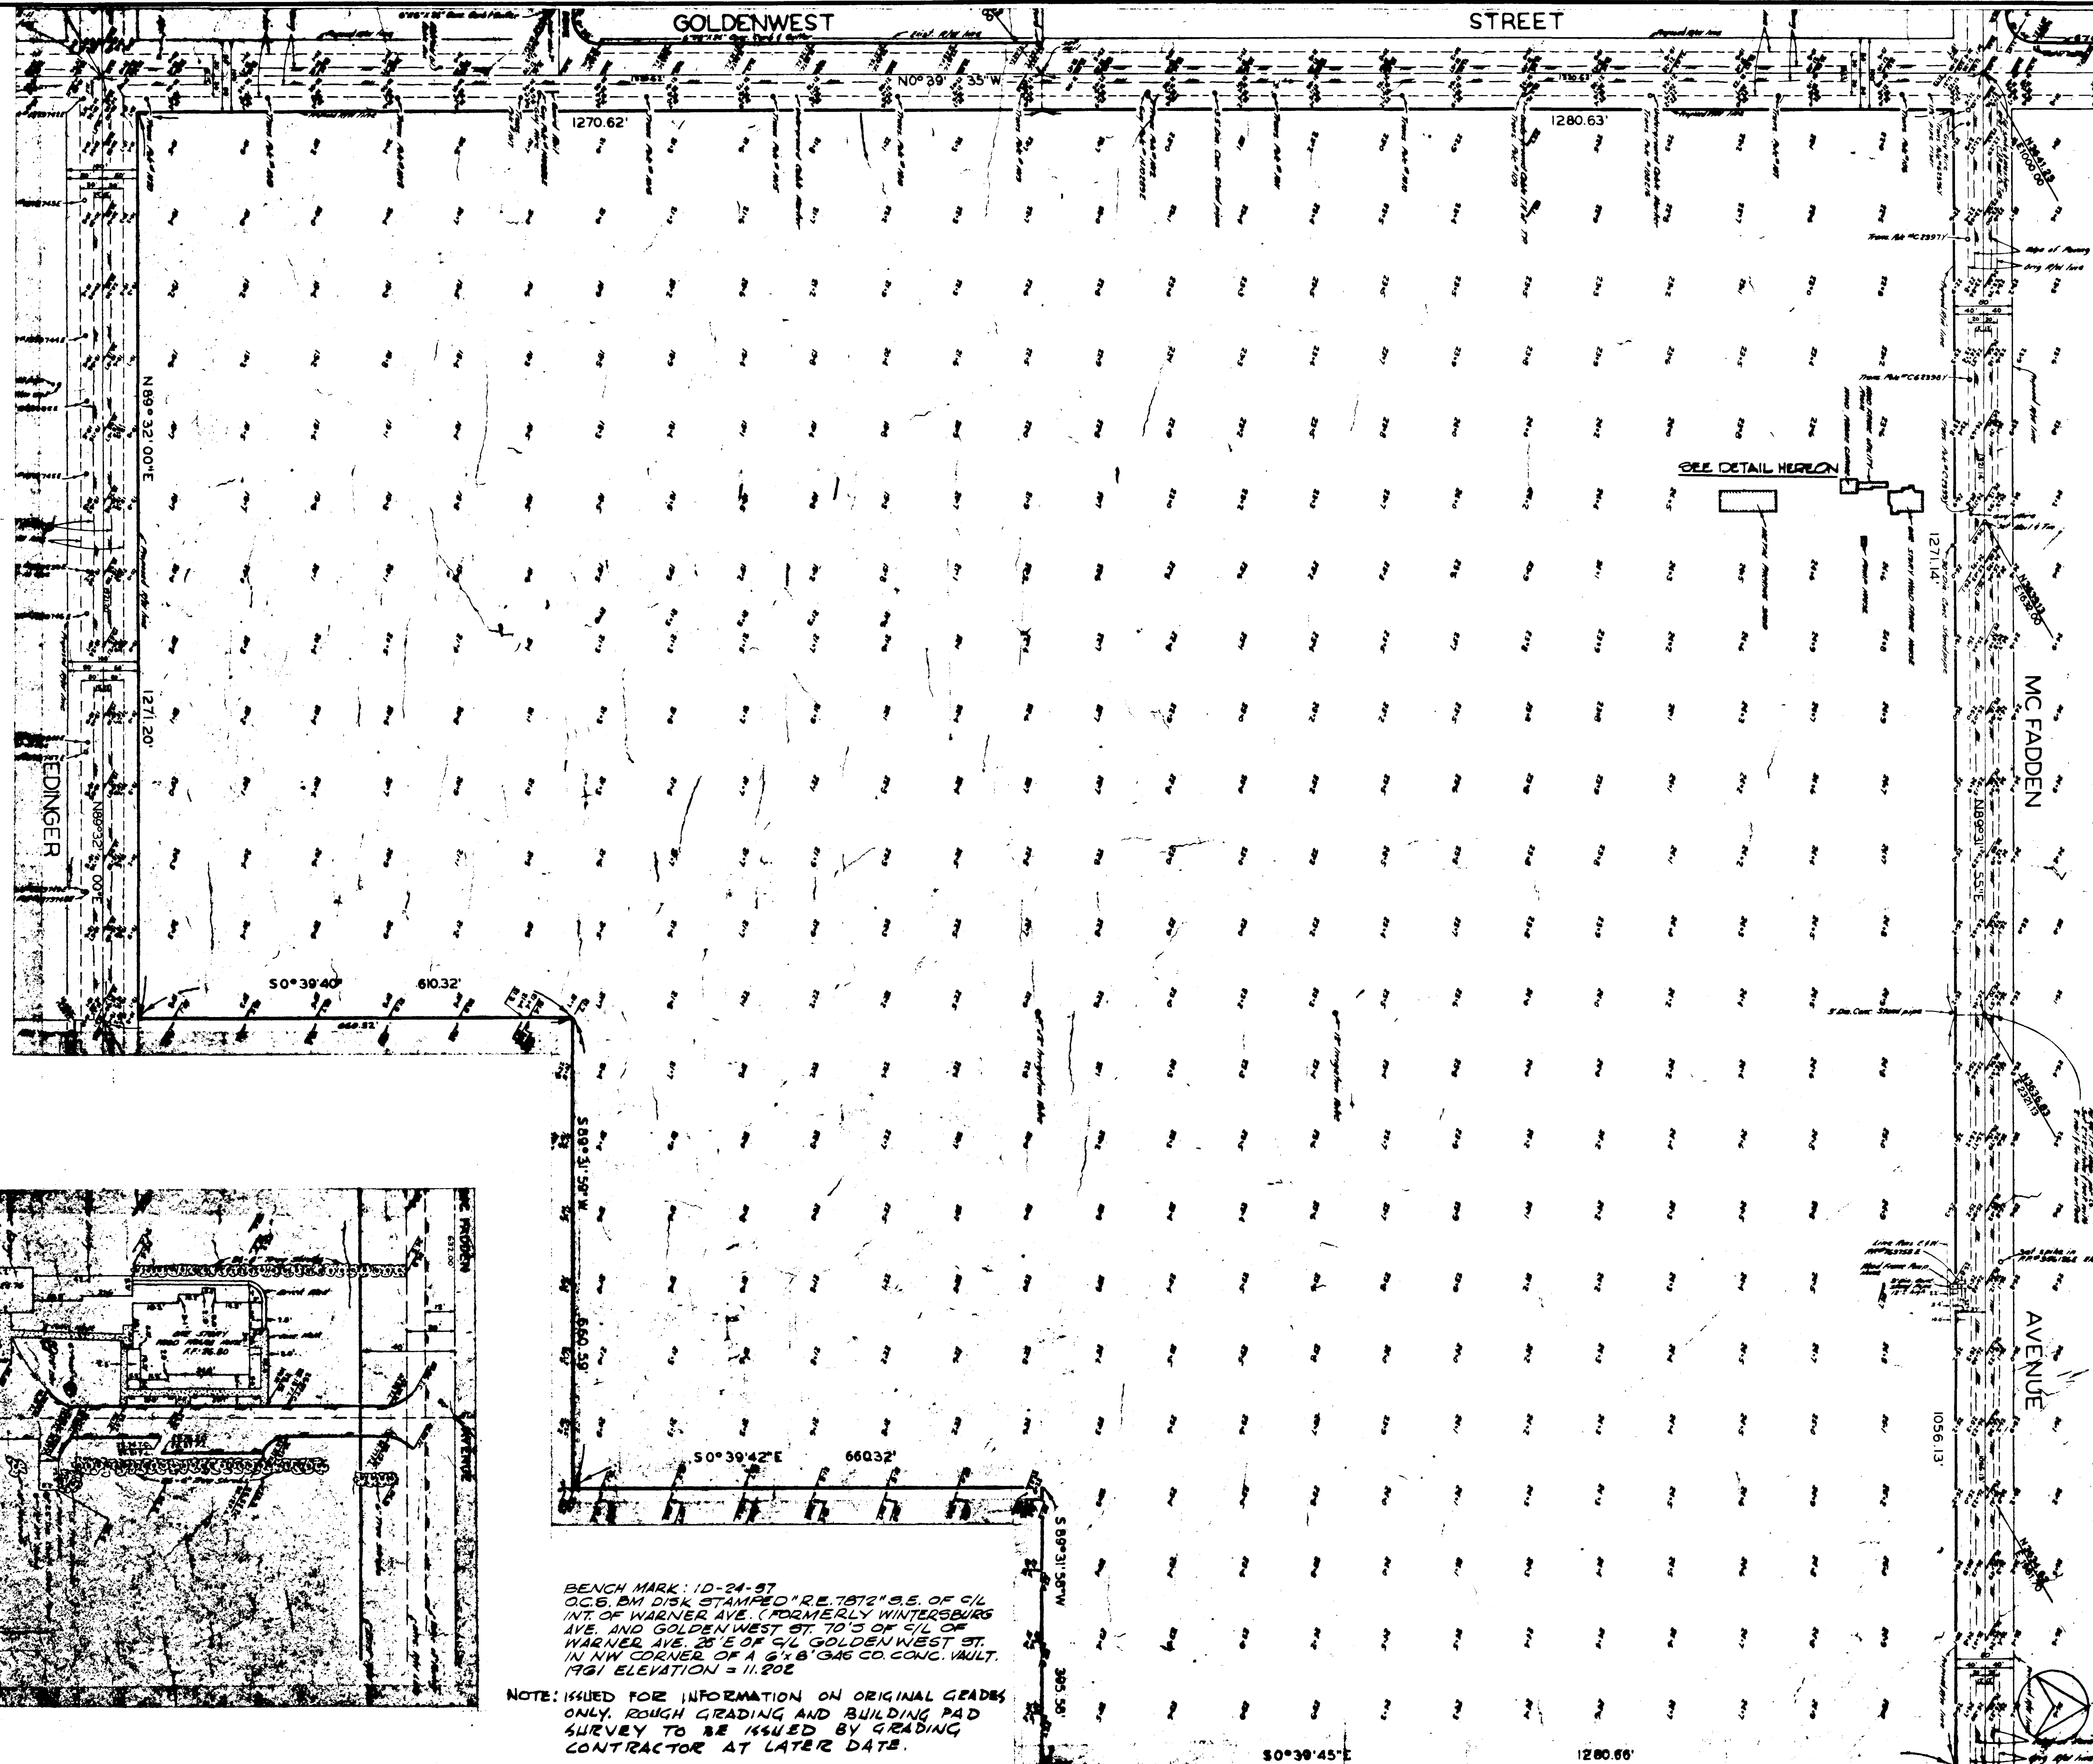
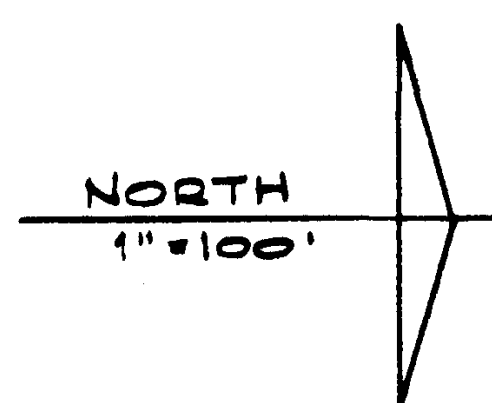

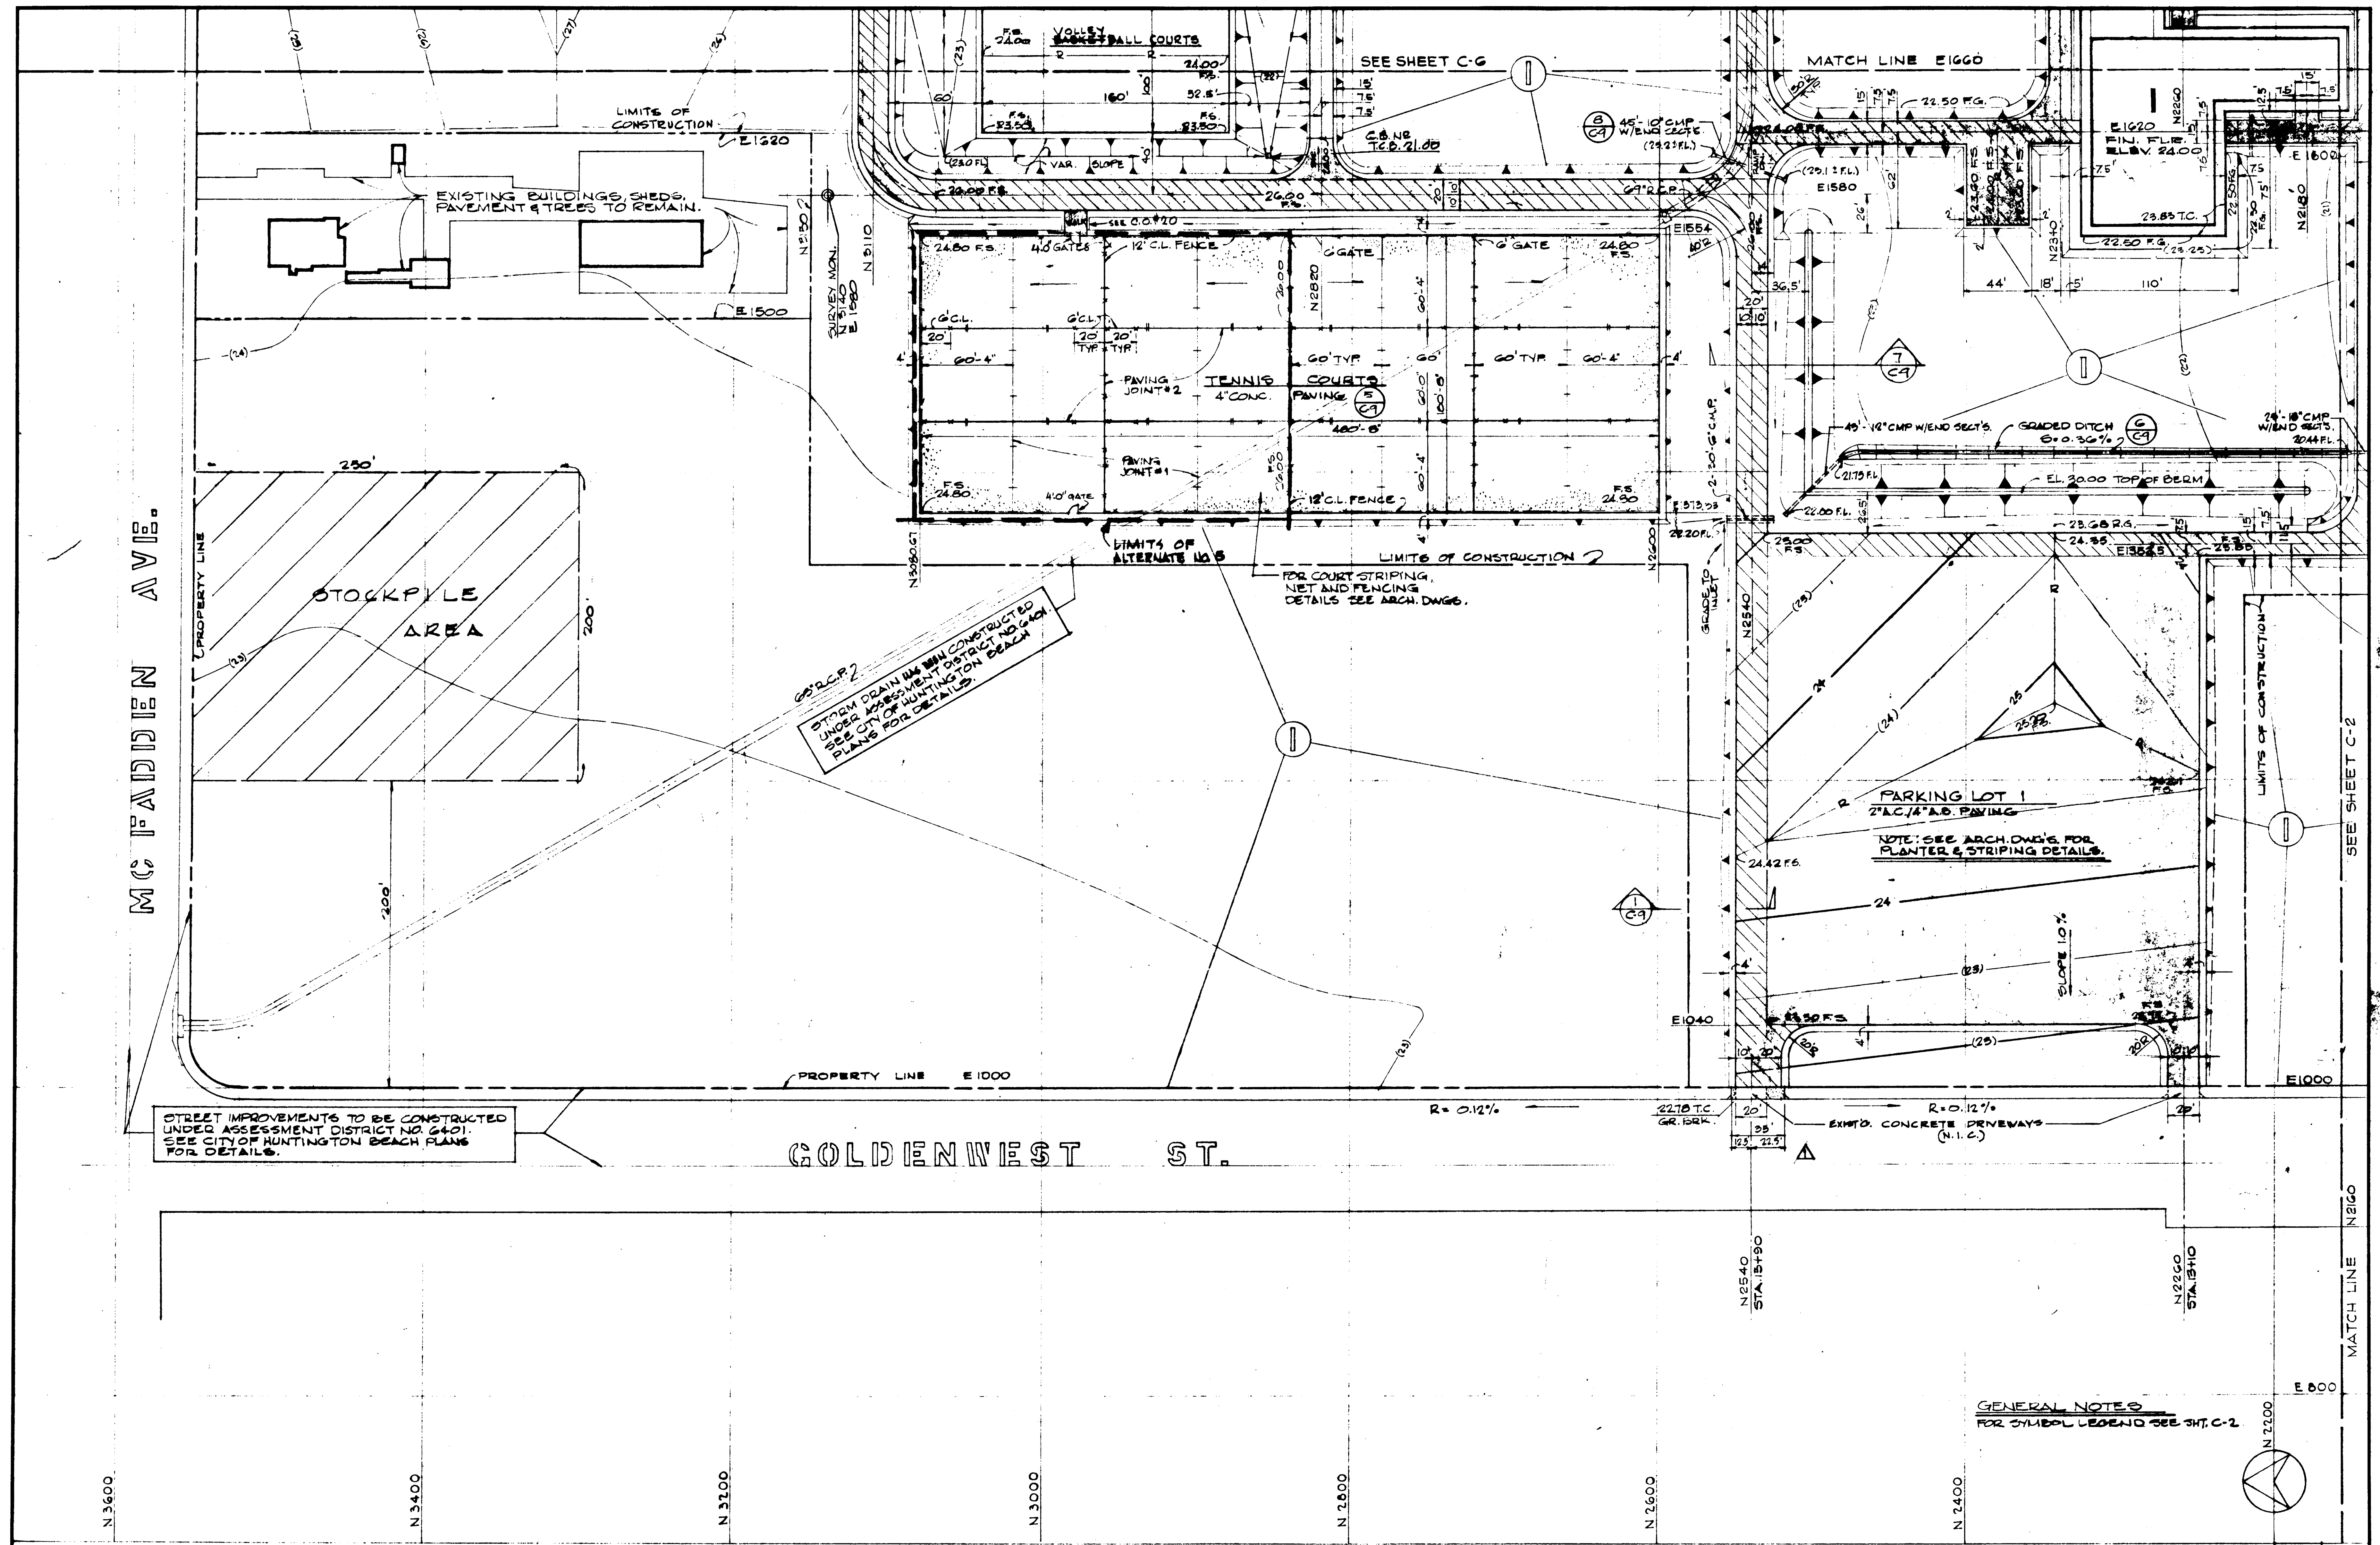
<p>REVISIONS</p>	<p>STRUCTURAL ENGINEERS BRANDOW & JOHNSON J.A. MARTIN & ASSOCIATES</p> <p>MECHANICAL ENGINEERS RALPH E. PHILLIPS, INC.</p> <p>ELECTRICAL ENGINEERS RALPH E. PHILLIPS, INC.</p> <p>CIVIL ENGINEERS G. SHURMAN & ASSOCIATES MOFFATT & NICHOLO</p>	<p>DESIGNED P.R.</p> <p>DRAWN BY J.R.</p> <p>CHECKED BY L.H.</p>	<p>ARCHITECT WILLIAM L. FERREIRA & ASSOCIATES</p> <p>ENGINEER A. QUINCY JONES, FREDERICK E. HEMMONS & ASSOCIATES BLUROCK ELLERBROEK & ASSOCIATES</p> <p>APPROVED STATE FIRE MARSHAL STATE OF CALIFORNIA JUN 3 1965</p>	<p>ASSOCIATED ARCHITECTS:</p> <p>WILLIAM L. FERREIRA & ASSOCIATES A. QUINCY JONES, FREDERICK E. HEMMONS & ASSOCIATES BLUROCK ELLERBROEK & ASSOCIATES</p> <p>URBANUS SQUARE • MACARTHUR BOULEVARD AT FORD ROAD TELEPHONE 714/675-2640 • CORONA DEL MAR, CALIFORNIA</p>	<p>GOLDEN WEST COLLEGE HUNTINGTON BEACH, CALIFORNIA ORANGE COAST JUNIOR COLLEGE DISTRICT</p>	<p>AREA 7</p> <p>GRADING PLANS</p>	<p>JOB NO. 1001</p> <p>DATE 6-15-65</p> <p>SHEET NO. C-7</p>
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SURVEY AND TOPOGRAPHY
ON A PORTION OF
SECTION 14, T.5S, R.11W, S.B.B.1M
CITY OF HUNTINGTON BEACH, CALIF.
ORANGE COAST COLLEGE
(GOLDENWEST CAMPUS)



PREPARED BY THE OFFICE OF
JACK S. RAUP & ASSOCIATES
36 ROCHESTER ST.
LOS ANGELES, CALIF.

DATE: 1-10-65
F.B. 132R



NOTE: ISSUED FOR INFORMATION ON ORIGINAL GRADES ONLY. ROUGH GRADING AND BUILDING PAD SURVEY TO BE ISSUED BY GRADING CONTRACTOR AT LATER DATE.


<p>DATE DRAWN</p> <p>REVISIONS</p>	<p>STRUCTURAL ENGINEERS BRANDOW & JOHNSTON J.A. MARTIN & ASSOCIATES</p> <p>MECHANICAL ENGINEERS RALPH E. PHILLIPS, INC.</p> <p>ELECTRICAL ENGINEERS RALPH E. PHILLIPS, INC.</p> <p>CIVIL ENGINEERS G. SHURMAN & ASSOCIATES MOFFATT & NICHOL</p>	<p>DESIGNED</p> <p>DRAWN BY</p> <p>CHECKED BY</p>	<p>ARCHITECT WILLIAM L. FERRERA & ASSOCIATES</p> <p>ENGINEER</p> <p>COLLEGE</p> <p>APPROVED STATE FIRE MARSHAL STATE OF CALIFORNIA JUN 21 1965</p>	<p>ASSOCIATED ARCHITECTS: WILLIAM L. FERRERA & ASSOCIATES A. QUINCY JONES-FREDERICK R. EDMONDS & ASSOCIATES BLUROCK ELLERBROCK & ASSOCIATES</p> <p>URBANUS SQUARE MACARTHUR BOULEVARD AT FORD ROAD TELEPHONE 714/675-2640 CORONA DEL MAR, CALIFORNIA</p>	<p>GOLDEN WEST COLLEGE HUNTINGTON BEACH, CALIFORNIA ORANGE COAST JUNIOR COLLEGE DISTRICT</p>	<p>SITE SURVEY JOB NO. 104</p> <p>GRADING PLANS DATE 6-15-65 SHEET NO. C-8</p>
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- NOTES:
- FOR M.H. NO. 2, CONSTRUCT TOP OF BOX AND SHAFT PER DETAIL A & SECT. C-C.
 - MANHOLE COVER AND FRAME SHALL BE ALHAMBRA FORD TYPE A-1204. TOP OF COVER SHALL BE 5' ABOVE FINISH GRADE.
 - FOR ELEVATIONS, R.D. AND T, SEE PLAN.
 - INLET PIPE SHALL BE ONE FULL LENGTH (6'), PLUGGED AT END WITH MORTAR AND BRICK. SEE PLAN FOR PIPE SIZE.
 - FOR PIPE BEDDING AND TRENCH DETAILS SEE

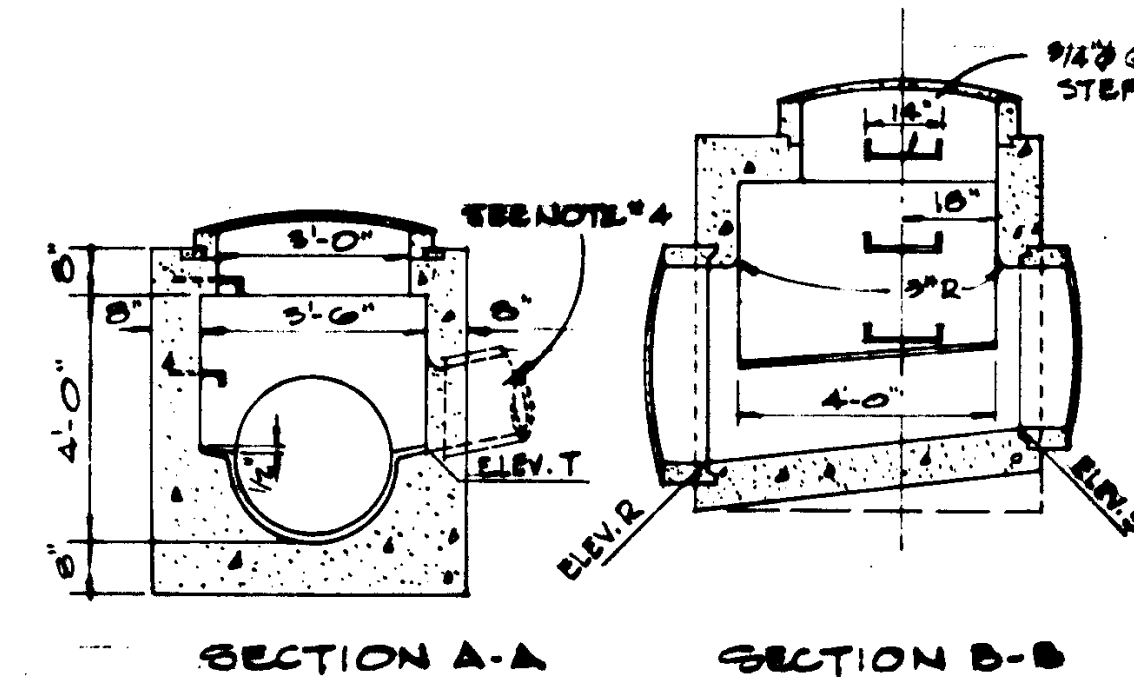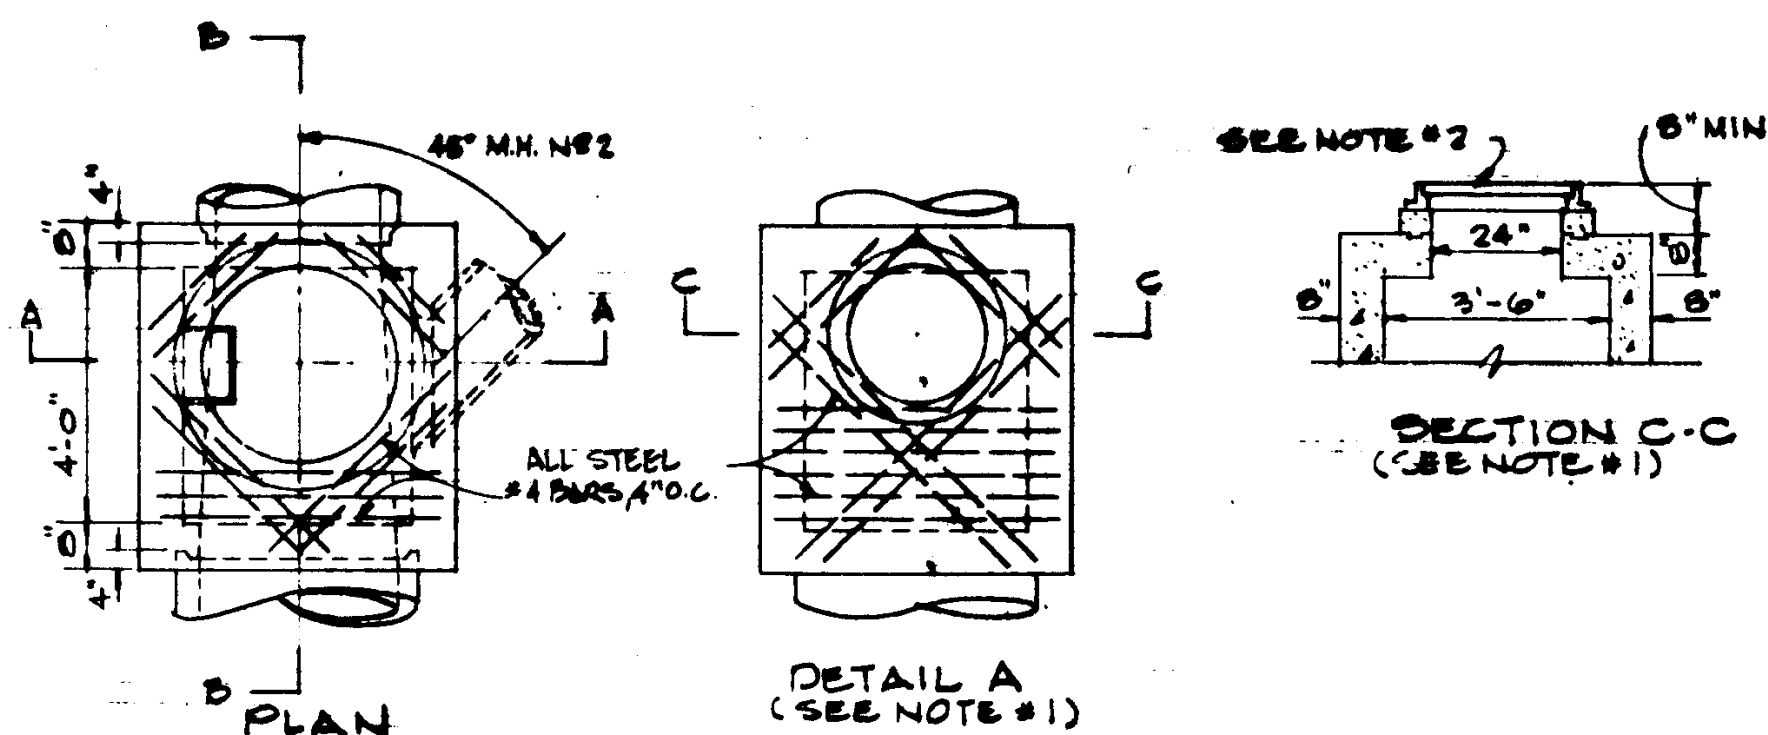
STORM DRAIN MANHOLE

SCALE NONE




TENNIS COURT PAVING

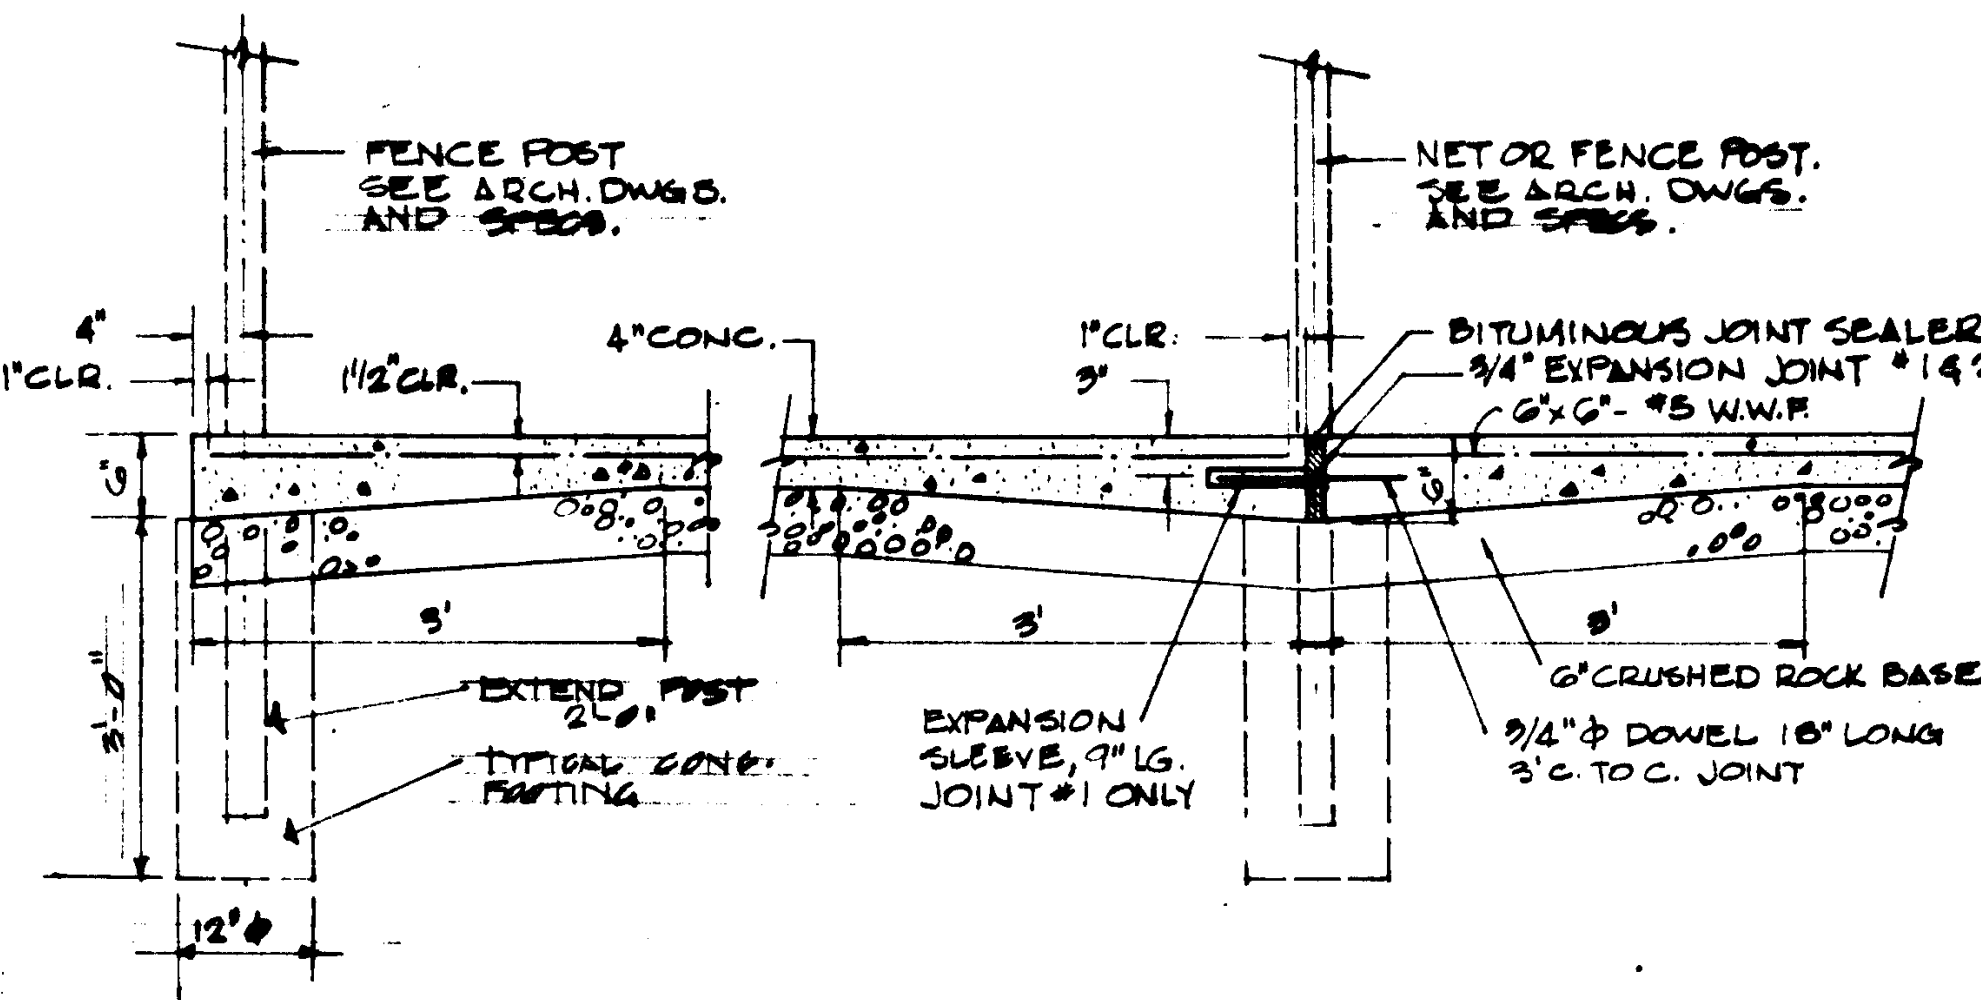SCALE NONE

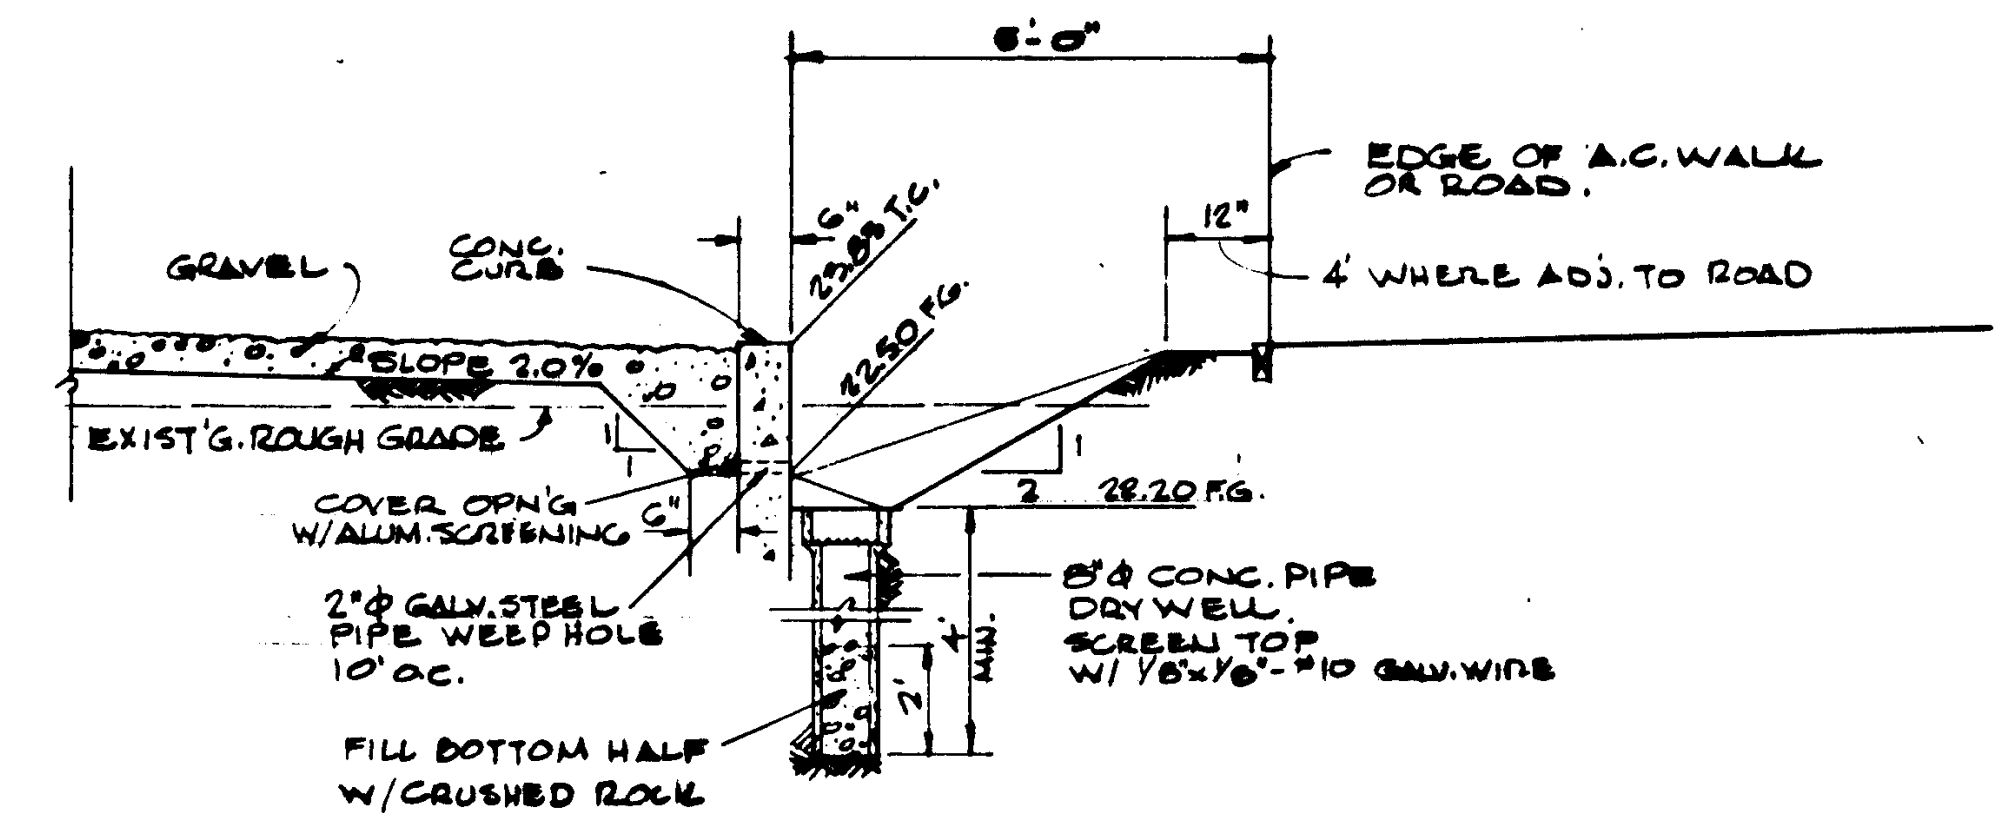


FINISH GRADING BETWEEN CURB & WALKS

SCALE NONE

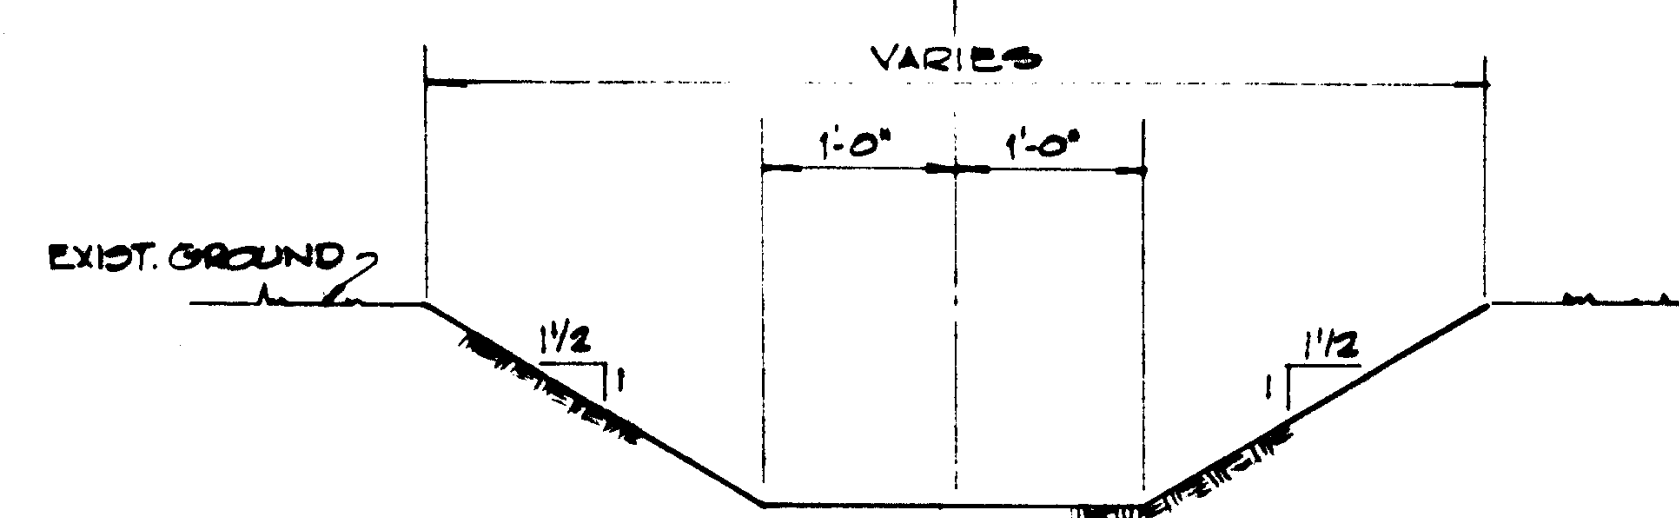

GRADED DITCH


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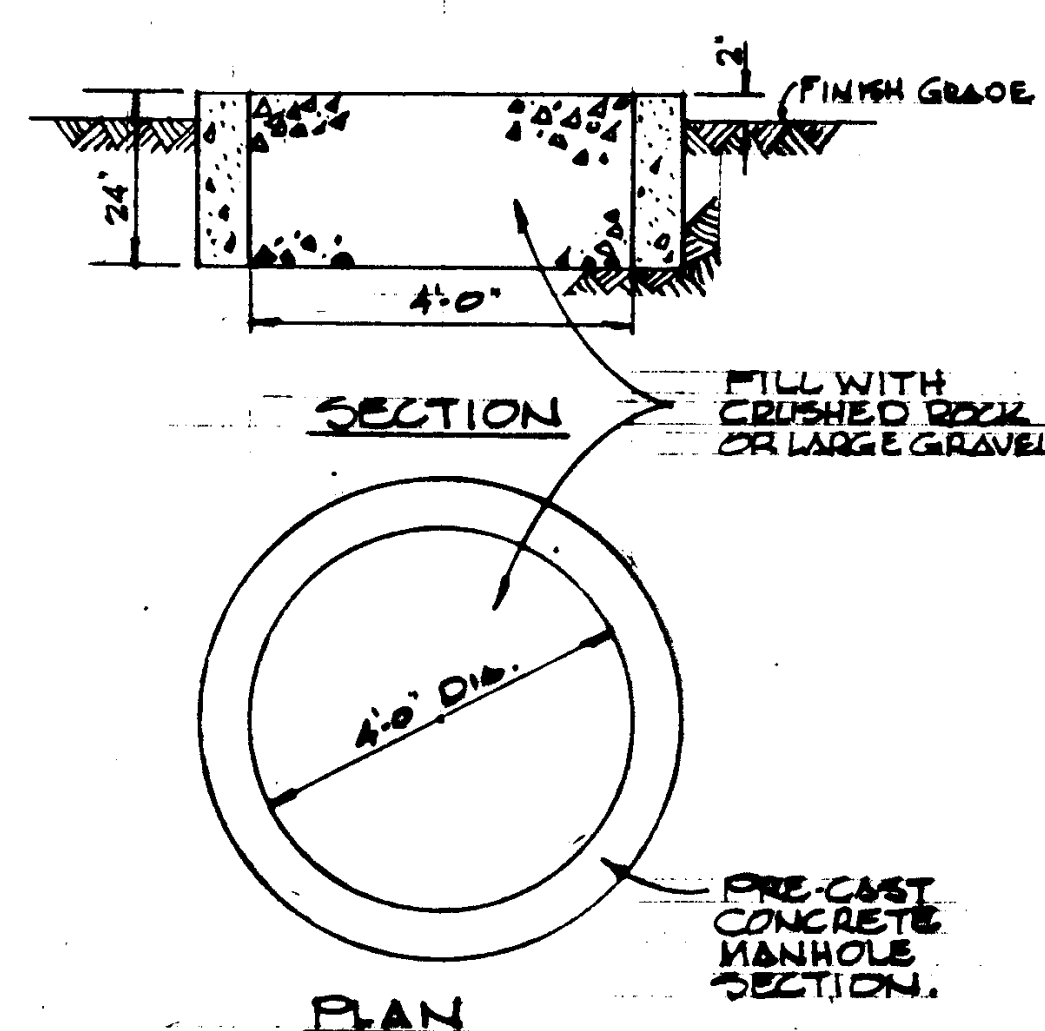
ASPHALTIC CONCRETE WALKS

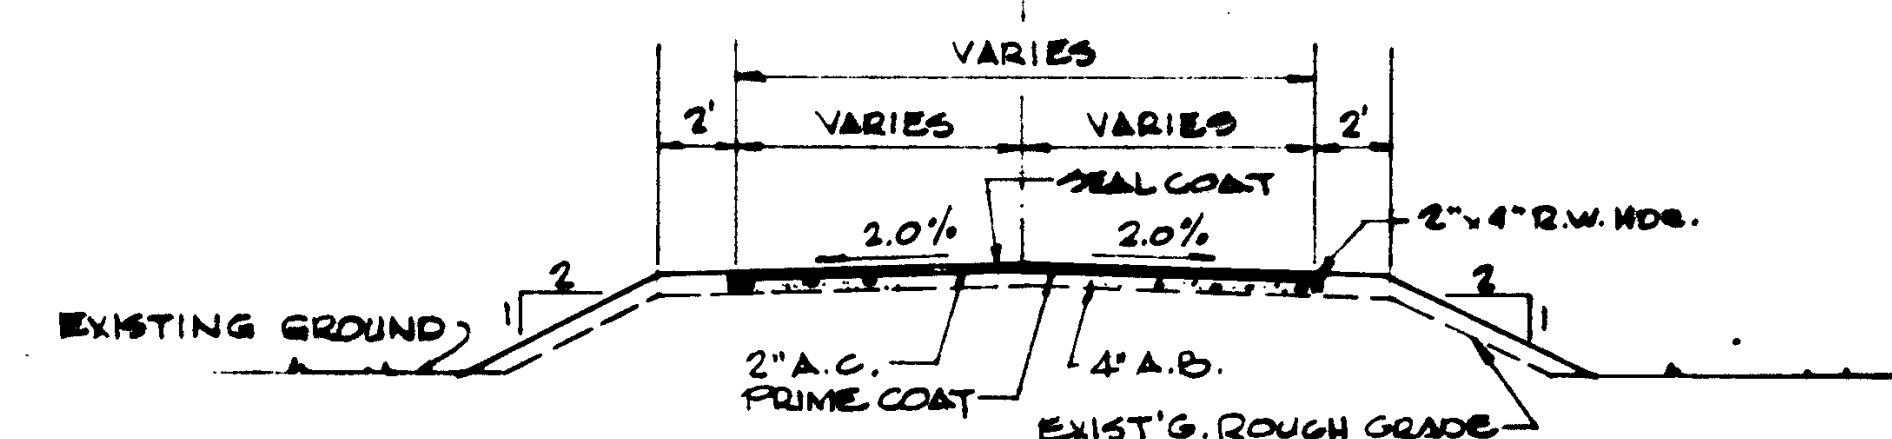SCALE NONE

C.B. NO.	TYPE
1	A
2	A
3	A
4	A
5	A
6	A
7	A
8	A
9	A
10	A
11	A
12	A
13	A
14	A
15	A
16	A




PLAN

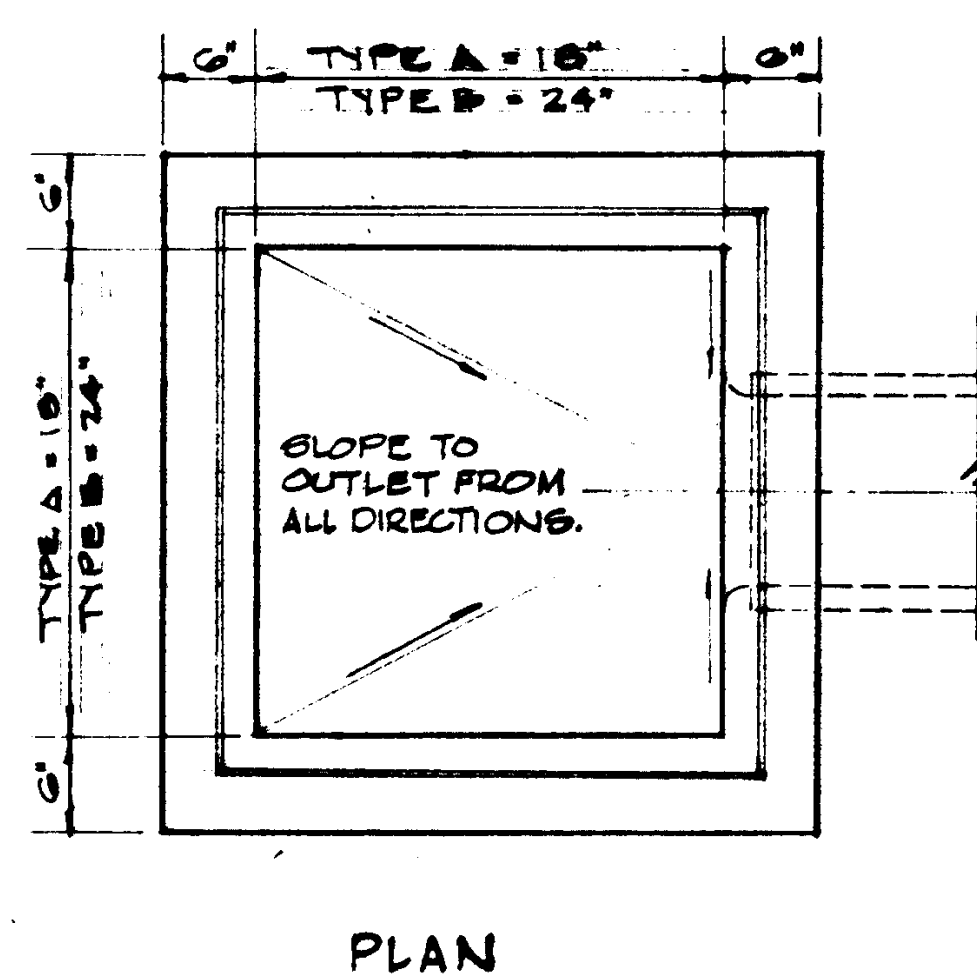

SPLASH WELL


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SECTION

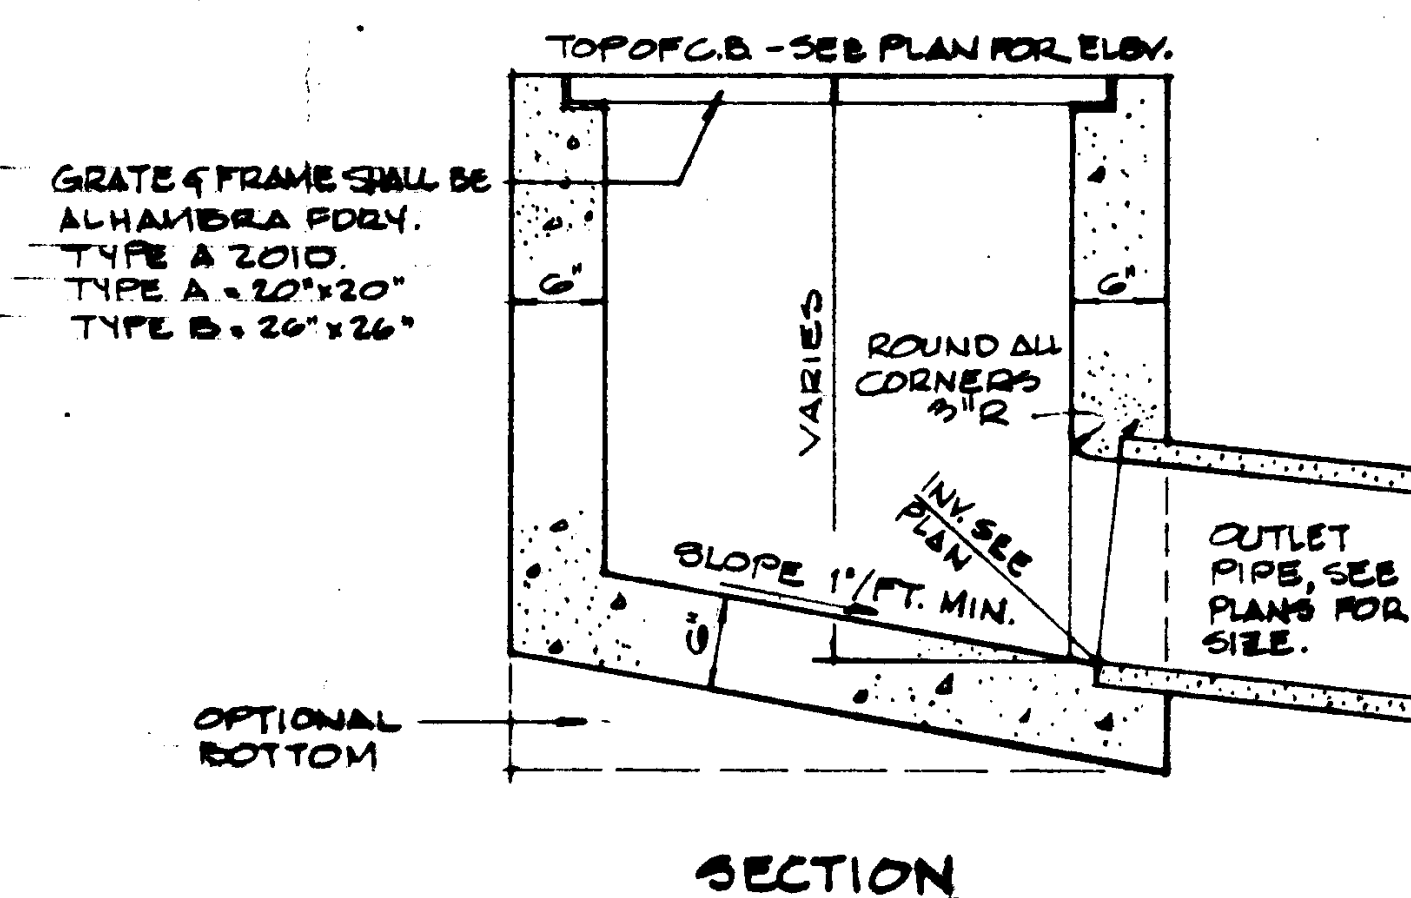
CATCH BASIN

SCALE NONE




C.M.P. CULVERTS

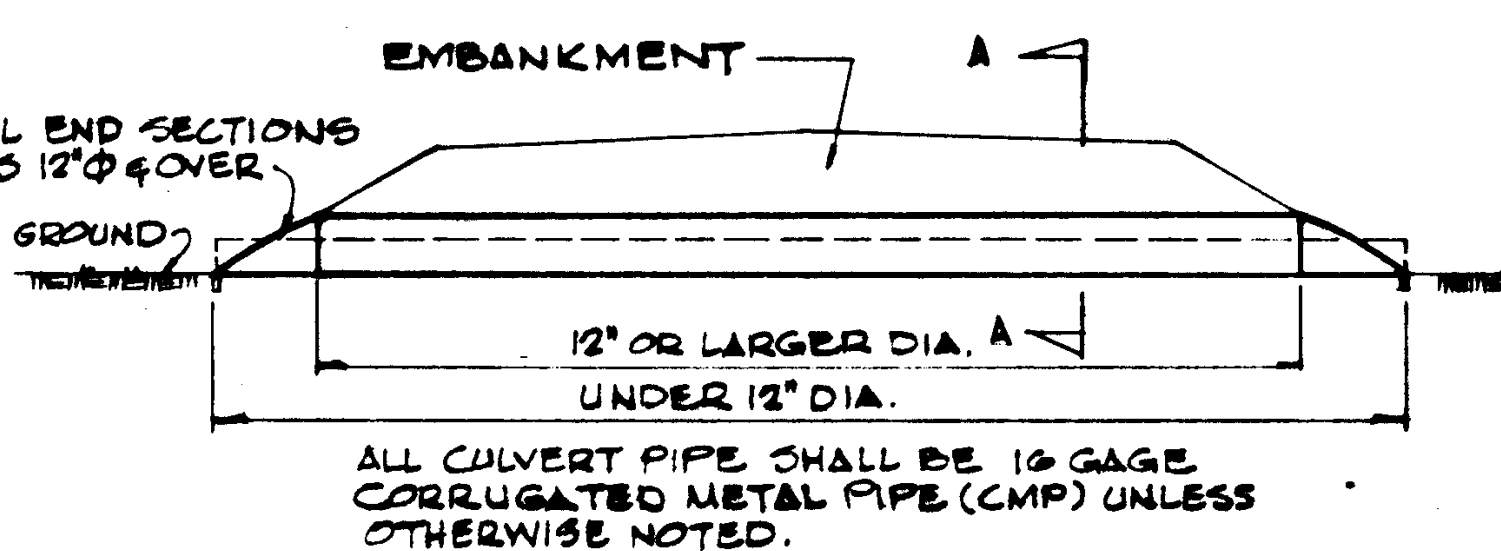SCALE NONE

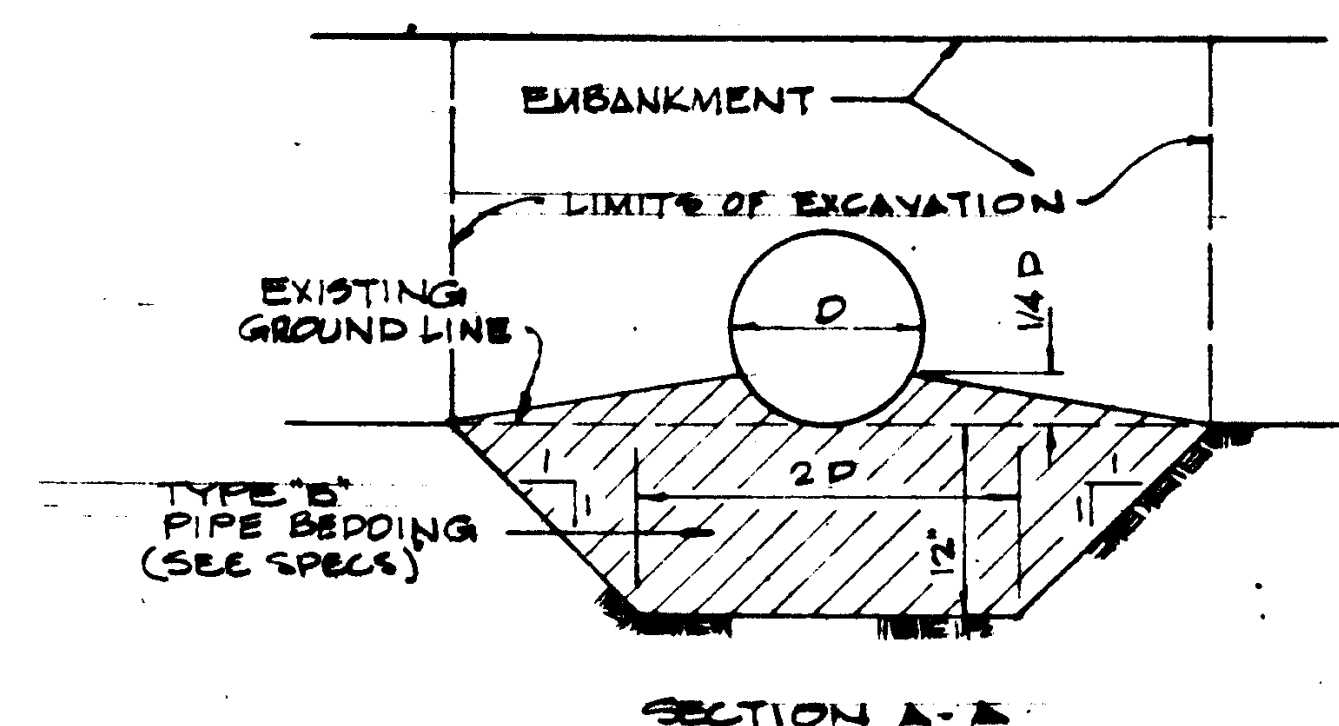


SECTION A-A

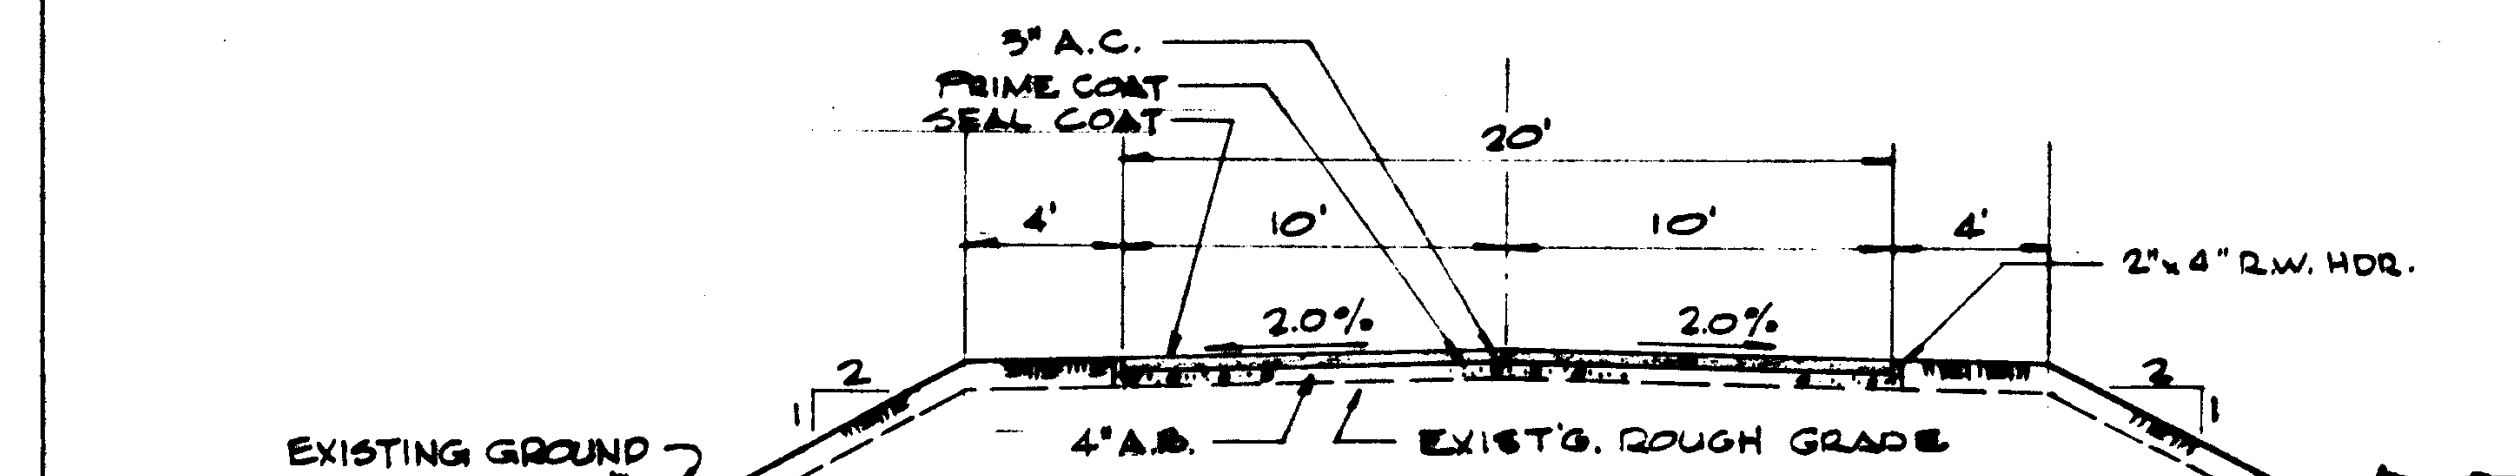


ASPHALTIC CONCRETE ROADS

SCALE NONE

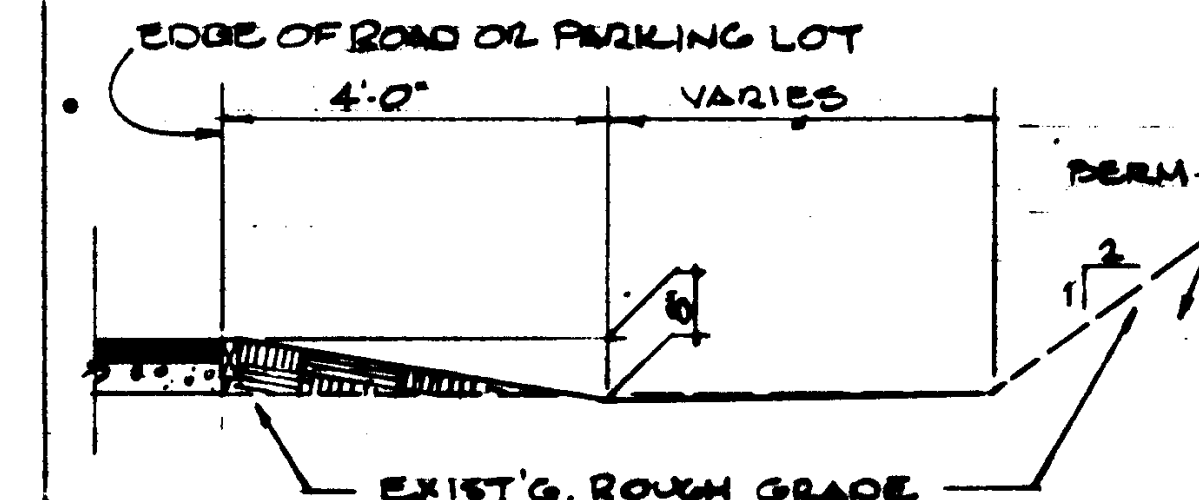

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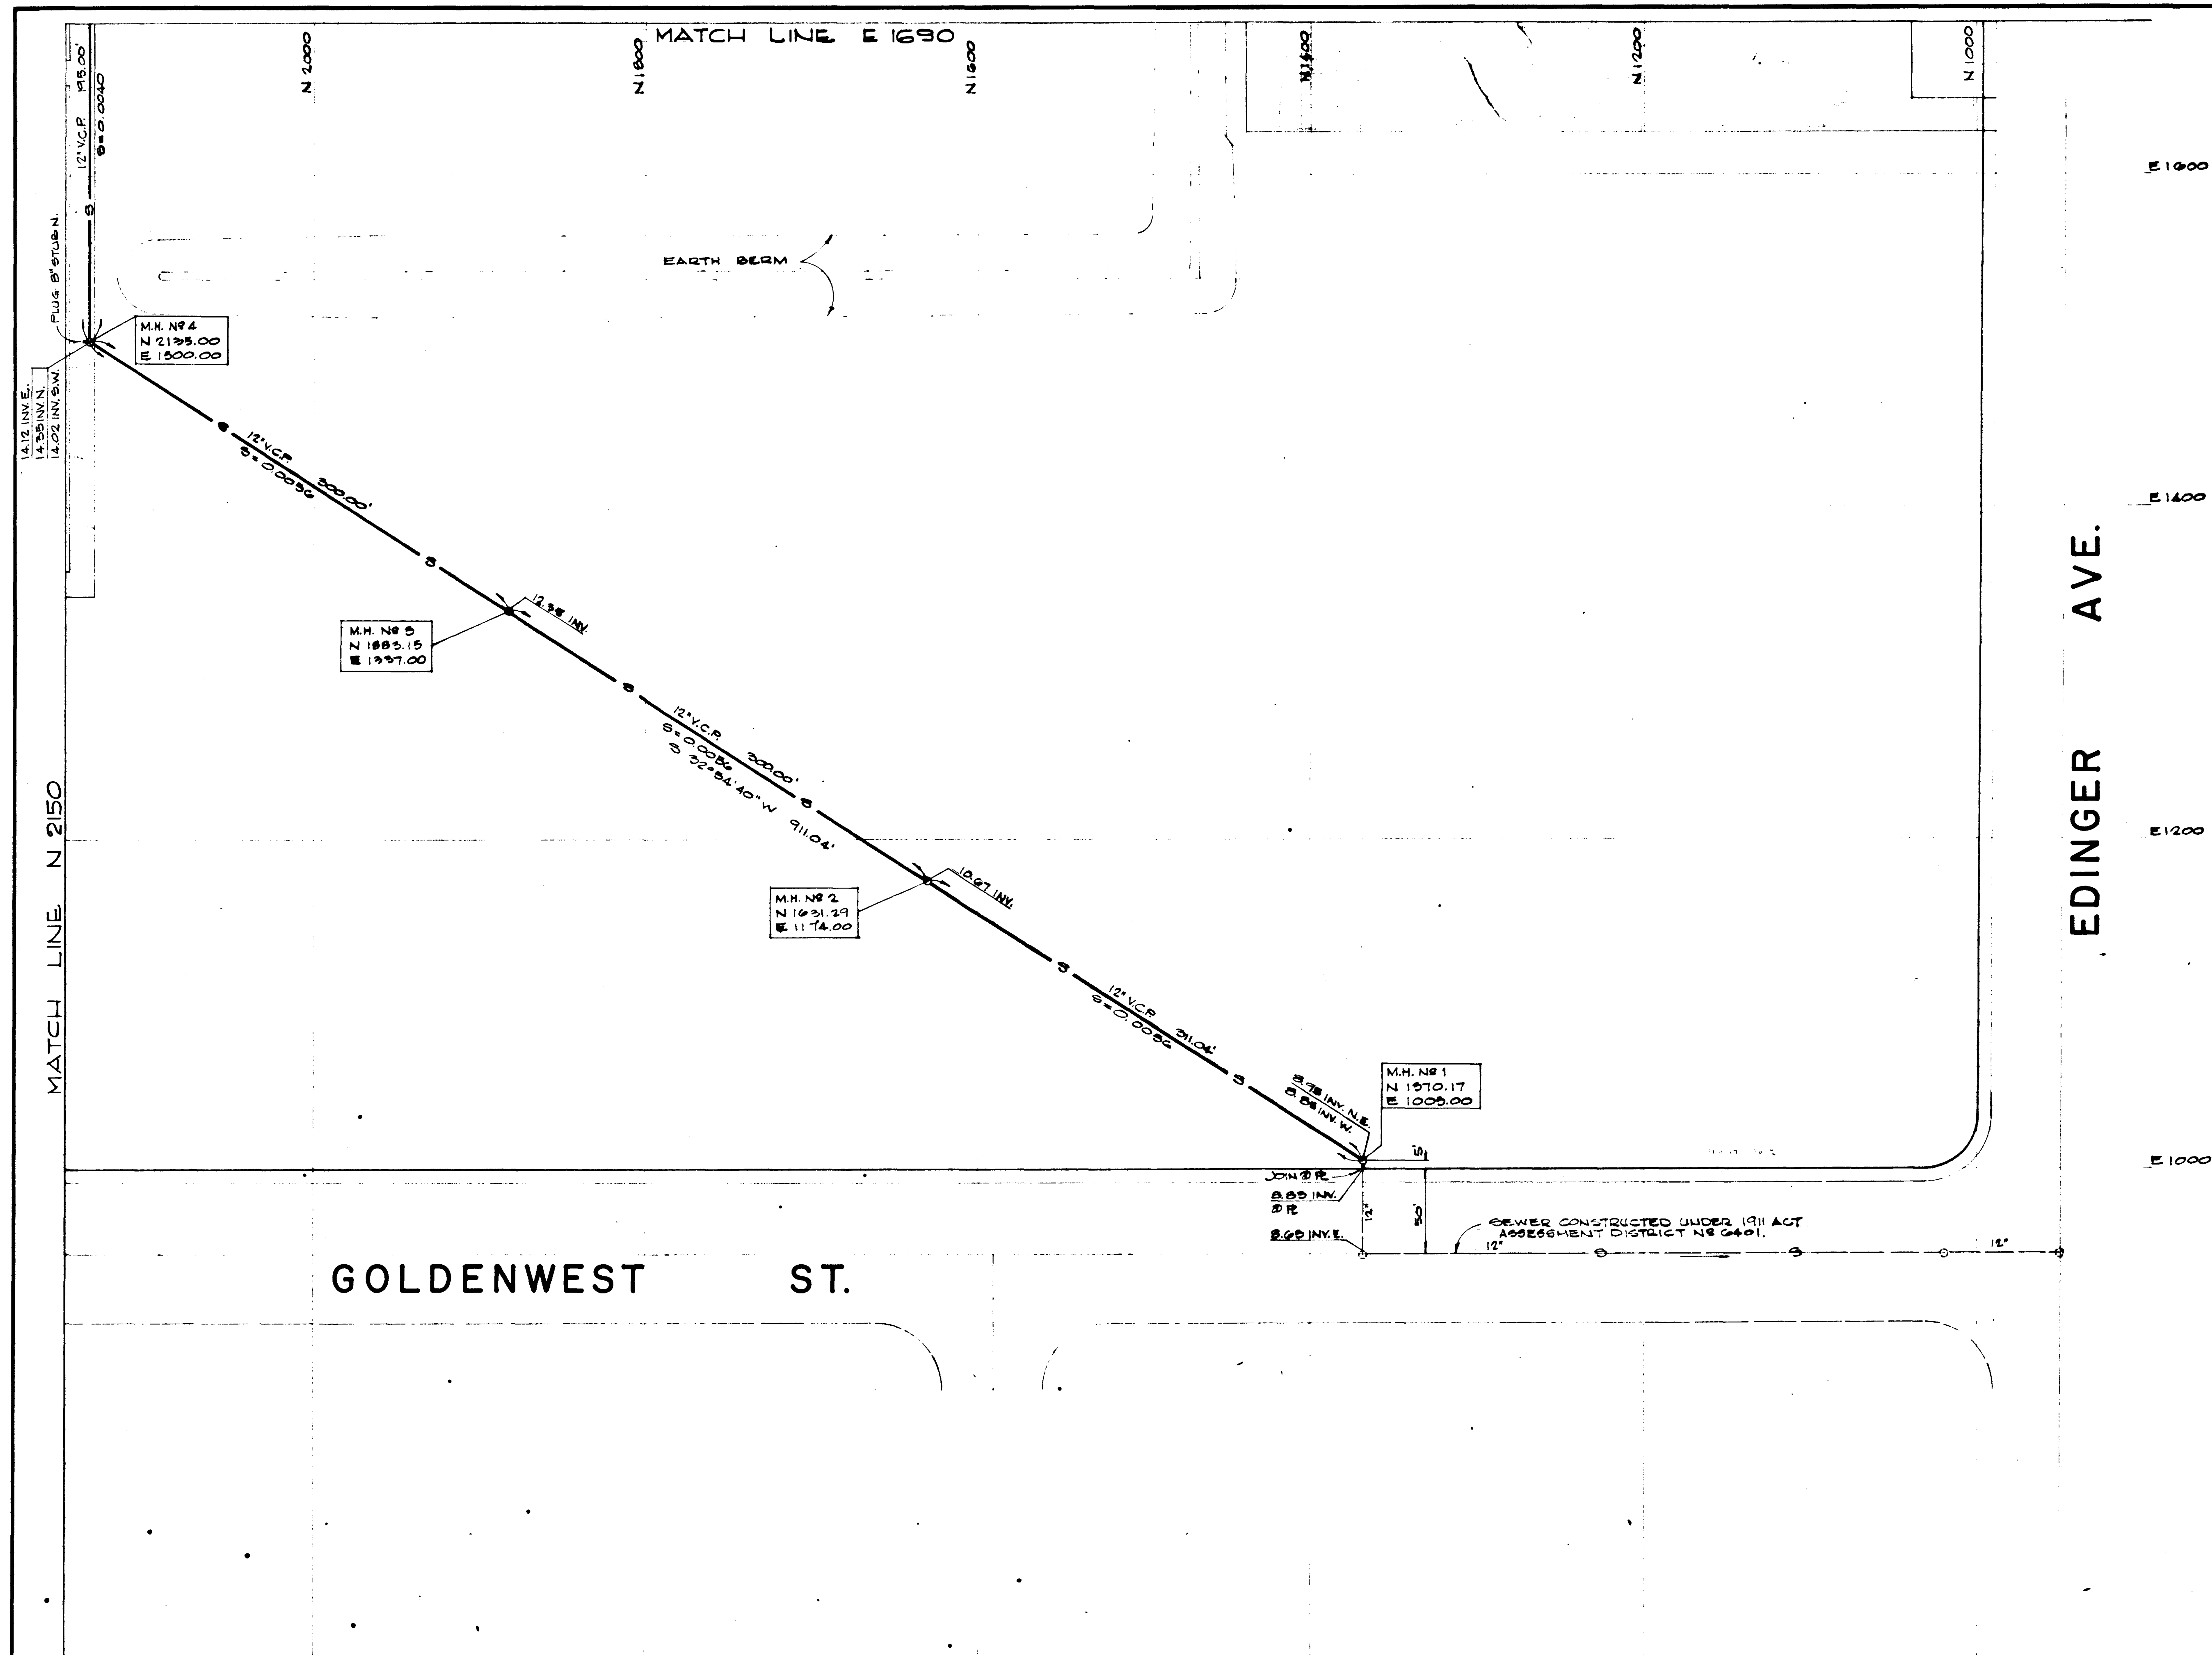
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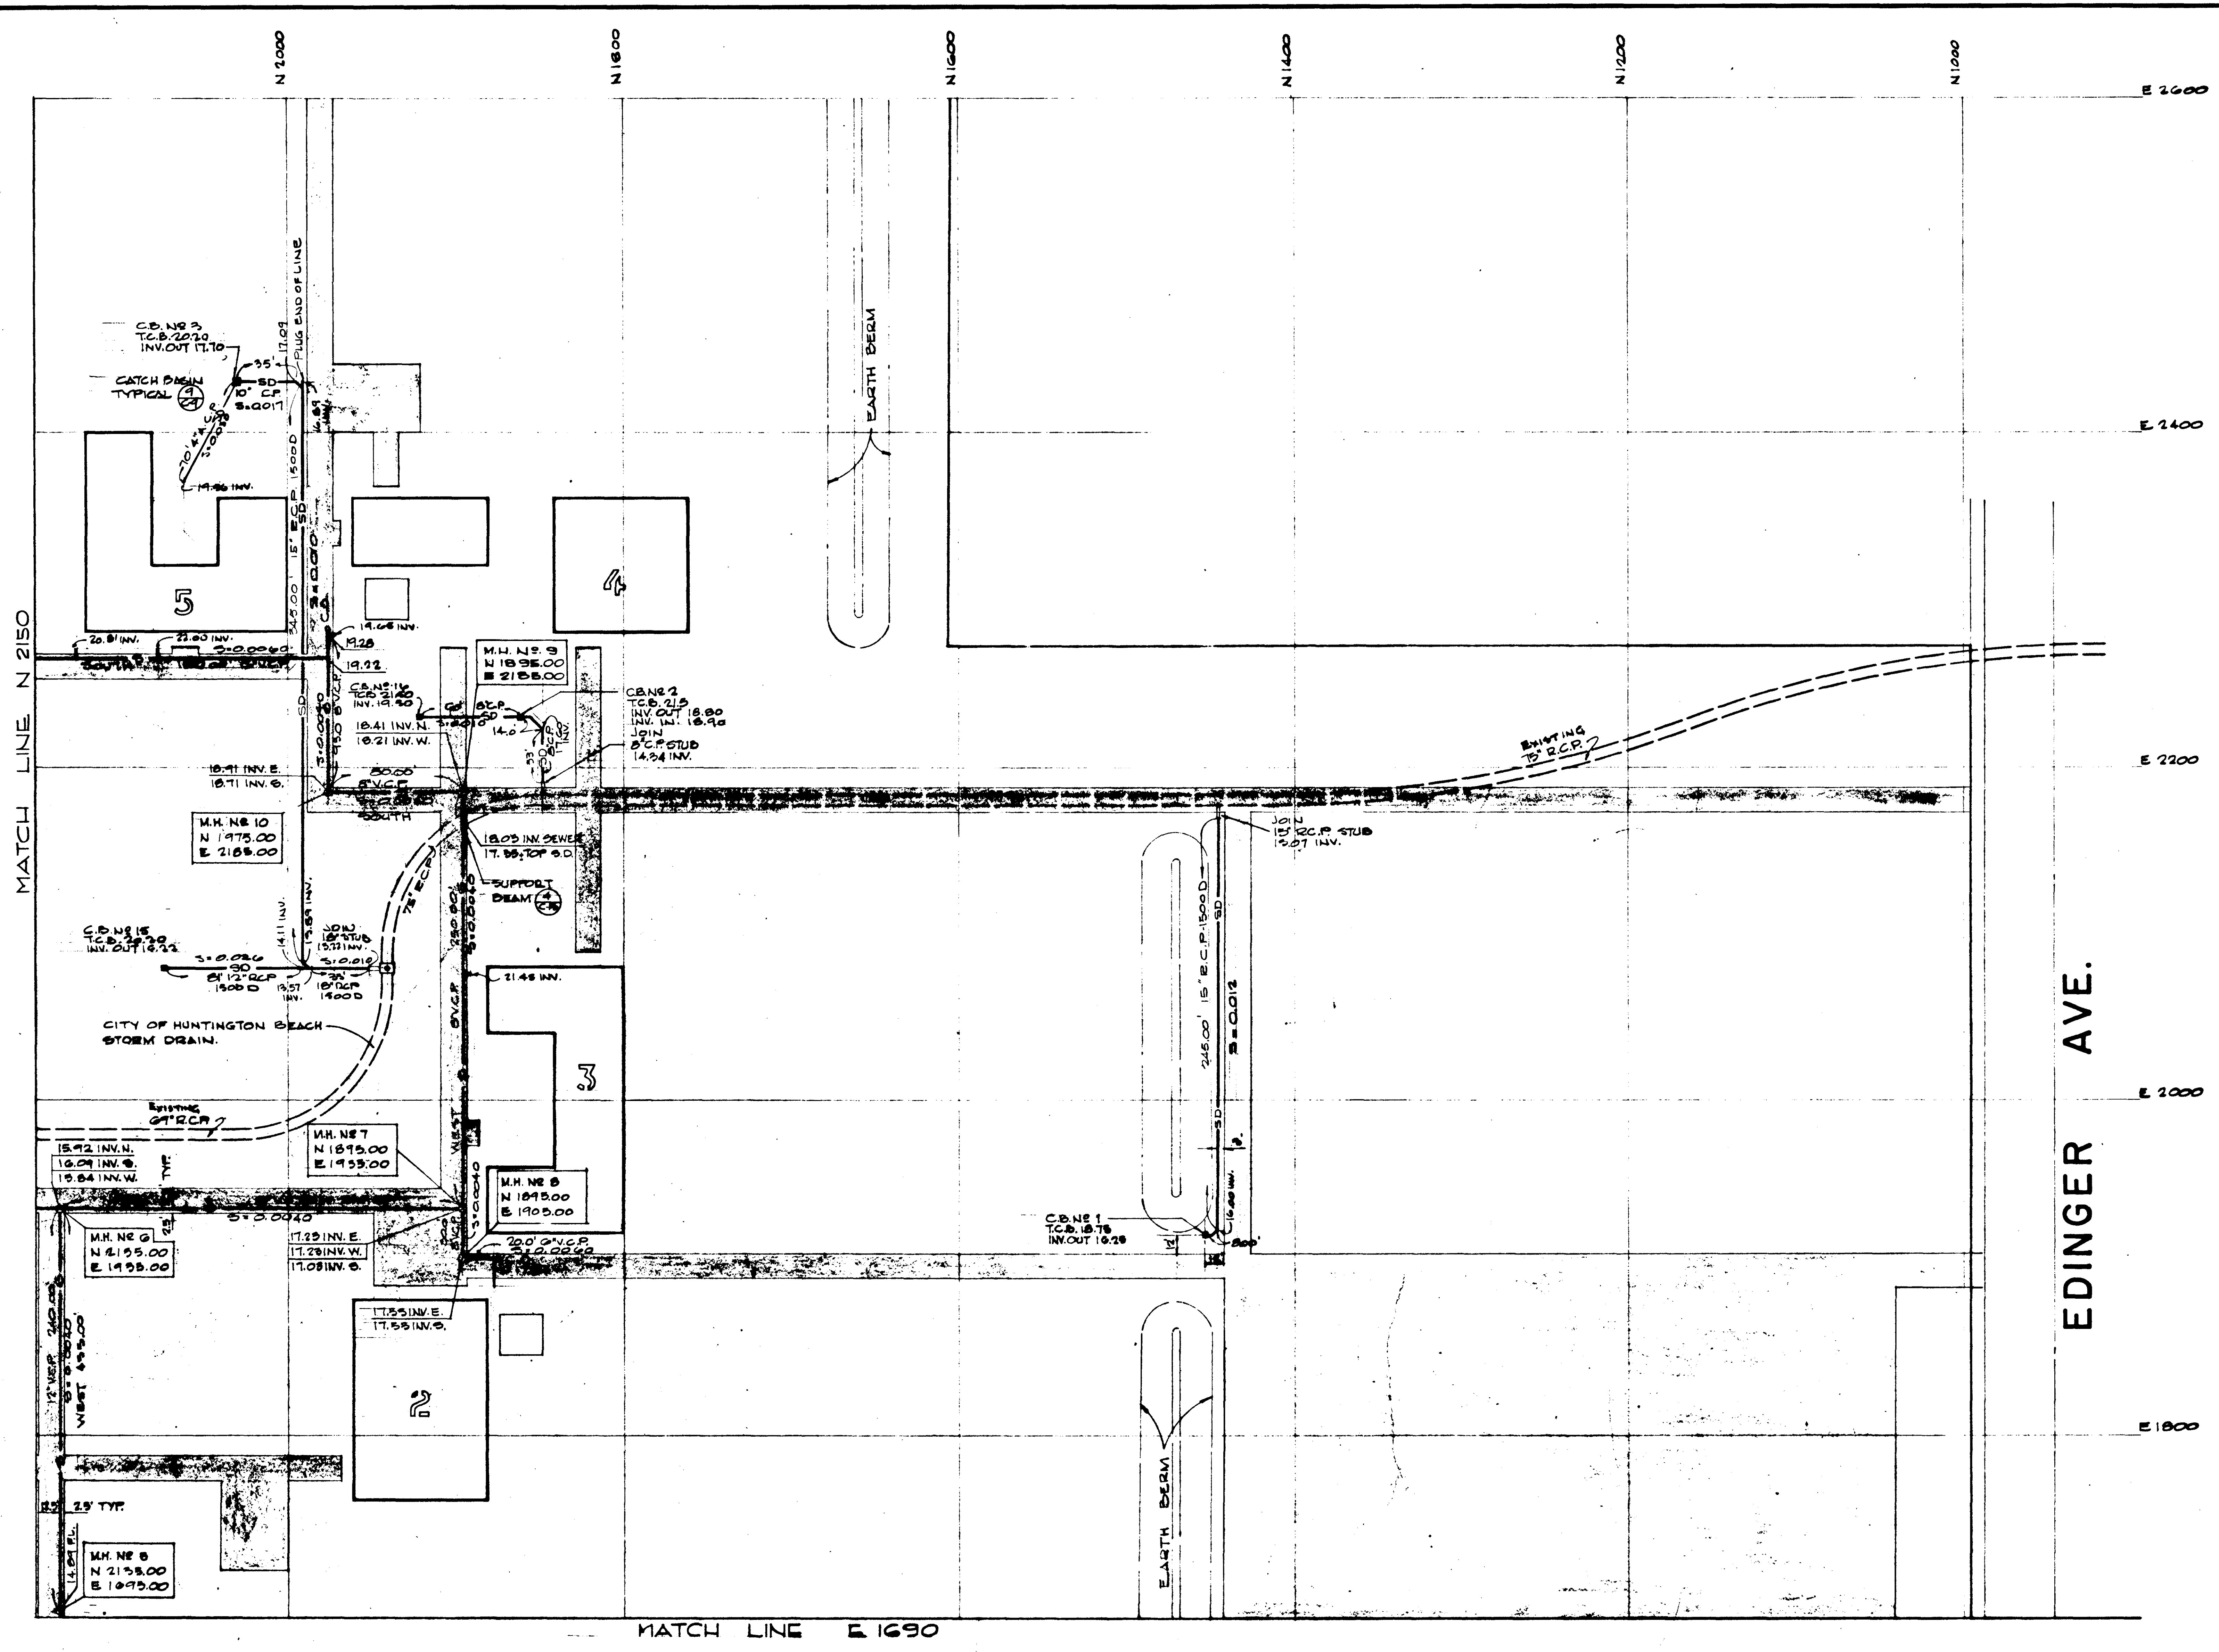
PARKING LOT SECTION

SCALE NONE

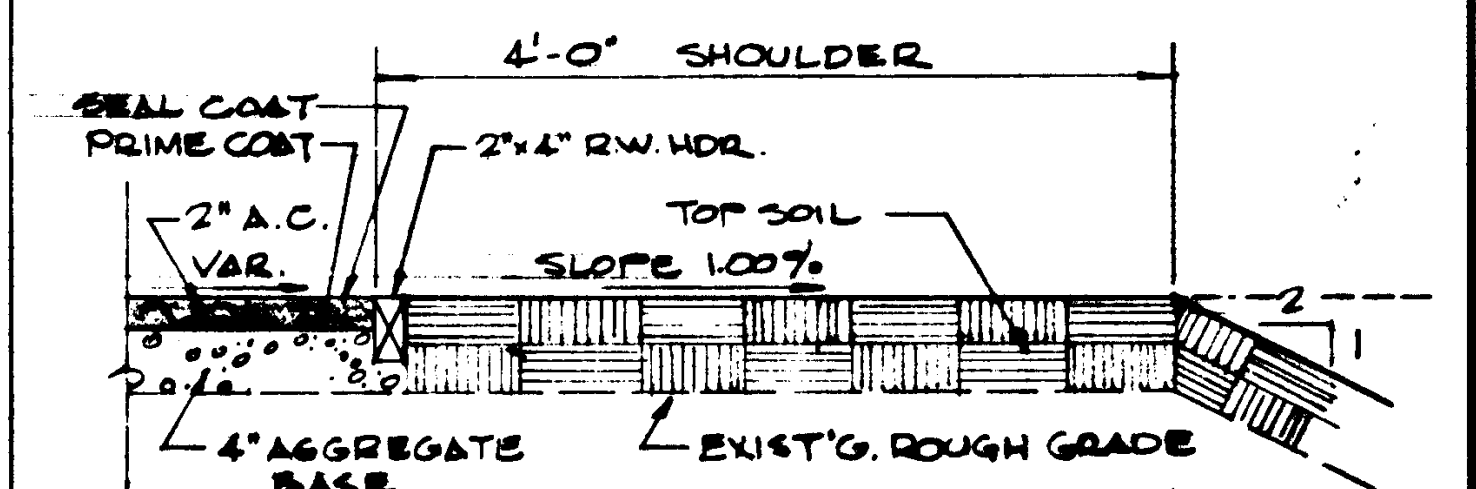
STRUCTURAL ENGINEERS BRADY & JOHNSON J.A. MARTIN & ASSOCIATES RALPH E. PHILLIPS, INC. ELECTRICAL ENGINEERS RALPH E. PHILLIPS, INC. CIVIL ENGINEERS G. BRUMMAN & ASSOCIATES MOTT & STONE		DESIGNED P.A. DRAWN BY P.A. CHECKED BY P.J. DATE JUN 21 1965	ARCHITECT WILLIAM L. PEREIRA & ASSOCIATES QUINCY JONES-FREDERICK E. EDMONS & ASSOCIATES BLUROCK MILLERBROOK & ASSOCIATES URBANUS SQUARE • MACARTHUR BOULEVARD AT FORD ROAD TELEPHONE 714/675-2640 • CORONA DEL MAR, CALIFORNIA	APPROVED STATE FIRE MARSHAL STATE OF CALIFORNIA DATE JUN 21 1965 25874 APPROVED JUN 21 1965	GOLDEN WEST COLLEGE HUNTINGTON BEACH, CALIFORNIA ORANGE COAST JUNIOR COLLEGE DISTRICT	DETAILS GRADING PLANS JOB NO. 104 DATE 6-15-65 SHEET NO. (C-3)
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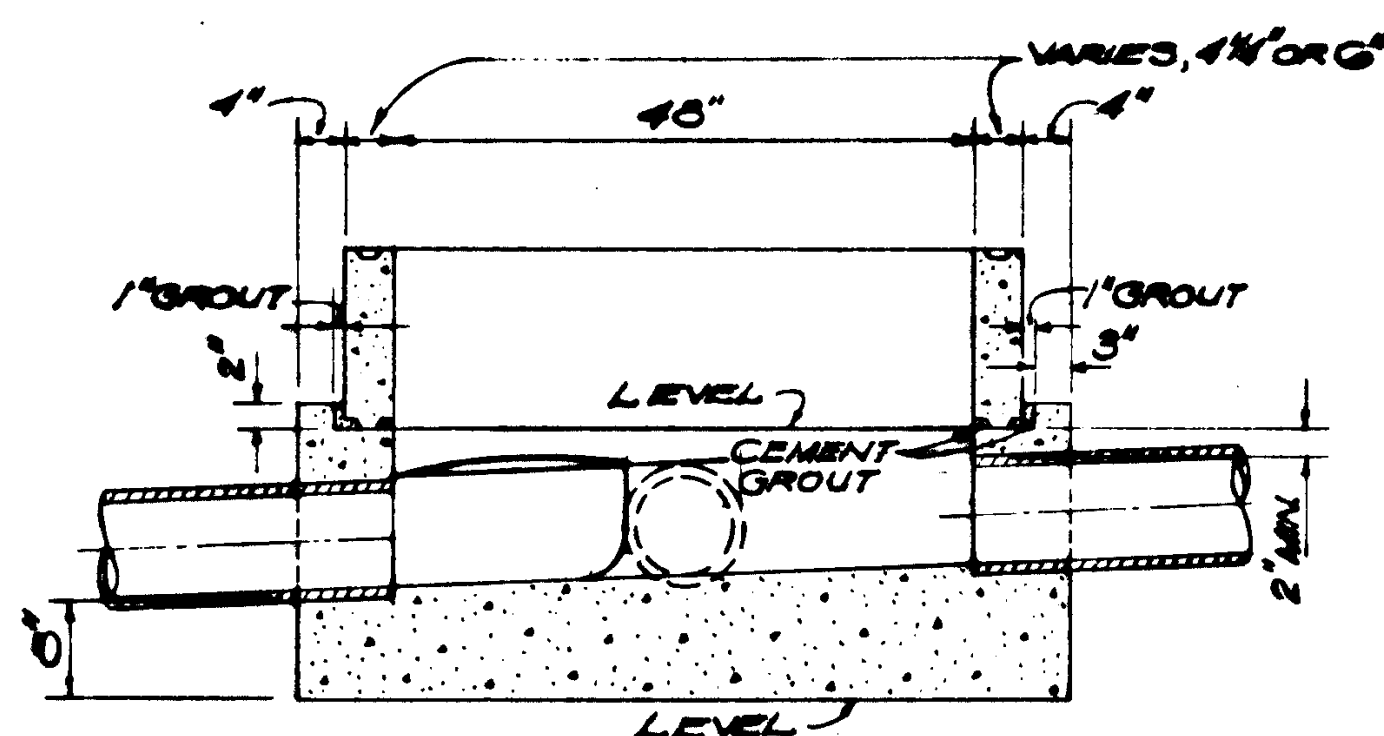
STRUCTURAL ENGINEERS BRANDOW & JOHNSTON J.A. MARTIN & ASSOCIATES		DESIGNED J.H.	ARCHITECT William L. Pereira	APPROVED William L. Pereira	ASSOCIATED ARCHITECTS: WILLIAM L. PEREIRA & ASSOCIATES A. QUINCY JONES, FREDERICK E. EMMONS & ASSOCIATES BLUROCK ELLERBROEK & ASSOCIATES URBANUS SQUARE • MACARTHUR BOULEVARD AT FORD ROAD TELEPHONE 714/675-2640 • CORONA DEL MAR, CALIFORNIA	GOLDEN WEST COLLEGE HUNTINGTON BEACH, CALIFORNIA ORANGE COAST JUNIOR COLLEGE DISTRICT	AREA - 1	JOB NO. 100-1
MECHANICAL ENGINEERS RALPH E. PHILLIPS, INC.		DRAWN BY S.H.	ENGINEER	APPROVED S.H.			STORM DRAIN	DATE 6-15-65
ELECTRICAL ENGINEERS RALPH E. PHILLIPS, INC.		CHECKED BY P.A.	COLLEGE	STATE FIRE MARSHAL STATE OF CALIFORNIA JUN 21 1965			AND SEWER PLAN	SHEET NO. C-10
CIVIL ENGINEERS G. SHUIMAN & ASSOCIATES MOFFATT & WICKOL								



STRUCTURAL ENGINEERS RANDOLPH & JOHNSON J.A. MARTIN & ASSOCIATES MECHANICAL ENGINEERS RALPH E. PHILLIPS, INC. ELECTRICAL ENGINEERS RALPH E. PHILLIPS, INC. CIVIL ENGINEERS O. SHULMAN & ASSOCIATES MOFFATT & NICHOL		DESIGNED BY J.A. MARTIN CHECKED BY J.M.	ARCHITECT WILLIAM L. FERRERA ENGINEER COLLEGE	APPROVED STATE FIRE MARSHAL STATE OF CALIFORNIA DATE JUN 21 1965 25574 APPROVED JUN 21 1965	ASSOCIATED ARCHITECTS: WILLIAM L. FERRERA & ASSOCIATES A QUINCY JONES-FREDERICK E. EDMONDS & ASSOCIATES BLUROCK ELLERBROEK & ASSOCIATES URBANUS SQUARE • MACARTHUR BOULEVARD AT FORD ROAD TELEPHONE 714/675-2640 • CORONA DEL MAR, CALIFORNIA	GOLDEN WEST COLLEGE HUNTINGTON BEACH, CALIFORNIA ORANGE COAST JUNIOR COLLEGE DISTRICT	AREA - 2 STORM DRAIN AND SEWER PLAN	SCALE 1"=40' JOB NO. 104 DATE 6-15-65 SHEET NO. C-11
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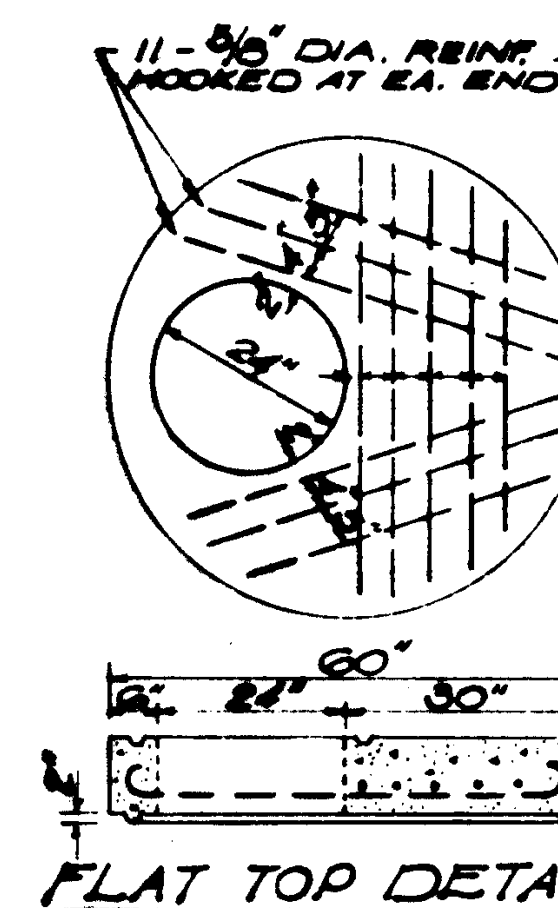


MANHOLE BASE
PLAN

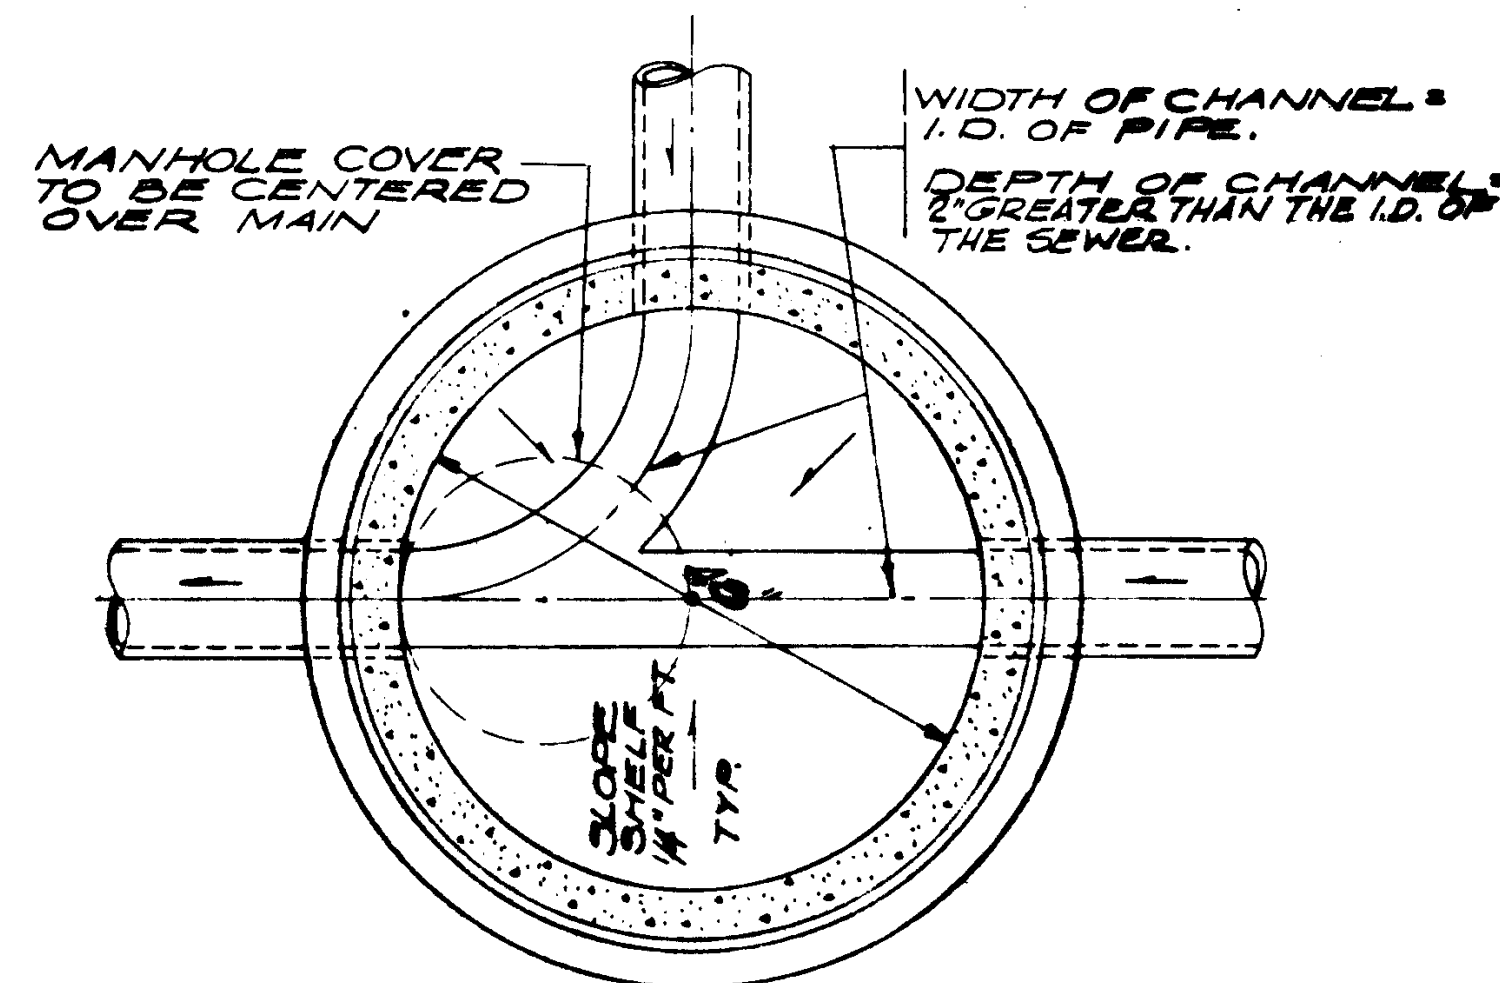


MANHOLE BASE
SECTION


- NOTES
1. MANHOLE COVER AND FRAME SHALL BE ALHAMBRA POUNDRY NO. A-12541
 2. STEPS SHALL BE OF THE SAFETY STIRRUP TYPE, 3/4" GALVANIZED STEEL, CAST IN PLACE AT TIME OF MANUFACTURE.




FLAT TOP DETAIL

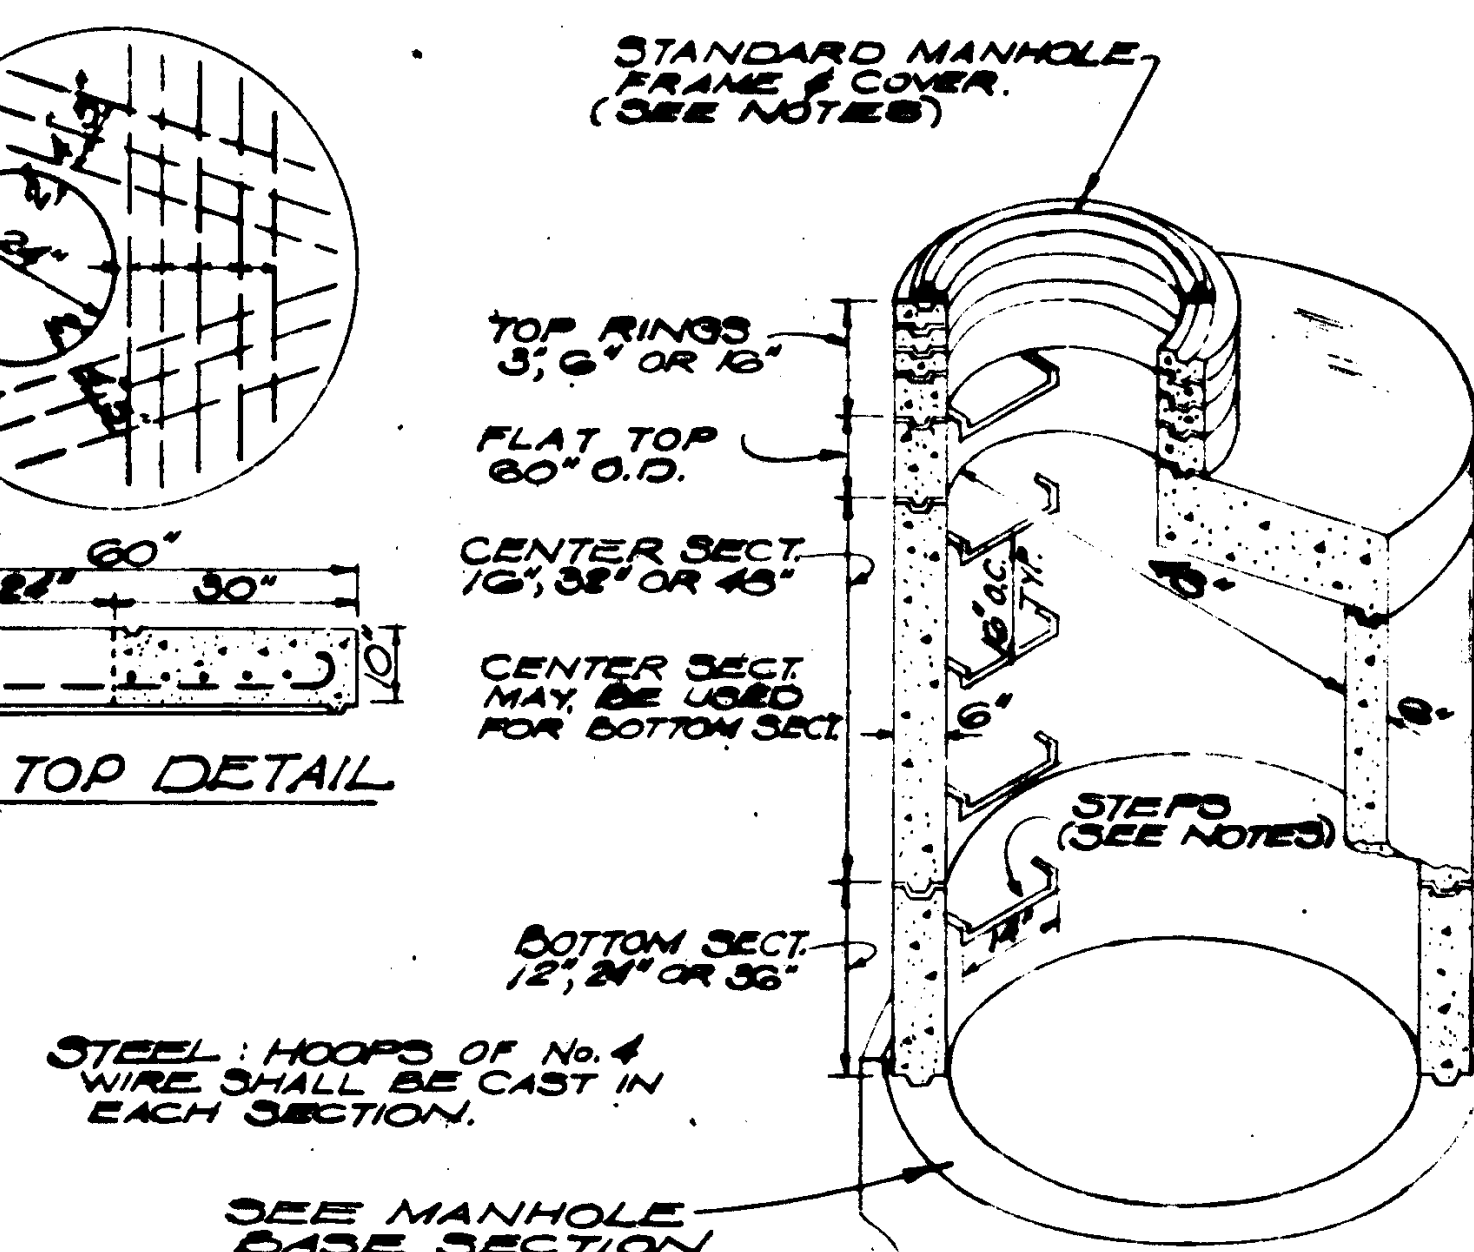


NOTE: THIS TYPE MANHOLE SHALL BE USED WHEN DEPTH OF MANHOLE FROM TOP OF COVER TO INVERT OF SEWER IS 8'-6" OR LESS.

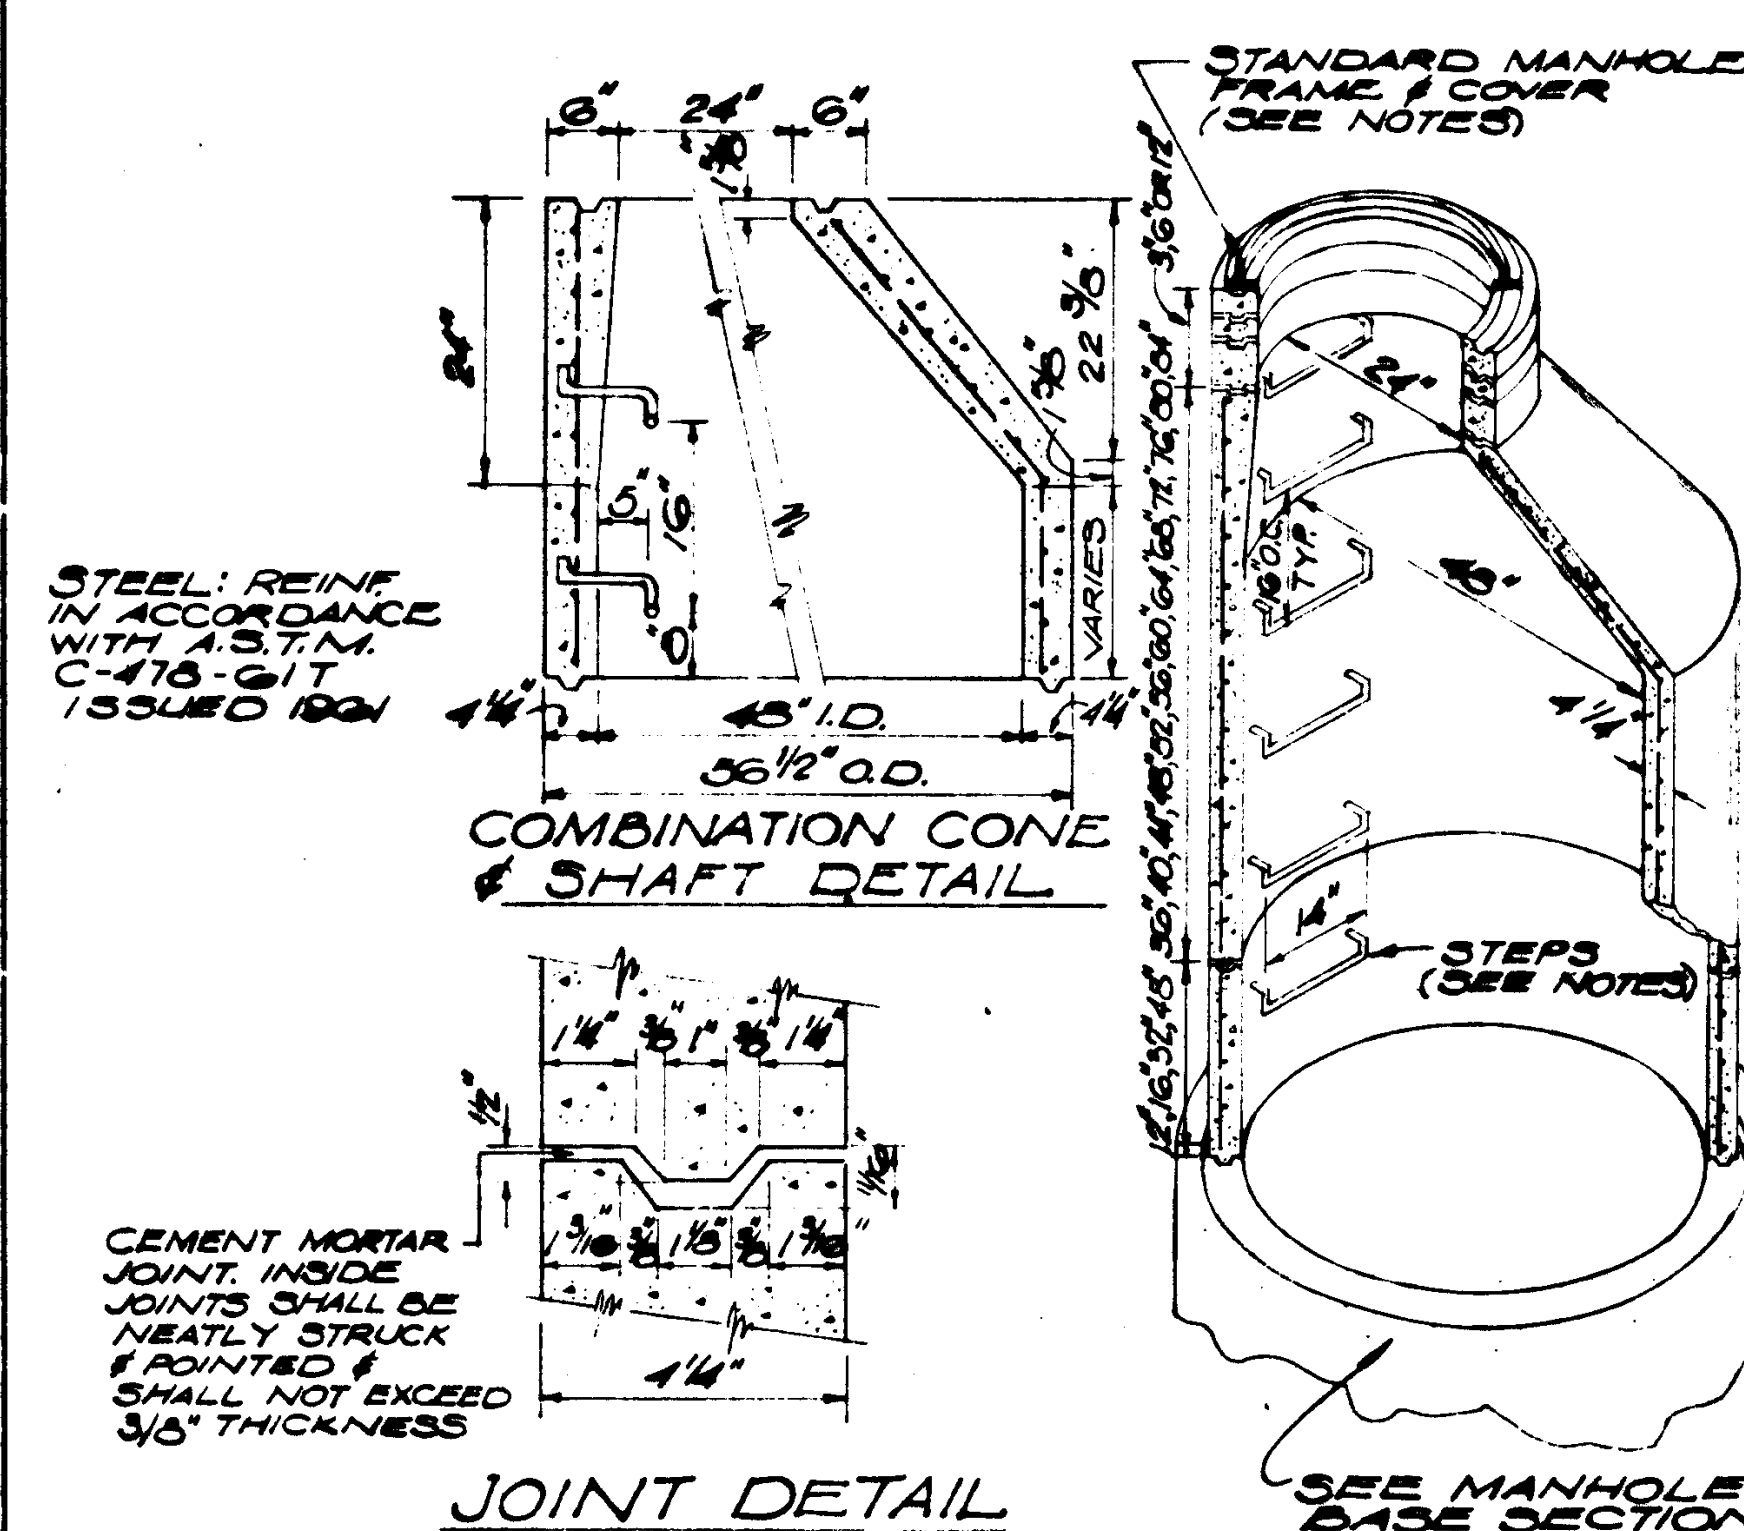


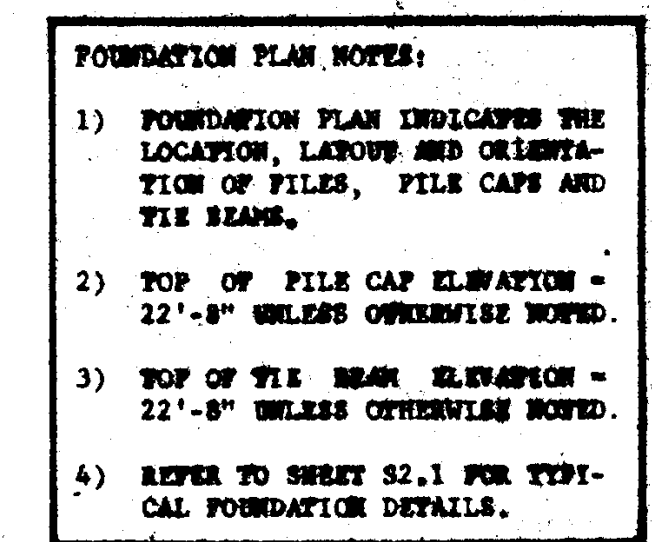

SCALE 1/8"	1
JOB NO.	
DATE	
1965	
SHEET NO.	
S 1.1	


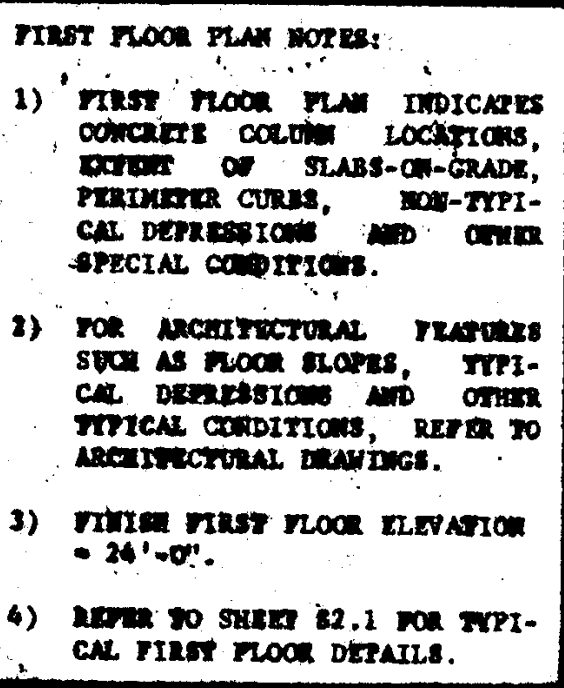


13 APR.

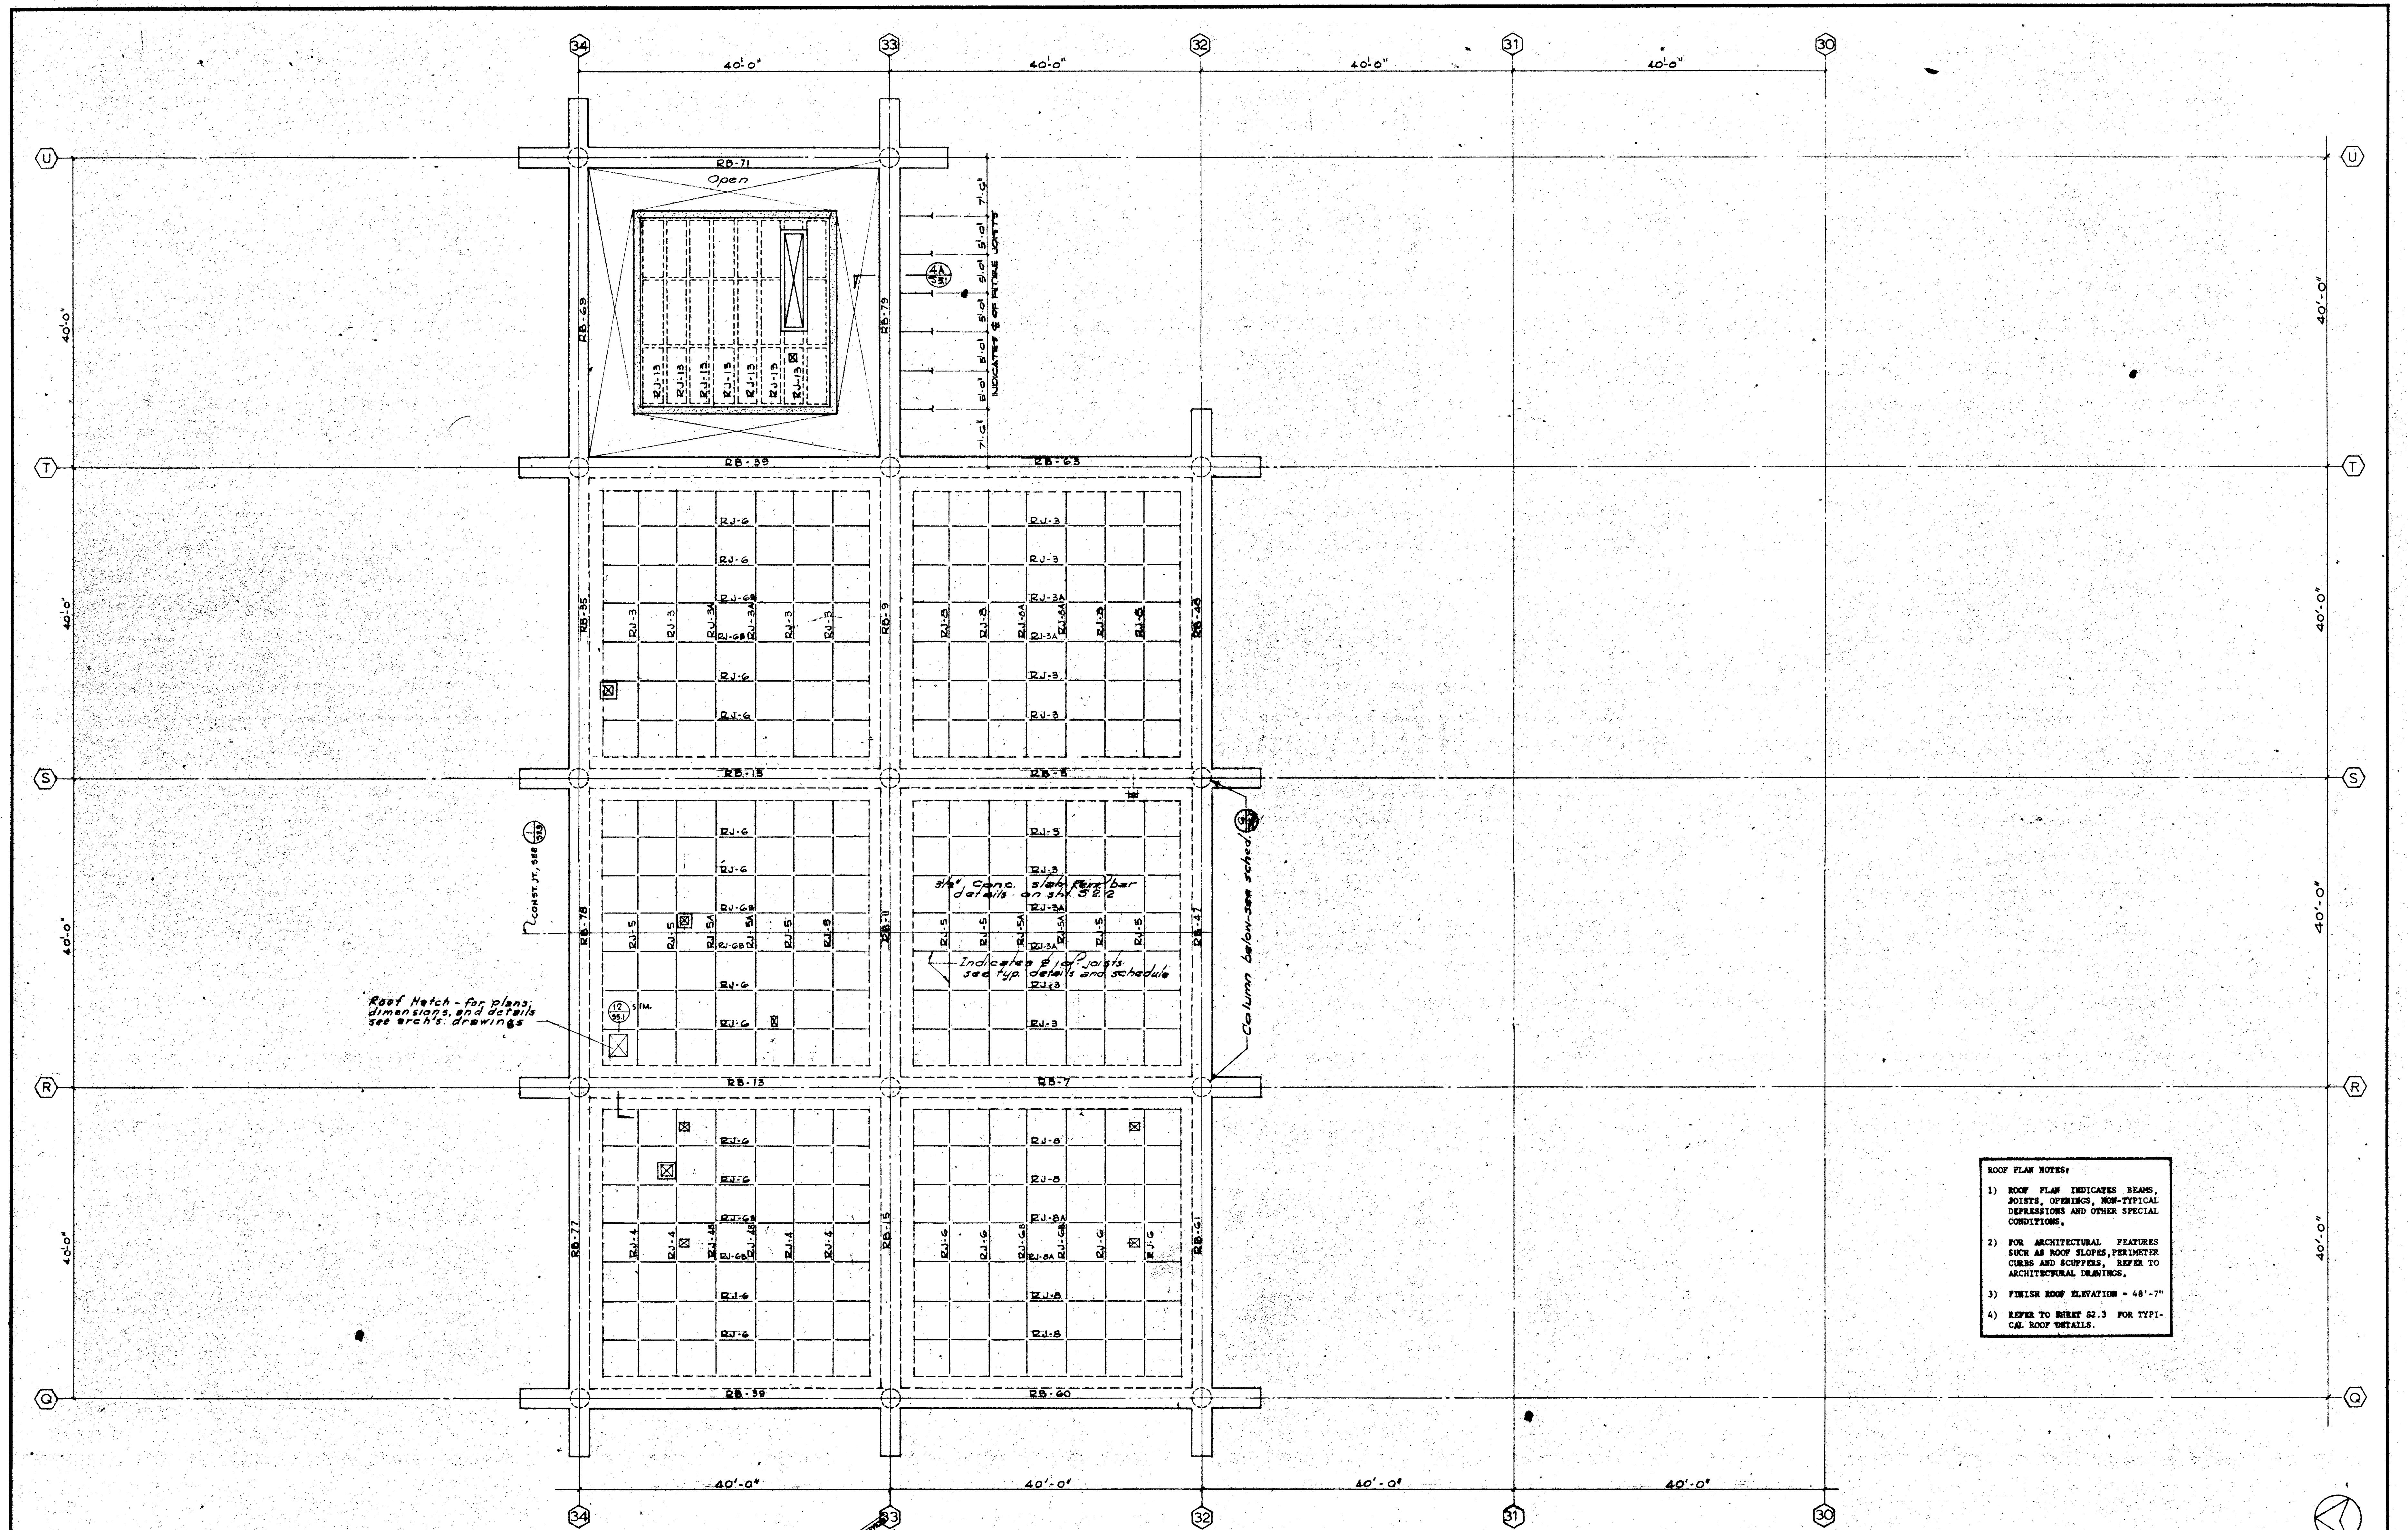


- ROOF PLAN NOTES:
- 1) ROOF PLAN INDICATES BEAMS, JOISTS, OPENINGS, NON-TYPICAL DEPRESSIONS AND OTHER SPECIAL CONDITIONS.
 - 2) FOR ARCHITECTURAL FEATURES SUCH AS ROOF SLOPES, PERIMETER CURBS AND COPPERS, REFER TO ARCHITECTURAL DRAWINGS.
 - 3) FINISH ROOF ELEVATION = 48'-7"
 - 4) REFER TO SHEET S2.3 FOR TYPICAL ROOF DETAILS.



STRUCTURAL ENGINEERS BRADY & JOHNSON 14. MARTIN & ASSOCIATES MECHANICAL ENGINEERS RALPH E. PHILLIPS, INC. ELECTRICAL ENGINEERS RALPH E. PHILLIPS, INC. CIVIL ENGINEERS G. SHURTMAN & ASSOCIATES MOFFATT & NICROL		DESIGNED DRAWN BY CHECKED BY APPROVED STATE FIRE MARSHAL DATE JUN 21 1965 BY	ARCHITECT WILLIAM L. PEREIRA & ASSOCIATES A. QUINCY JONES-FREDERICK E. EMMONS & ASSOCIATES BLUROCK ELLERBROEK & ASSOCIATES URBANUS SQUARE • MACARTHUR BOULEVARD AT FORD ROAD TELEPHONE 714/675-2640 • CORONA DEL MAR, CALIFORNIA	GOLDEN WEST COLLEGE HUNTINGTON BEACH, CALIFORNIA ORANGE COAST JUNIOR COLLEGE DISTRICT	UNIT 1 ROOF PLAN	SCALE 1/8" = 1'-0" JOB NO. 104 DATE 10 JUN 1965 SHEET NO. S 1-4
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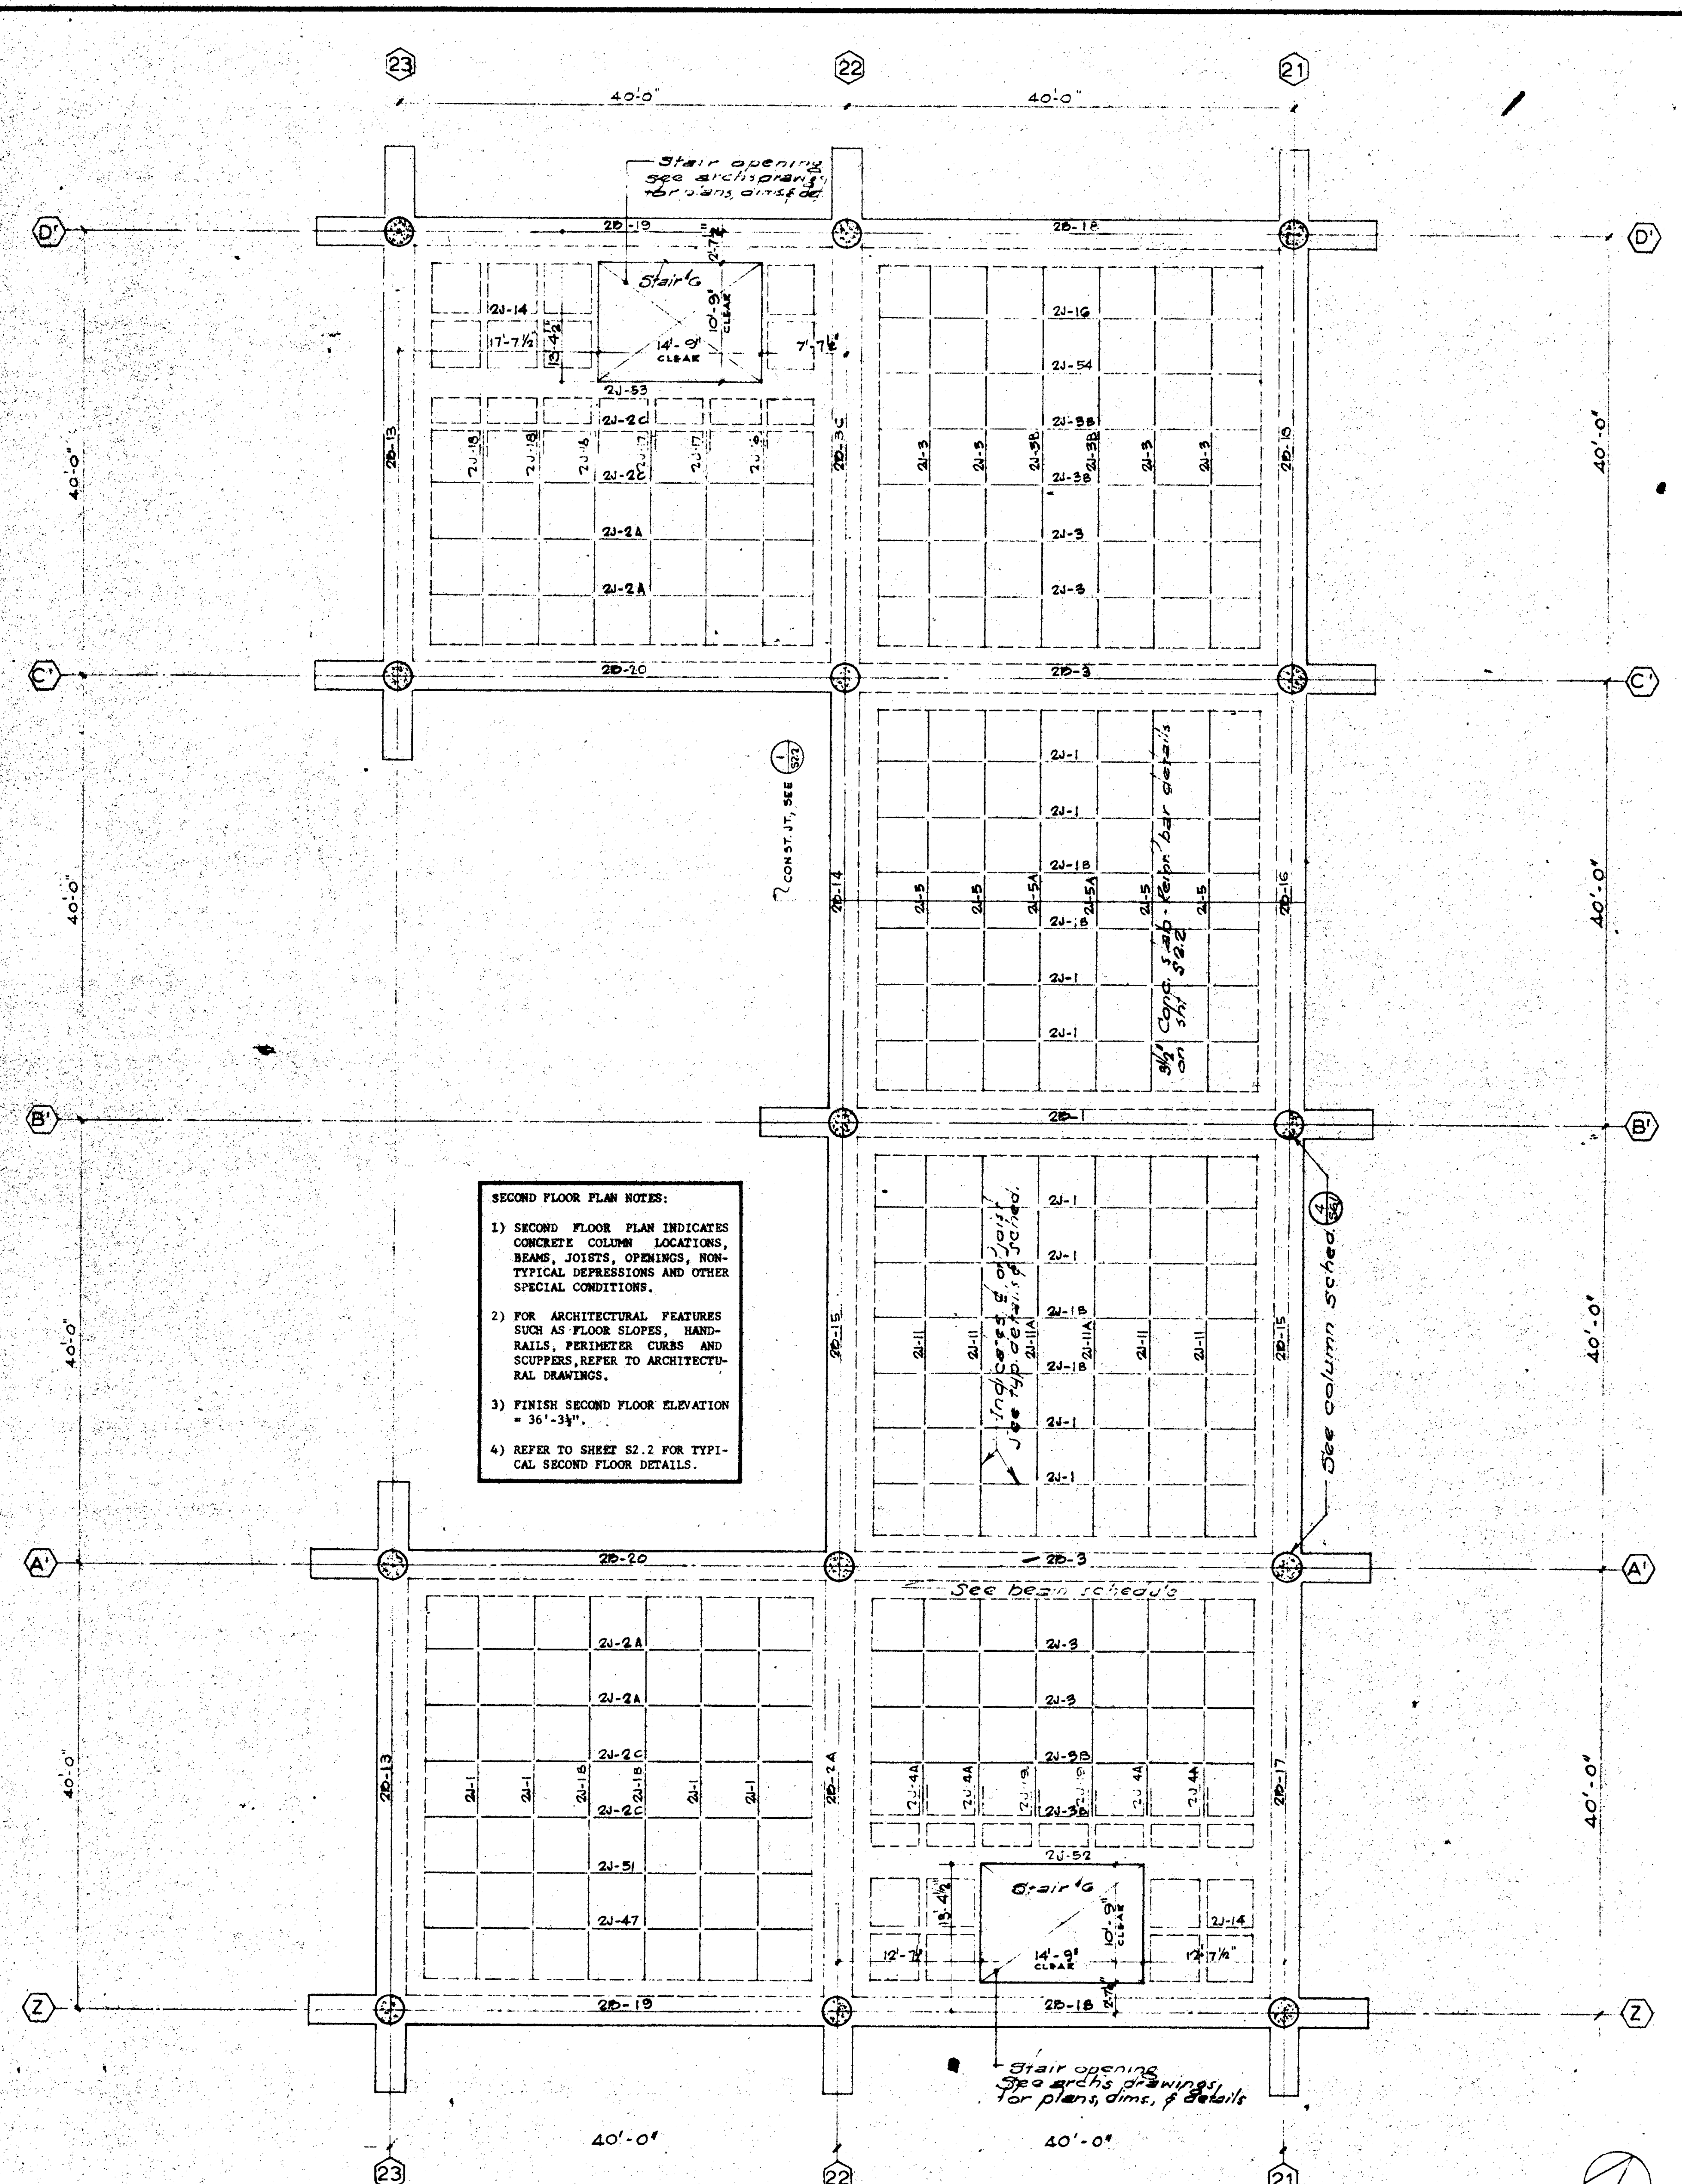
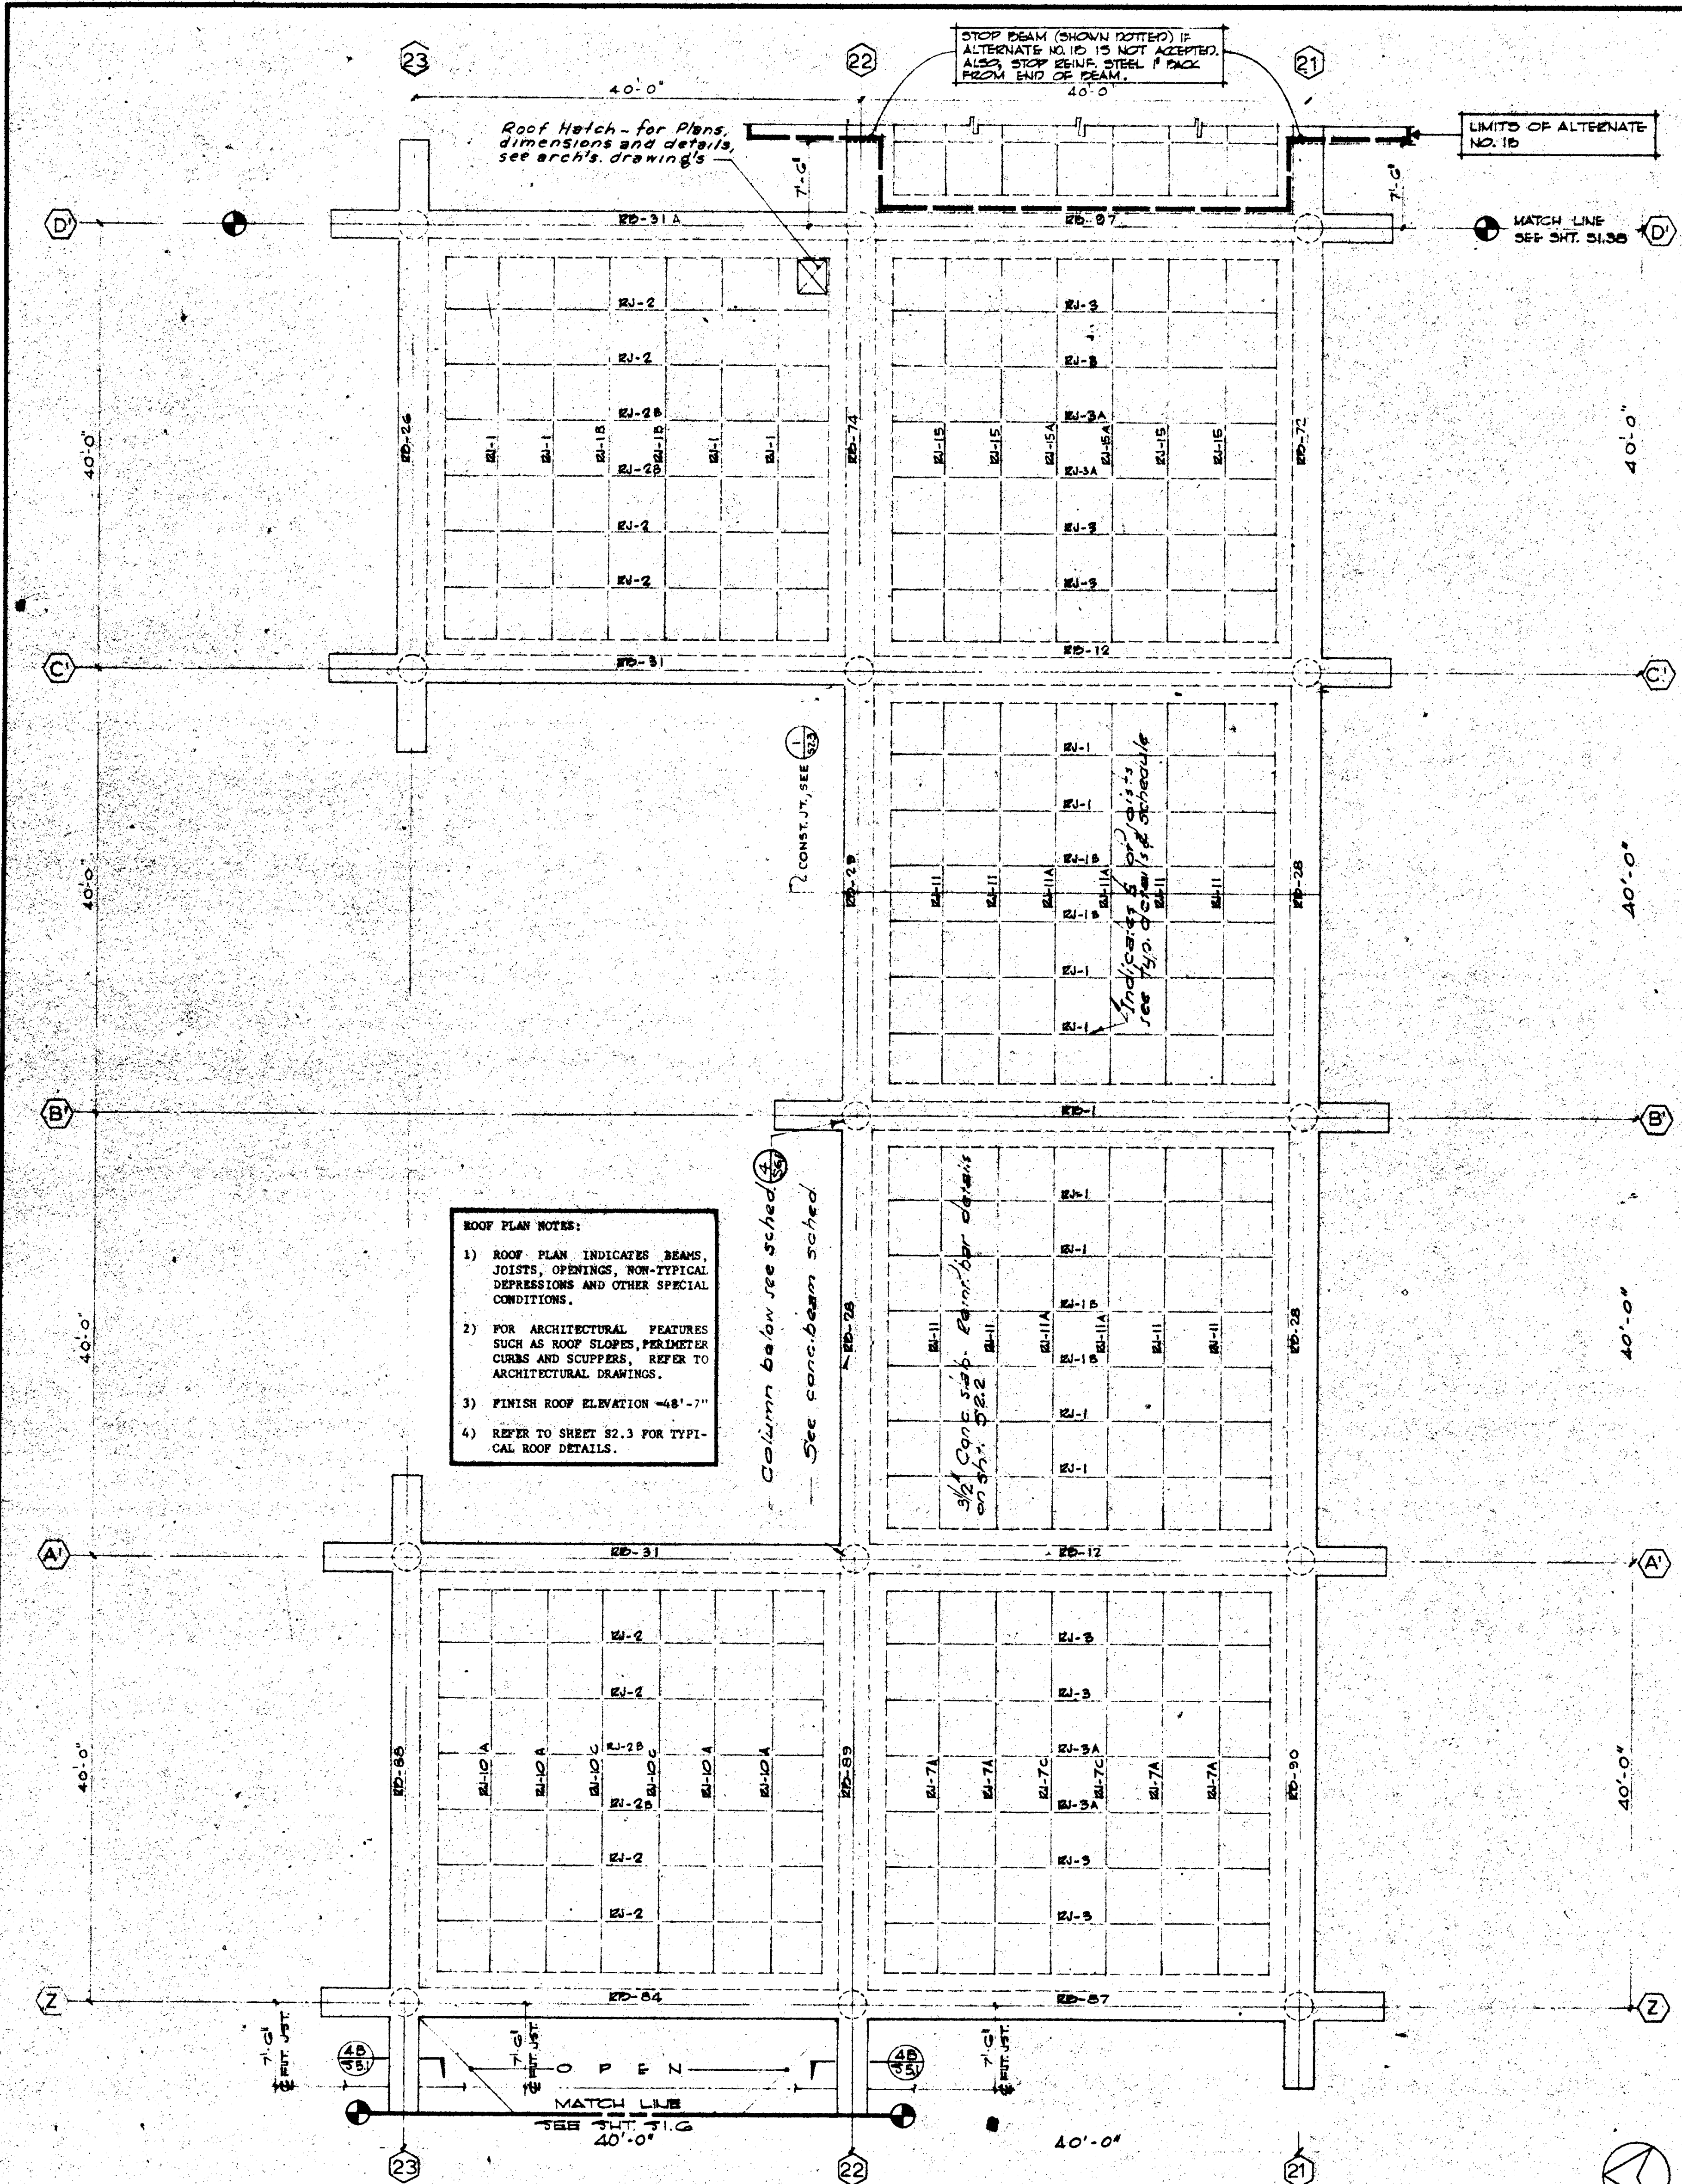
APPROVED STATE FIRE MARSHAL STATE OF CALIFORNIA DATE JUN 2 1965		FIRST FLOOR		FOUNDATION		SCALE 1/8" = 1'-0"
STRUCTURAL ENGINEERS BRADY & JOHNSON J.A. MARTIN & ASSOCIATES MECHANICAL ENGINEERS RALPH E. PHILLIPS, INC. ELECTRICAL ENGINEERS RALPH E. PHILLIPS, INC. CIVIL ENGINEERS G. SHURMAN & ASSOCIATES MOFFATT & NICHOL		DESIGNED J.C. DRAWN BY R.C.E. CHECKED BY A.C.		ARCHITECT WILLIAM L. PEREIRA & ASSOCIATES A. QUINCY JONES-FREDERICK E. EMMONS & ASSOCIATES BLUROCK ELLERBROEK & ASSOCIATES URBANUS SQUARE • MACARTHUR BOULEVARD AT FORD ROAD TELEPHONE 714/675-2640 • CORONA DEL MAR, CALIFORNIA		UNIT 2 FOUNDATION AND FIRST FLOOR PLANS
REVISIONS 1. 7/1/65 2. 7/1/65 3. 7/1/65 4. 7/1/65 5. 7/1/65 6. 7/1/65 7. 7/1/65 8. 7/1/65 9. 7/1/65 10. 7/1/65		APPROVED MAY 5 - 1965 55874		DATE 6 MAY 1965 SHEET NO. S 15		JOB NO. 10-1

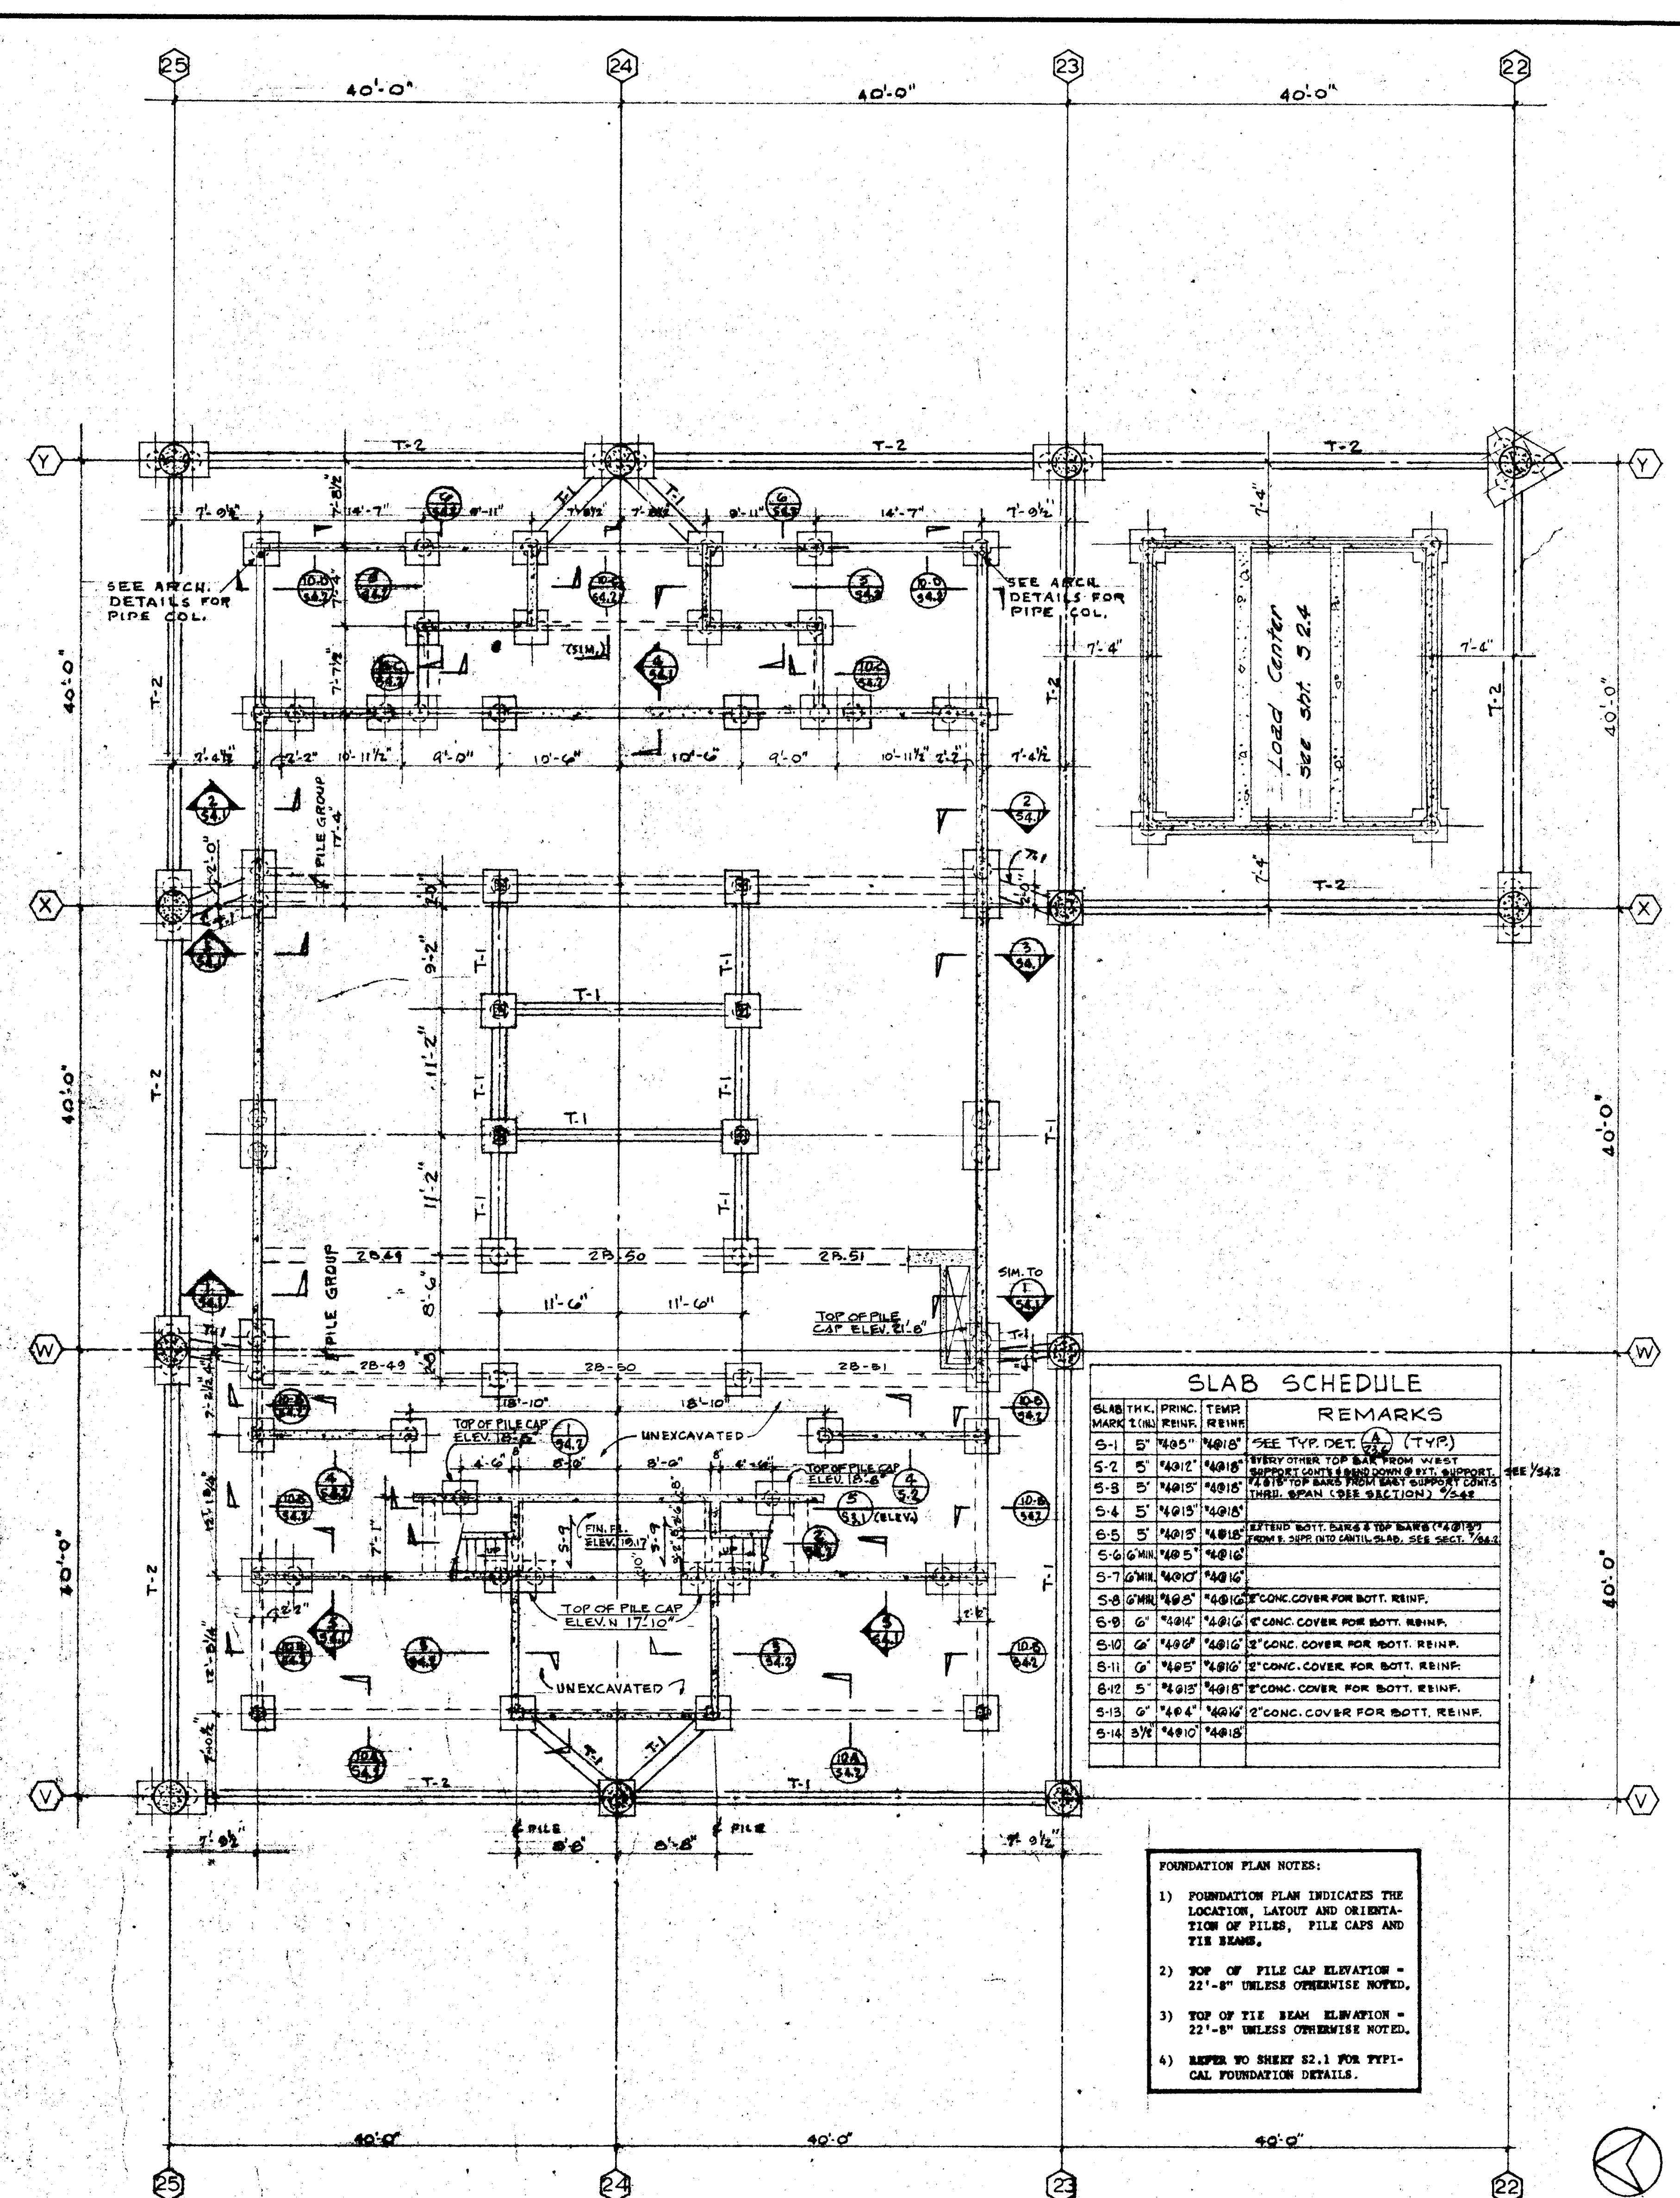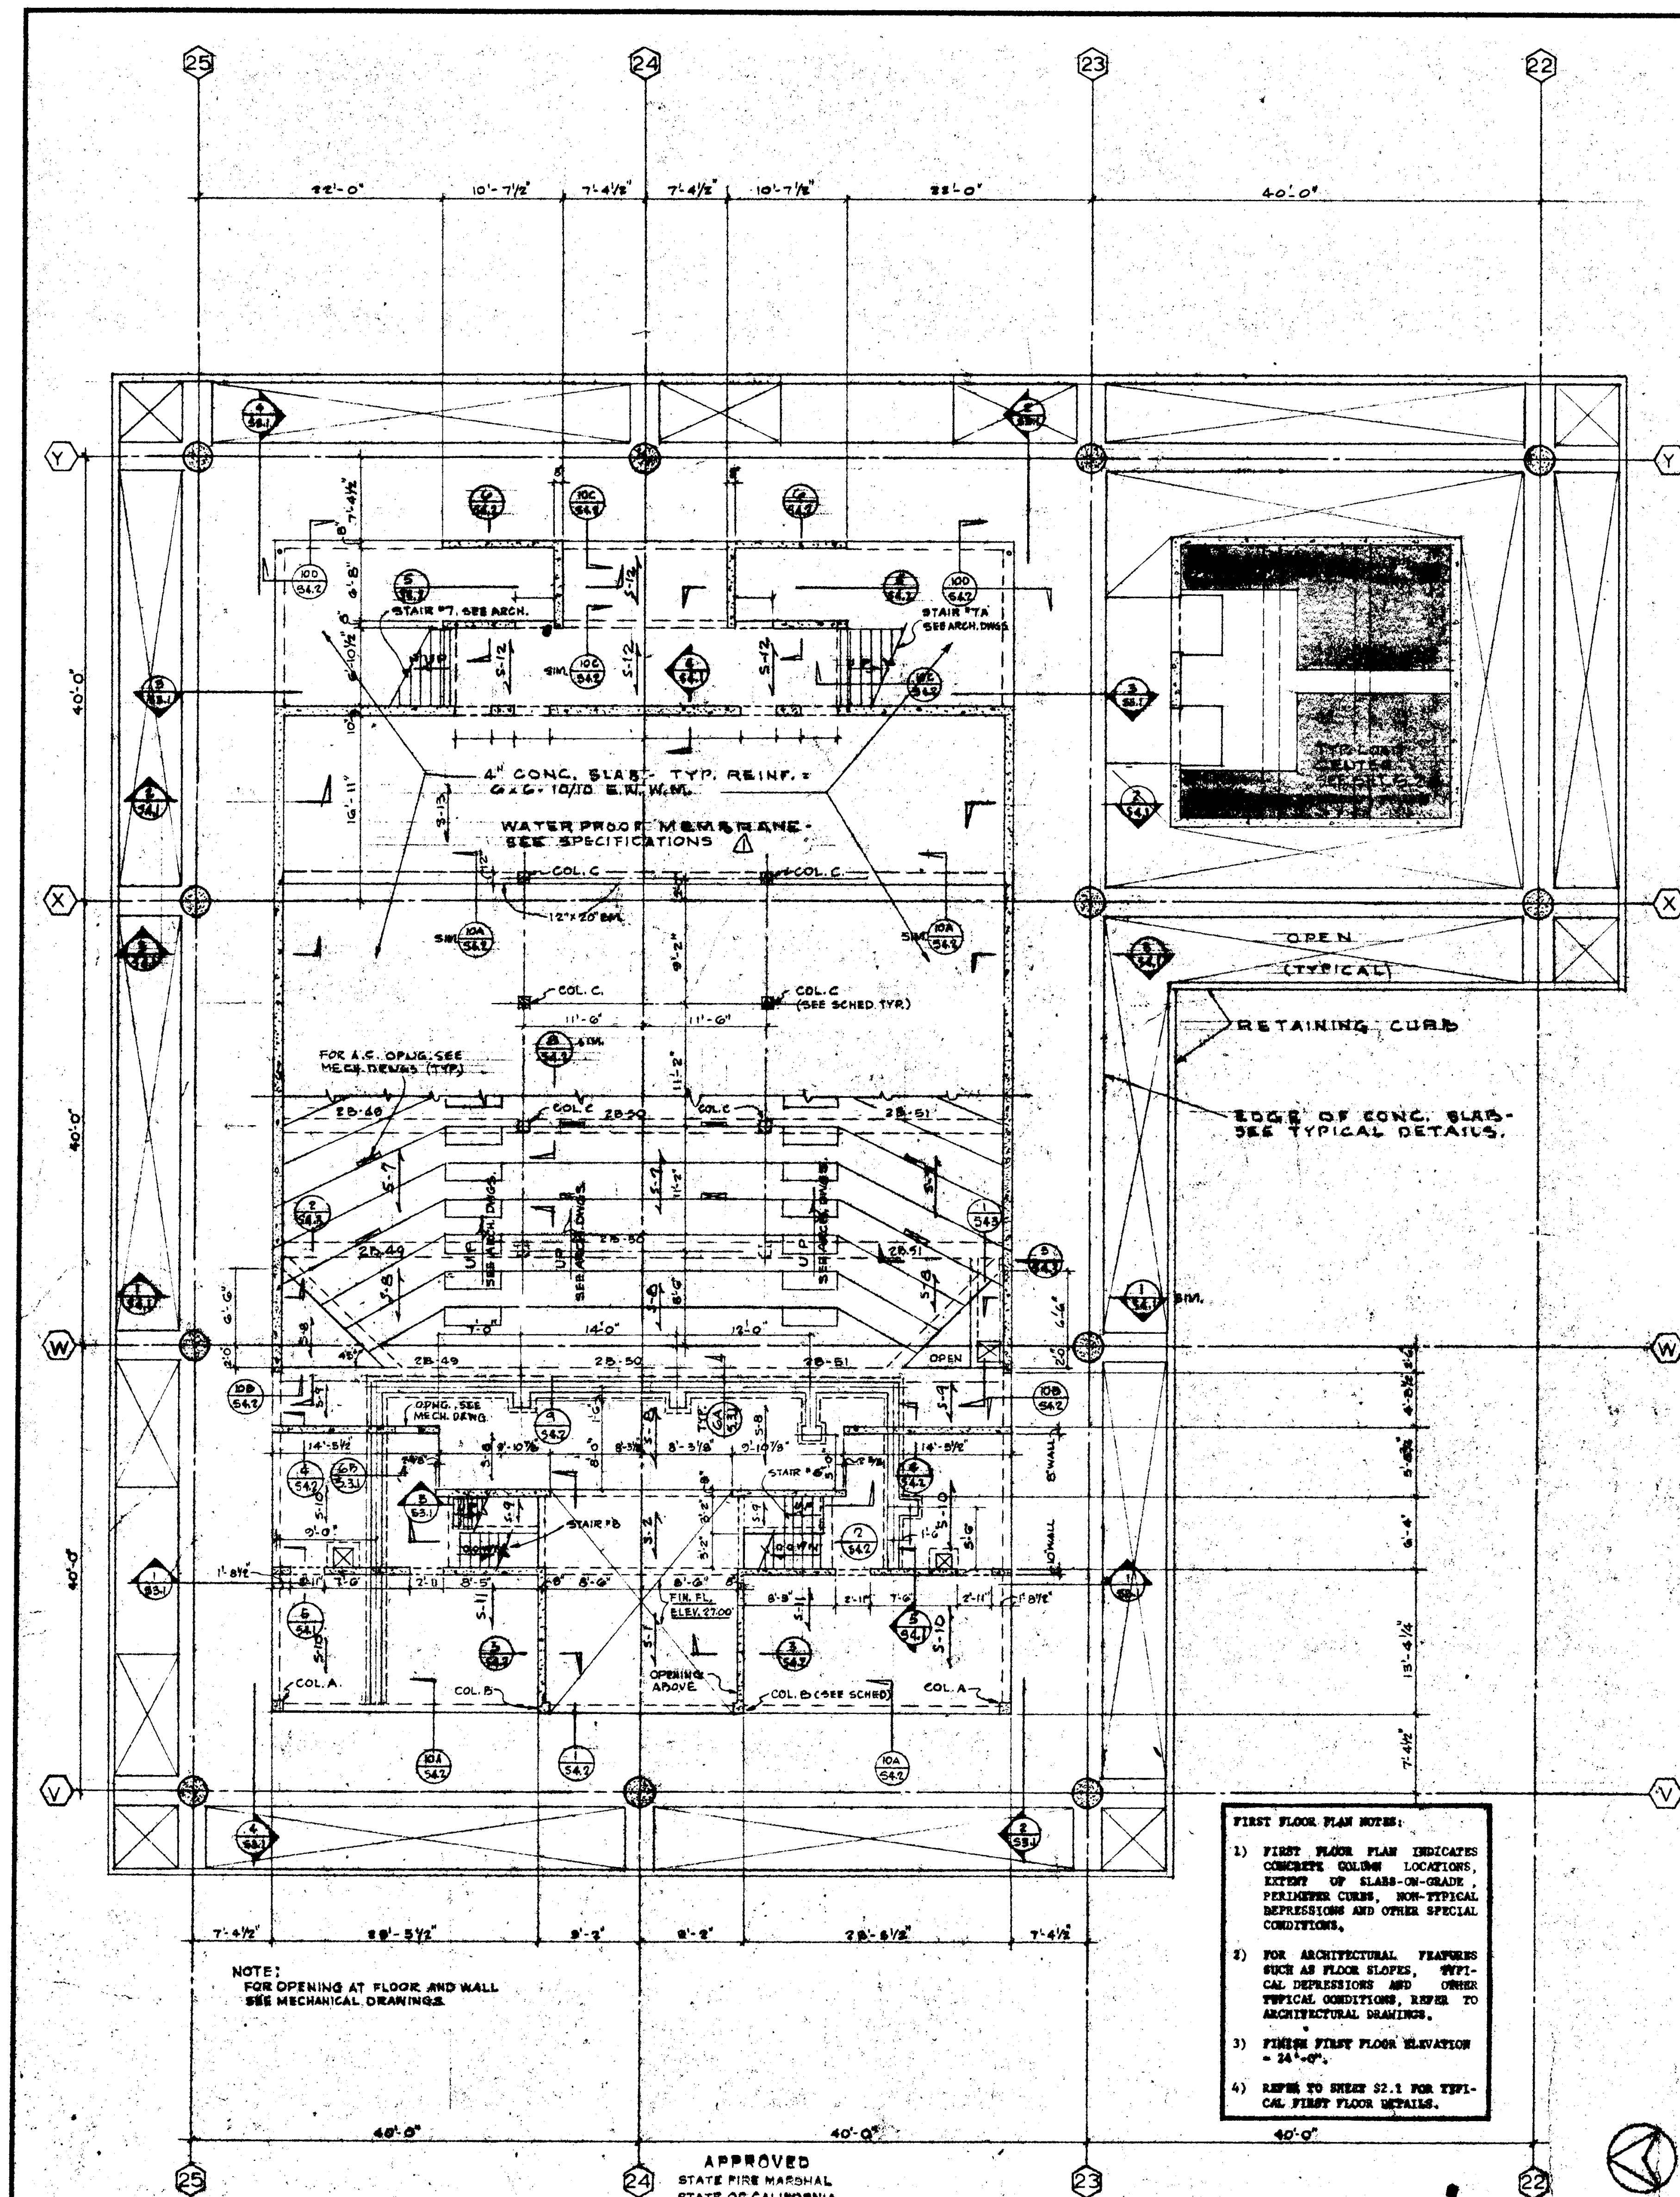[illegible]

13 APR
11 MAY

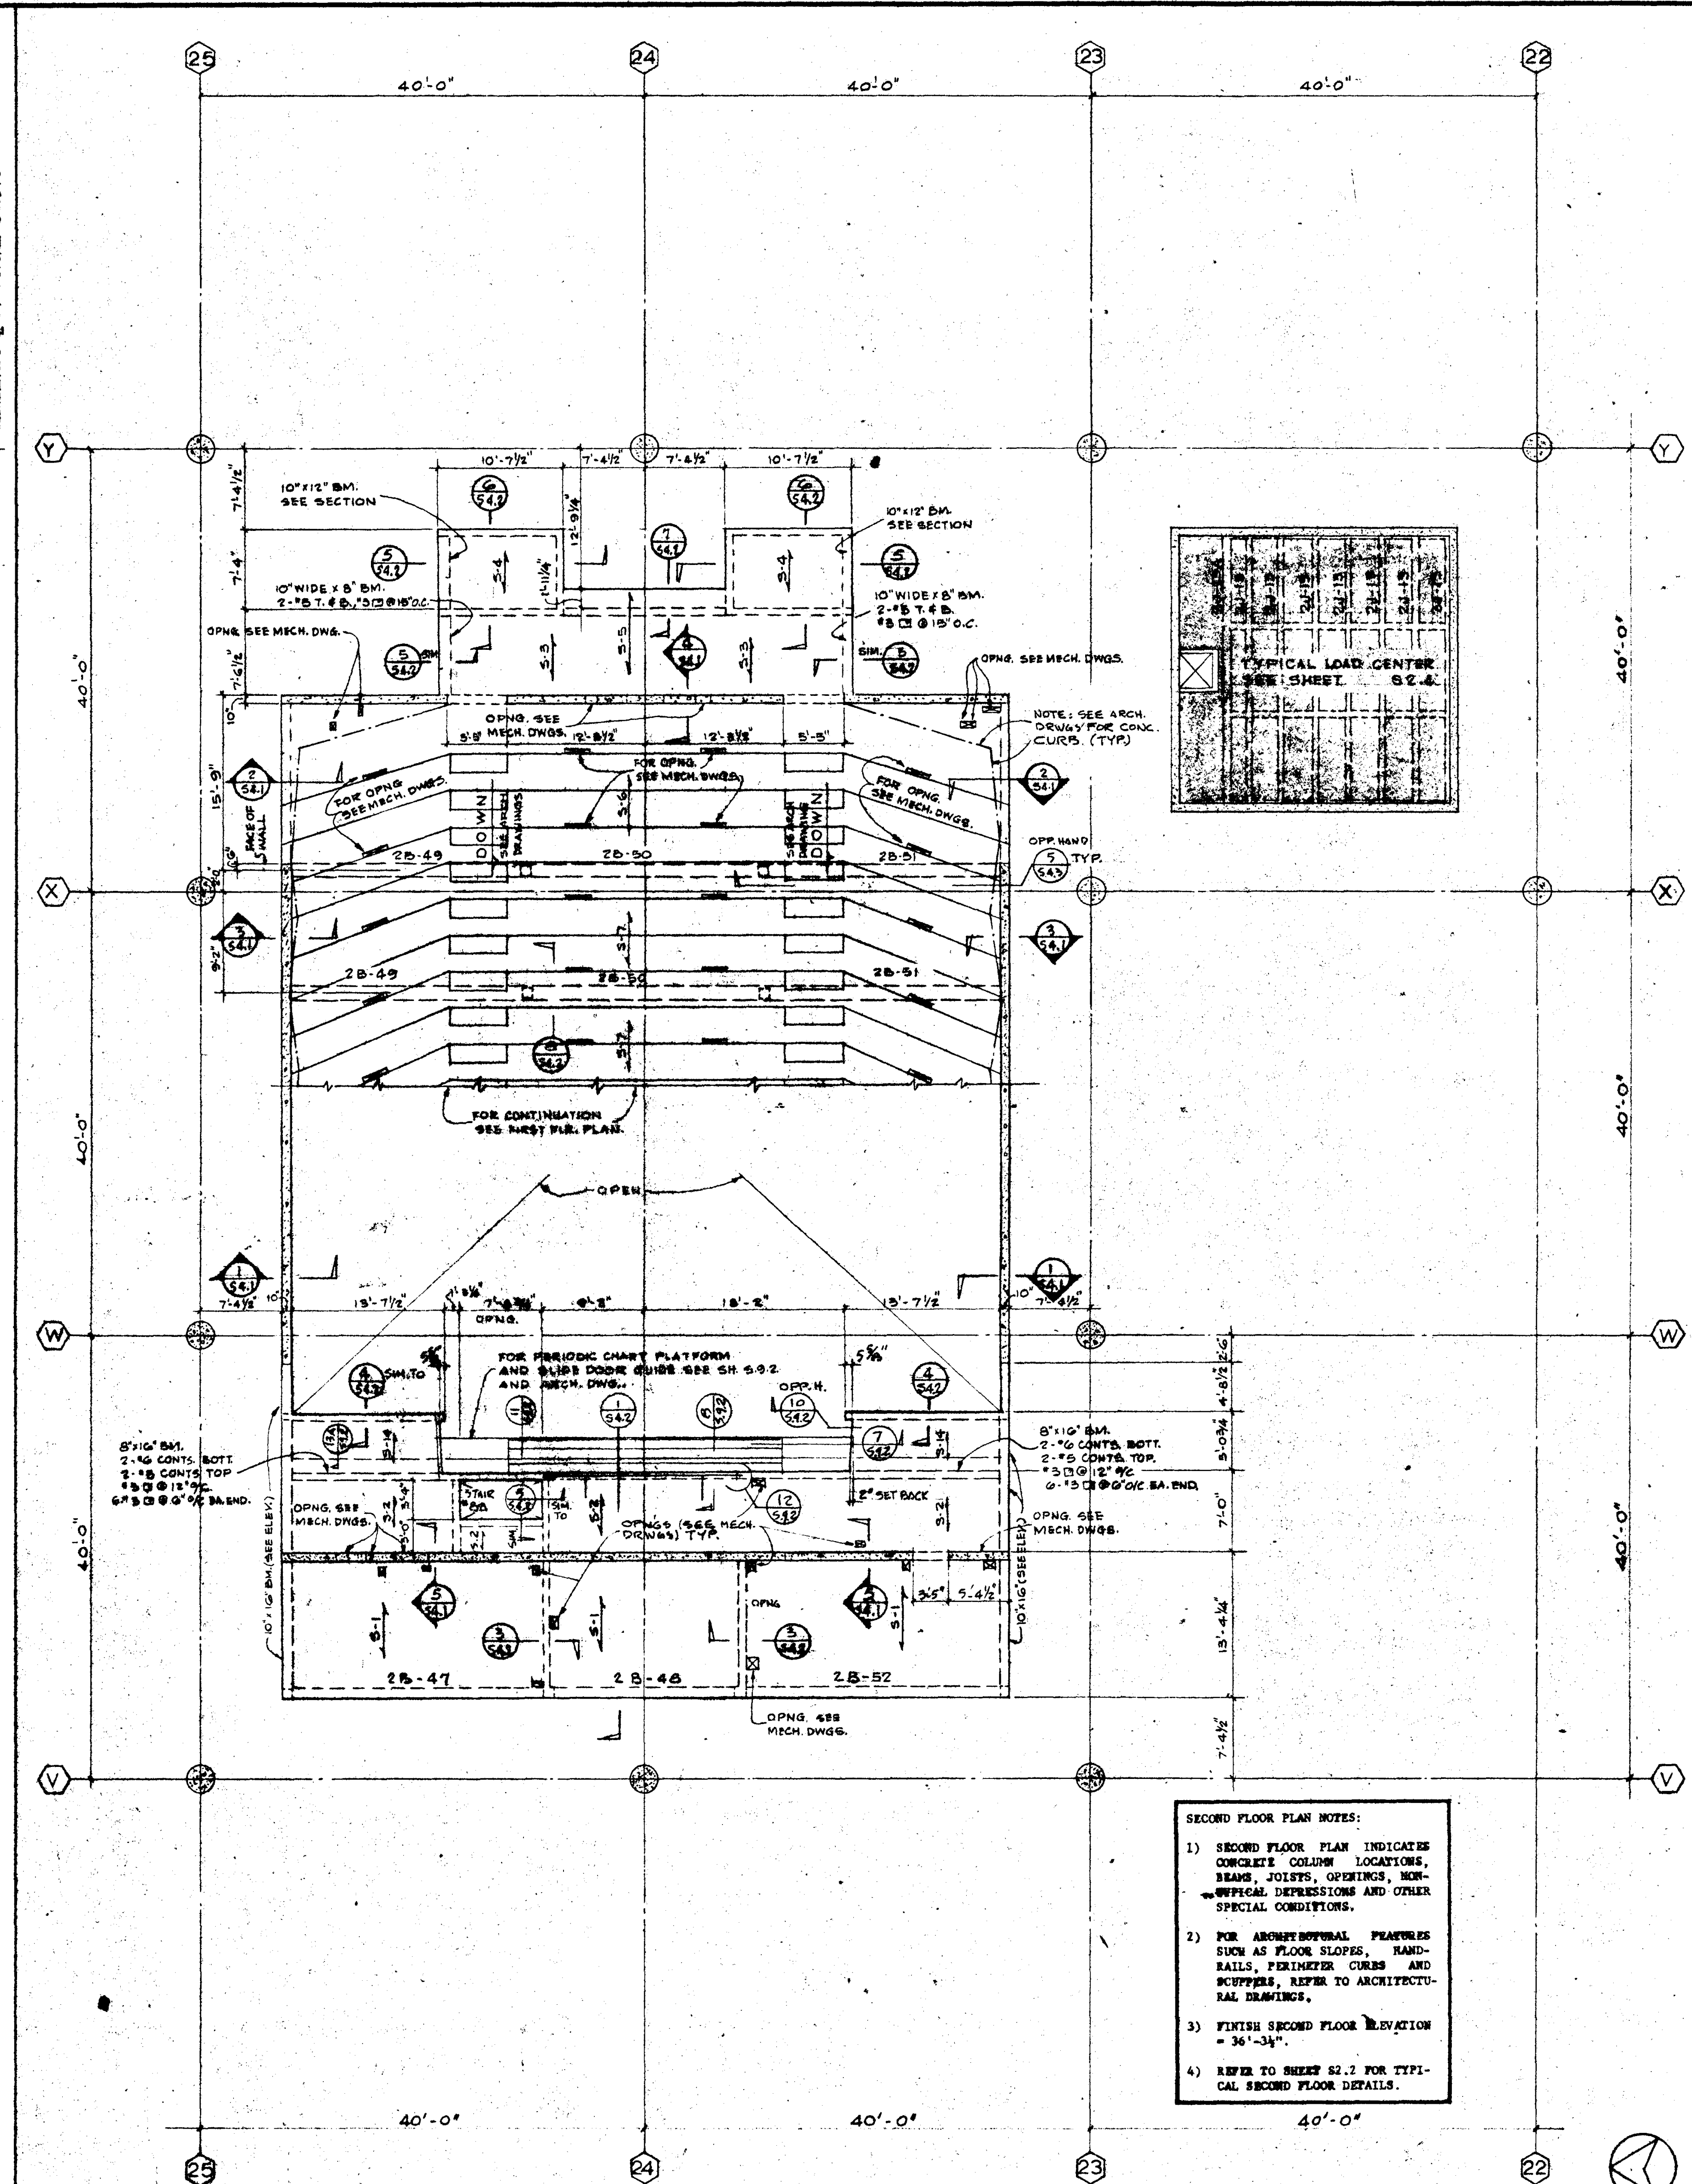


APPROVED STATE ENGINEER DATE 10/10/1965		FIRST FLOOR		SCALE 1/8" = 1'-0"	FOUNDATION		SCALE 1/8" = 1'-0"	1	
STRUCTURAL ENGINEERS RANDOW & JOHNSTON J. A. MARTIN & ASSOCIATES MECHANICAL ENGINEERS RALPH E. PHILLIPS, INC. ELECTRICAL ENGINEERS RALPH E. PHILLIPS, INC. CIVIL ENGINEERS G. SHURMAN & ASSOCIATES MOFFATT & NICHOL		DESIGNED A.C.N. DRAWN BY C.D. CHECKED BY L.P.	ARCHITECT WILLIAM L. PEREIRA & ASSOCIATES A. QUINCY JONES-FREDERICK E. EMMONS & ASSOCIATES BLUROCK ELLERBROEK & ASSOCIATES	ASSOCIATED ARCHITECTS: WILLIAM L. PEREIRA & ASSOCIATES A. QUINCY JONES-FREDERICK E. EMMONS & ASSOCIATES BLUROCK ELLERBROEK & ASSOCIATES URBANUS SQUARE • MACARTHUR BOULEVARD AT FORD ROAD TELEPHONE 714/675-2640 • CORDONA DEL MAR, CALIFORNIA		GOLDEN WEST COLLEGE HUNTINGTON BEACH, CALIFORNIA ORANGE COAST JUNIOR COLLEGE DISTRICT		UNIT 3 FOUNDATION AND FIRST FLOOR PLANS	JOB NO. 100-1 DATE 6 MAY 1965 SHEET NO. S 1.7

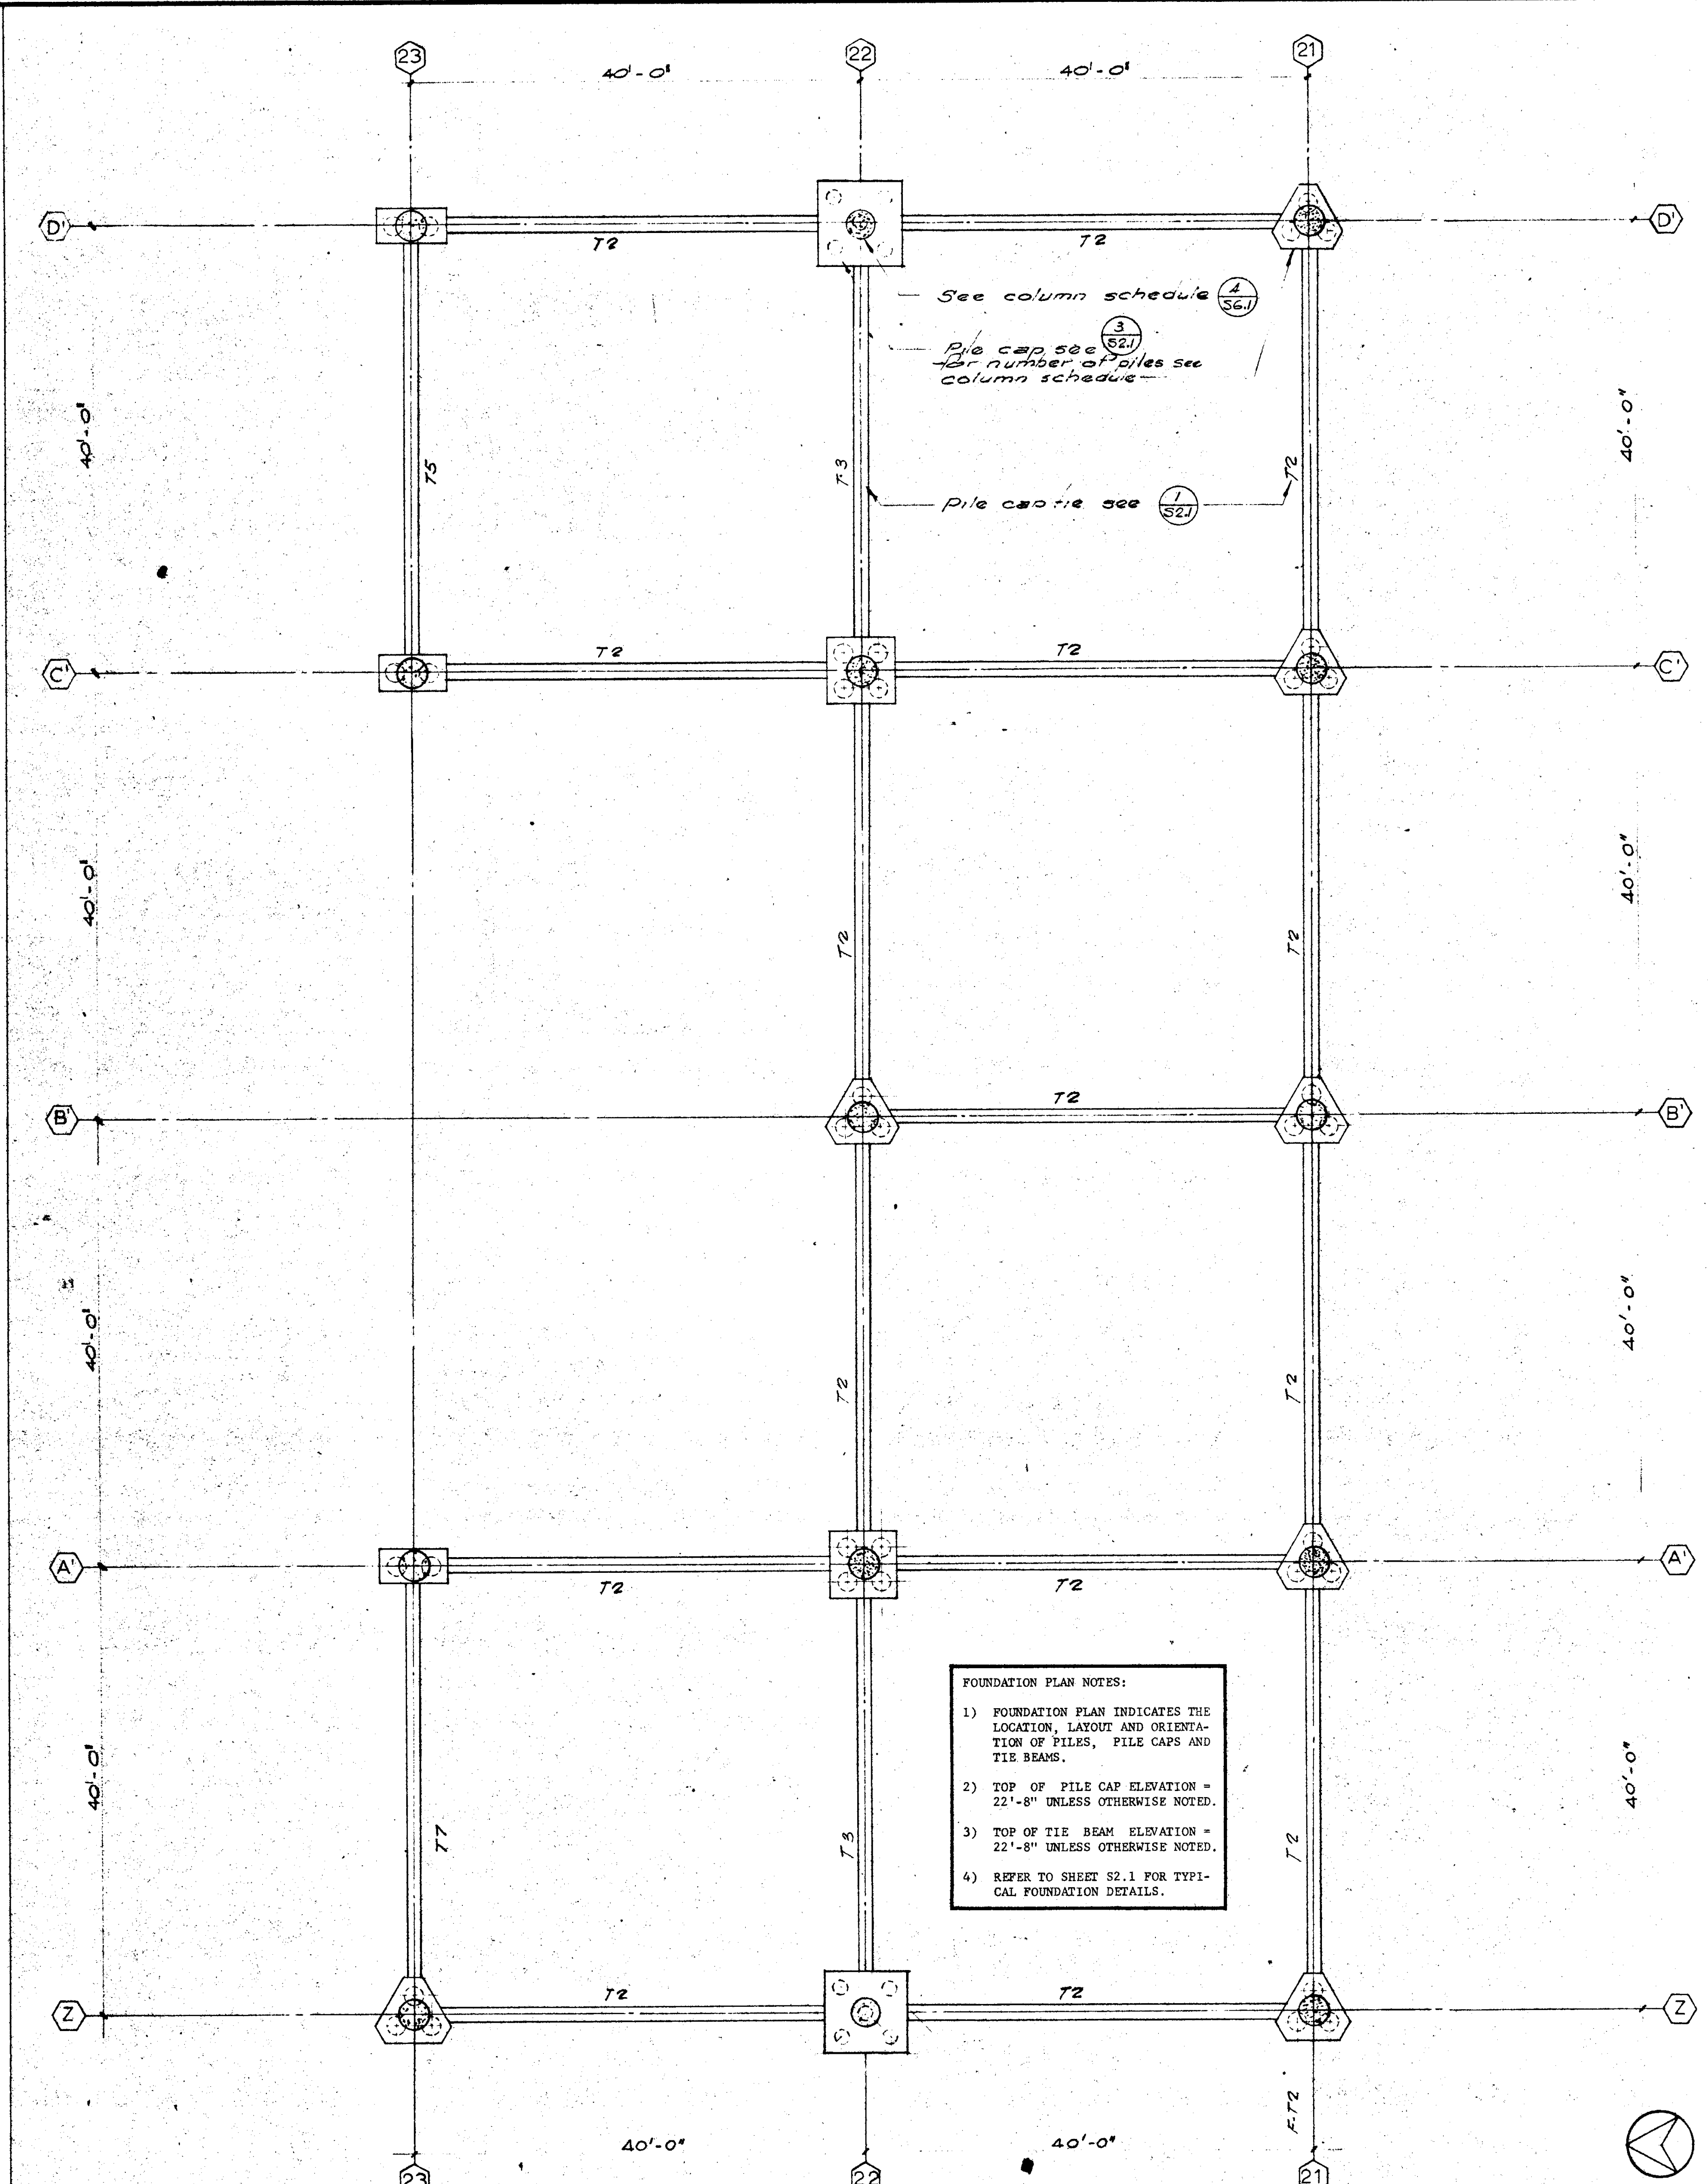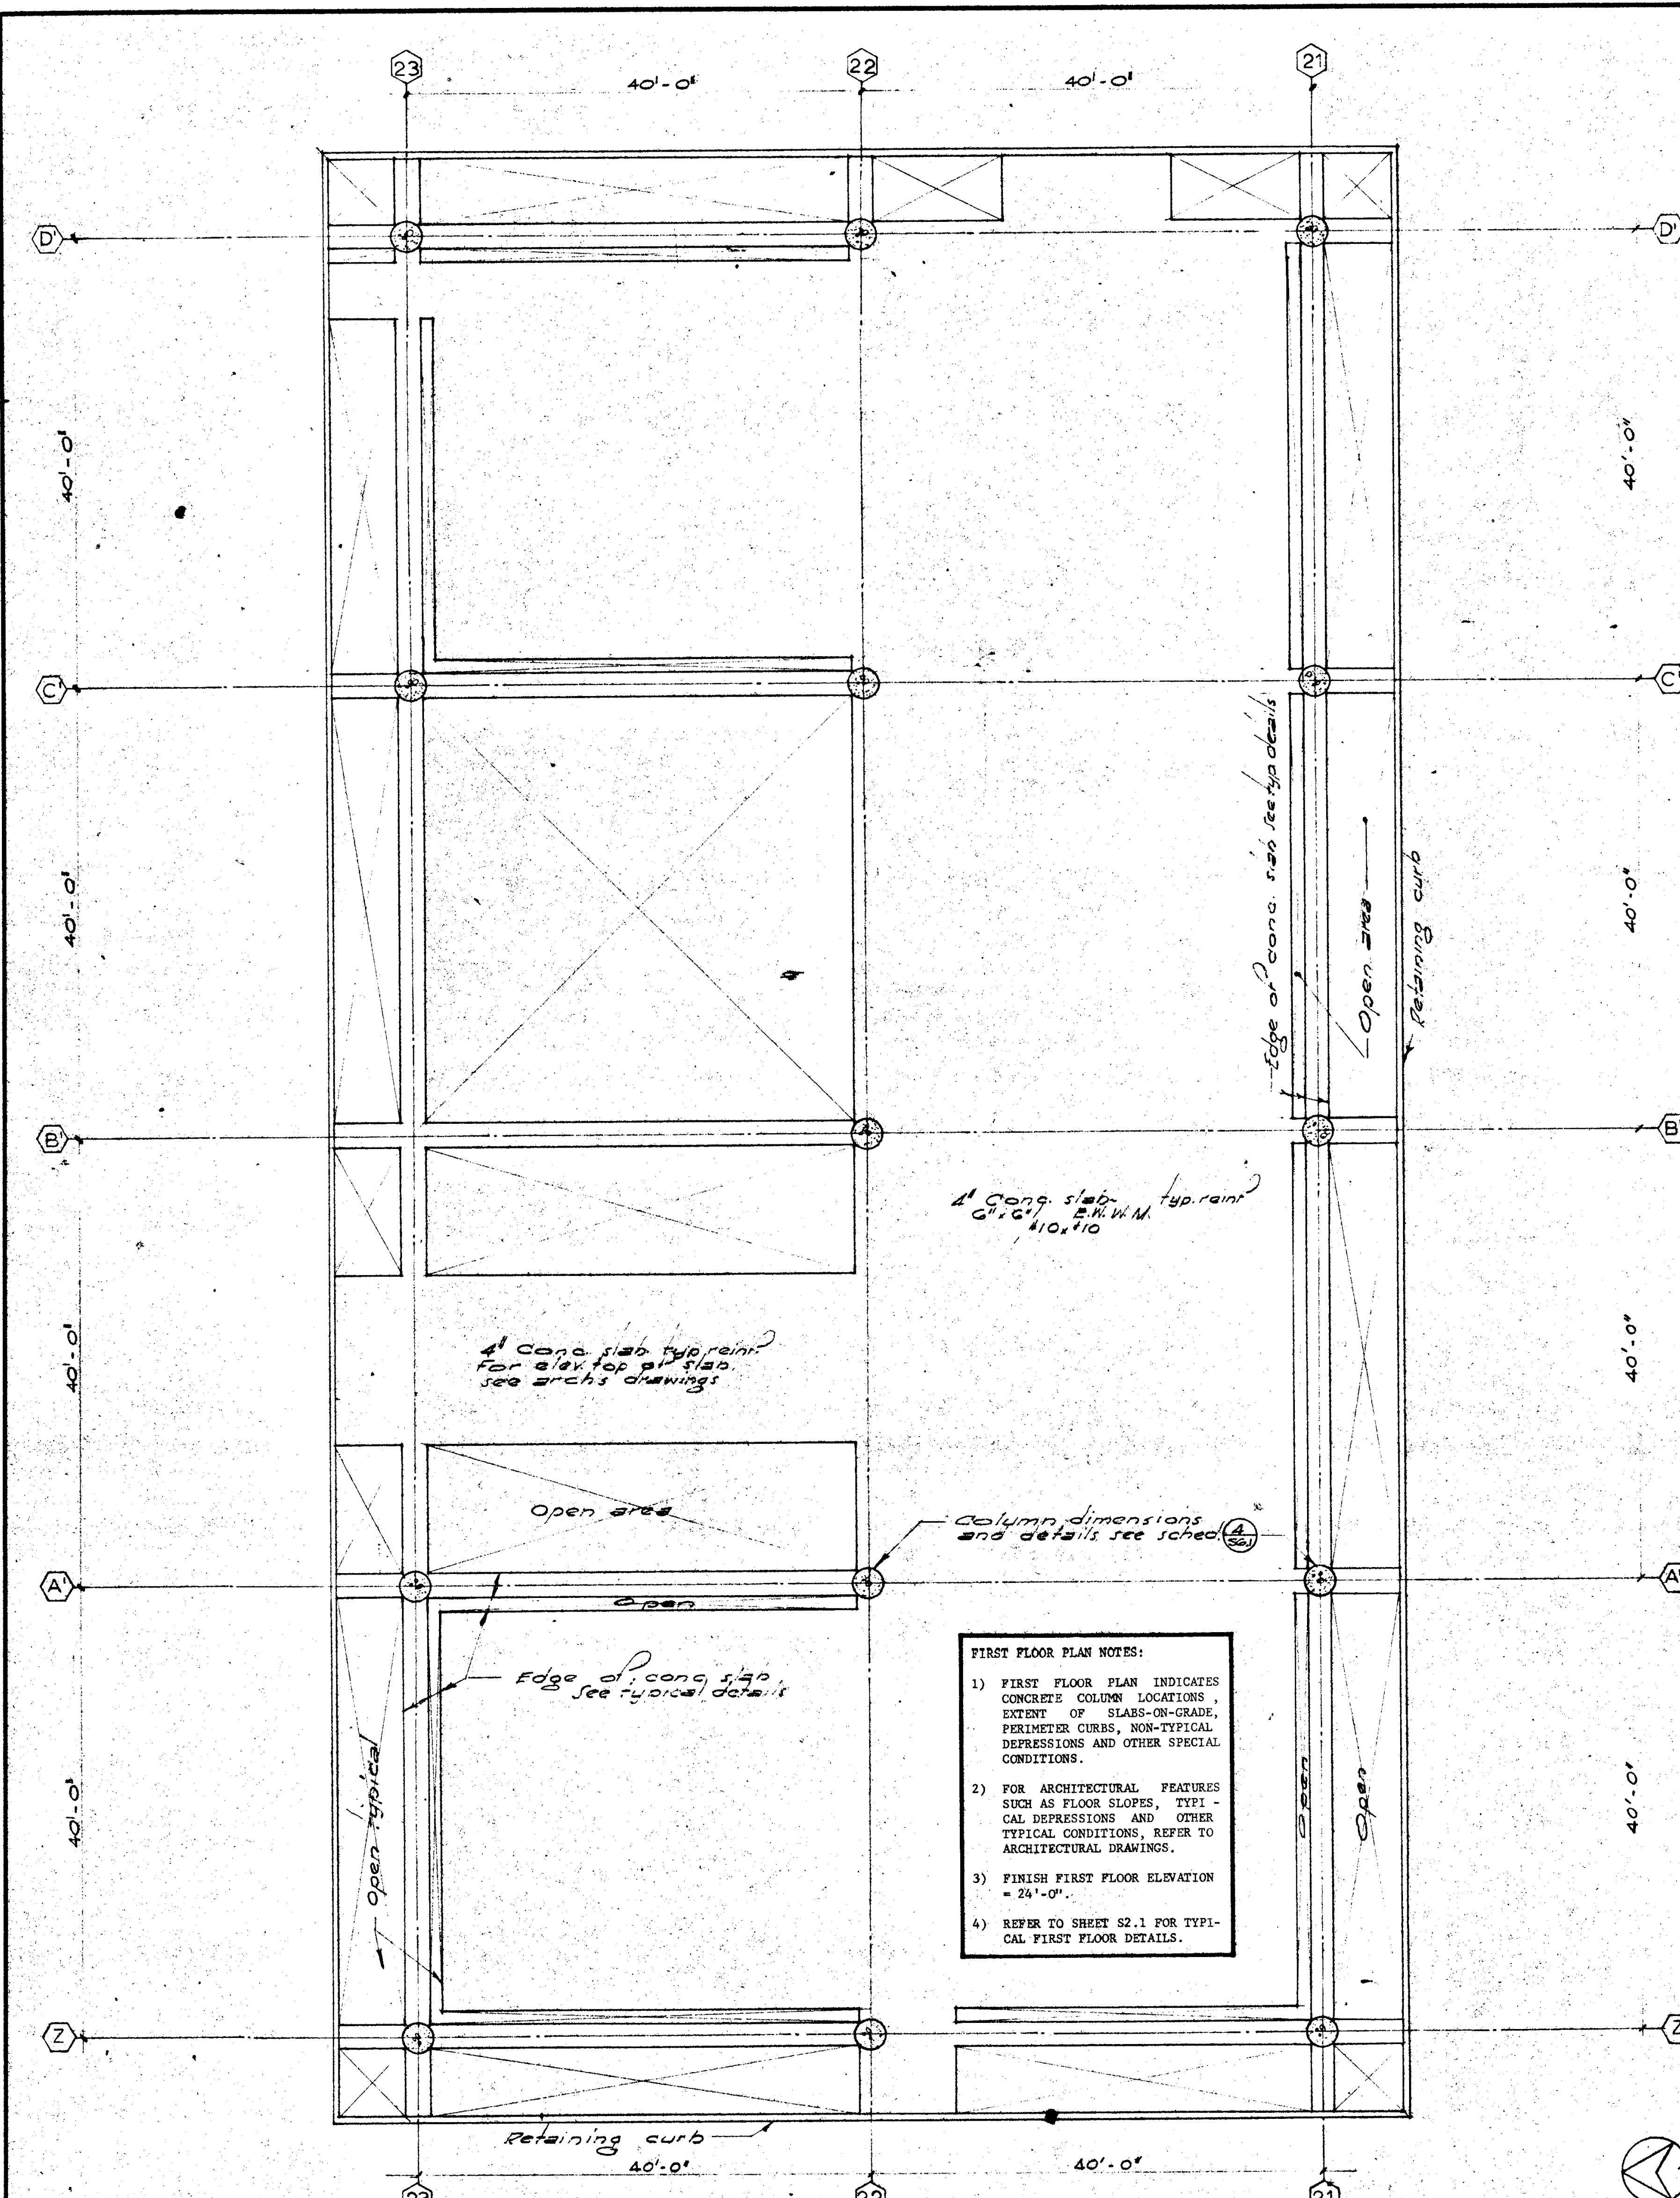


UNIT 3 ROOF

UNIT 3 SECOND FLOOR

<p>DATE: 10 JUN 1965</p> <p>REVISIONS:</p>	<p>STRUCTURAL ENGINEERS BRANDOW & JOHNSON 7 A. MARTIN & ASSOCIATES</p> <p>MECHANICAL ENGINEERS RALPH E. PHILLIPS, INC.</p> <p>ELECTRICAL ENGINEERS RALPH E. PHILLIPS, INC.</p> <p>CIVIL ENGINEERS G. SHURMAN & ASSOCIATES MOFFATT & NICHOL</p>	<p>DESIGNED OU</p> <p>DRAWN BY 100</p> <p>CHECKED BY G.U.</p> <p>APPROVED ARCHITECT WILLIAM L. PEREIRA & ASSOCIATES A QUINCY JONES-FREDERICK E. HEMMONS & ASSOCIATES BLUROCK ELLERBROCK & ASSOCIATES</p>	<p>ASSOCIATED ARCHITECTS: WILLIAM L. PEREIRA & ASSOCIATES A QUINCY JONES-FREDERICK E. HEMMONS & ASSOCIATES BLUROCK ELLERBROCK & ASSOCIATES</p> <p>URBANUS SQUARE • MACARTHUR BOULEVARD AT FORD ROAD TELEPHONE 714/675-2640 • CORONA DEL MAR, CALIFORNIA</p>	<p>GOLDEN WEST COLLEGE HUNTINGTON BEACH, CALIFORNIA ORANGE COAST JUNIOR COLLEGE DISTRICT</p>	<p>UNIT 3 SECOND FLOOR AND ROOF PLANS</p> <p>SCALE: 1/8" = 1'</p> <p>JOB NO. 10-1</p> <p>DATE: 10 JUN 1965</p> <p>SHEET NO. S 1 & 2</p>
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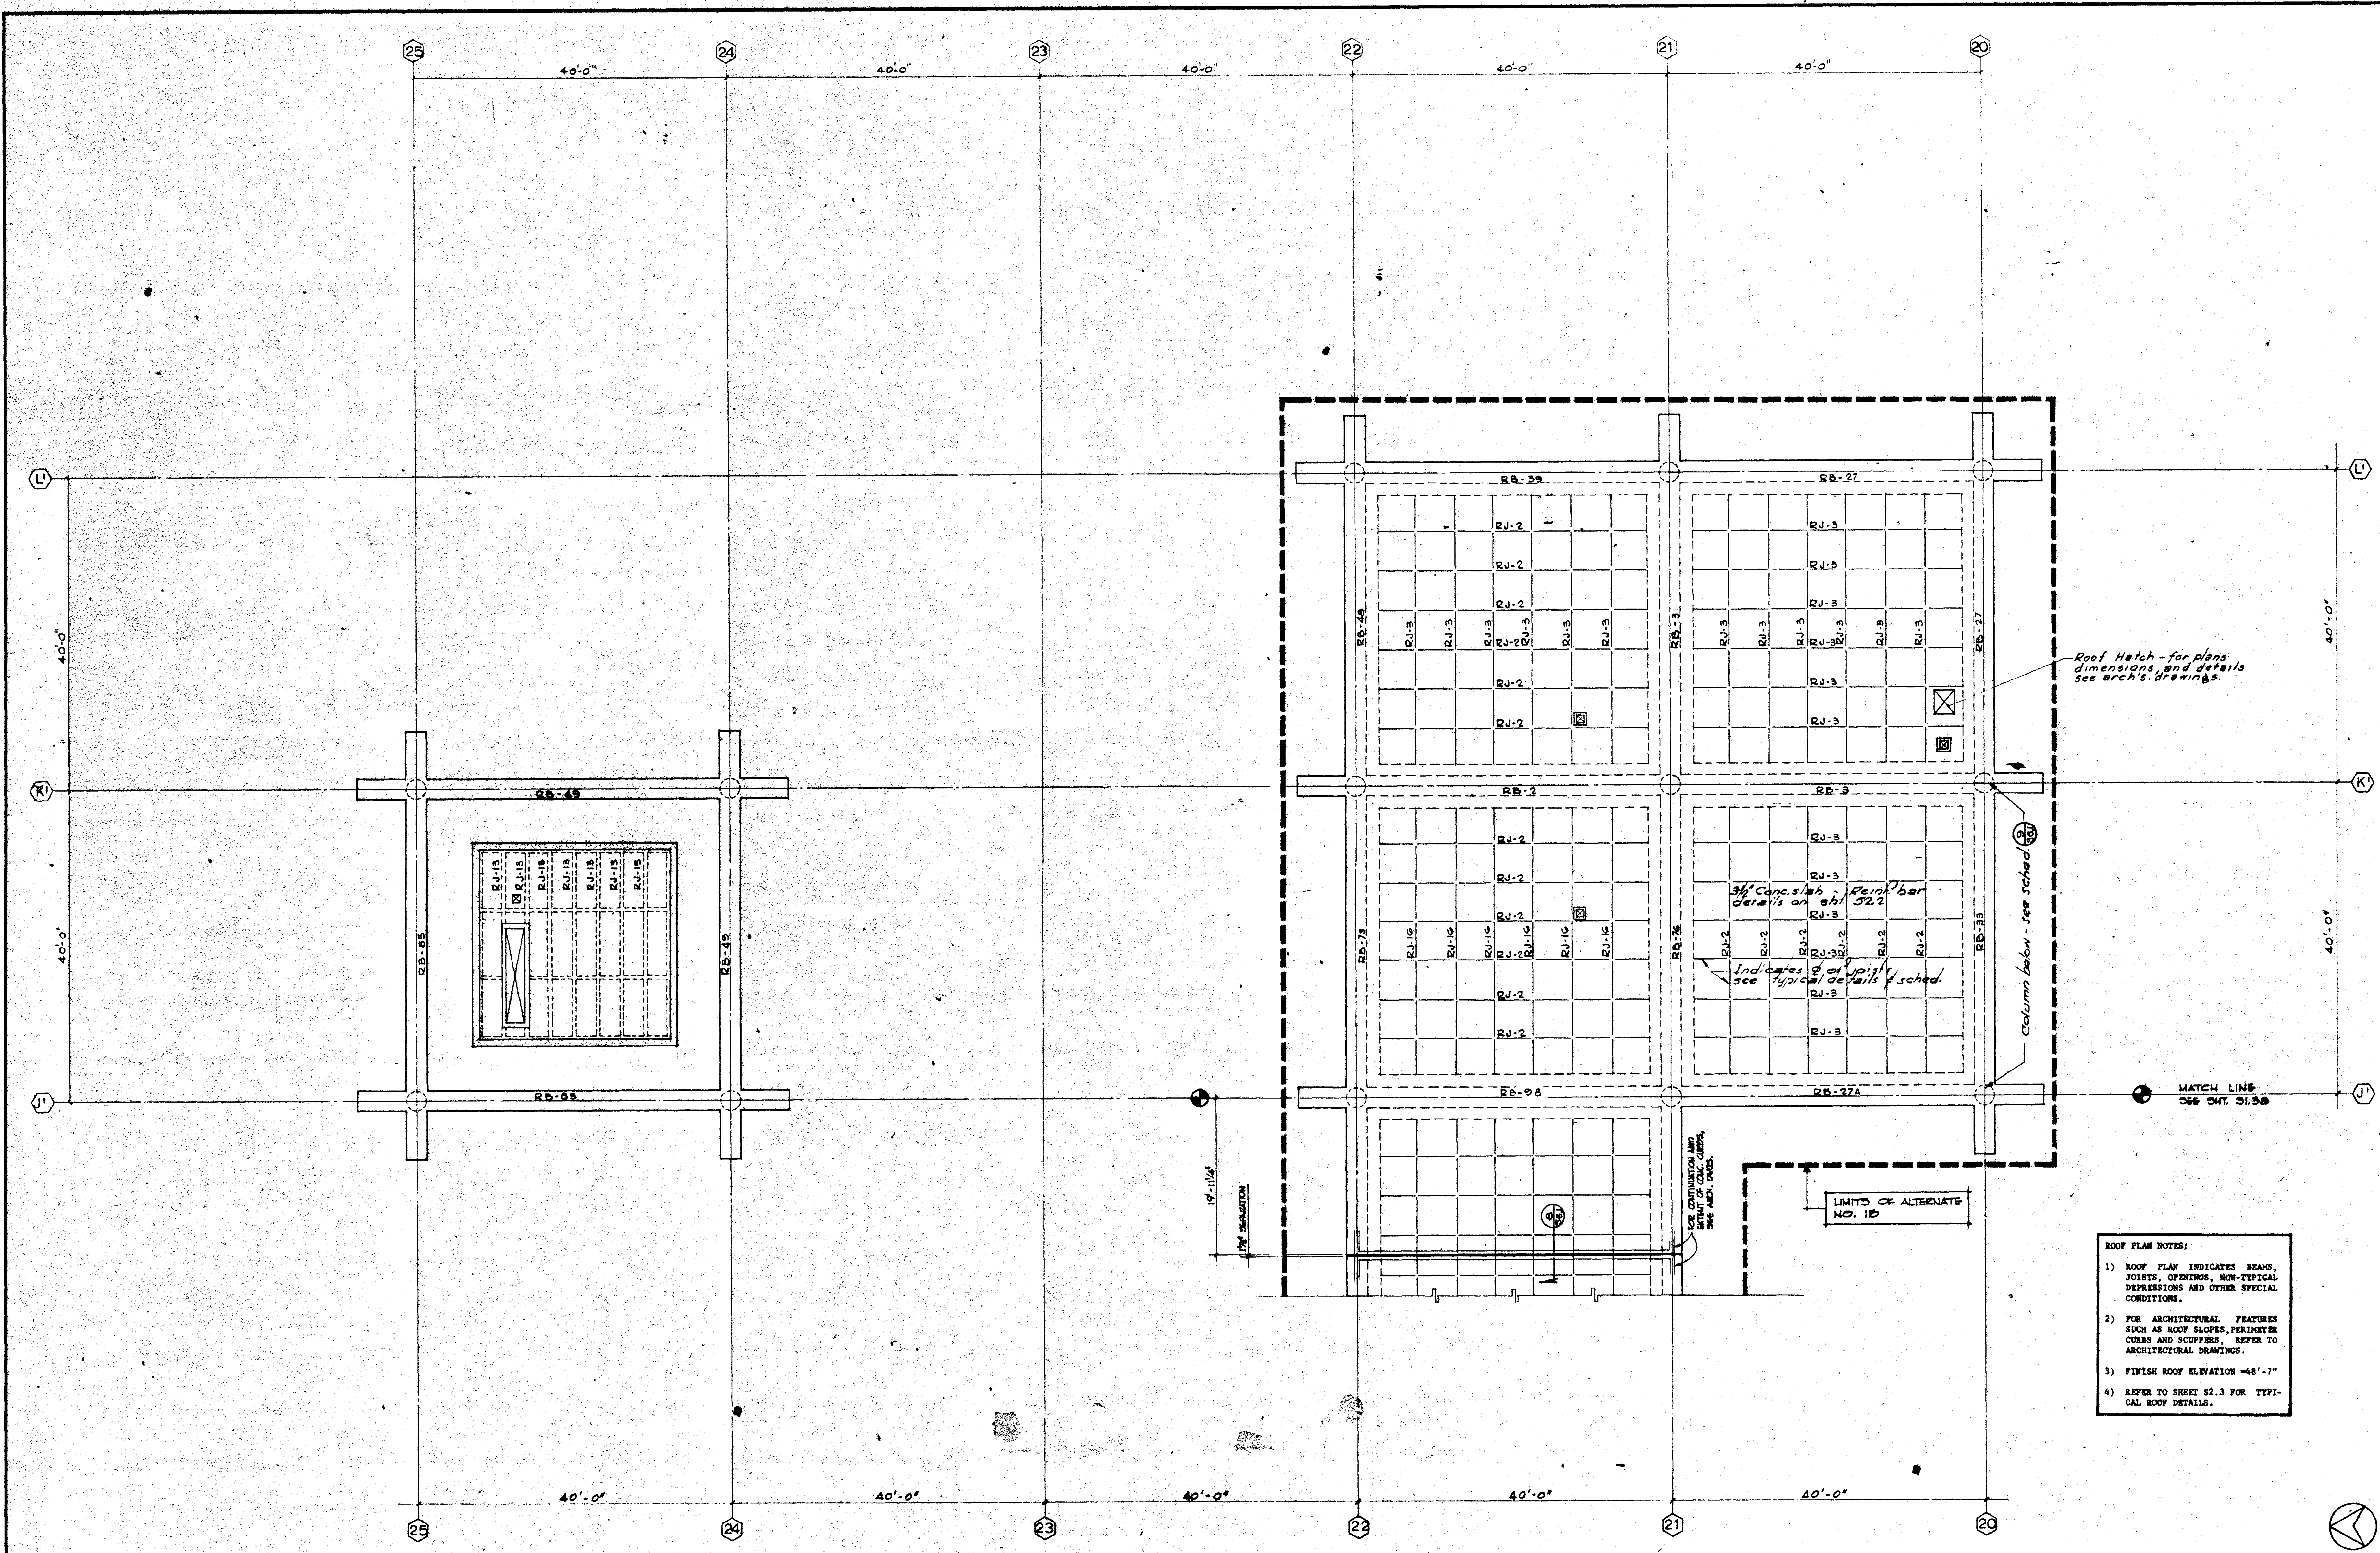


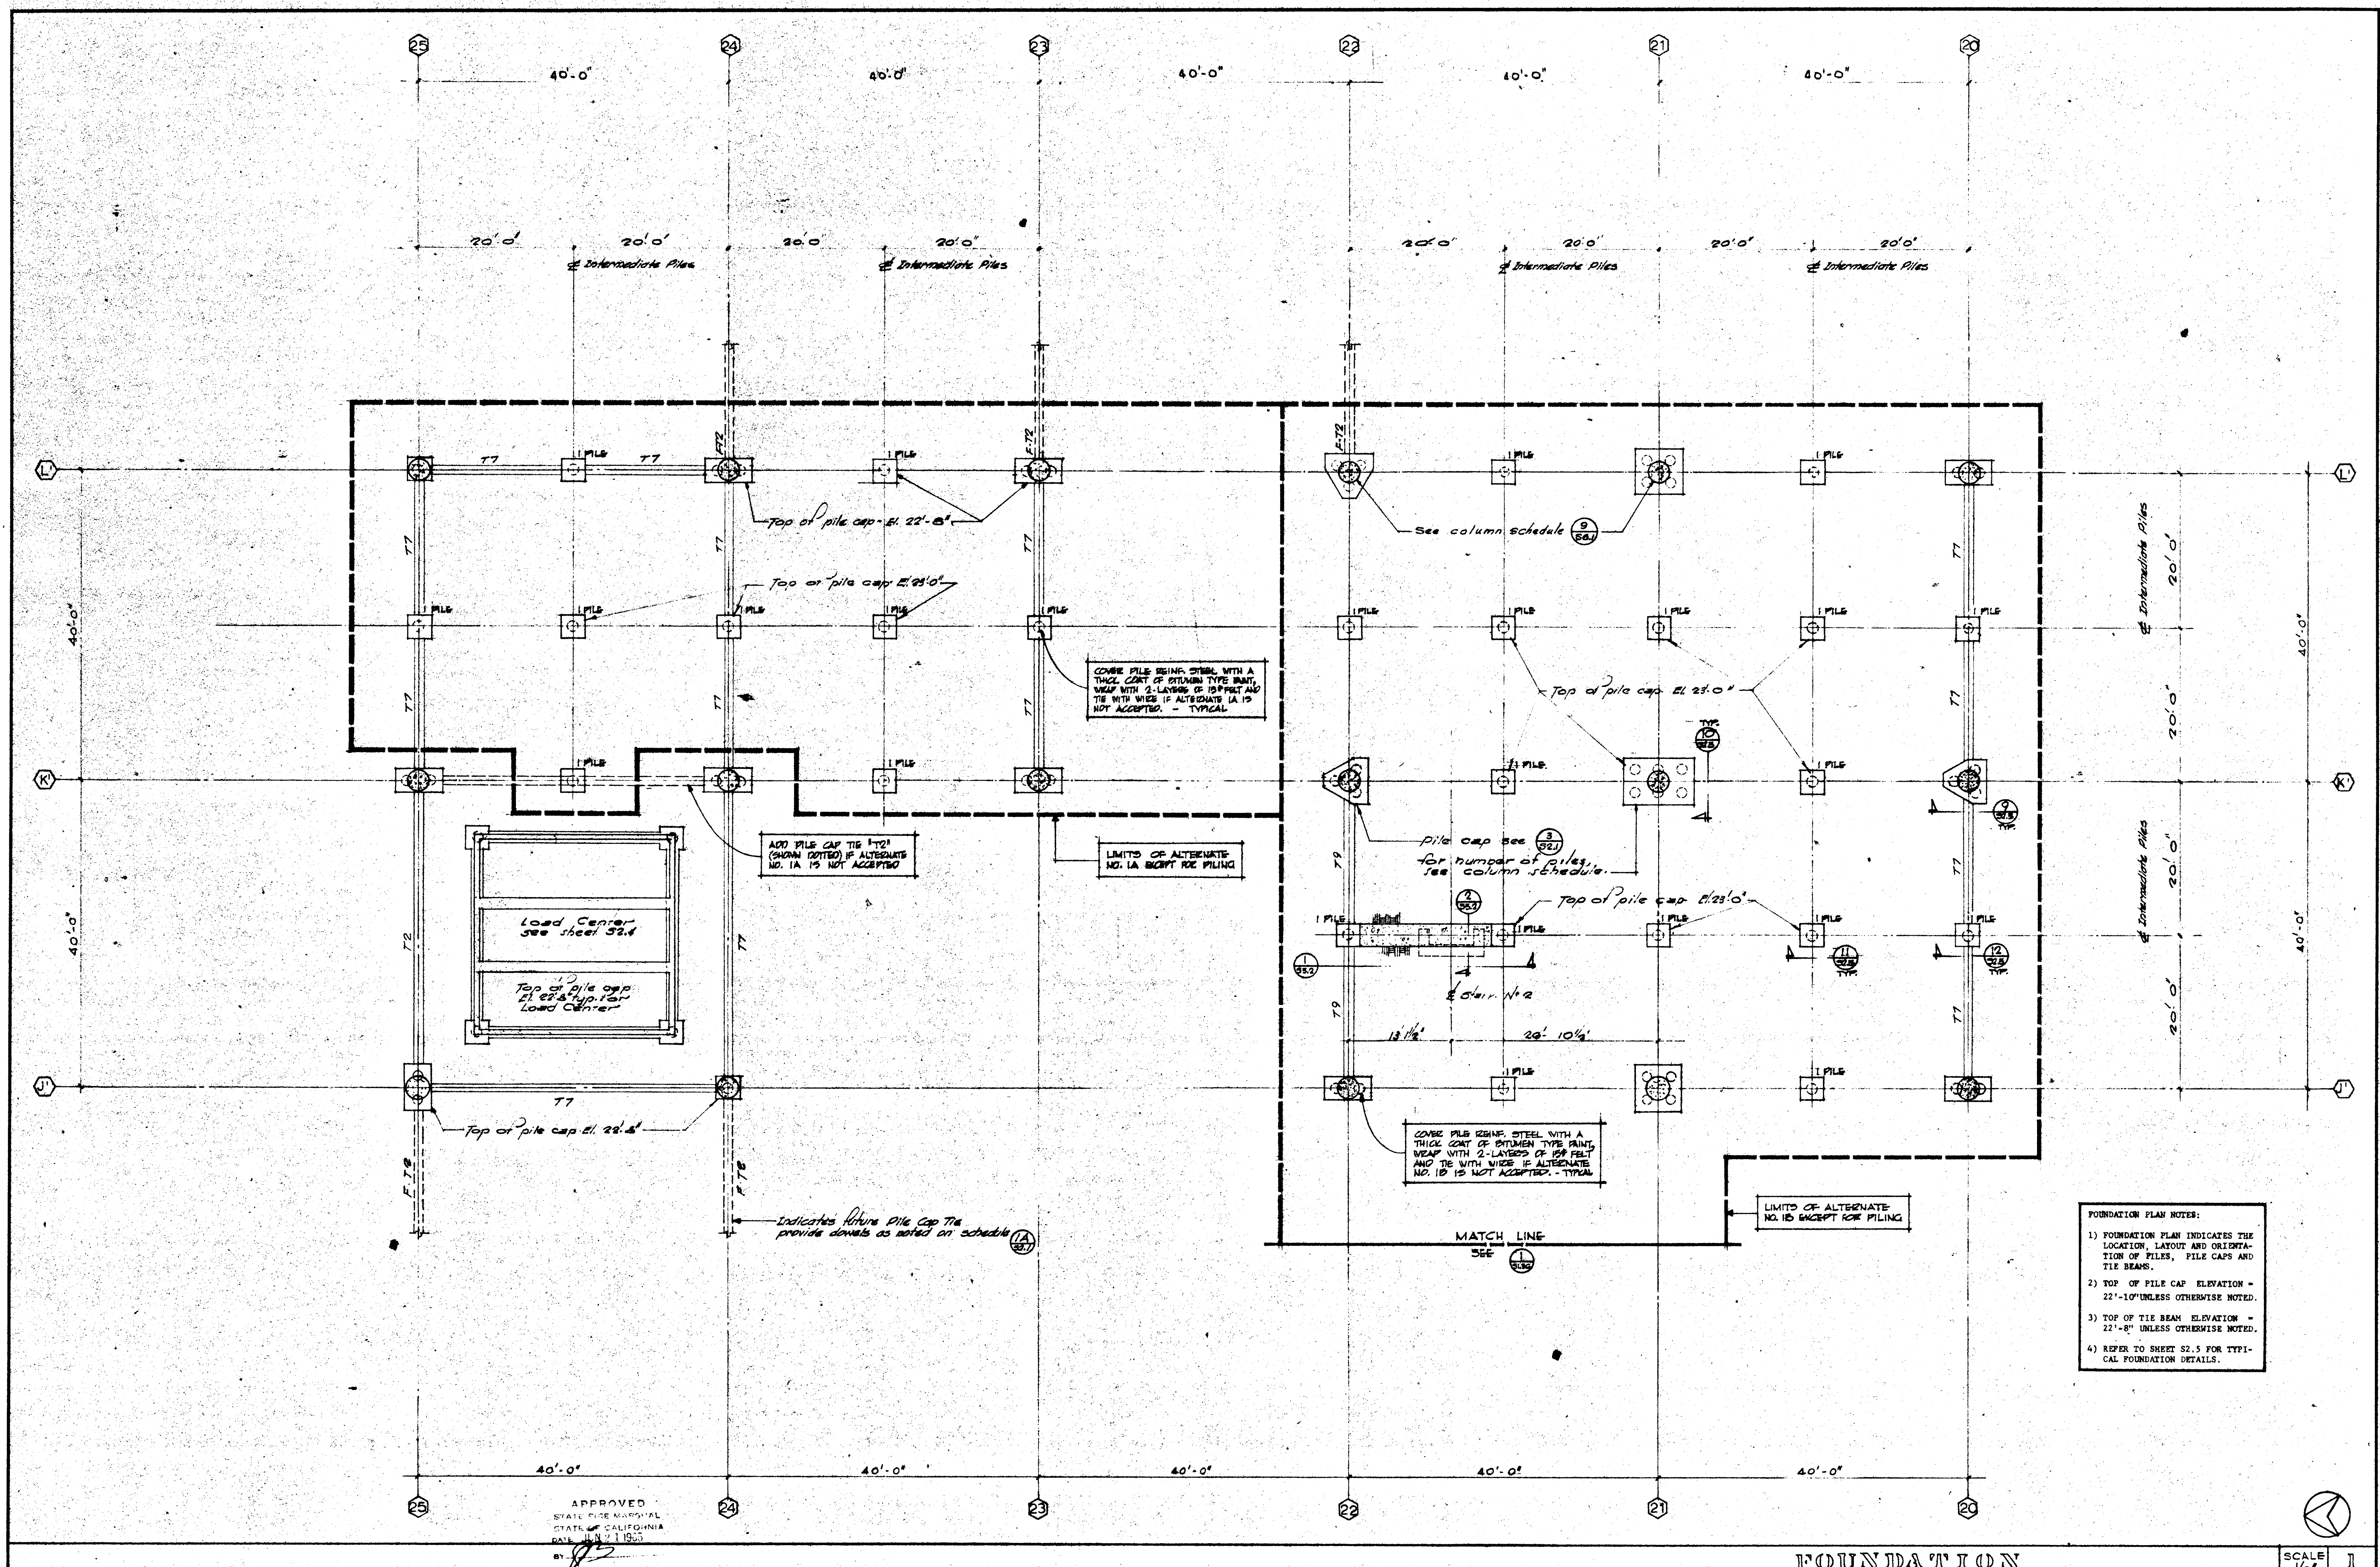DATE <u> </u> DRAWN <u> </u> REVISIONS <u> </u>		STRUCTURAL ENGINEERS <u>BRANDTOW & JOHNSTON</u> <u>J. & MARTIN & ASSOCIATES</u>	DESIGNED <u>A. C. N.</u>	ARCHITECT <u>W. J. P. & S.</u>	APPROVED <u>25874</u> APR 10 1925	ASSOCIATED ARCHITECTS: WILLIAM L. PEREIRA & ASSOCIATES A. QUINCY JONES, FREDERICK E. EMMONS & ASSOCIATES BLU ROCK ELLERBROEK & ASSOCIATES URBANUS SQUARE MACARTHUR BOULEVARD AT FORD ROAD TELEPHONE 714/675-2640 CORONA DEL MAR, CALIFORNIA	GOLDEN WEST COLLEGE HUNTINGTON BEACH, CALIFORNIA ORANGE COAST JUNIOR COLLEGE DISTRICT	UNIT <u>1</u> FOUNDATION PLAN	JOB NO. <u>1041</u> DATE <u>G. MAY 1925</u> SHEET NO. <u>1 of 1</u>
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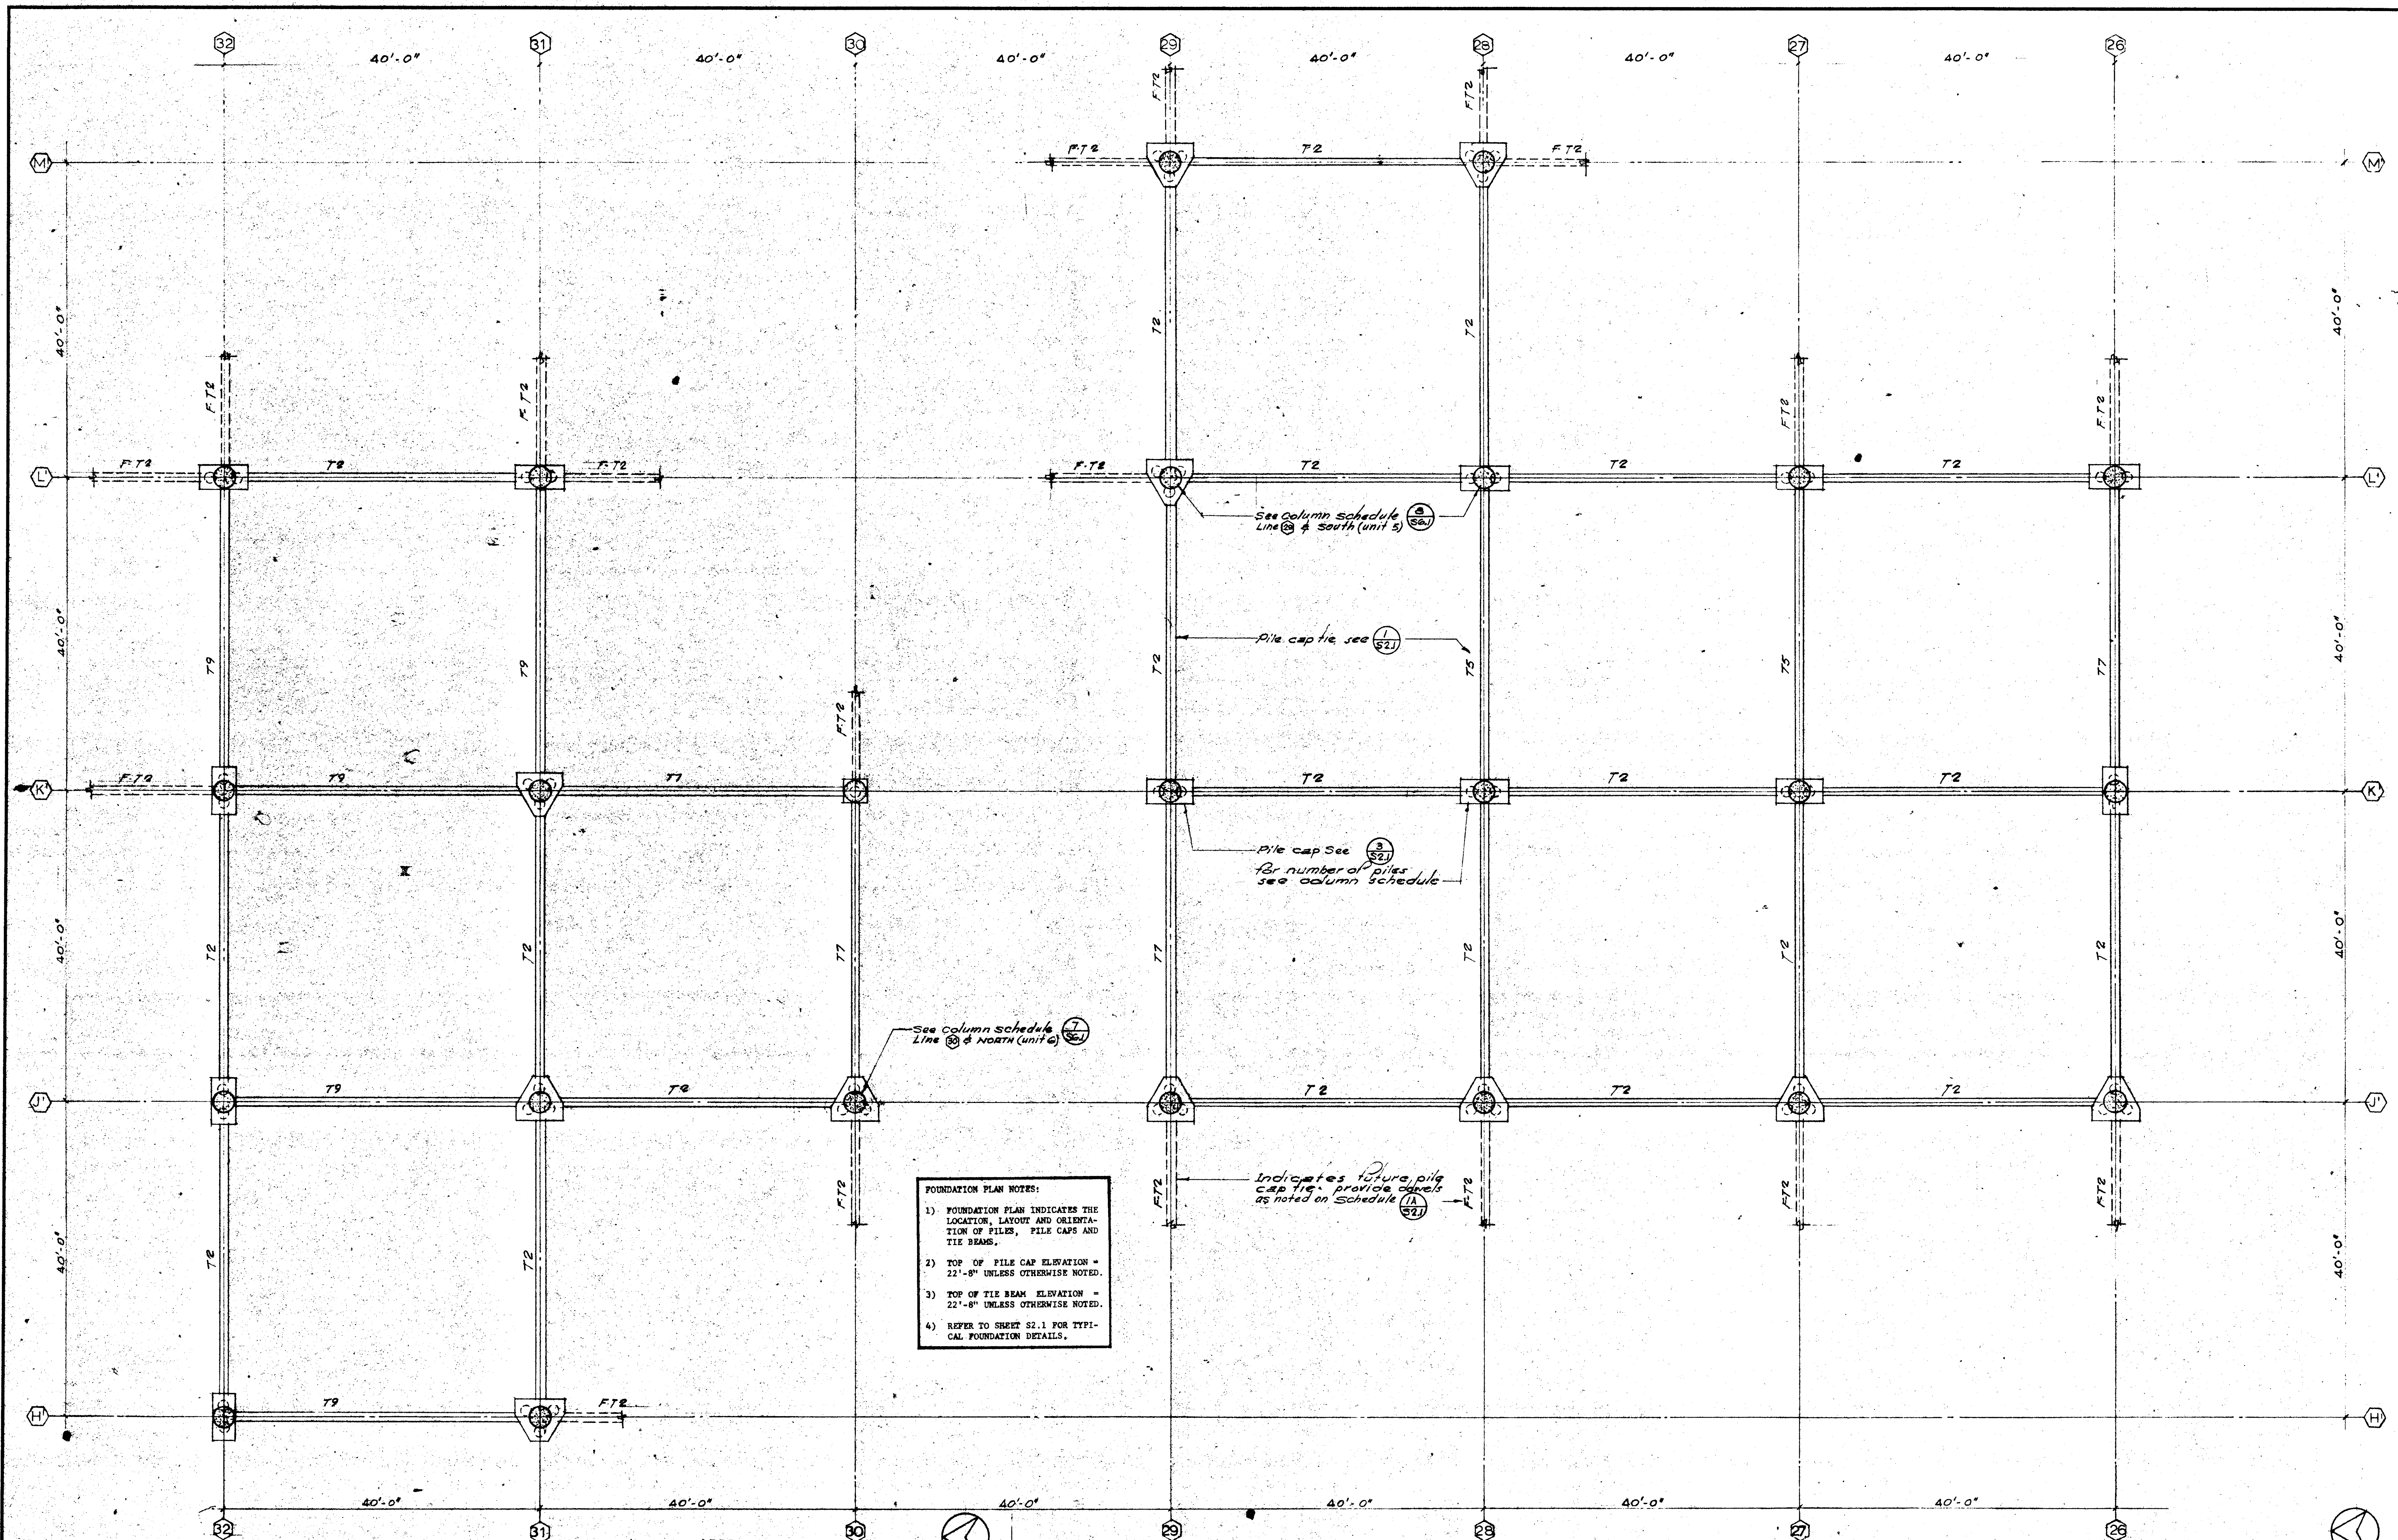
- FIRST FLOOR PLAN NOTES:
- 1) FIRST FLOOR PLAN INDICATES CONCRETE COLUMN LOCATIONS, EXTENT OF SLABS-ON-GRADE, PERIMETER CURB, NON-TYPICAL DEPRESSIONS AND OTHER SPECIAL CONDITIONS.
 - 2) FOR ARCHITECTURAL FEATURES SUCH AS FLOOR SLOPES, TYPICAL DEPRESSIONS AND OTHER TYPICAL CONDITIONS, REFER TO ARCHITECTURAL DRAWINGS.
 - 3) FINISH FIRST FLOOR ELEVATION = 24'-0".
 - 4) REFER TO SHEET 22.5 FOR TYPICAL FIRST FLOOR DETAILS.

<p>UNIT 4 FIRST FLOOR</p>				<p>SCALE 1/8" = 1'</p>	
<p>GOLDEN WEST COLLEGE HUNTINGTON BEACH, CALIFORNIA ORANGE COAST JUNIOR COLLEGE DISTRICT</p>				<p>UNIT 4 FIRST FLOOR PLAN</p>	
<p>ASSOCIATED ARCHITECTS: WILLIAM L. FERREIRA & ASSOCIATES A. QUINCY JONES-FREDERICK E. EMMONS & ASSOCIATES BLUROCK HILSBROOK & ASSOCIATES</p>				<p>JOB NO. 104 DATE 10 JAN 1975 SHEET NO. S 1.1 (D)</p>	
<p>URBANUS SQUARE • MACARTHUR BOULEVARD AT FORD ROAD TELEPHONE 714/675-2640 • CORONA DEL MAR, CALIFORNIA</p>					
<p>STRUCTURAL ENGINEERS BRANDTOW & JOHNSON J. A. MARTIN & ASSOCIATES</p>		<p>DESIGNED A.C.N.</p>		<p>APPROVED STATE FIRE MARSHAL STATE OF CALIFORNIA JUN 21 1975</p>	
<p>MECHANICAL ENGINEERS RALPH E. PHILLIPS, INC.</p>		<p>DRAWN BY 100</p>			
<p>ELECTRICAL ENGINEERS RALPH E. PHILLIPS, INC.</p>		<p>CHECKED BY 10</p>			
<p>CIVIL ENGINEERS G. SHURMAN & ASSOCIATES MOFFATT & NICHOL</p>					
<p>DATE DRAWN</p>		<p>REVISIONS</p>			

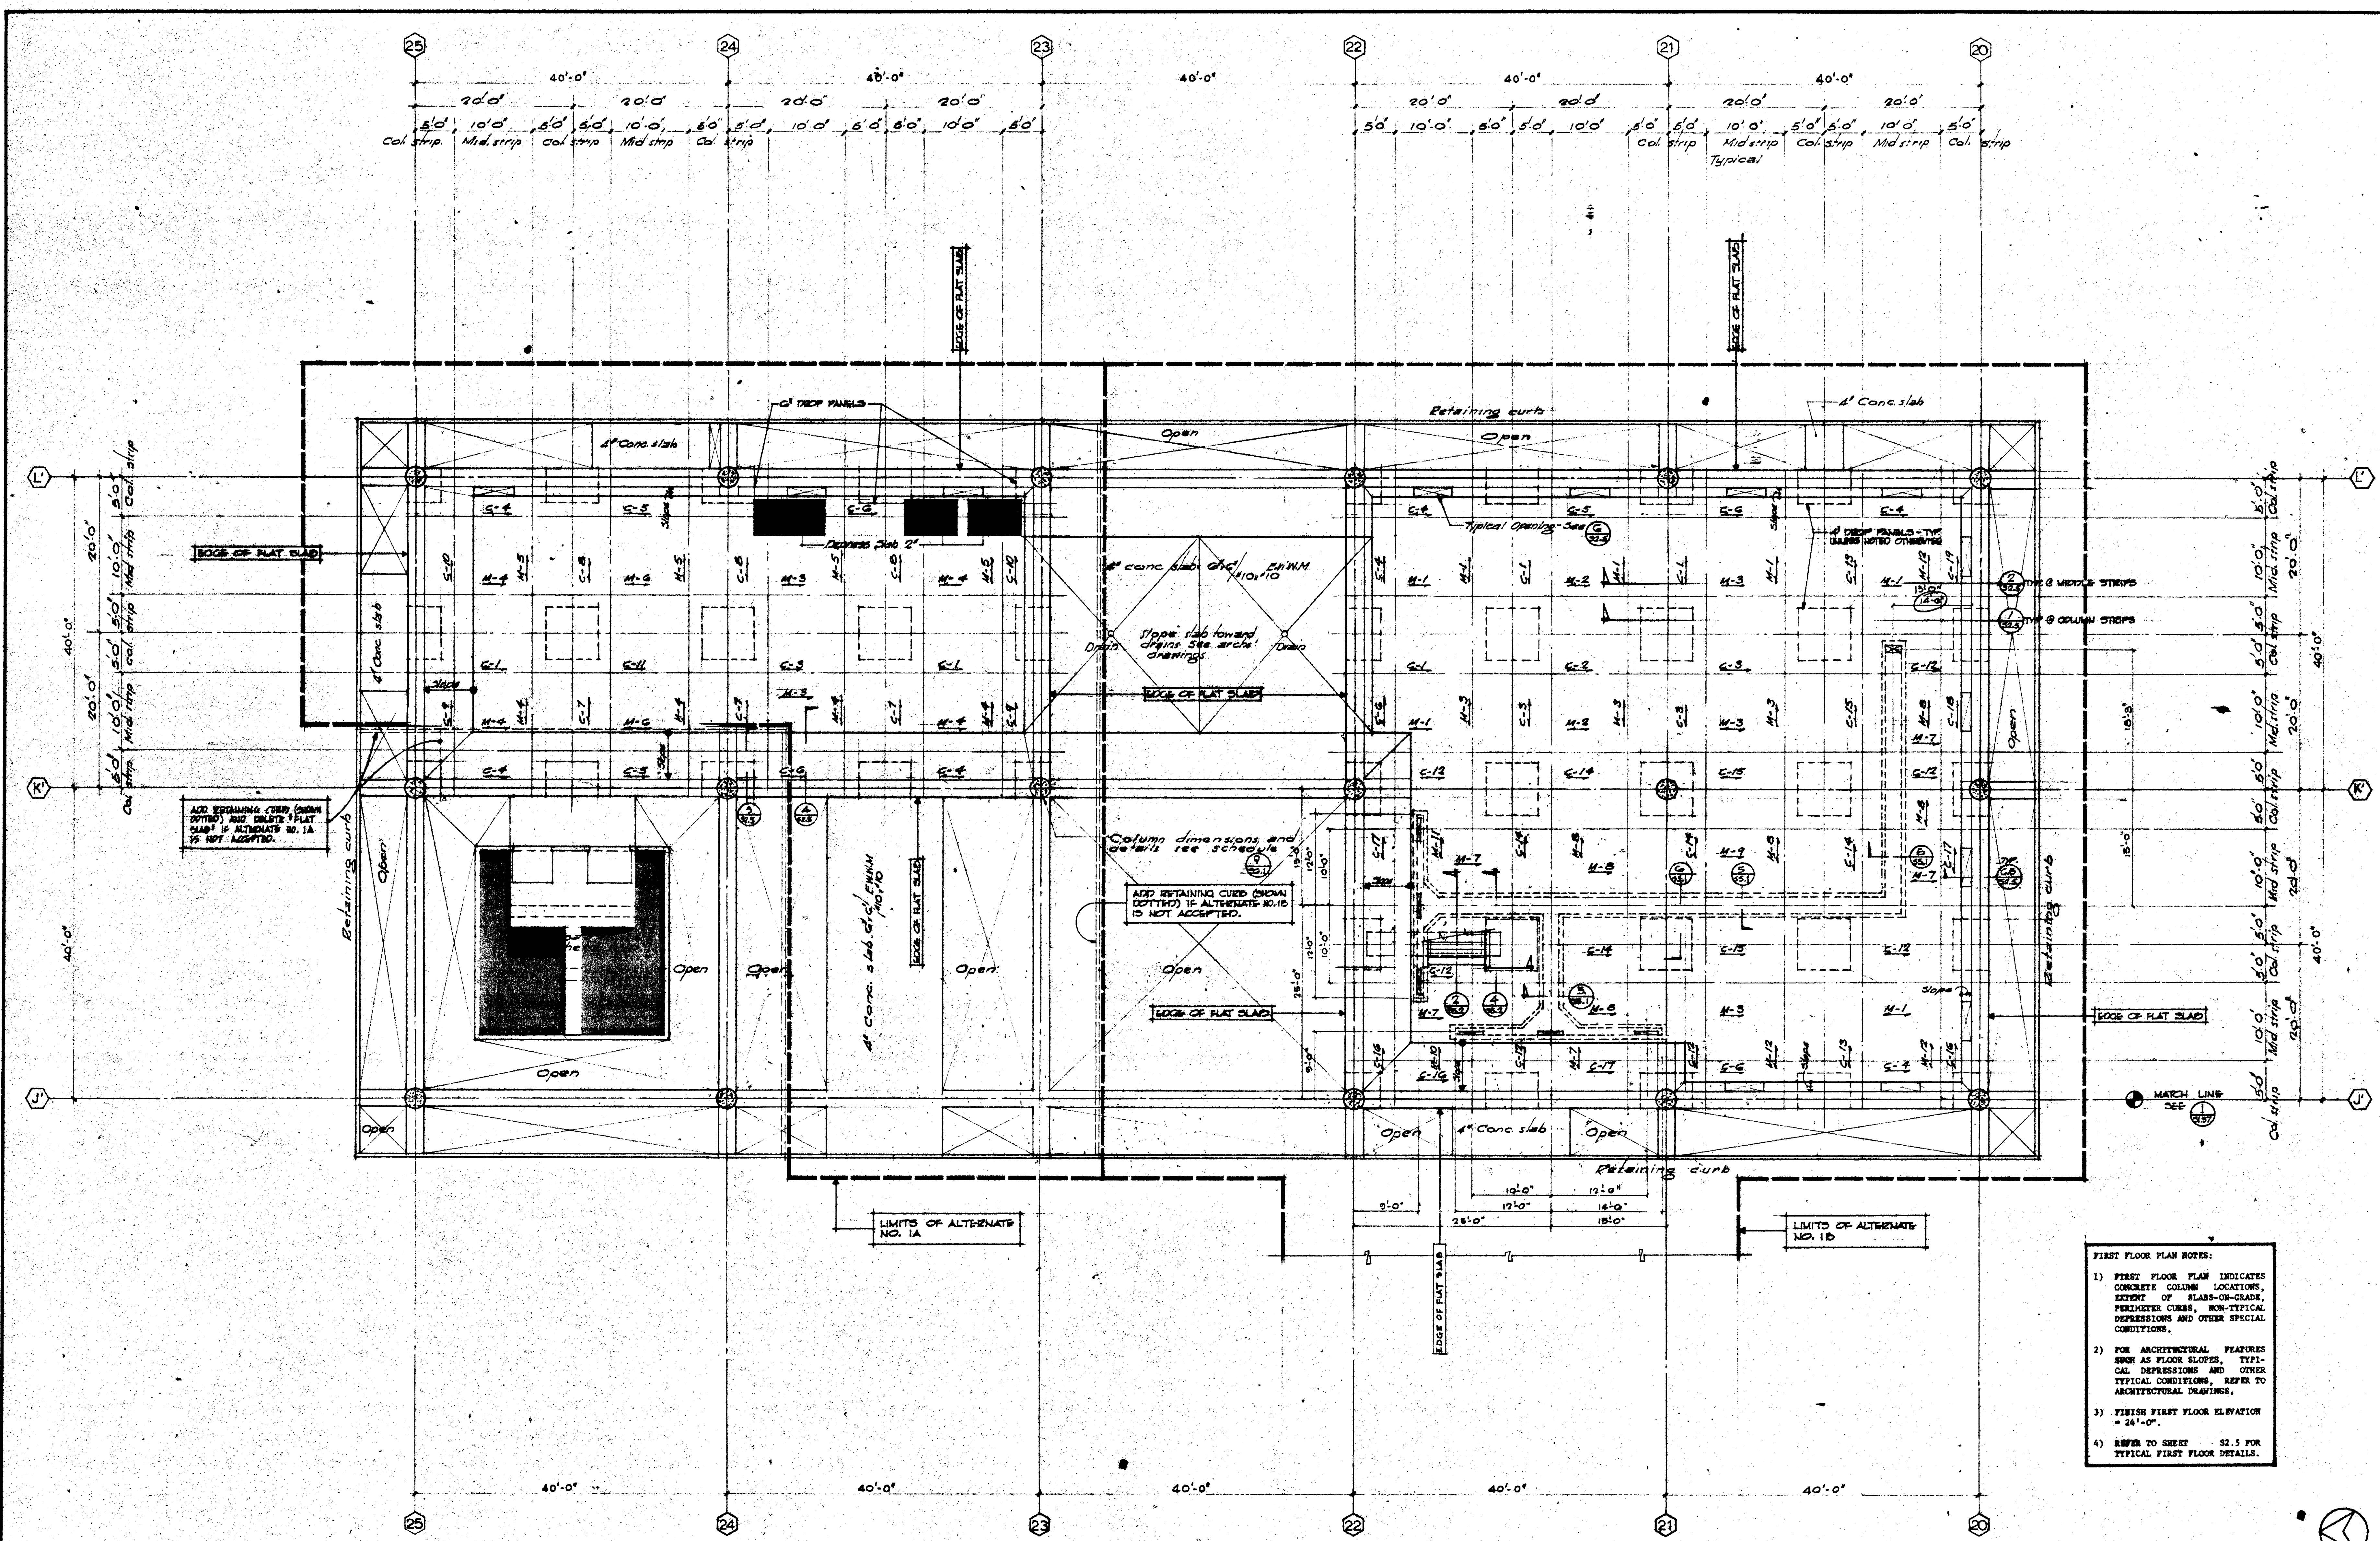

- ROOF PLAN NOTES:
- 1) ROOF PLAN INDICATES BEAMS, JOISTS, OPENINGS, NON-TYPICAL DEPRESSIONS AND OTHER SPECIAL CONDITIONS.
 - 2) FOR ARCHITECTURAL FEATURES SUCH AS ROOF SLOPES, PERIMETER CURBS AND SCUPPERS, REFER TO ARCHITECTURAL DRAWINGS.
 - 3) FINISH ROOF ELEVATION -48'-7"
 - 4) REFER TO SHEET S2.3 FOR TYPICAL ROOF DETAILS.

STRUCTURAL ENGINEERS BRANDOW & JOHNSTON J.A. MARTIN & ASSOCIATES MECHANICAL ENGINEERS RALPH E. PHILLIPS, INC. ELECTRICAL ENGINEERS RALPH E. PHILLIPS, INC. CIVIL ENGINEERS G. SHURMAN & ASSOCIATES MOFFATT & NICBOL		DESIGNED G.U. DRAWN BY 1.08 CHECKED BY G.U.	ARCHITECT WILLIAM L. PEREIRA & ASSOCIATES QUINCY JONES-FREDERICK E. EMMONS & ASSOCIATES BLUROCK ELLERBROEK & ASSOCIATES URBANUS SQUARE • MACARTHUR BOULEVARD AT FORD ROAD TELEPHONE 714/675-2640 • CORONA DEL MAR, CALIFORNIA	APPROVED STATE FIRE MARSHAL STATE OF CALIFORNIA DATE: JUN 21 1965 BY: [Signature]	APPROVED JUN 21 1965 25874 APPROVED JUN 21 1965 25874	GOLDEN WEST COLLEGE HUNTINGTON BEACH, CALIFORNIA ORANGE COAST JUNIOR COLLEGE DISTRICT	UNIT 4 ROOF PLAN	SCALE 1/8" = 1'-0" JOB NO. 1004 DATE 10 JUN 1965 SHEET NO. S 1.1 2
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UNIT G FOUNDATION

UNIT 5 FOUNDATION

STRUCTURAL ENGINEERS BRANDOW & JOHNSON T.A. MARTIN & ASSOCIATES	DESIGNED A.C.N.	ARCHITECT W.L. PEREIRA & ASSOCIATES
MECHANICAL ENGINEERS RALPH E. PHILLIPS, INC.	DRAWN BY O.D.	ENGINEER FREDERICK E. EMMONS & ASSOCIATES
ELECTRICAL ENGINEERS RALPH E. PHILLIPS, INC.	CHECKED BY L.P.	COLLEGES
CIVIL ENGINEERS G. SHURMAN & ASSOCIATES MOFFATT & NICHOL		

APPROVED
STATE FIRE MARSHAL
STATE OF CALIFORNIA
DATE JUN 11 1965

2587

APPROVED MAY 5 1965


STATE OF CALIFORNIA - CIVIL ENGINEER GENERAL SERVICES
DIVISION OF ARCHITECTURE AND CONSTRUCTION


ASSOCIATED ARCHITECTS:
WILLIAM L. PEREIRA & ASSOCIATES
A. QUINCY JONES-FREDERICK E. EMMONS & ASSOCIATES
BLUROCK ELLERBROEK & ASSOCIATES

URBANUS SQUARE • MACARTHUR BOULEVARD AT FORD ROAD
TELEPHONE 714/675-2640 • CORONA DEL MAR, CALIFORNIA


GOLDEN WEST COLLEGE
HUNTINGTON BEACH, CALIFORNIA
ORANGE COAST JUNIOR COLLEGE DISTRICT

UNITS 5 & 6	SCALE 1/8" = 1'	JOB NO. 104
FOUNDATION PLANS	DATE 6 MAY 1965	SHEET NO. S 1.13

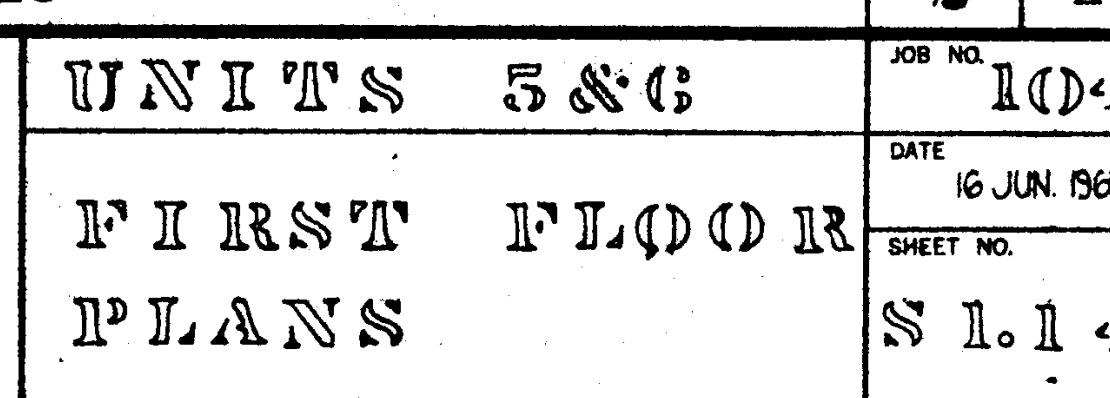

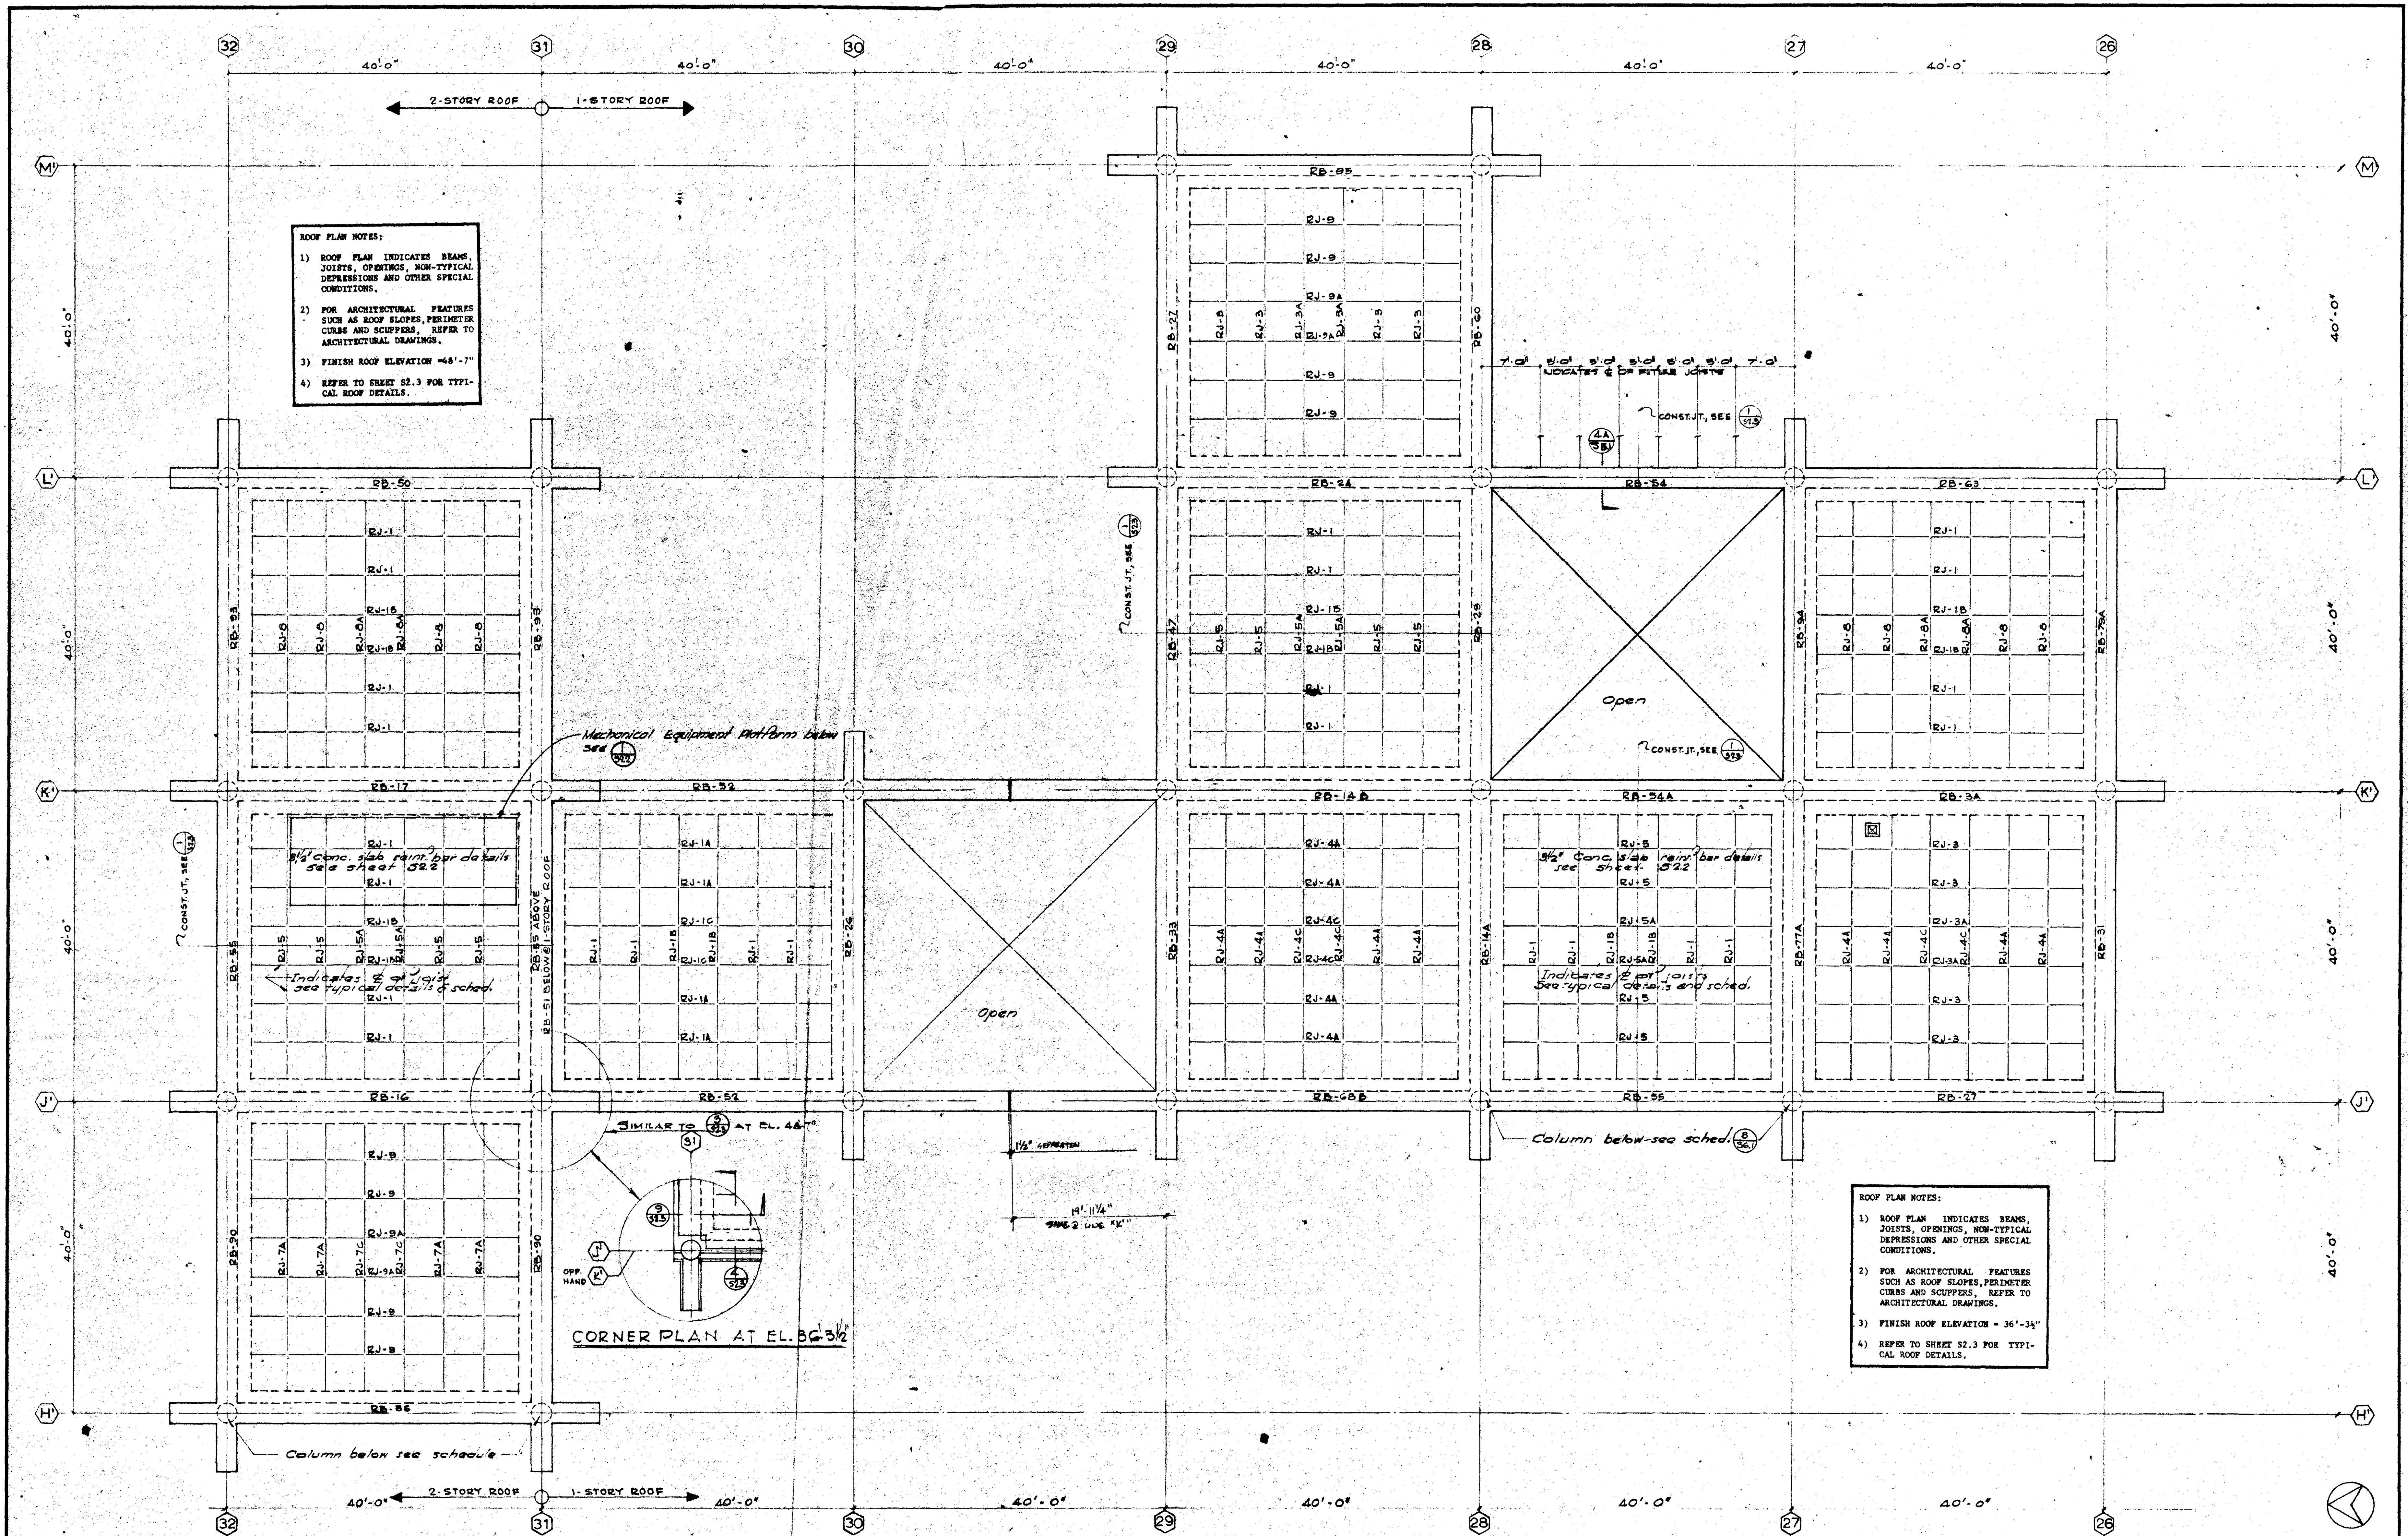

UNIT 5 ROOF				UNIT 5 ROOF				SCALE 1/8" = 1'-0"	
STRUCTURAL ENGINEERS BRADY & JOHNSON J.A. MARTIN & ASSOCIATES	DESIGNED G.J.	ARCHITECT WILLIAM L. PEREIRA	APPROVED JUN 21 1965	ASSOCIATED ARCHITECTS: WILLIAM L. PEREIRA & ASSOCIATES A. QUINCY JONES-FREDERICK E. EMMONS & ASSOCIATES BLUROCK ELLENBROCK & ASSOCIATES		GOLDEN WEST COLLEGE HUNTINGTON BEACH, CALIFORNIA ORANGE COAST JUNIOR COLLEGE DISTRICT		UNITS 5 & 6 ROOF PLANS	
MECHANICAL ENGINEERS RALPH E. PHILLIPS, INC.	DRAWN BY T.O.D.	ENGINEER Ralph Phillips	APPROVED JUN 21 1965	URBANUS SQUARE • MACARTHUR BOULEVARD AT FORD ROAD TELEPHONE 714/675-2640 • CORONA DEL MAR, CALIFORNIA				JOB NO. 104	
ELECTRICAL ENGINEERS RALPH E. PHILLIPS, INC.	CHECKED BY G.J.	COLLGE	APPROVED JUN 21 1965					DATE 16 JUN 1965	
CIVIL ENGINEERS O. GUERMAN & ASSOCIATES MOFFATT & NICHOL			BY G.J.					SHEET NO. 1.15	
REVISIONS									

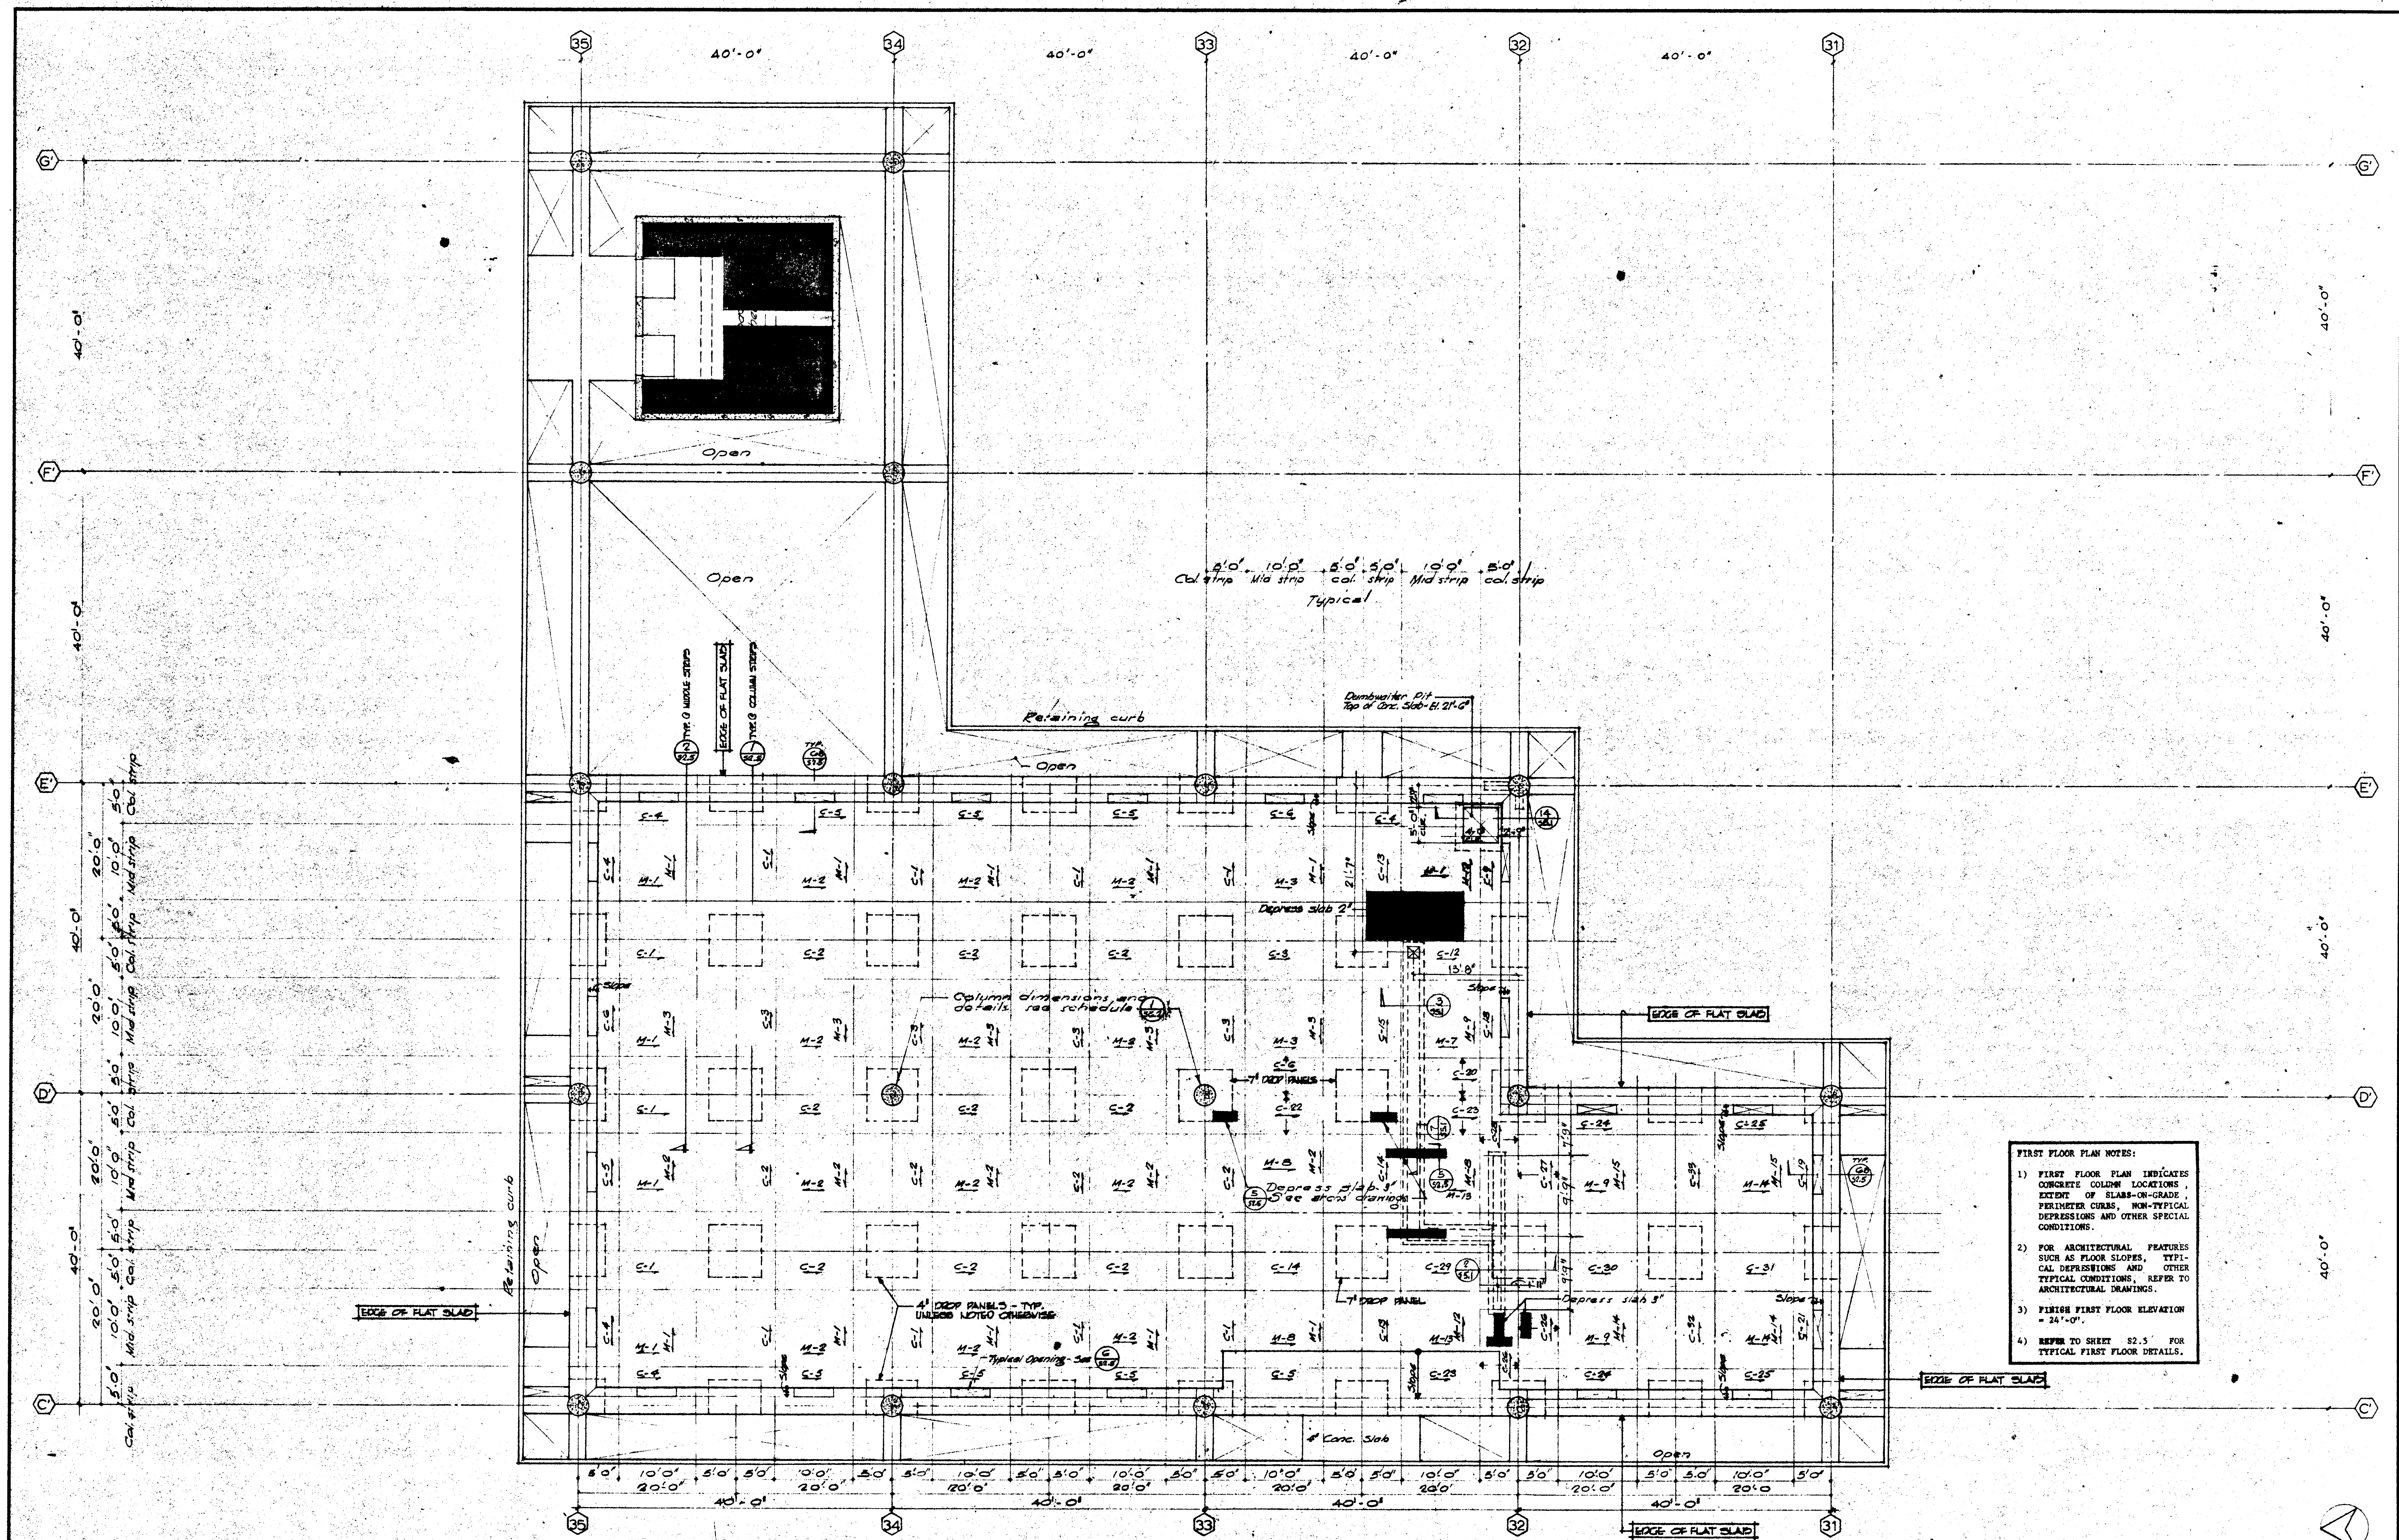

- FIRST FLOOR PLAN NOTES:**
- 1) FIRST FLOOR PLAN INDICATES CONCRETE COLUMN LOCATIONS, EXTENT OF SLABS-ON-GRADE, PERIMETER CURBS, NON-TYPICAL DEPRESSIONS AND OTHER SPECIAL CONDITIONS.
 - 2) FOR ARCHITECTURAL FEATURES SUCH AS FLOOR SLOPES, TYPICAL DEPRESSIONS AND OTHER TYPICAL CONDITIONS, REFER TO ARCHITECTURAL DRAWINGS.
 - 3) FINISH FIRST FLOOR ELEVATION = 24'-0".
 - 4) REFER TO SHEET S2.5 FOR TYPICAL FIRST FLOOR DETAILS.

UNIT 7 FIRST FLOOR

DATE	REVISIONS

STRUCTURAL ENGINEERS BRANDOW & JOHNSON J.A. MARTIN & ASSOCIATES	DESIGNED ACN
MECHANICAL ENGINEERS RALPH E. PHILLIPS, INC.	DRAWN BY TDB
ELECTRICAL ENGINEERS RALPH E. PHILLIPS, INC.	CHECKED BY P
CIVIL ENGINEERS G. SHURMAN & ASSOCIATES MOFFATT & NICHOL	

ARCHITECT WILLIAM L. PEREIRA	APPROVED JUN 21 1965
ENGINEER A. QUINCY JONES	
COLLEGE	


STATE OF CALIFORNIA - DEPARTMENT OF GENERAL SERVICES OFFICE OF ARCHITECTURE AND CONSTRUCTION	APPROVED JUN 21 1965
STATE FIRE MARSHAL STATE OF CALIFORNIA DATE JUN 21 1965	

ASSOCIATED ARCHITECTS: WILLIAM L. PEREIRA & ASSOCIATES A. QUINCY JONES - FREDERICK E. EMMONS & ASSOCIATES BLUROCK ELLERBROEK & ASSOCIATES	URBANUS SQUARE • MACARTHUR BOULEVARD AT FORD ROAD TELEPHONE 714/675-2640 • CORONA DEL MAR, CALIFORNIA
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GOLDEN WEST COLLEGE
HUNTINGTON BEACH, CALIFORNIA
ORANGE COAST JUNIOR COLLEGE DISTRICT

UNIT 7	JOB NO. 1004
FIRST FLOOR	DATE 16 JUN 1965
PLAN	SHEET NO. S 1.17


SCALE 1/8" = 1'-0"	1
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- ROOF PLAN NOTES:
- 1) ROOF PLAN INDICATES BEAMS, JOINTS, OPENINGS, NON-TYPICAL DEPRESSIONS AND OTHER SPECIAL CONDITIONS.
 - 2) FOR ARCHITECTURAL FEATURES SUCH AS ROOF SLOPES, PERIMETER CURBS AND SCUPPERS, REFER TO ARCHITECTURAL DRAWINGS.
 - 3) FINISH ROOF ELEVATION = 48'-7"
 - 4) REFER TO SHEET S2.3 FOR TYPICAL ROOF DETAILS.


MATCH LINE
SEE SHT. S1.2B

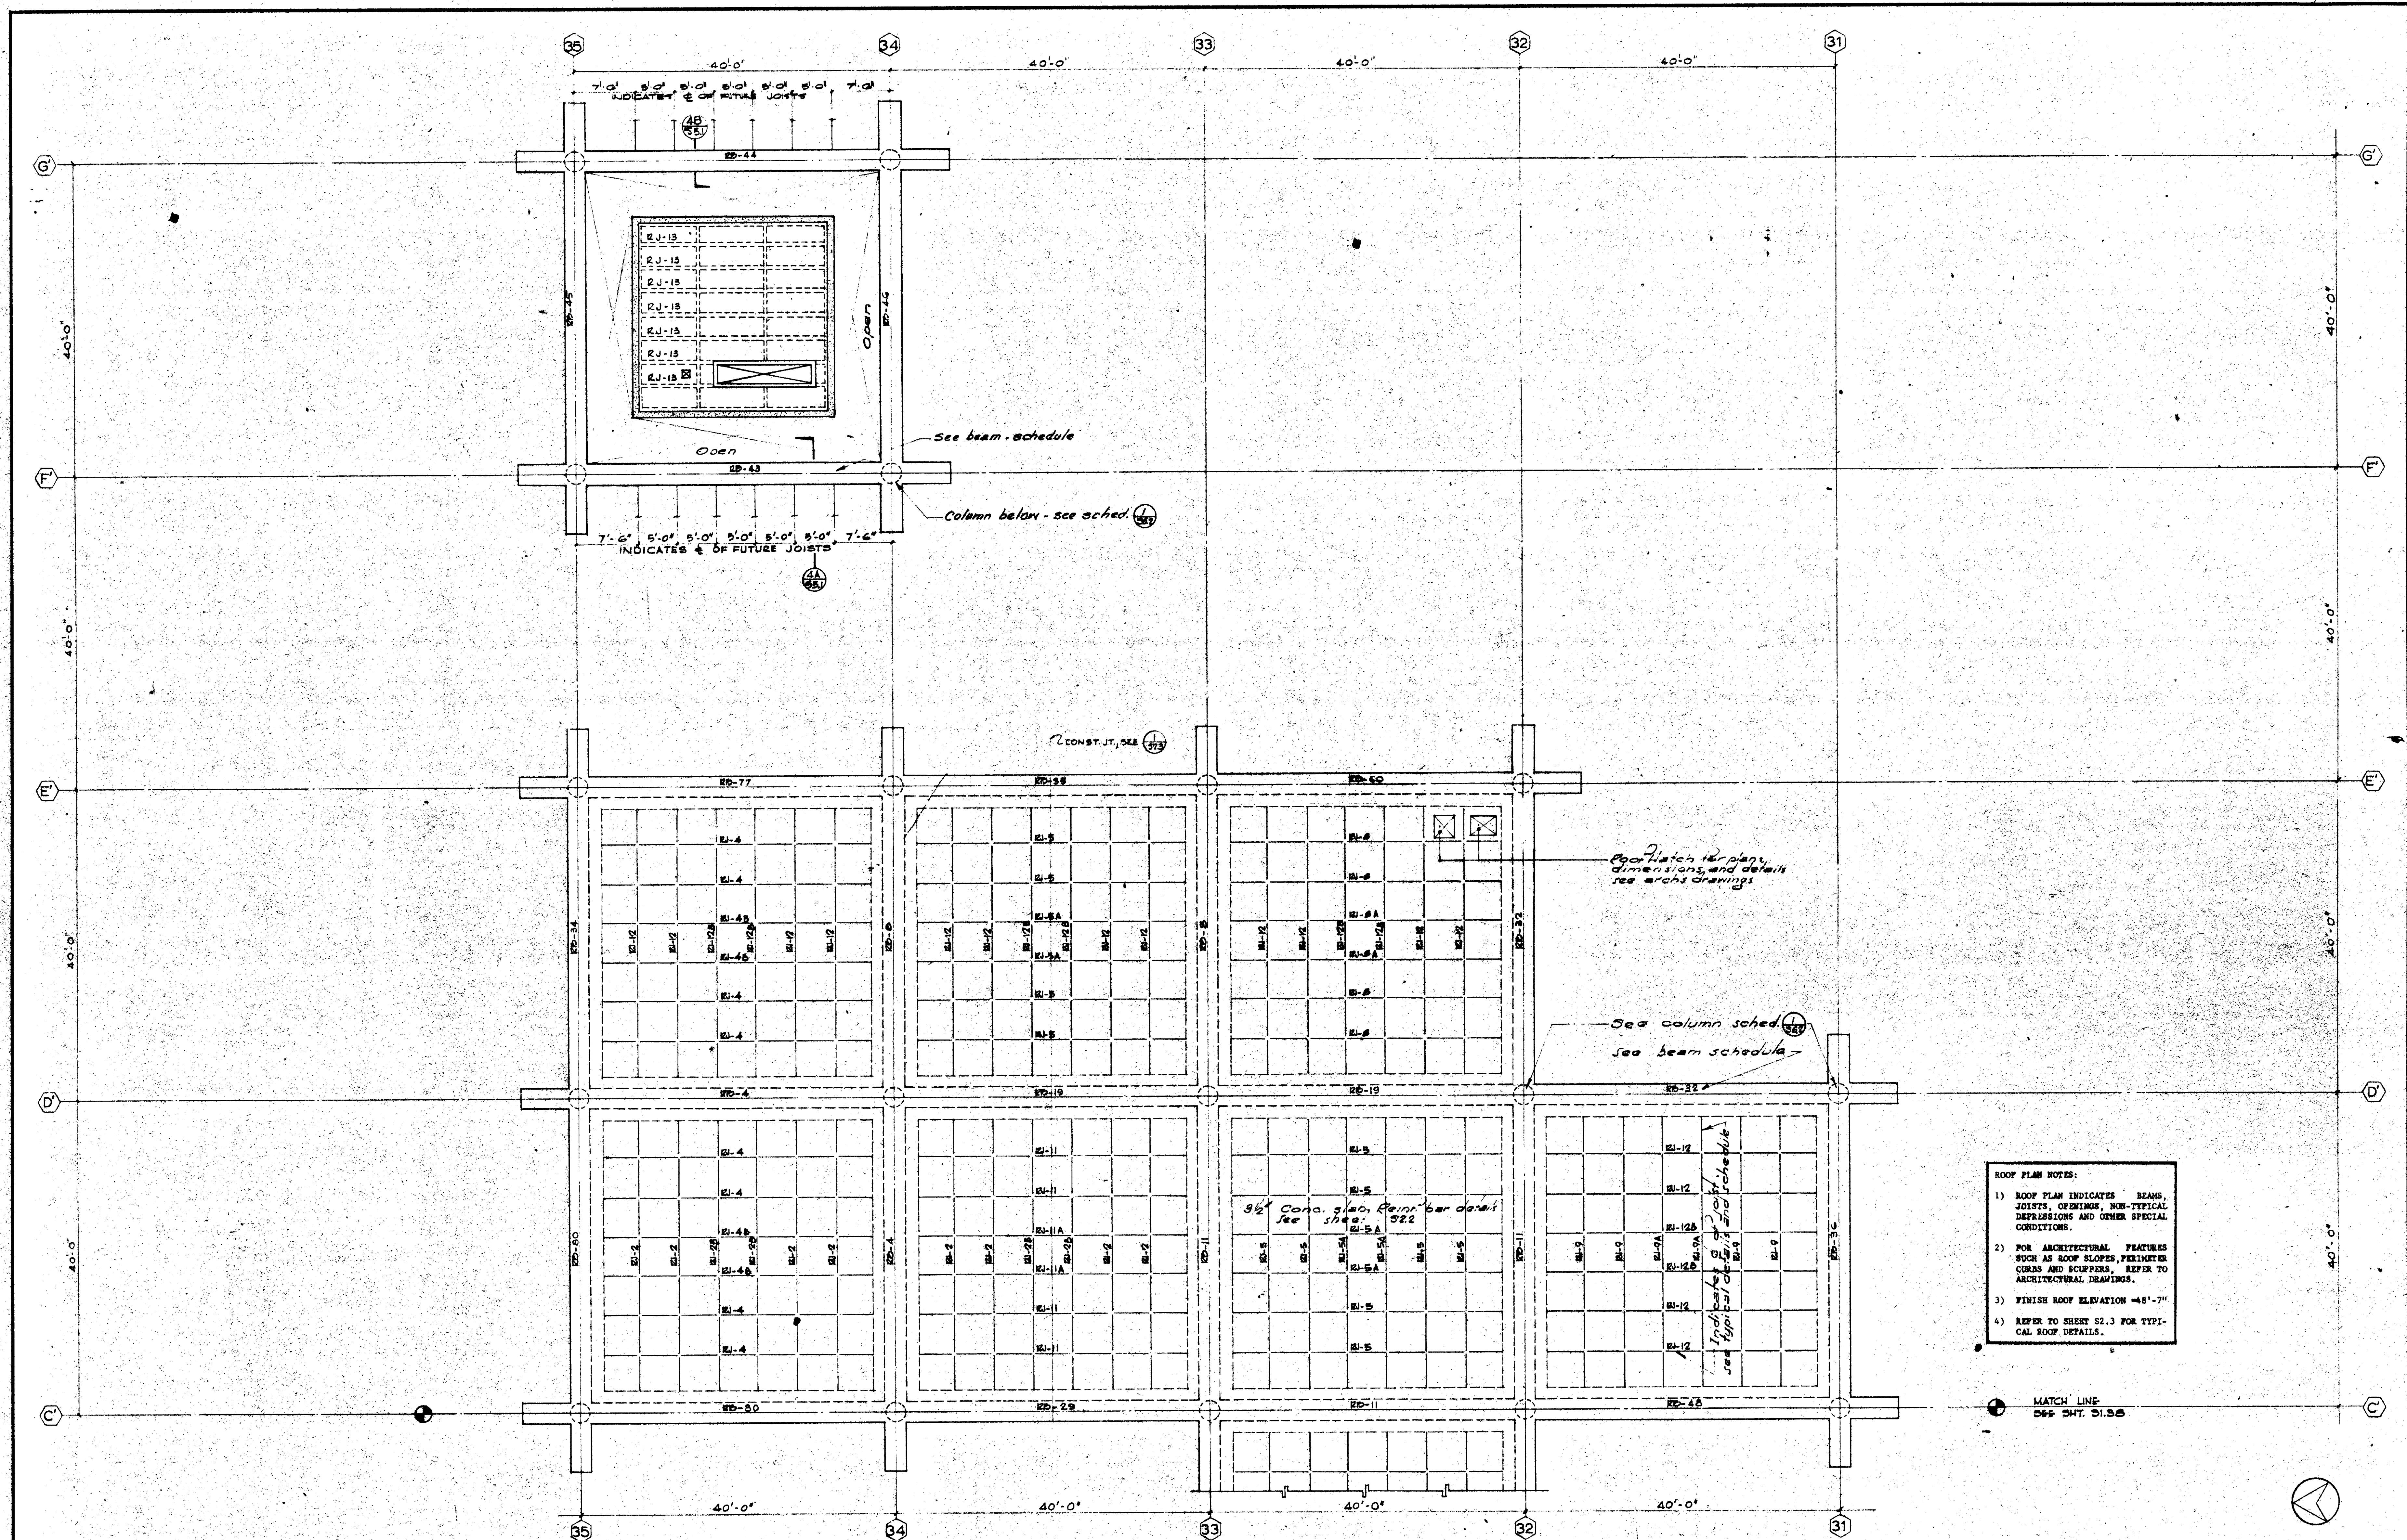STRUCTURAL ENGINEERS BRANDOW & JOHNSTON & A. MARTIN & ASSOCIATES MECHANICAL ENGINEERS RALPH E. PHILLIPS, INC. ELECTRICAL ENGINEERS RALPH E. PHILLIPS, INC. CIVIL ENGINEERS O. SHURMAN & ASSOCIATES MOFFATT & NICHOL		DESIGNED GU DRAWN BY T.O.B. CHECKED BY G.U.	ARCHITECT WILLIAM L. PEREIRA ENGINEER LLOYD J. JOHNSON COLLEGE	APPROVED 25974 APPROVED JUN 1 1965 WILLIAM L. PEREIRA	ASSOCIATED ARCHITECTS: WILLIAM L. PEREIRA & ASSOCIATES A. QUINCY JONES-FREDERICK E. EMMONS & ASSOCIATES BLUROCK ELLERBROEK & ASSOCIATES URBANUS SQUARE • MACARTHUR BOULEVARD AT FORD ROAD TELEPHONE 714/675-2640 • CORONA DEL MAR, CALIFORNIA	GOLDEN WEST COLLEGE HUNTINGTON BEACH, CALIFORNIA ORANGE COAST JUNIOR COLLEGE DISTRICT	UNIT 7 ROOF PLAN	SCALE 1/8" = 1'-0" JOB NO. 104 DATE 16 JUN 1965 SHEET NO. S 1.1 D
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- FOUNDATION PLAN NOTES:
- 1) FOUNDATION PLAN INDICATES THE LOCATION, LAYOUT AND ORIENTATION OF PILES, PILE CAPS AND TIE BEAMS.
 - 2) TOP OF PILE CAP ELEVATION = 22'-8" UNLESS OTHERWISE NOTED.
 - 3) TOP OF TIE BEAM ELEVATION = 22'-8" UNLESS OTHERWISE NOTED.
 - 4) REFER TO SHEET S2.1 FOR TYPICAL FOUNDATION DETAILS.

APPROVED STATE OF CALIFORNIA DATE JUN 1965										UNIT 8a FOUNDATION										SCALE 1/8" = 1'	1									
<div>STRUCTURAL ENGINEERS BRANDOW & JOHNSTON J. A. MARTIN & ASSOCIATES</div> <div>MECHANICAL ENGINEERS RALPH E. PHILLIPS, INC.</div> <div>ELECTRICAL ENGINEERS RALPH E. PHILLIPS, INC.</div> <div>CIVIL ENGINEERS G. SHURMAN & ASSOCIATES MOFFATT & NICHOL</div>										DESIGNED A.C.N.		ARCHITECT WILLIAM L. PEREIRA & ASSOCIATES A. QUINCY JONES-FREDERICK E. EMMONS & ASSOCIATES BLUROCK ELLERBROEK & ASSOCIATES		APPROVED DATE JUN 1965		GOLDEN WEST COLLEGE HUNTINGTON BEACH, CALIFORNIA ORANGE COAST JUNIOR COLLEGE DISTRICT										UNIT 8a FOUNDATION PLAN		JOB NO. 1004	DATE 6 MAY 1965	SHEET NO. S 1.2 (D)
REVISIONS										DRAWN BY O.P.		CHECKED BY IP		URBANUS SQUARE • MACARTHUR BOULEVARD AT FORD ROAD TELEPHONE 714/675-2640 • CORONA DEL MAR, CALIFORNIA																

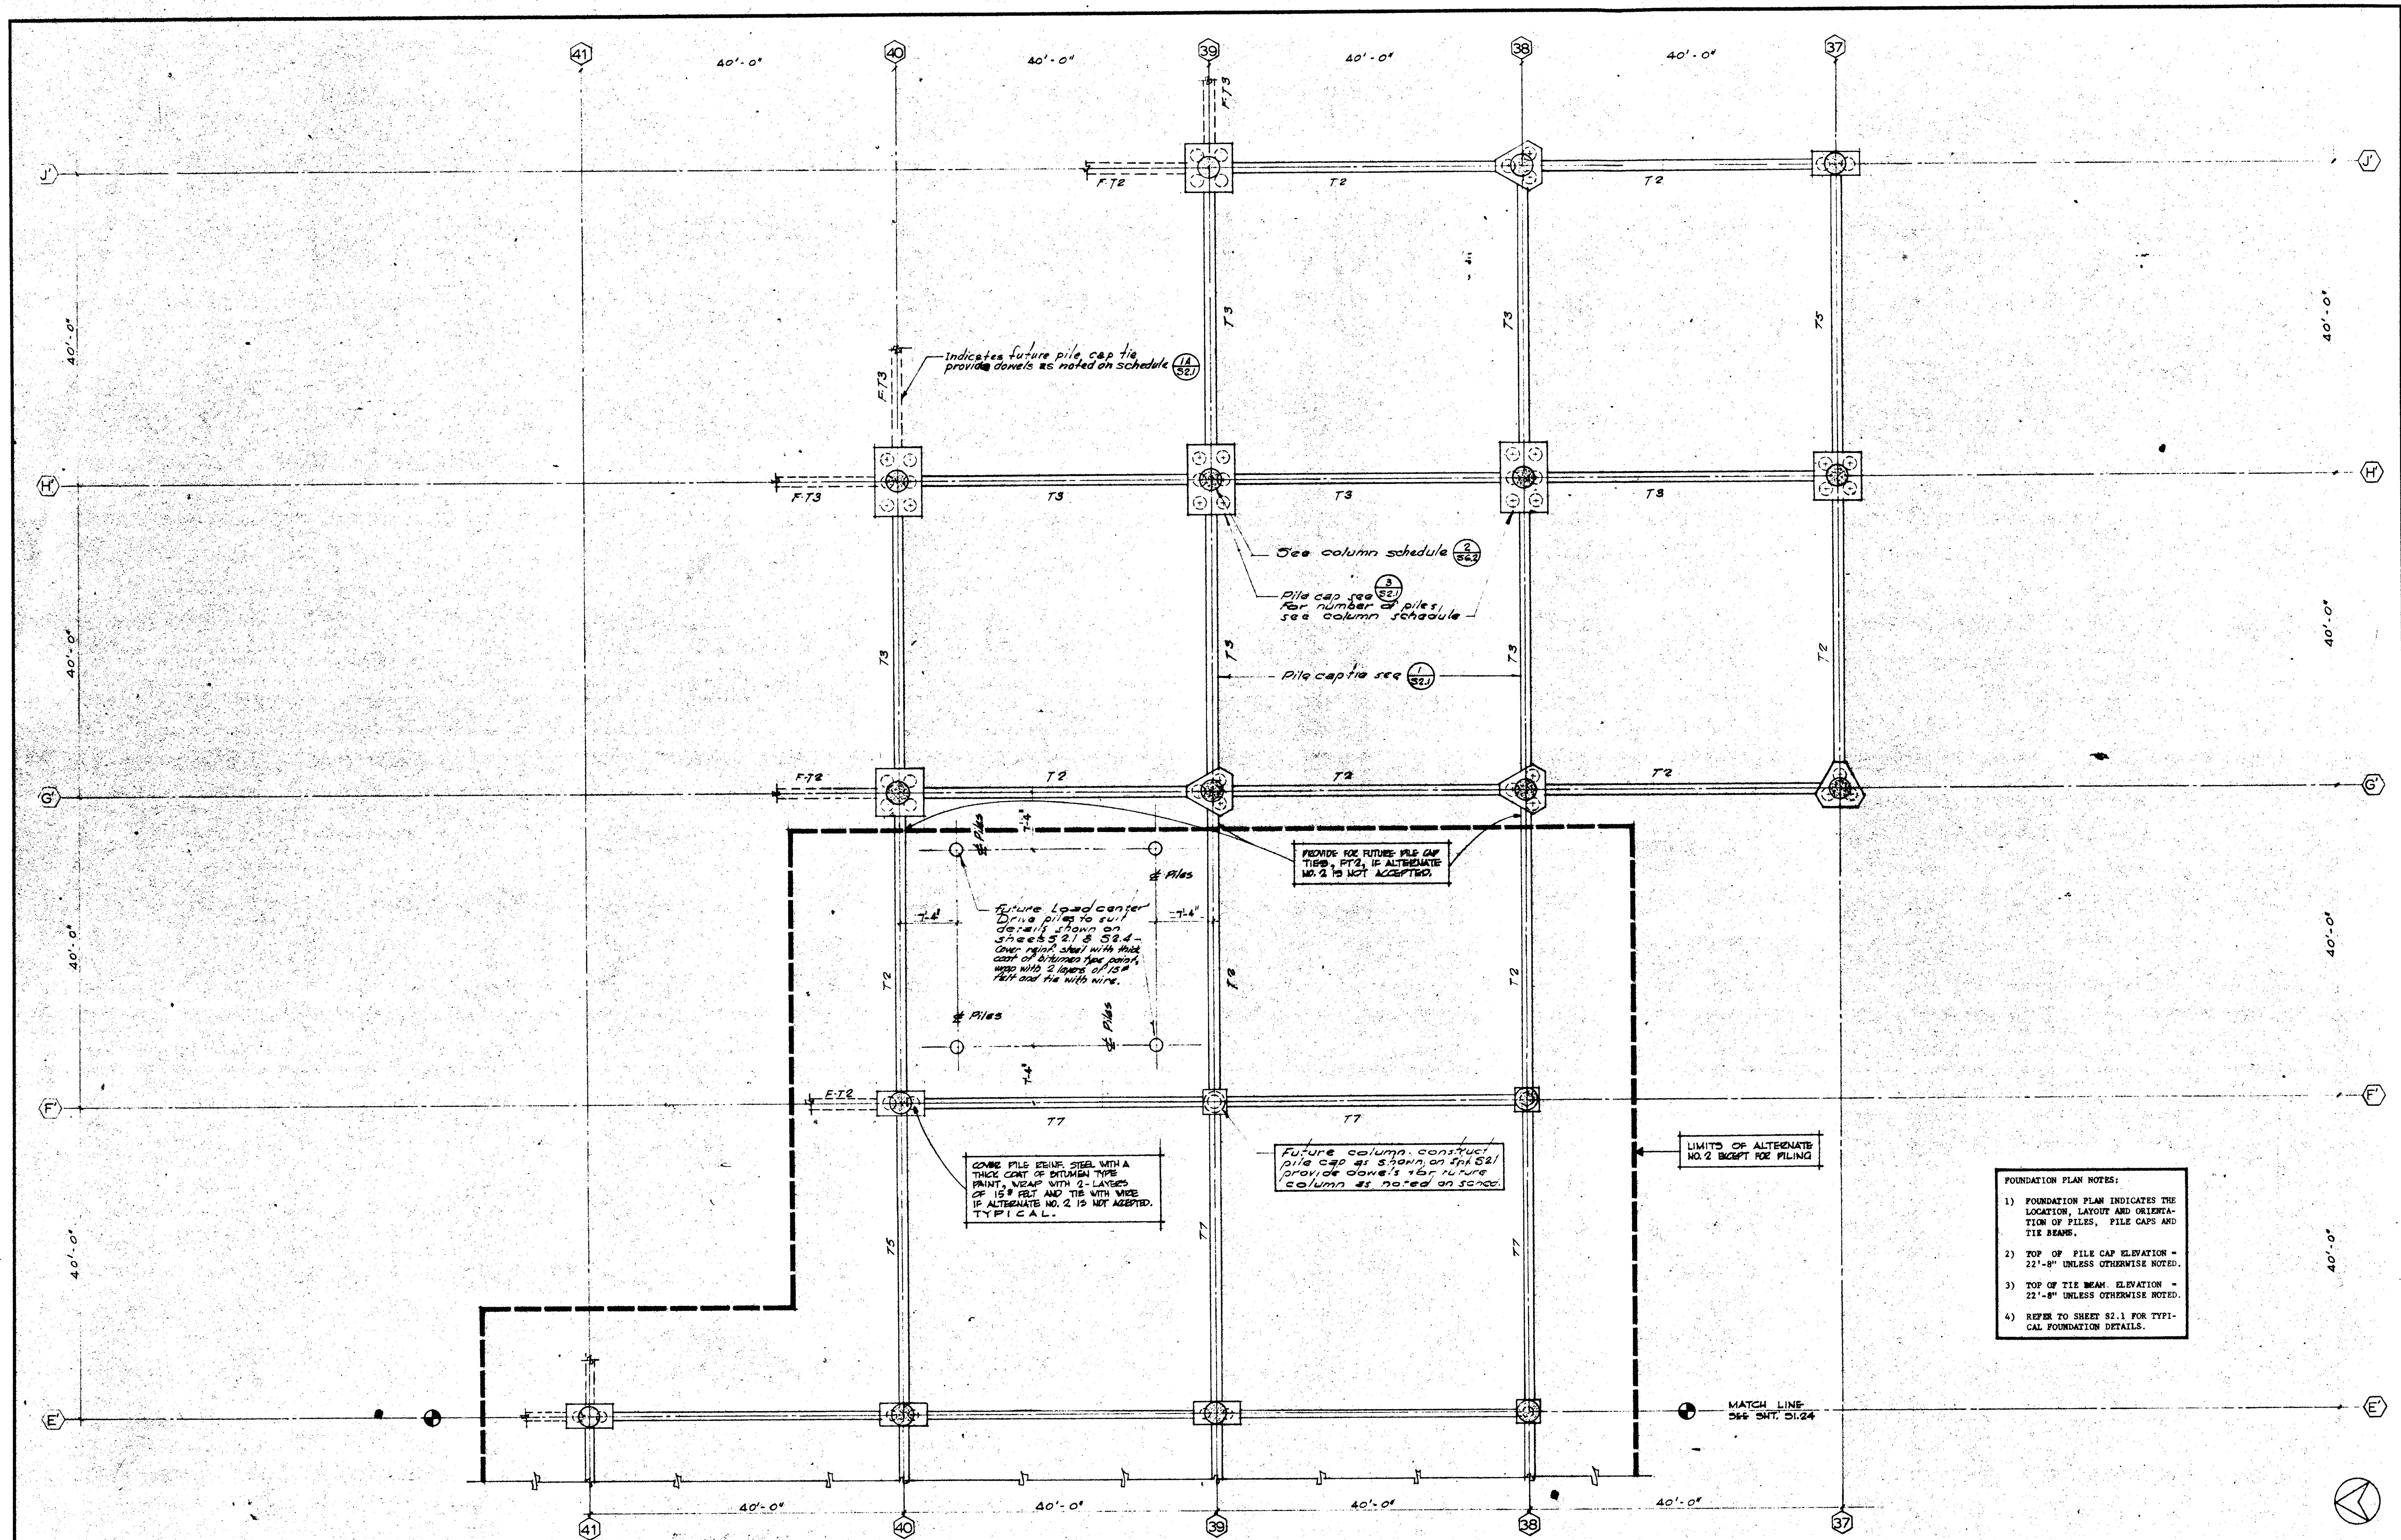

- FIRST FLOOR PLAN NOTES:**
- 1) FIRST FLOOR PLAN INDICATES CONCRETE COLUMN LOCATIONS, EXISTING OF SLAB-ON-GRADE, PERIMETER CURBS, NON-TYPICAL DEPRESSIONS AND OTHER SPECIAL CONDITIONS.
 - 2) FOR ARCHITECTURAL FEATURES SUCH AS FLOOR SLOPE, TYPICAL DEPRESSIONS AND OTHER TYPICAL CONDITIONS, REFER TO ARCHITECTURAL DRAWINGS.
 - 3) FINISH FIRST FLOOR ELEVATION = 24'-0".
 - 4) REFER TO SHEET 52.1 FOR TYPICAL FIRST FLOOR DETAILS.

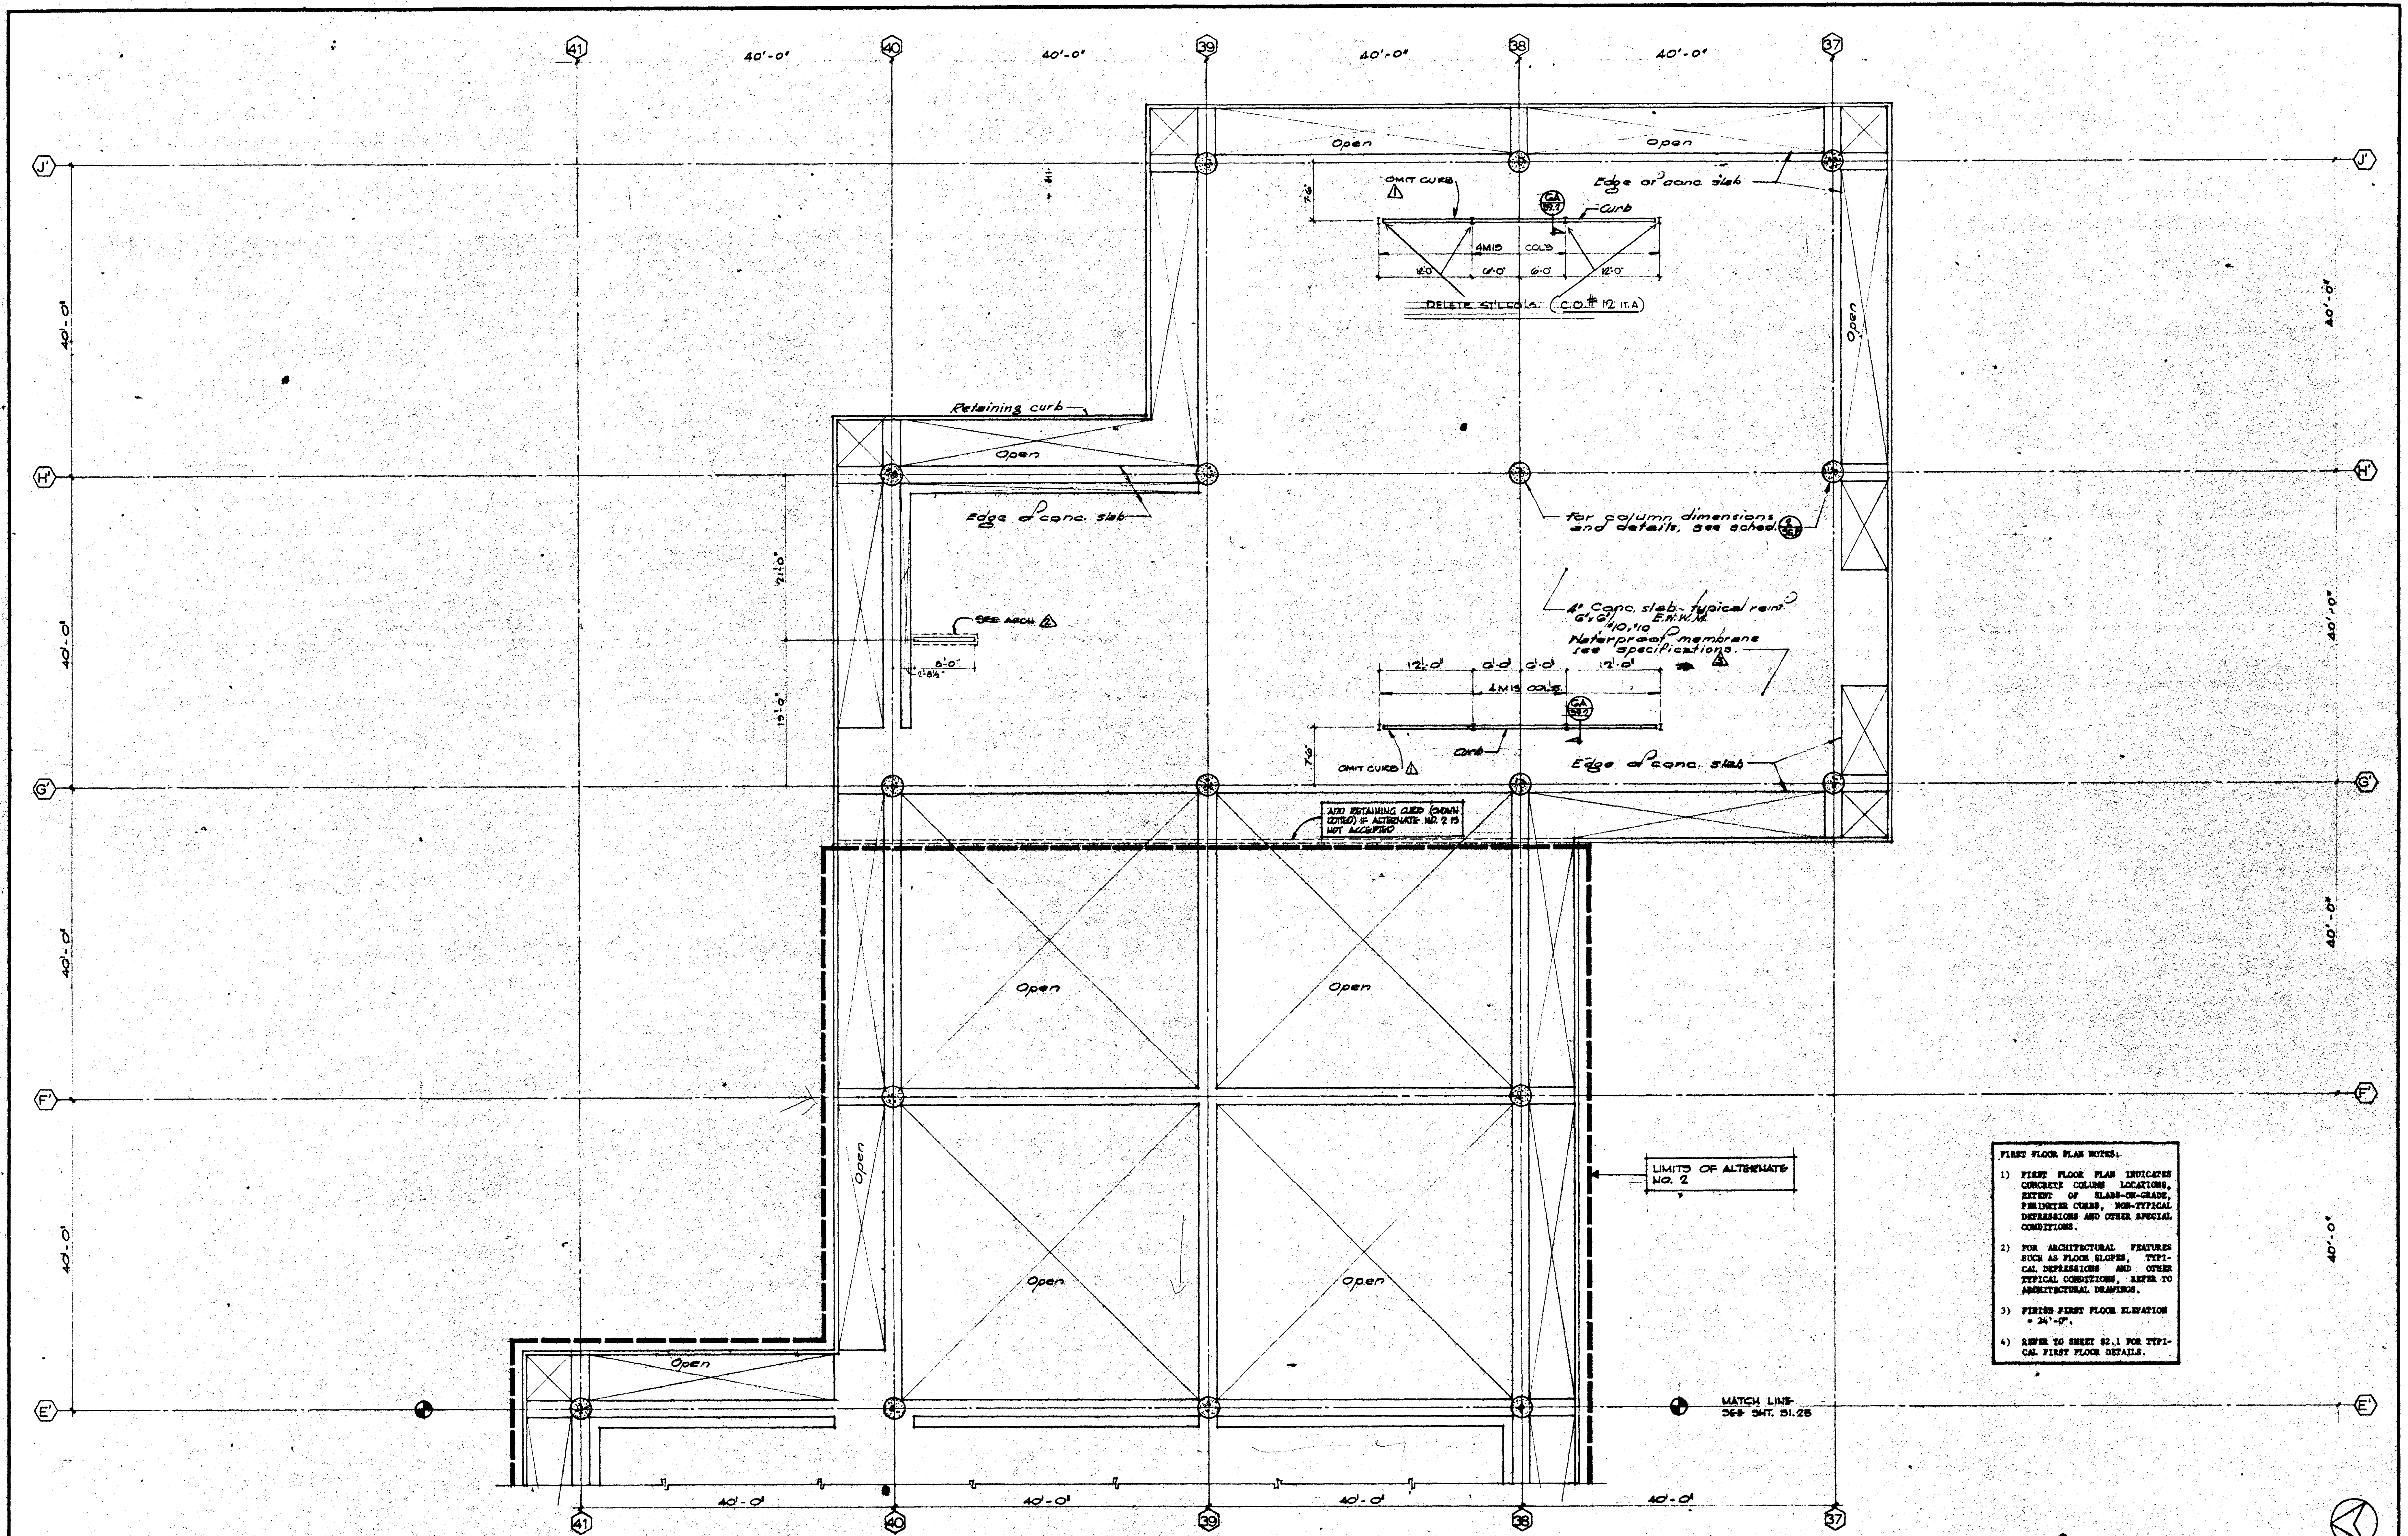UNIT 8a FIRST FLOOR


DESIGNED BY	SEE SHEET NO. 1, ITEM 22a	STRUCTURAL ENGINEERS	BRANDOW & JOHNSON J.A. MARTIN & ASSOCIATES	DESIGNED	A.C.N.	ARCHITECT	W.L. PEREIRA
DRAWN BY	SEE SHEET NO. 1, ITEM 22b	MECHANICAL ENGINEERS	RALPH S. PHILLIPS, INC.	DRAWN BY	1.00	ENGINEER	RAY H. PHILLIPS
CHECKED BY	SEE SHEET NO. 2, ITEM 1	ELECTRICAL ENGINEERS	RALPH S. PHILLIPS, INC.	CHECKED BY	W.P.	COLLAGE	
DATE		CIVIL ENGINEERS	G. BRUJMAN & ASSOCIATES MOFRATT & NICCOL	APPROVED		STATE FIRE MARSHAL	
REVISIONS				DATE	JUN 21 1965	DATE	JUN 21 1965

APPROVED	STATE FIRE MARSHAL	DATE	JUN 21 1965
APPROVED	STATE FIRE MARSHAL	DATE	JUN 21 1965

ASSOCIATED ARCHITECTS:
 WILLIAM L. PEREIRA & ASSOCIATES
 A. QUINCY JONES-FREDERICK E. EMMONS & ASSOCIATES
 BLUE ROCK ELLERBROOK & ASSOCIATES
 URBANUS SQUARE • MACARTHUR BOULEVARD AT FORD ROAD
 TELEPHONE 716/675-2640 • CORONA DEL MAR, CALIFORNIA

GOLDEN WEST COLLEGE
 HUNTINGTON BEACH, CALIFORNIA
 ORANGE COAST JUNIOR COLLEGE DISTRICT

UNIT 8a	SCALE	1/8" = 1'-0"
FIRST FLOOR PLAN	JOB NO.	1041
	DATE	16 JUN 1965
	SHEET NO.	S 1.2 1

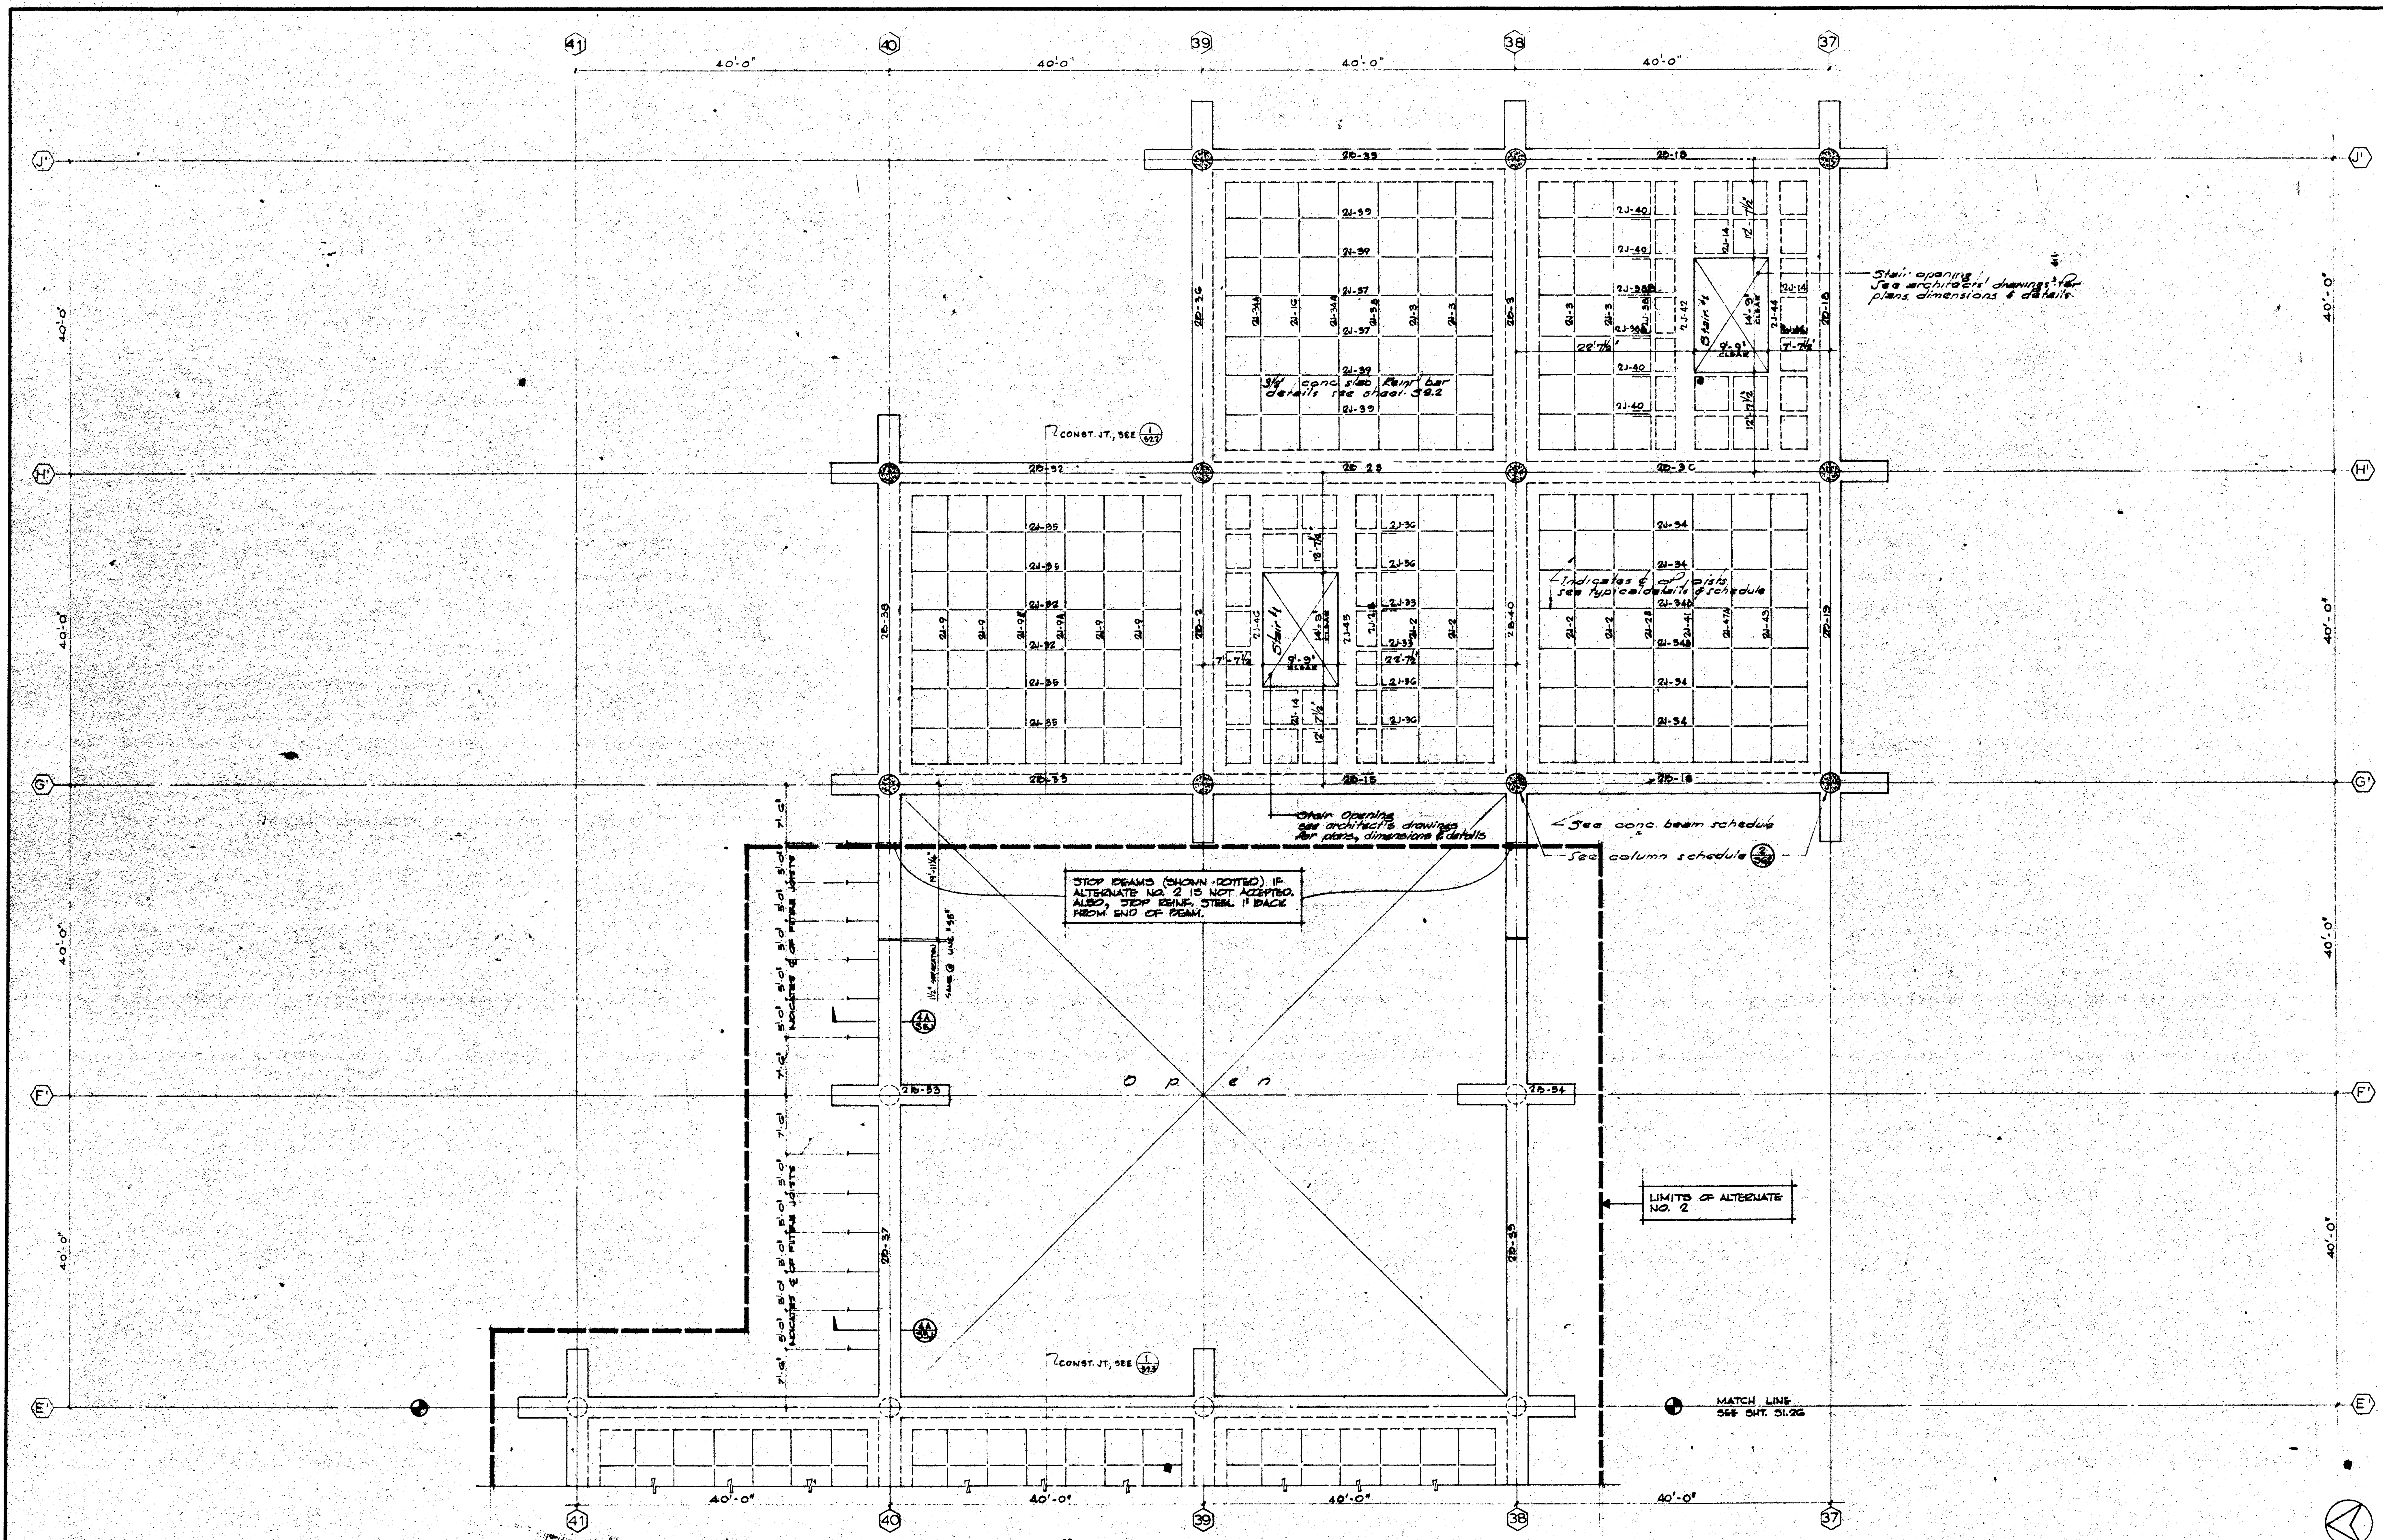

UNIT #3a SECOND FLOOR


DESIGNED GU	ARCHITECT W. L. PEREIRA	APPROVED STATE FIRE MARSHAL DATE JUN 21 1965
DRAWN BY L. D.	CHECKED BY GU	
STRUCTURAL ENGINEERS BRANDOW & JOHNSTON J. A. MARTIN & ASSOCIATES	MECHANICAL ENGINEERS RALPH E. PHILLIPS, INC.	ELECTRICAL ENGINEERS RALPH E. PHILLIPS, INC.
CIVIL ENGINEERS G. SHURMAN & ASSOCIATES MOFFATT & NICHOL		

ASSOCIATED ARCHITECTS:
WILLIAM L. PEREIRA & ASSOCIATES
A. QUINCY JONES-FREDERICK E. EMMONS & ASSOCIATES
BLUROCK ELLERBROCK & ASSOCIATES
URBANUS SQUARE • MACARTHUR BOULEVARD AT FORD ROAD
TELEPHONE 714/675-2640 • CORONA DEL MAR, CALIFORNIA

GOLDEN WEST COLLEGE
HUNTINGTON BEACH, CALIFORNIA
ORANGE COAST JUNIOR COLLEGE DISTRICT


UNIT #3a	JOB NO. 1004
SECOND FLOOR PLAN	DATE 16 JUN 1965
	SHEET NO. S 1.22

SCALE 1/8" = 1'

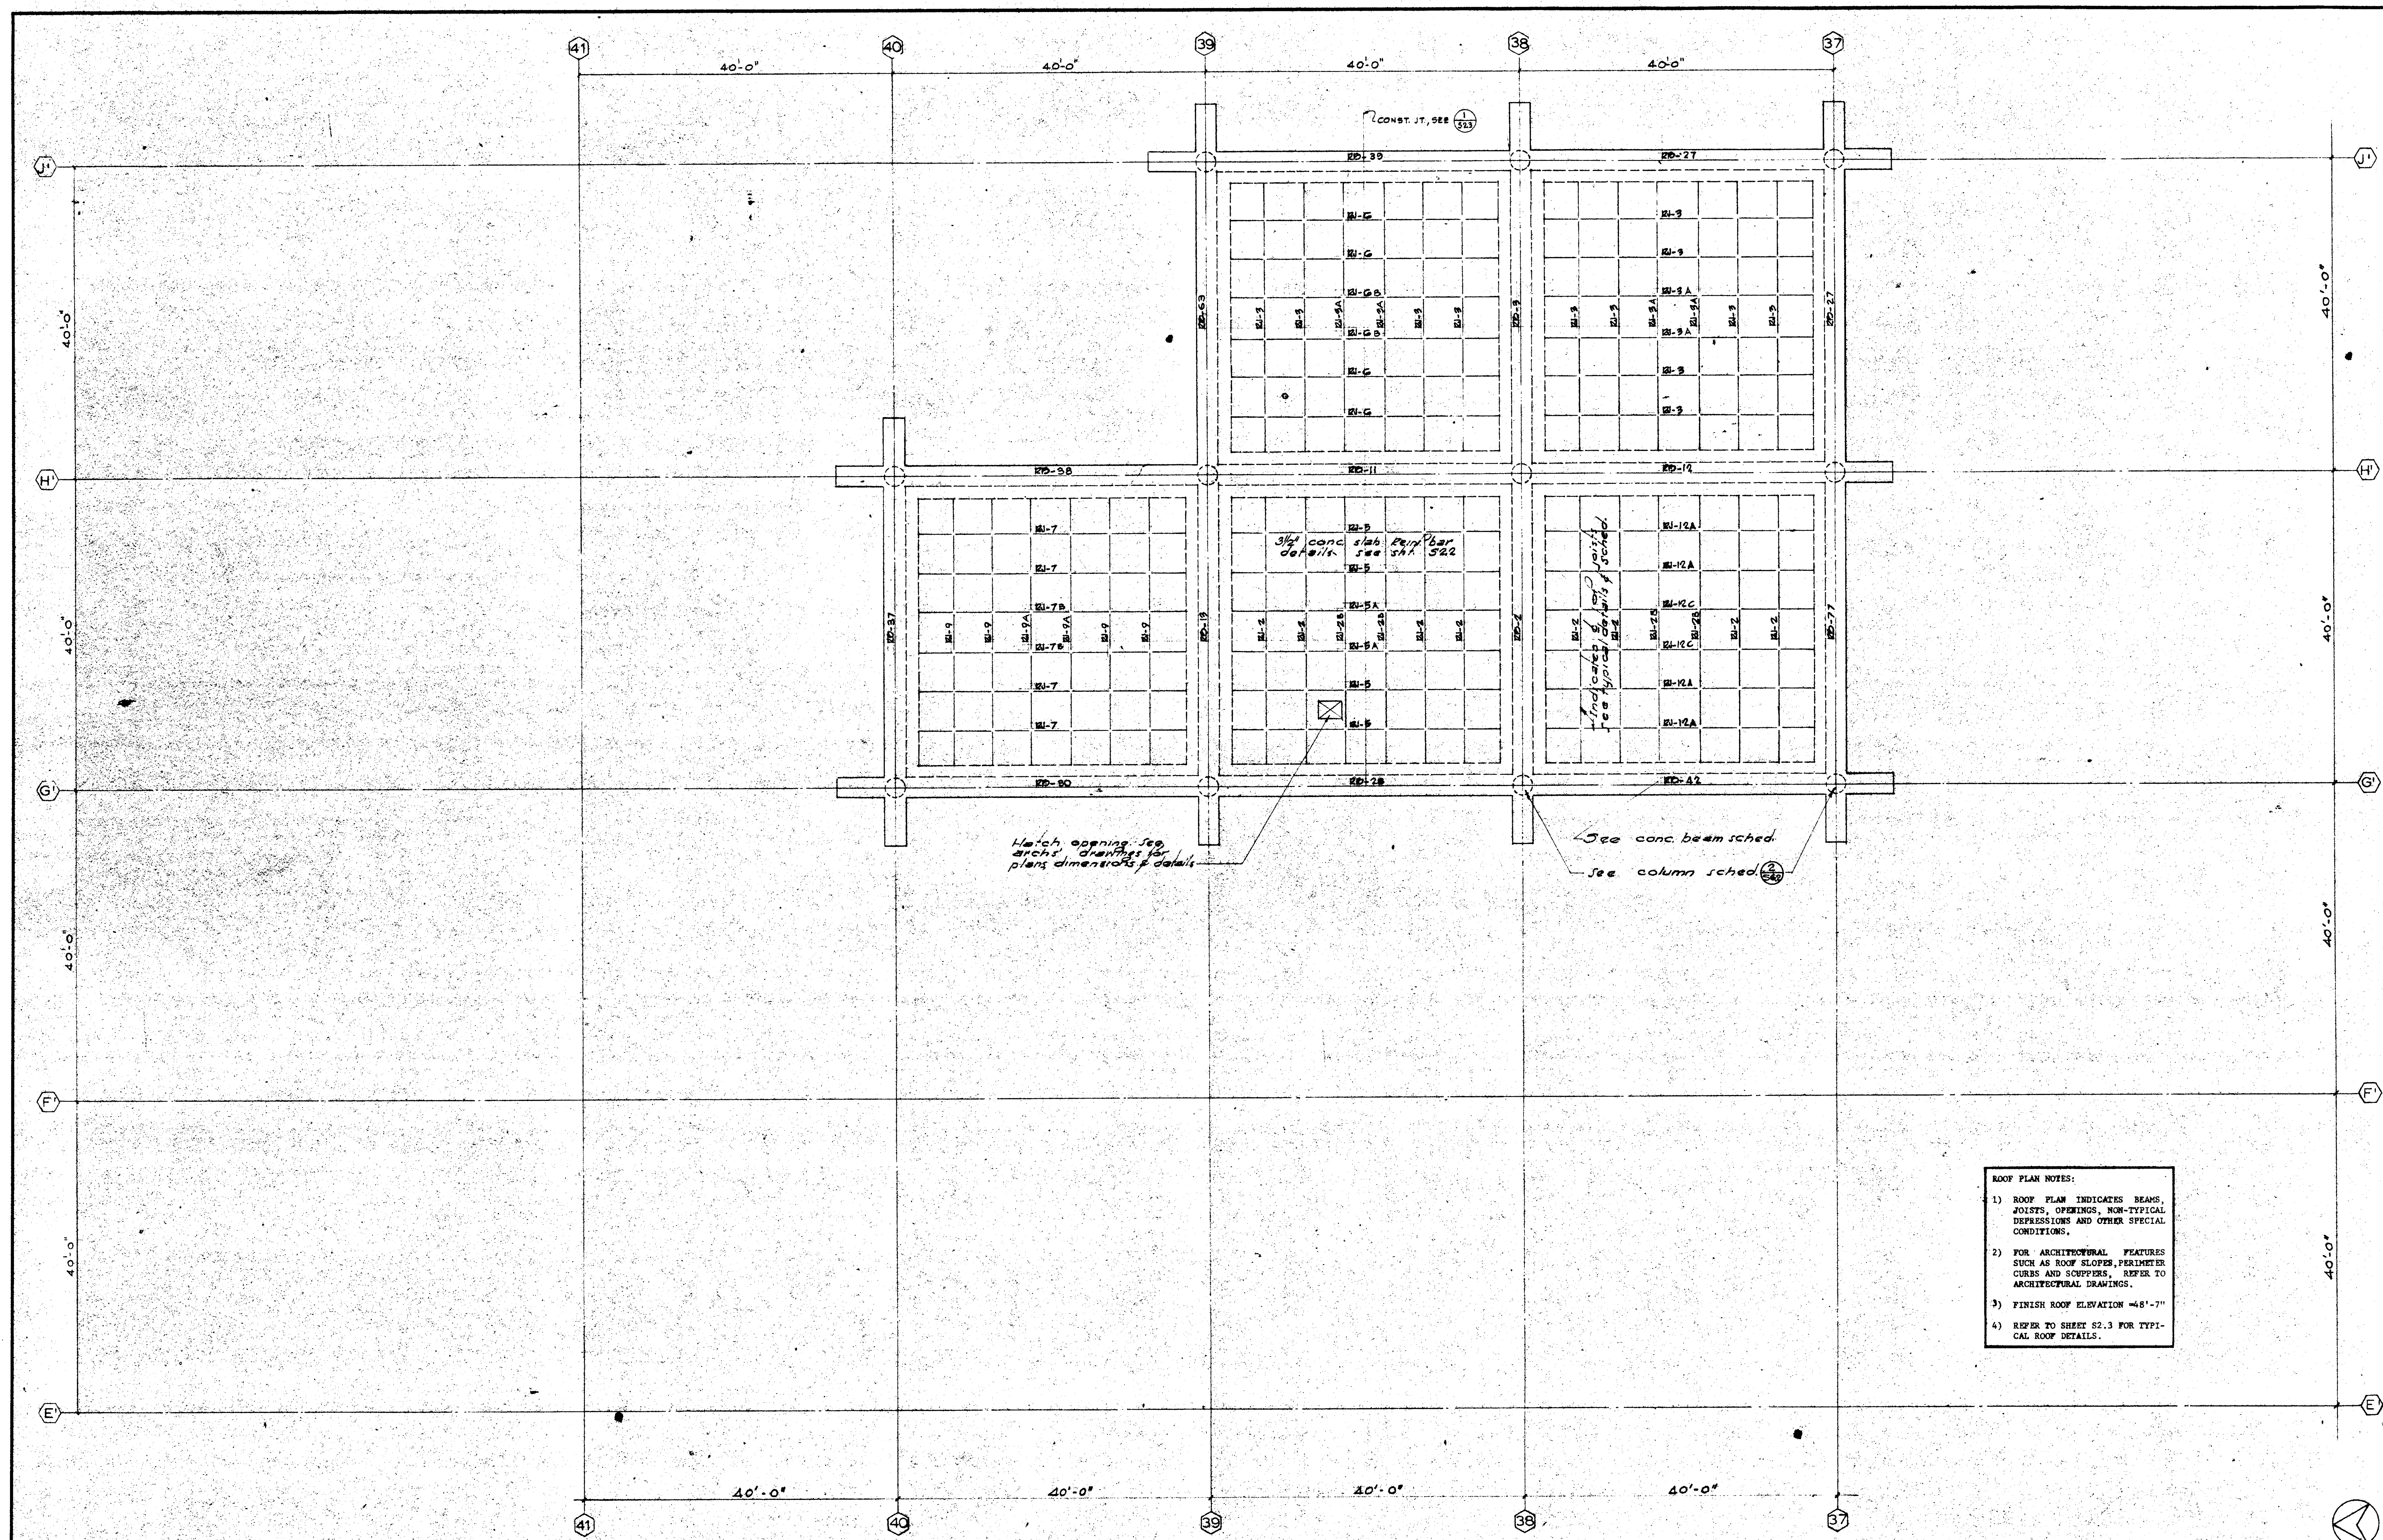


- ROOF PLAN NOTES:
- 1) ROOF PLAN INDICATES BEAMS, JOISTS, OPENINGS, NON-TYPICAL DEPRESSIONS AND OTHER SPECIAL CONDITIONS.
 - 2) FOR ARCHITECTURAL FEATURES SUCH AS ROOF SLOPES, PERIMETER CURBS AND SCUPPERS, REFER TO ARCHITECTURAL DRAWINGS.
 - 3) FINISH ROOF ELEVATION = 6'-7"
 - 4) REFER TO SHEET S2.3 FOR TYPICAL ROOF DETAILS.

STRUCTURAL ENGINEERS BRANDROW & JOHNSTON J.A. MARTIN & ASSOCIATES		DESIGNED GL	ARCHITECT W.L. PEREIRA	APPROVED S.P. 874	ASSOCIATED ARCHITECTS: WILLIAM L. PEREIRA & ASSOCIATES A. QUINCY JONES-FREDERICK E. EMMONS & ASSOCIATES BLUROCK ELLERBROEK & ASSOCIATES		GOLDEN WEST COLLEGE HUNTINGTON BEACH, CALIFORNIA ORANGE COAST JUNIOR COLLEGE DISTRICT		UNIT 8a	SCALE 1/8"	1
MECHANICAL ENGINEERS RALPH E. PHILLIPS, INC.		DRAWN BY TOD	ENGINEER L. J. JOHNSON	APPROVED JUN 21 1965	URBANUS SQUARE • MACARTHUR BOULEVARD AT FORD ROAD TELEPHONE 714/675-2640 • CORONA DEL MAR, CALIFORNIA		UNIT 8a		ROOF	JOB NO. 1004	DATE 10 JUN 1965
ELECTRICAL ENGINEERS RALPH E. PHILLIPS, INC.		CHECKED BY GL	COLLEGE	APPROVED STATE FIRE MARSHAL STATE OF CALIFORNIA JUN 21 1965			PLAN			SHEET NO. S 1.23	
CIVIL ENGINEERS O. SHURMAN & ASSOCIATES MOFFATT & NICHOL											

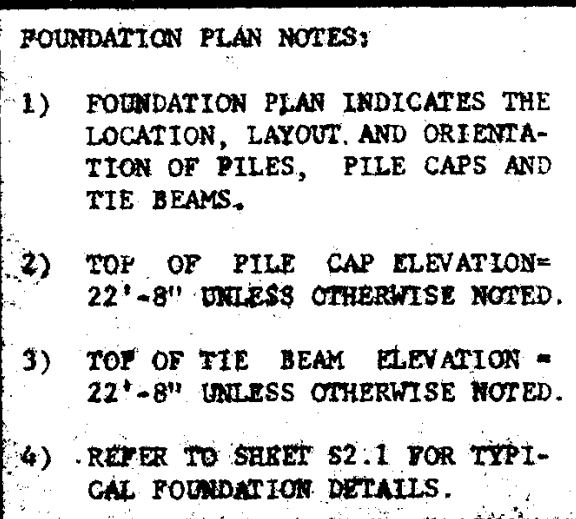


<div>1 2 3 4 276 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2221 2222 2223 2224 2225 2226 2227 2228 2229 2230 2231 2232 2233 2234 2235 2236 2237 2238 2239 2240 2241 2242 2243 2244 2245 2246 2247</div>
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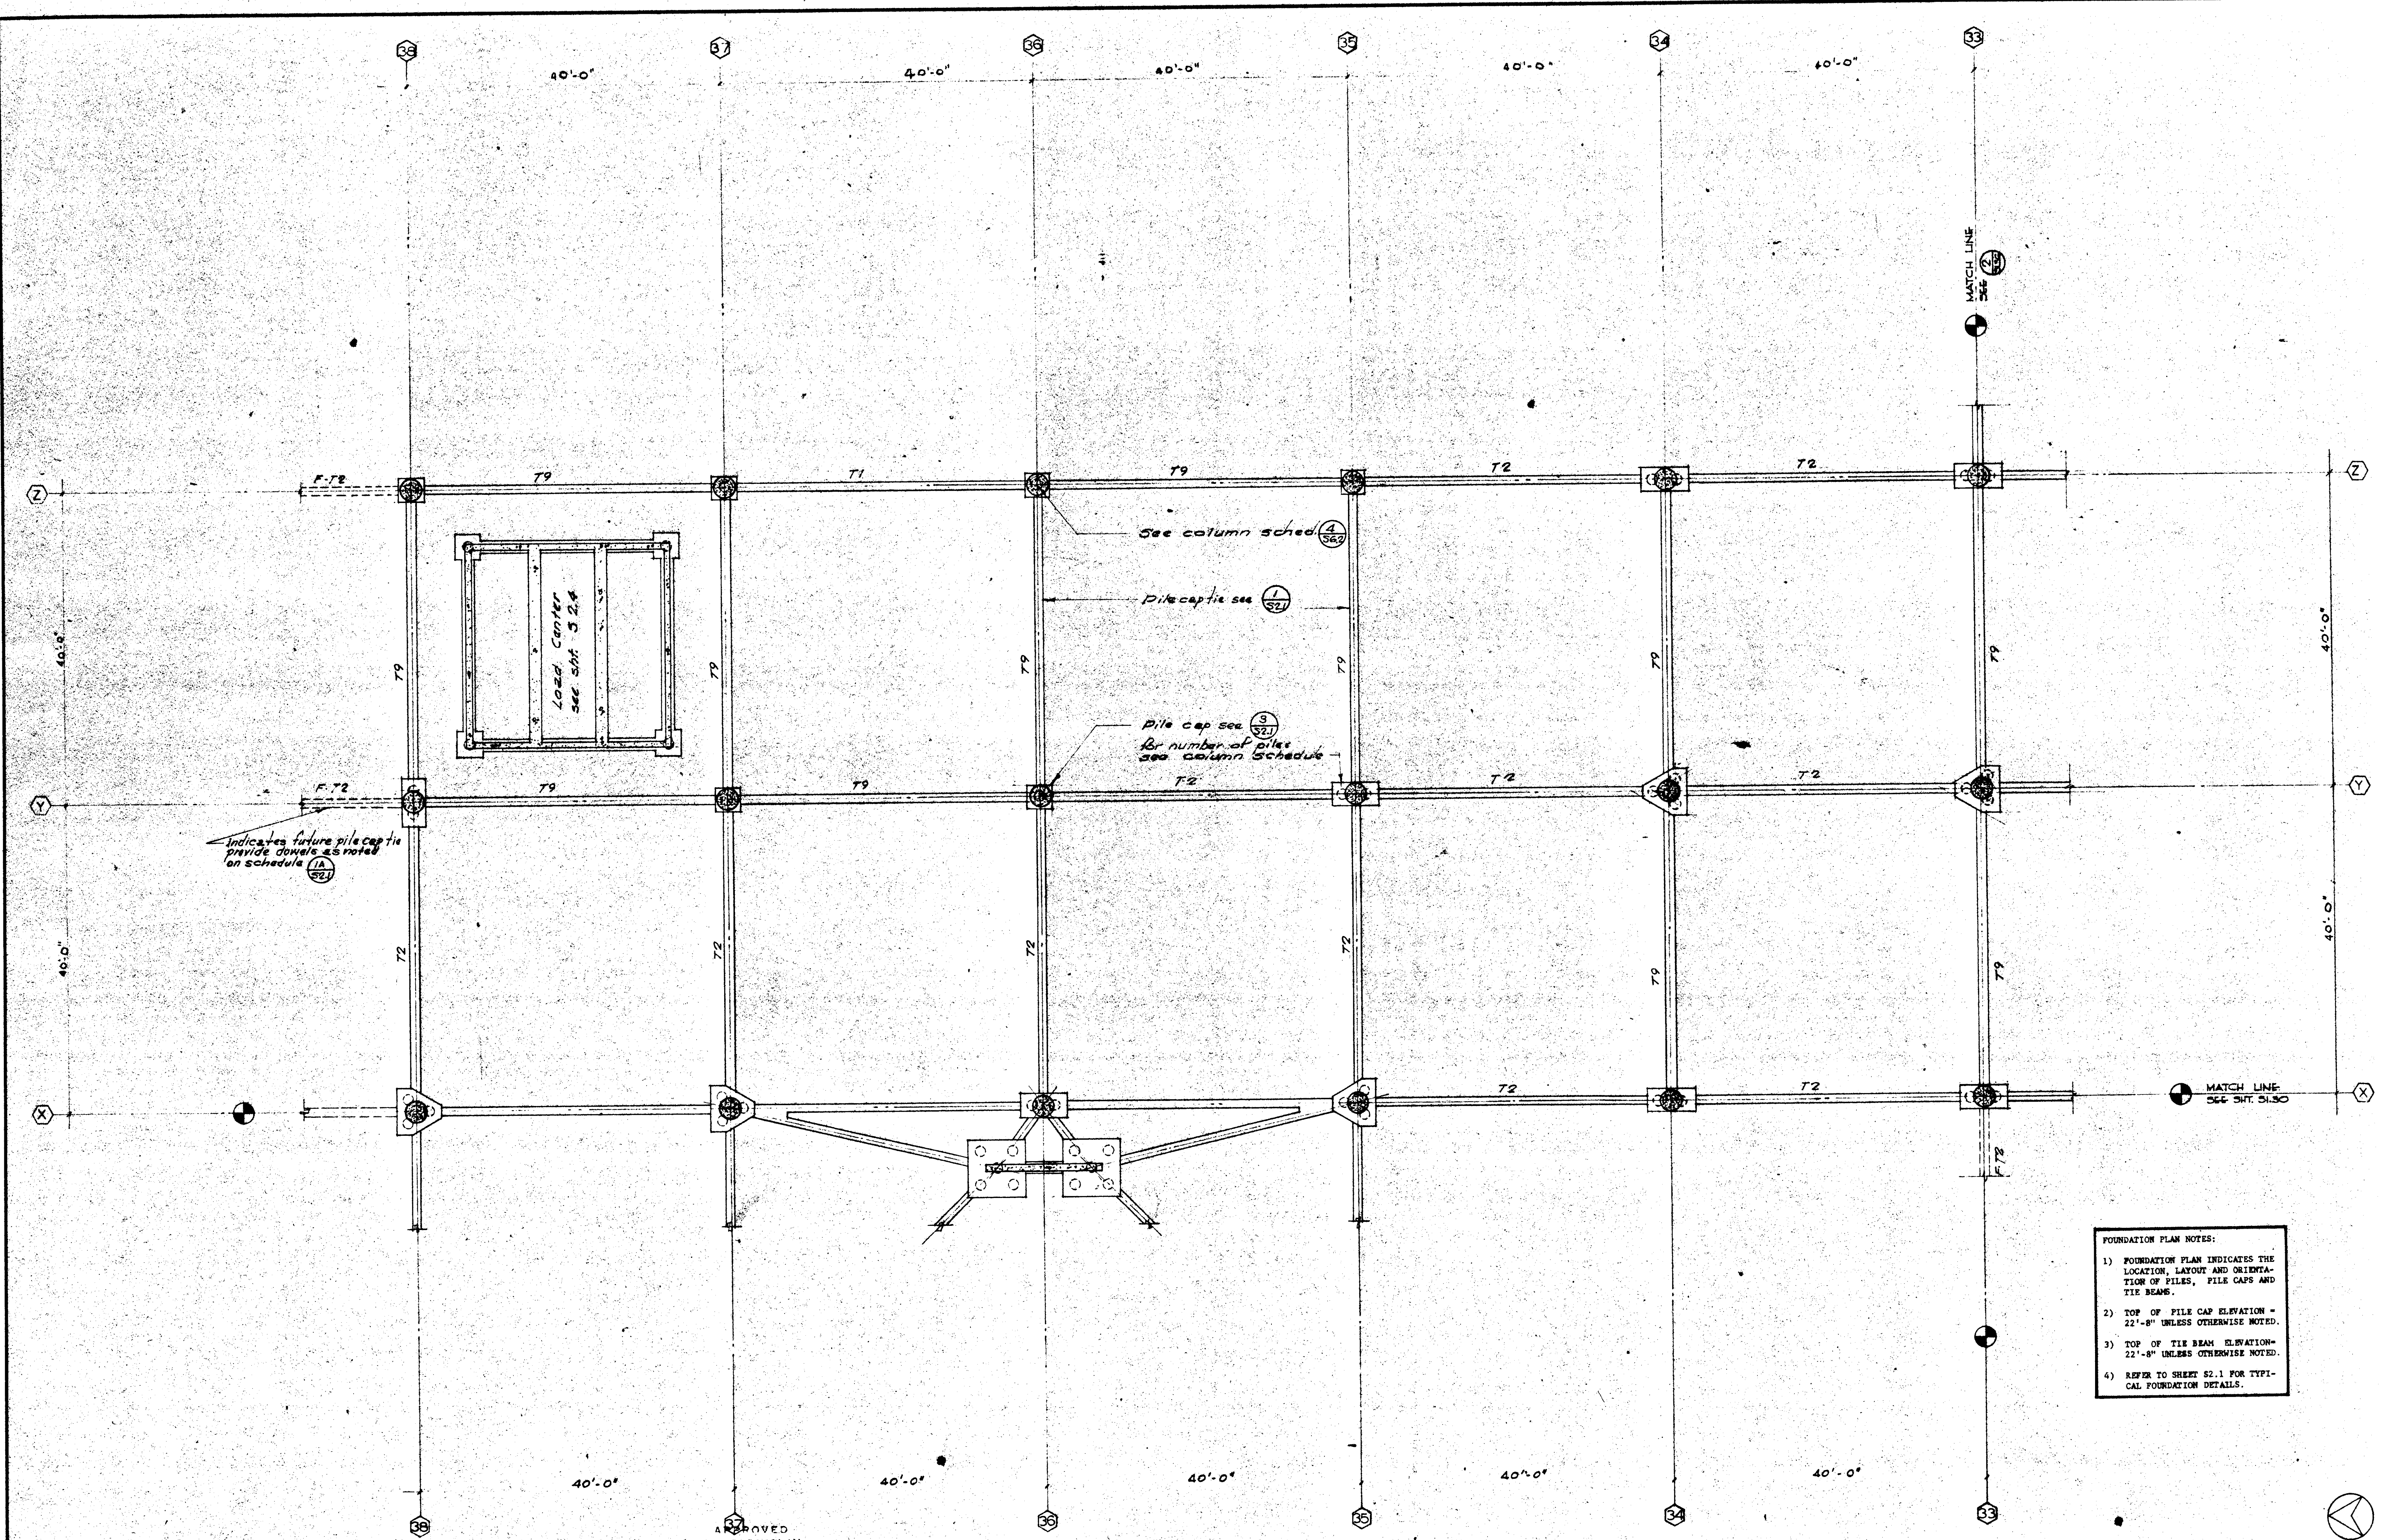
- FIRST FLOOR PLAN NOTES:**
- 1) FIRST FLOOR PLAN INDICATES COMPLETE COLUMN LOCATIONS, EXTENT OF SLABS-ON-GRADE, PERIMETER CURBS, NON-TYPICAL DEPRESSIONS AND OTHER SPECIAL CONDITIONS.
 - 2) FOR ARCHITECTURAL FEATURES SUCH AS FLOOR SLOPES, TYPICAL DEPRESSIONS AND OTHER TYPICAL CONDITIONS, REFER TO ARCHITECTURAL DRAWINGS.
 - 3) FINISH FIRST FLOOR ELEVATION = 24'-0\"/>

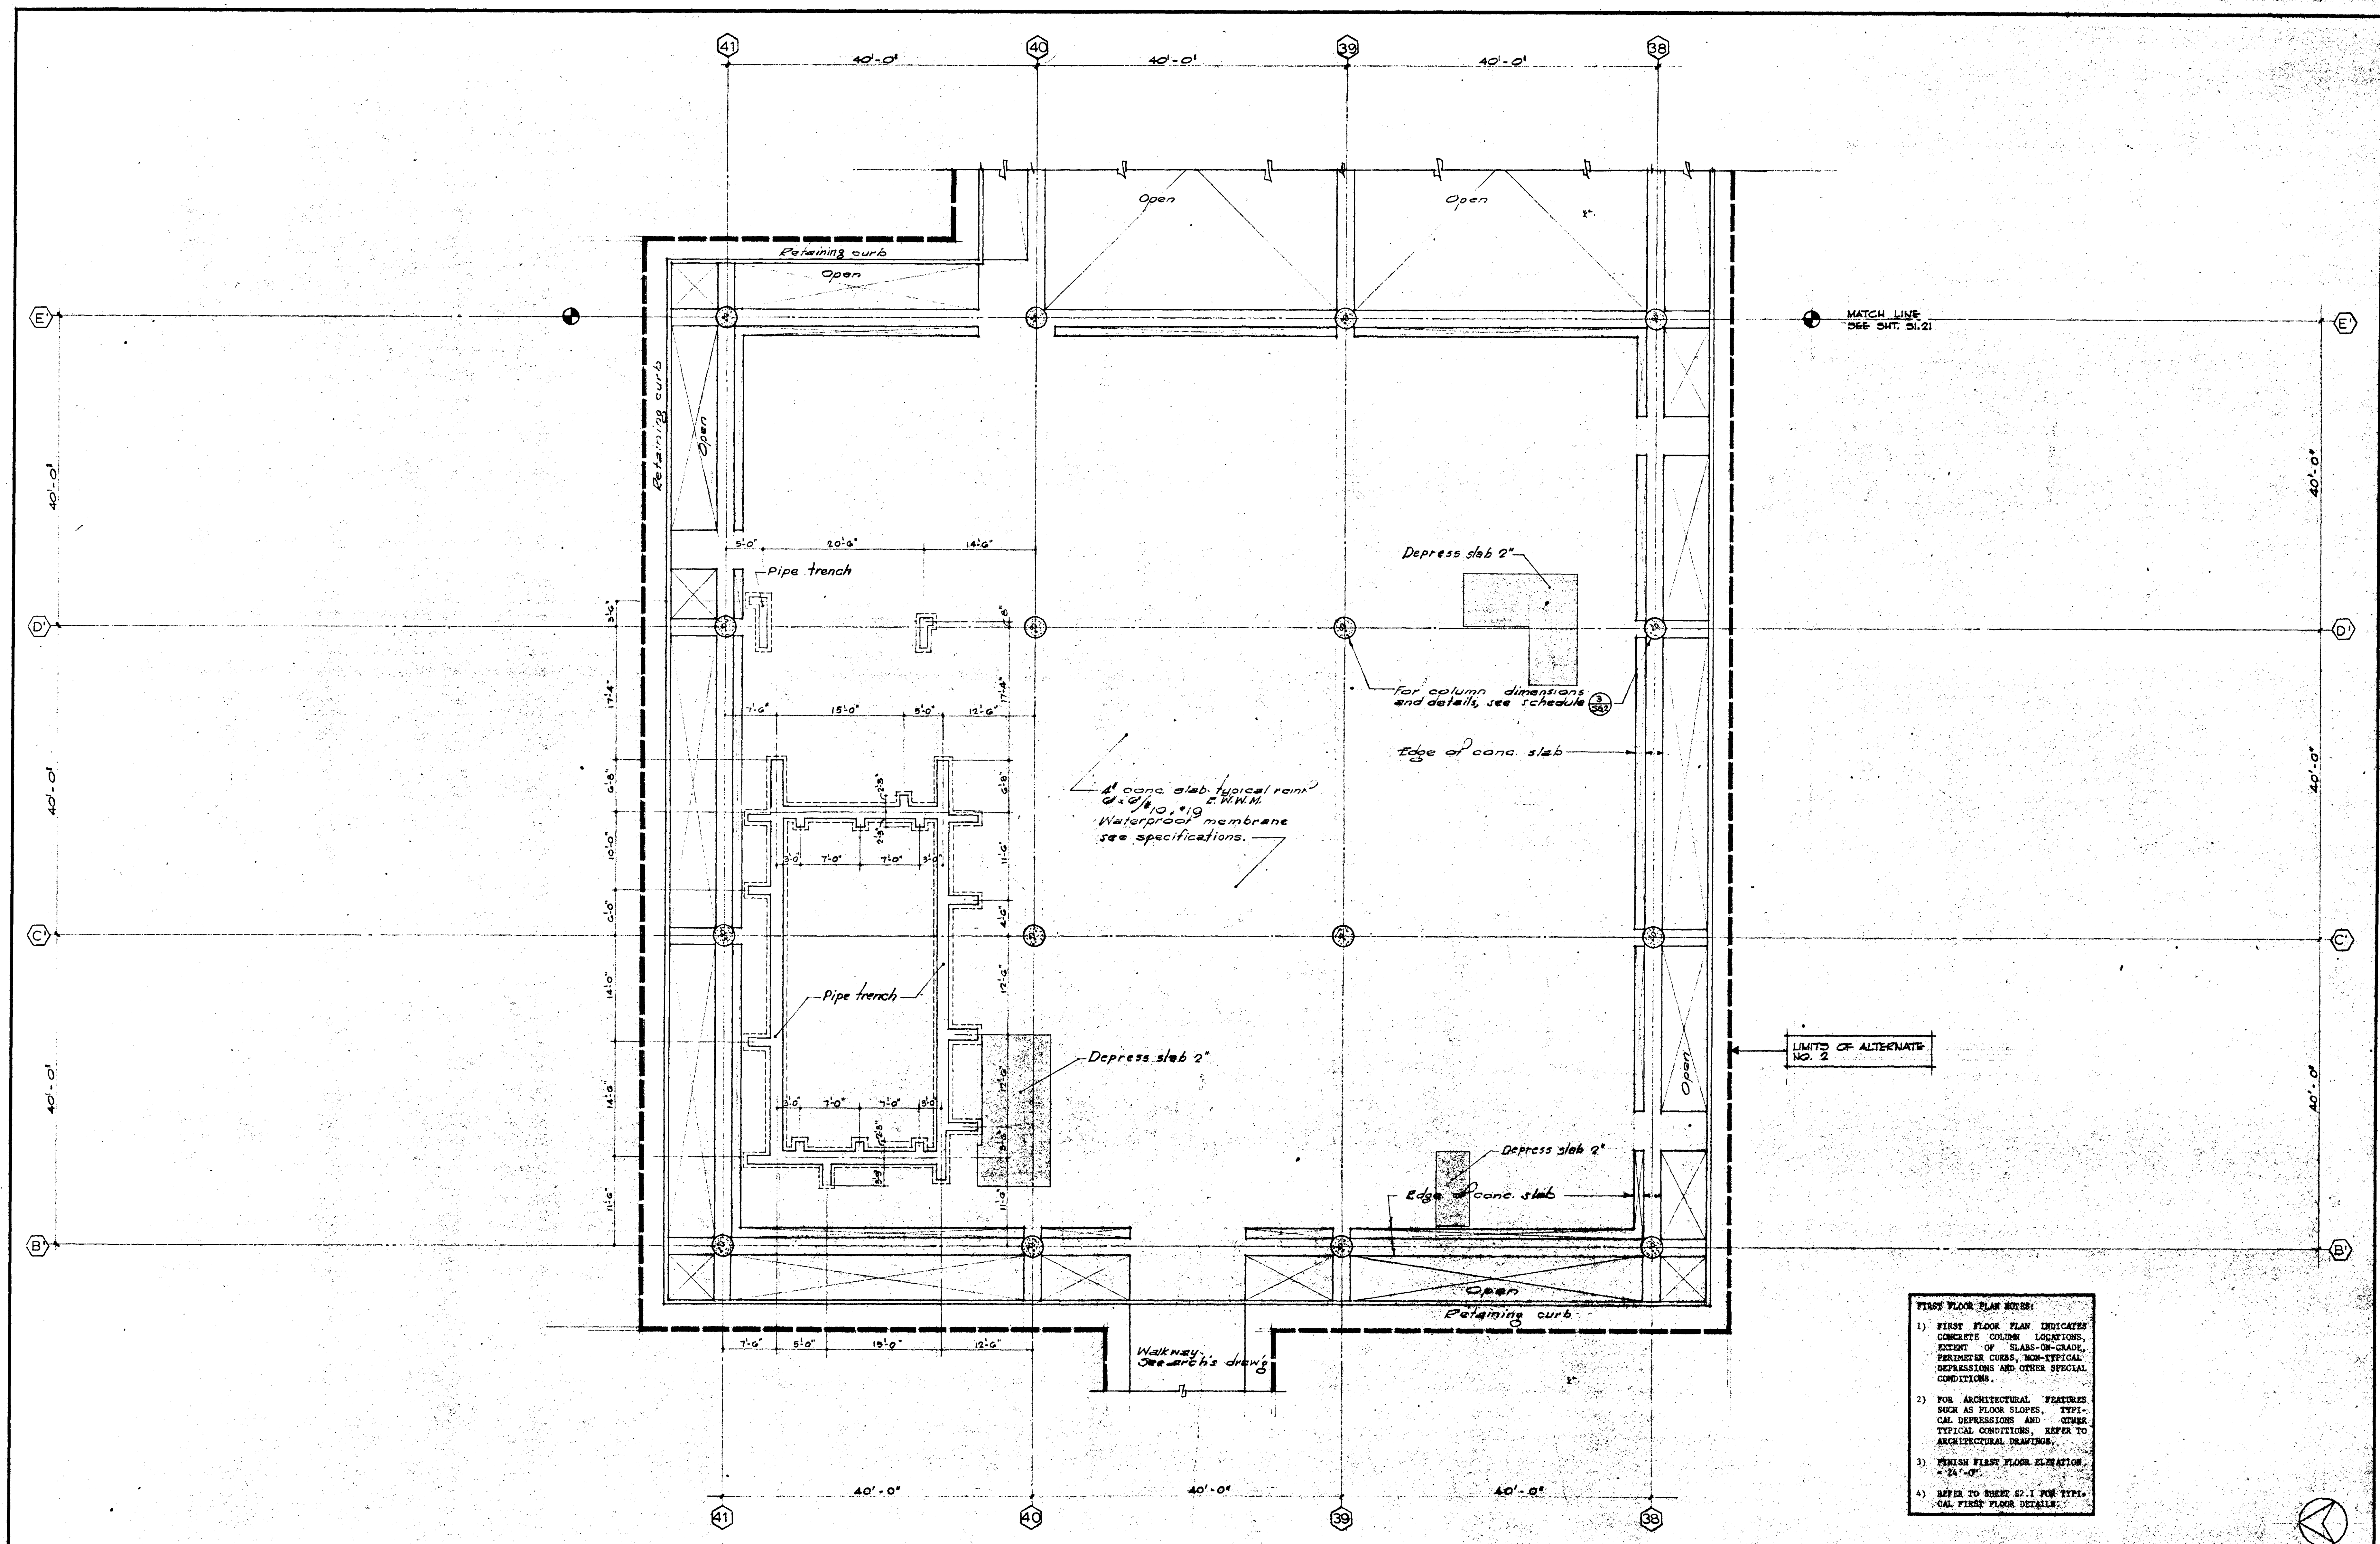STRUCTURAL ENGINEERS BRANDOW & JOHNSTON J. A. MARTIN & ASSOCIATES MECHANICAL ENGINEERS RALPH E. PHILLIPS, INC. ELECTRICAL ENGINEERS RALPH E. PHILLIPS, INC. CIVIL ENGINEERS G. SHURMAN & ASSOCIATES MOFFATT & NICHOL				DESIGNED A.C.N. DRAWN BY T.O.B. CHECKED BY YP		ARCHITECT WILLIAM L. PEREIRA & ASSOCIATES A. QUINCY JONES-FREDERICK E. EMMONS & ASSOCIATES BLUROCK ELLERBROEK & ASSOCIATES URBANUS SQUARE • MACARTHUR BOULEVARD AT FORD ROAD TELEPHONE 714/675-2640 • CORONA DEL MAR, CALIFORNIA		GOLDEN WEST COLLEGE HUNTINGTON BEACH, CALIFORNIA ORANGE COAST JUNIOR COLLEGE DISTRICT		UNIT 8b FIRST FLOOR PLAN		SCALE 1/8" = 1'-0"
DATE DRAWN REVISIONS				APPROVED STATE OF CALIFORNIA JUNE 21 1965		APPROVED JUNE 21 1965		UNIT 8b FIRST FLOOR PLAN		JOB NO. 10041 DATE 16 JUN 1965 SHEET NO. S 1.25		




- ROOF PLAN NOTES:**
- 1) ROOF PLAN INDICATES BEAMS, JOINTS, OPENINGS, NON-TYPICAL DEPRESSIONS AND OTHER SPECIAL CONDITIONS.
 - 2) FOR ARCHITECTURAL FEATURES SUCH AS ROOF SLOPES, PERIMETER CURBS AND SCUFFERS, REFER TO ARCHITECTURAL DRAWINGS.
 - 3) FINISH ROOF ELEVATION = 36'-3 1/2"
 - 4) REFER TO SHEET S2.3 FOR TYPICAL ROOF DETAILS.

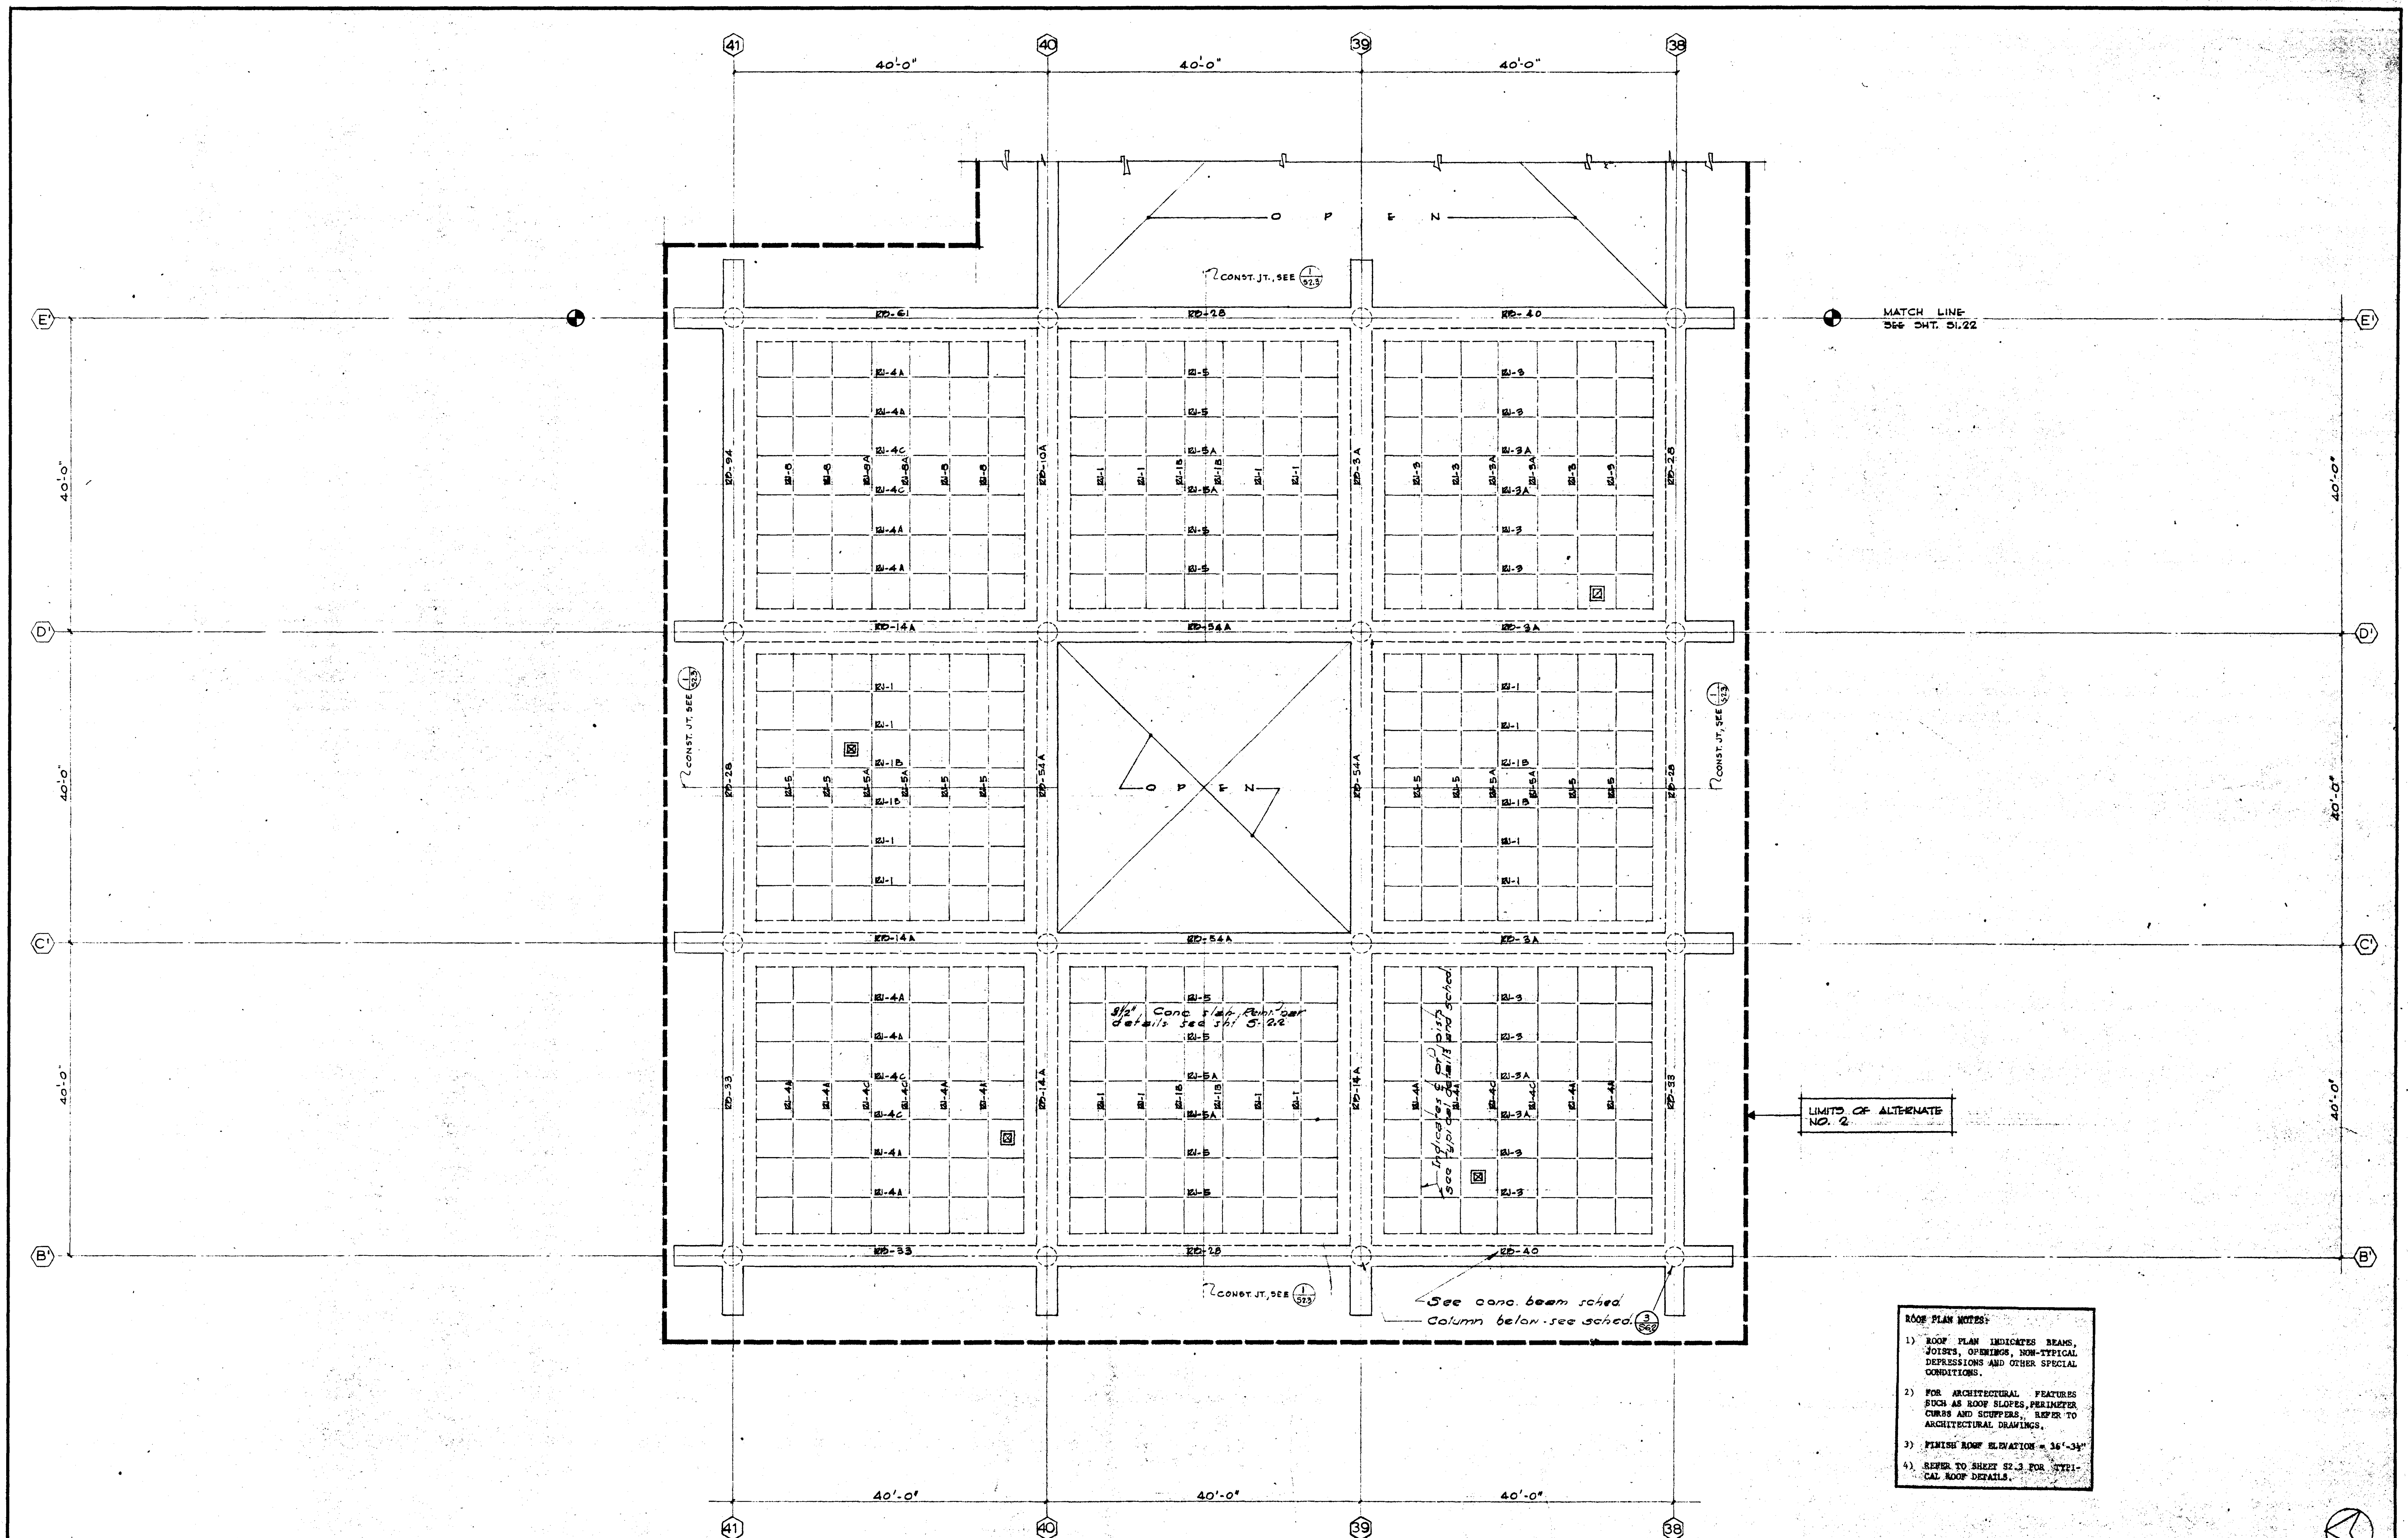STRUCTURAL ENGINEERS BRANDOW & JOHNSTON J.A. MARTIN & ASSOCIATES MECHANICAL ENGINEERS RALPH E. PHILLIPS, INC. ELECTRICAL ENGINEERS RALPH E. PHILLIPS, INC. CIVIL ENGINEERS G. SHURMAN & ASSOCIATES MOFFATT & NICHOL		DESIGNED GU DRAWN BY T.O.B. CHECKED BY GU	ARCHITECT WILLIAM L. PEREIRA ENGINEER A. QUINCY JONES-FREDERICK E. EMMONS & ASSOCIATES COLLEGE	APPROVED APPROVED JUN 21 1965 APPROVED JUN 21 1965	ASSOCIATED ARCHITECTS: WILLIAM L. PEREIRA & ASSOCIATES A. QUINCY JONES-FREDERICK E. EMMONS & ASSOCIATES BLUROCK ELLERBROEK & ASSOCIATES URBANUS SQUARE • MACARTHUR BOULEVARD AT FORD ROAD TELEPHONE 714/675-2640 • CORONA DEL MAR, CALIFORNIA	GOLDEN WEST COLLEGE HUNTINGTON BEACH, CALIFORNIA ORANGE COAST JUNIOR COLLEGE DISTRICT	UNIT 8b ROOF UNIT 8b ROOF PLAN	SCALE 1/8" = 1'-0" JOB NO. 1041 DATE 16 JUN 1965 SHEET NO. S 1.2 C
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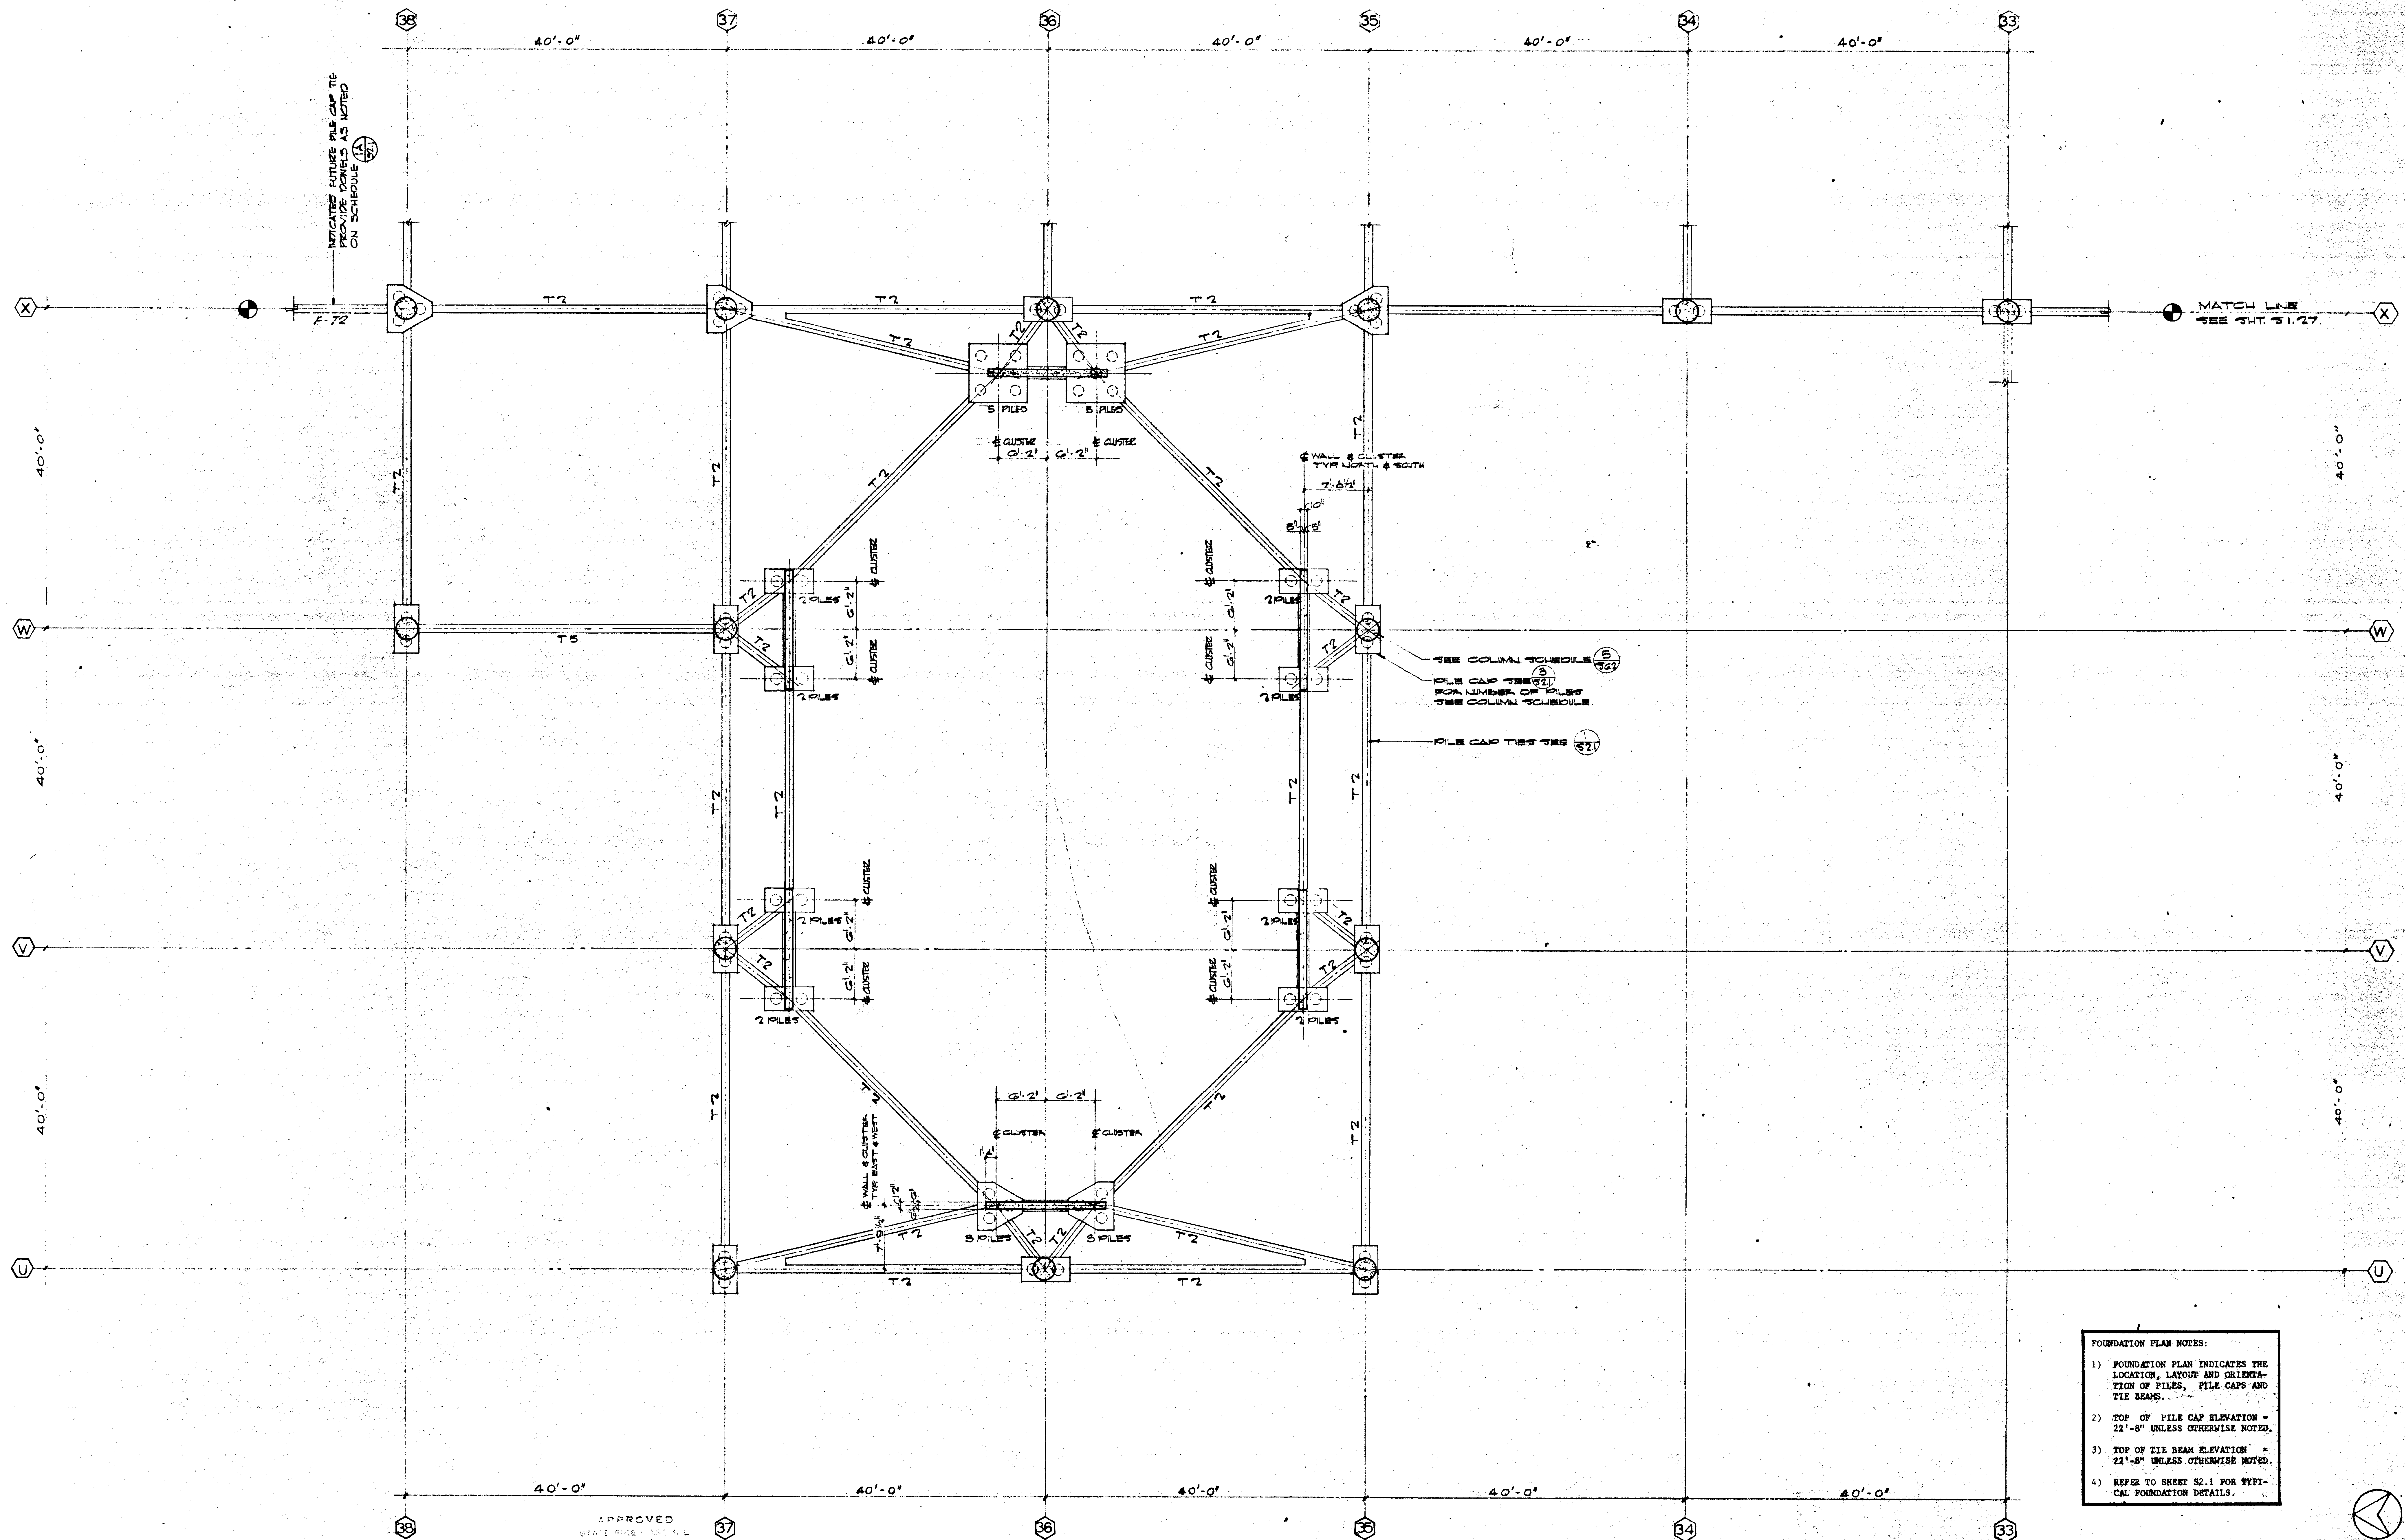
- FOUNDATION PLAN NOTES:
- 1) FOUNDATION PLAN INDICATES THE LOCATION, LAYOUT AND ORIENTATION OF PILES, PILE CAPS AND TIE BEAMS.
 - 2) TOP OF PILE CAP ELEVATION - 22'-8" UNLESS OTHERWISE NOTED.
 - 3) TOP OF TIE BEAM ELEVATION - 22'-8" UNLESS OTHERWISE NOTED.
 - 4) REFER TO SHEET S2.1 FOR TYPICAL FOUNDATION DETAILS.

STRUCTURAL ENGINEERS BRANDOW & JOHNSON 11111 1/2 STREET HUNTINGTON BEACH, CALIFORNIA 92648 TELEPHONE 714/675-2640		DESIGNED A.C.N. DRAWN BY C.B. CHECKED BY L.P.	ARCHITECT WILLIAM L. PEREIRA & ASSOCIATES 11111 1/2 STREET HUNTINGTON BEACH, CALIFORNIA 92648 TELEPHONE 714/675-2640	ASSOCIATED ARCHITECTS: WILLIAM L. PEREIRA & ASSOCIATES A. QUINCY JONES-FREDERICK E. HEMMONS & ASSOCIATES BLUROCK MILLERBROOK & ASSOCIATES URBANUS SQUARE • MACARTHUR BOULEVARD AT FORD ROAD TELEPHONE 714/675-2640 • CORONA DEL MAR, CALIFORNIA	GOLDEN WEST COLLEGE HUNTINGTON BEACH, CALIFORNIA ORANGE COAST JUNIOR COLLEGE DISTRICT	FOUNDATION UNIT 1 FOUNDATION PLAN	SCALE 1/2" = 1'-0" JOB NO. 104 DATE 6 MAY 1965 SHEET NO. S 1.27
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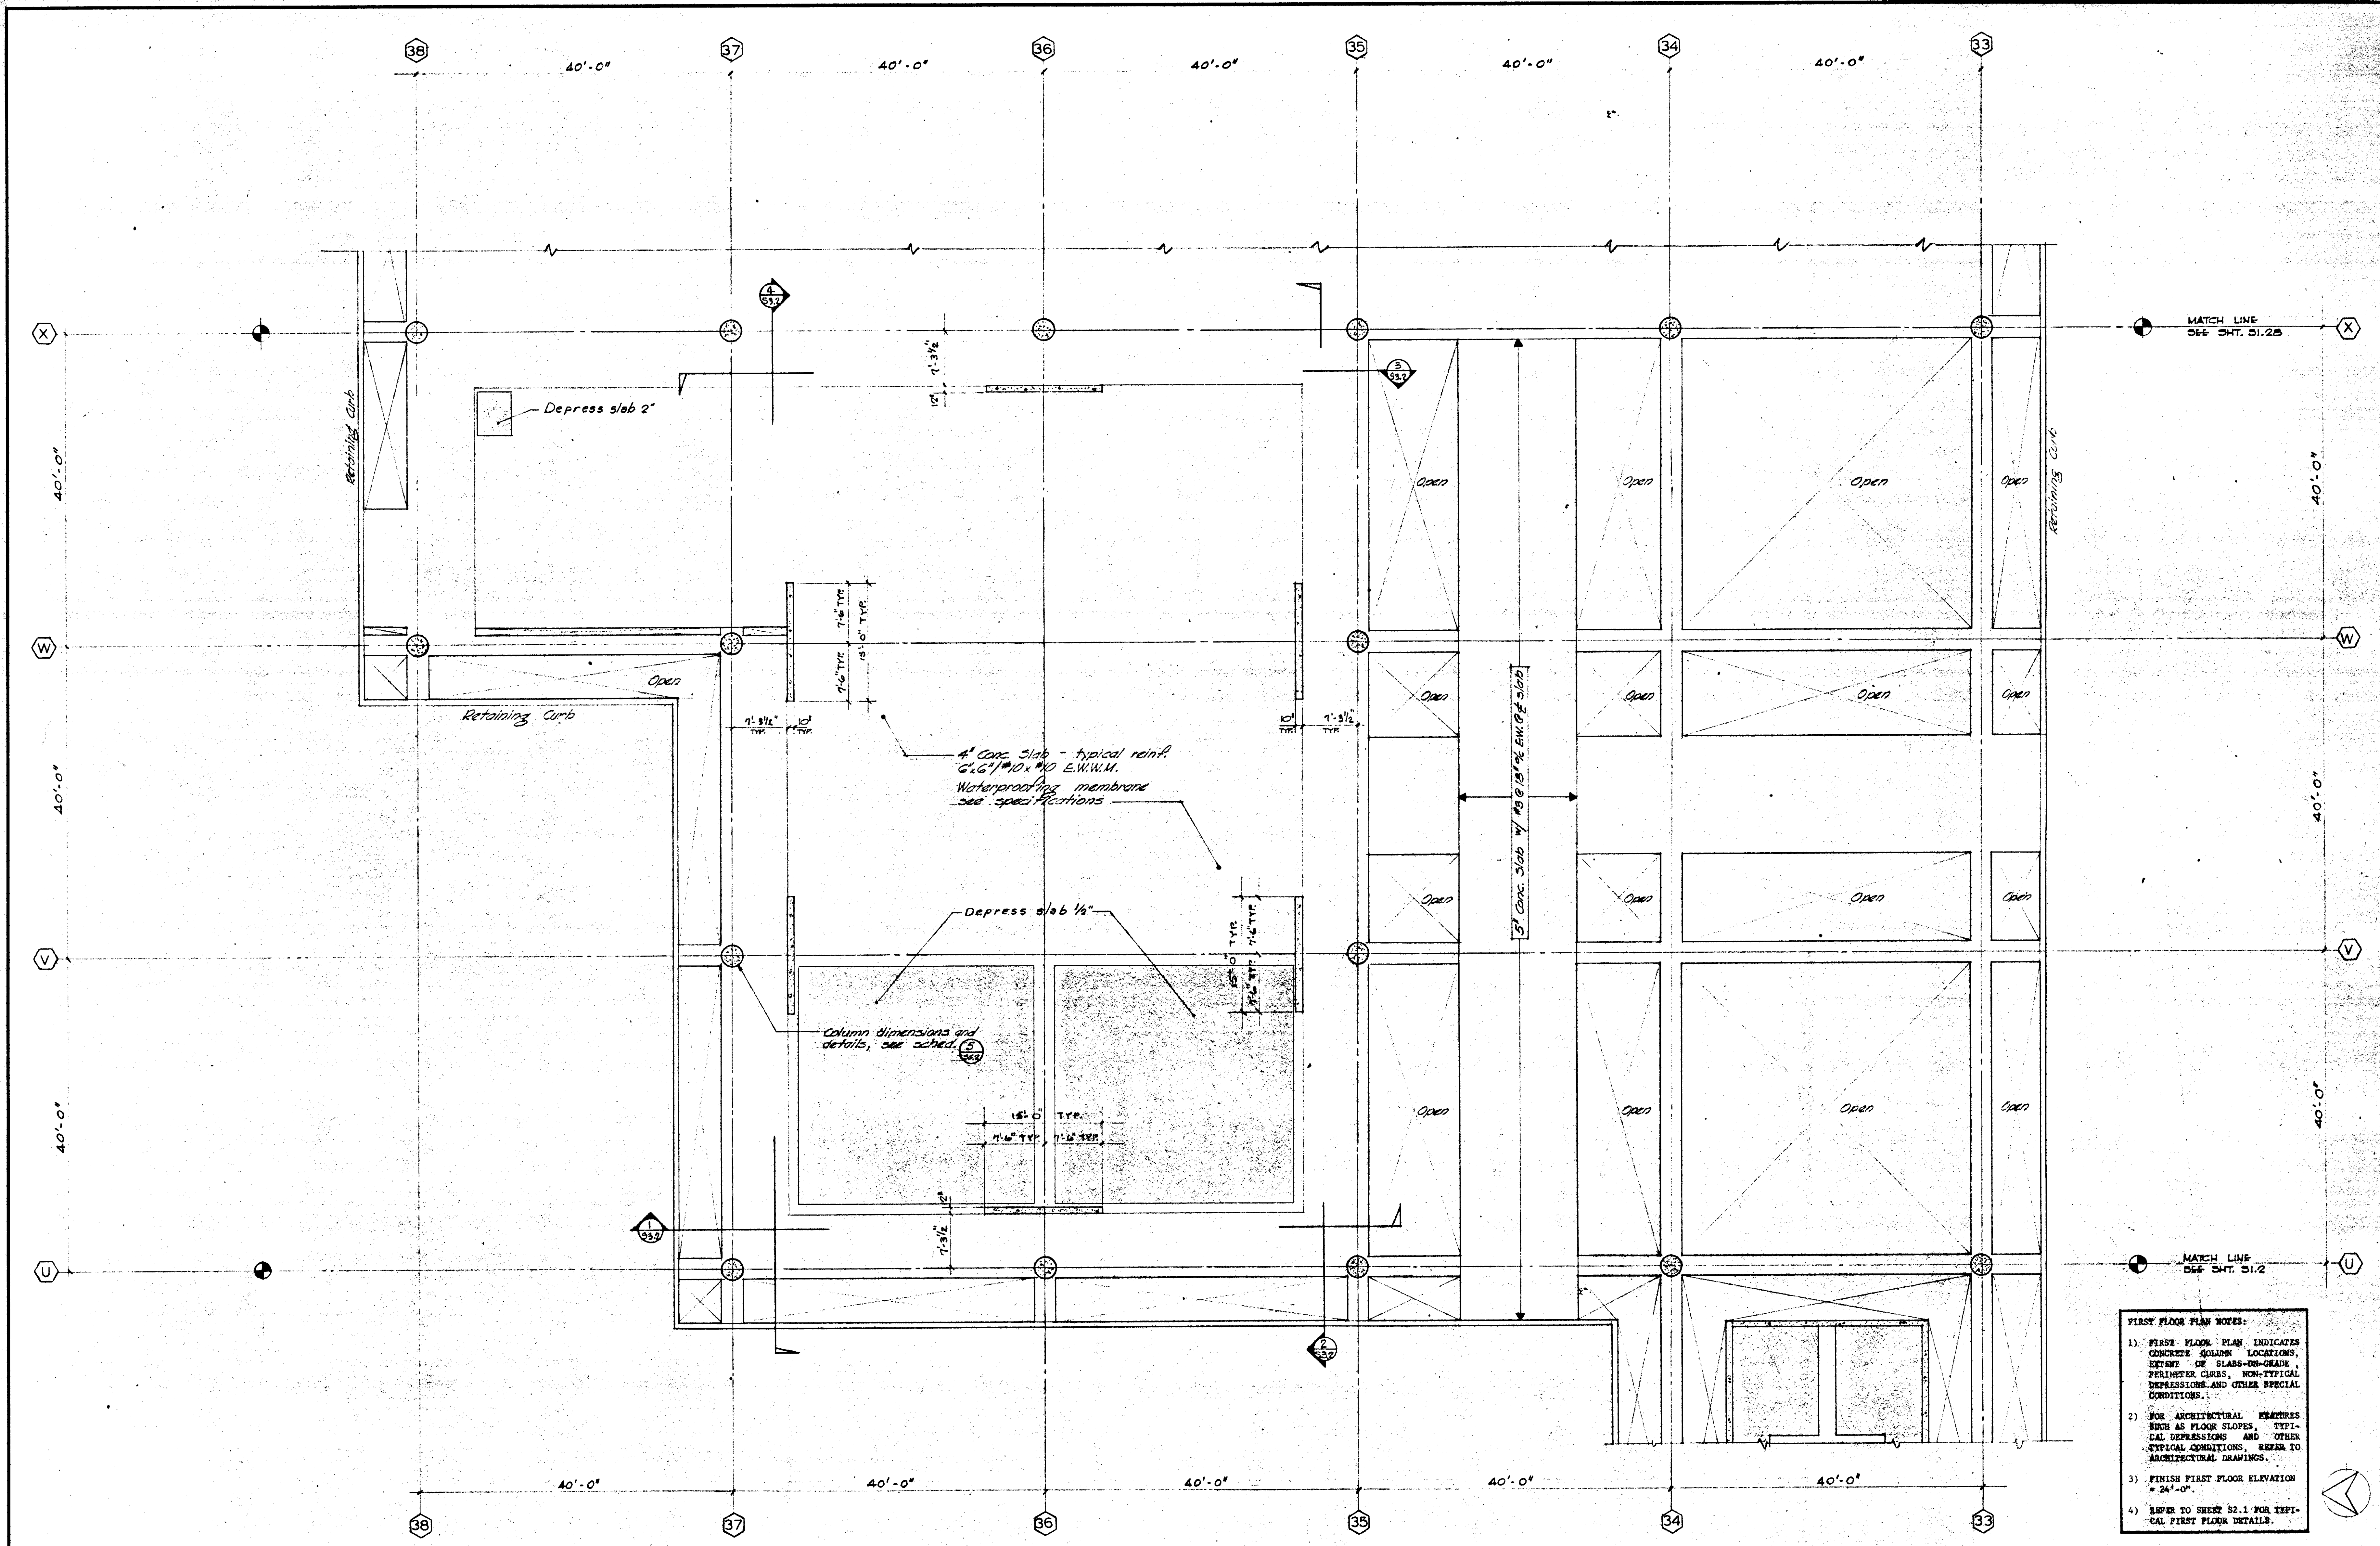
- FIRST FLOOR PLAN NOTES:
- 1) FIRST FLOOR PLAN INDICATES CONCRETE COLUMN LOCATIONS, EXTENT OF SLABS-ON-GRADE, PERIMETER CURBS, NON-TYPICAL DEPRESSIONS AND OTHER SPECIAL CONDITIONS.
 - 2) FOR ARCHITECTURAL FEATURES SUCH AS FLOOR SLOPES, TYPICAL DEPRESSIONS AND OTHER TYPICAL CONDITIONS, REFER TO ARCHITECTURAL DRAWINGS.
 - 3) FINISH FIRST FLOOR ELEVATION = 24'-0".
 - 4) REFER TO SHEET S2.1 FOR TYPICAL FIRST FLOOR DETAILS.

STRUCTURAL ENGINEERS BRANDOW & JOHNSON 1500 N. GARDEN ST. ANAHEIM, CALIF. 92805 (714) 771-1111				DESIGNED ACN JUN 21 1965		ARCHITECT WILLIAM L. PEREIRA & ASSOCIATES 1000 N. GARDEN ST. ANAHEIM, CALIF. 92805 (714) 771-1111		APPROVED STATE OF CALIFORNIA DATE JUN 21 1965 BY [Signature]		ASSOCIATED ARCHITECTS: WILLIAM L. PEREIRA & ASSOCIATES A. QUINCY JONES-FREDERICK E. EMMONS & ASSOCIATES BLUROCK ELLERBROCK & ASSOCIATES URBANUS SQUARE • MACARTHUR BOULEVARD AT FORD ROAD TELEPHONE 714/675-2640 • CORONA DEL MAR, CALIFORNIA		GOLDEN WEST COLLEGE HUNTINGTON BEACH, CALIFORNIA ORANGE COAST JUNIOR COLLEGE DISTRICT		UNIT - 100 ft FIRST FLOOR PLAN SCALE 1/8" = 1'-0"	
MECHANICAL ENGINEERS RALPH E. PHILLIPS, INC. 1000 N. GARDEN ST. ANAHEIM, CALIF. 92805 (714) 771-1111				DRAWN BY 1.02 JUN 21 1965		ENGINEER RALPH E. PHILLIPS, INC. 1000 N. GARDEN ST. ANAHEIM, CALIF. 92805 (714) 771-1111		CHECKED BY LP JUN 21 1965		APPROVED STATE OF CALIFORNIA DATE JUN 21 1965 BY [Signature]		DATE JUN 21 1965		REVISIONS	

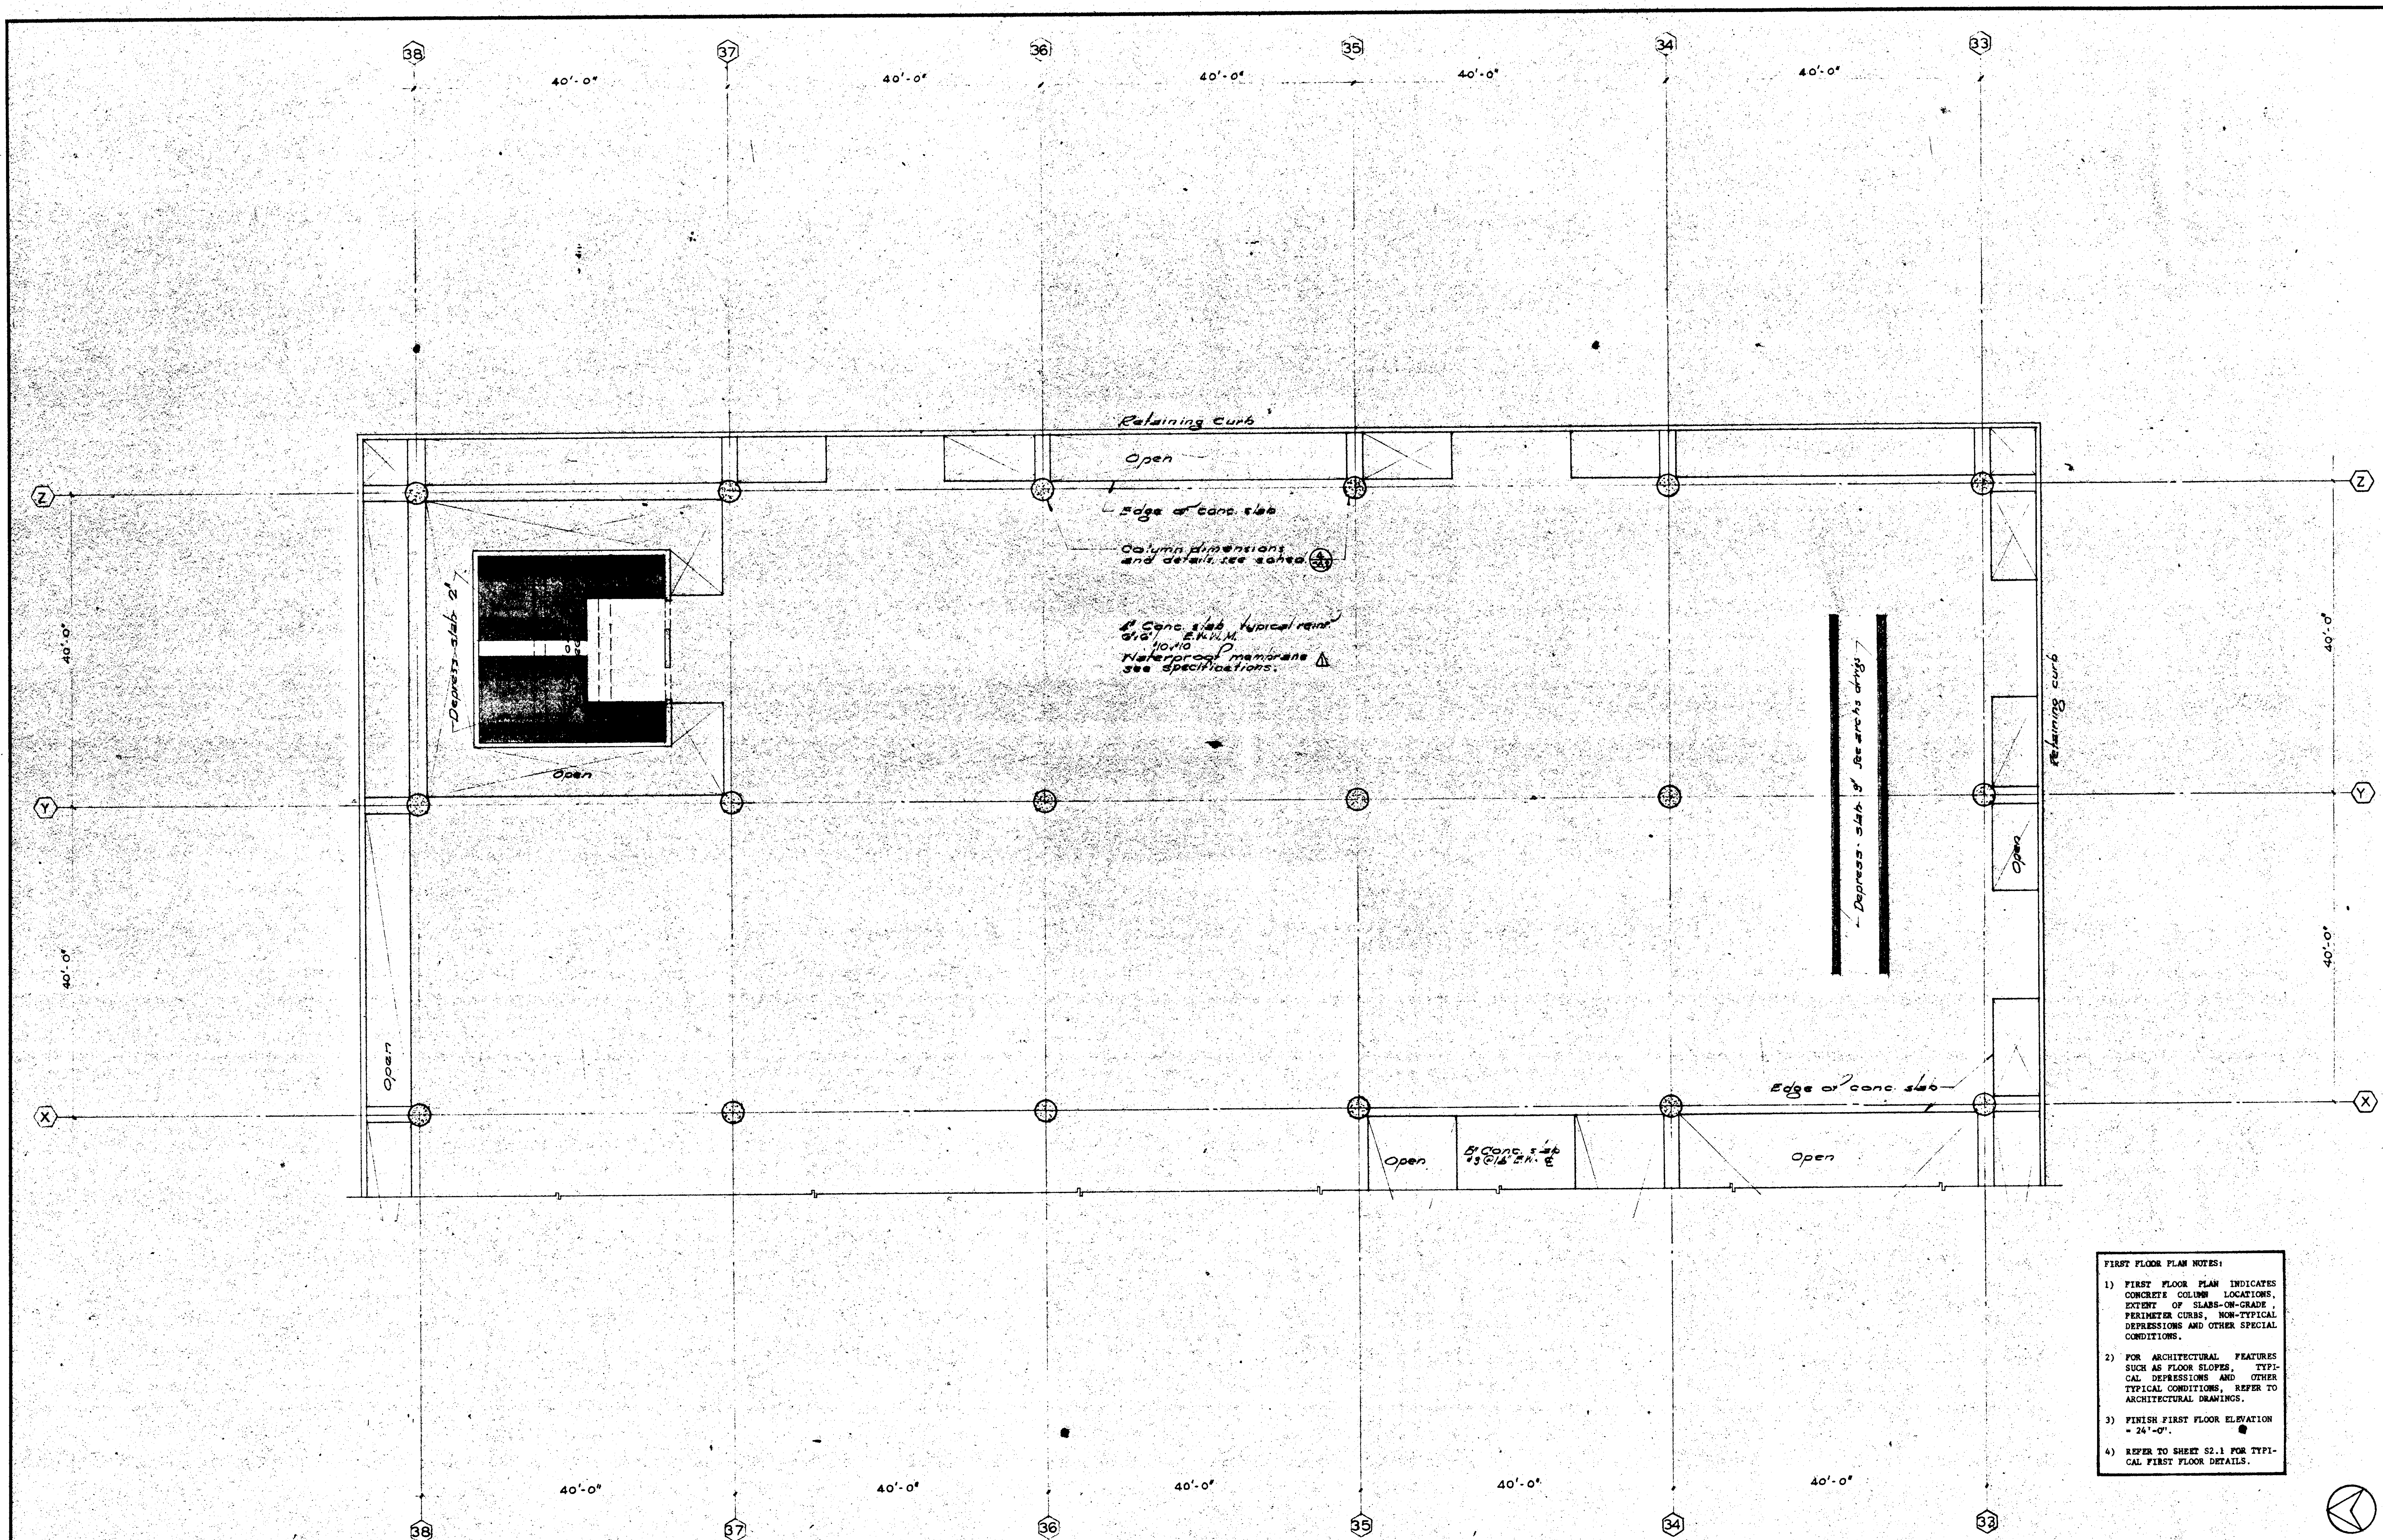


- FOUNDATION PLAN NOTES:
- 1) FOUNDATION PLAN INDICATES THE LOCATION, LAYOUT AND ORIENTATION OF PILES, PILE CAPS AND TIE BEAMS.
 - 2) TOP OF PILE CAP ELEVATION = 22'-8" UNLESS OTHERWISE NOTED.
 - 3) TOP OF TIE BEAM ELEVATION = 22'-8" UNLESS OTHERWISE NOTED.
 - 4) REFER TO SHEET S2.1 FOR TYPICAL FOUNDATION DETAILS.

FOUNDATION										SCALE	1
UNIT 10										JOB NO.	104
FOUNDATION										DATE	6 MAY 1965
PLAN										SHEET NO.	S 1.30




- FIRST FLOOR NOTES:**
1. FIRST FLOOR PLAN INDICATES CONCRETE COLUMN LOCATIONS, EXTENT OF SLABS-ON-GRADE, PERIMETER CURBS, NON-TYPICAL DEPRESSIONS AND OTHER SPECIAL CONDITIONS.
 2. FOR ARCHITECTURAL FEATURES SUCH AS FLOOR SLOPES, TYPICAL DEPRESSIONS AND OTHER TYPICAL CONDITIONS, REFER TO ARCHITECTURAL DRAWINGS.
 3. FINISH FIRST FLOOR ELEVATION = 24'-0".
 4. REFER TO SHEET 52.1 FOR TYPICAL FIRST FLOOR DETAILS.

FIRST FLOOR				SCALE 1/8" = 1'-0"			
STRUCTURAL ENGINEERS BRANDOW & JOHNSON J.A. MARTIN & ASSOCIATES MECHANICAL ENGINEERS RALPH E. PHILLIPS, INC. ELECTRICAL ENGINEERS RALPH E. PHILLIPS, INC. CIVIL ENGINEERS G. SHUIRMAN & ASSOCIATES MOFFATT & WICKOL		DESIGNED AL DRAWN BY KCE CHECKED BY AL	ARCHITECT WILLIAM L. PEREIRA ENGINEER A. QUINCY JONES-FREDERICK E. EMMONS & ASSOCIATES BLUROCK ETLEBROEK & ASSOCIATES COLLEGE	APPROVED WILLIAM L. PEREIRA APPROVED JUN 24 1965 URBANUS SQUARE • MACARTHUR BOULEVARD AT FORD ROAD TELEPHONE 714/675-2640 • CORONA DEL MAR, CALIFORNIA	GOLDEN WEST COLLEGE HUNTINGTON BEACH, CALIFORNIA ORANGE COAST JUNIOR COLLEGE DISTRICT	UNIT 104 FIRST FLOOR PLAN	JOB NO. 104 DATE 16 JUN 1965 SHEET NO. S 1.3 1

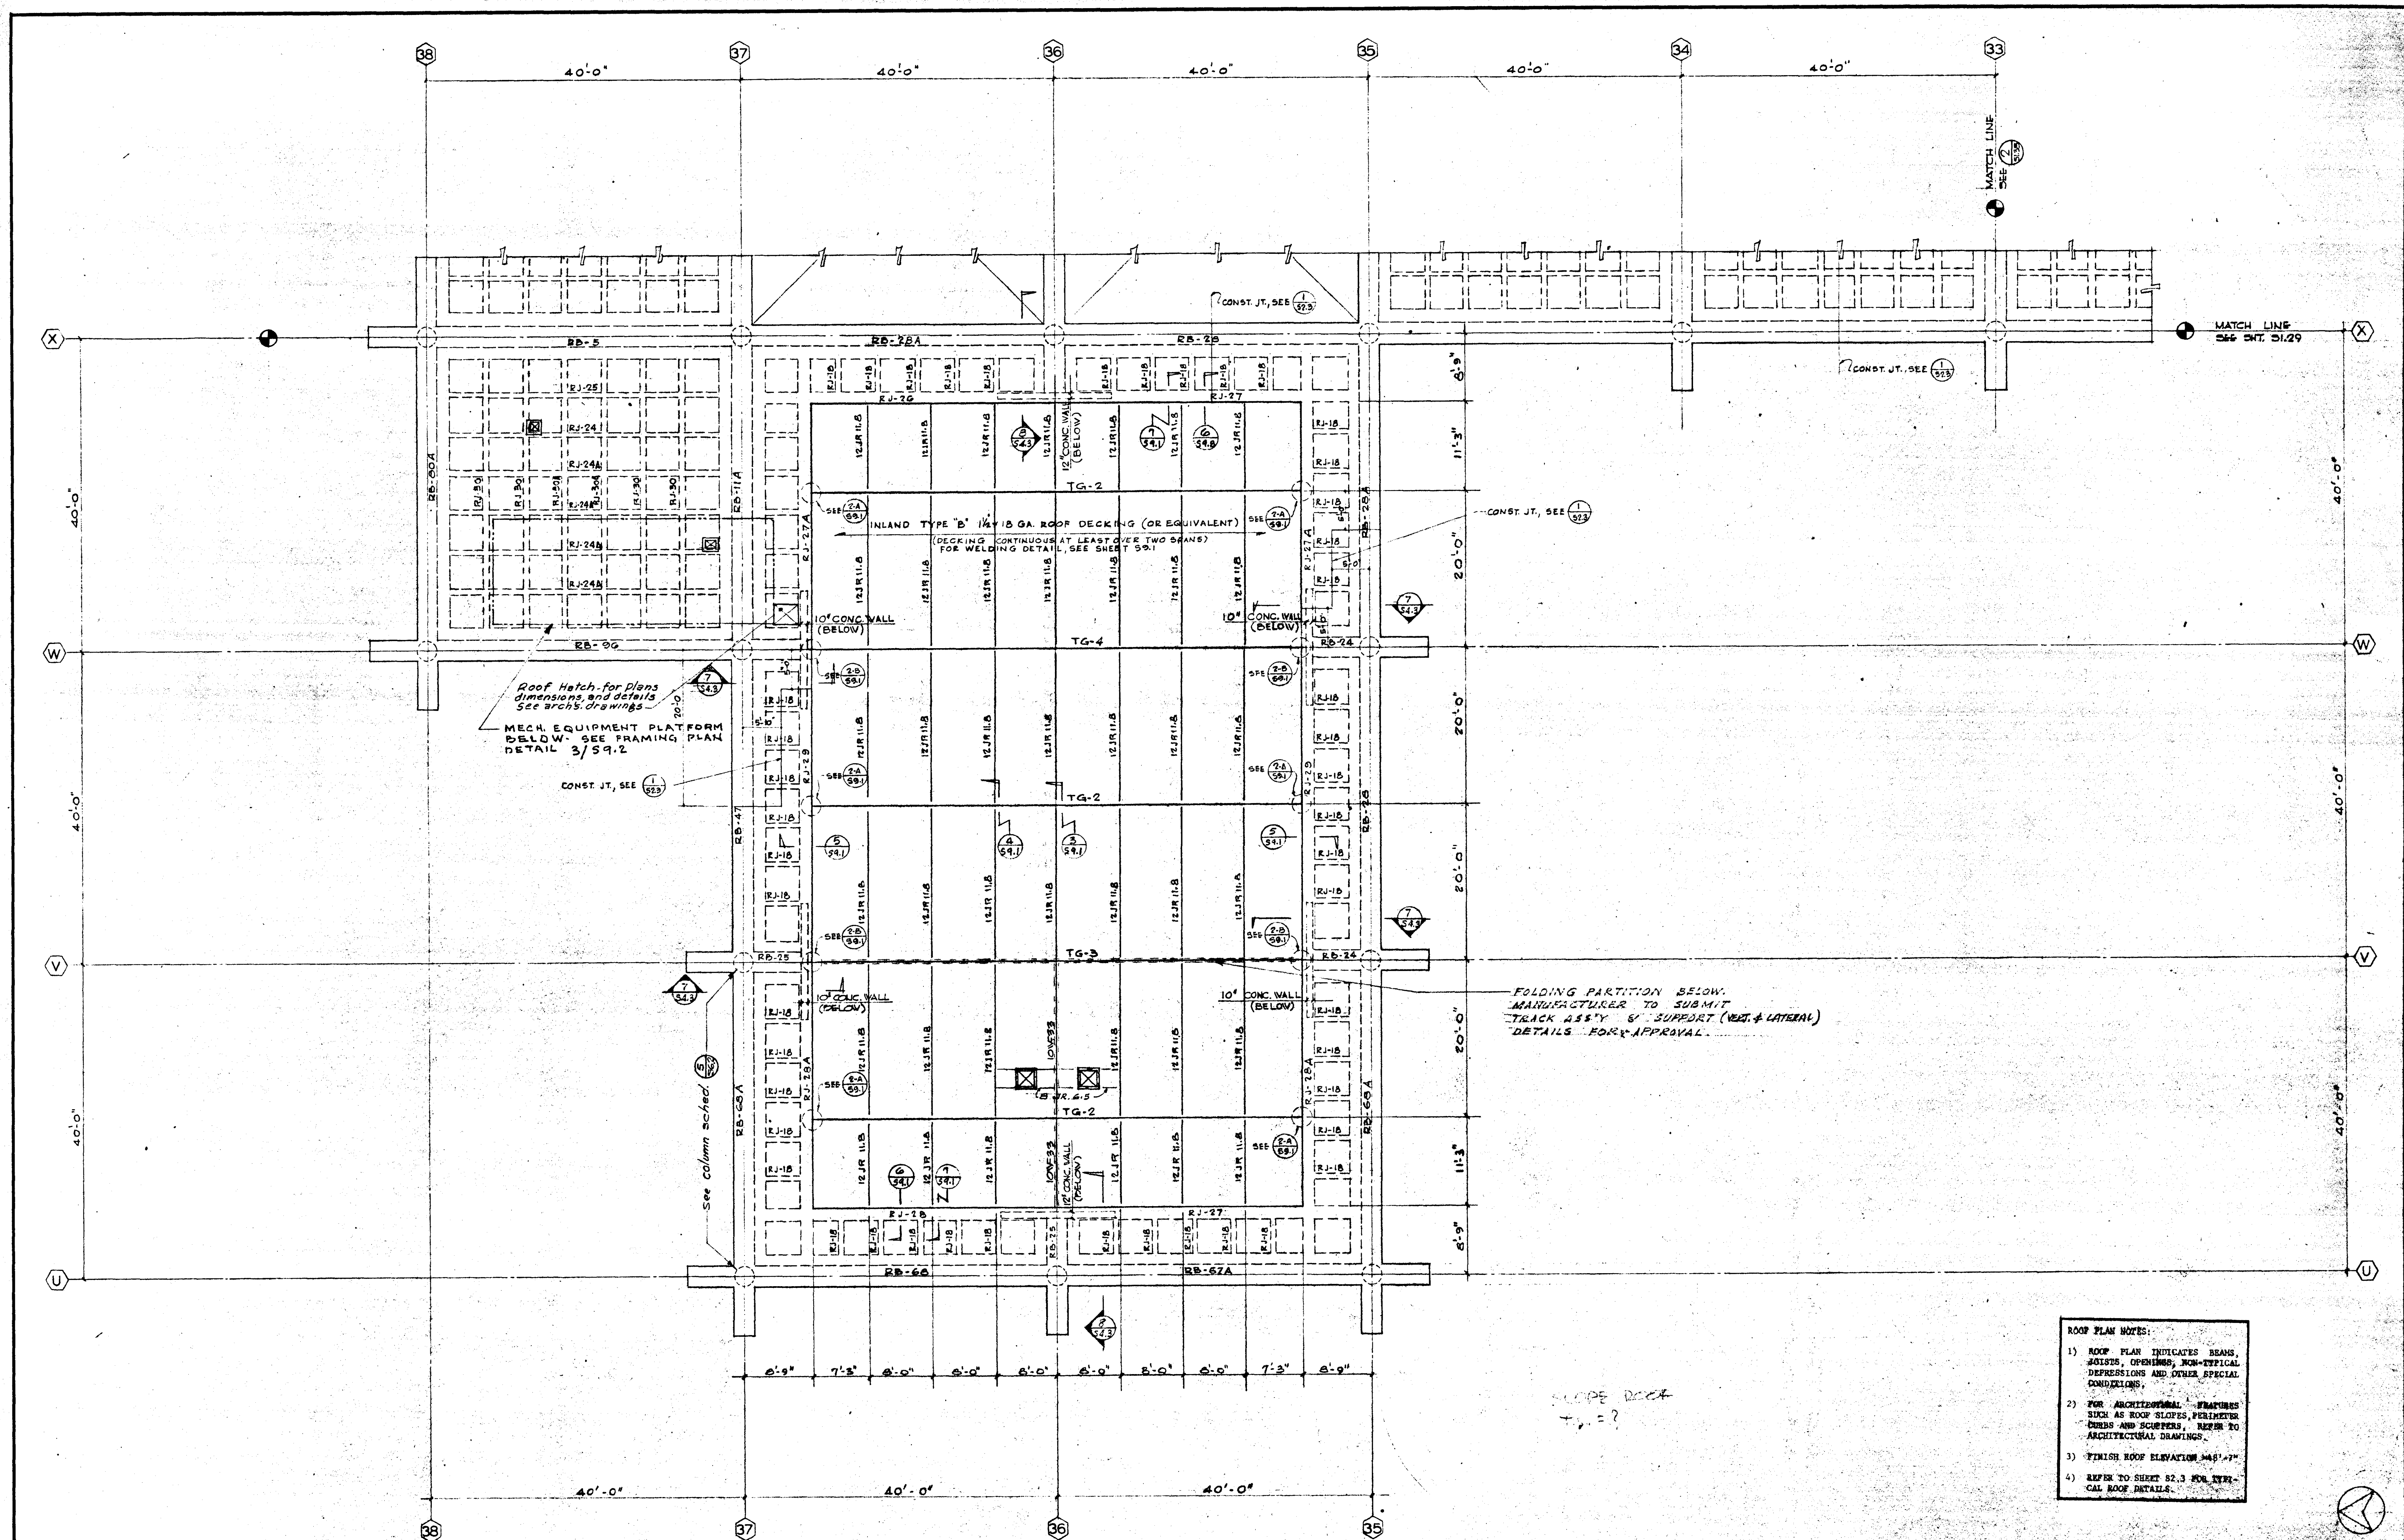


- ROOF PLAN NOTES:
- 1) ROOF PLAN INDICATES BEAMS, JOISTS, OPENINGS, NON-TYPICAL DEPRESSIONS AND OTHER SPECIAL CONDITIONS.
 - 2) FOR ARCHITECTURAL FEATURES SUCH AS ROOF SLOPES, PERIMETER CURBS AND SCUPPERS, REFER TO ARCHITECTURAL DRAWINGS.
 - 3) FINISH ROOF ELEVATION 44'-7".
 - 4) REFER TO SHEET 52.3 FOR TYPICAL ROOF DETAILS.

				UNIT 3b ROOF		SCALE 1/8" = 1'
				UNIT 3b		JOB NO. 104
				ROOF		DATE 16 JUN 1965
				PLAN		SHEET NO. S 1.32
STRUCTURAL ENGINEERS BRANDOW & JOHNSON J. A. MARTIN & ASSOCIATES MECHANICAL ENGINEERS RALPH E. PHILLIPS, INC. ELECTRICAL ENGINEERS RALPH E. PHILLIPS, INC. CIVIL ENGINEERS G. SHURMAN & ASSOCIATES MOFFATT & NICHOL				ASSOCIATED ARCHITECTS: WILLIAM L. PEREIRA & ASSOCIATES A. QUINCY JONES-FREDERICK E. EMMONS & ASSOCIATES BLUROCK ELLERBROEK & ASSOCIATES URBANUS SQUARE • MACARTHUR BOULEVARD AT FORD ROAD TELEPHONE 714/675-2640 • CORONA DEL MAR, CALIFORNIA		
DESIGNED BY ARCHITECT APPROVED JUN 21 1965				GOLDEN WEST COLLEGE HUNTINGTON BEACH, CALIFORNIA ORANGE COAST JUNIOR COLLEGE DISTRICT		
REVISIONS DATE DRAWN						

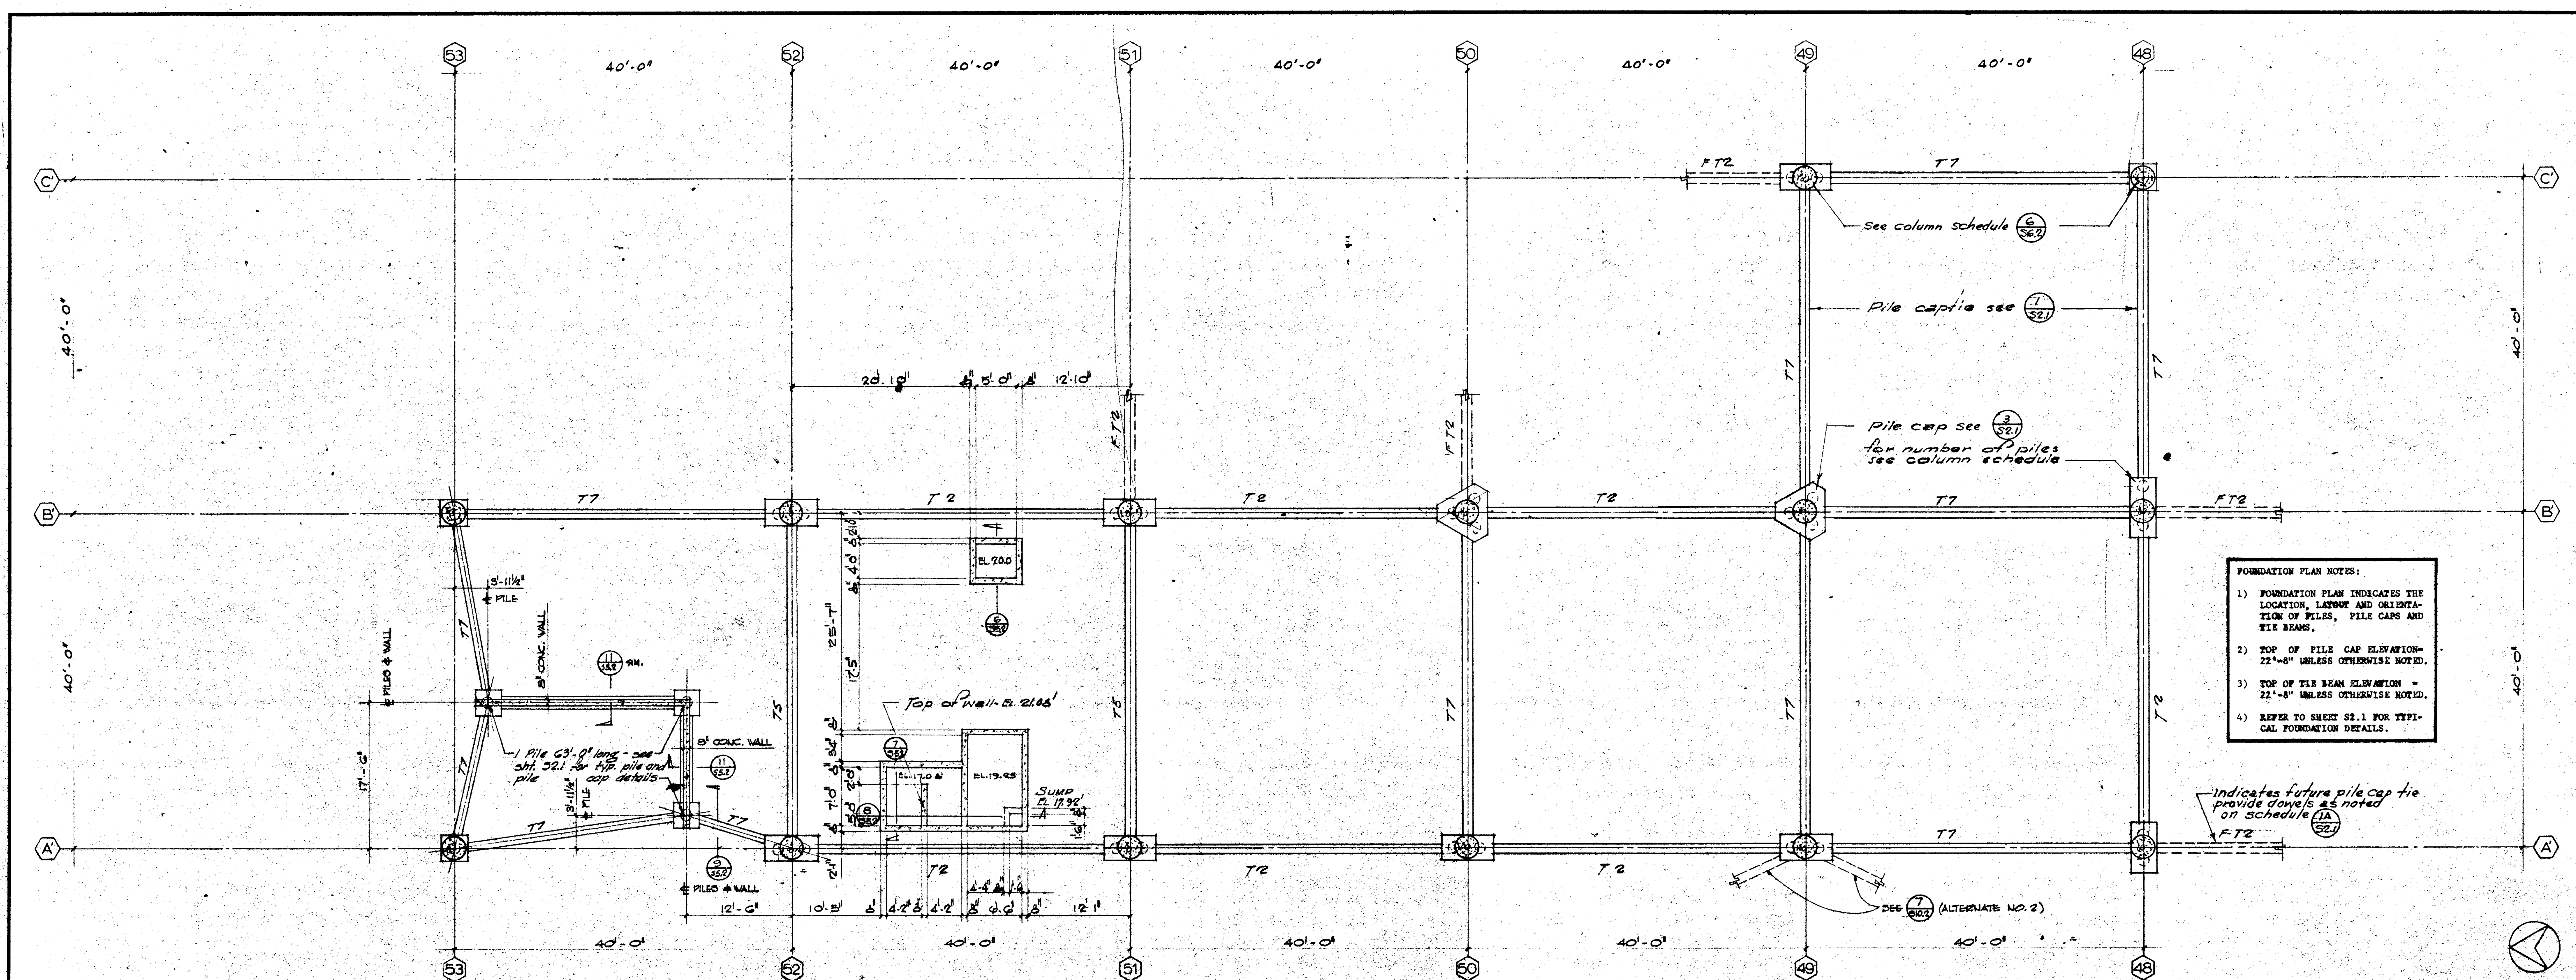

UNIT ID FOUNDATION ID N

SCALE	1/8"
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UNIT 11 FOUNDATION

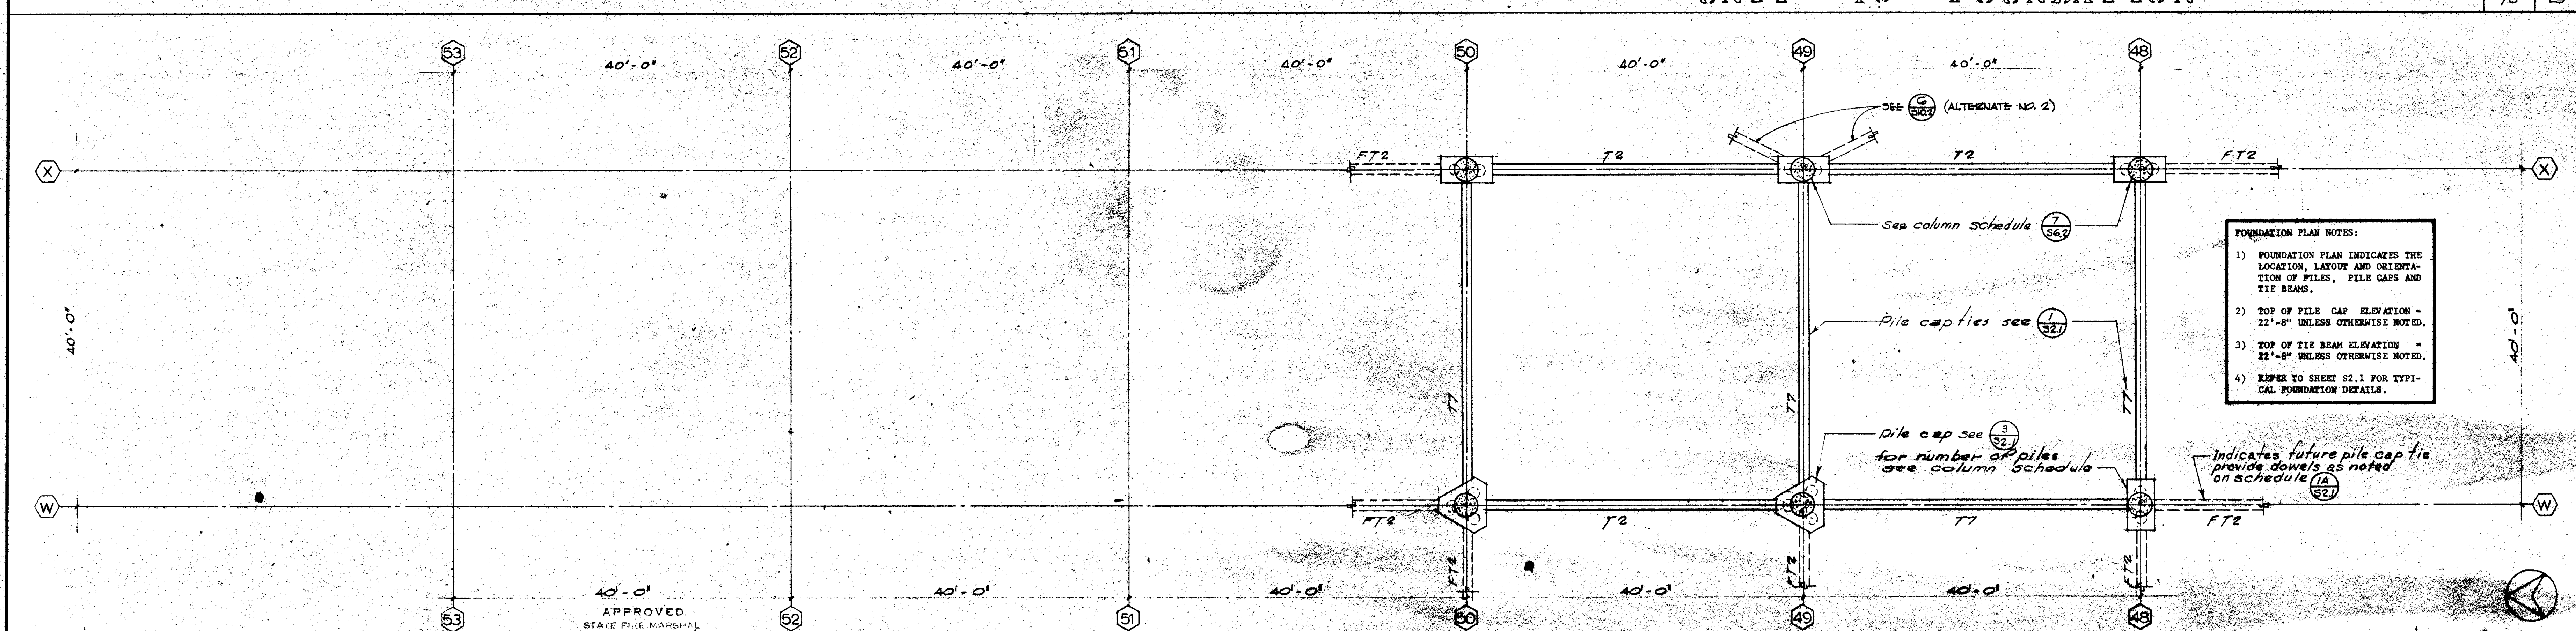SCALE	1
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▲						STRUCTURAL ENGINEERS BRANDOW & JOHNSTON S.A. MARTIN & ASSOCIATES	DESIGNED A.C.N.	ARCHITECT WILLIAMS & P.
▲						MECHANICAL ENGINEERS RALPH E. PHILLIPS, INC.	DRAWN BY O.P.	ENGINEER Eugene J. J.
▲						ELECTRICAL ENGINEERS RALPH E. PHILLIPS, INC.	CHECKED BY LP	COLLEGE
▲						CIVIL ENGINEERS O. SHUKRMAN & ASSOCIATES MOFAT & ASSOCIATES	not	
▲	DATE	DRAWN	REVISIONS					

APPROVED
STATE OF CALIFORNIA — DEPARTMENT OF GENERAL SERVICES
OFFICE OF ARCHITECTURE AND CONSTRUCTION

25874 APPROVED MAY 5 - 1965


Per *B. Barker*
PHOTOGRAPH BY EDWARD W. L. SMITH

ASSOCIATED ARCHITECTS :
WILLIAM L. PERBIRA & ASSOCIATES
A. QUINCY JONES-FREDERICK E. EMMONS & ASSOCIATES
BLUEROCK ELLERBROEK & ASSOCIATES

URBANUS SQUARE • MACARTHUR BOULEVARD AT FORD ROAD
TELEPHONE 714/675-2640 • CORONA DEL MAR, CALIFORNIA

GOLDEN WEST COLLEGE
HUNTINGTON BEACH, CALIFORNIA
ORANGE COAST JUNIOR COLLEGE DISTRICT


UNIT'S	10&11	JOB NO.	10-4
FOUNDATION		DATE	G MAY 1965
PLANS		SHEET NO.	S 1.33

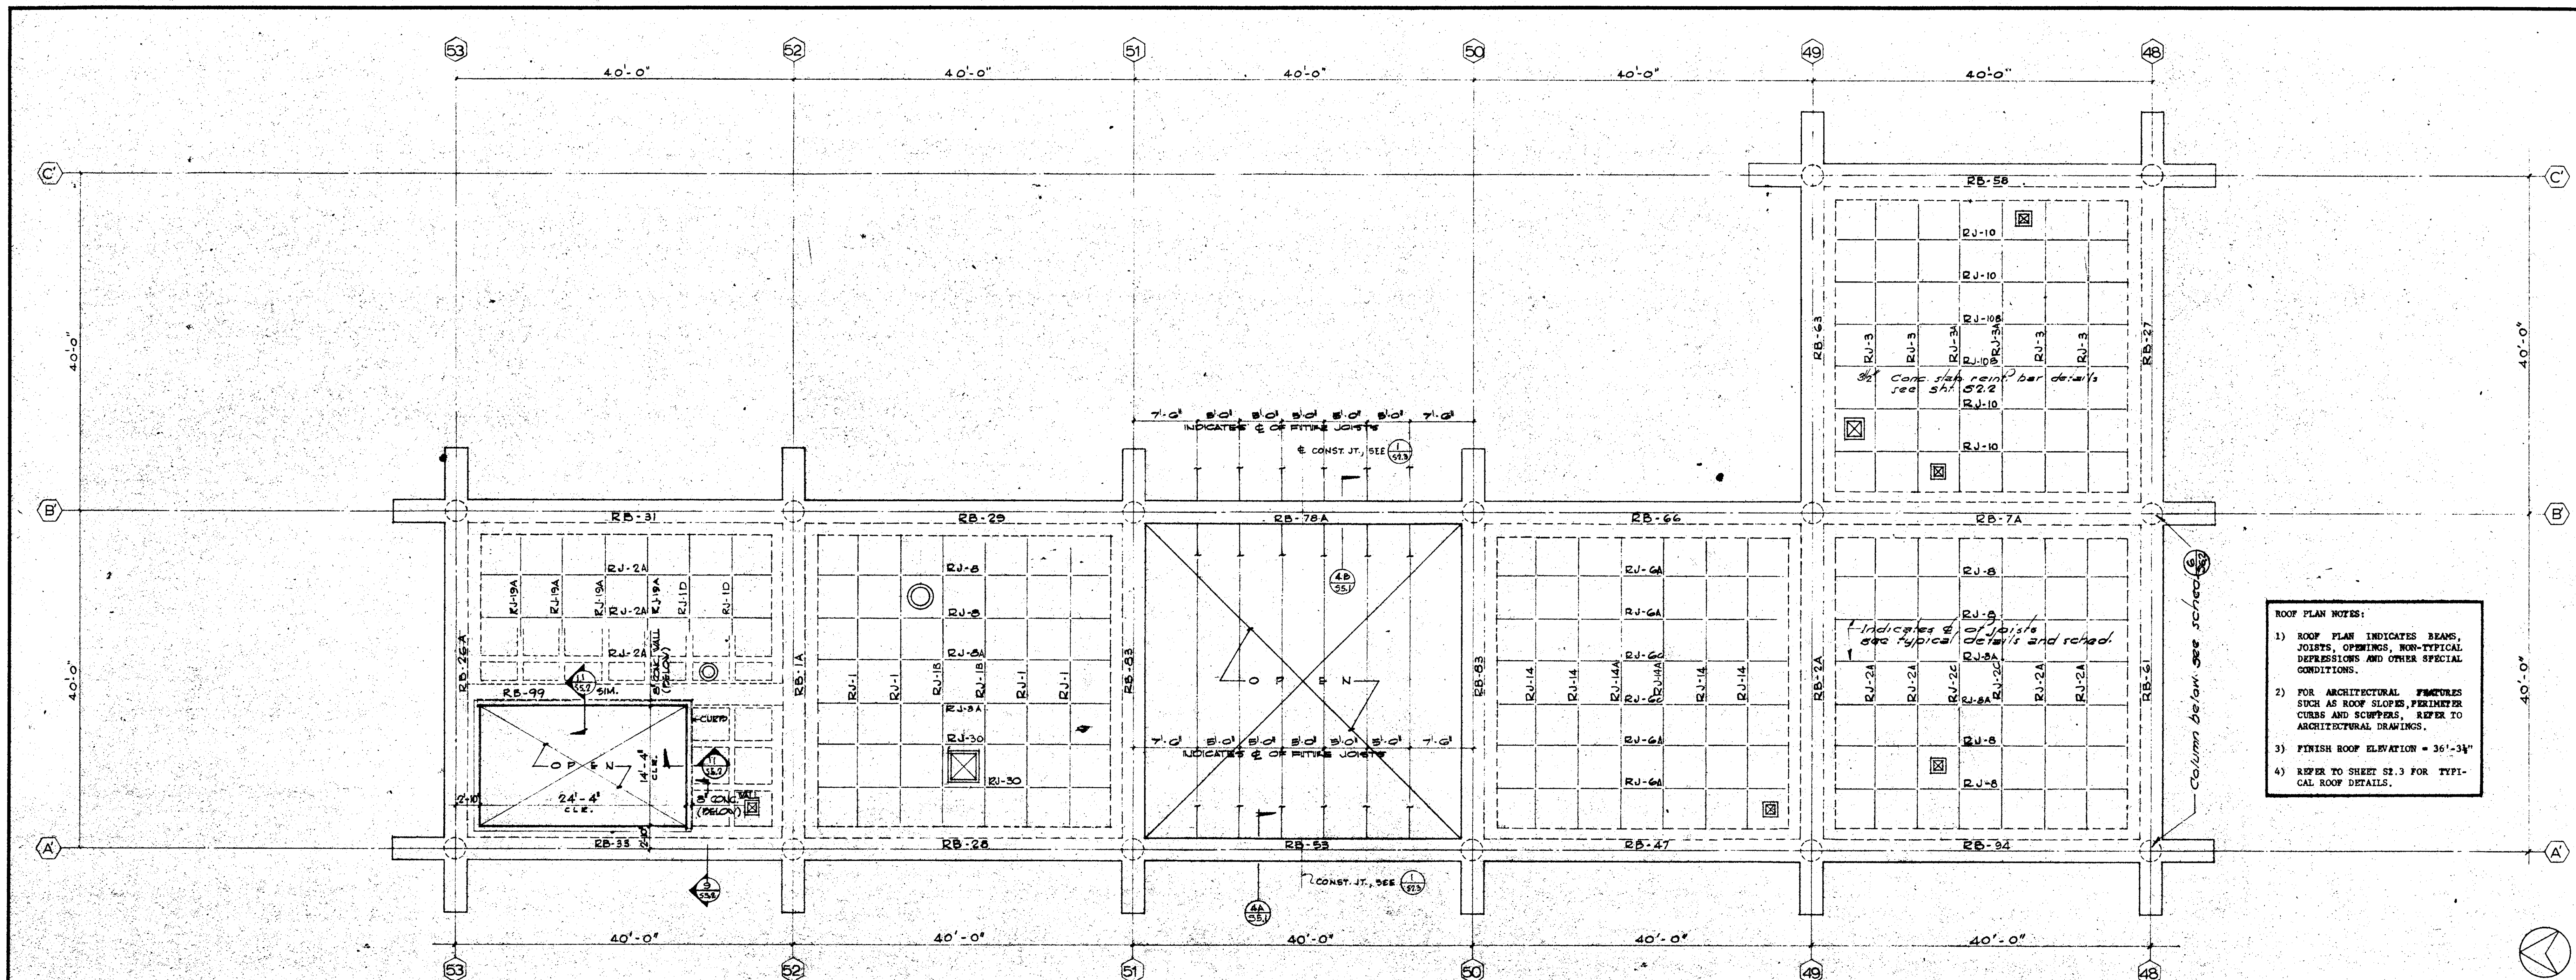

- ROOF PLAN NOTES:**
- 1) ROOF PLAN INDICATES BEAMS, JOISTS, OPENINGS, NON-TYPICAL DEPRESSIONS AND OTHER SPECIAL CONDITIONS.
 - 2) FOR ARCHITECTURAL FEATURES SUCH AS ROOF SLOPES, PERIMETER CURBS AND SCUPPERS, REFER TO ARCHITECTURAL DRAWINGS.
 - 3) FINISH ROOF ELEVATION = 36'-3 1/2"
 - 4) REFER TO SHEET S2.3 FOR TYPICAL ROOF DETAILS.

UNIT 10 ROOF

SCALE 1/8" = 1'

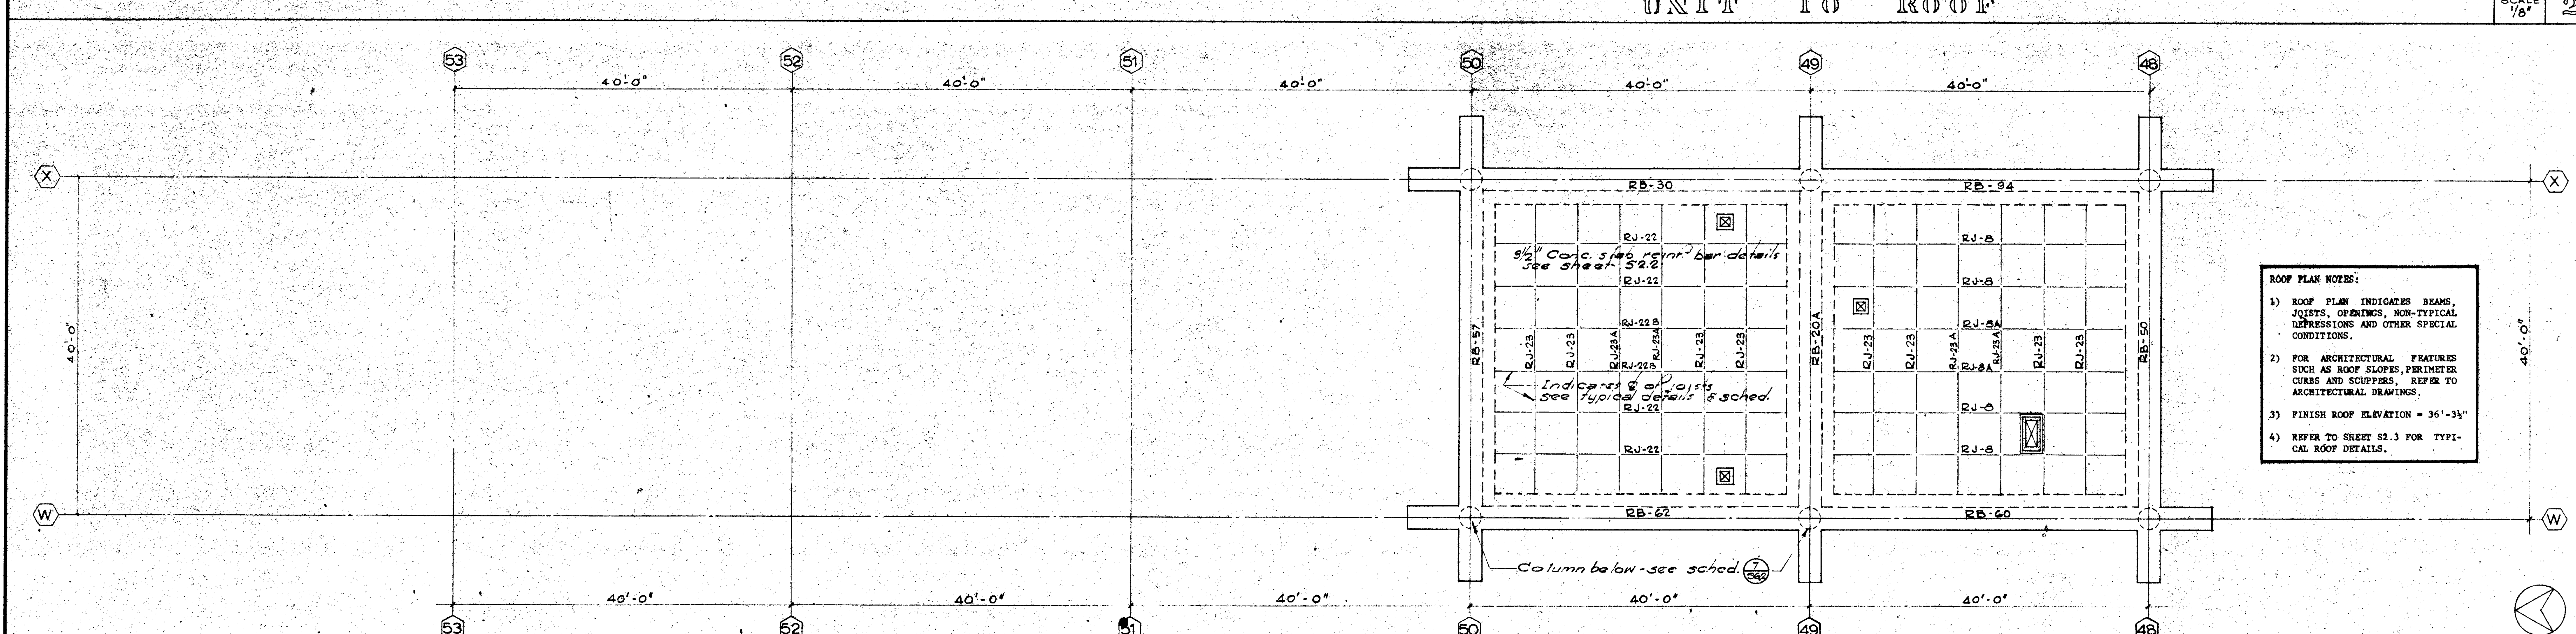


- ROOF PLAN NOTES:**
- 1) ROOF PLAN INDICATES BEAMS, JOISTS, OPENINGS, NON-TYPICAL DEPRESSIONS AND OTHER SPECIAL CONDITIONS.
 - 2) FOR ARCHITECTURAL FEATURES SUCH AS ROOF SLOPES, PERIMETER CURBS AND SCUPPERS, REFER TO ARCHITECTURAL DRAWINGS.
 - 3) FINISH ROOF ELEVATION = 36'-3 1/2"
 - 4) REFER TO SHEET S2.3 FOR TYPICAL ROOF DETAILS.

UNIT 11 ROOF


SCALE 1/8" = 1'

STRUCTURAL ENGINEERS BRANDOW & JOHNSON J.A. MARTIN & ASSOCIATES MECHANICAL ENGINEERS RALPH B. PHILLIPS, INC. ELECTRICAL ENGINEERS RALPH B. PHILLIPS, INC. CIVIL ENGINEERS G. SHURMAN & ASSOCIATES MOFFATT & NICHOL		DESIGNED GU DRAWN BY 1.08 CHECKED BY GU	ARCHITECT WILLIAM L. PEREIRA ENGINEER A. QUINCY JONES COLLEGE	APPROVED STATE OF CALIFORNIA DATE JUN 21 1965	ASSOCIATED ARCHITECTS: WILLIAM L. PEREIRA & ASSOCIATES A. QUINCY JONES - FREDERICK E. EMMONS & ASSOCIATES BLUROCK ELLERBROCK & ASSOCIATES URBANUS SQUARE • MACARTHUR BOULEVARD AT FORD ROAD TELEPHONE 714/675-2640 • CORONA DEL MAR, CALIFORNIA	GOLDEN WEST COLLEGE HUNTINGTON BEACH, CALIFORNIA ORANGE COAST JUNIOR COLLEGE DISTRICT	UNIT'S 10 & 11 ROOF PLANS	JOB NO. 104 DATE 10 JUN 1965 SHEET NO. S 1.35
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UNIT 13 FOUNDATION

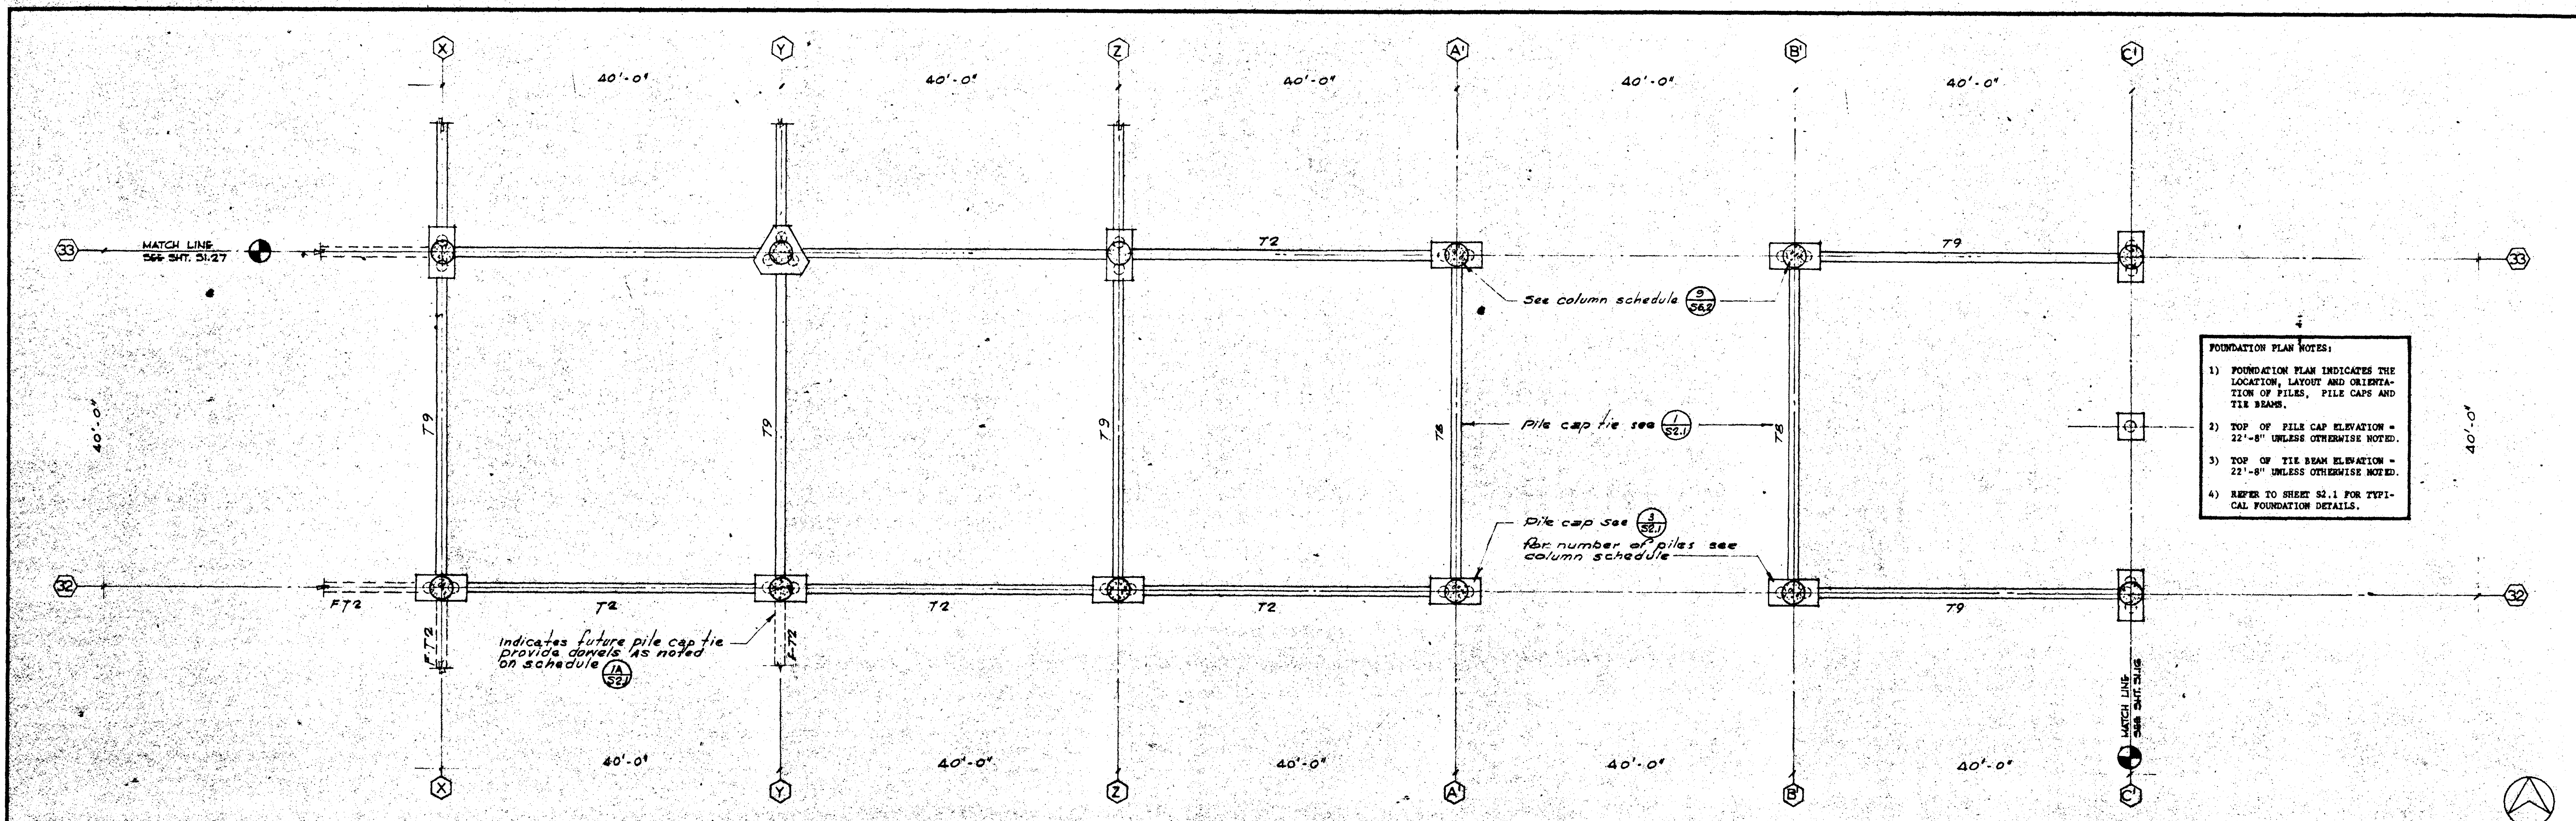
SCALE 1/8" = 1'



UNIT 12 FOUNDATION

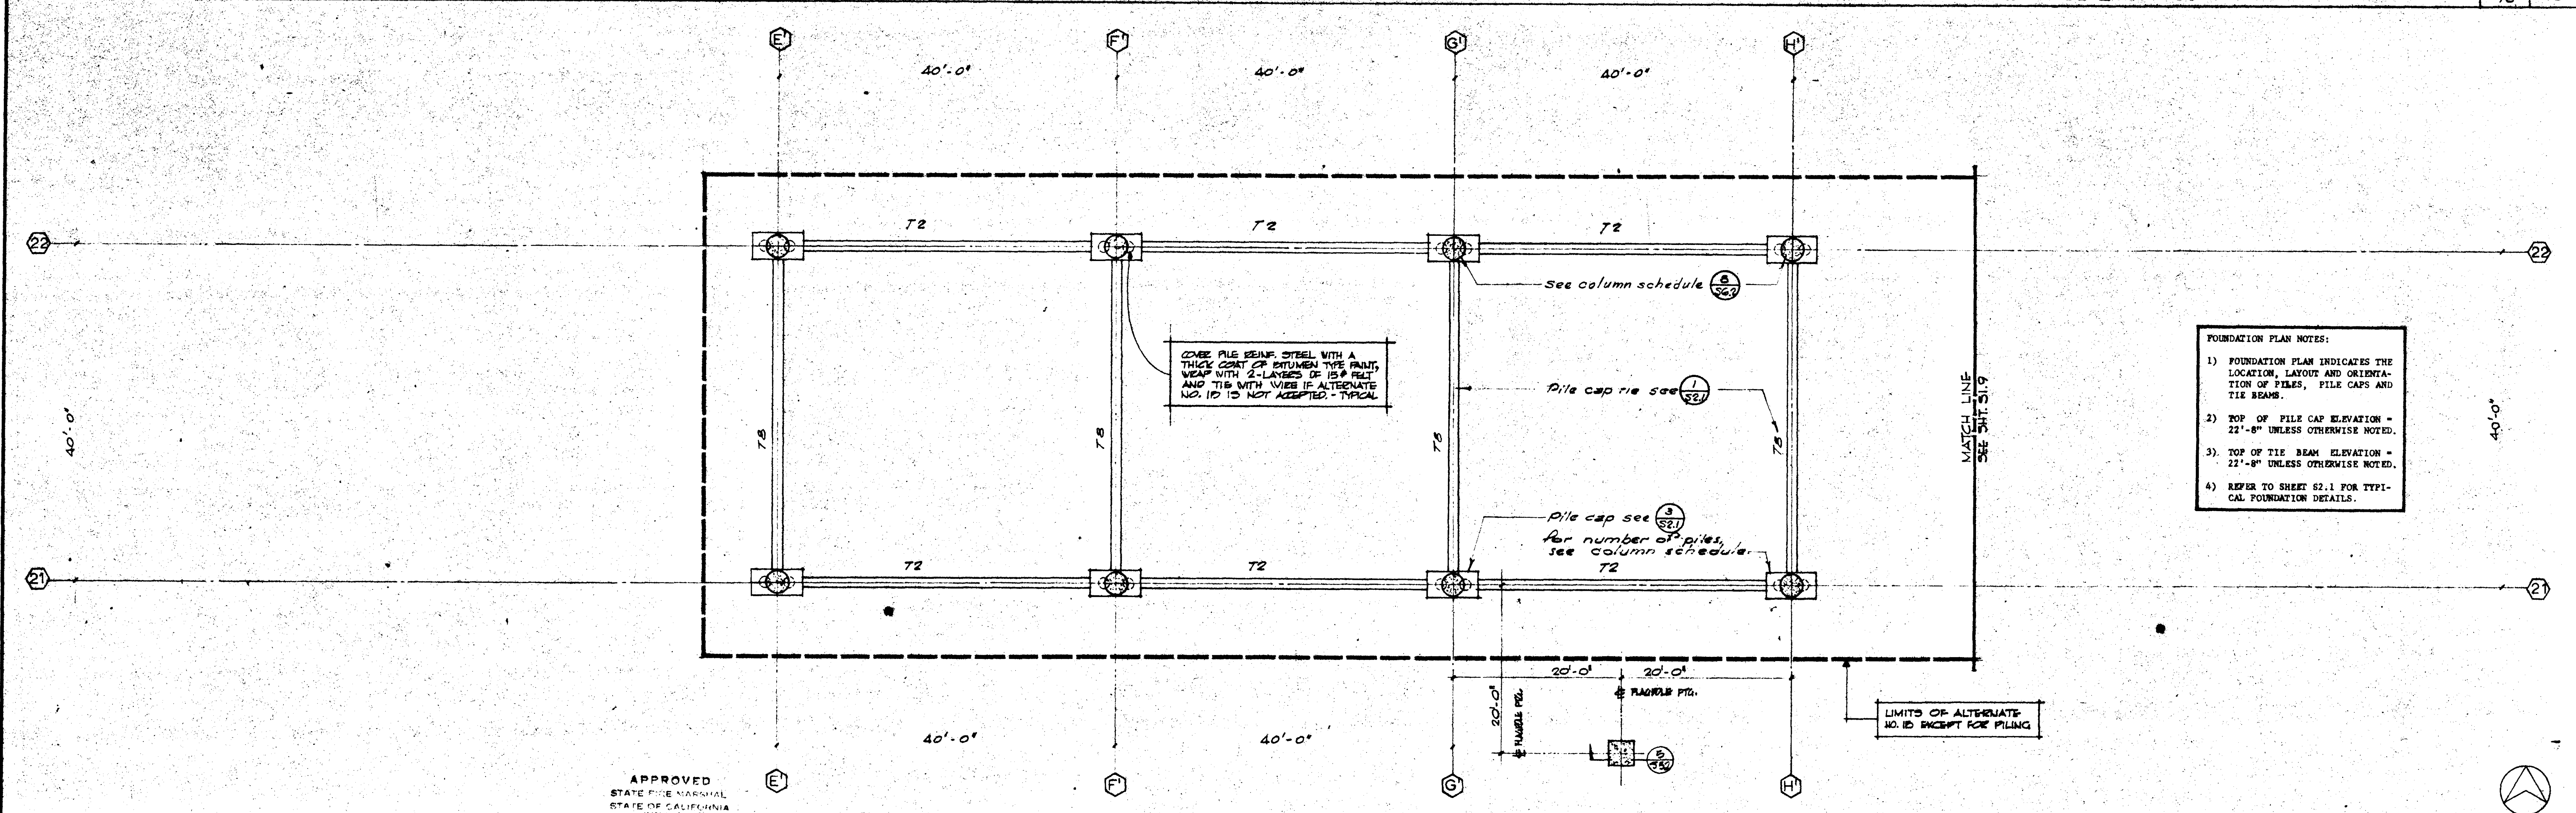
SCALE 1/8" = 1'

<p>REVISIONS</p>	<p>STRUCTURAL ENGINEERS BRANDOW & JOHNSON J.A. MARTIN & ASSOCIATES</p> <p>MECHANICAL ENGINEERS RALPH E. PHILLIPS, INC.</p> <p>ELECTRICAL ENGINEERS RALPH E. PHILLIPS, INC.</p> <p>CIVIL ENGINEERS G. SHURMAN & ASSOCIATES MOFFATT & NICHOL</p>	<p>DESIGNED A.C.N.</p> <p>DRAWN BY C.P.B.</p> <p>CHECKED BY L.P.</p> <p>COLLEGE</p>	<p>APPROVED</p> <p>DATE OF PLAN</p> <p>25 8 74</p> <p>1965</p>	<p>ASSOCIATED ARCHITECTS:</p> <p>WILLIAM L. PEREIRA & ASSOCIATES</p> <p>A. QUINCY JONES, FREDERICK E. EMMONS & ASSOCIATES</p> <p>BLUROCK ELLERBROEK & ASSOCIATES</p> <p>URBANUS SQUARE • MACARTHUR BOULEVARD AT FORD ROAD</p> <p>TELEPHONE 714/675-2640 • CORONA DEL MAR, CALIFORNIA</p>	<p>GOLDEN WEST COLLEGE</p> <p>HUNTINGTON BEACH, CALIFORNIA</p> <p>ORANGE COAST JUNIOR COLLEGE DISTRICT</p>	<p>UNITS 12 & 13</p> <p>FOUNDATION PLANS</p> <p>JOB NO. 1044</p> <p>DATE 6 MAY 1965</p> <p>SHEET NO. S 1.3 C</p>
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UNIT 13 FIRST FLOOR

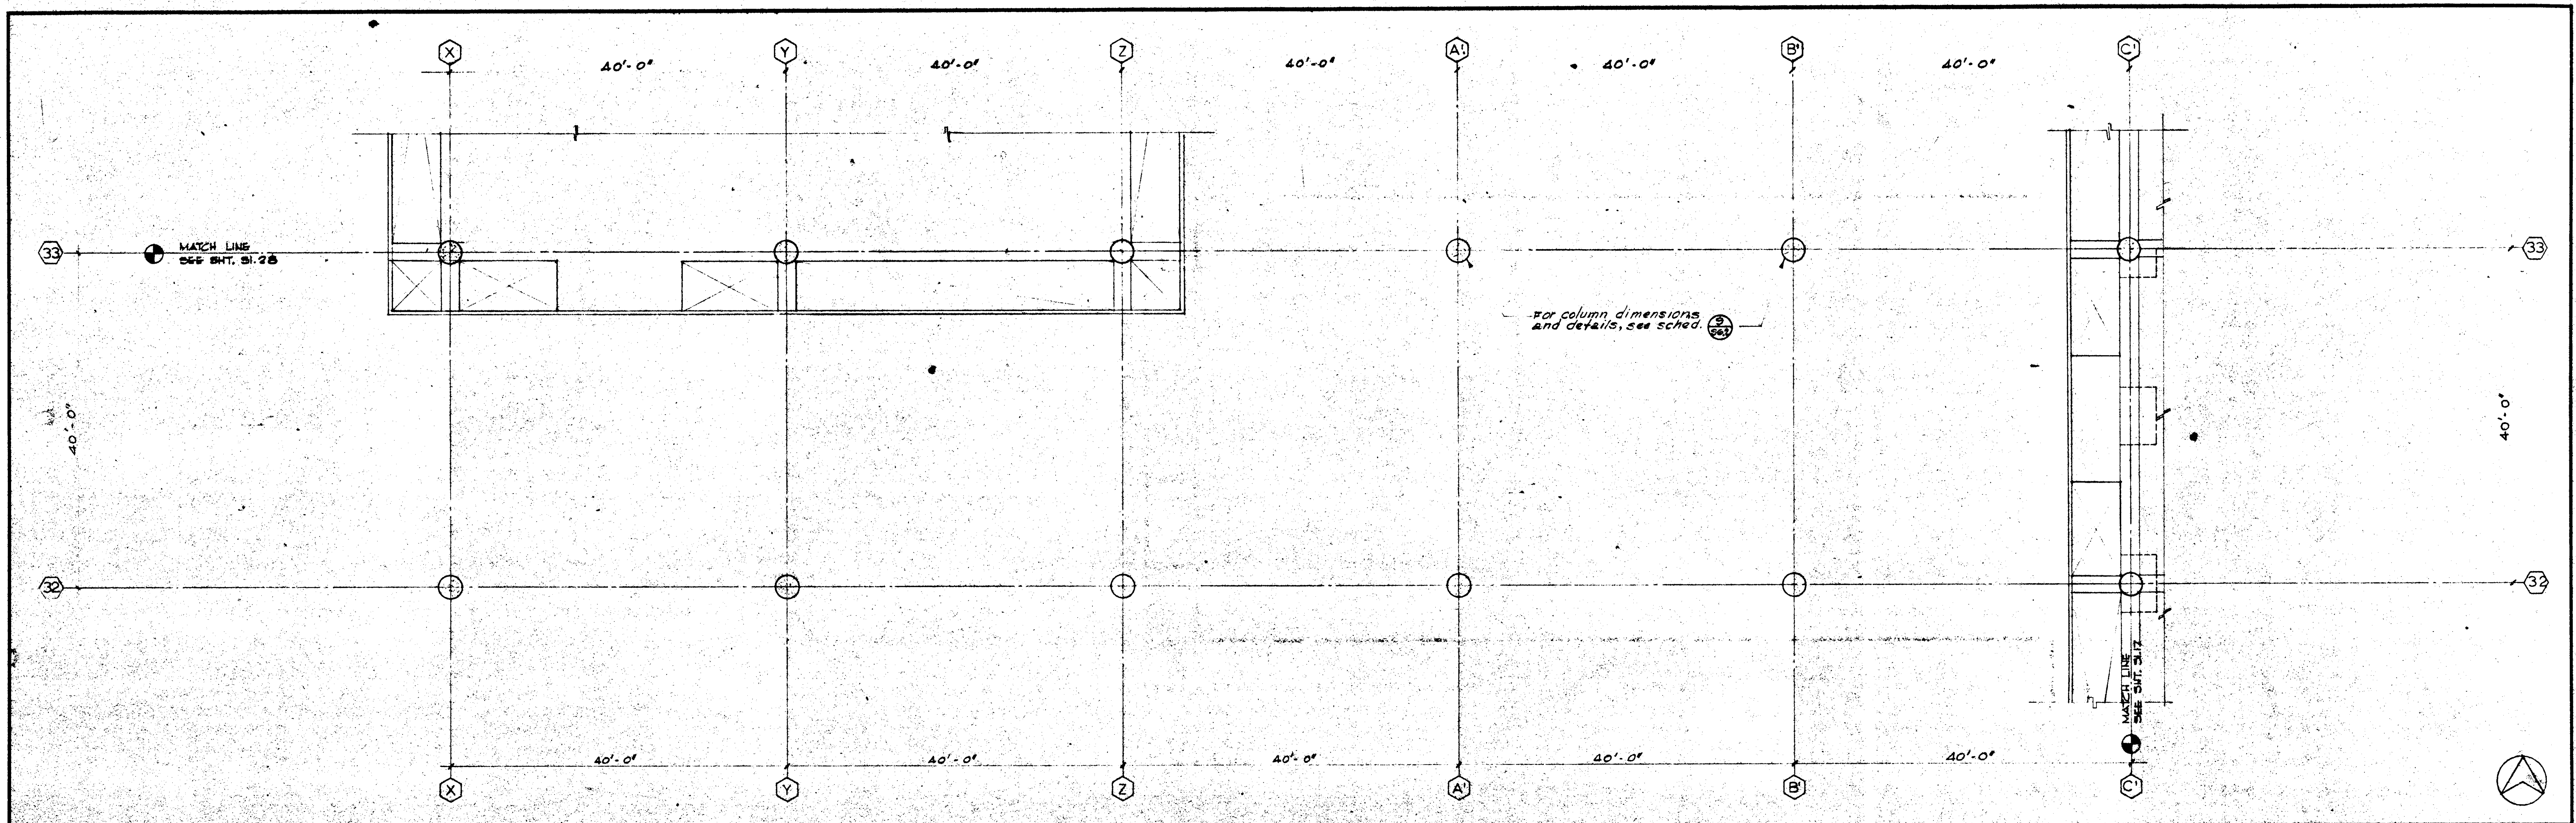
SCALE 1/8" = 1'



UNIT 12 FIRST FLOOR

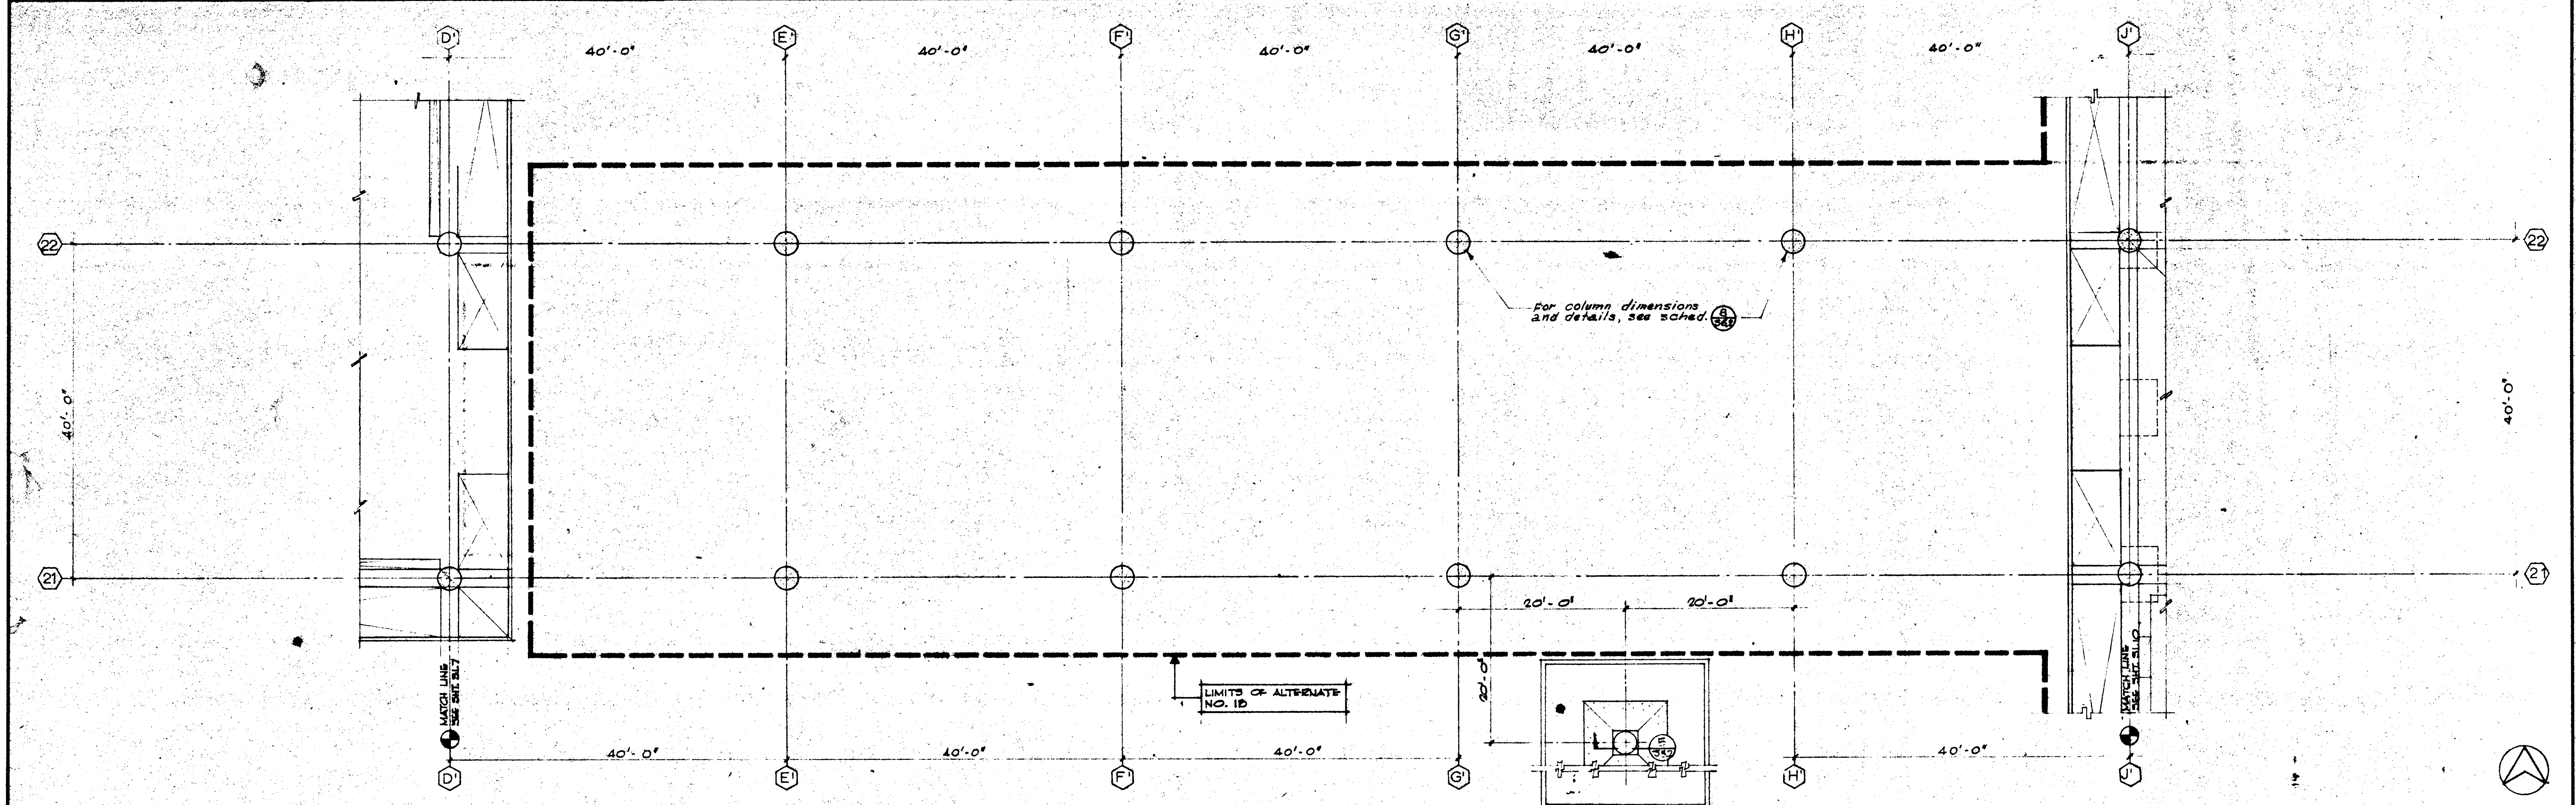SCALE 1/8" = 1'


<div> <div>DATE</div> <div>DRAWN</div> </div> <div> <div>REVISIONS</div> </div>	<div>STRUCTURAL ENGINEERS</div> <div>BRANDOW & JOHNSTON</div> <div>J. A. MARTIN & ASSOCIATES</div> <div>MECHANICAL ENGINEERS</div> <div>RALPH E. PHILLIPS, INC.</div> <div>ELECTRICAL ENGINEERS</div> <div>RALPH E. PHILLIPS, INC.</div> <div>CIVIL ENGINEERS</div> <div>G. SHURMAN & ASSOCIATES</div> <div>MOFFATT & NICHOL</div>	<div>DESIGNED</div> <div>ACN</div> <div>DRAWN BY</div> <div>T.O.B.</div> <div>CHECKED BY</div> <div>4</div>	<div>ARCHITECT</div> <div>WILLIAM L. PEREIRA</div> <div>ENGINEER</div> <div>RAYMOND E. EMMONS</div> <div>COLLEGE</div>	<div>APPROVED</div> <div>APPROVED JUN 21 1965</div>	<div>ASSOCIATED ARCHITECTS:</div> <div>WILLIAM L. PEREIRA & ASSOCIATES</div> <div>A. QUINCY JONES-FREDERICK E. EMMONS & ASSOCIATES</div> <div>BLUROCK ELLERBROEK & ASSOCIATES</div> <div>URBANUS SQUARE • MACARTHUR BOULEVARD AT FORD ROAD</div> <div>TELEPHONE 714/675-2640 • CORONA DEL MAR, CALIFORNIA</div>	<div>GOLDEN WEST COLLEGE</div> <div>HUNTINGTON BEACH, CALIFORNIA</div> <div>ORANGE COAST JUNIOR COLLEGE DISTRICT</div>	<div>UNITS 12 & 13</div> <div>FIRST FLOOR</div> <div>PLANS</div>	<div>SCALE 1/8" = 1'</div> <div>1</div> <div>JOB NO. 1004</div> <div>DATE 16 JUN 1965</div> <div>SHEET NO. S 1.3 7</div>
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- ROOF PLAN NOTES:
- 1) ROOF PLAN INDICATES BEAMS, JOISTS, OPENINGS, NON-TYPICAL DEPRESSIONS AND OTHER SPECIAL CONDITIONS.
 - 2) FOR ARCHITECTURAL FEATURES SUCH AS ROOF SLOPES, PERIMETER CURBS AND SCUPPERS, REFER TO ARCHITECTURAL DRAWINGS.
 - 3) FINISH ROOF ELEVATION = 48'-7"
 - 4) REFER TO SHEET 52.3 FOR TYPICAL ROOF DETAILS.

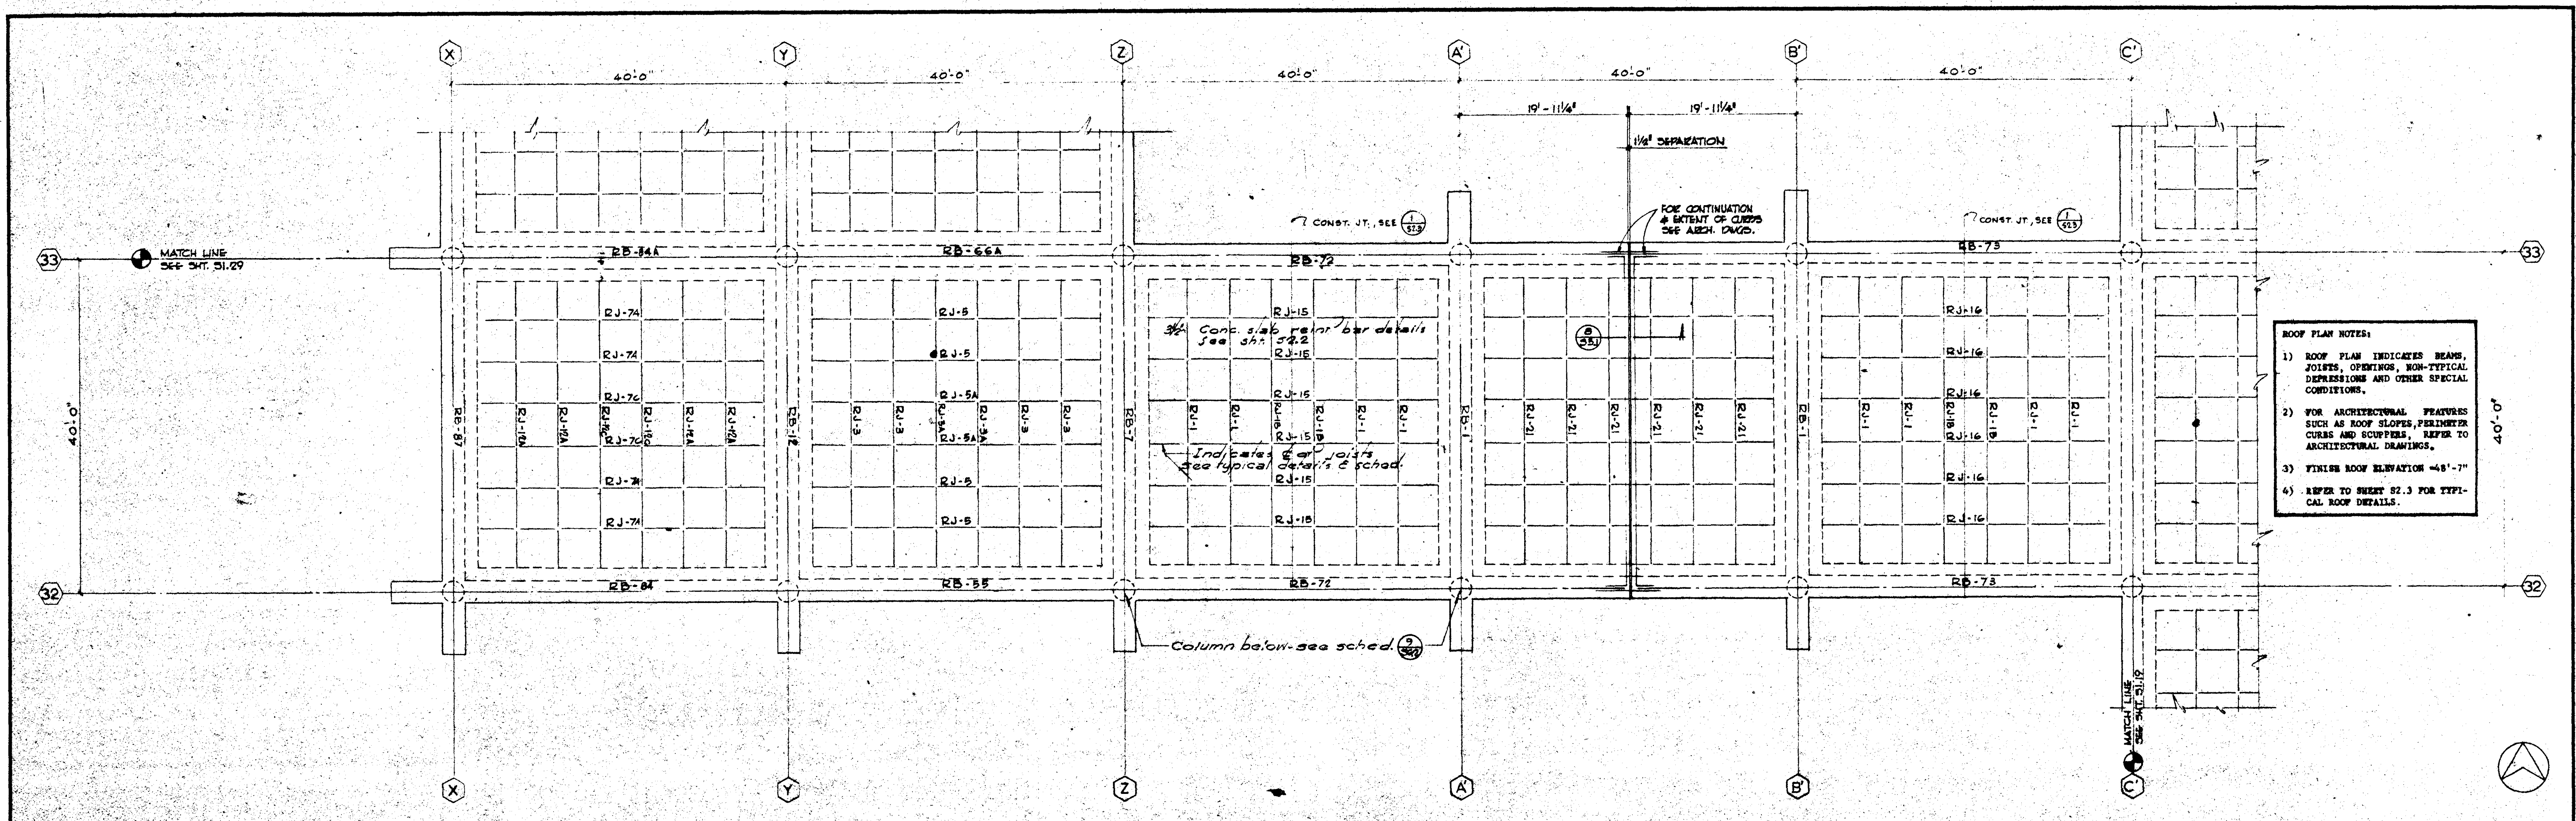UNIT 13 ROOF

SCALE 1/8" = 1'-0" 2




- ROOF PLAN NOTES:
- 1) ROOF PLAN INDICATES BEAMS, JOISTS, OPENINGS, NON-TYPICAL DEPRESSIONS AND OTHER SPECIAL CONDITIONS.
 - 2) FOR ARCHITECTURAL FEATURES SUCH AS ROOF SLOPES, PERIMETER CURBS AND SCUPPERS, REFER TO ARCHITECTURAL DRAWINGS.
 - 3) FINISH ROOF ELEVATION = 48'-7"
 - 4) REFER TO SHEET 52.3 FOR TYPICAL ROOF DETAILS.

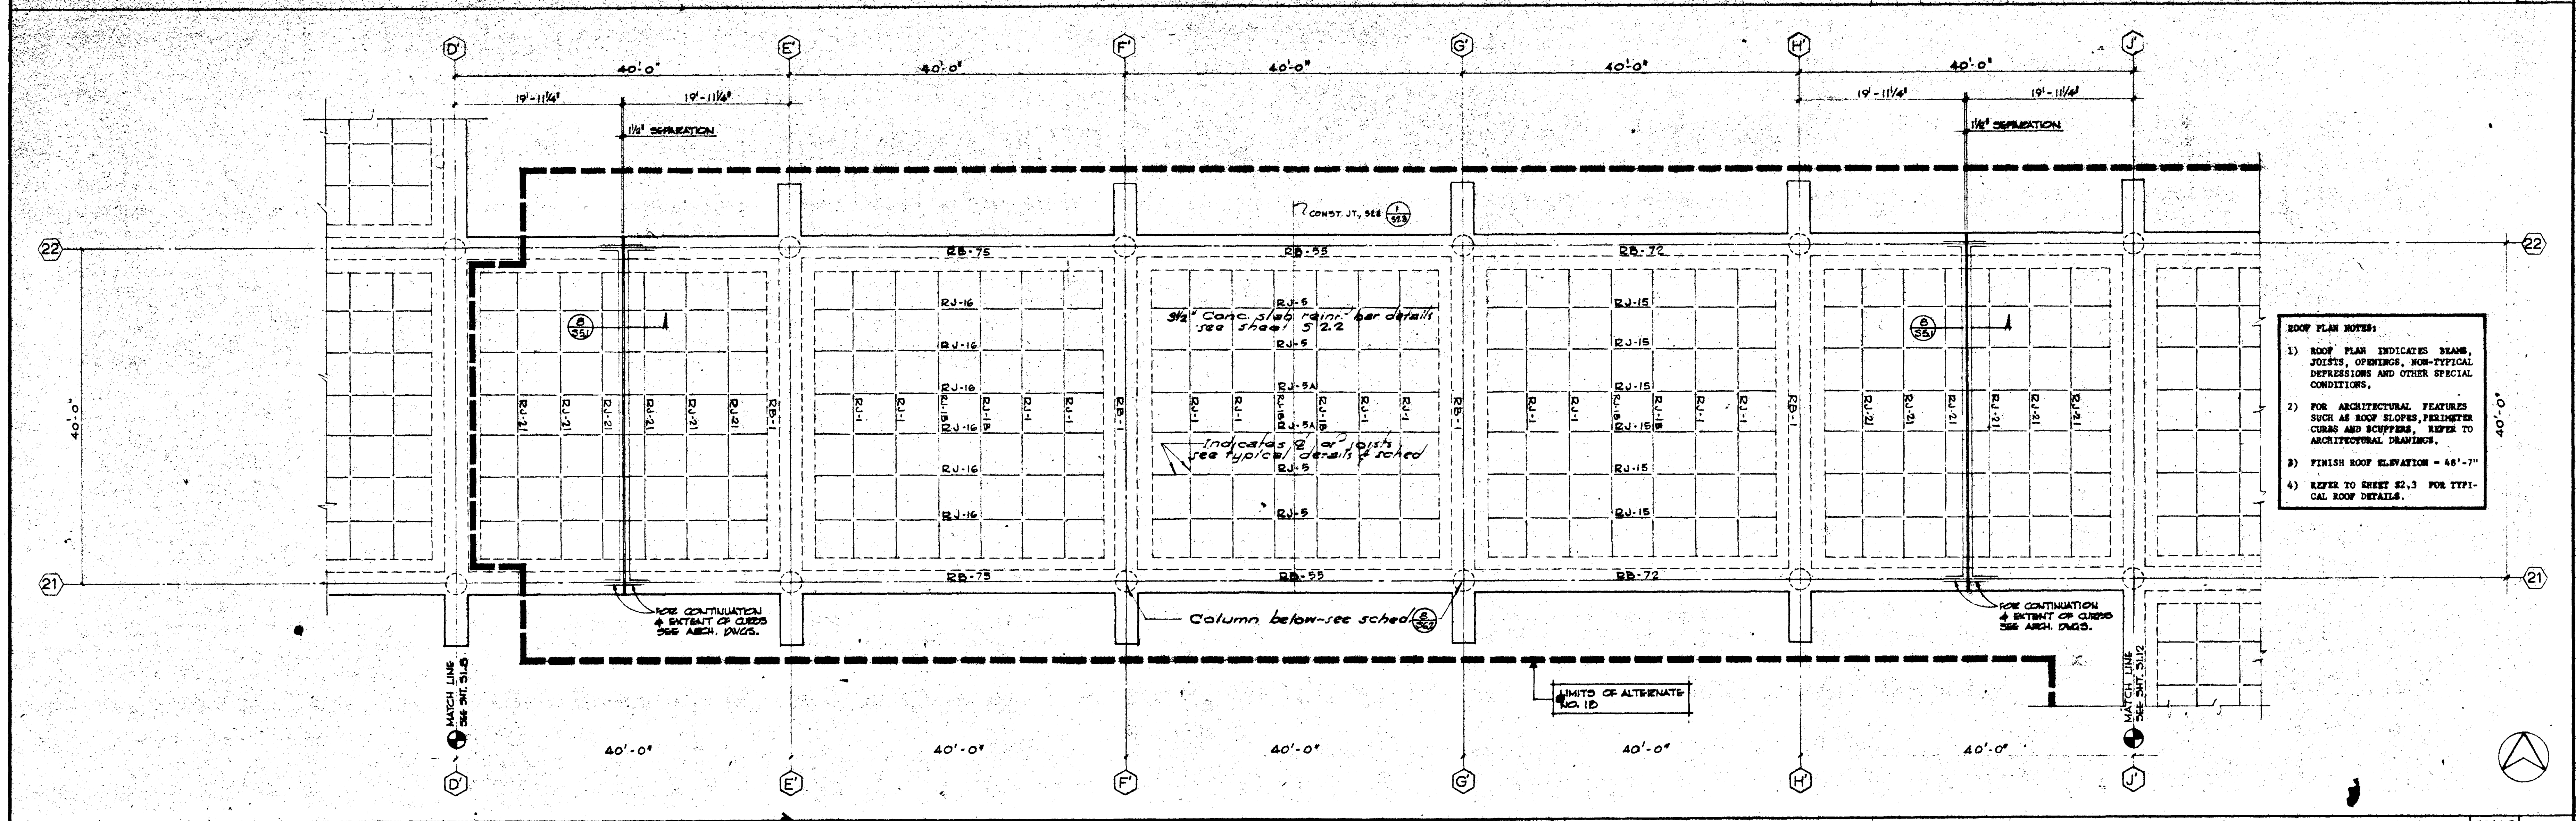UNIT 12 ROOF




SCALE 1/8" = 1'-0" 1

			STRUCTURAL ENGINEERS BRANDOW & JOHNSTON J.A. MARTIN & ASSOCIATES		DESIGNED GLU	ARCHITECT WILLIAM L. FERREIRA	APPROVED STATE FIRE MARSHAL STATE OF CALIFORNIA DATE JUN 21 1965	ASSOCIATED ARCHITECTS: WILLIAM L. FERREIRA & ASSOCIATES A. QUINCY JONES-FREDERICK E. EMMONS & ASSOCIATES BLUROCK ELLERBROCK & ASSOCIATES		GOLDEN WEST COLLEGE HUNTINGTON BEACH, CALIFORNIA ORANGE COAST JUNIOR COLLEGE DISTRICT		UNITS 12&13	JOB NO. 104	
			MECHANICAL ENGINEERS RALPH E. PHILLIPS, INC.		DRAWN BY T.O.D.	ENGINEER A. QUINCY JONES-FREDERICK E. EMMONS & ASSOCIATES						DATE 16 JUN 1965		
			ELECTRICAL ENGINEERS RALPH E. PHILLIPS, INC.		CHECKED BY GLU	COLLEGE BLUROCK ELLERBROCK & ASSOCIATES						SHEET NO.		
			CIVIL ENGINEERS O. BRUHMANN & ASSOCIATES MOFFATT & NICROL					URBANUS SQUARE • MACARTHUR BOULEVARD AT FORD ROAD TELEPHONE 714/675-2640 • CORONA DEL MAR, CALIFORNIA				S \$138		
DATE DRAWN			REVISIONS											

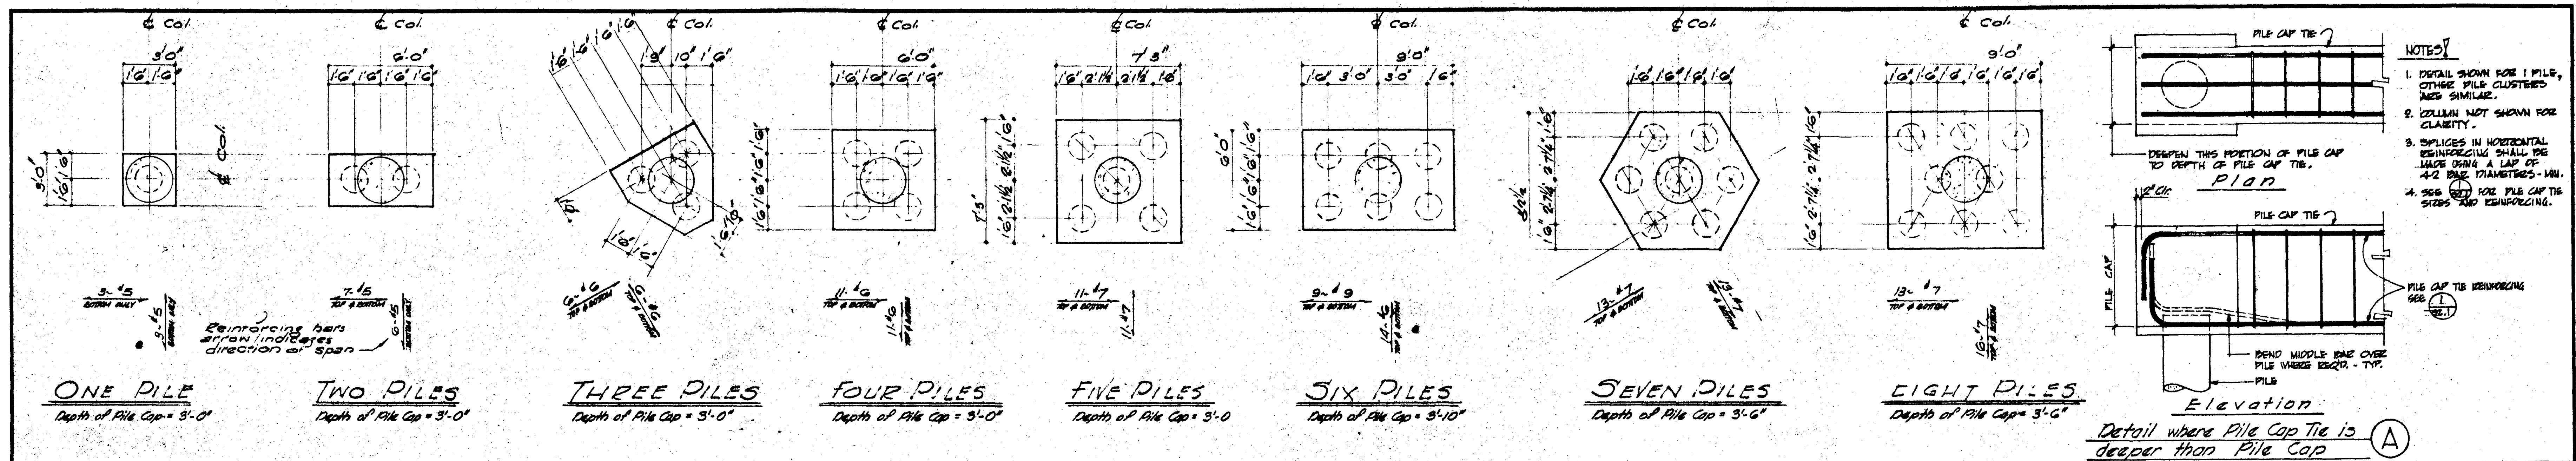

TYPICAL PILE CAPS AND PILE SPACING DETAILS

SCALE 1/4" = 1'-0"

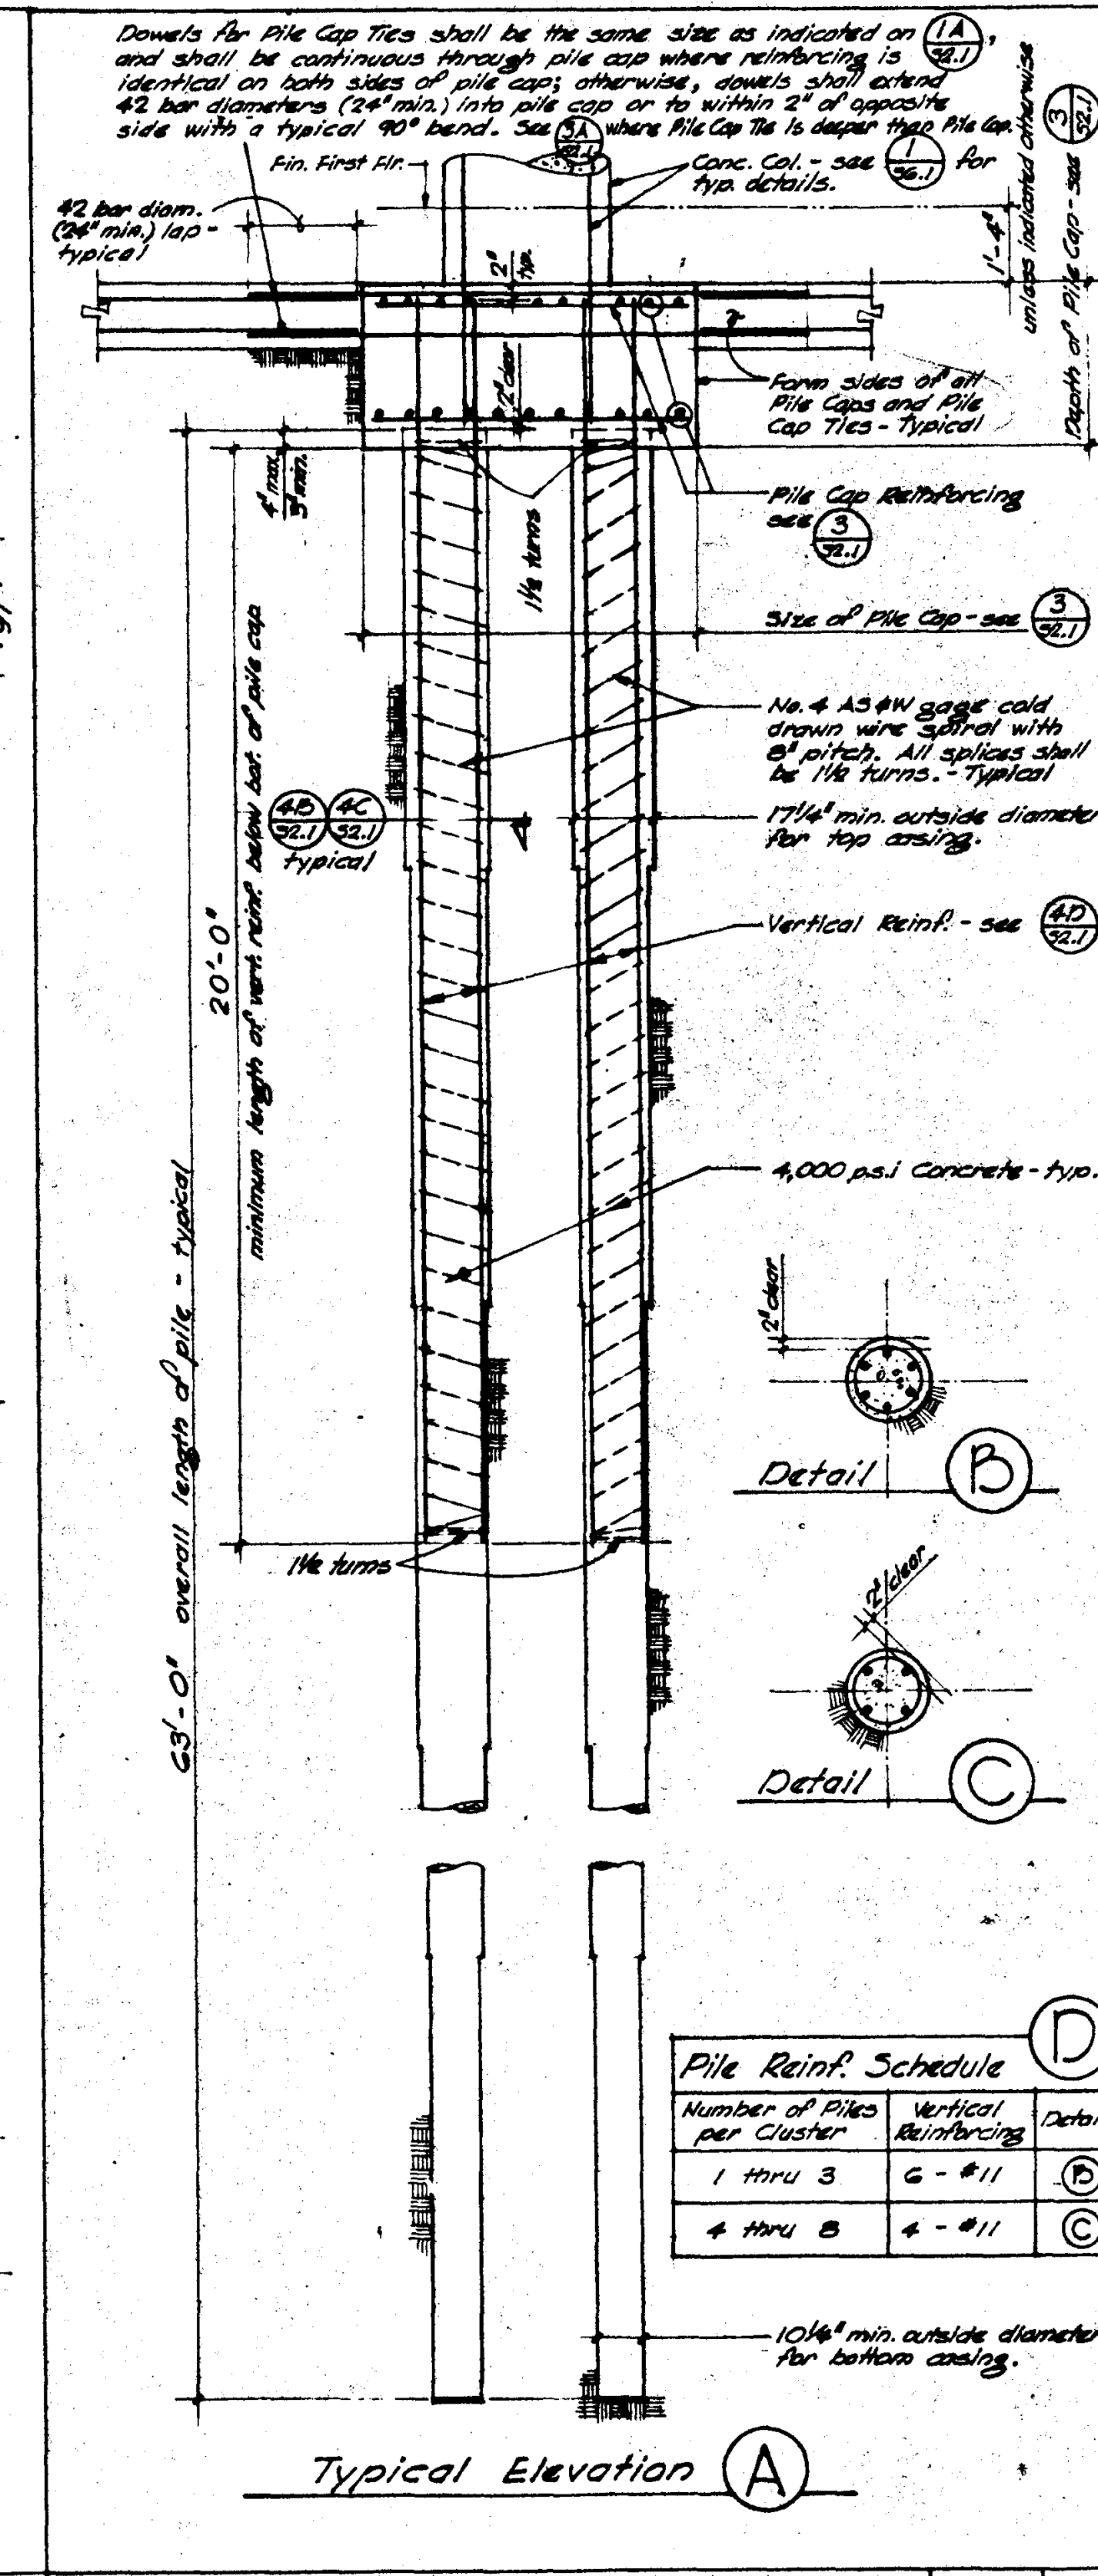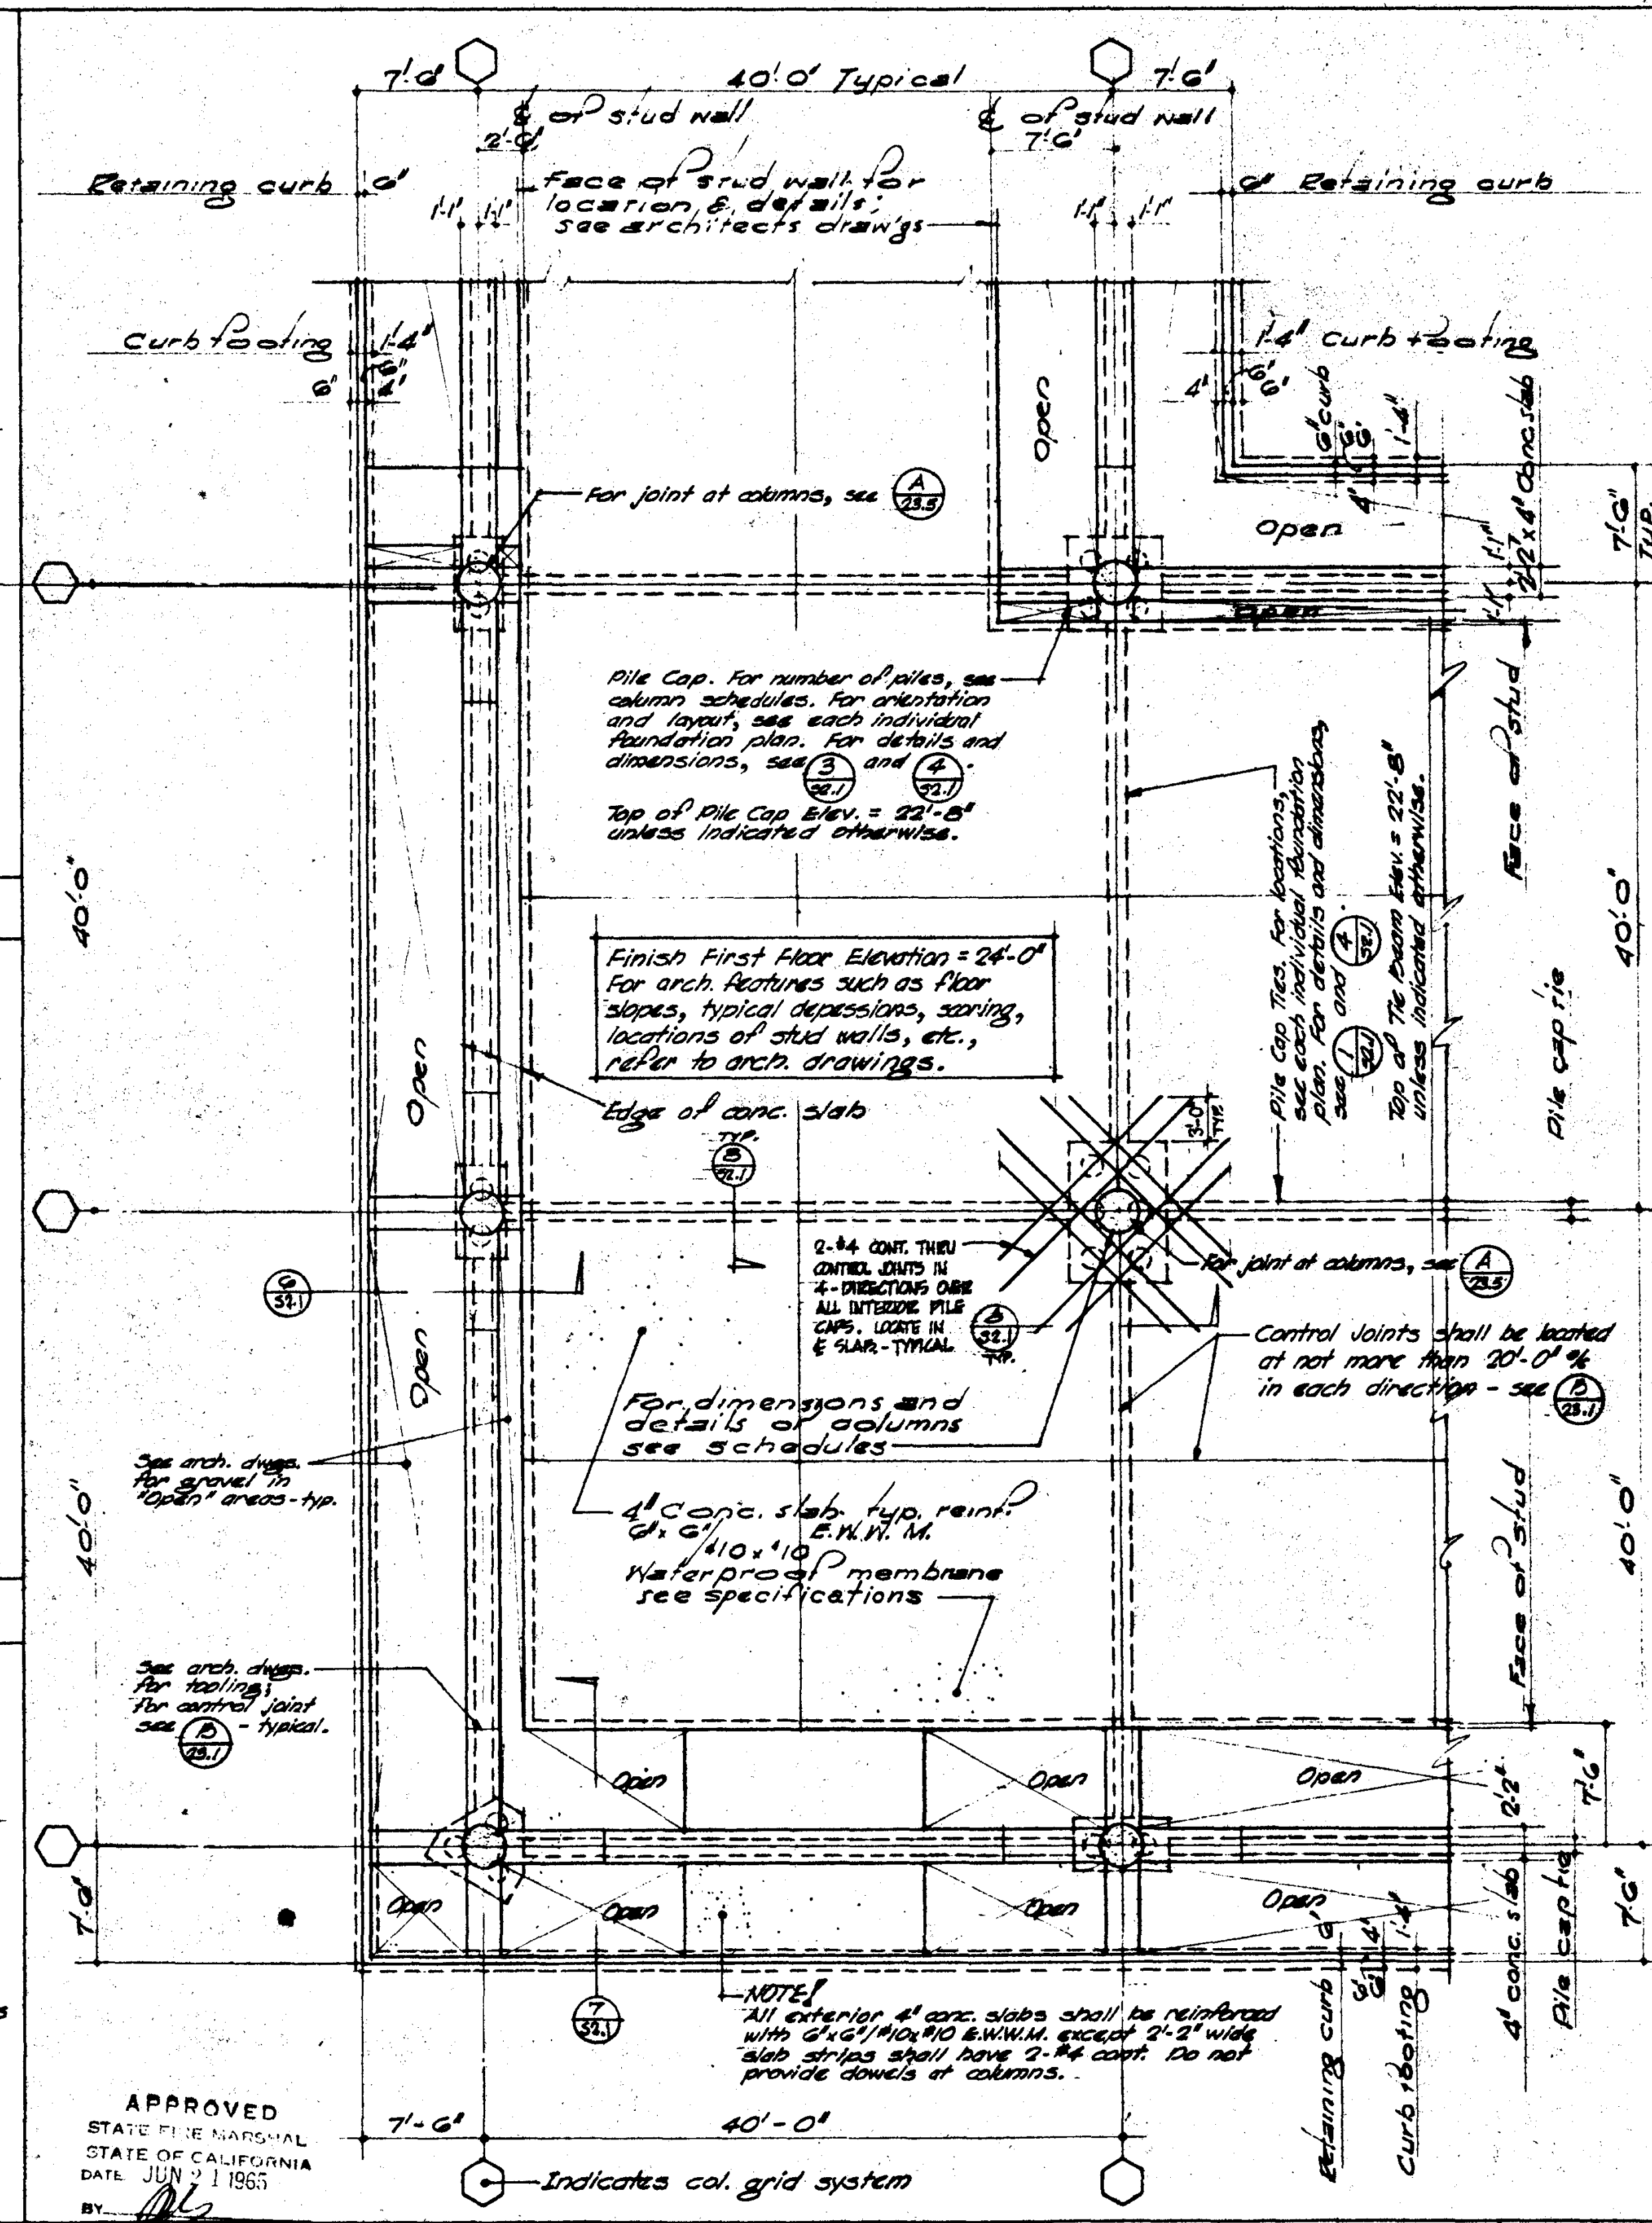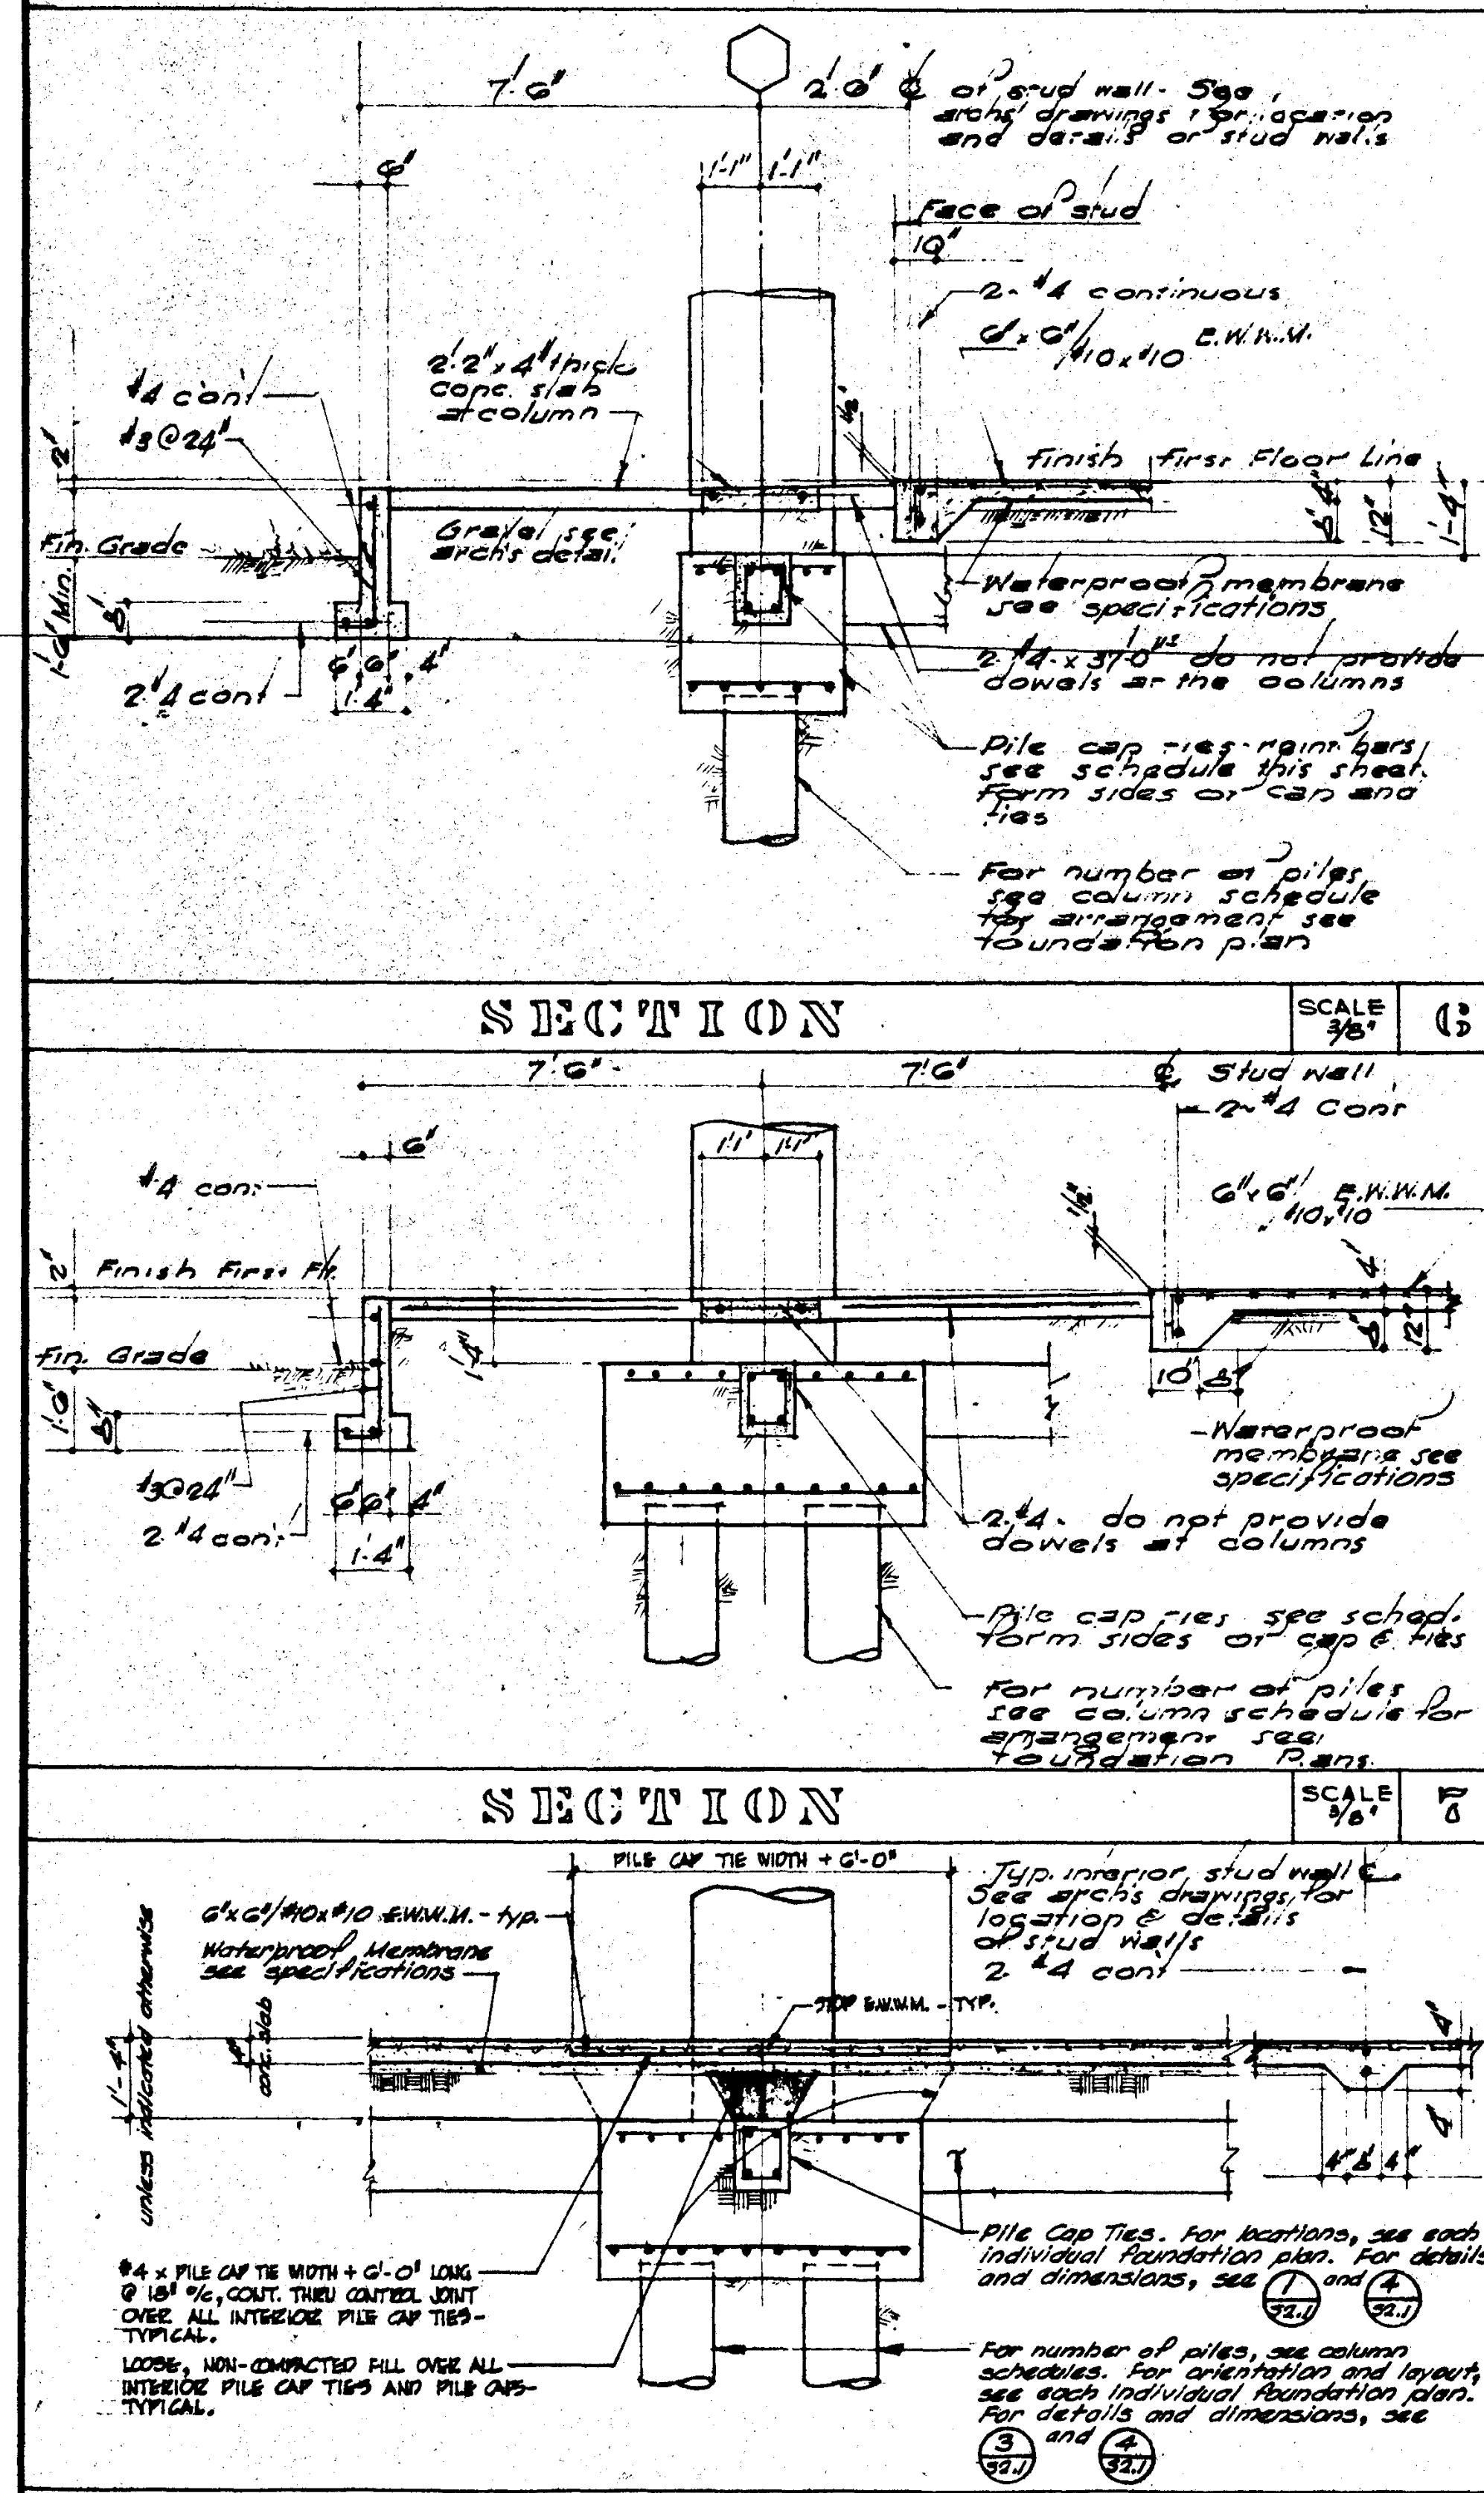

- PILE NOTES**
- PILE DESIGN BASED UPON RECOMMENDATIONS CONTAINED IN "FOUNDATION INVESTIGATION, GOLDEN WEST COLLEGE, HUNTINGTON BEACH, CALIFORNIA, FOR ASSOCIATED ARCHITECTS, CORONA DEL MAR, CALIFORNIA," DATED APRIL 20, 1964, INCLUDING ALL ADDENDA, AND "REPORT OF A PILE TEST, GOLDEN WEST COLLEGE, HUNTINGTON BEACH, CALIFORNIA, FOR ASSOCIATED ARCHITECTS, CORONA DEL MAR, CALIFORNIA," DATED DECEMBER 10, 1964, ALL PREPARED BY L.T. EVANS, INC., FOUNDATION ENGINEERS.
 - ALL PILES SHALL BE TAPERED, METAL-CASED, CAST-IN-PLACE CONCRETE, FRICTION TYPE. PILE CASINGS (SHELLS) SHALL BE "RAYMOND, 'STEP-TAPER'."
 - THE DESIGN CAPACITY OF A SINGLE PILE APPROXIMATELY 63' LONG = 160,000# FOR DEAD PLUS LIVE LOADS.
 - ALL PILE CASINGS SHALL BE DRIVEN TO REFUSAL; I.E., USING A PILE DRIVING HAMMER DELIVERING A BLOW OF 15,500 FOOT POUNDS OF ENERGY, AT LEAST 90 BLOWS PER FOOT OF PENETRATION IS MEASURED OVER NOT LESS THAN THE LAST 3' OF DRIVING.
 - THE FOUNDATION ENGINEER, L.T. EVANS, INC., SHALL INSPECT AND APPROVE EACH PILE CASING PRIOR TO POURING CONCRETE.
 - NO PILE CASING WITHIN A SINGLE CLUSTER OR WITHIN 12'-0" CENTER-TO-CENTER SHALL BE FILLED WITH CONCRETE UNTIL ALL OF THE PILE CASINGS WITHIN THAT CLUSTER OR WITHIN 12'-0" CENTER-TO-CENTER HAVE BEEN INSPECTED AND APPROVED BY THE FOUNDATION ENGINEER.
 - ALL PILE CASINGS SHALL BE FREE OF WATER AT THE TIME THEY ARE BEING FILLED WITH CONCRETE.
 - VERTICAL REINFORCING STEEL SHALL CONFORM TO A.S.T.M. A 432 AND A 305.
 - SPIRAL REINFORCING STEEL SHALL CONFORM TO A.S.T.M. A 82.
 - ALL REINFORCING STEEL SHALL BE WELL SECURED IN PROPER POSITION PRIOR TO POURING CONCRETE.
 - CONCRETE SHALL HAVE A MINIMUM ULTIMATE COMPRESSIVE STRENGTH OF 4,000 P.S.I. AT 28 DAY TEST. COARSE AGGREGATE SHALL BE HARDROCK, USING A 3/4" MAXIMUM SIZE.

PILE NOTES

SCALE
NONE

2

Pile Cap Tie Schedule

(A)

Mark		Dimensions		Reinforcing	Ties
Present	Future	(A)	(B)		
T1	F-71	12"	10"	A - #7 CONT.	#5 @ 12"
T2	F-72	12"	10"	A - #8 CONT.	do
T3	F-73	12"	10"	A - #9 CONT.	do
T4	F-74	12"	10"	A - #10 CONT.	do
T5	---	15"	45"	A - #11 CONT.	do
T6	---	15"	45"	A - #10 CONT.	do
T7	---	20"	39"	C - #11 CONT.	do
T8	---	15"	45"	C - #11 CONT.	do
T9	---	20"	39"	B - #11 CONT.	do

Bottom of sand on top of compacted fill.

*NOTE I

Future pile cap ties are indicated on each foundation plan. Provide dowels as scheduled and detailed. Cover dowels with a thick coat of bitumen type paint, wrap with 2-layers of 15# felt and tie with wire mesh, typical.

Forming of Pile Cap Ties may be omitted if width (B) is increased 2" and polyvinylchloride sheathing is used to line the excavation as shown - typical.

Typical Section

(B)

SECTION SCALE 1/8" = 1'-0" **TYP. FIRST FLR. & FOUNDATION PLAN** SCALE 1/8" = 1'-0" **TYP. PILE DETAIL** SCALE 1/4" = 1'-0" **TYP. PILE CAP TIE** SCALE 1/4" = 1'-0"

STRUCTURAL ENGINEERS
BRANDOW & JOHNSTON
J.A. MARTIN & ASSOCIATES

MECHANICAL ENGINEERS
RALPH E. PHILLIPS, INC.

ELECTRICAL ENGINEERS
RALPH E. PHILLIPS, INC.

CIVIL ENGINEERS
G. SHUURMAN & ASSOCIATES
MOFFATT & NICHOL

DESIGNED
A.C.N.

DRAWN BY
C.D.

CHECKED BY
I.P.

ARCHITECT
WILLIAM L. FERRERA
A. QUINCY JONES-FREDERICK R. EMMONS & ASSOCIATES
BLUROCK ELLERBROCK & ASSOCIATES

APPROVED
DATE OF REVIEW: 6/1/65

URBANUS SQUARE
TELEPHONE 714/675-2640

MACARTHUR BOULEVARD AT FORD ROAD
CORONA DEL MAR, CALIFORNIA












GOLDEN WEST COLLEGE
HUNTINGTON BEACH, CALIFORNIA
ORANGE COAST JUNIOR COLLEGE DISTRICT


TYPICAL
FIRST FLR. & FOUNDATION DETAILS


JOB NO.
10041

DATE
6 MAY 1965

SHEET NO.
S 2.1

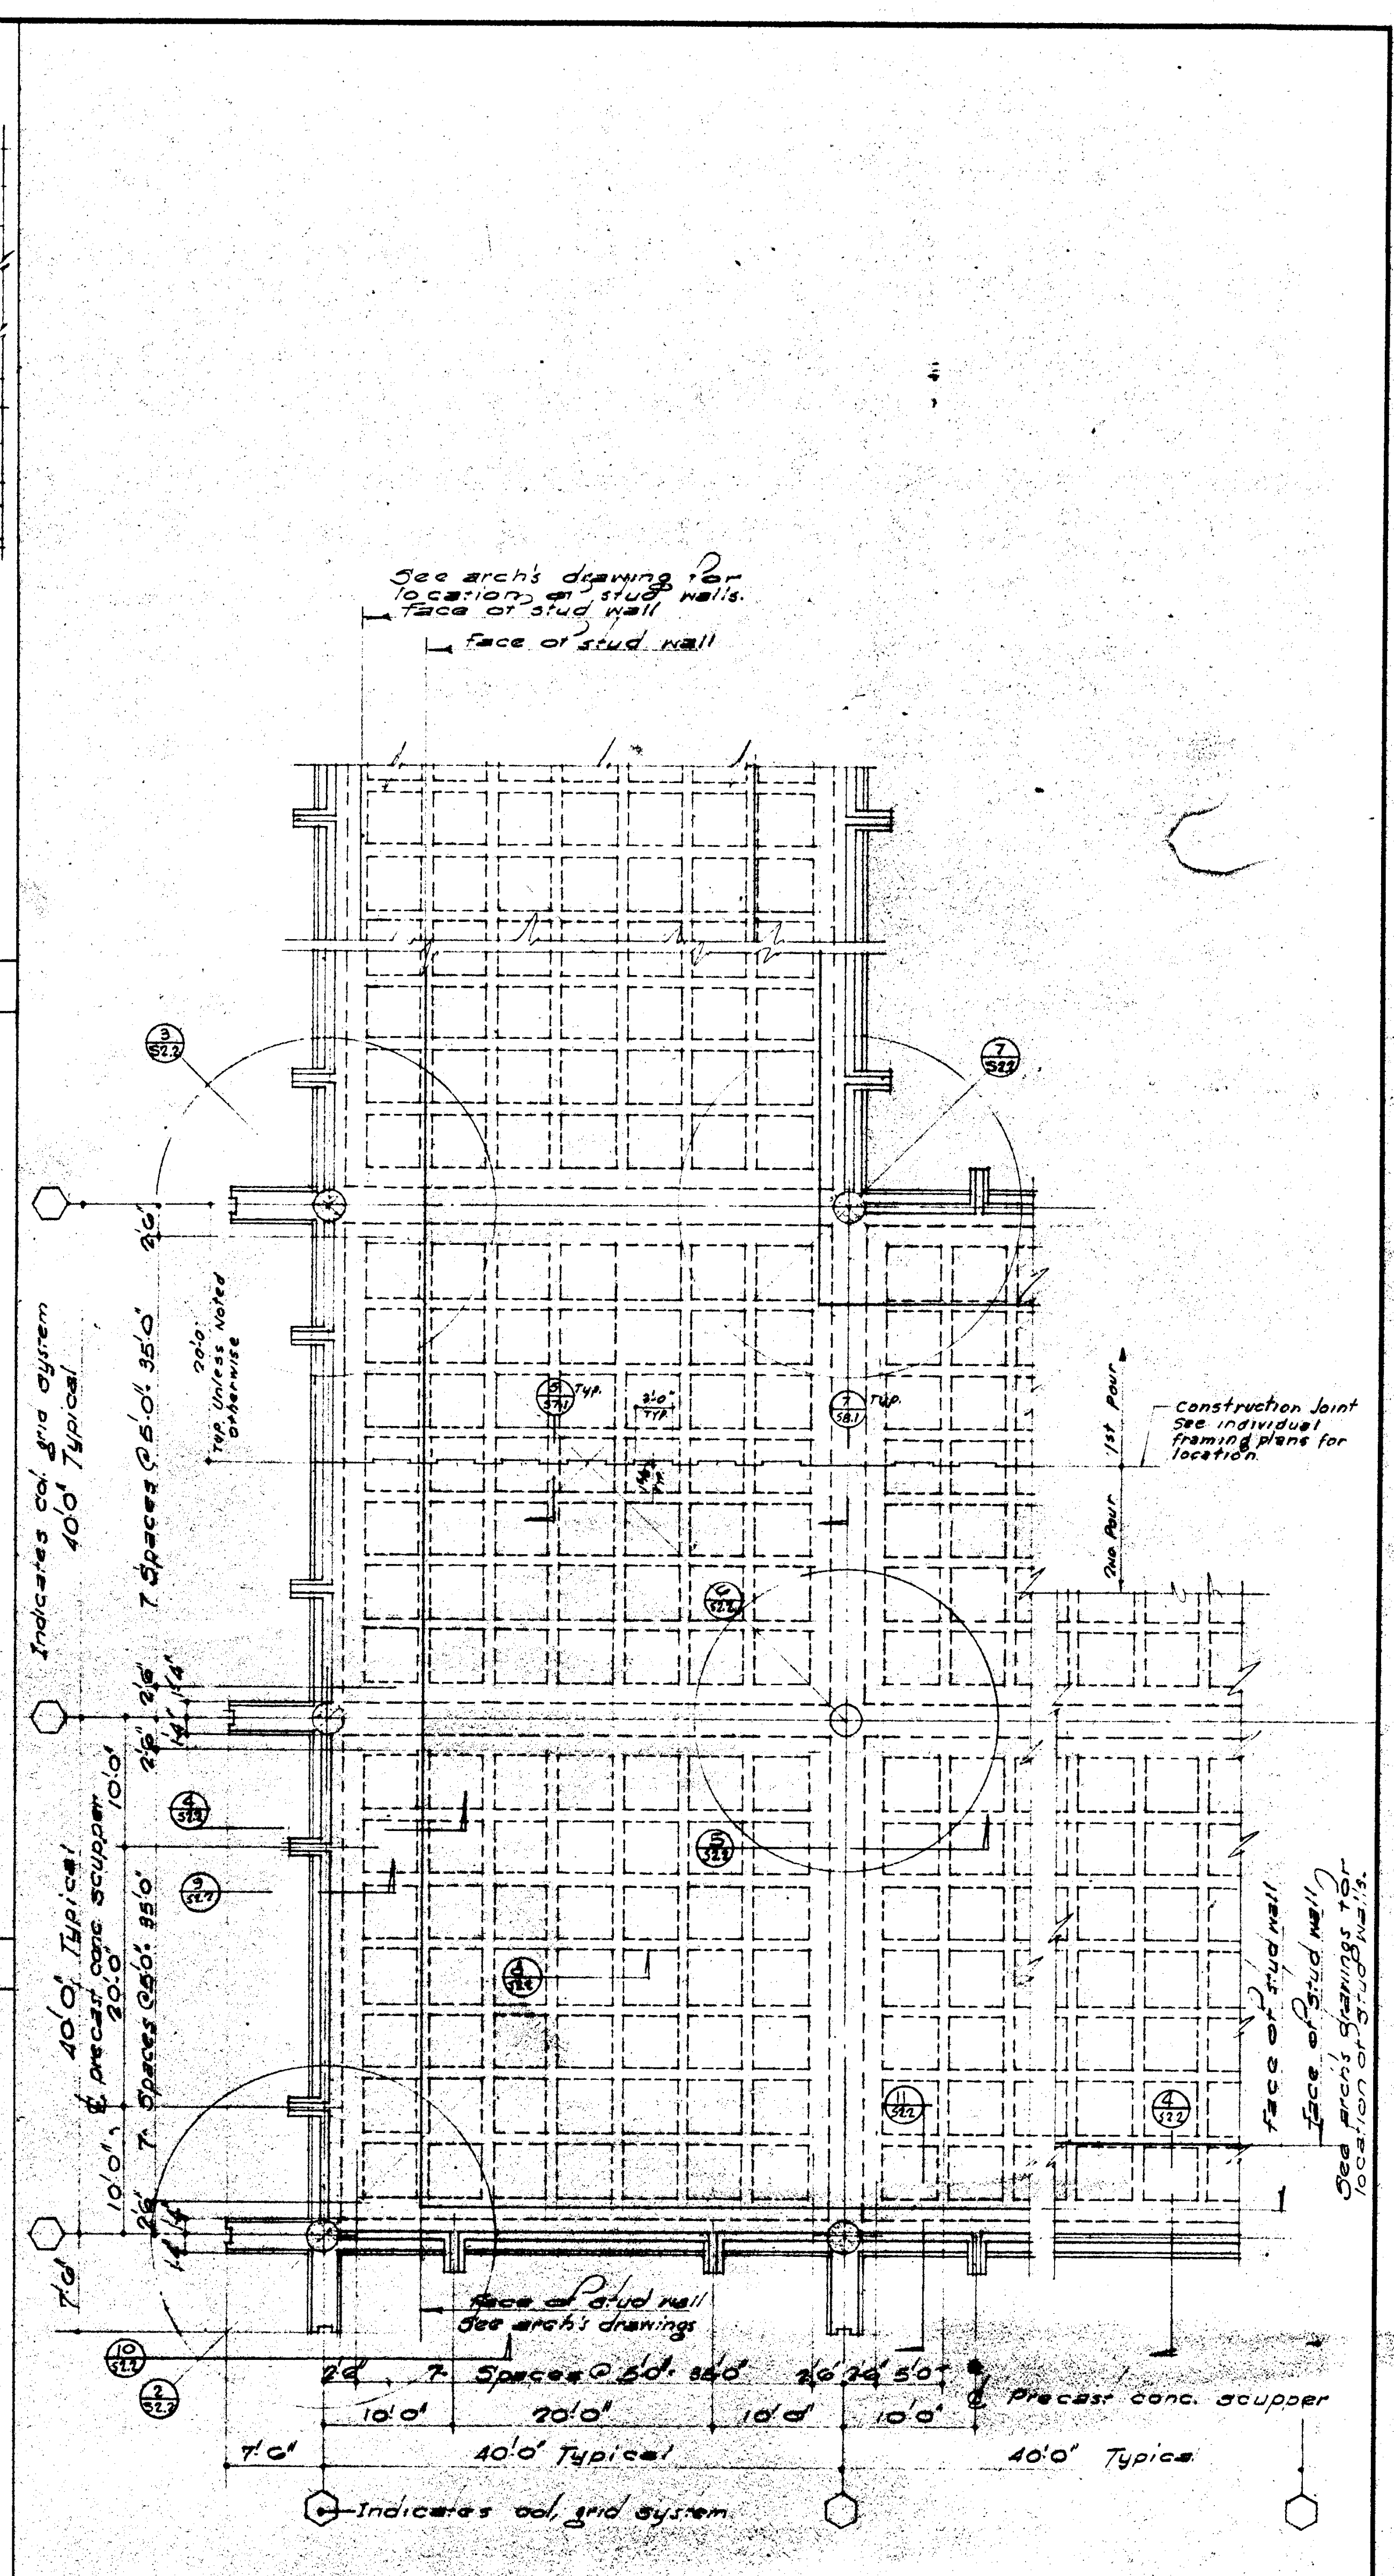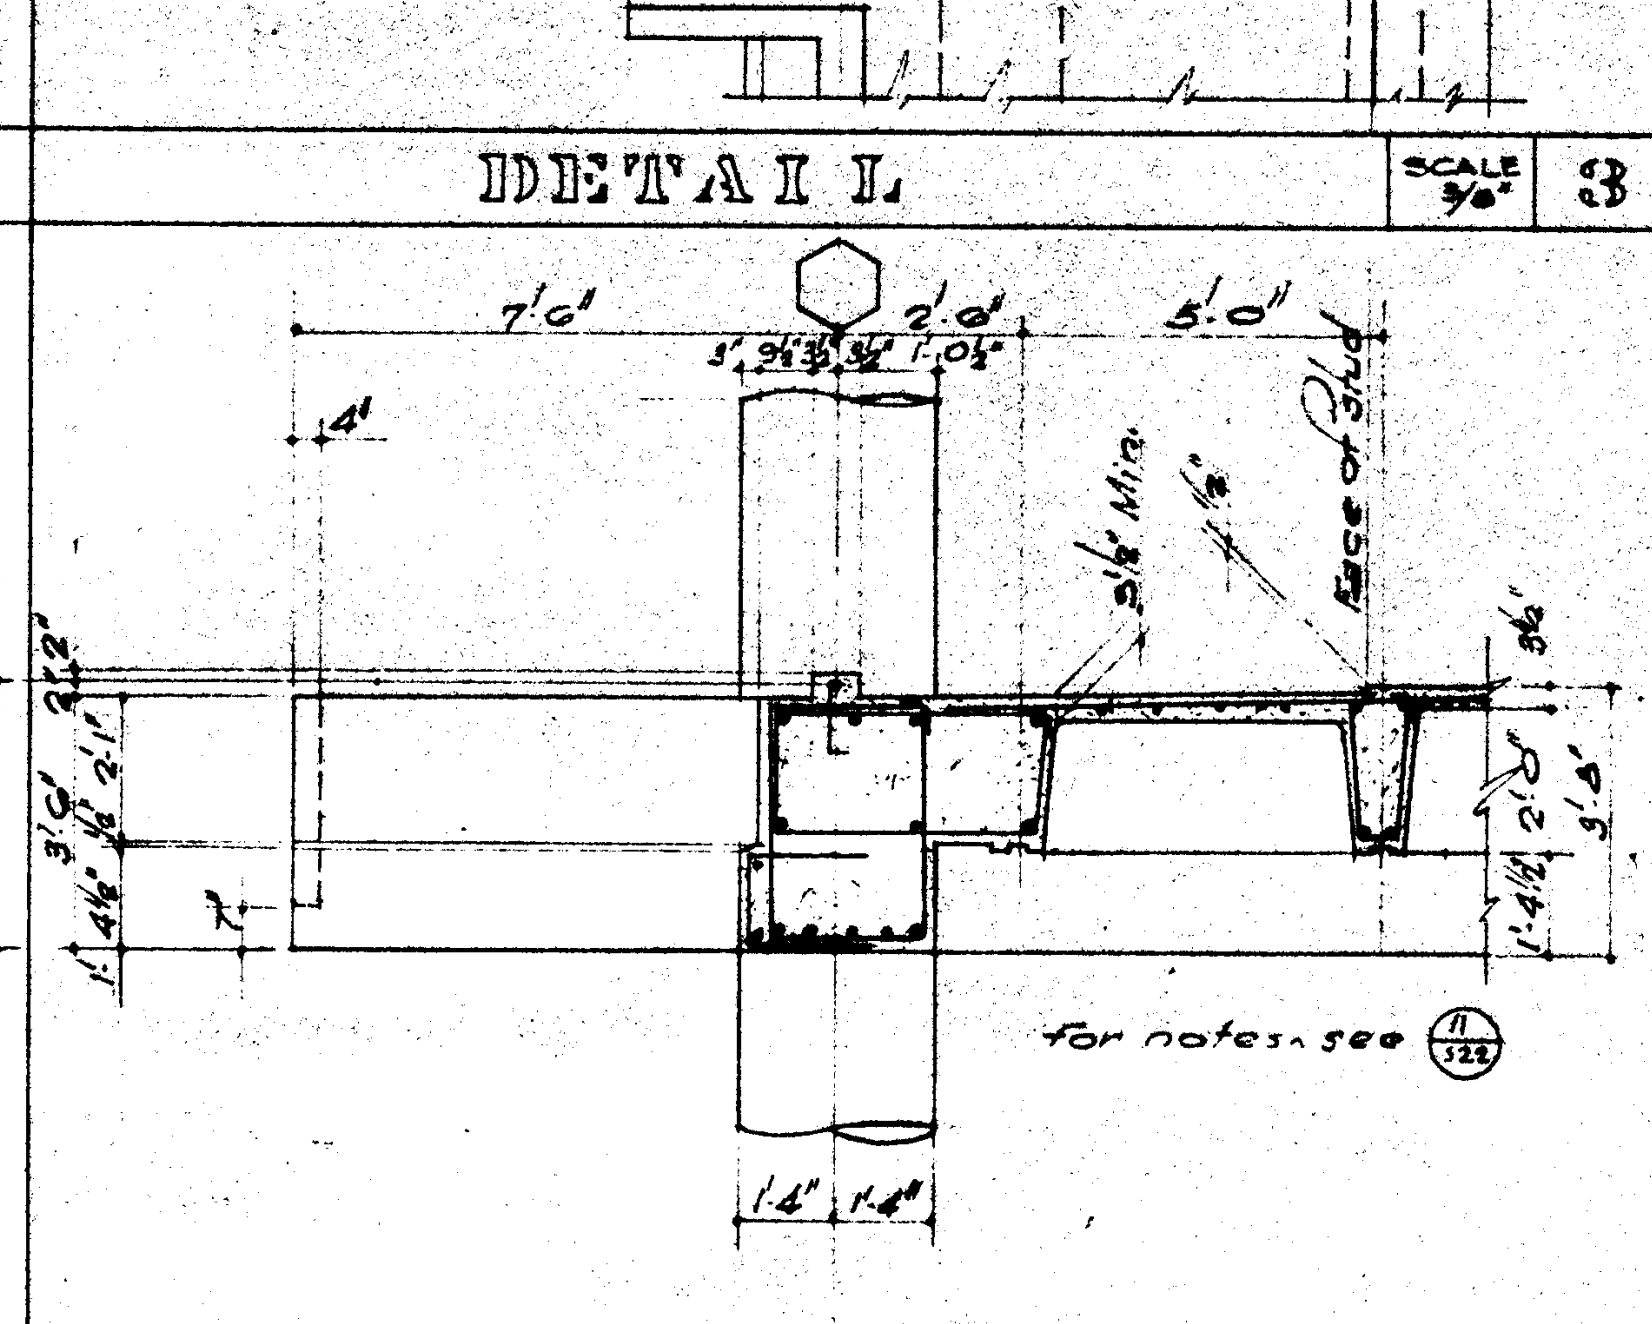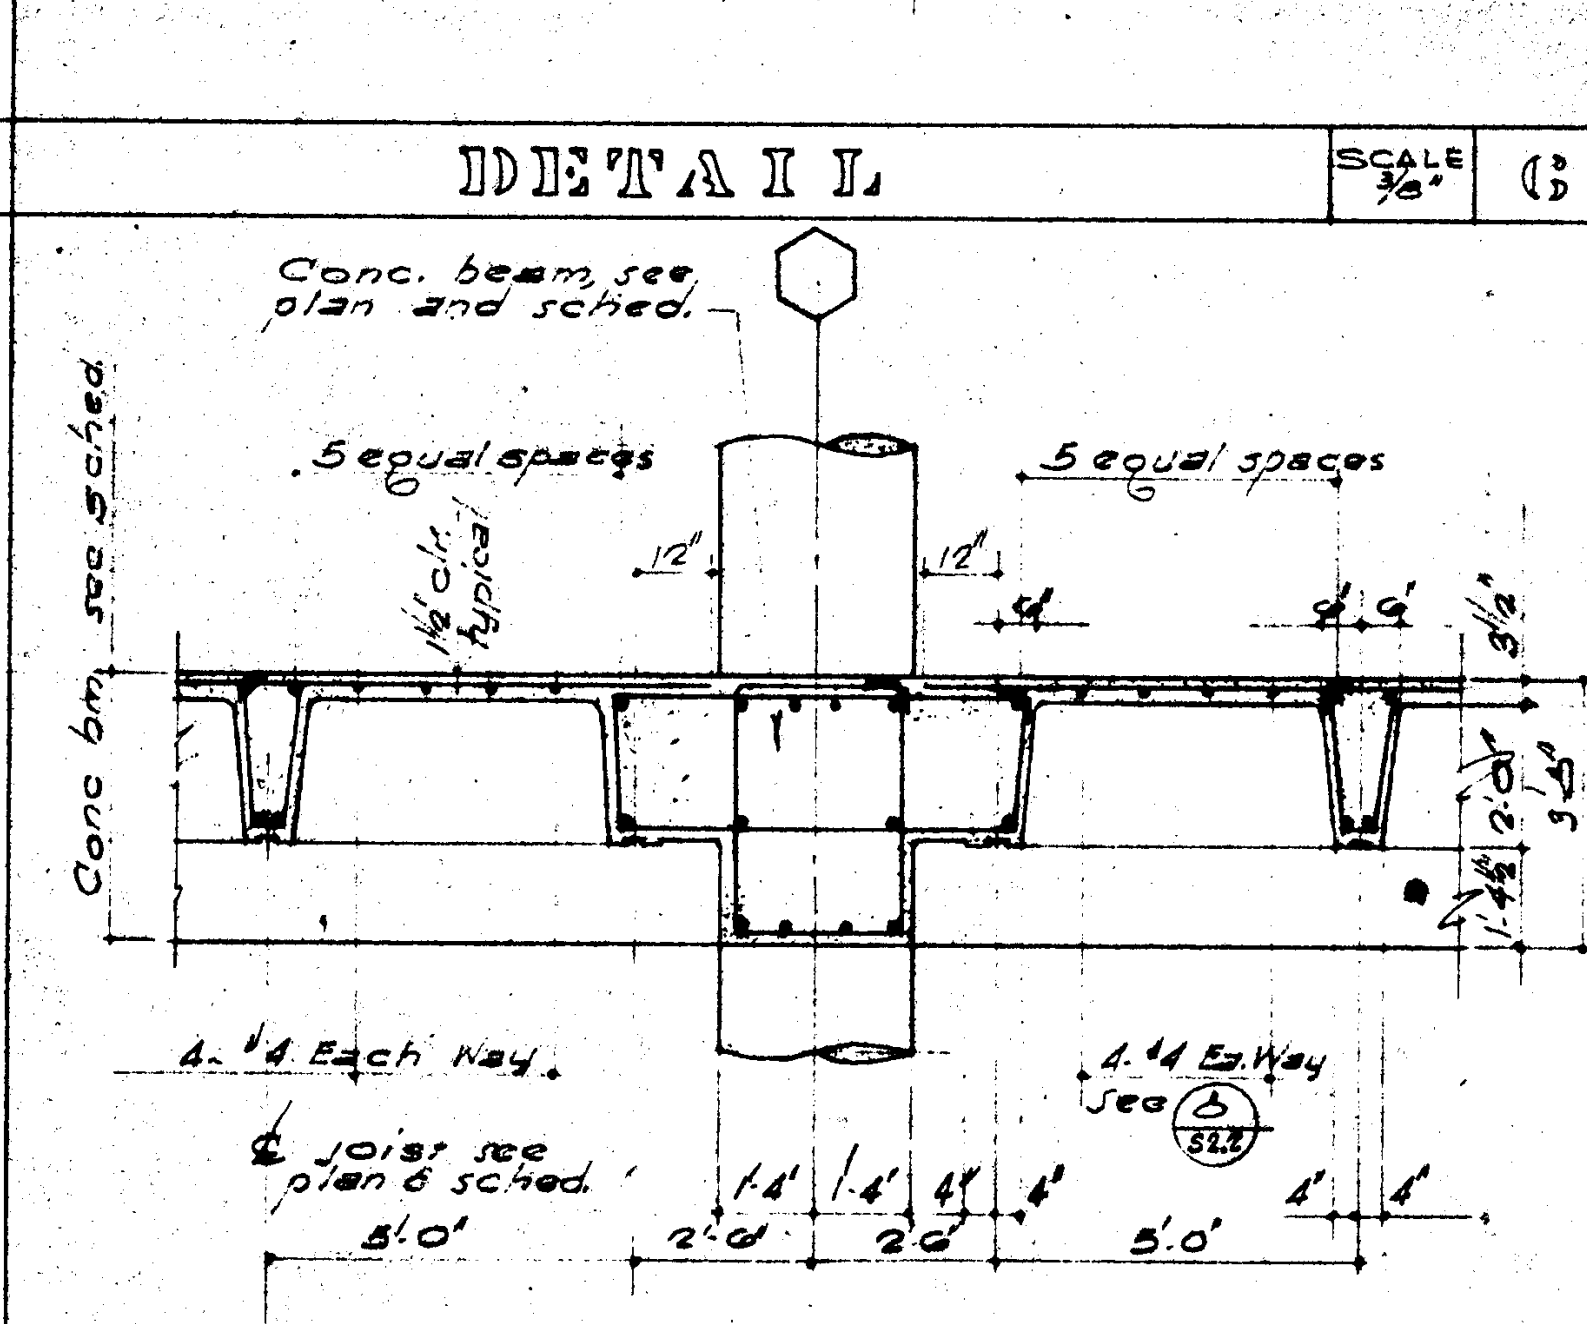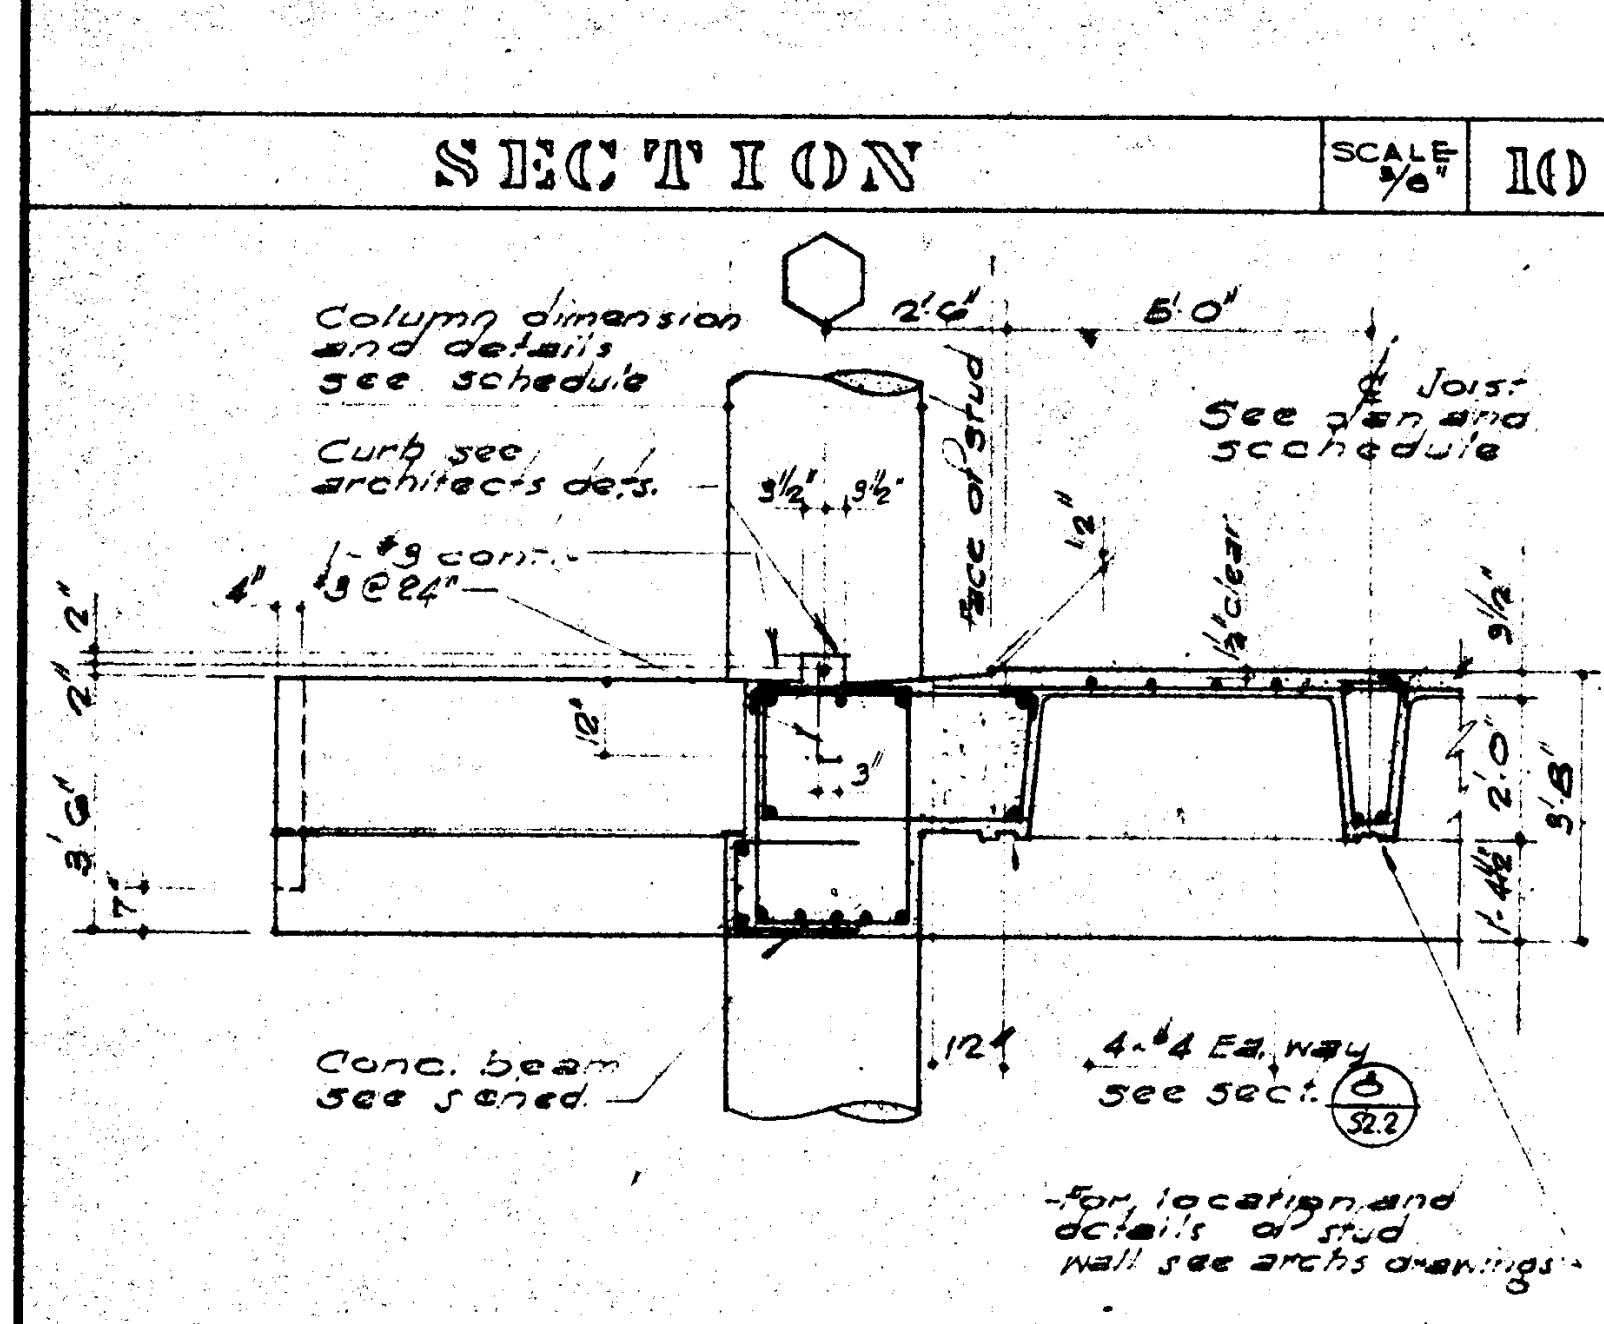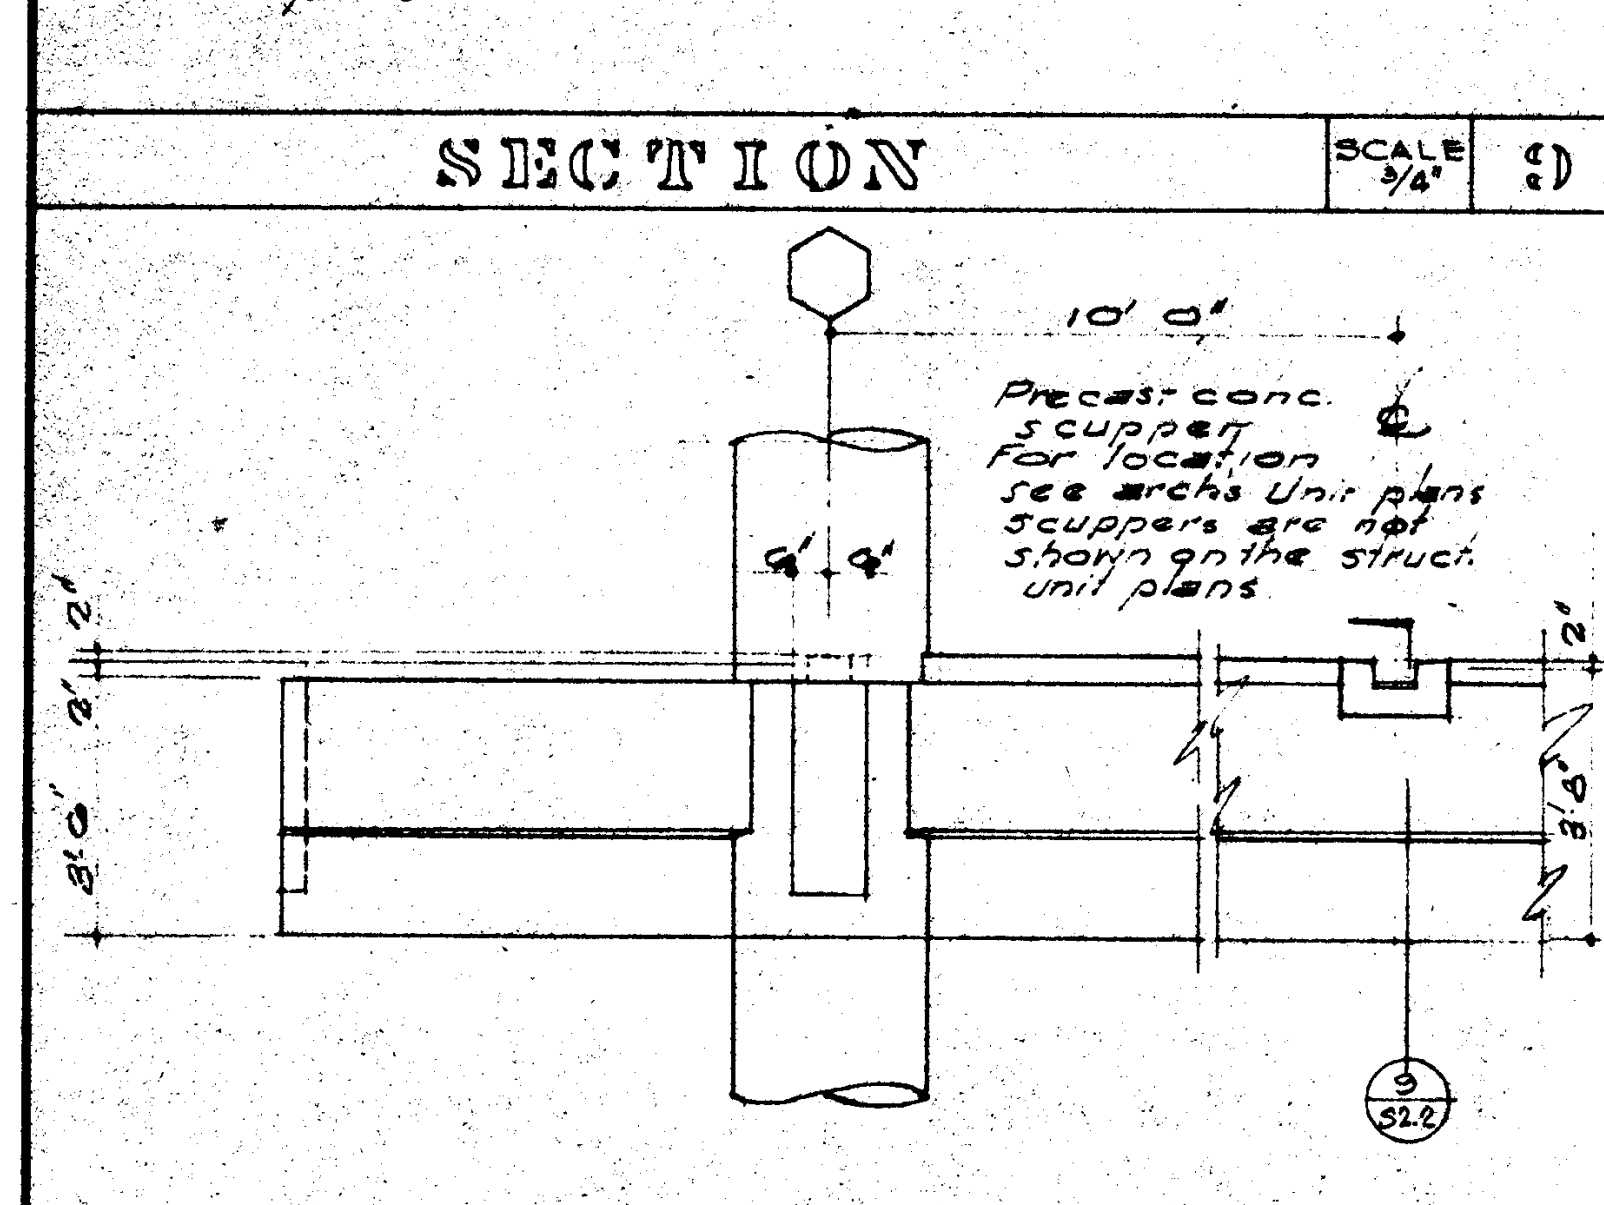
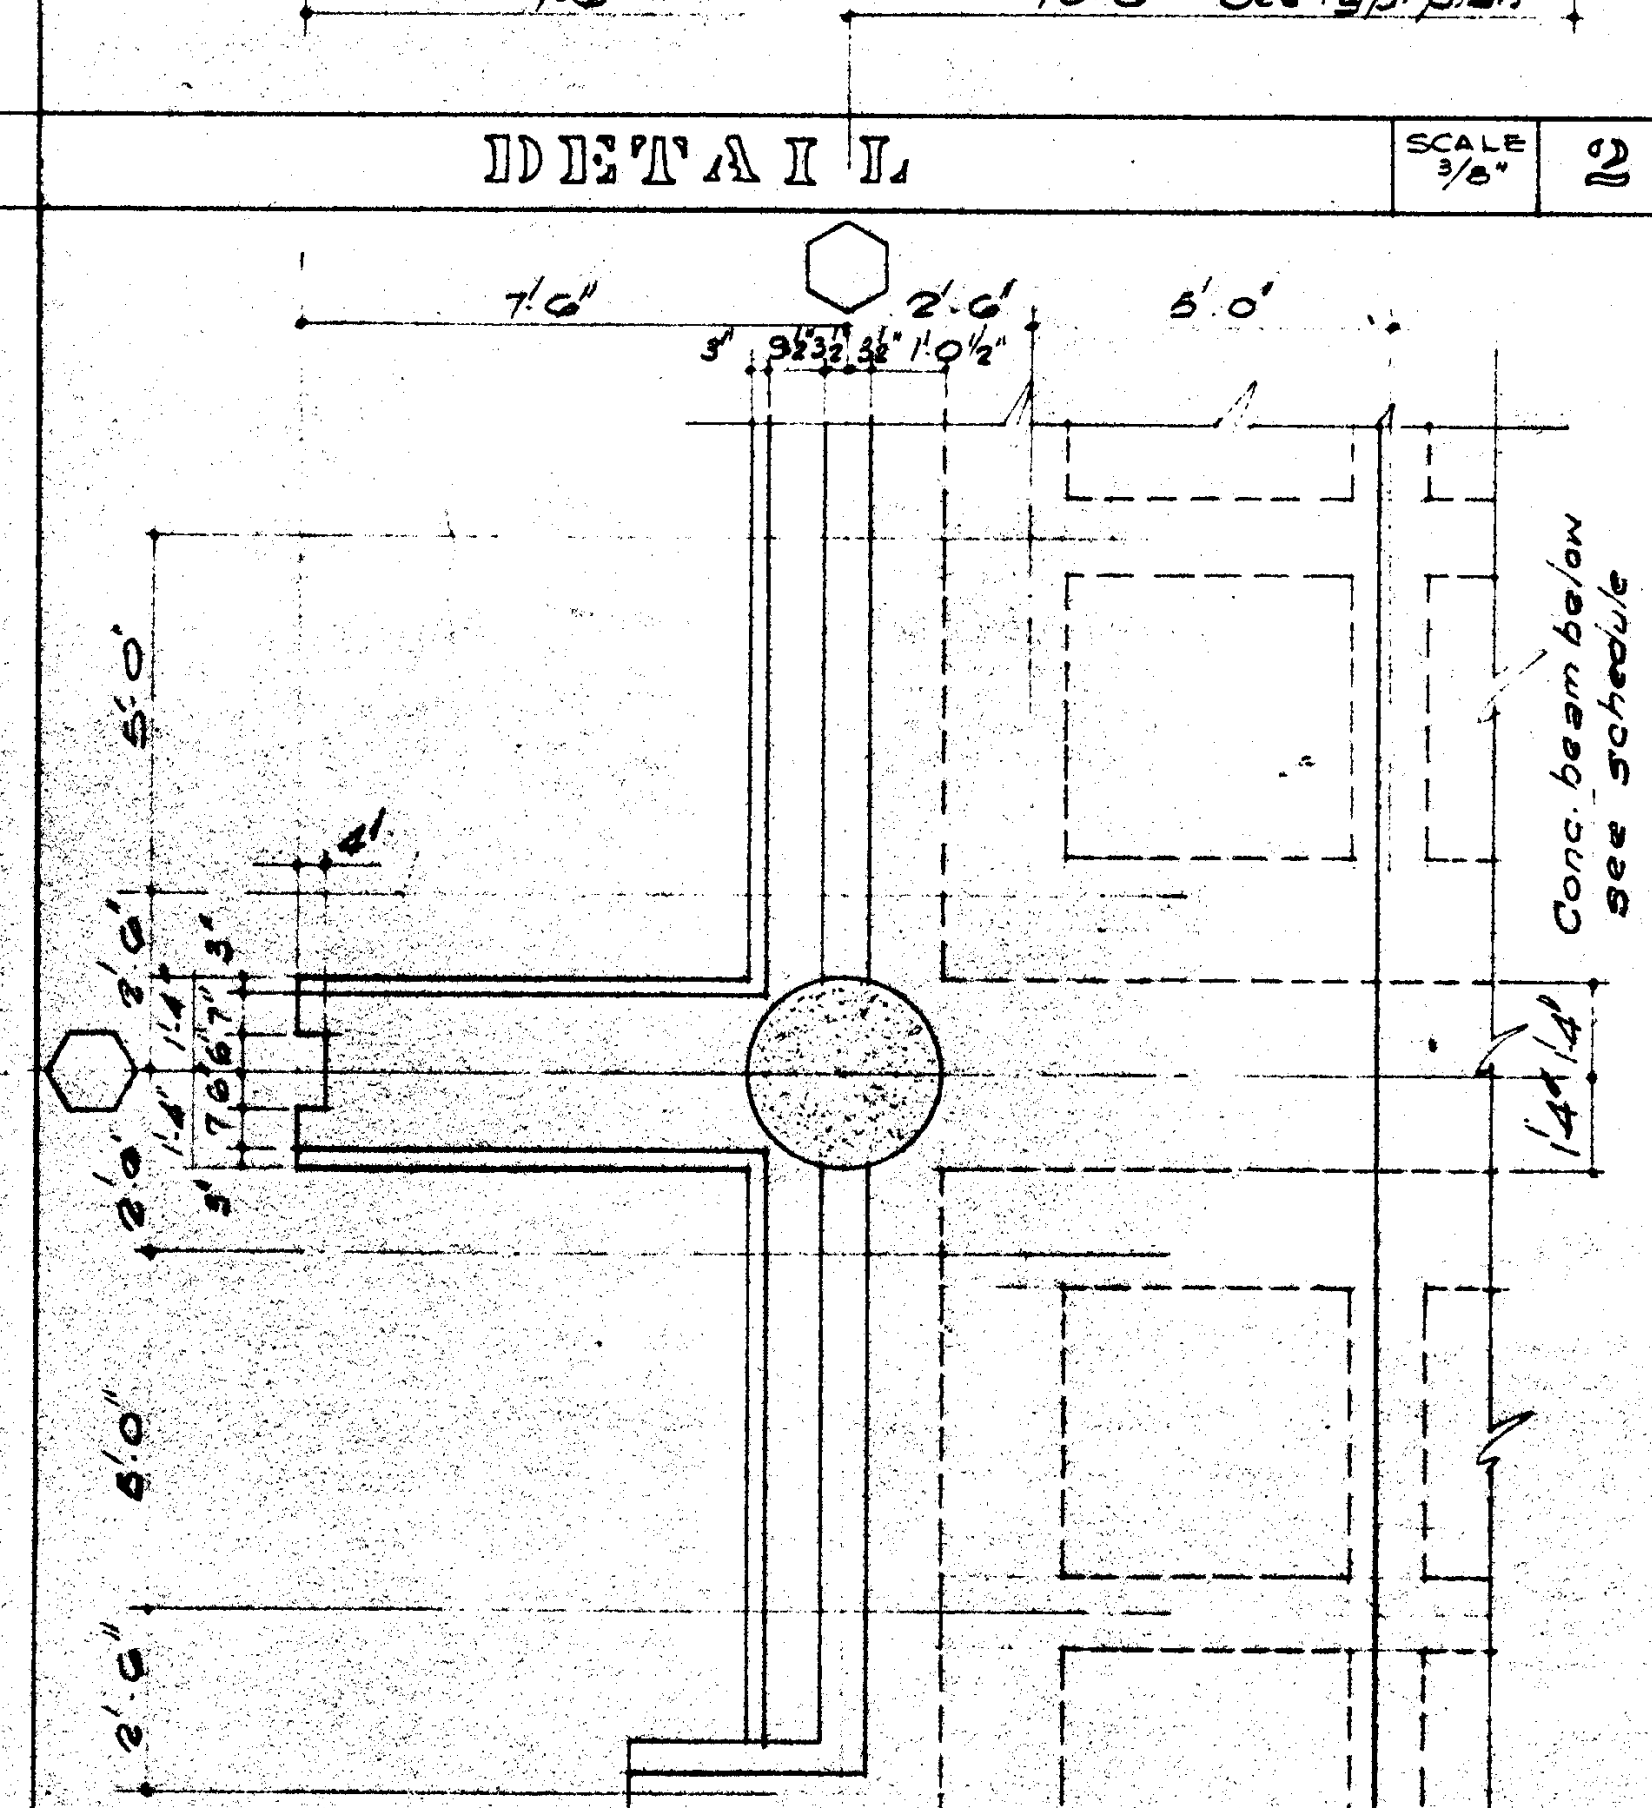
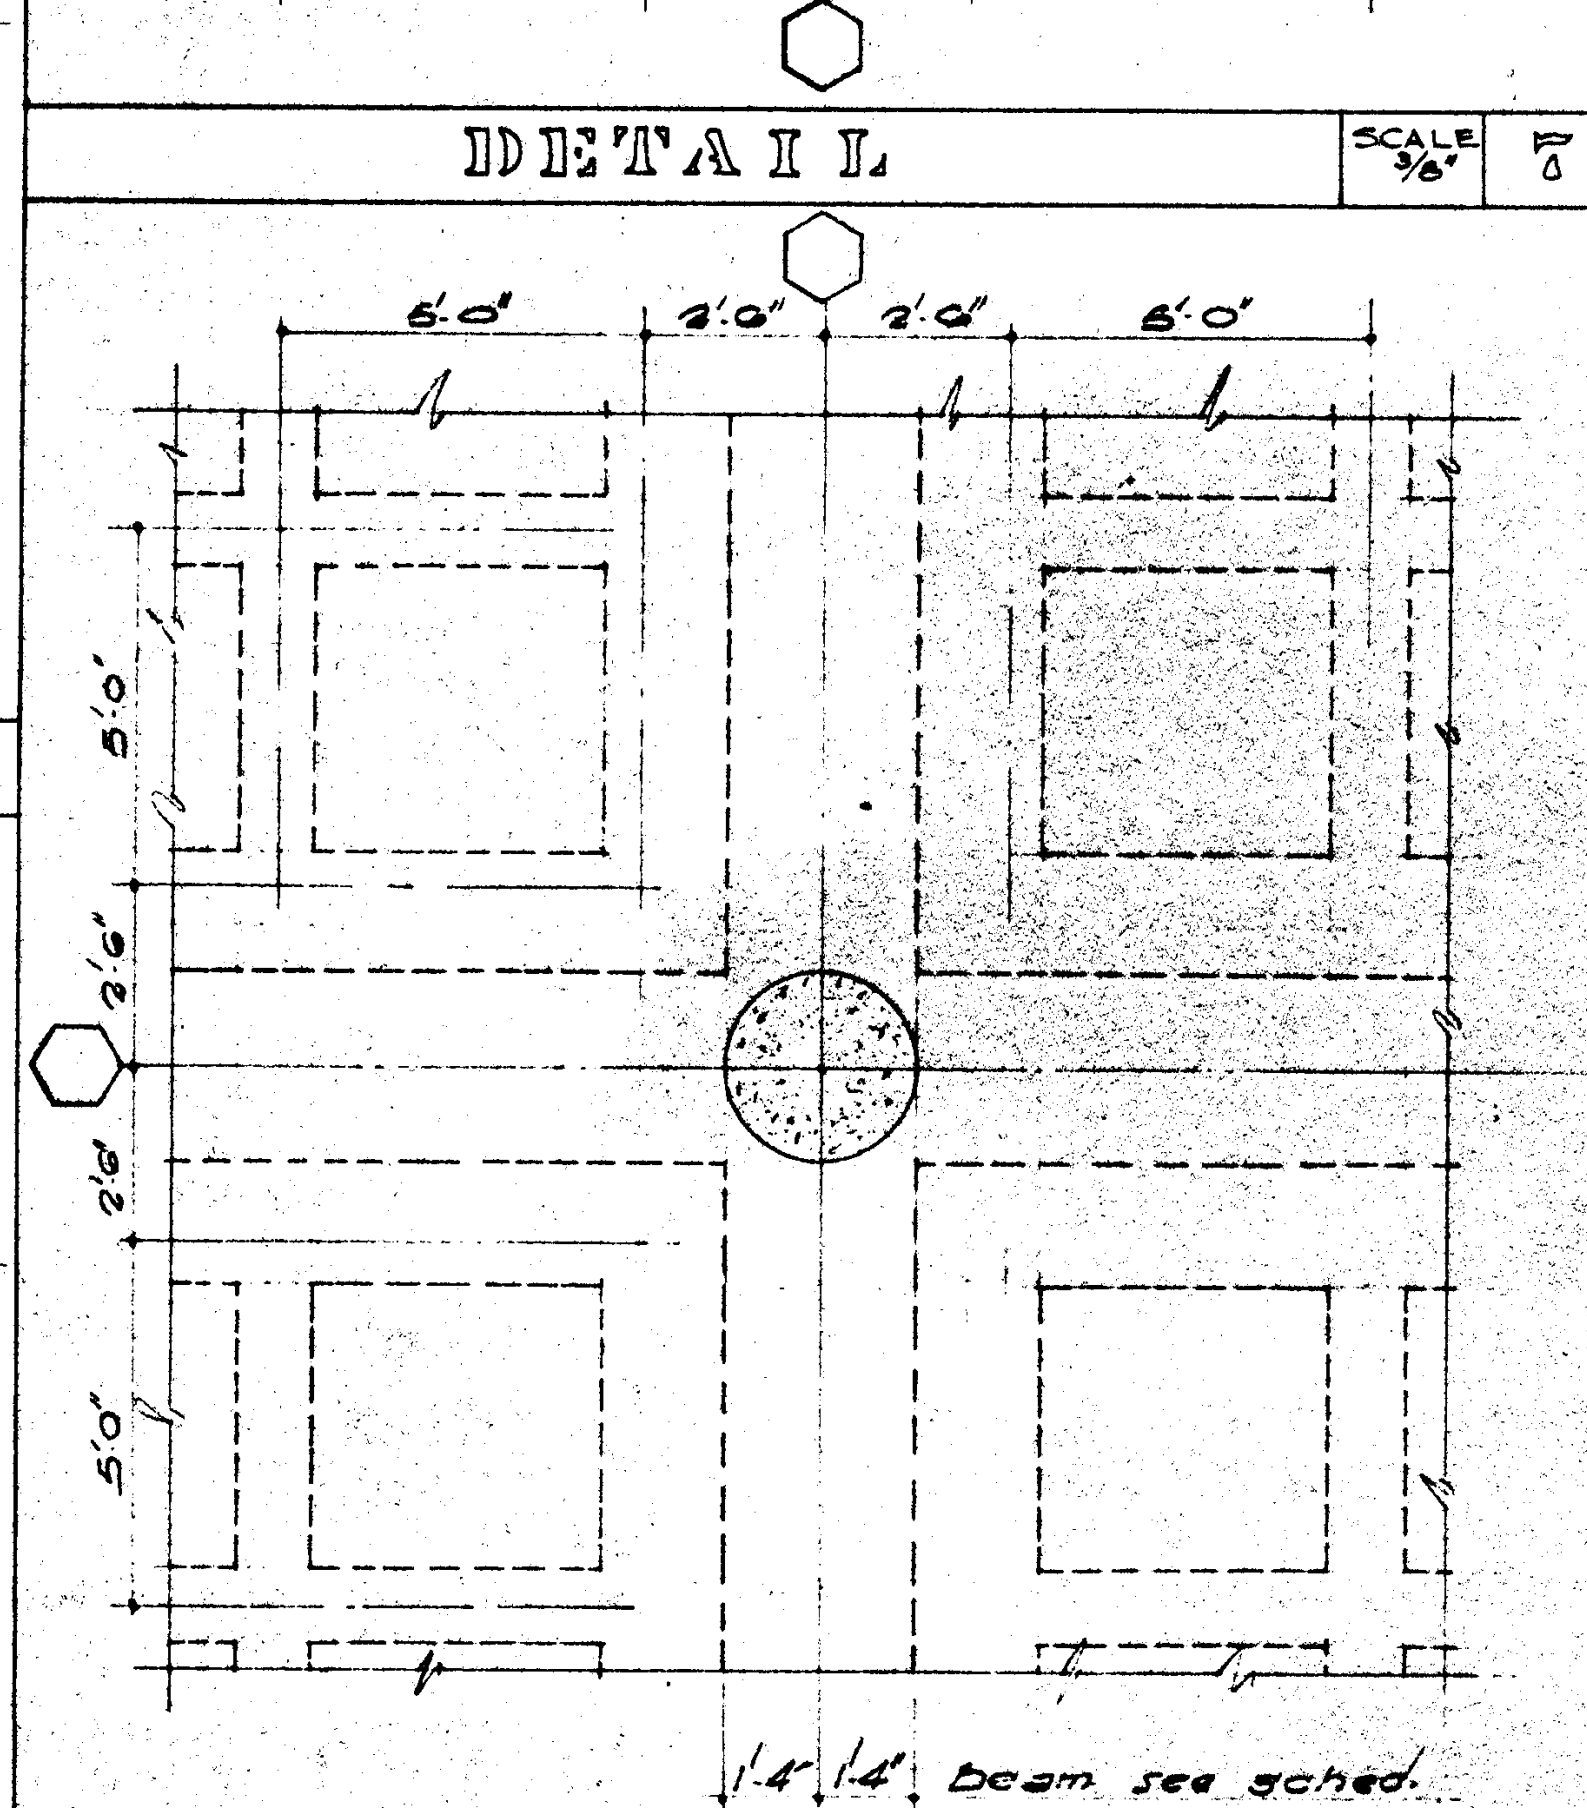
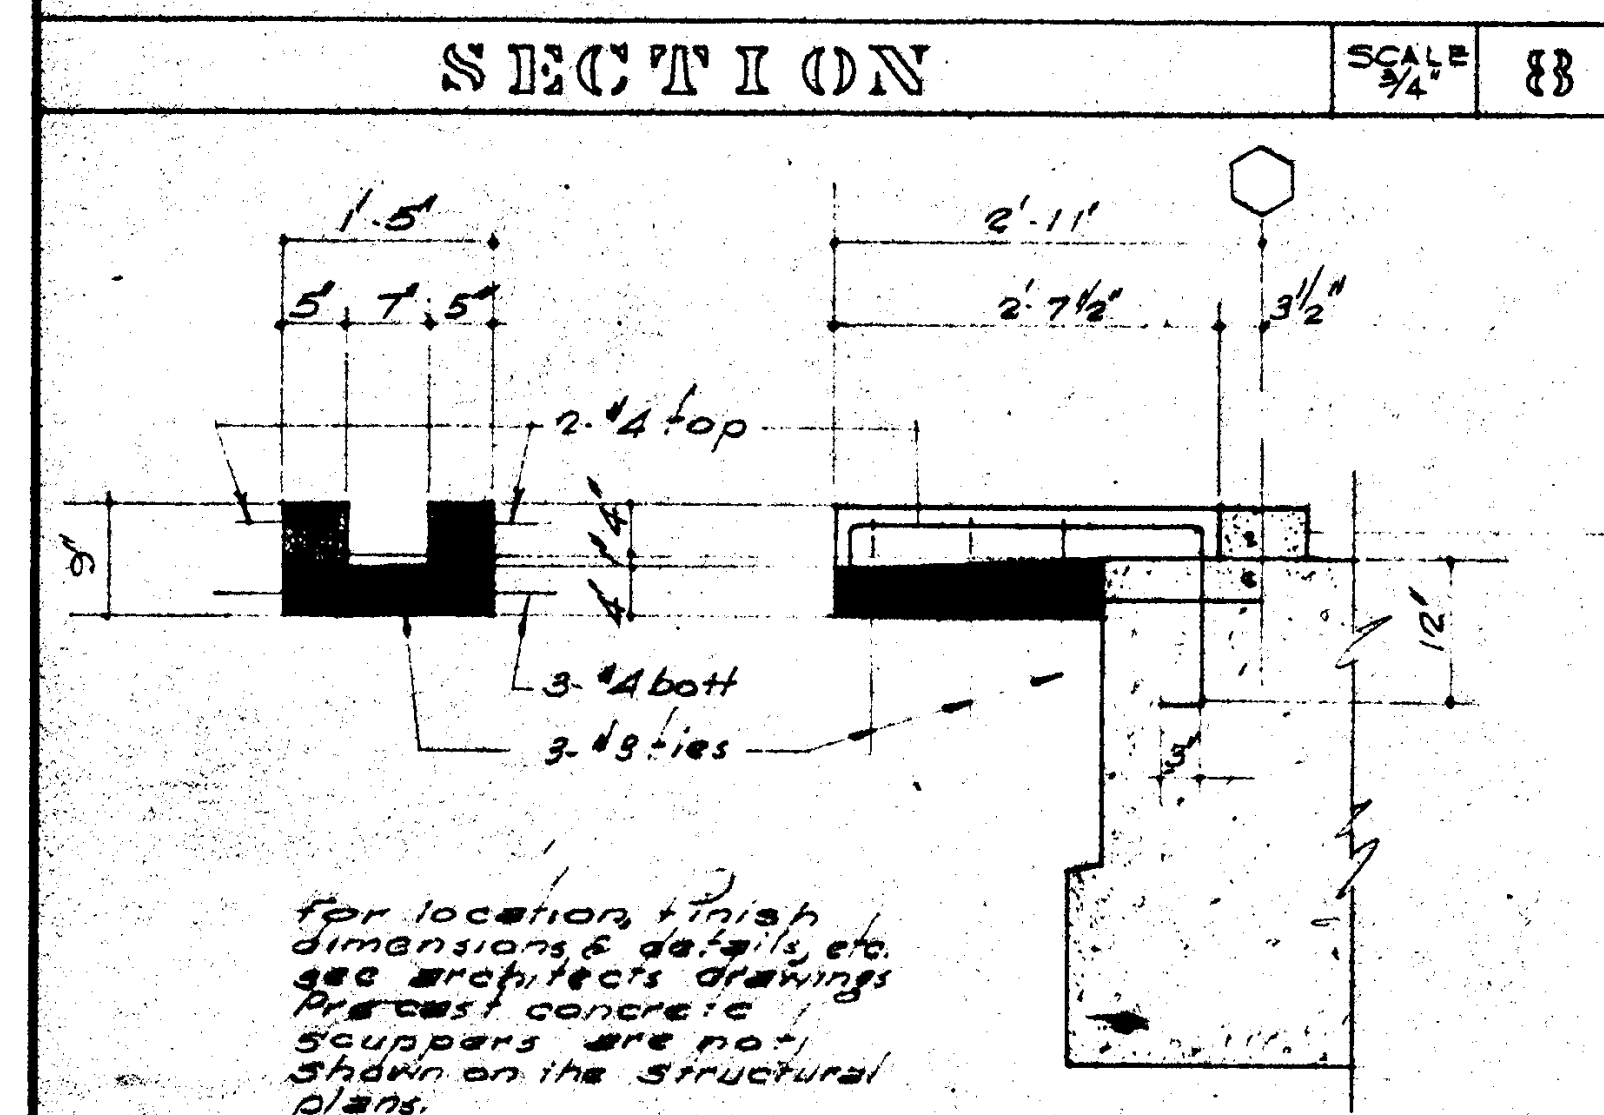
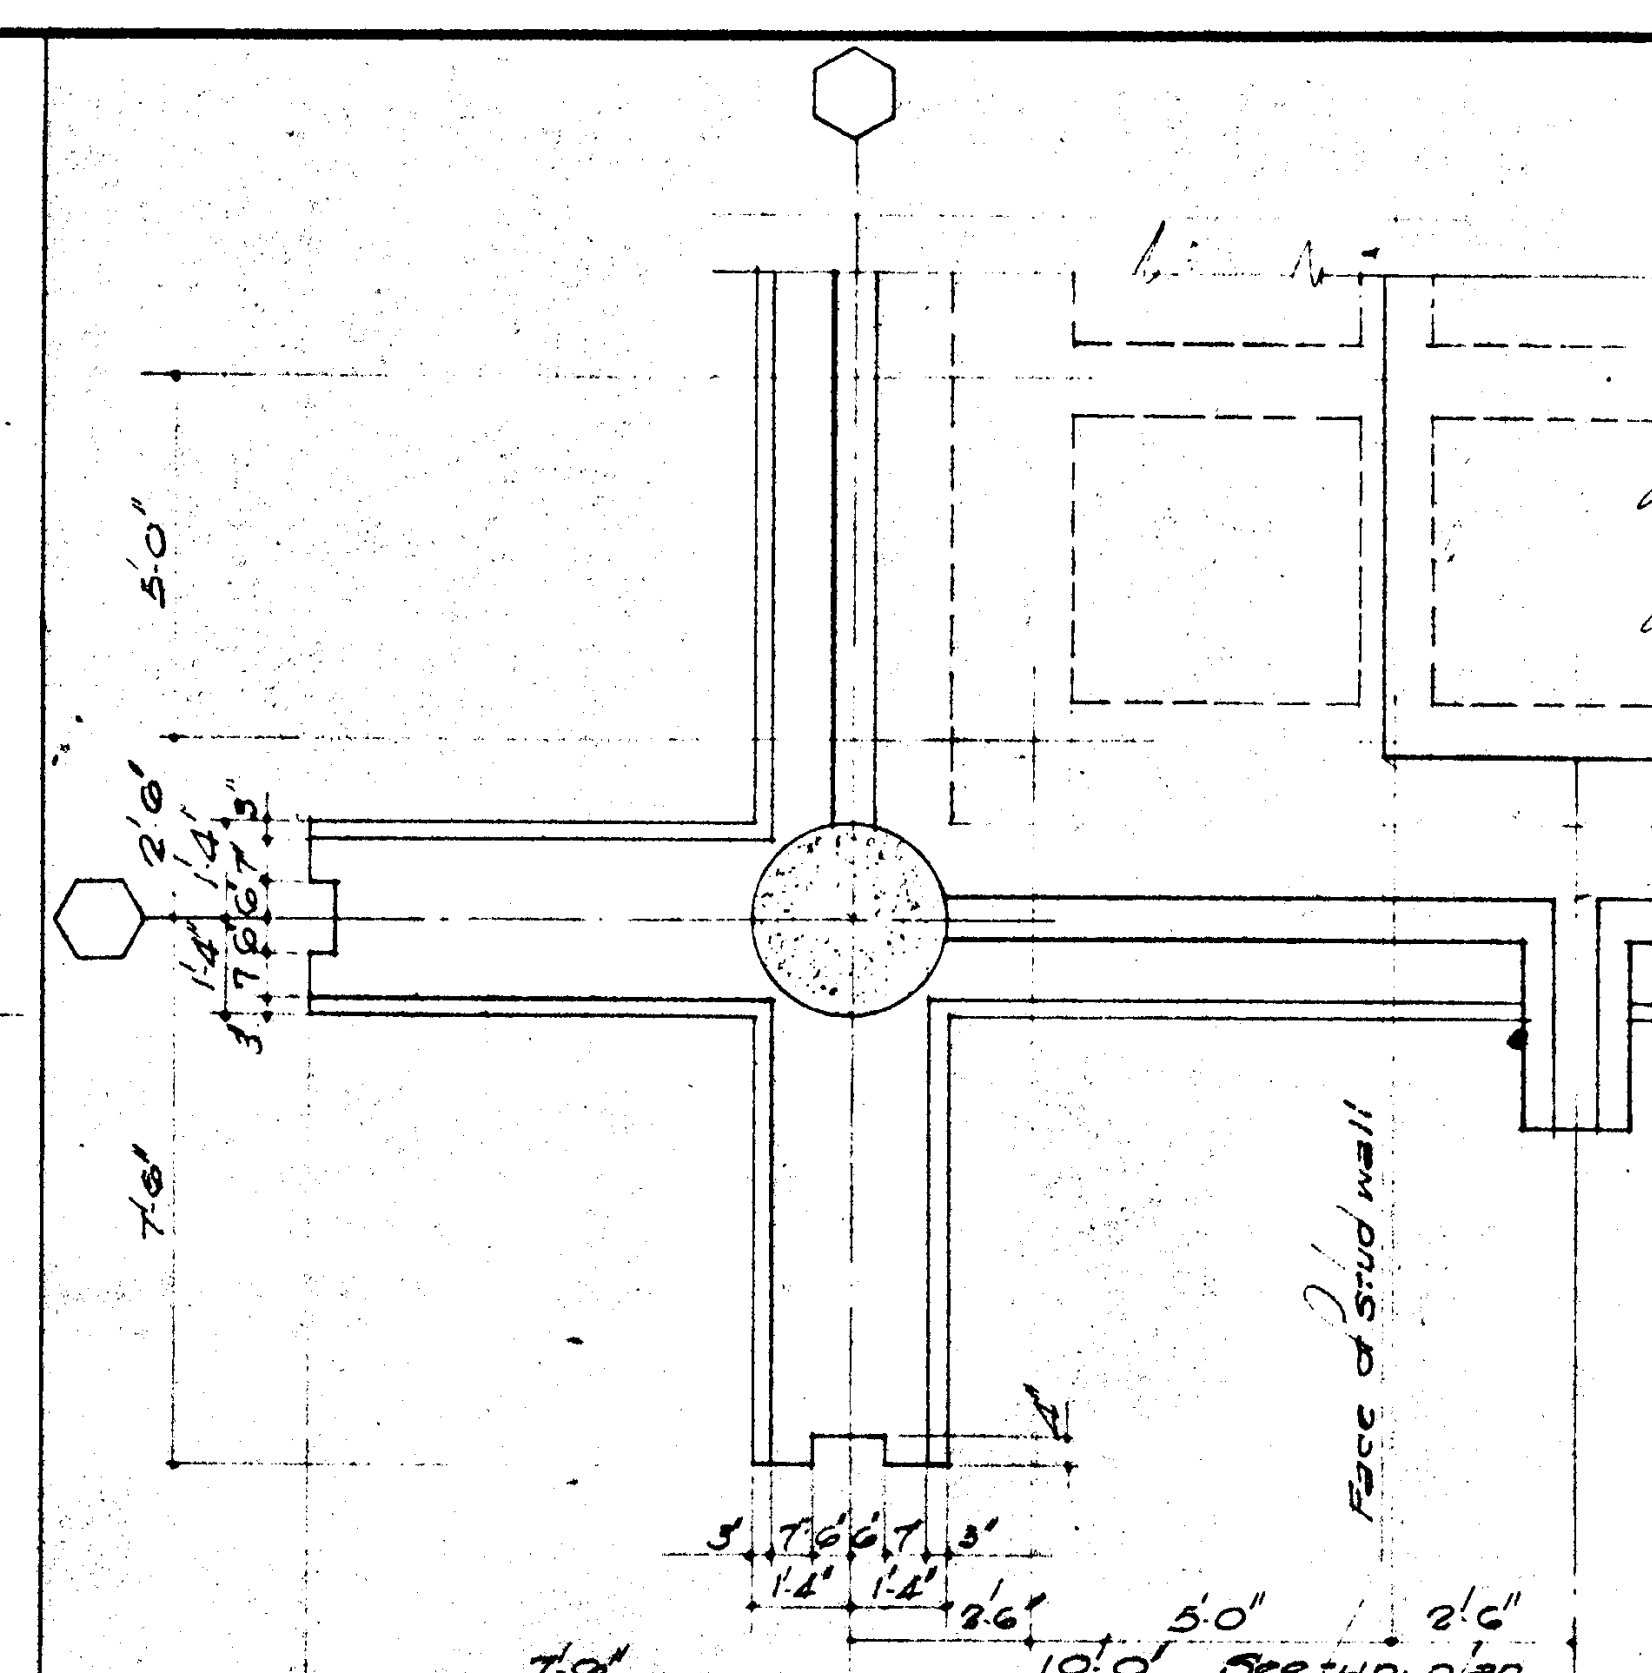
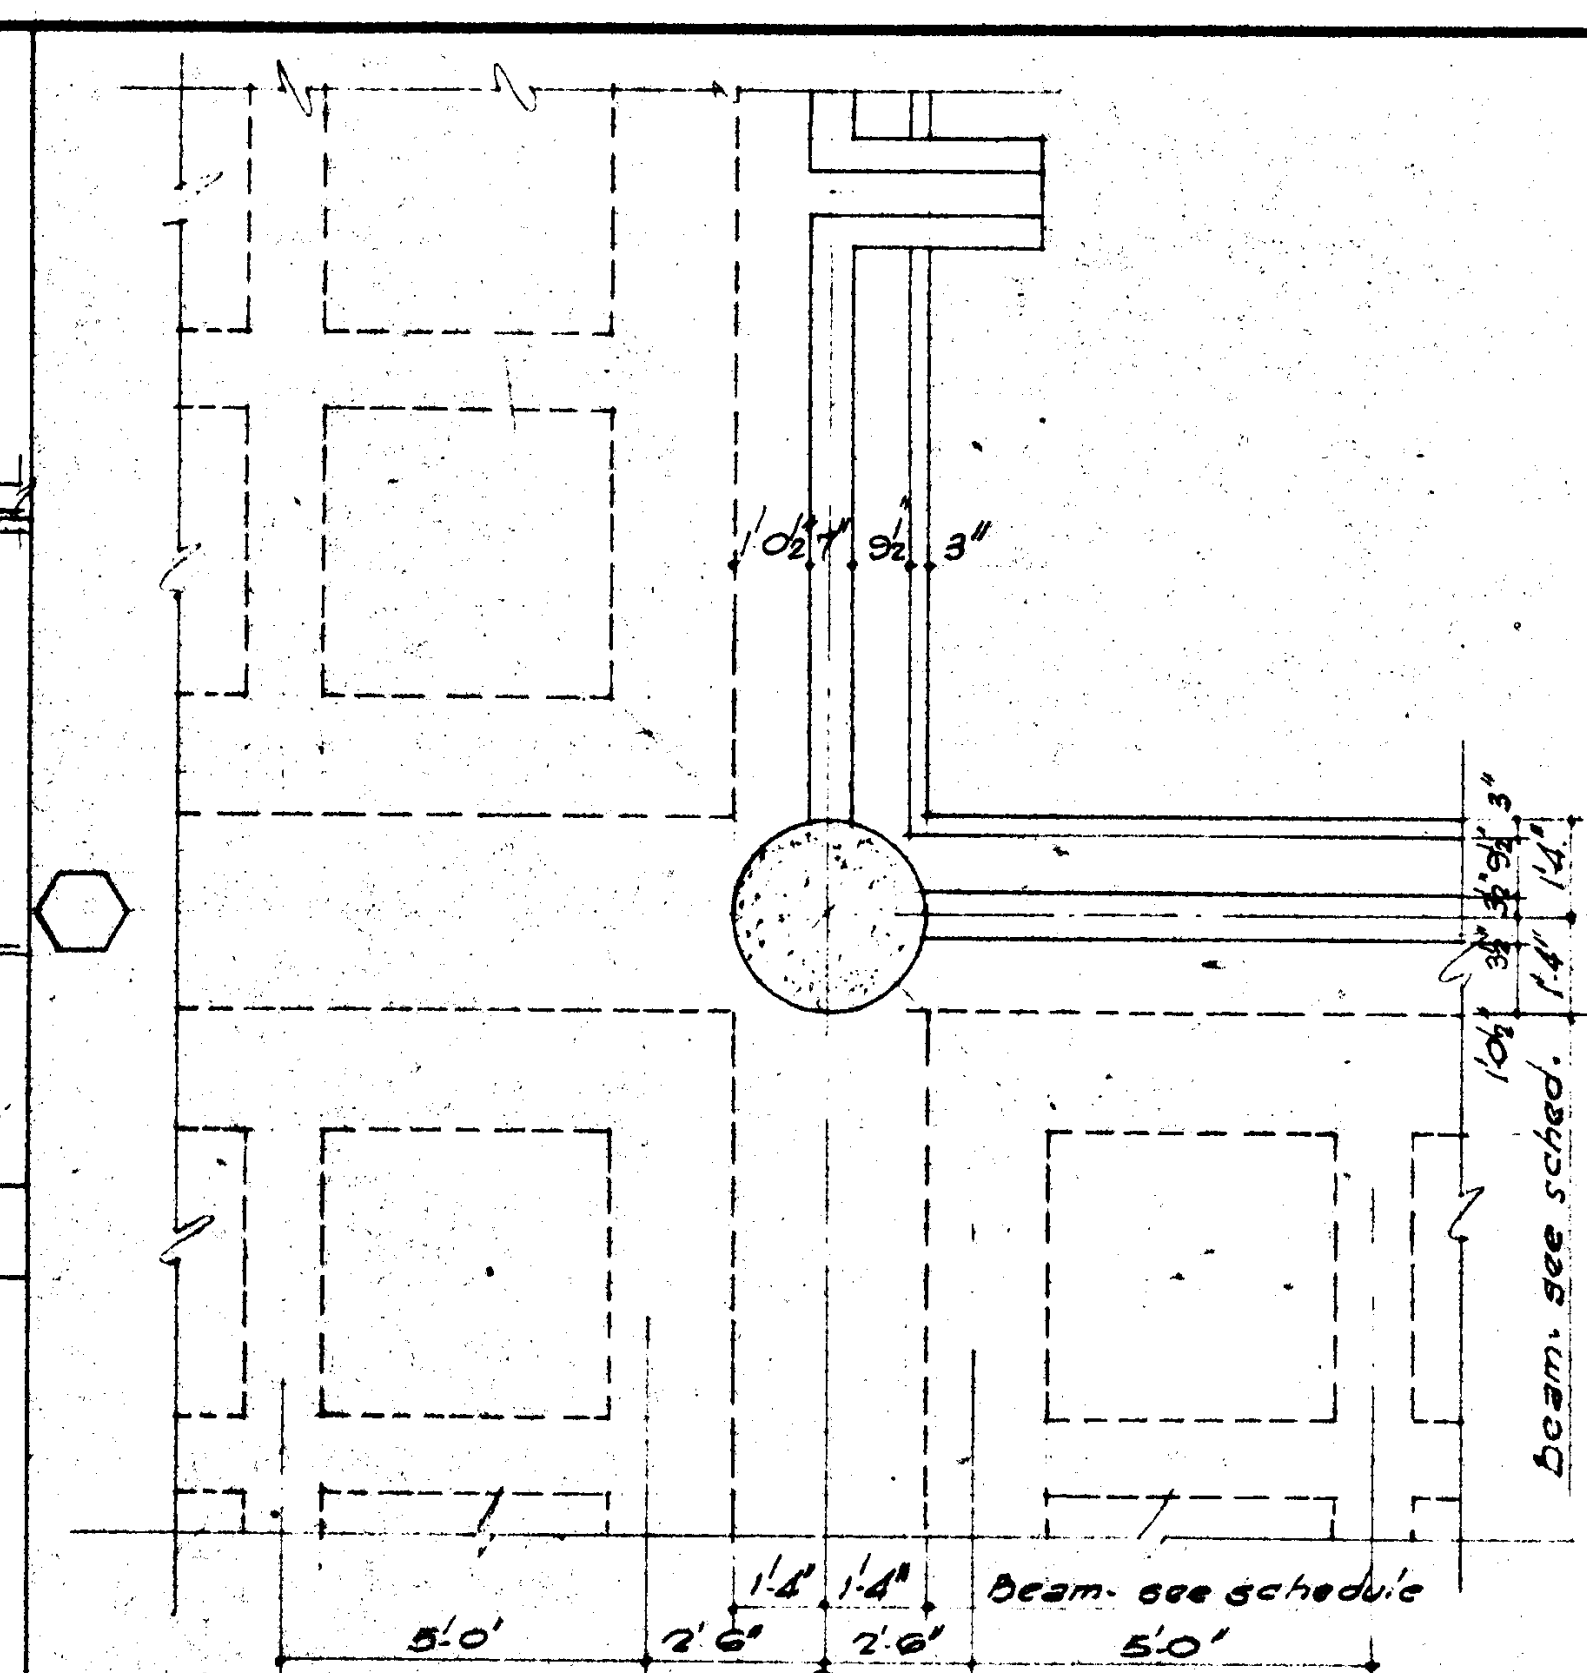
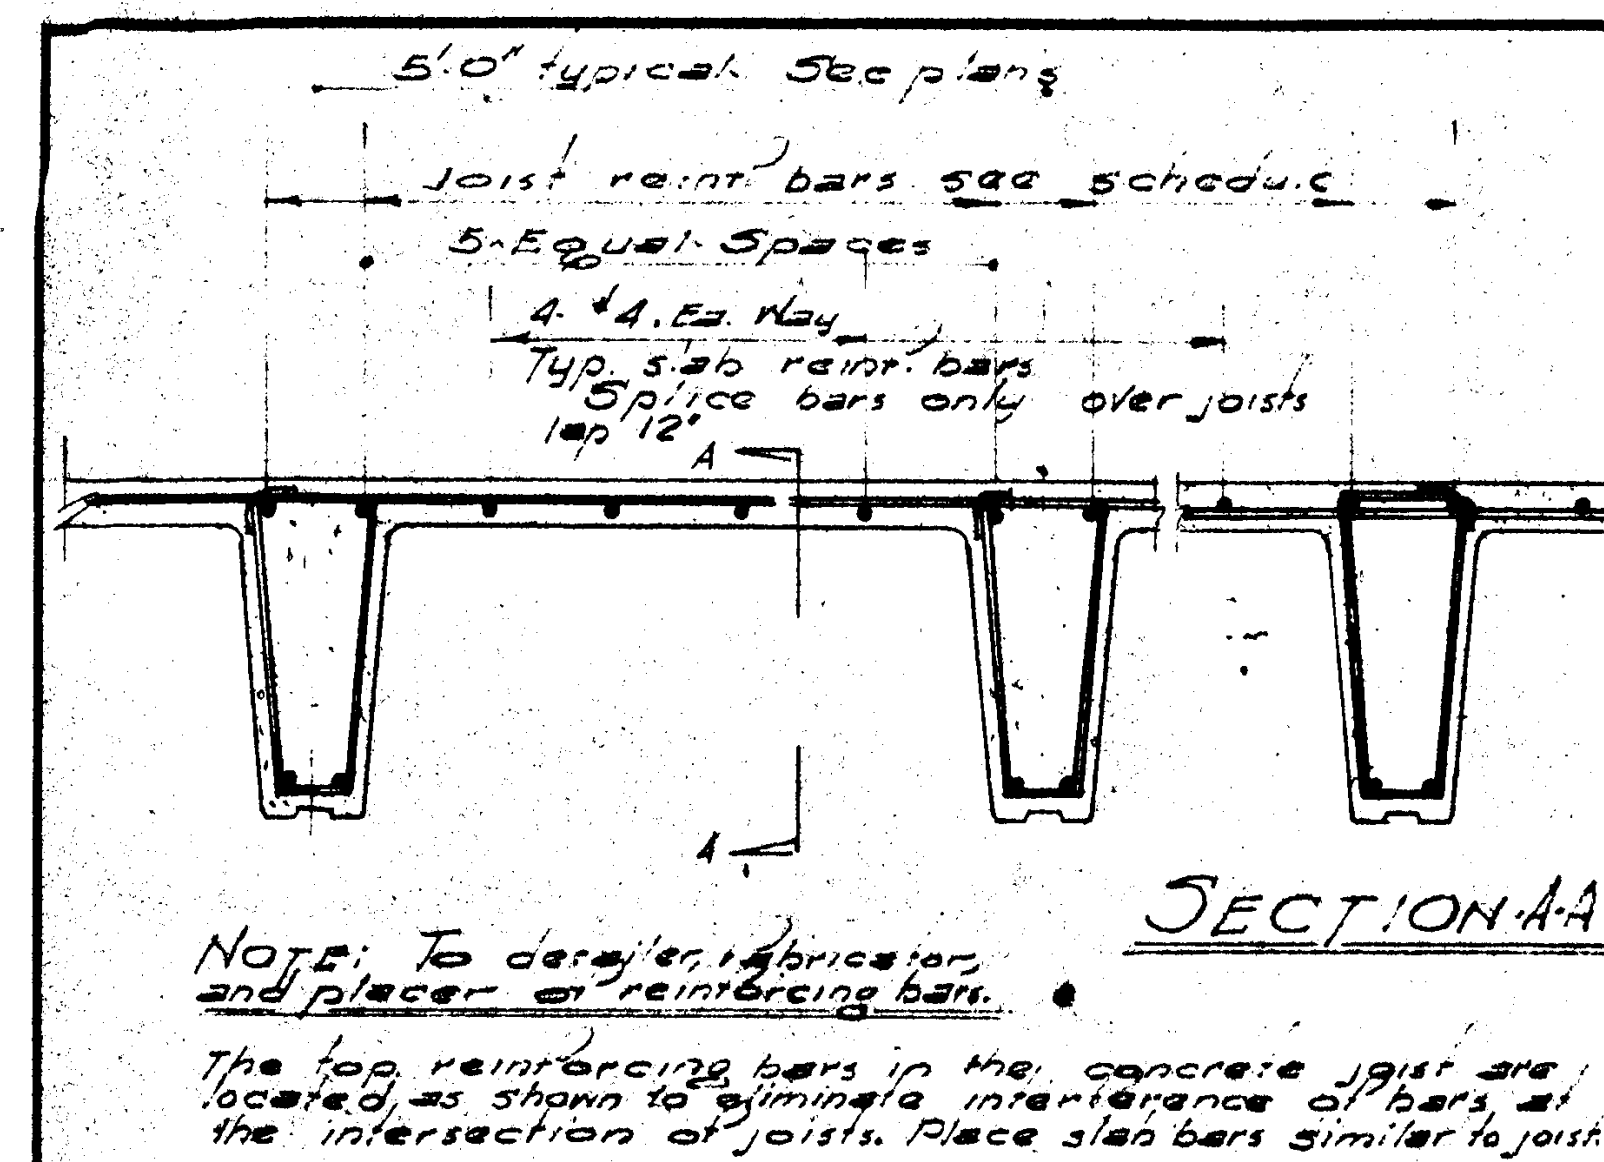


SECTION				SCALE 3/8" = 1'	11	SECTION				SCALE 3/8" = 5'	5	SECTION				SCALE 3/8" = 4'	4	SECOND FLOOR FRAMING				SCALE 3/8" = 1'	1
<div>▲</div> <div>▲</div> <div>▲</div> <div>▲</div> <div>▲</div> <div>▲</div> <div>DATE DRAWN</div> <div>REVISIONS</div>				STRUCTURAL ENGINEERS BRANDOW & JOHNSTON J. A. MARTIN & ASSOCIATES		DESIGNED GU	ARCHITECT <i>William L. Ferreira</i> ENGINEER <i>Ralph E. Phillips</i> COLLEGE		APPROVED  APPROVED STATE FIRE MARSHAL STATE OF CALIFORNIA DATE JUN 21 1955		ASSOCIATED ARCHITECTS: WILLIAM L. FERREIRA & ASSOCIATES A. QUINCY JONES-FREDERICK E. EMMONS & ASSOCIATES ELDRIDGE ELLERBROEK & ASSOCIATES URBANUS SQUARE • MACARTHUR BOULEVARD AT FORD ROAD TELEPHONE 714/875-2640 • CORONA DEL MAR, CALIFORNIA				GOLDEN WEST COLLEGE HUNTINGTON BEACH, CALIFORNIA ORANGE COAST JUNIOR COLLEGE DISTRICT				TYPICAL SECOND FLOOR DETAILS		JOB NO. 10-1 DATE 16 JUN 1965 SHEET NO. S 2.2		
				MECHANICAL ENGINEERS RALPH E. PHILLIPS, INC.		DRAWN BY CDR																	
				ELECTRICAL ENGINEERS RALPH E. PHILLIPS, INC.		CHECKED BY GU																	
				CIVIL ENGINEERS G. SHUURMAN & ASSOCIATES MOFFATT & NICHOL																			

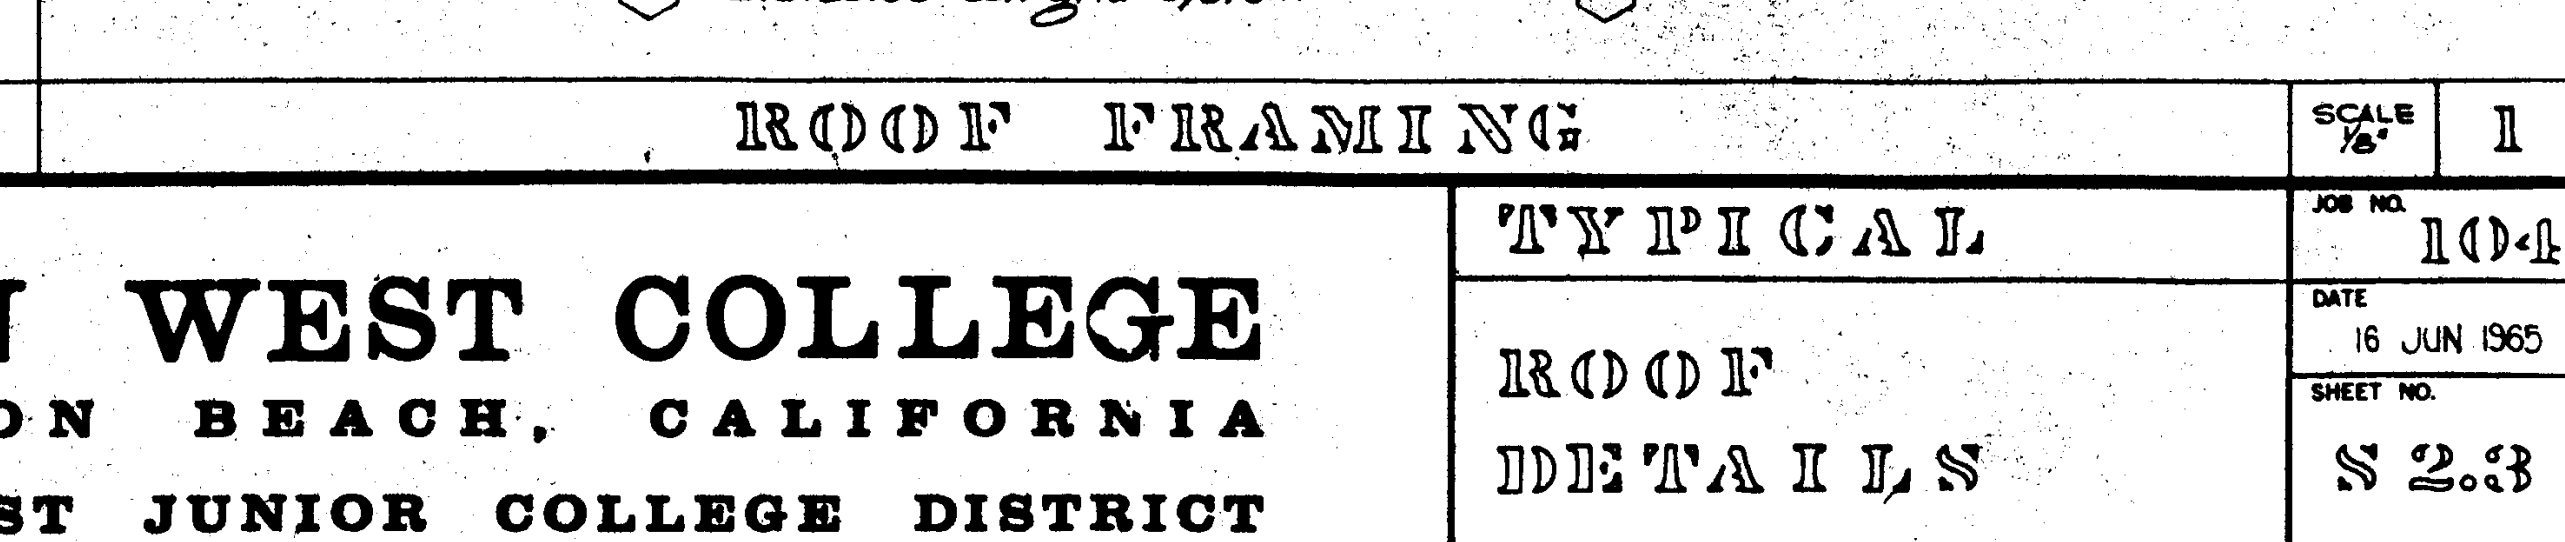


ASSOCIATED ARCHITECTS:
WILLIAM L. PEREIRA & ASSOCIATES
A. QUINCY JONES-FREDERICK R. EDMONS & ASSOCIATES
BLUROCK ELLERBROEK & ASSOCIATES


URBANUS SQUARE • MACARTHUR BOULEVARD AT FORD ROAD
TELEPHONE 714/675-2640 • CORONA DEL MAR, CALIFORNIA

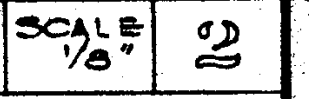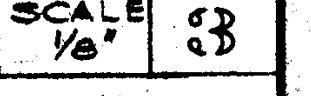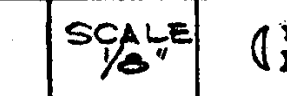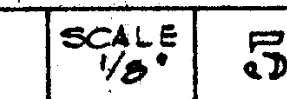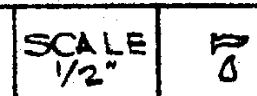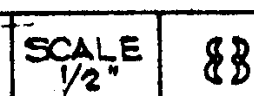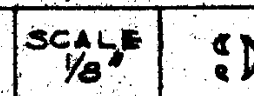


TYPICAL LOAD CENTER DETAILS	JOB NO. 104 DATE 6 MAY 1965 SHEET NO. 52.4
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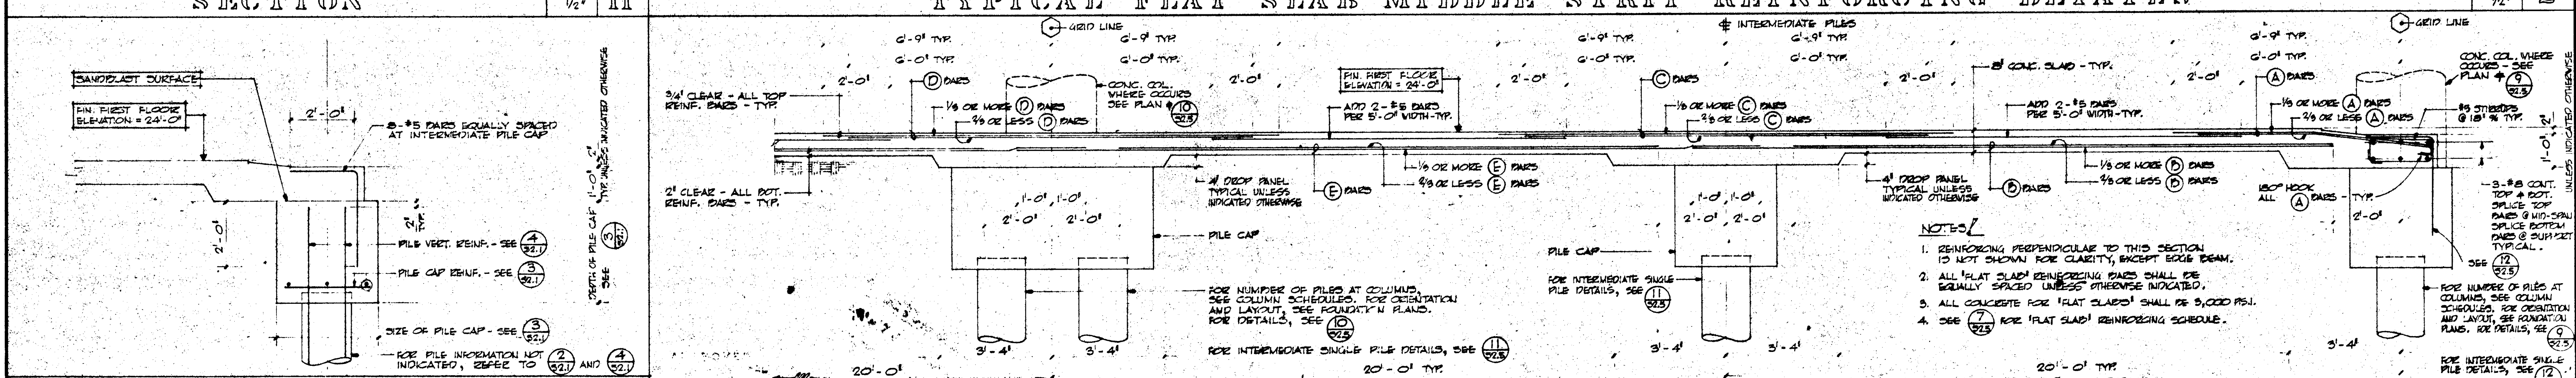
SECTION AT EXTERIOR COLUMN PILE CLUSTER SCALE 1/2" = 1'

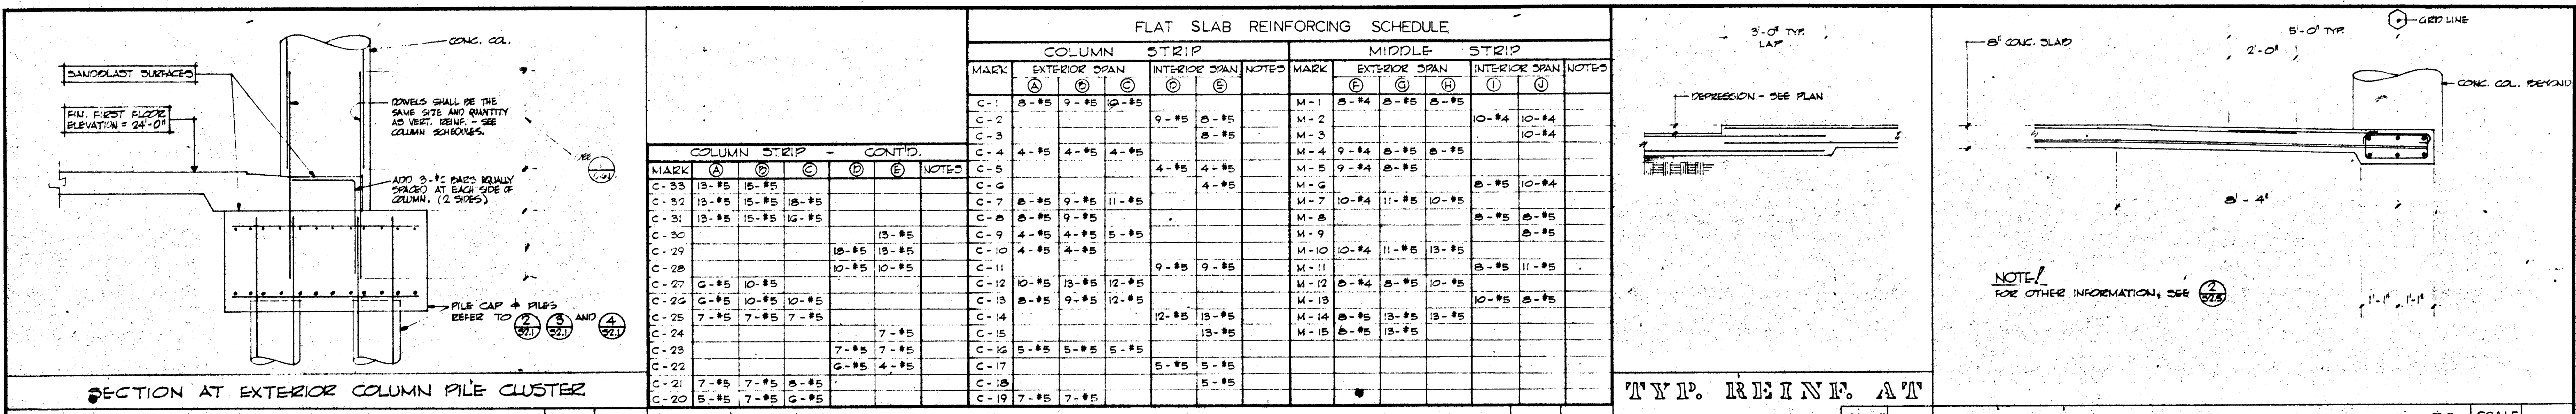

SECTION AT INTERIOR COLUMN PILE CLUSTER SCALE 1/2" = 1'

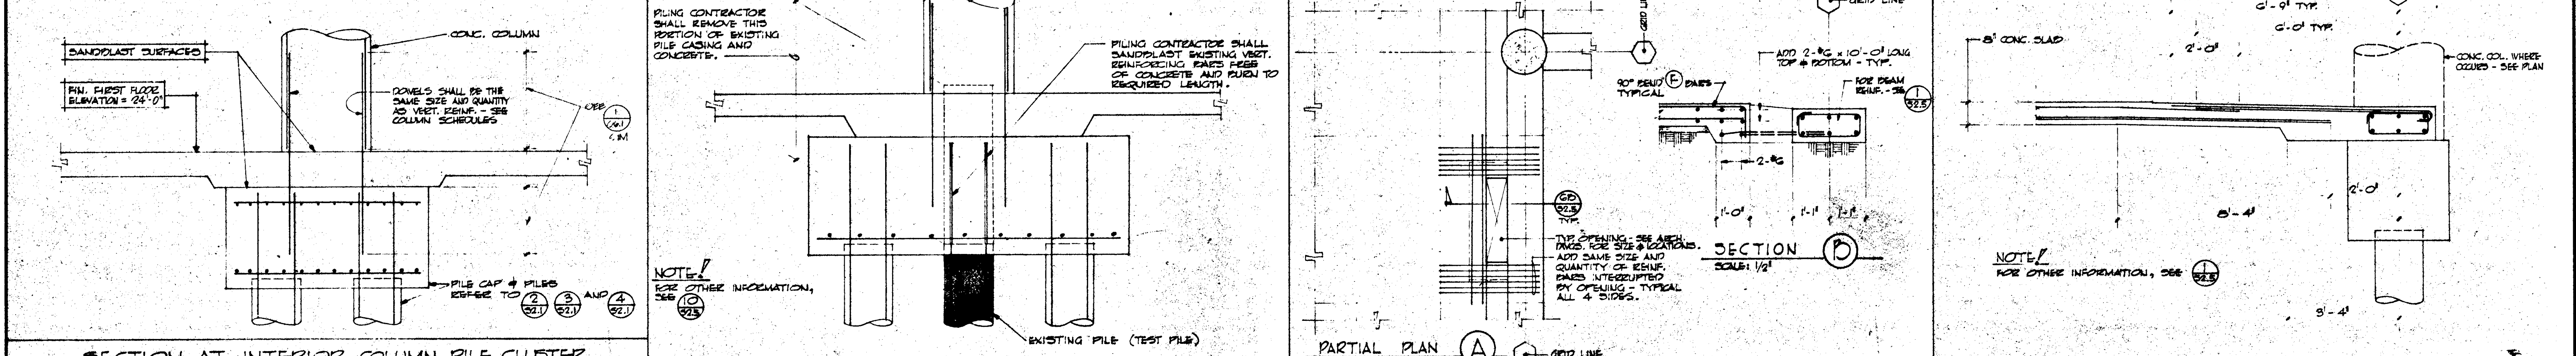

SECTION AT INTERIOR INTERMEDIATE PILE SCALE 1/2" = 1'

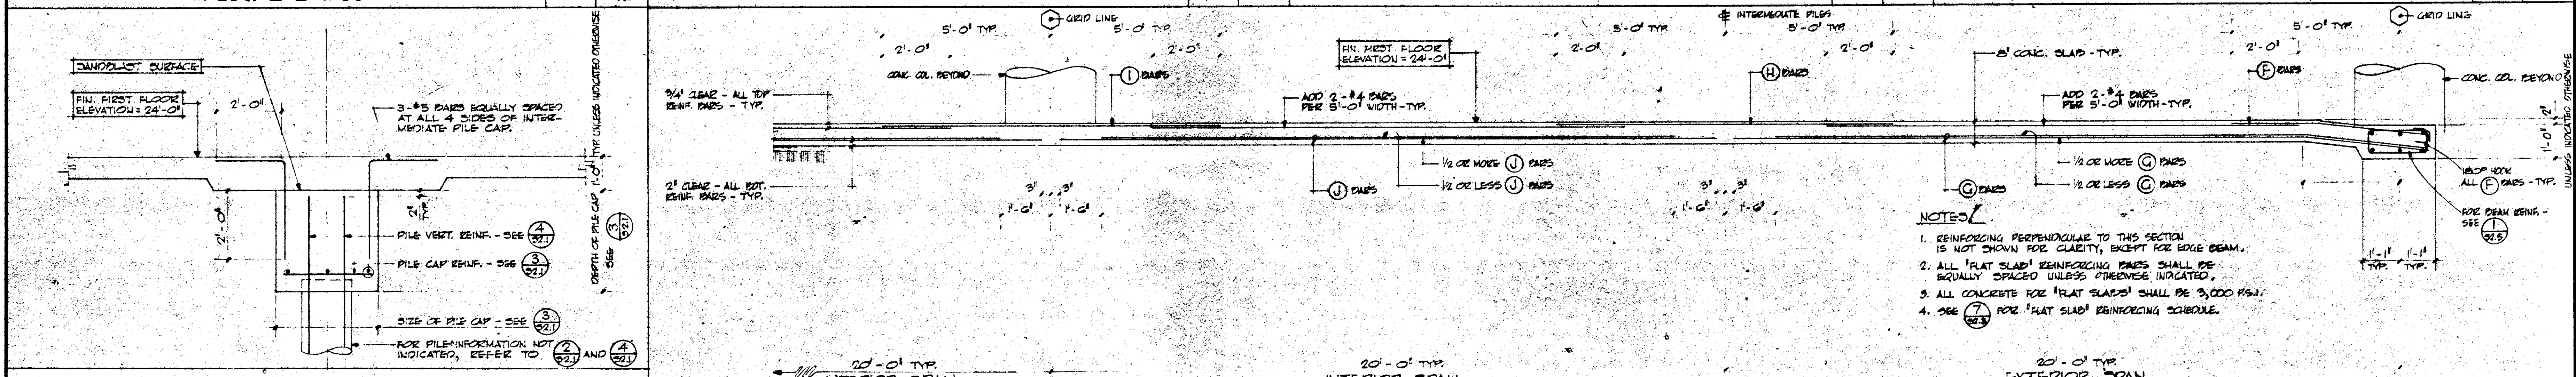

SECTION AT EXTERIOR INTERMEDIATE PILE SCALE 1/2" = 1'

FLAT SLAB REINFORCING SCHEDULE			
COLUMN STRIP		MIDDLE STRIP	
MARK	REINFORCING	MARK	REINFORCING
C-1	9-#5	M-1	9-#4
C-2	9-#5	M-2	9-#4
C-3	9-#5	M-3	9-#4
C-4	9-#5	M-4	9-#4
C-5	9-#5	M-5	9-#4
C-6	9-#5	M-6	9-#4
C-7	9-#5	M-7	9-#4
C-8	9-#5	M-8	9-#4
C-9	9-#5	M-9	9-#4
C-10	9-#5	M-10	9-#4
C-11	9-#5	M-11	9-#4
C-12	9-#5	M-12	9-#4
C-13	9-#5	M-13	9-#4
C-14	9-#5	M-14	9-#4
C-15	9-#5	M-15	9-#4
C-16	9-#5		
C-17	9-#5		
C-18	9-#5		
C-19	9-#5		

GOLDEN WEST COLLEGE
HUNTINGTON BEACH, CALIFORNIA
ORANGE COAST JUNIOR COLLEGE DISTRICT

UNITS 4 & 7
FIRST FLR. &
FOUNDATION
DETAILS

ASSOCIATED ARCHITECTS:
WILLIAM L. PEREIRA & ASSOCIATES
A. QUINCY JONES-FREDERICK E. EMMONS & ASSOCIATES
BLUROCK ELLERBROCK & ASSOCIATES

STRUCTURAL ENGINEERS:
BRANDOW & JOHNSTON
J. A. MARTIN & ASSOCIATES
MECHANICAL ENGINEERS:
RALPH E. PHILLIPS, INC.
ELECTRICAL ENGINEERS:
RALPH E. PHILLIPS, INC.
CIVIL ENGINEERS:
G. SHURMAN & ASSOCIATES
MOFFATT & NICOL






DESIGNED:
A.C.N.
DRAWN BY:
J.O.R.
CHECKED BY:
J.P.








ARCHITECT:
J. A. MARTIN & ASSOCIATES
ENGINEER:
J. A. MARTIN & ASSOCIATES
COLLEGE:
GOLDEN WEST COLLEGE

APPROVED:
[Signature]
DATE:
MAY 1965


URBANUS SQUARE
MACARTHUR BOULEVARD AT FORD ROAD
TELEPHONE 714/675-2640
CORONA DEL MAR, CALIFORNIA

JOB NO. 10-1
DATE: MAY 1965
SHEET NO. S 2.5

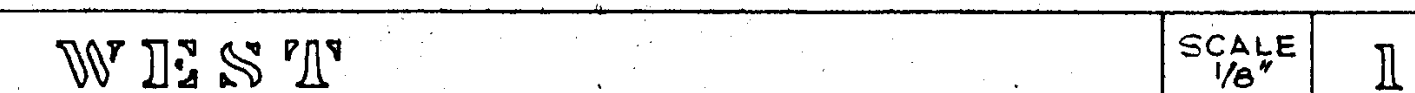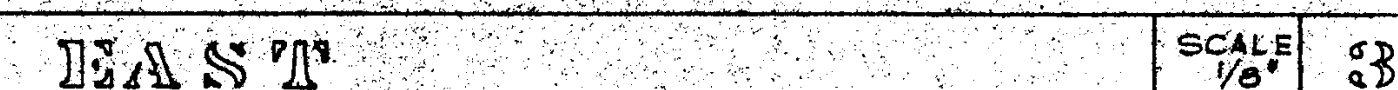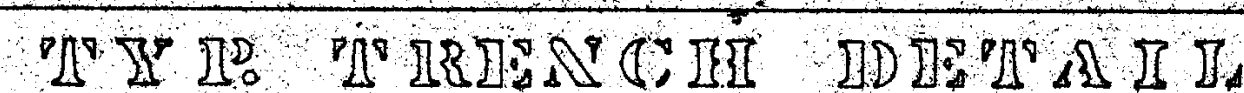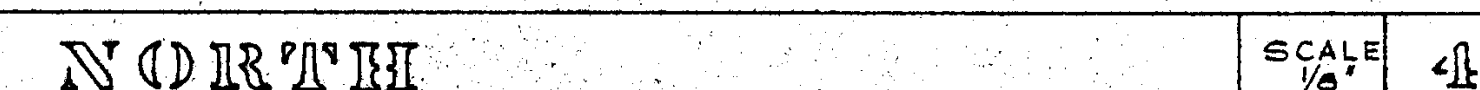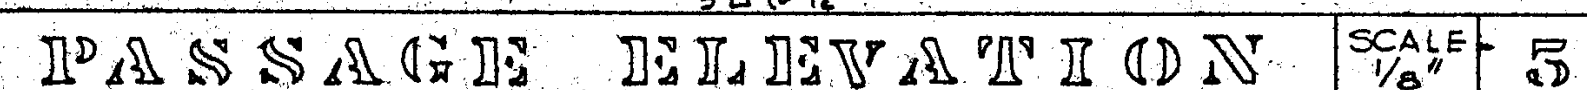
12 Nov

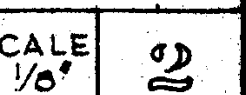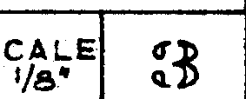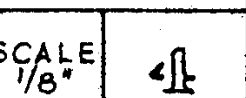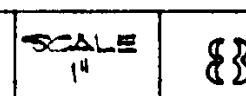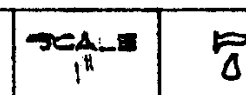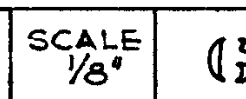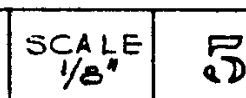




UNITED STATES STRUCTURAL ELEVATIONS	JOB NO.	1004
	DATE	16 JUN 1960
	SHEET NO.	S 32

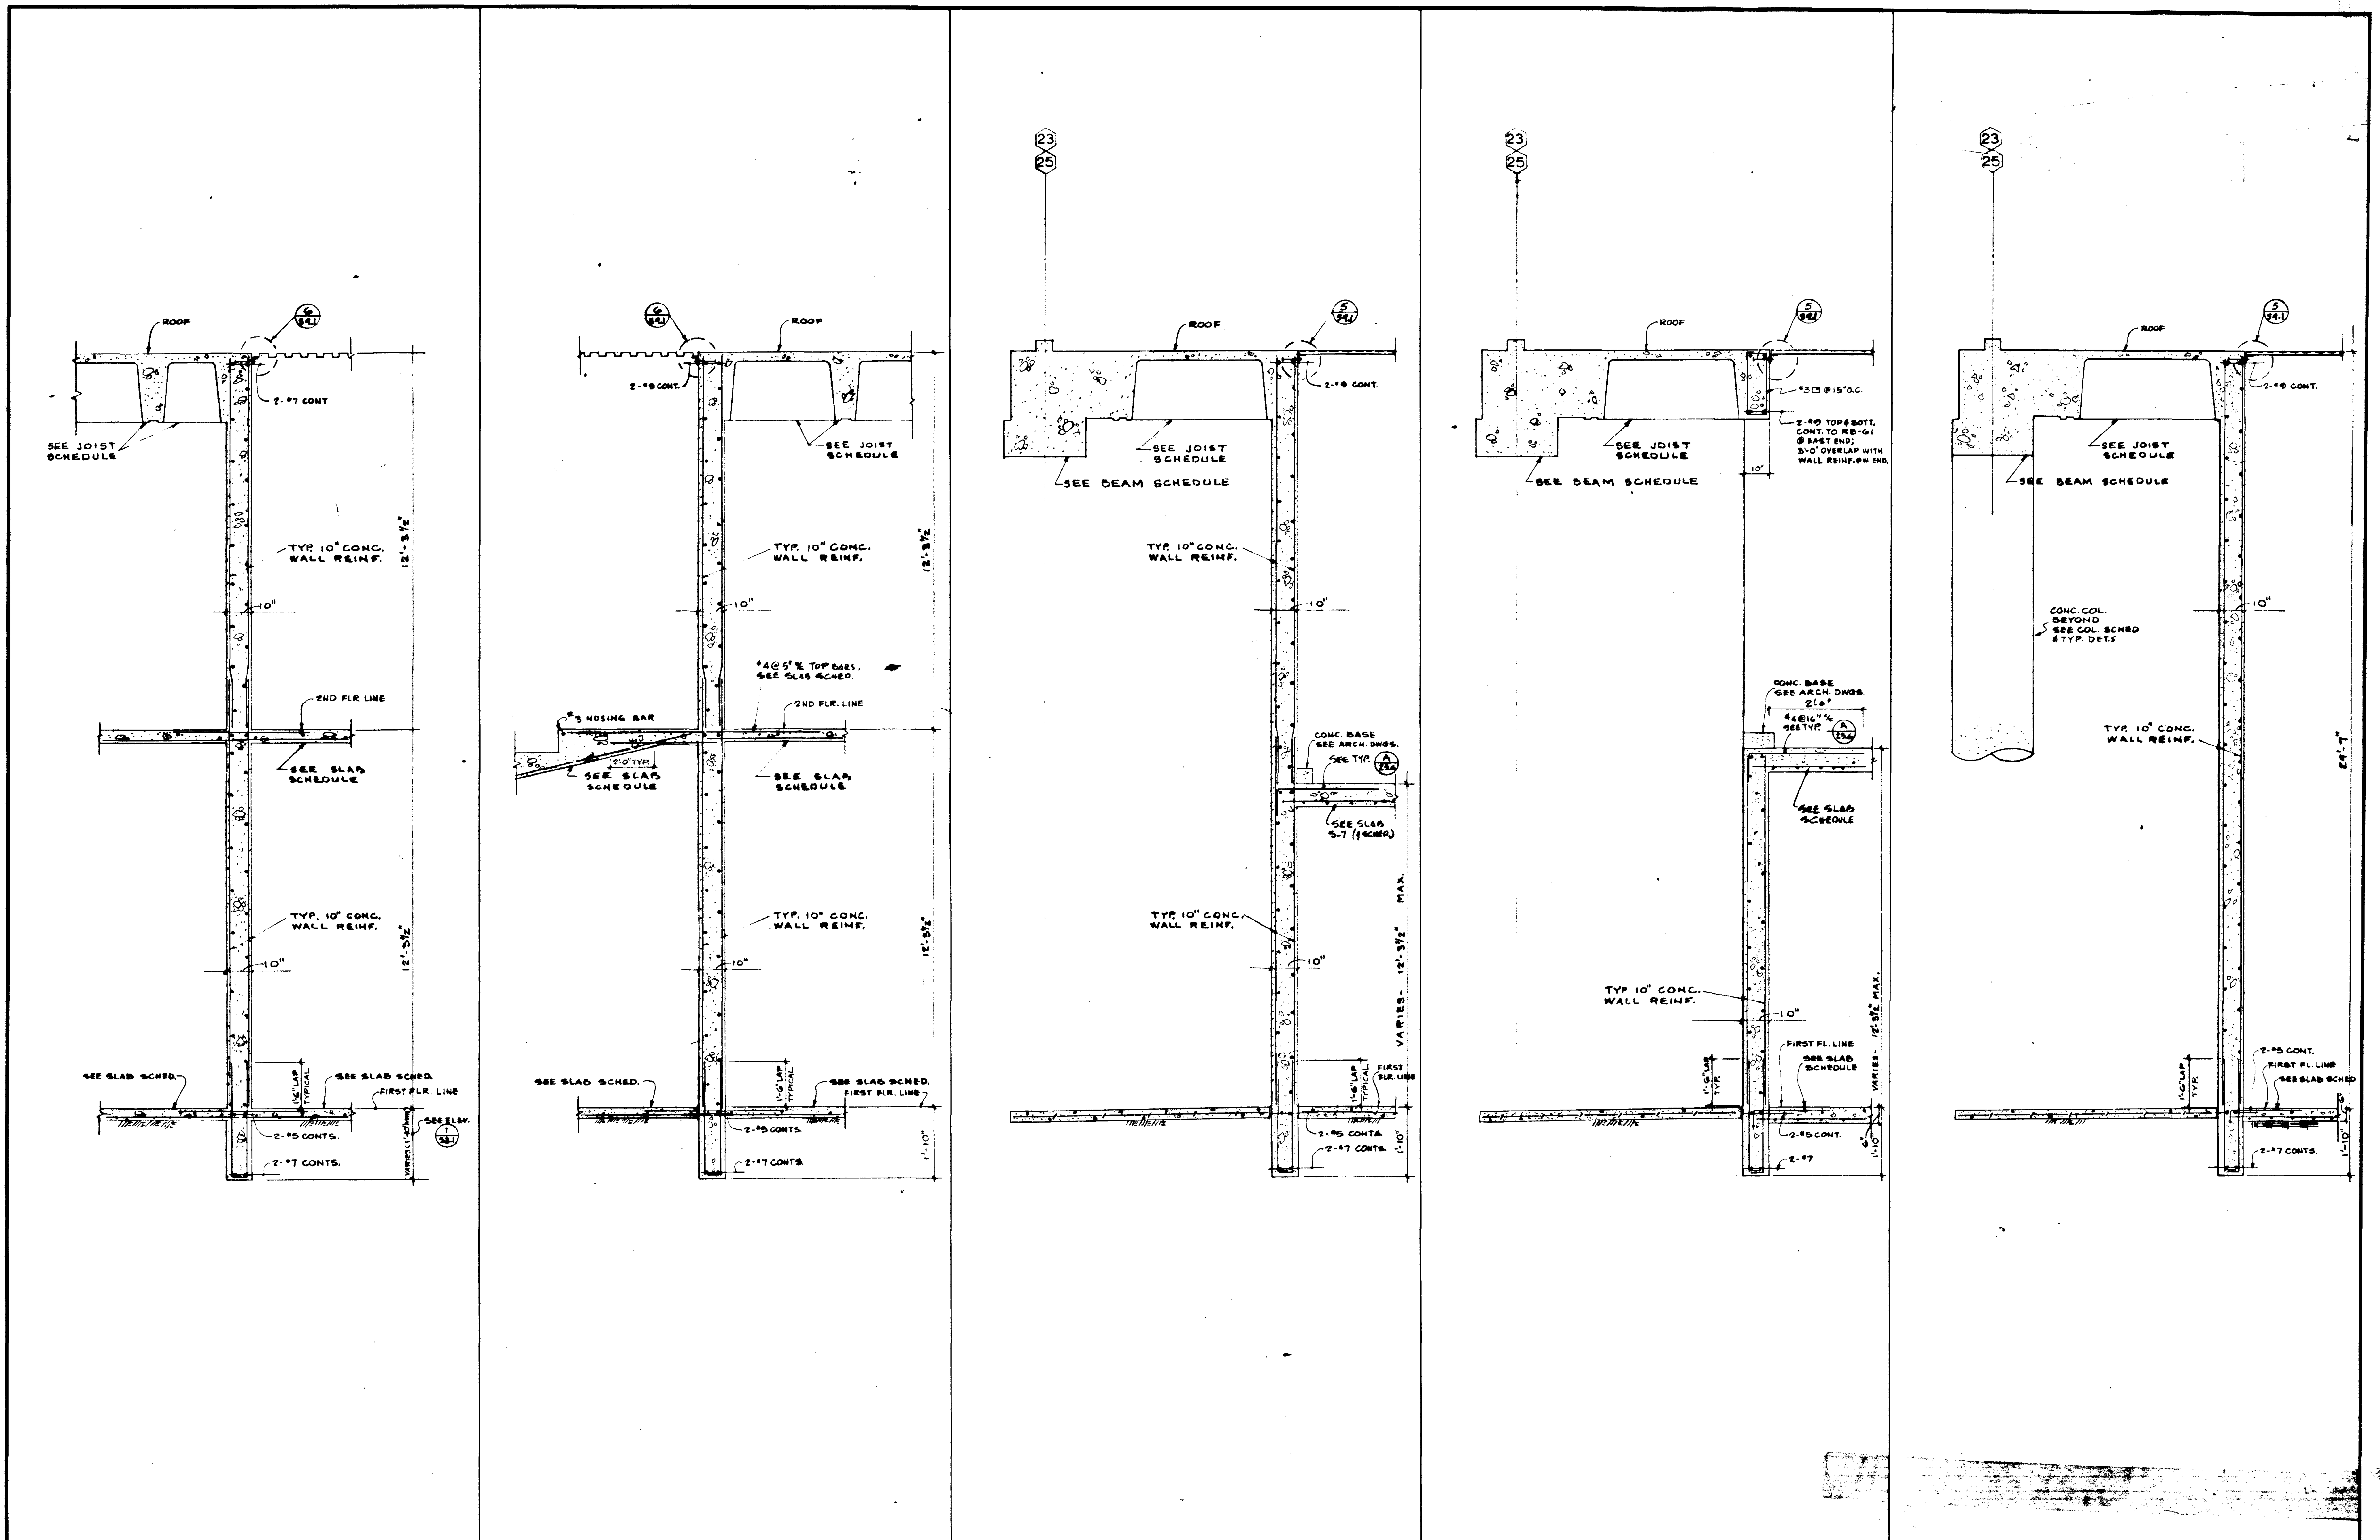

SECTION 1				SECTION 2				SECTION 3				SECTION 4				SECTION 5			
SCALE 1/2"				SCALE 1/2"				SCALE 1/2"				SCALE 1/2"				SCALE 1/2"			
STRUCTURAL ENGINEERS BRADY & JOHNSON J.A. MARTIN & ASSOCIATES				DESIGNED A.C.				ARCHITECT WILLIAM L. PEREIRA & ASSOCIATES				APPROVED STATE FIRE MARSHAL STATE OF CALIFORNIA DATE JUN 21 1965				APPROVED STATE FIRE MARSHAL STATE OF CALIFORNIA DATE JUN 21 1965			
MECHANICAL ENGINEERS RALPH E. PHILLIPS, INC.				DRAWN BY R.C.E.				ENGINEER WILLIAM L. PEREIRA & ASSOCIATES				APPROVED STATE FIRE MARSHAL STATE OF CALIFORNIA DATE JUN 21 1965				APPROVED STATE FIRE MARSHAL STATE OF CALIFORNIA DATE JUN 21 1965			
ELECTRICAL ENGINEERS RALPH E. PHILLIPS, INC.				CHECKED BY A.C.				COLLEGE				APPROVED STATE FIRE MARSHAL STATE OF CALIFORNIA DATE JUN 21 1965				APPROVED STATE FIRE MARSHAL STATE OF CALIFORNIA DATE JUN 21 1965			
CIVIL ENGINEERS O. SHURMAN & ASSOCIATES MOFFATT & NICHOL				REVISIONS				URBANUS SQUARE • MACARTHUR BOULEVARD AT FORD ROAD TELEPHONE 714/675-2640 • CORONA DEL MAR, CALIFORNIA				GOLDEN WEST COLLEGE HUNTINGTON BEACH, CALIFORNIA ORANGE COAST JUNIOR COLLEGE DISTRICT				UNIT 2 WALL SECTIONS			

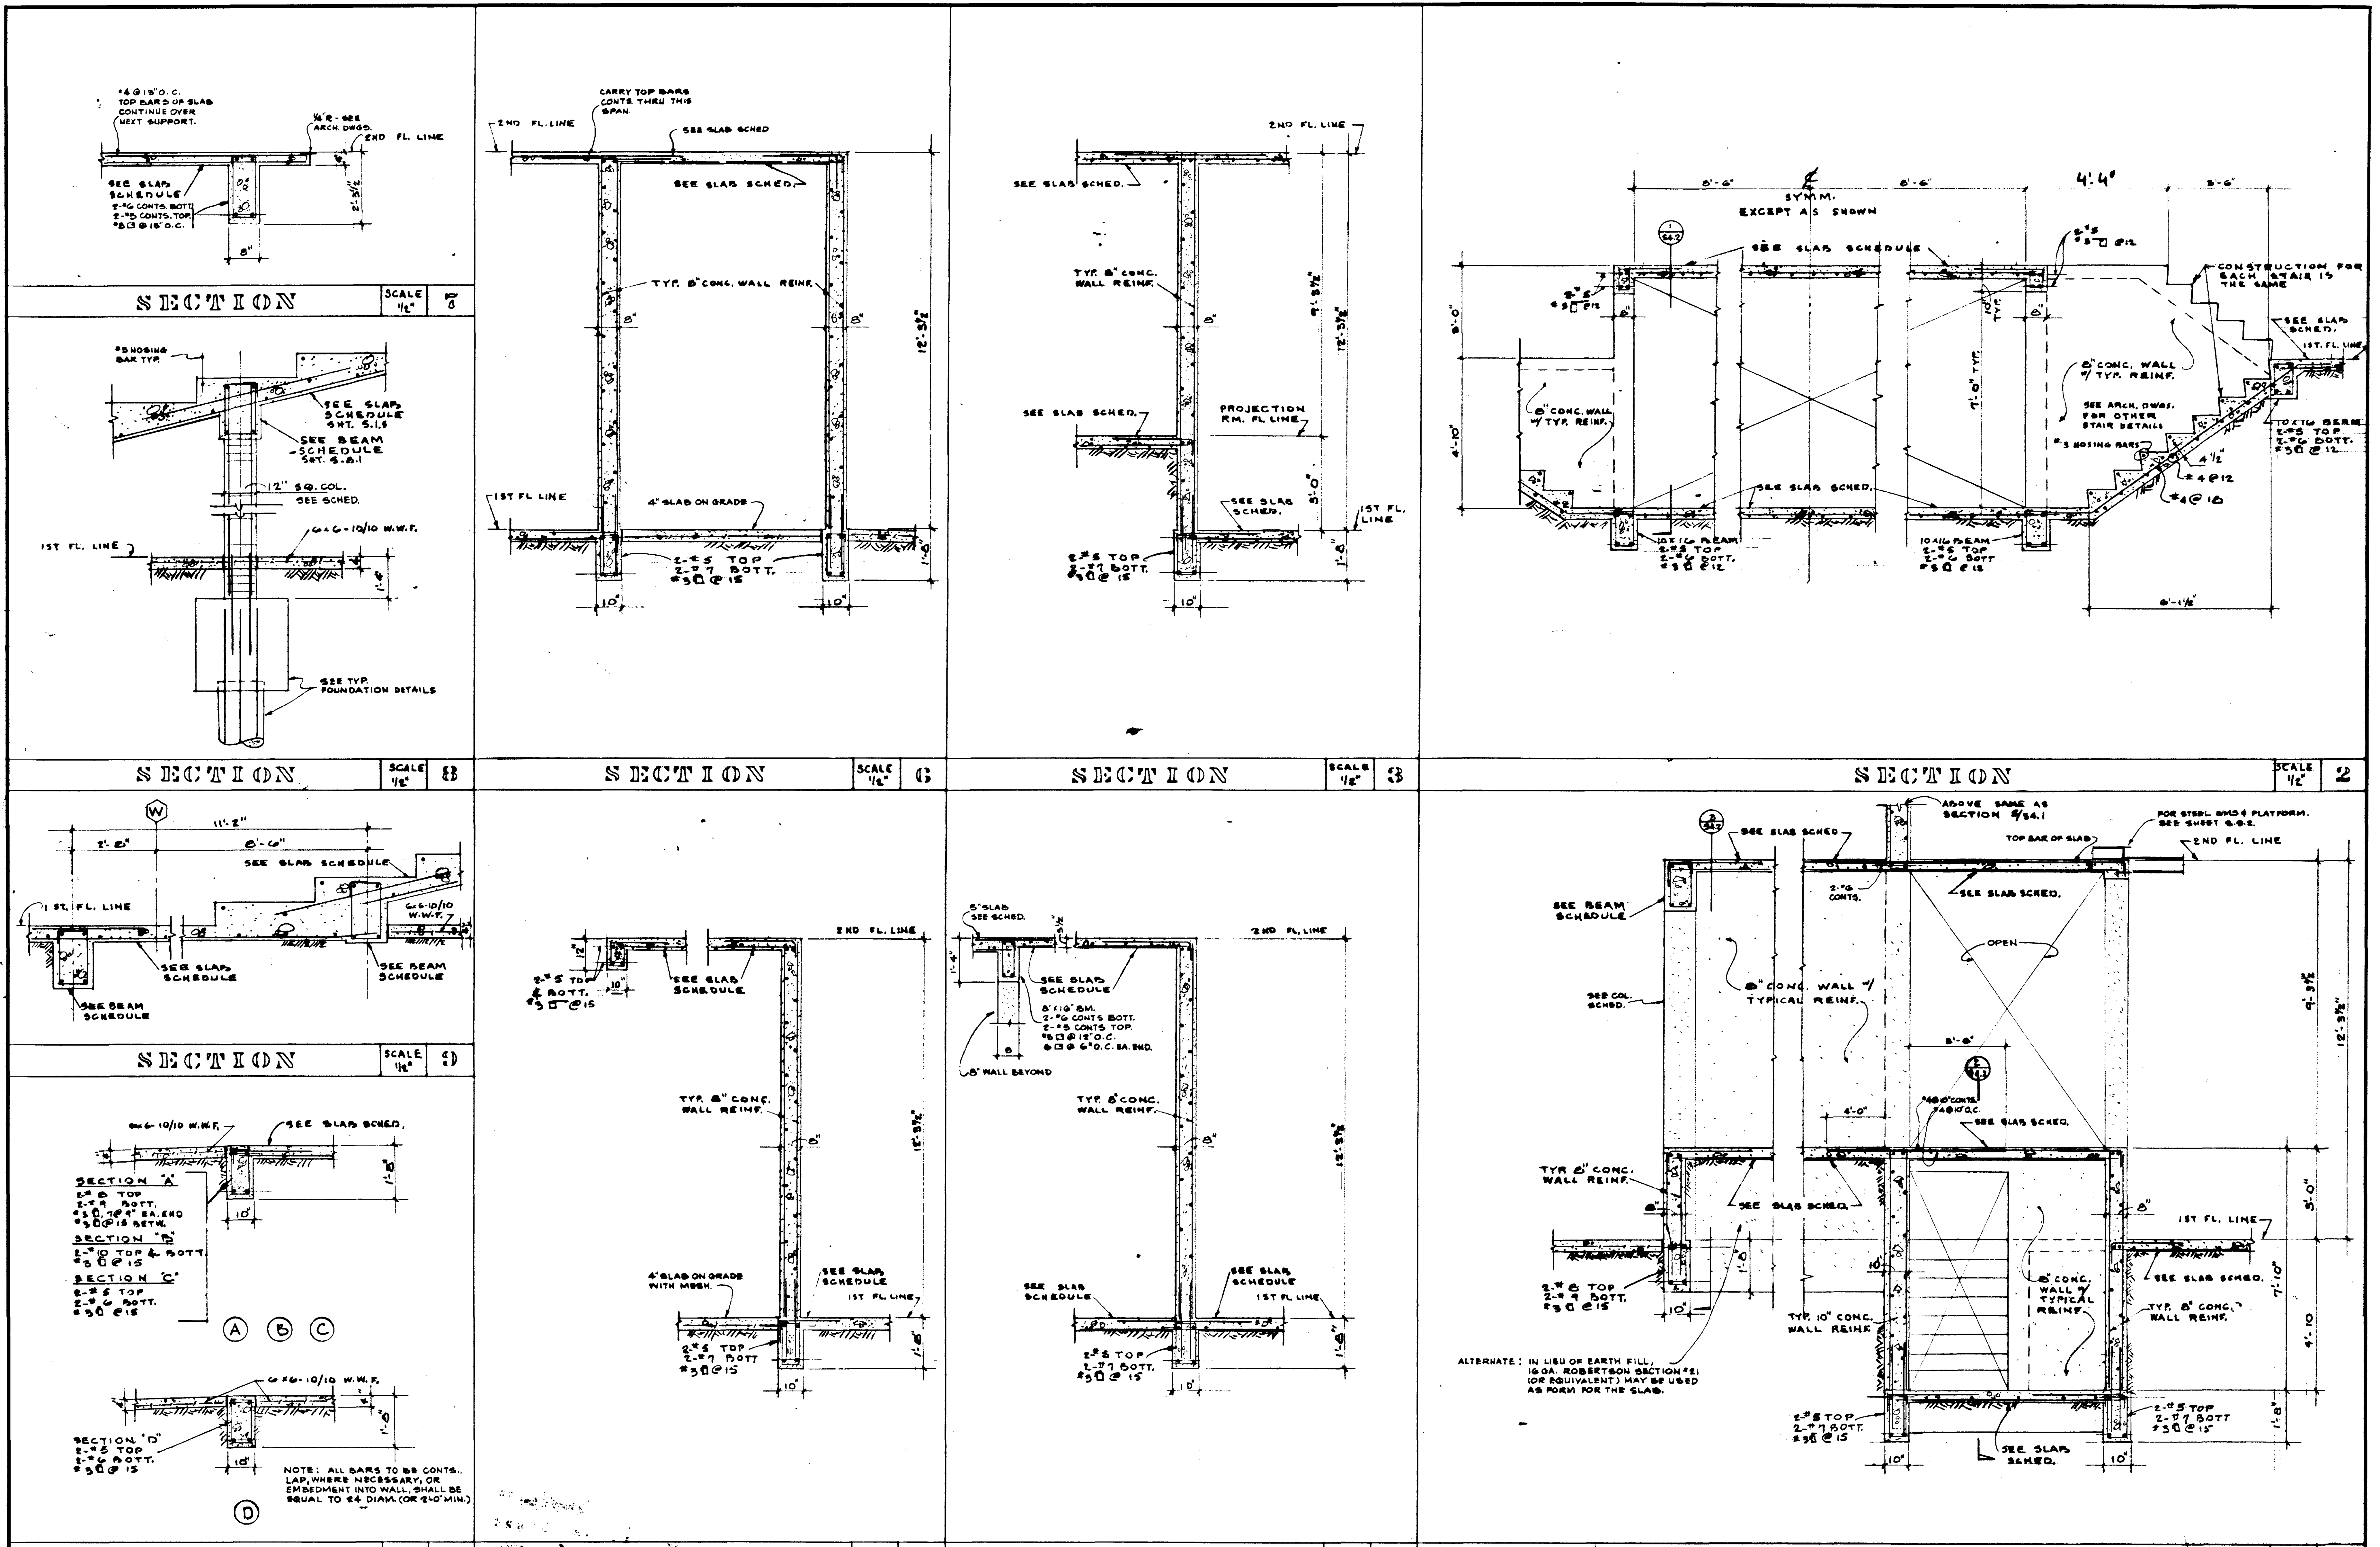

SECTION				SCALE	1/2"	10	SECTION				SCALE	1/2"	5	SECTION				SCALE	1/2"	1	SECTION				SCALE	1/2"	1
STRUCTURAL ENGINEERS BRANDOW & JOHNSTON J.A. MARTIN & ASSOCIATES				DESIGNED A.C.		ARCHITECT WILLIAM L. PEREIRA & ASSOCIATES		APPROVED OFFICE OF THE DEPARTMENT OF GENERAL SERVICES DIVISION OF ARCHITECTURE AND CONSTRUCTION JUN 21 1965				ASSOCIATED ARCHITECTS: WILLIAM L. PEREIRA & ASSOCIATES A. QUINCY JONES-FREDERICK E. EMMONS & ASSOCIATES BLUROCK ELLERBROCK & ASSOCIATES				GOLDEN WEST COLLEGE HUNTINGTON BEACH, CALIFORNIA ORANGE COAST JUNIOR COLLEGE DISTRICT				UNIT 2		JOB NO. 1041					
MECHANICAL ENGINEERS RALPH E. PHILLIPS, INC.				DRAWN BY R.C.E.		ENGINEER RALPH E. PHILLIPS, INC.		APPROVED JUN 21 1965				DATE JUN 21 1965		STATE OF CALIFORNIA						DATE 16 JUN 1965							
ELECTRICAL ENGINEERS RALPH E. PHILLIPS, INC.				CHECKED BY A.C.		COLLEGE		APPROVED				STATE FIRE MARSHAL		SHEET NO.													
CIVIL ENGINEERS G. SHUURMAN & ASSOCIATES MOFFATT & NICHOL								APPROVED				URBANUS SQUARE		MACARTHUR BOULEVARD AT FORD ROAD													
REVISIONS												TELEPHONE 714/675-2640		CORONA DEL MAR, CALIFORNIA						S4.2							

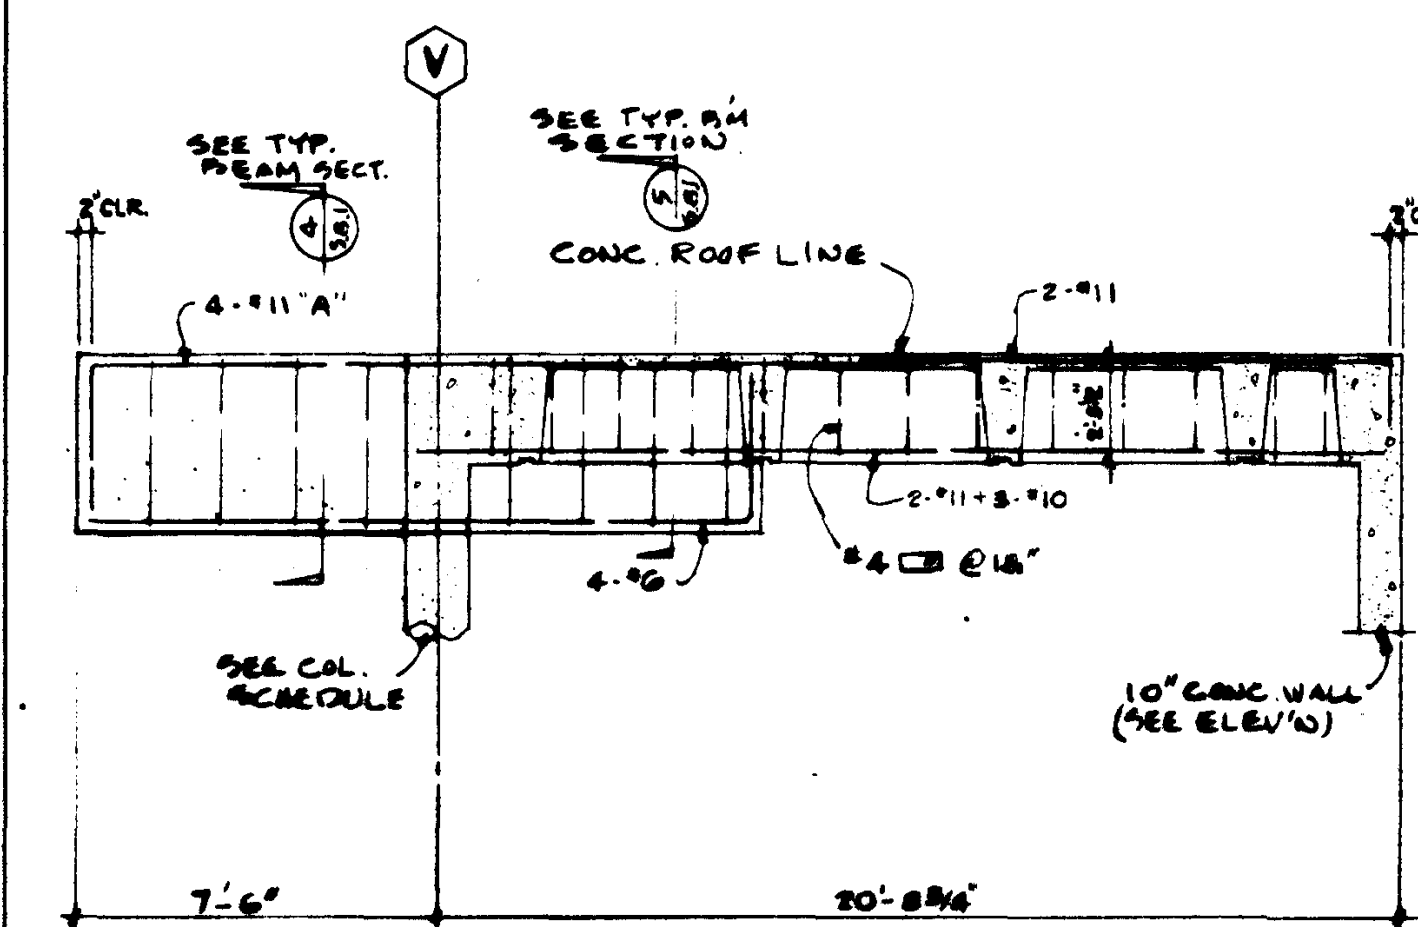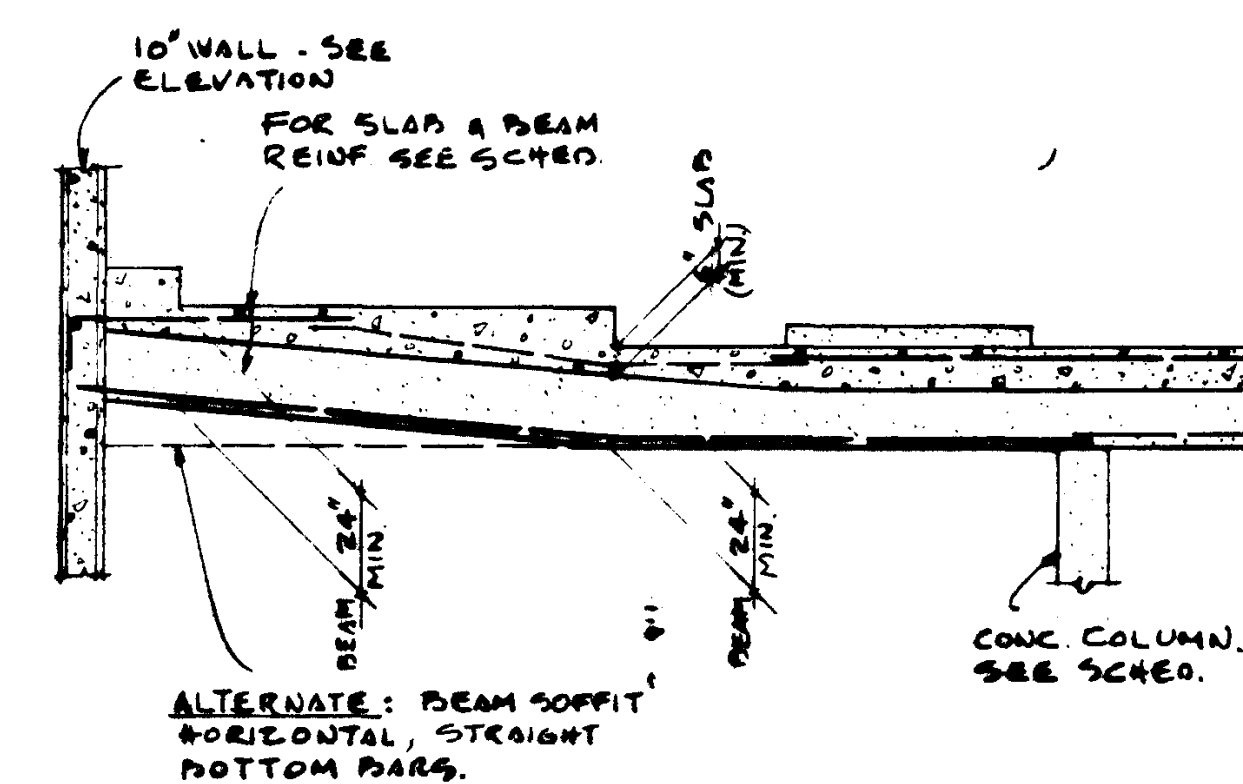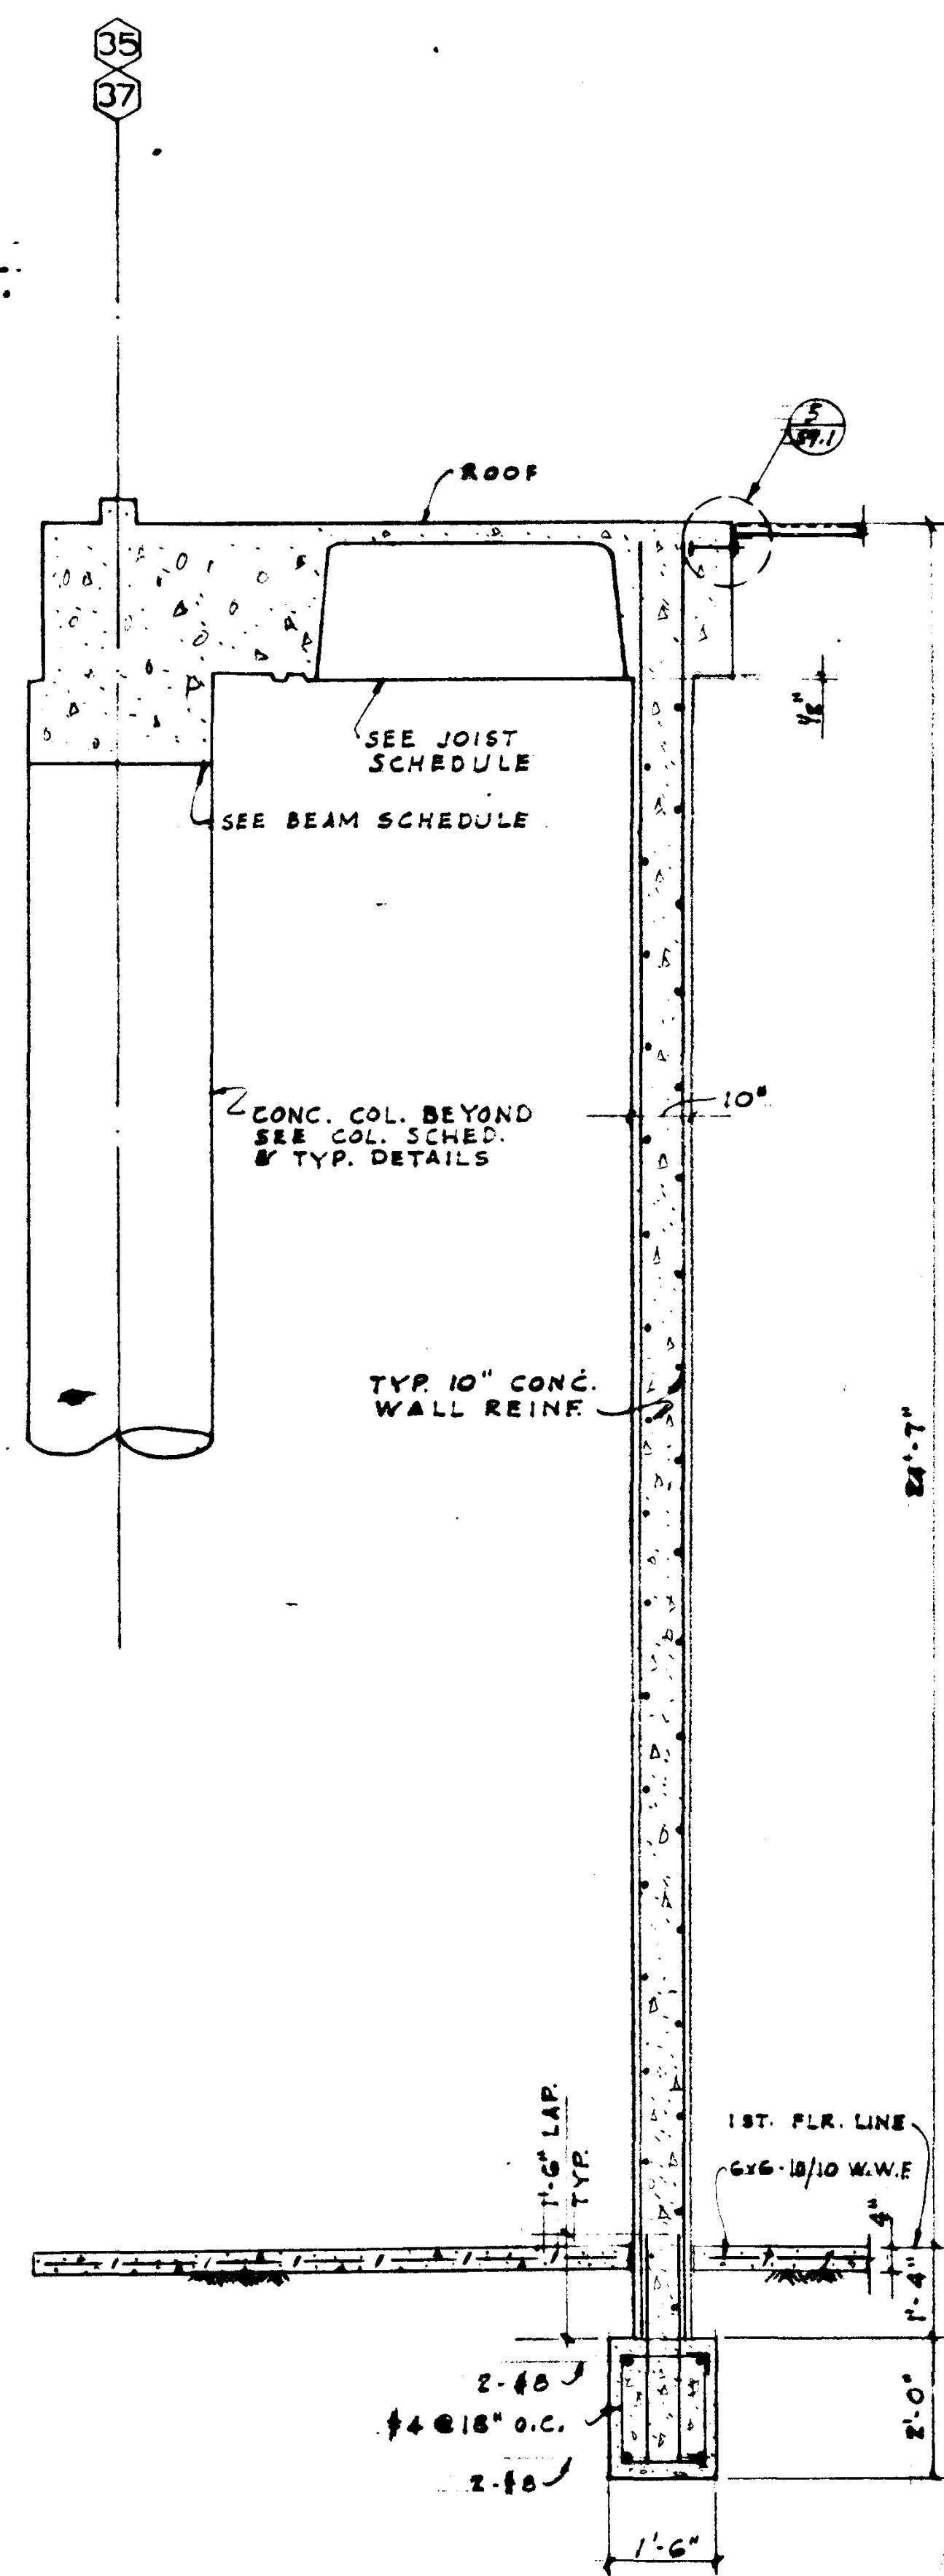


RELEVANT ION

SCALE	$\frac{1}{4}"$	57
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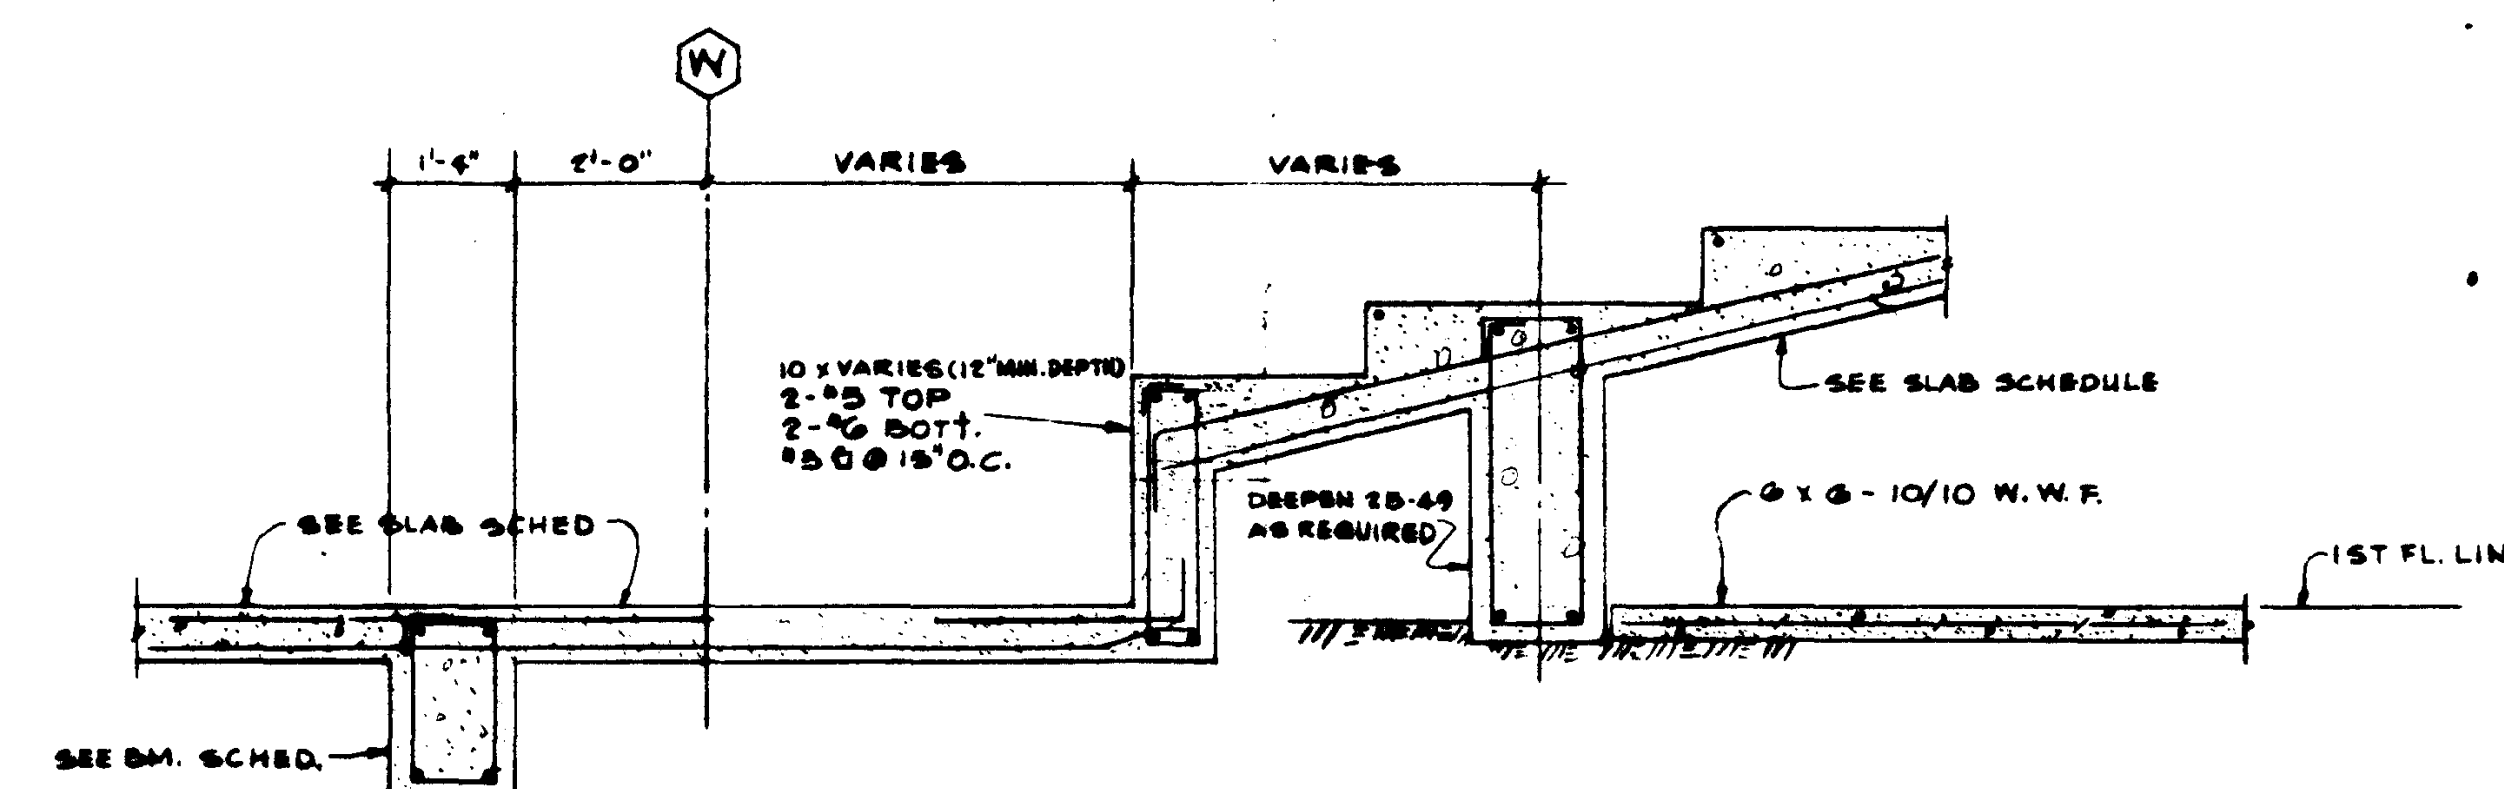
DECLARATION

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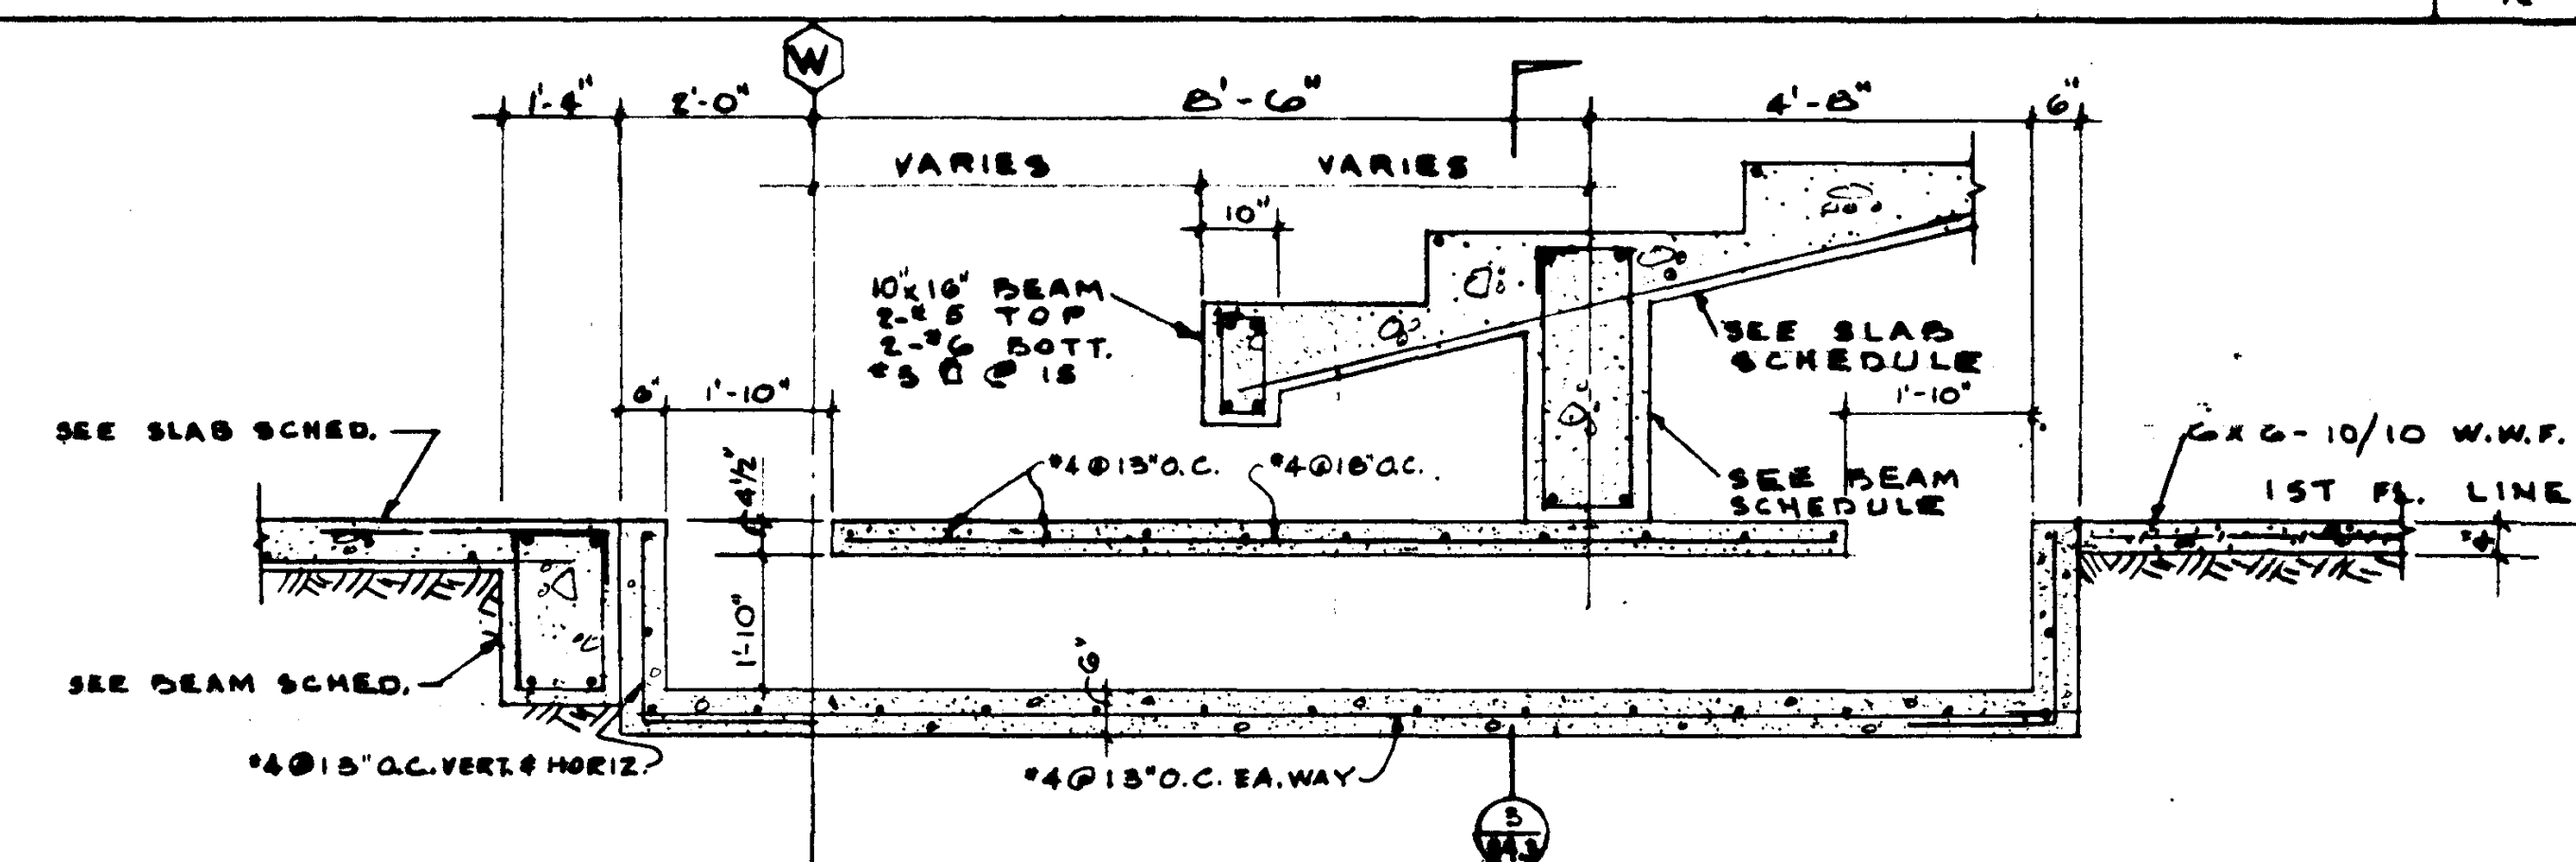
SECTION

SCALE	53
1/2"	63

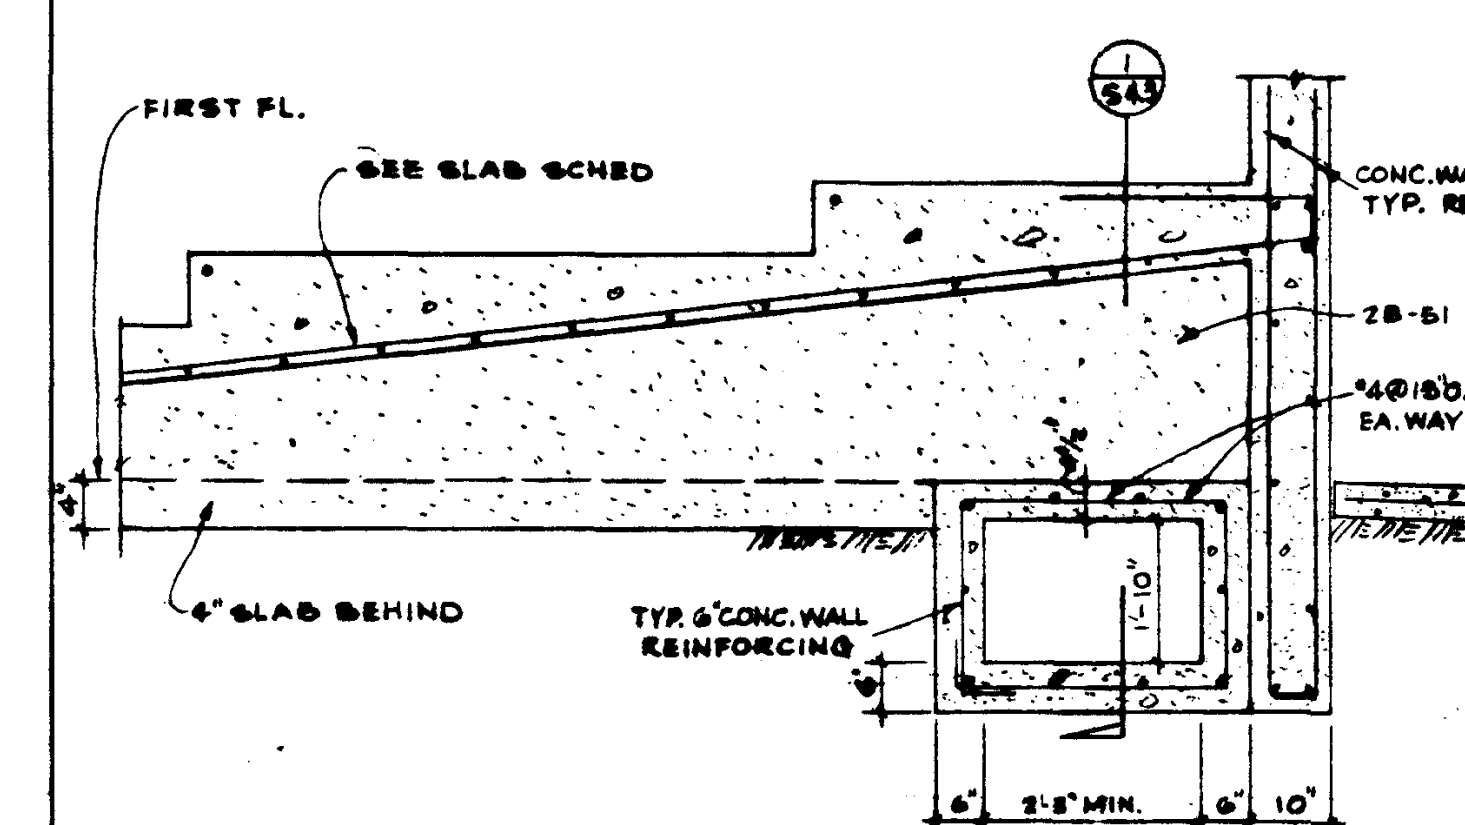

SECTION

SCALE	2
1/2"	



SECTION

SCALE	1
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			STRUCTURAL ENGINEERS
			WARDLOW & JOHNSTON
			J. A. MARTIN & ASSOCIATES
			MECHANICAL ENGINEERS
			RALPH E. PHILLIPS, INC.
			ELECTRICAL ENGINEERS
			RALPH E. PHILLIPS, INC.
			CIVIL ENGINEERS
			G. SHUURMAN & ASSOCIATES
			WYATT & NICHOL
DATE	BY	REVISIONS	

DESIGNED A.C.	ARCHITECT <i>Willis L. Cain</i>
DRAWN BY L.P.	ENGINEER <i>Ralph J. Johnston</i>
CHECKED BY A.C.	COLLEGE

APPROVED 25874 APPROVED JUN 21 1965
DATE FIRE MARSHAL
DATE OF CALIFORNIA
JUN 21 1965




ASSOCIATED ARCHITECTS:
WILLIAM L. PEREIRA & ASSOCIATES
A. QUINCY JONES-FREDERICK E. EMMONS & ASSOCIATES
BLUROCK ELLERBROCK & ASSOCIATES

URBANUS SQUARE • MACARTHUR BOULEVARD AT FORD ROAD
TELEPHONE 714/675-2640 • CORONA DEL MAR, CALIFORNIA

GOLDEN WEST COLLEGE
HUNTINGTON BEACH, CALIFORNIA
ORANGE COAST JUNIOR COLLEGE DISTRICT

WALL SECTIONS


JOB NO.	1100-1
DATE	16 JUN 1985
SHEET NO.	S-1.33

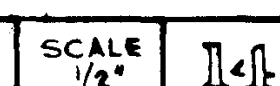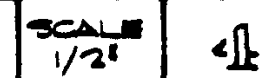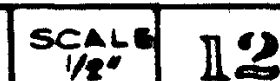

WEST COLLEGE N BEACH, CALIFORNIA T JUNIOR COLLEGE DISTRICT	C O N C U R R E N T E S E C T I O N S A N D D E T A I L S	JOB NO. 1004 DATE 10 JUN 1965 SHEET NO. \$ 5.1


GOLDEN WEST COLLEGE
HUNTINGTON BEACH, CALIFORNIA
ORANGE COAST JUNIOR COLLEGE DISTRICT

CONCRETE SECTIONS AND DETAILS	JOB NO. 104
	DATE 16 JUN 1966
	SHEET NO. S 5.1

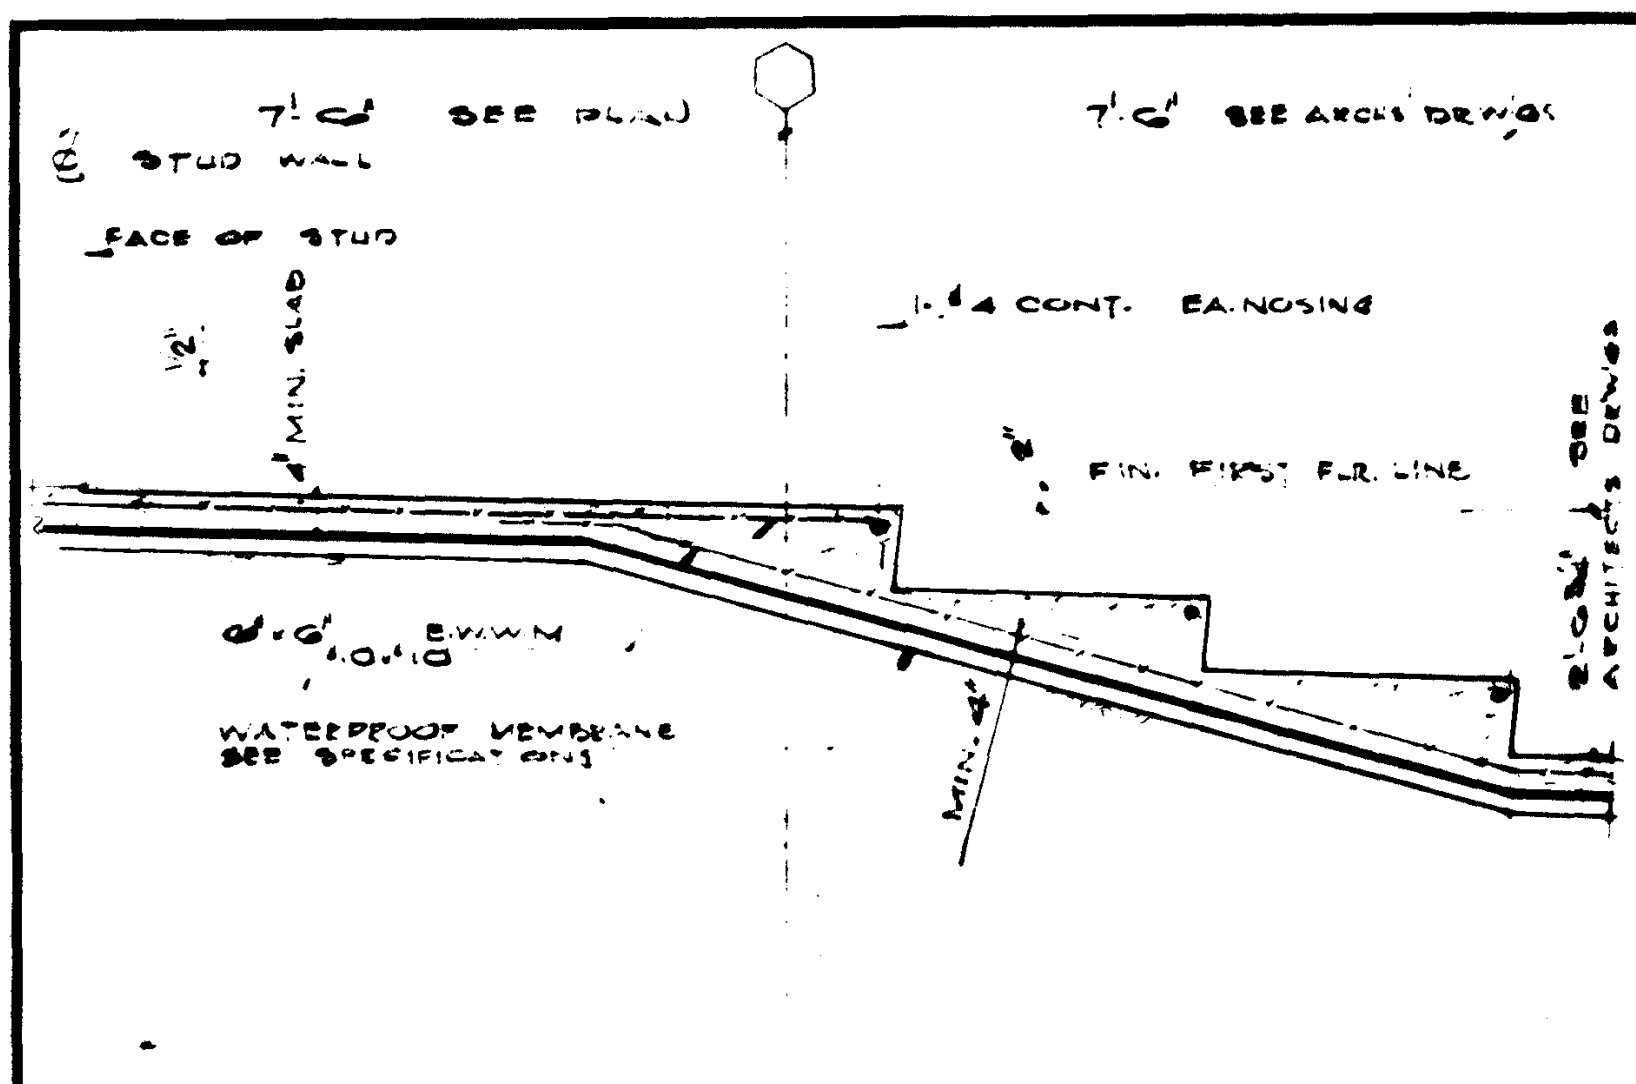


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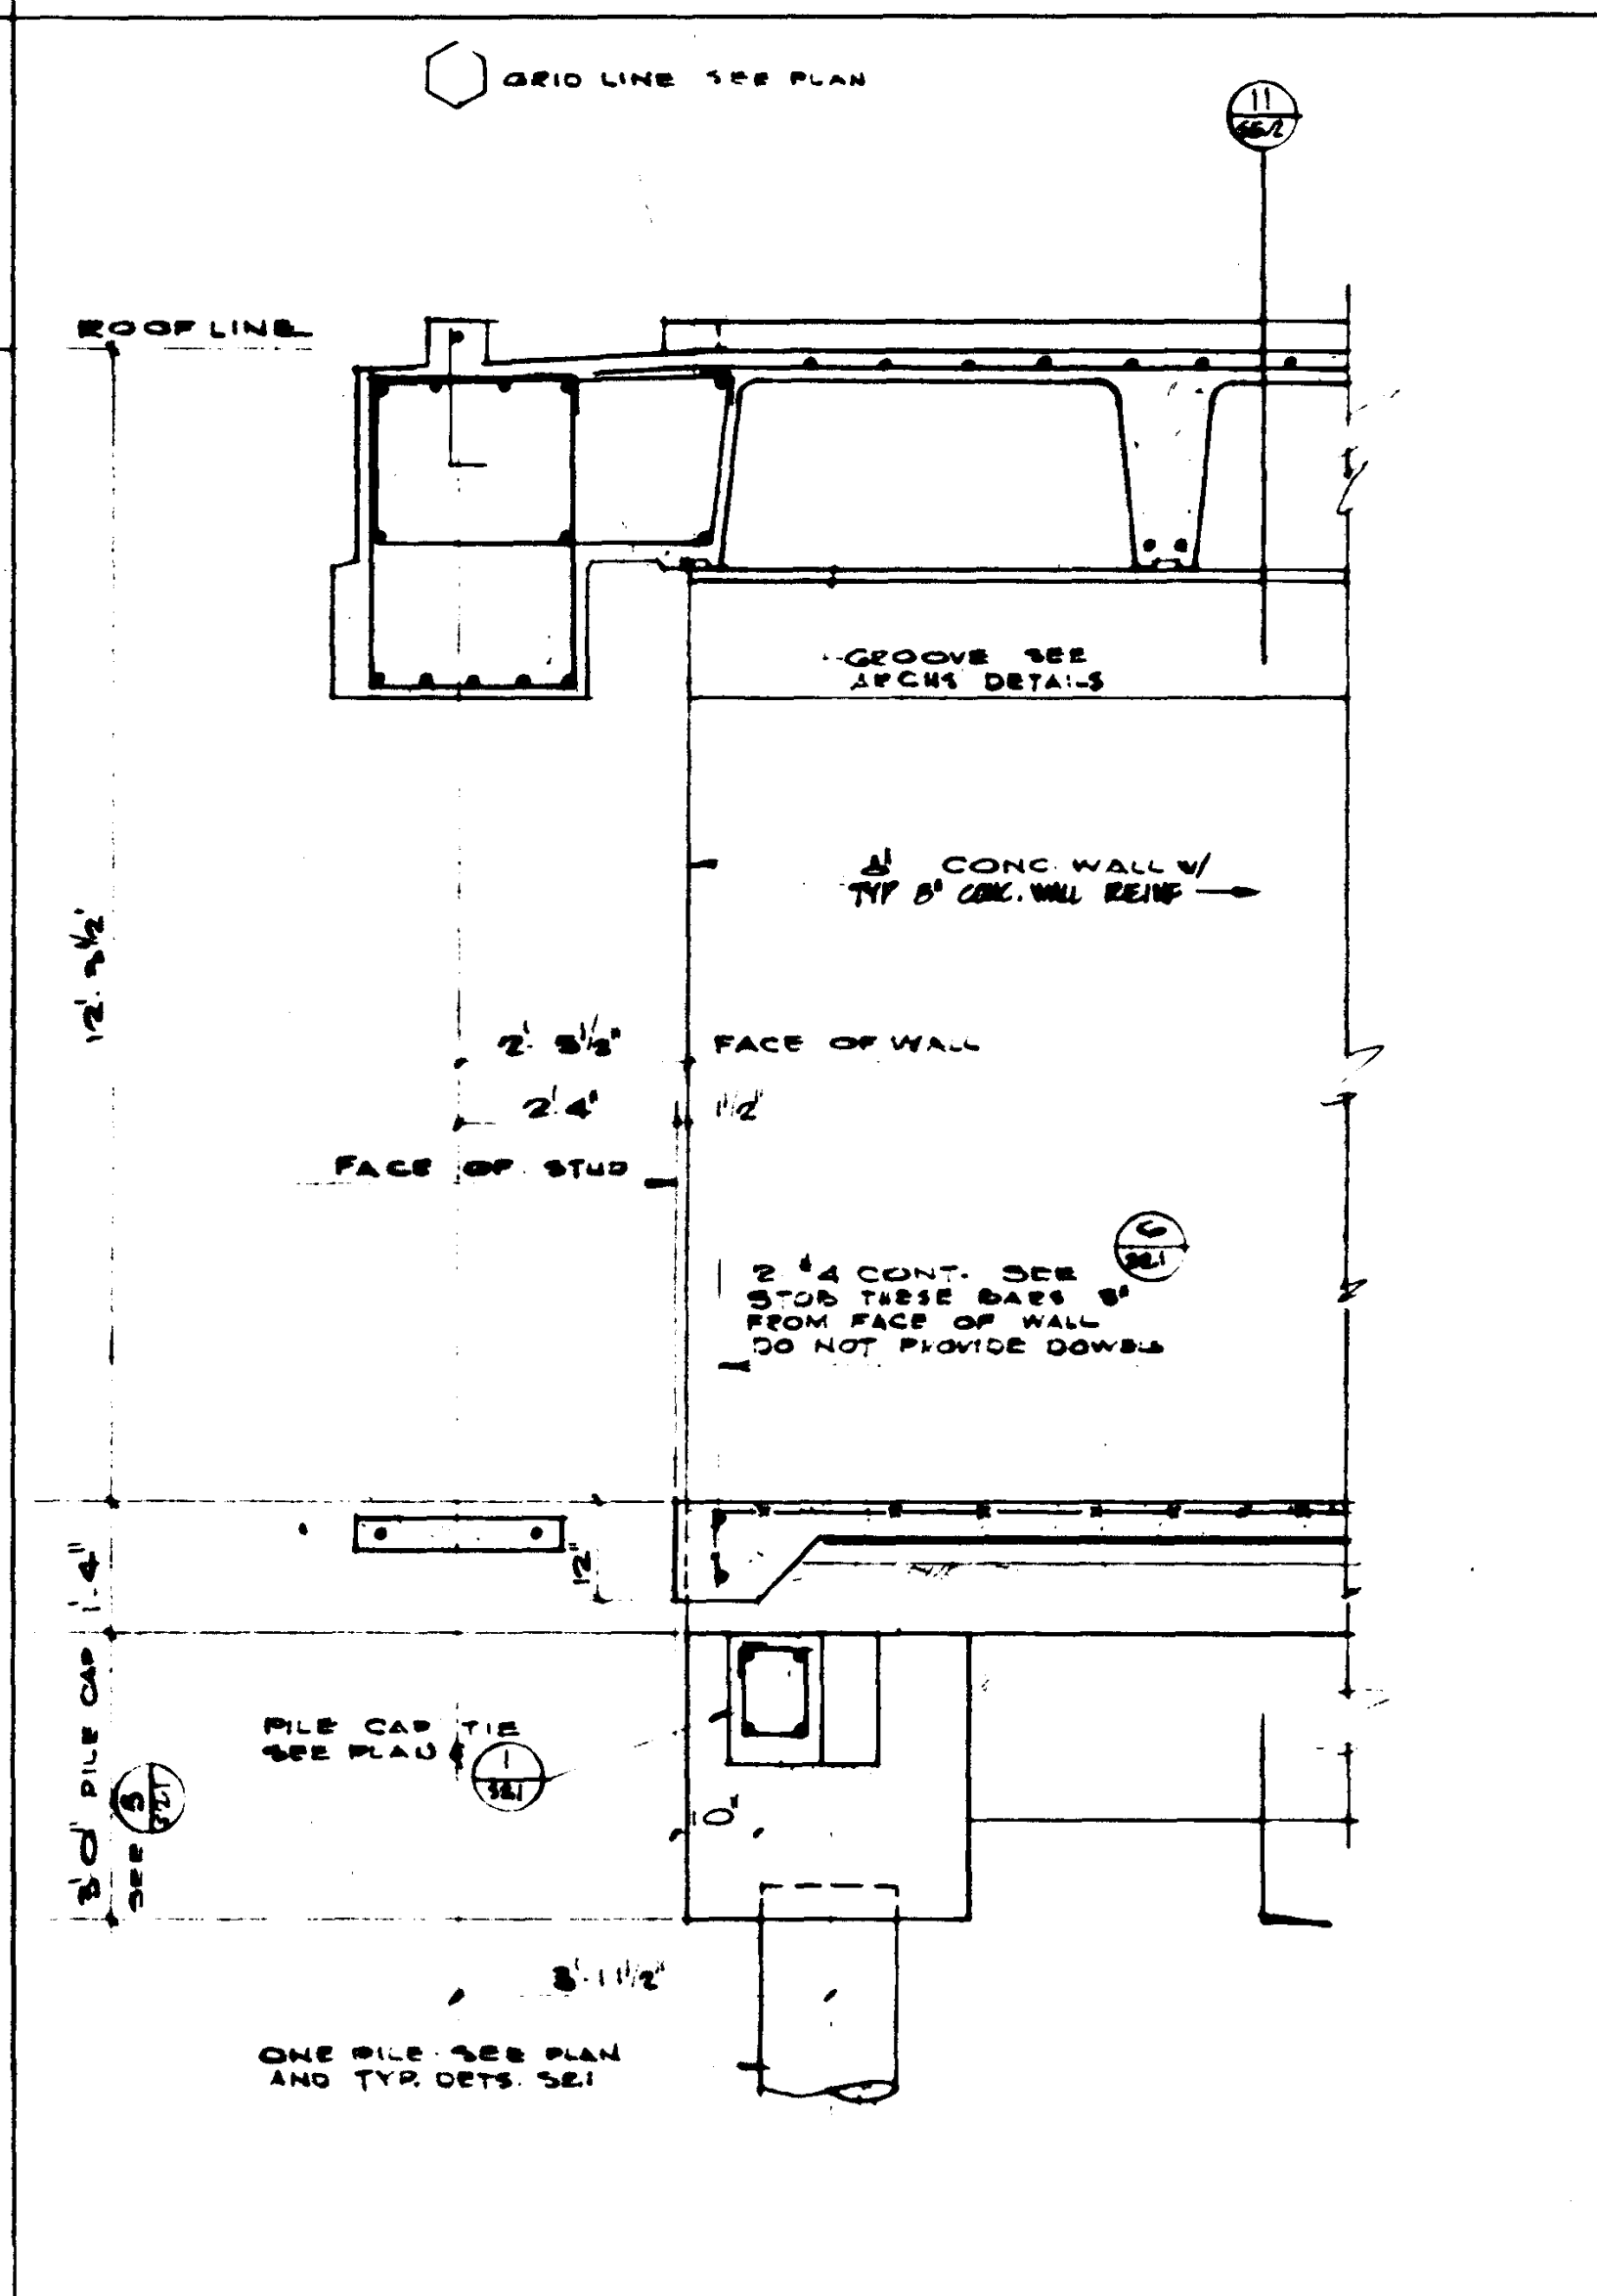
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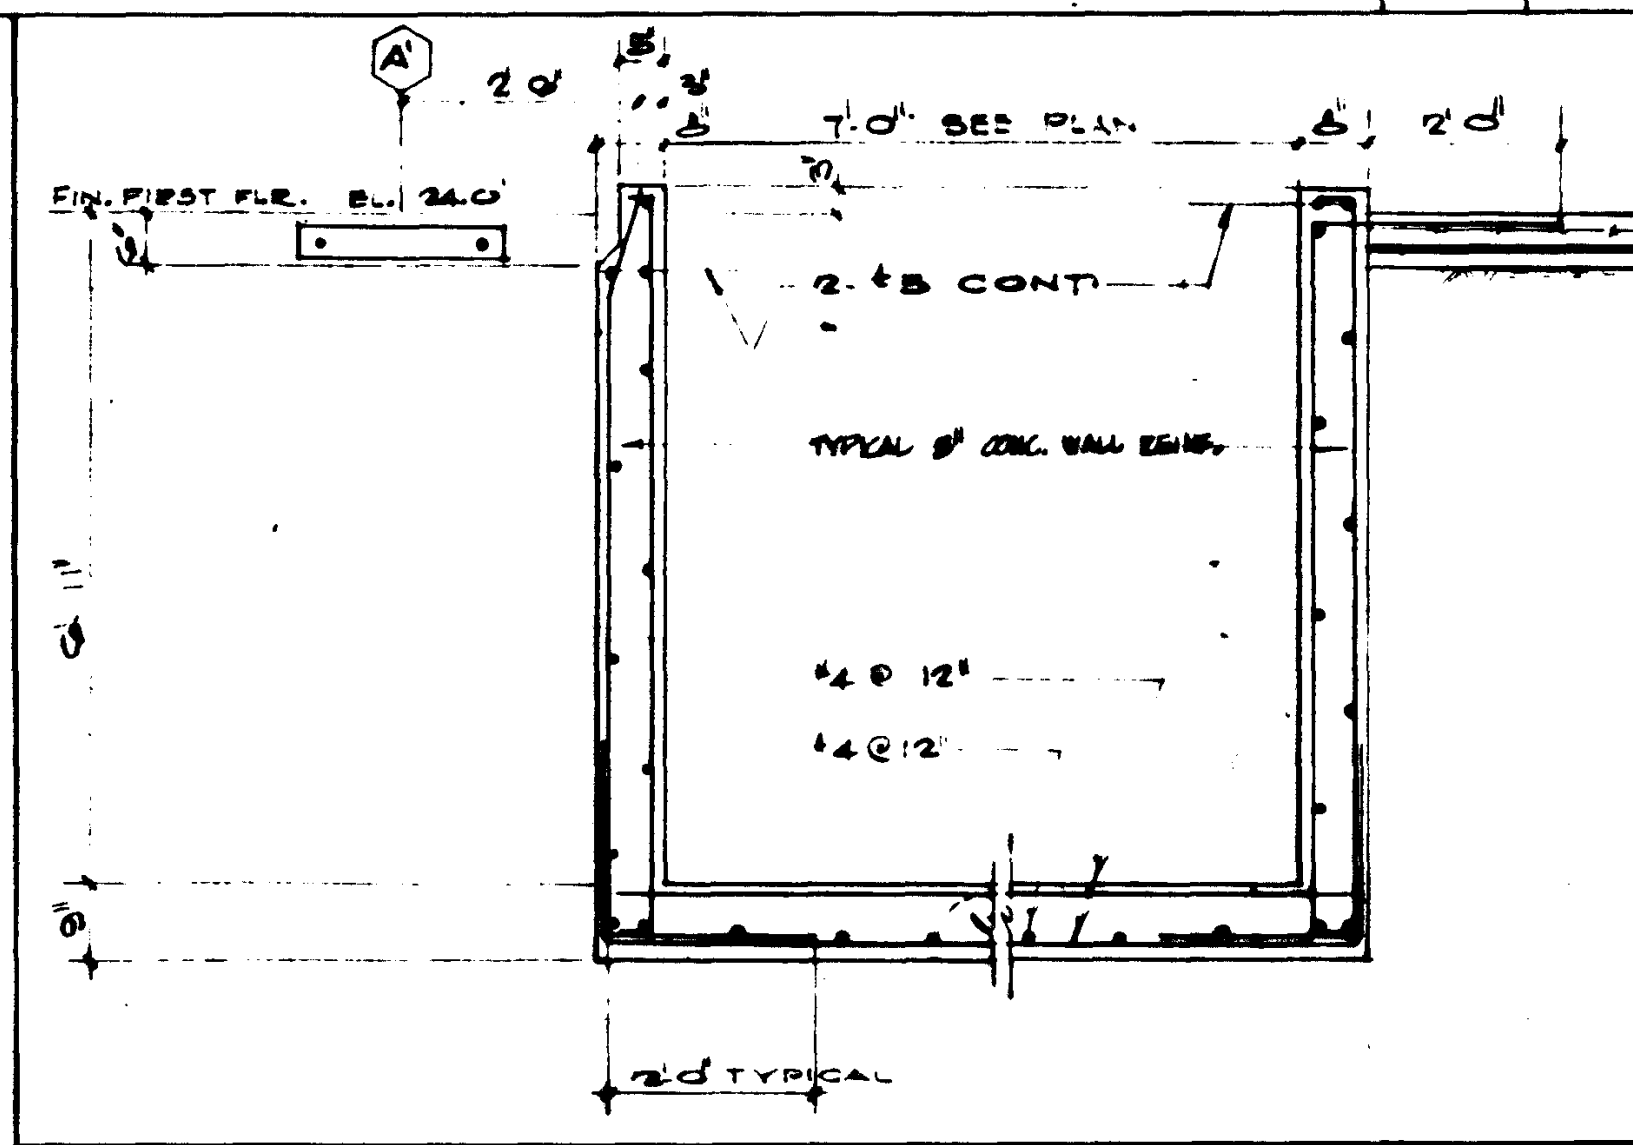
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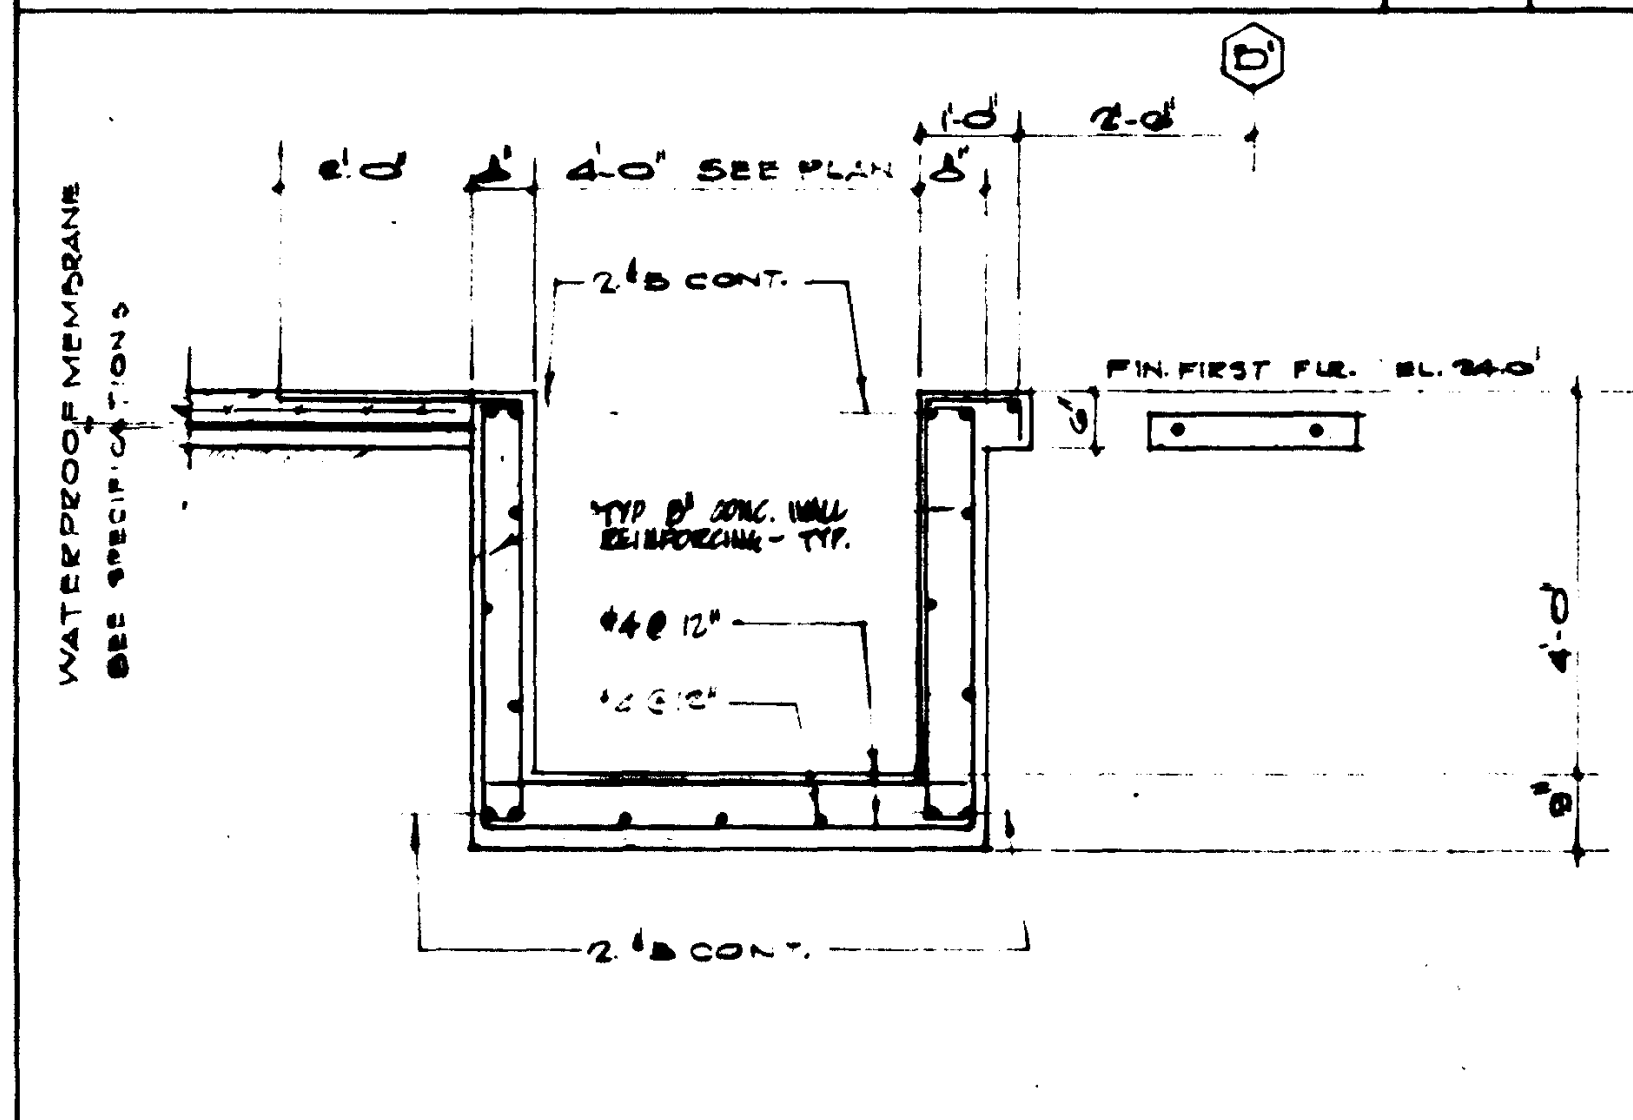
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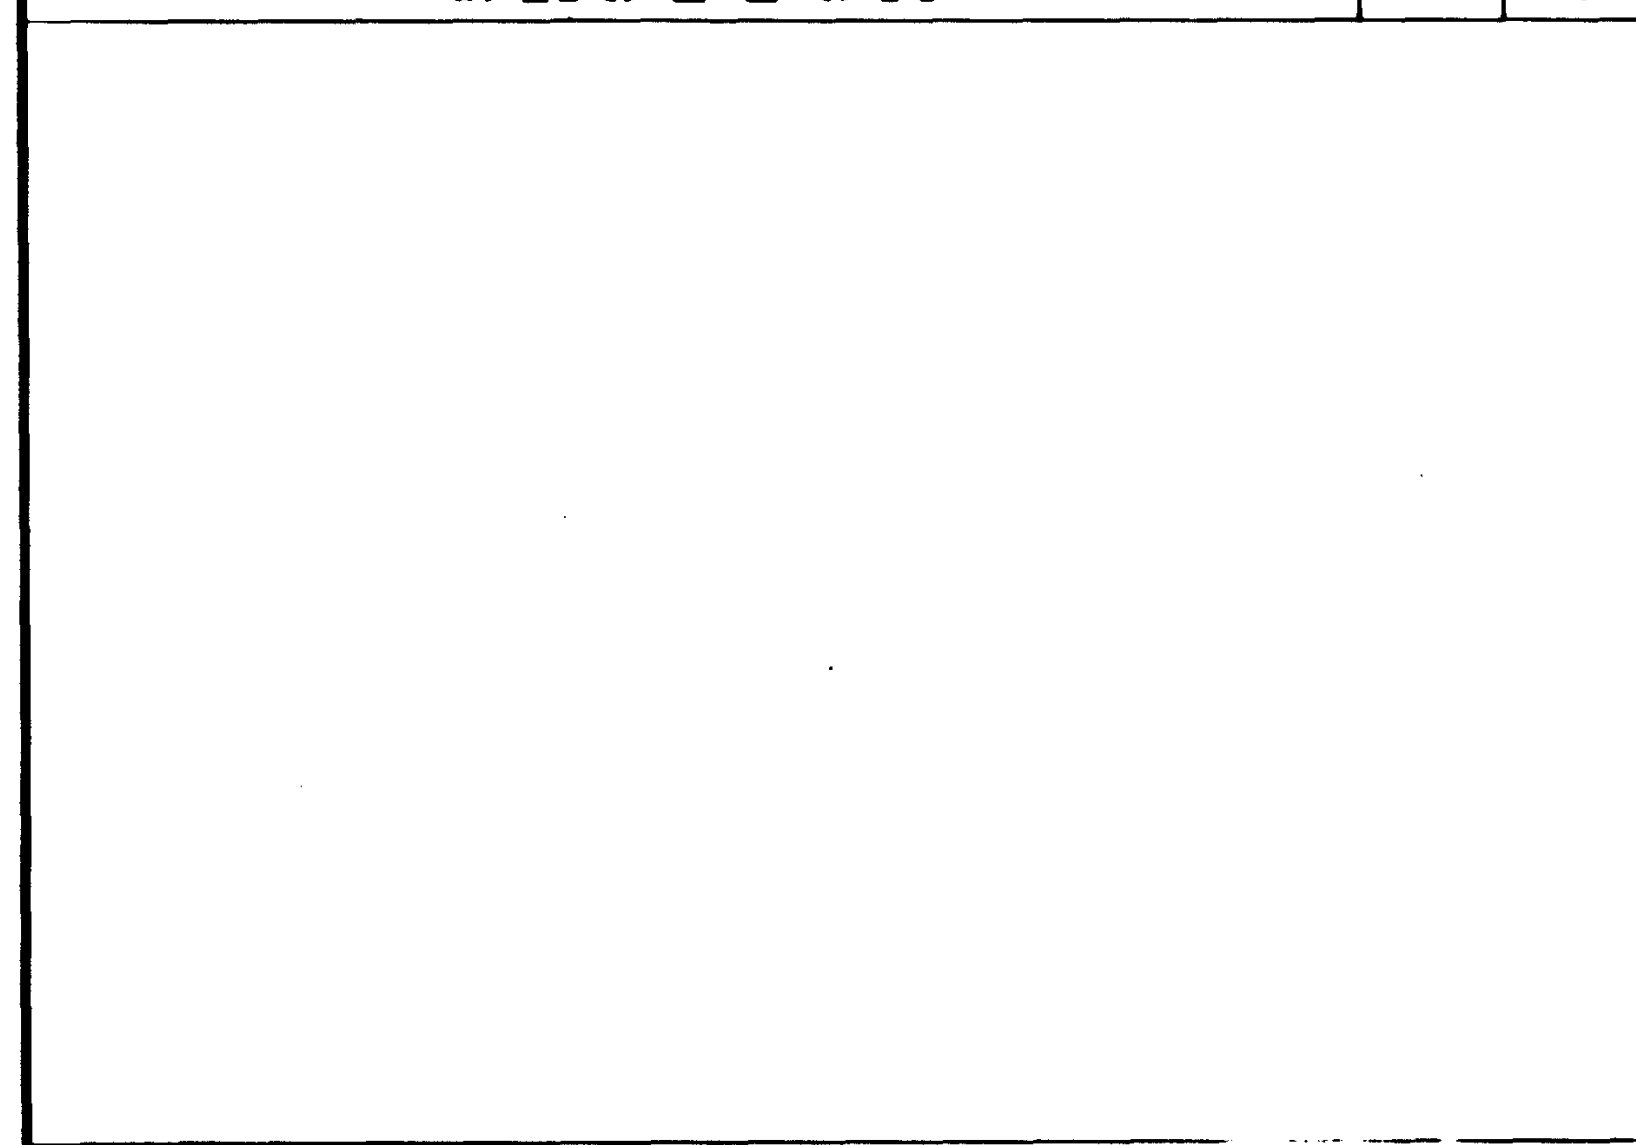
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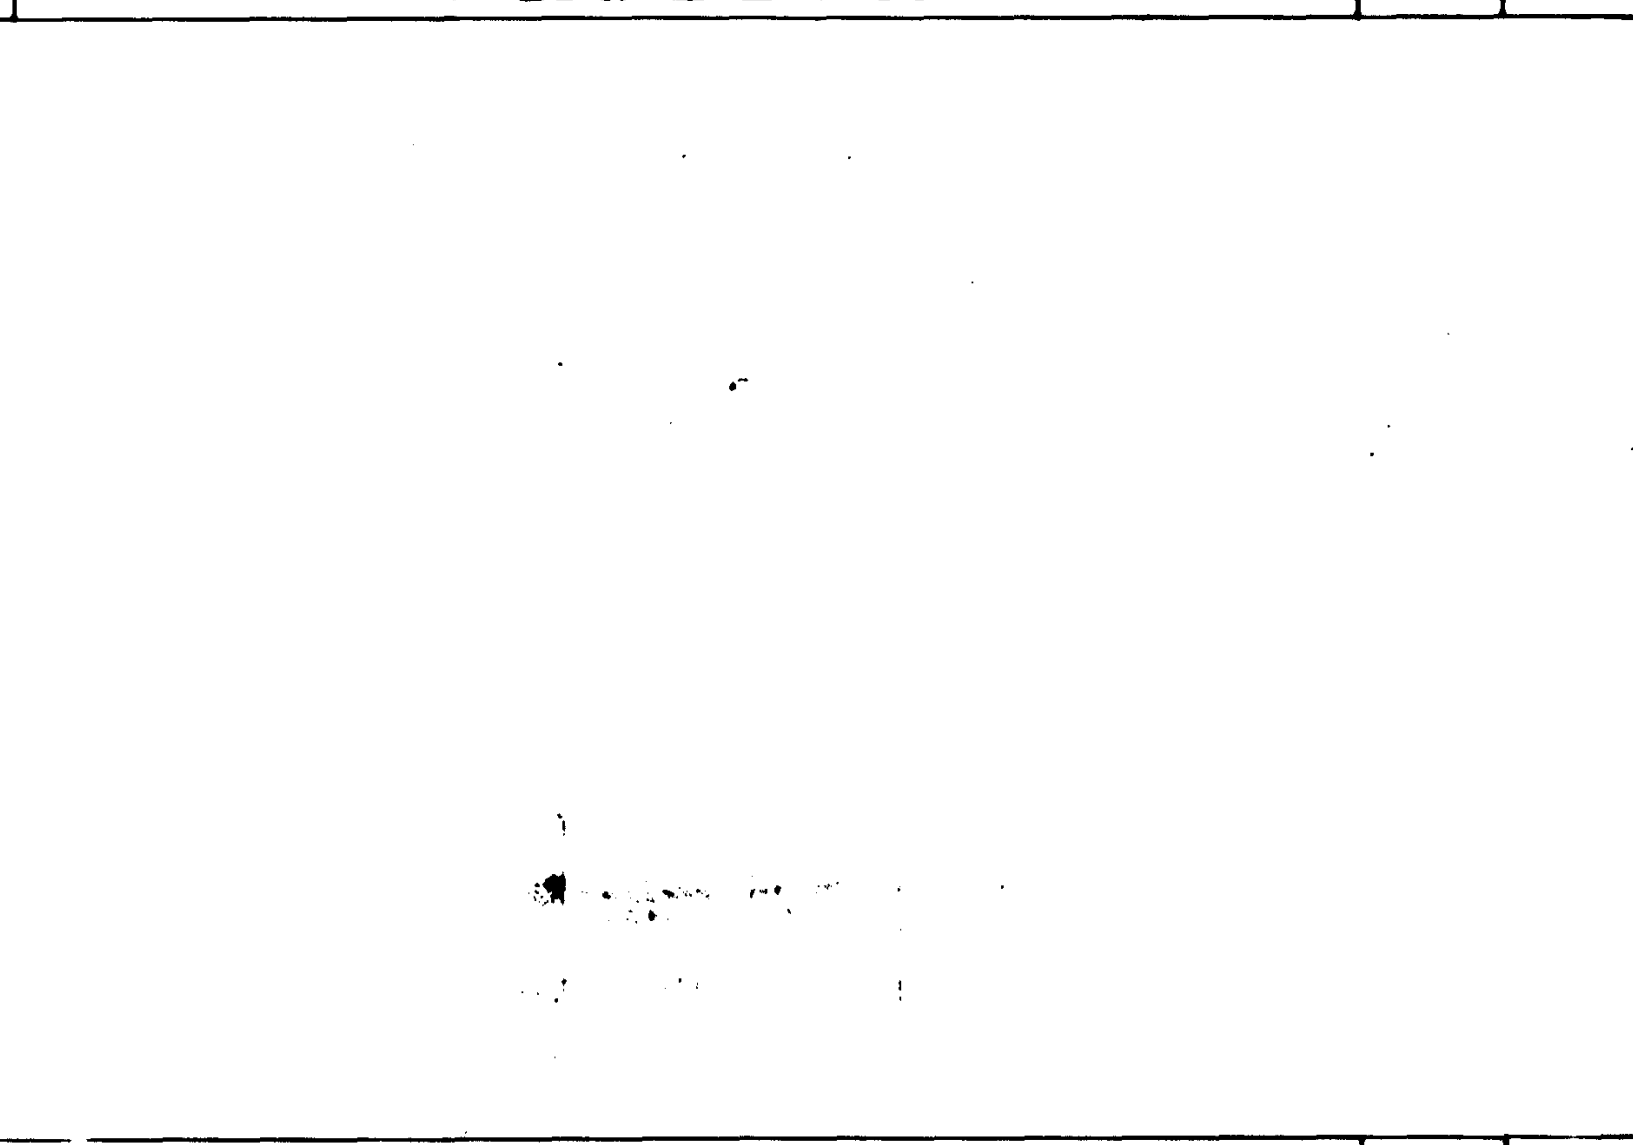
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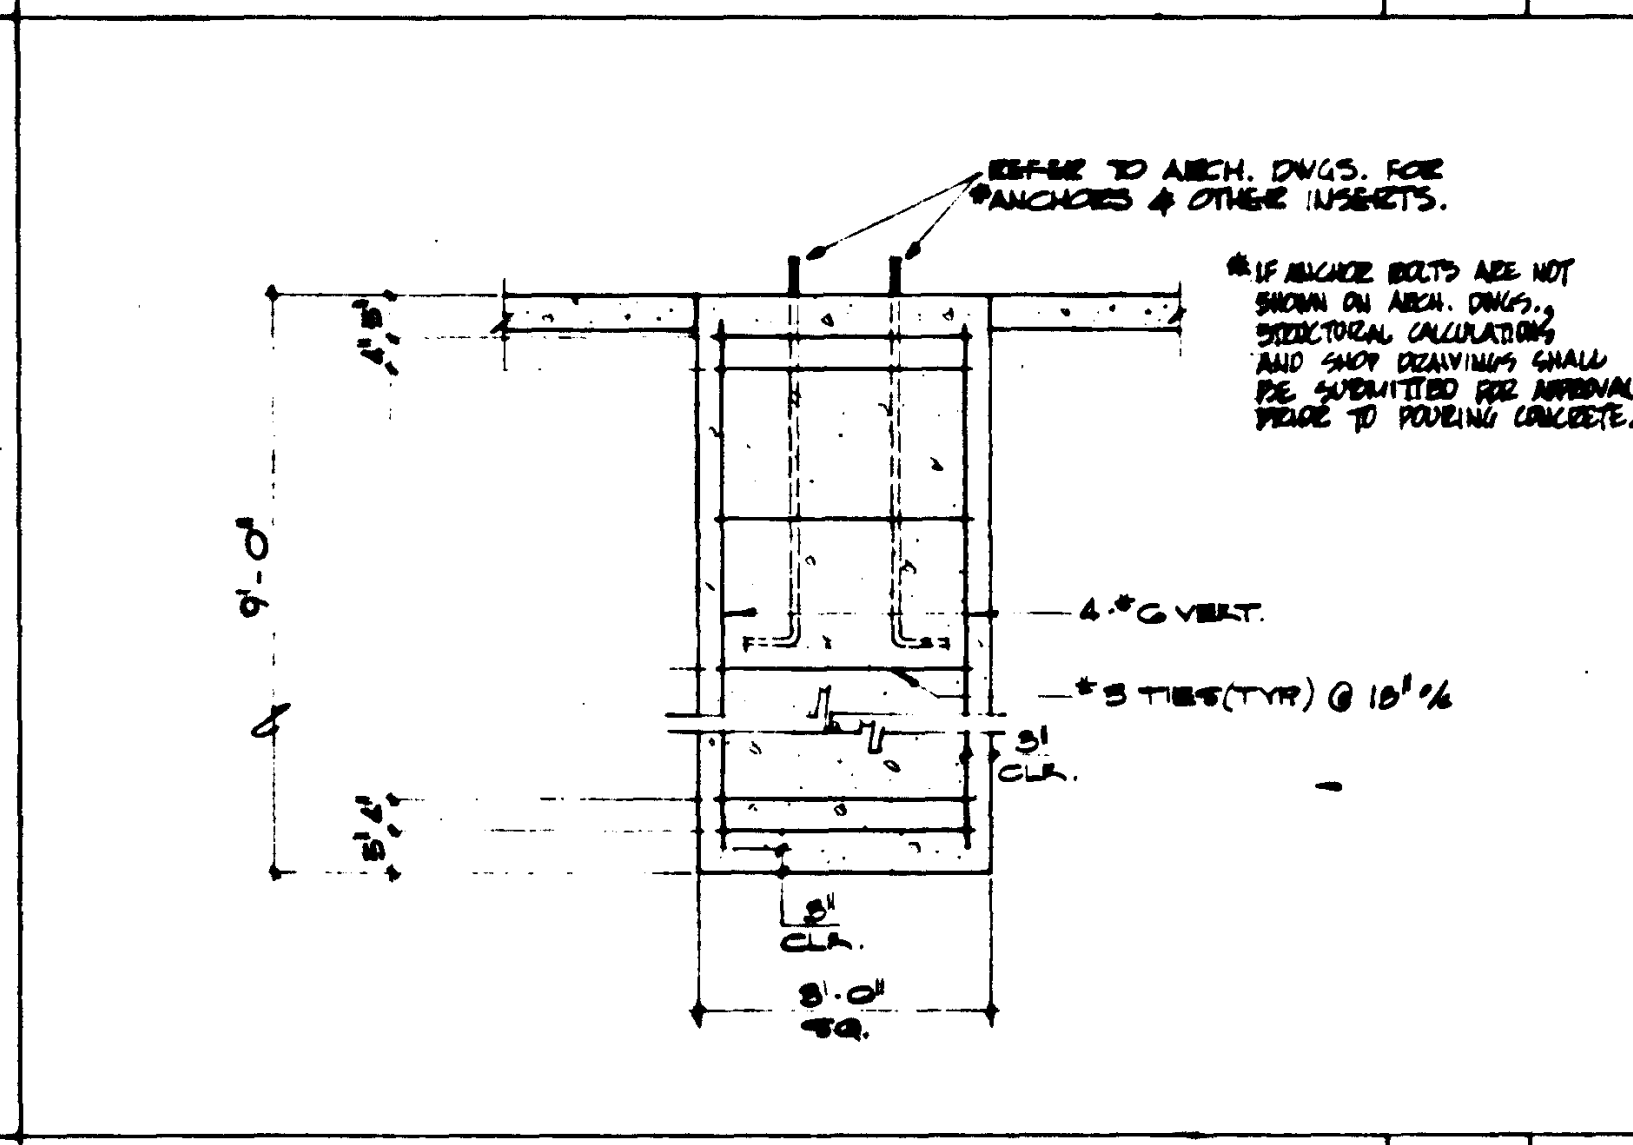
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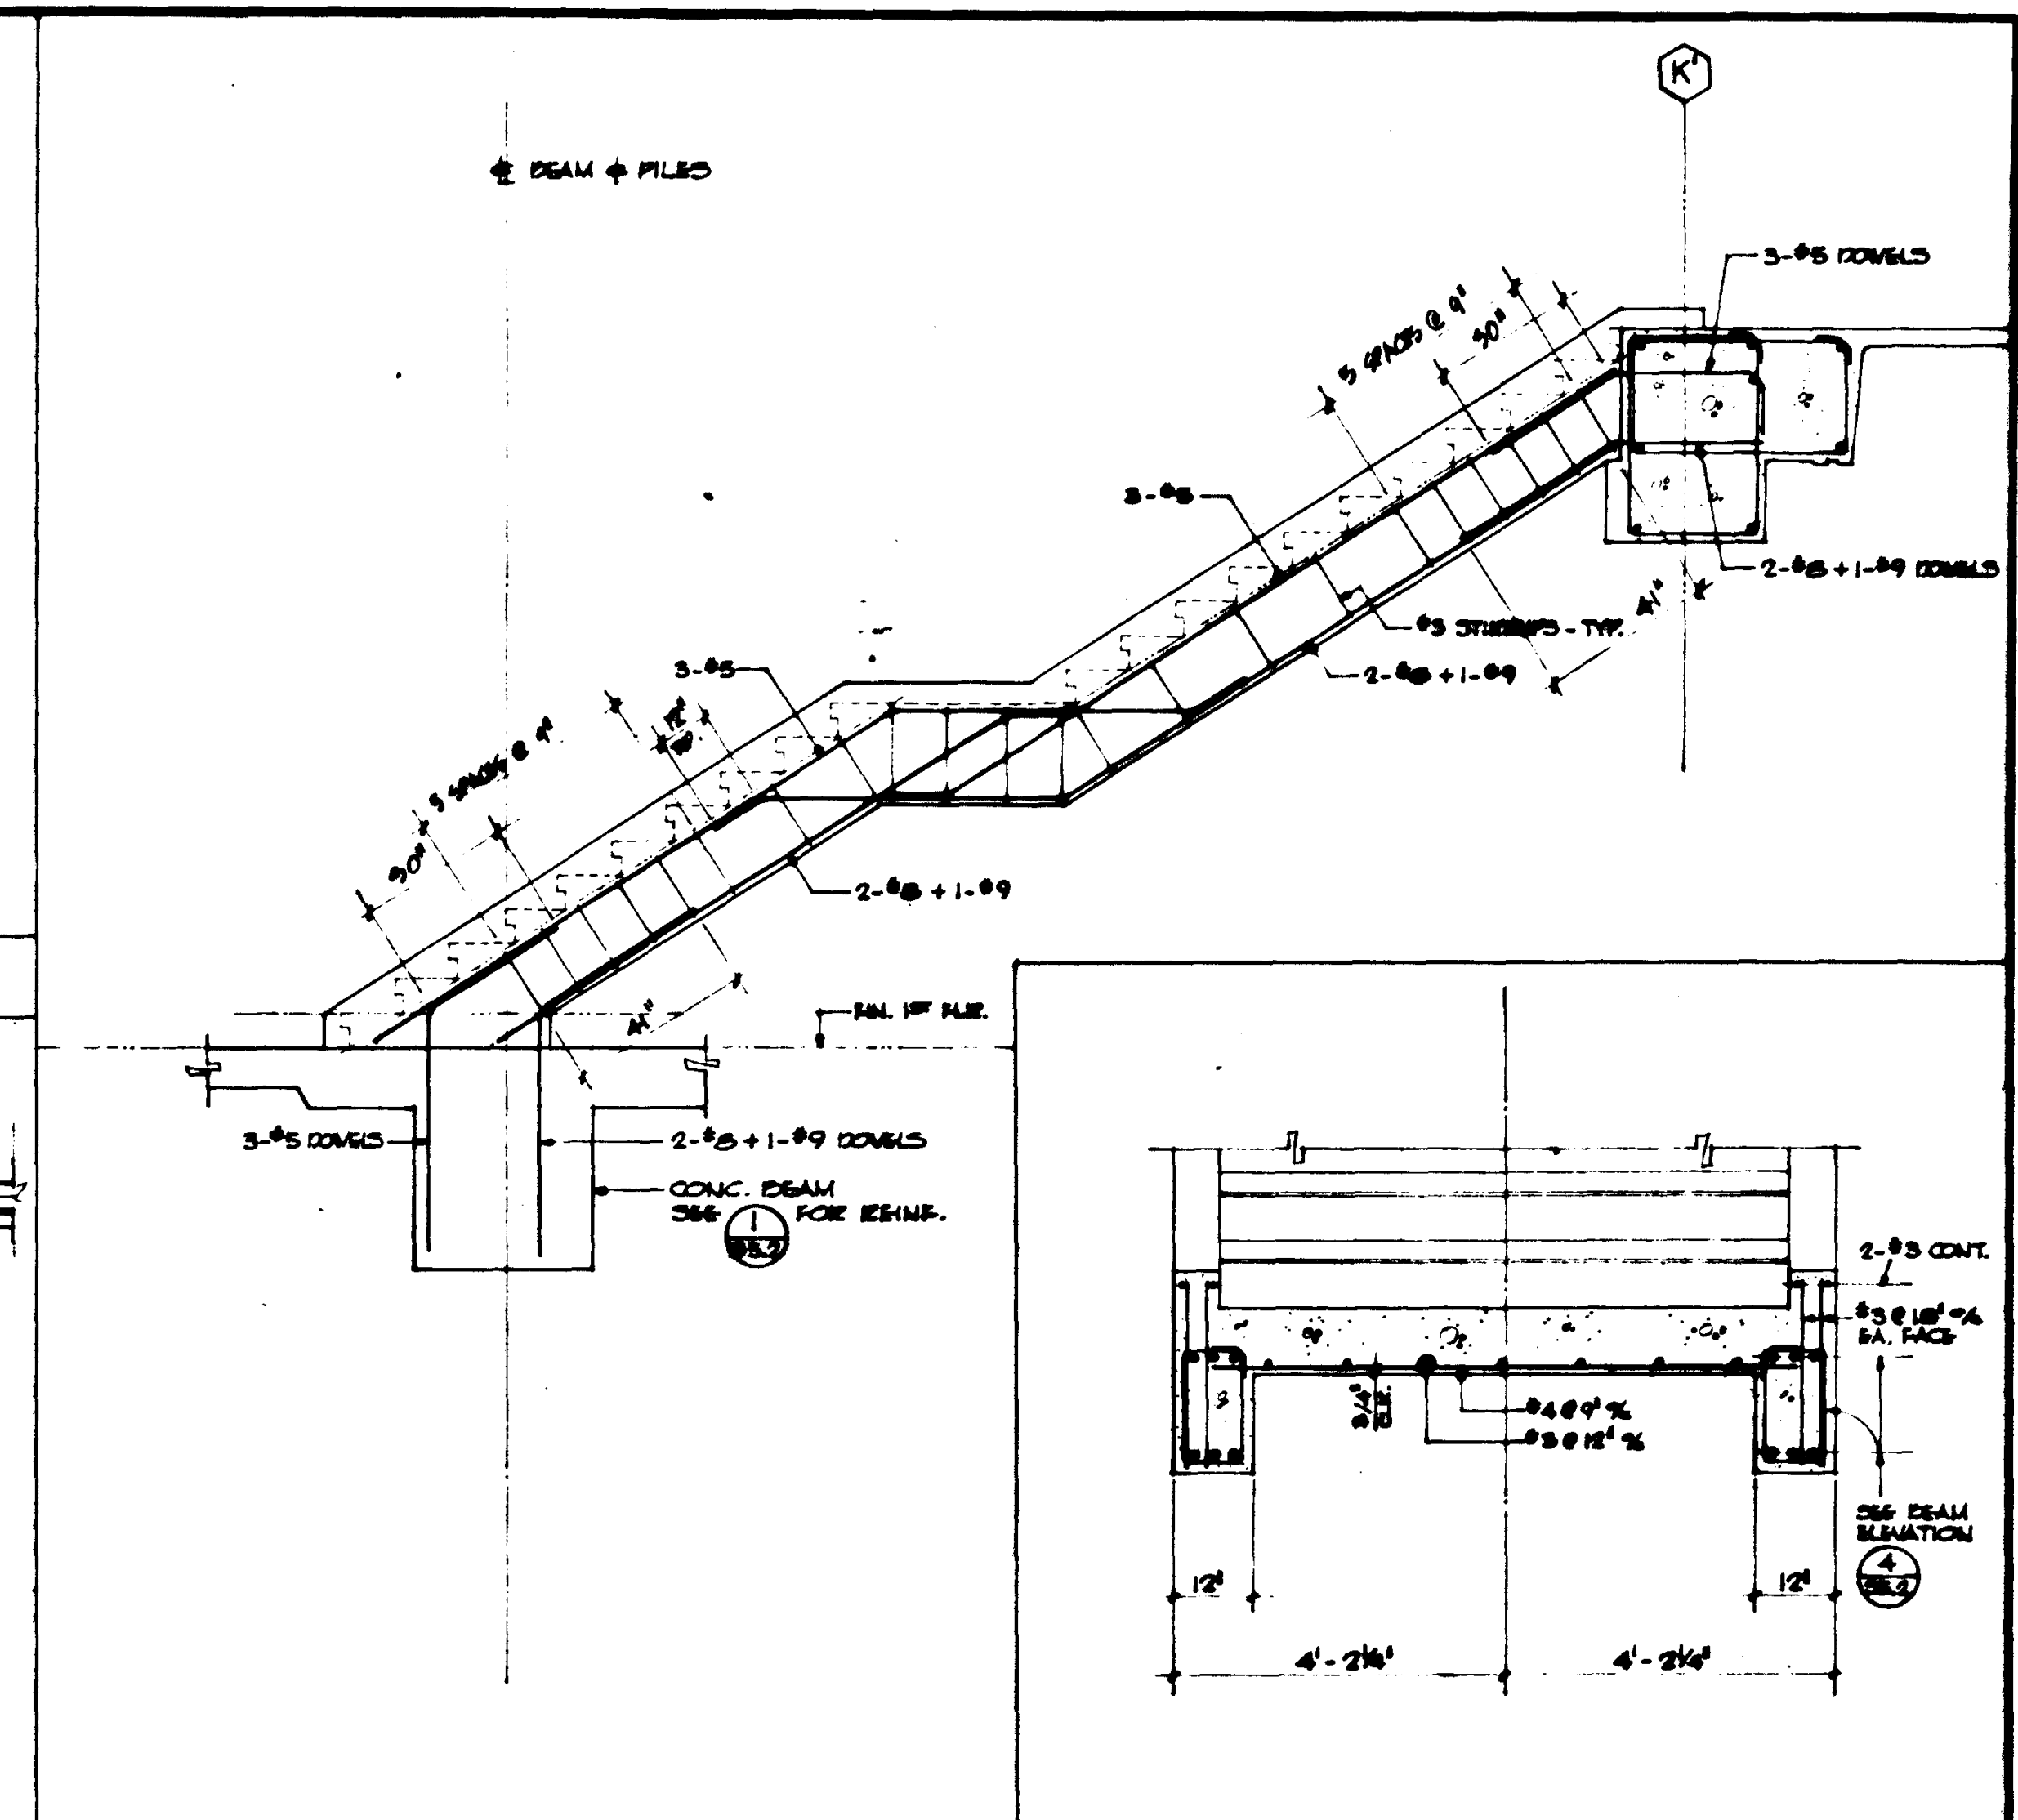
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SCALE 1/2" = 1'-0"

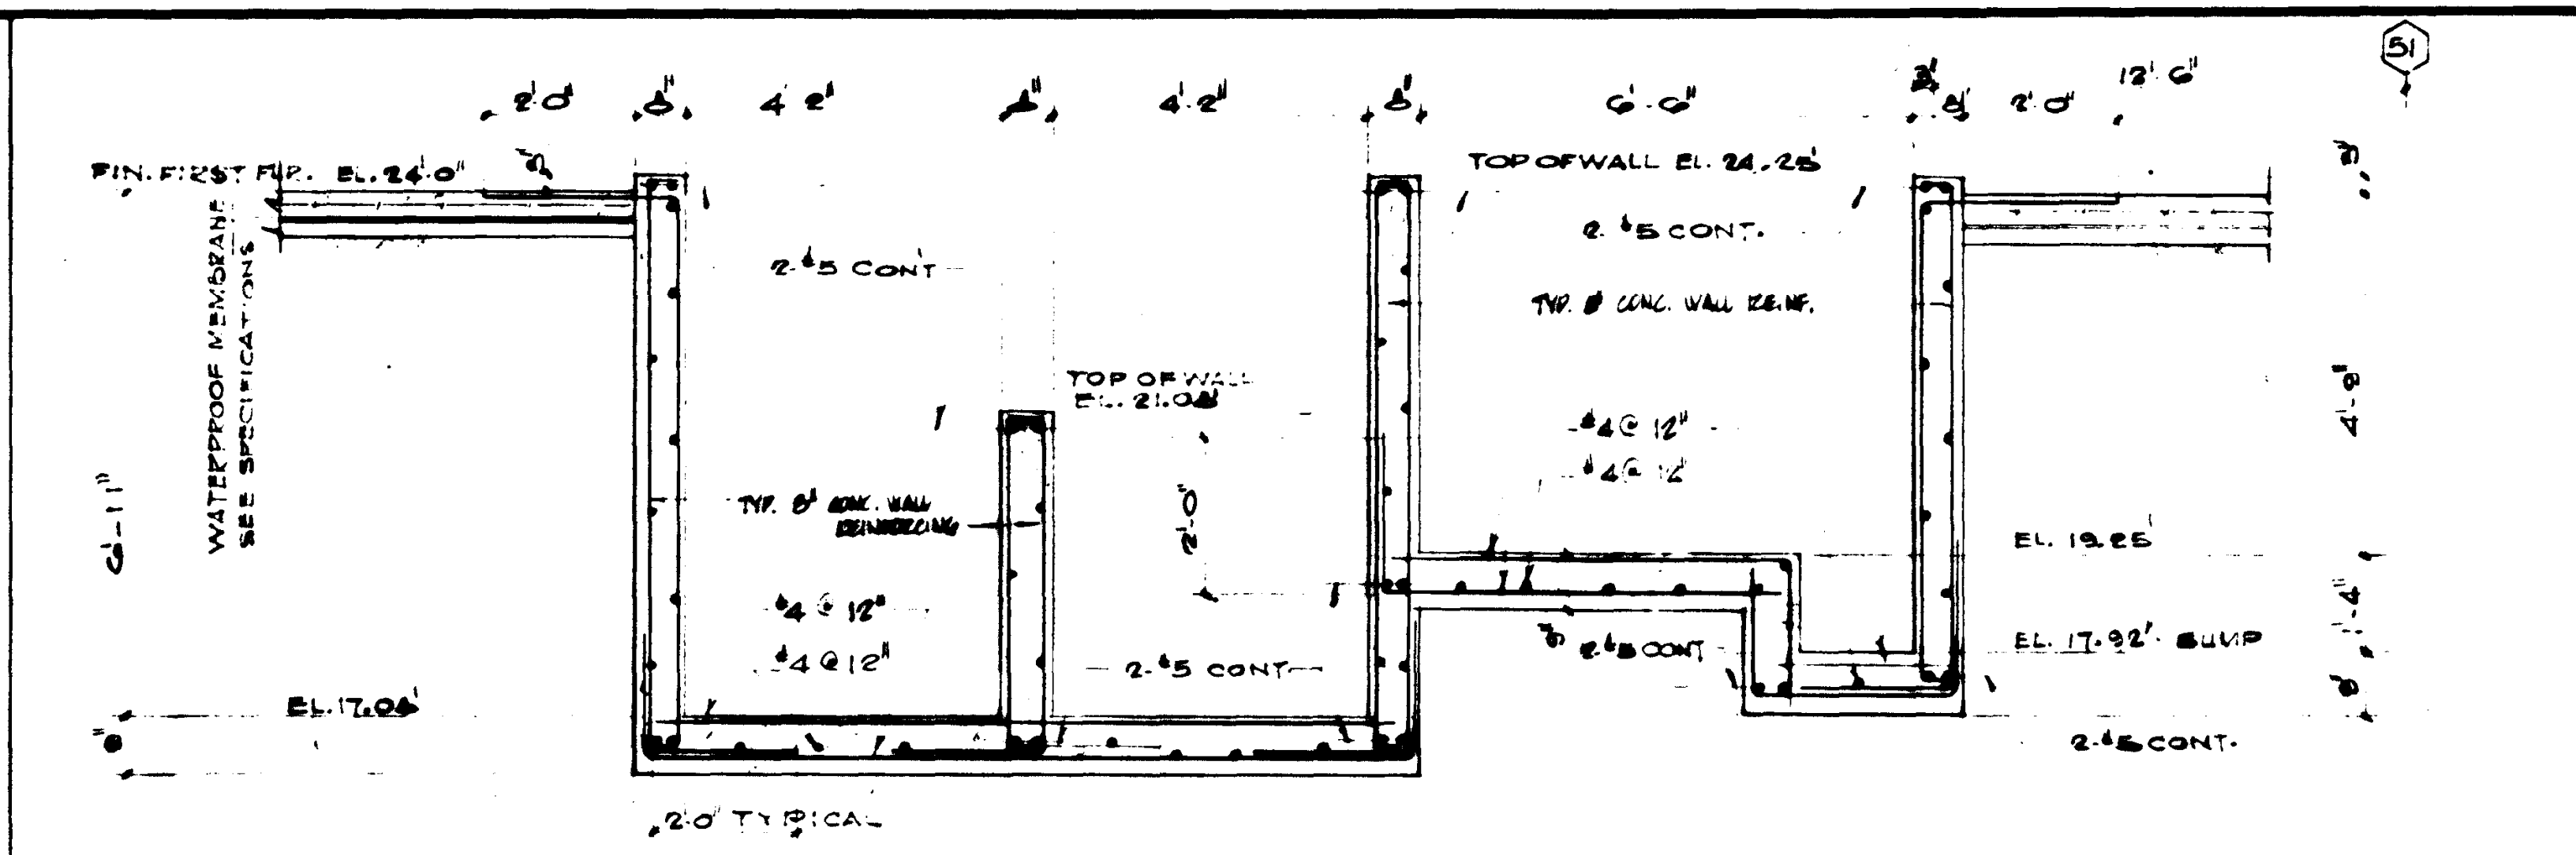


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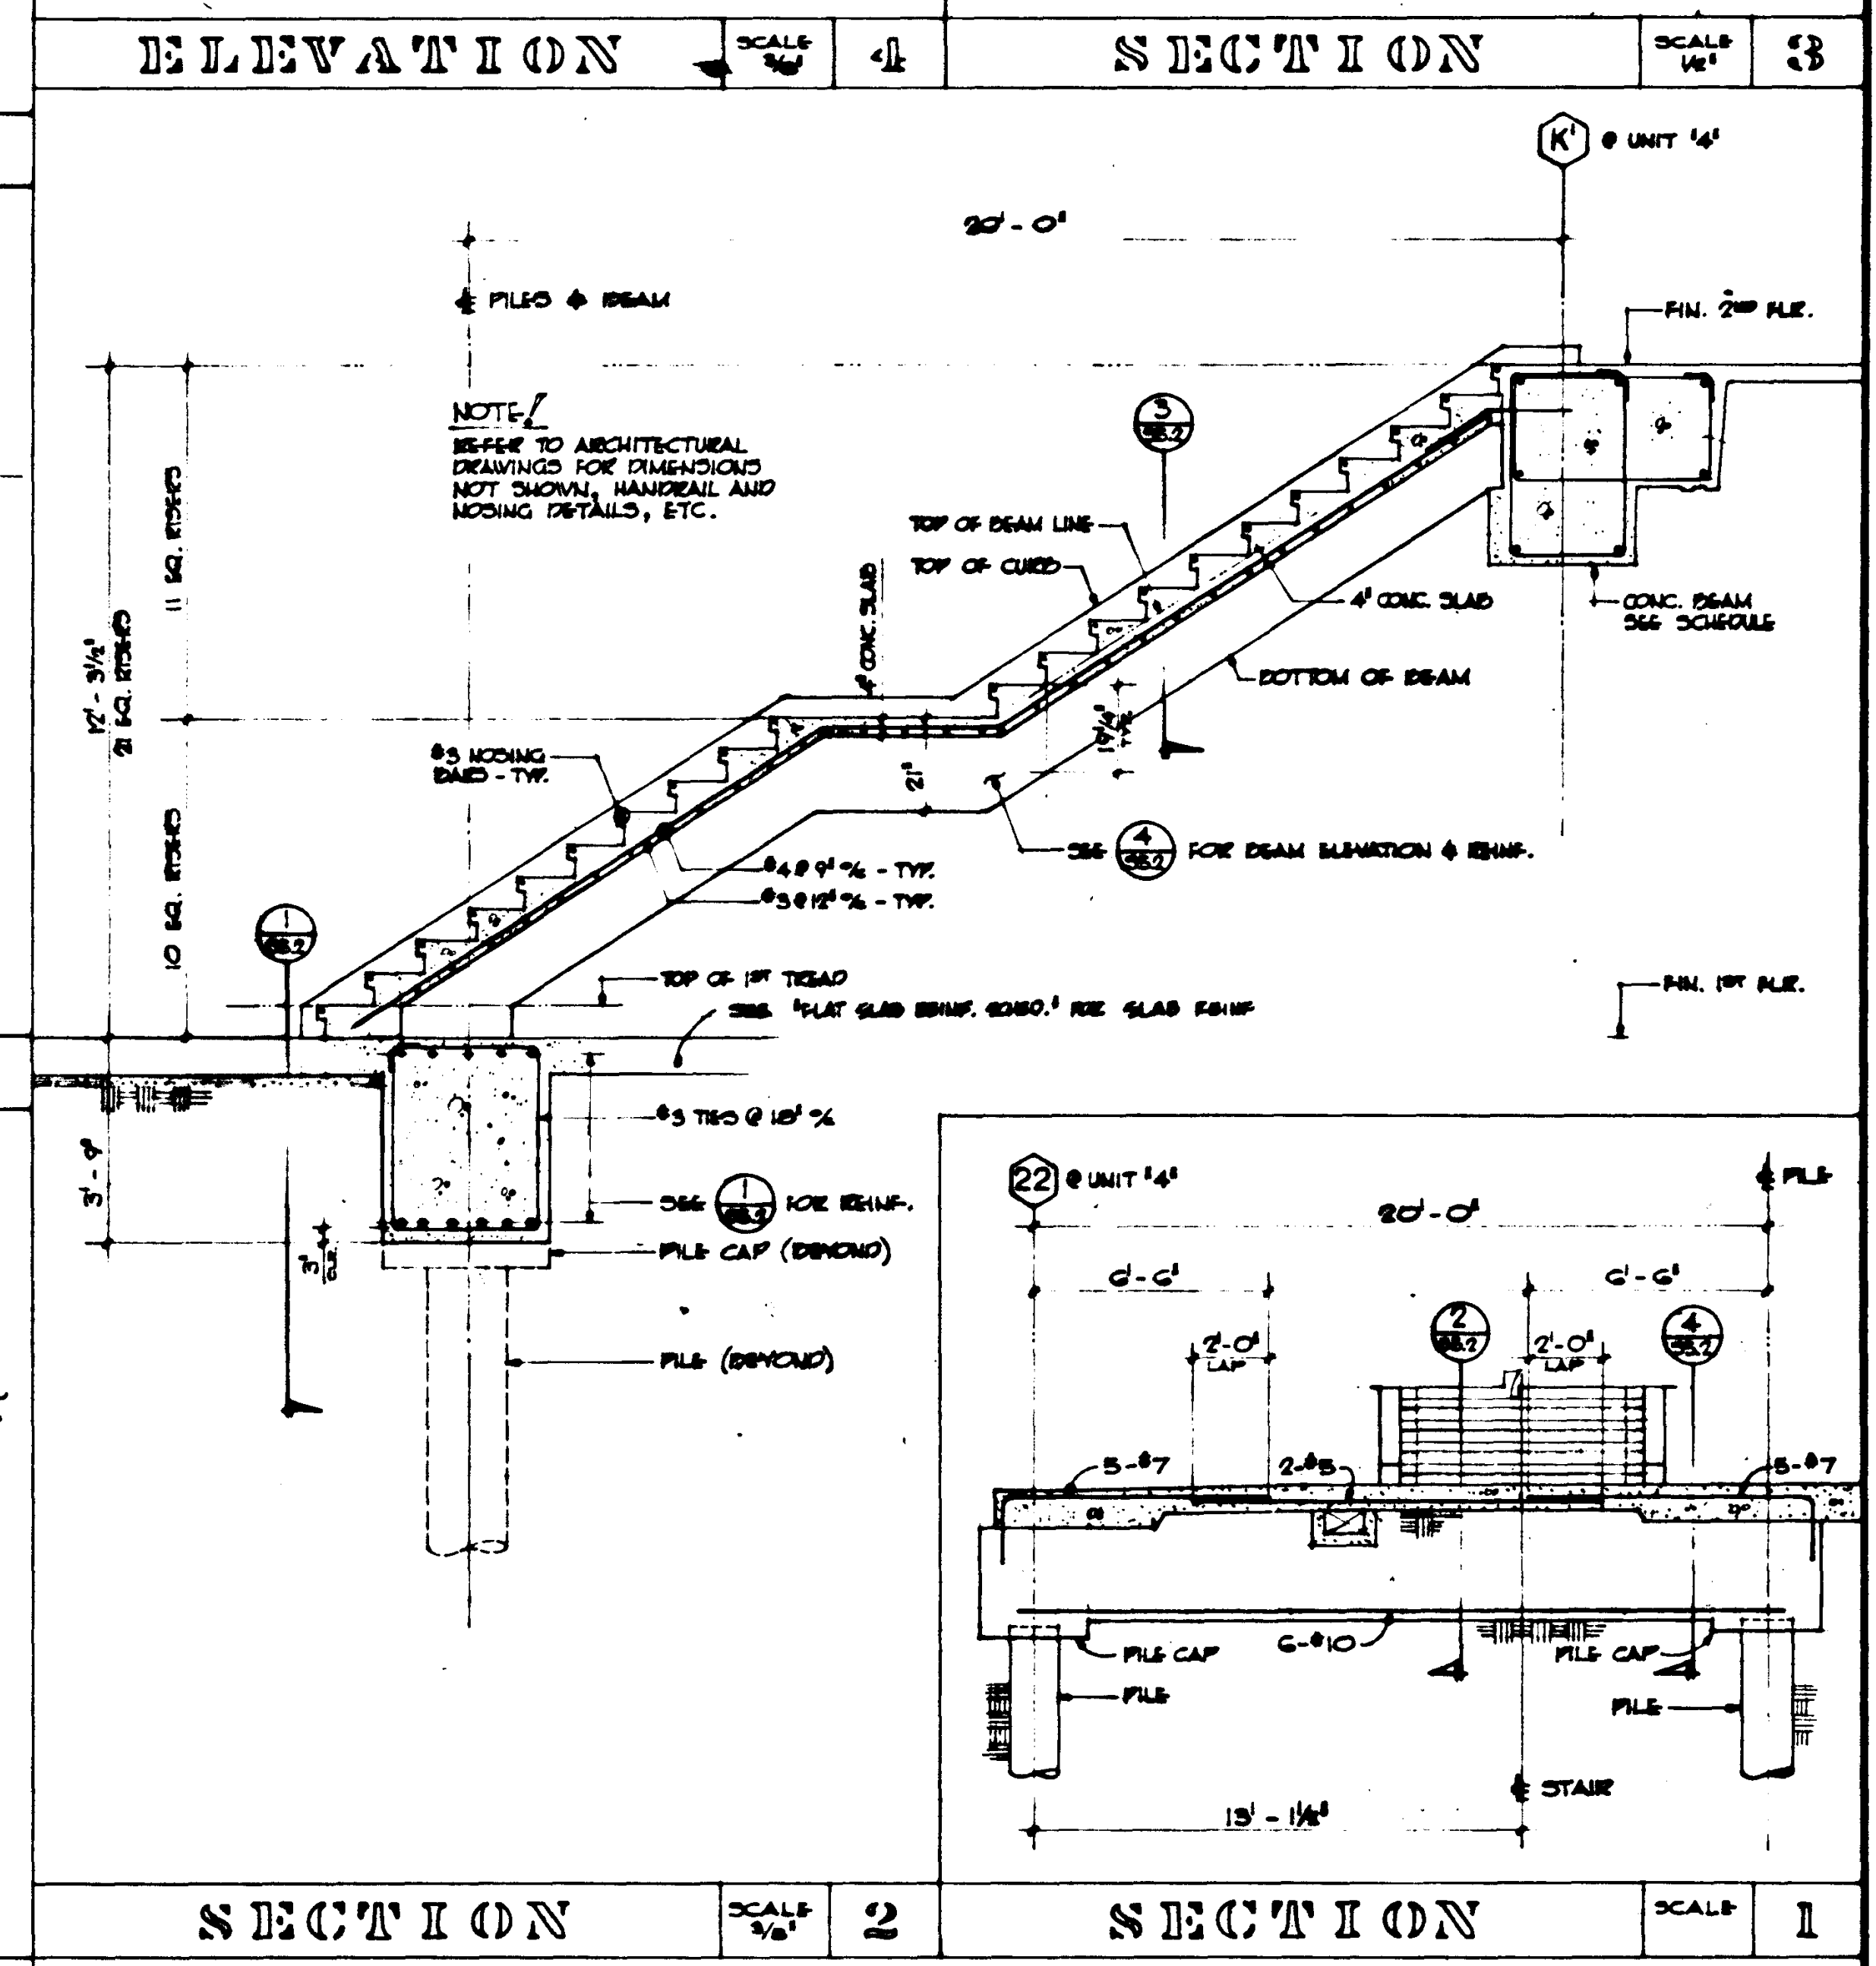
ELEVATION

SCALE 1/2" = 1'-0"

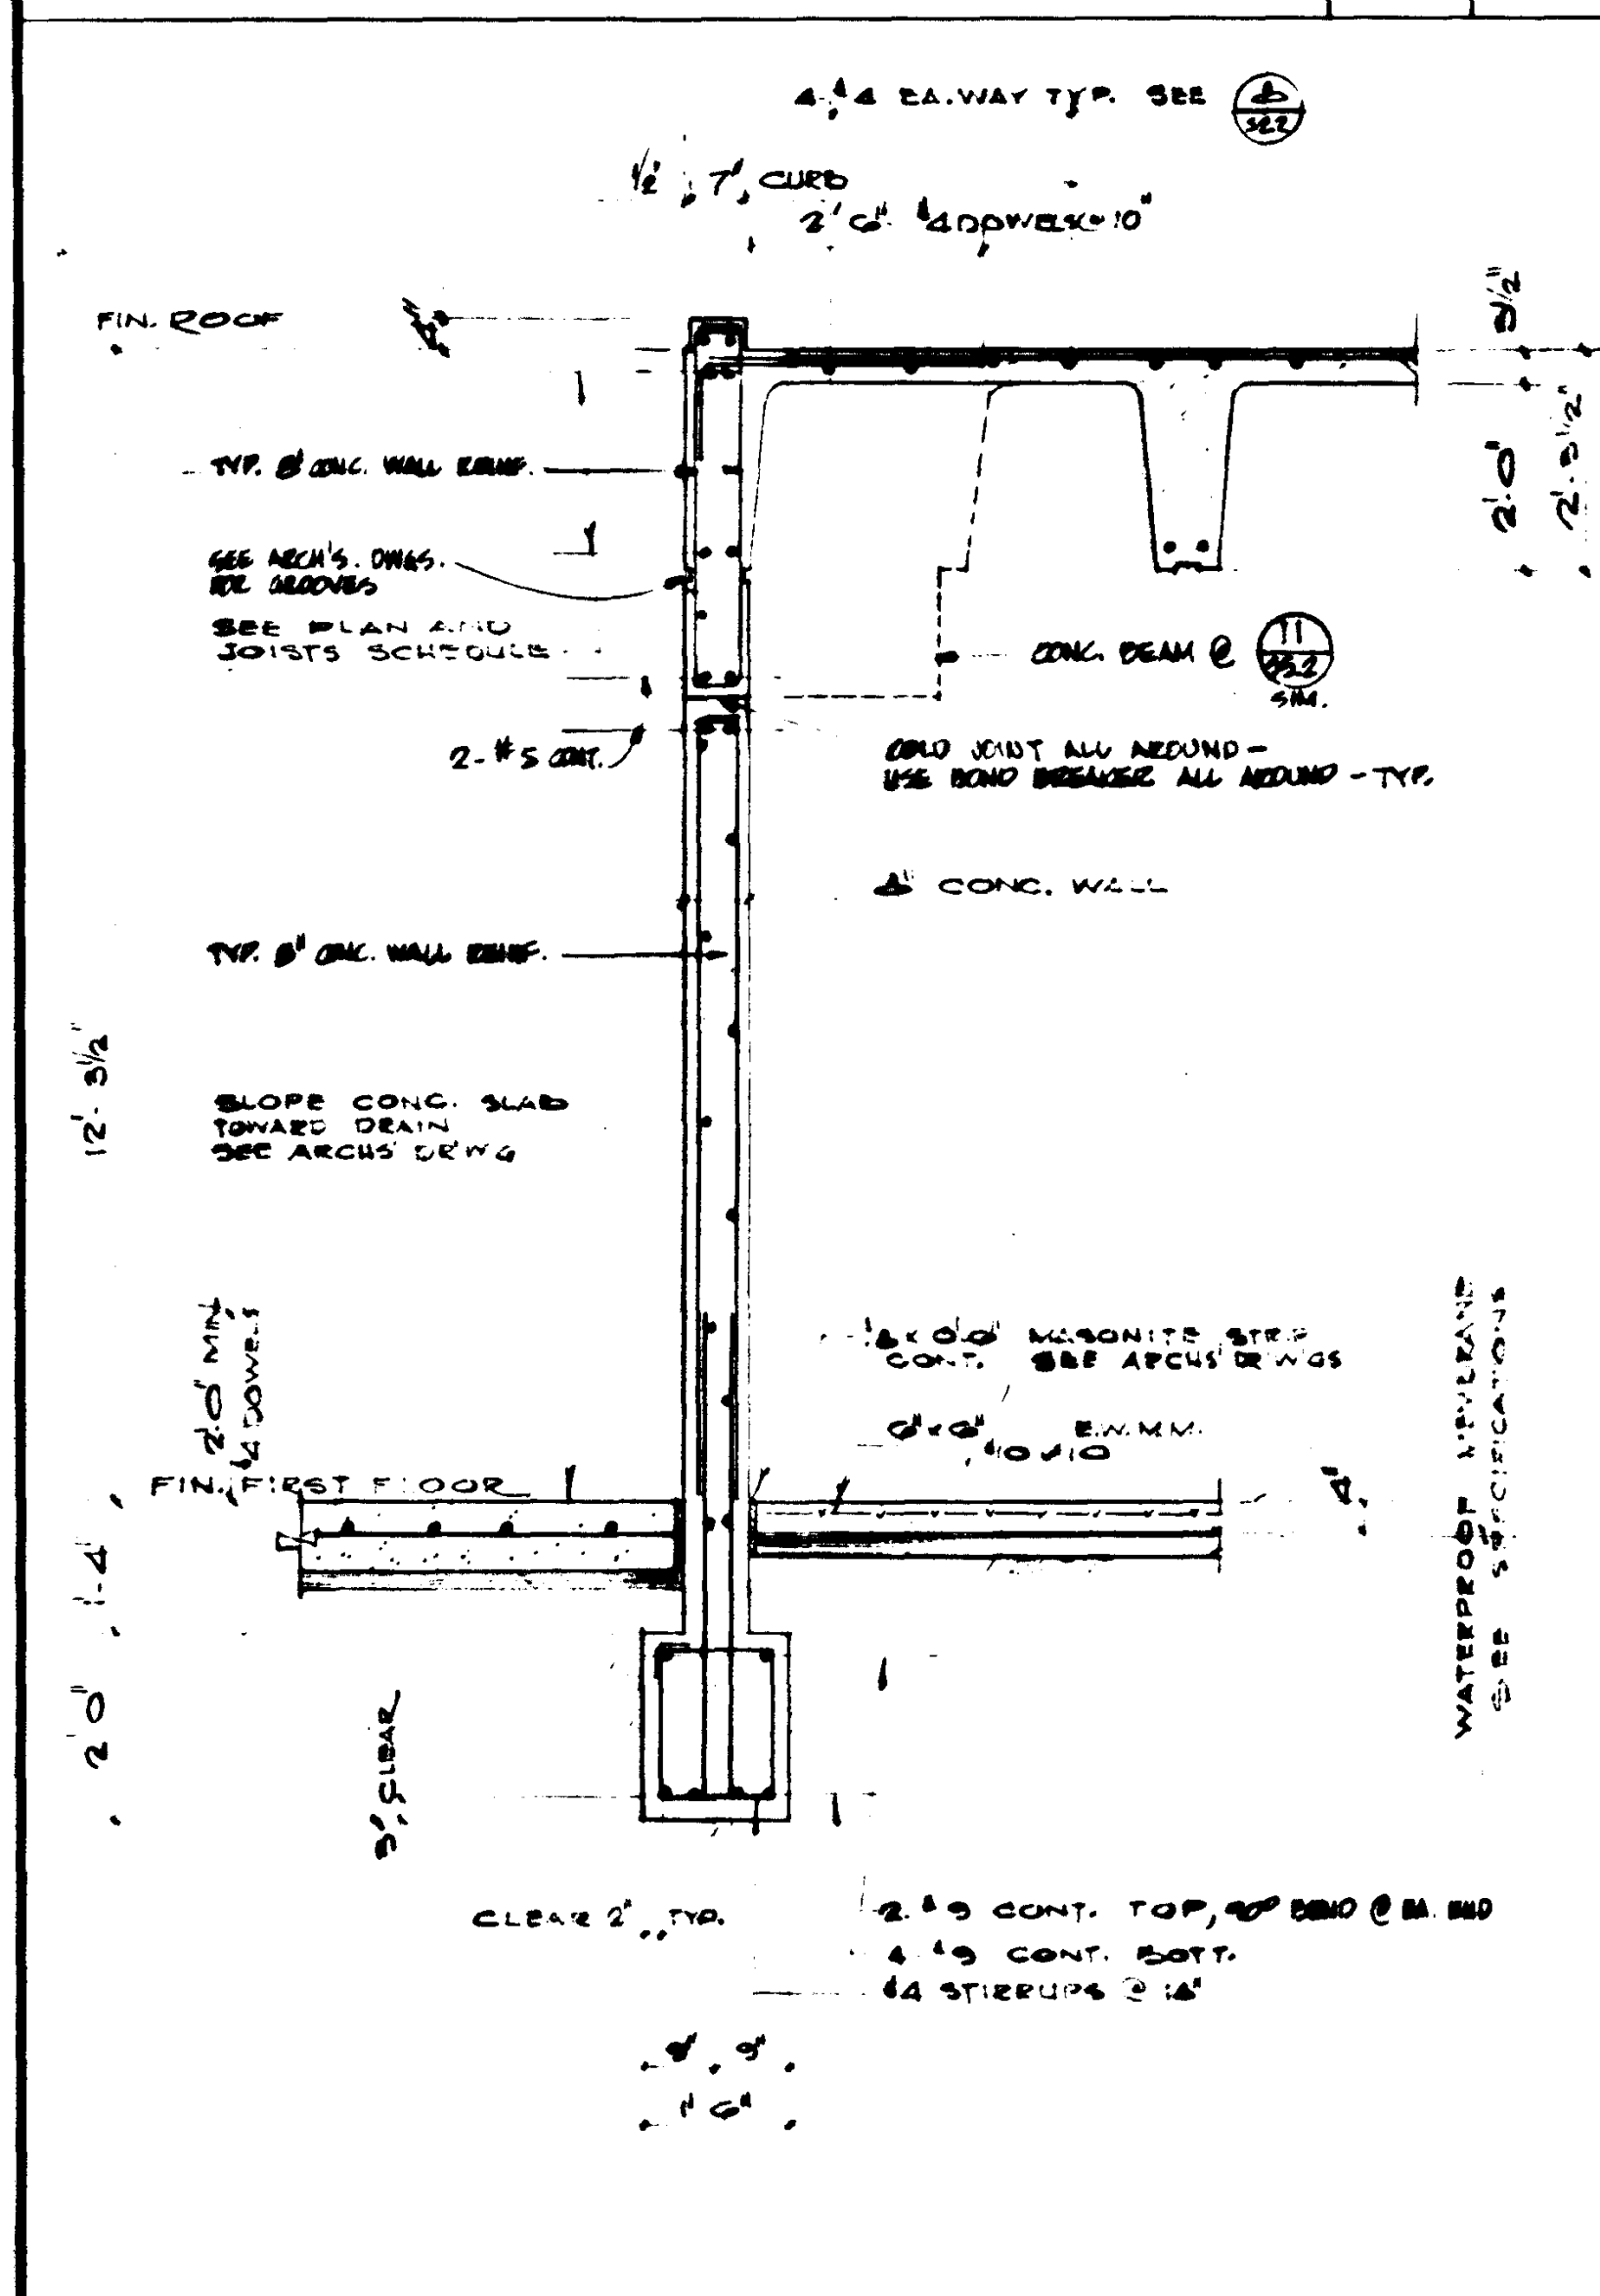


SECTION

SCALE 1/2" = 1'-0"

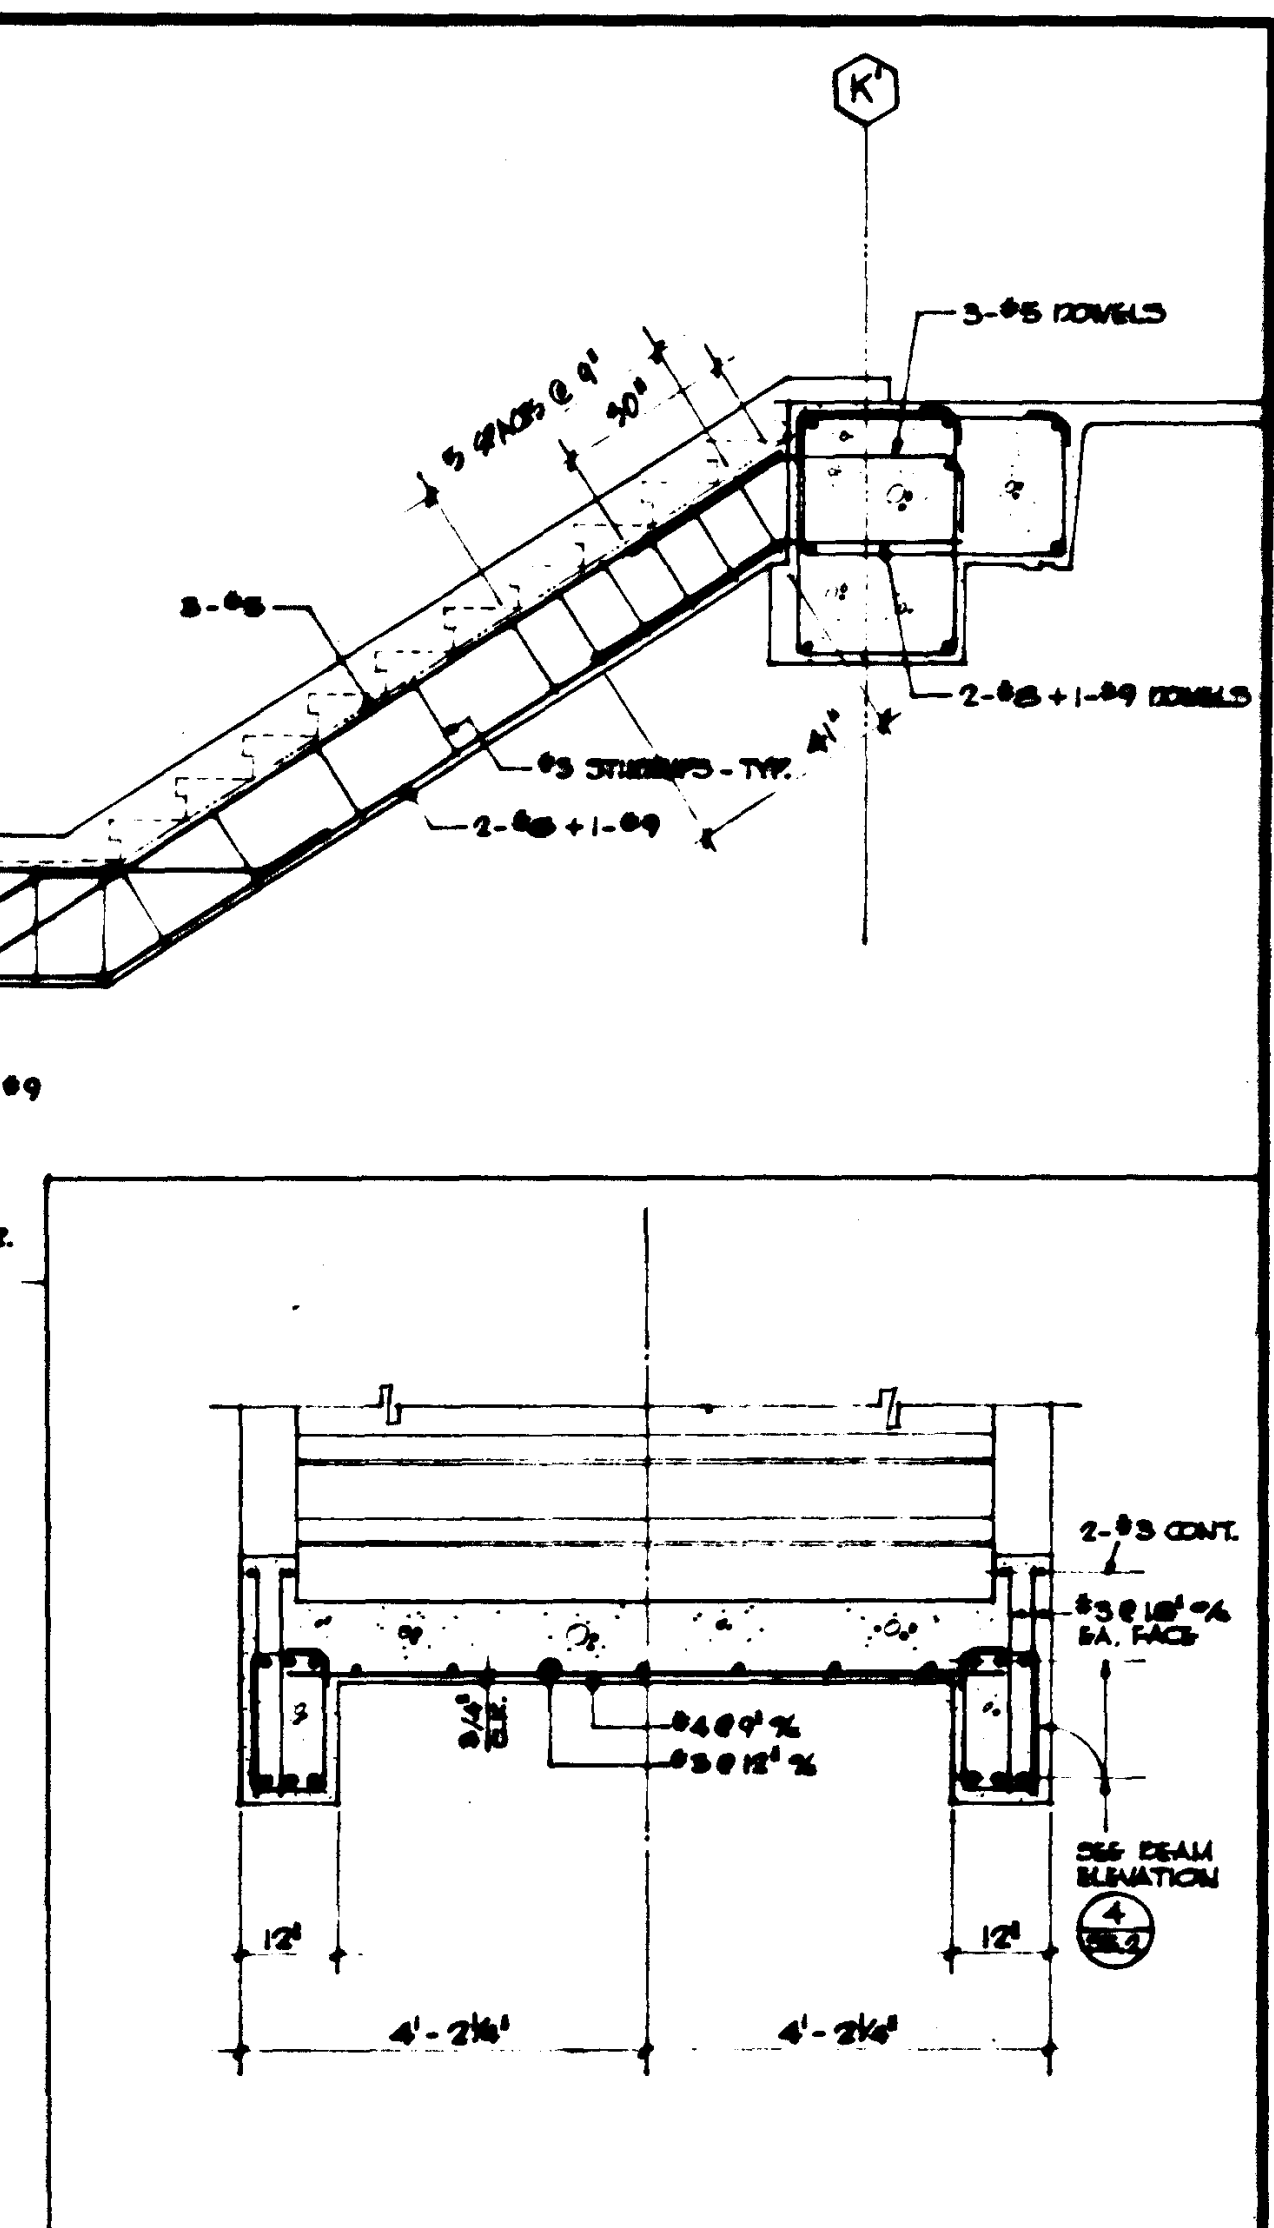

SECTION



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SECTION

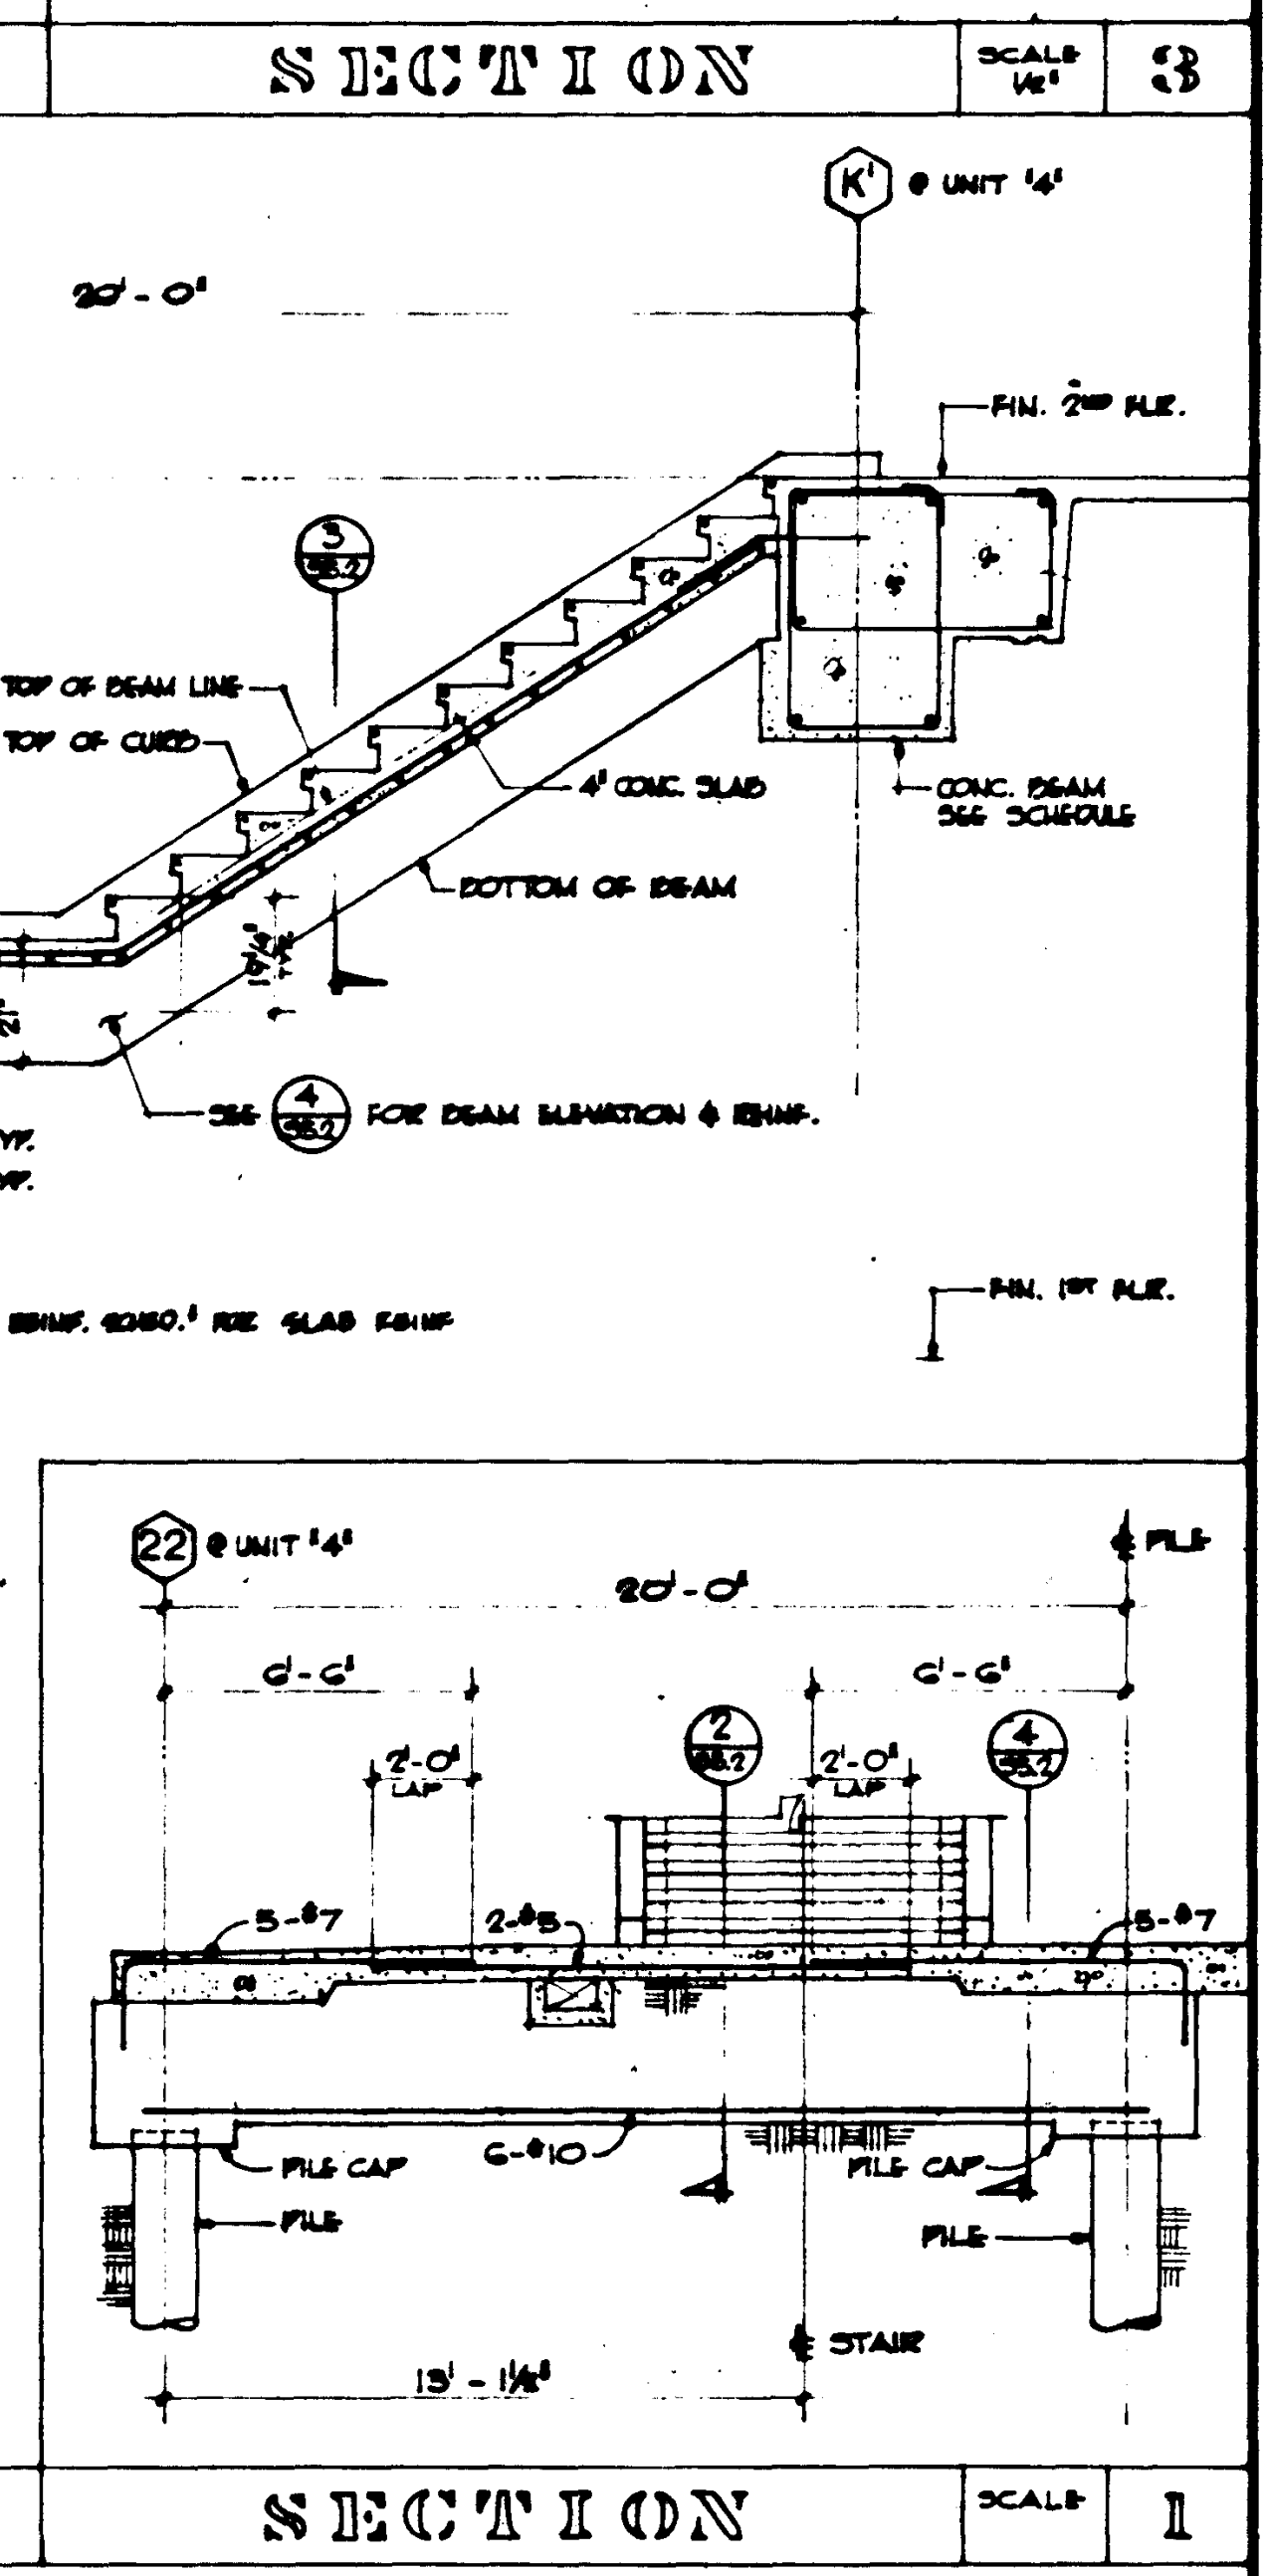
SCALE 1/2" = 1'-0"

<p>REVISIONS</p>	<p>STRUCTURAL ENGINEERS BRADY & JOHNSTON J.A. MARTIN & ASSOCIATES</p>	<p>DESIGNED BY J.P.</p>	<p>ARCHITECT WILLIAM L. PEREIRA</p>	<p>APPROVED JUN 21 1955 STATE FIRE MARSHAL JUN 21 1955</p>	<p>ASSOCIATED ARCHITECTS: WILLIAM L. PEREIRA & ASSOCIATES A. QUINCY JONES-FREDERICK E. EMMONS & ASSOCIATES BLUROCK ELLERBROCK & ASSOCIATES</p>	<p>GOLDEN WEST COLLEGE HUNTINGTON BEACH, CALIFORNIA ORANGE COAST JUNIOR COLLEGE DISTRICT</p>	<p>CONCRETE SECTIONS AND DETAILS</p>	<p>JOB NO. 10-4 DATE 16 JUN 1955 SHEET NO. 53.2</p>
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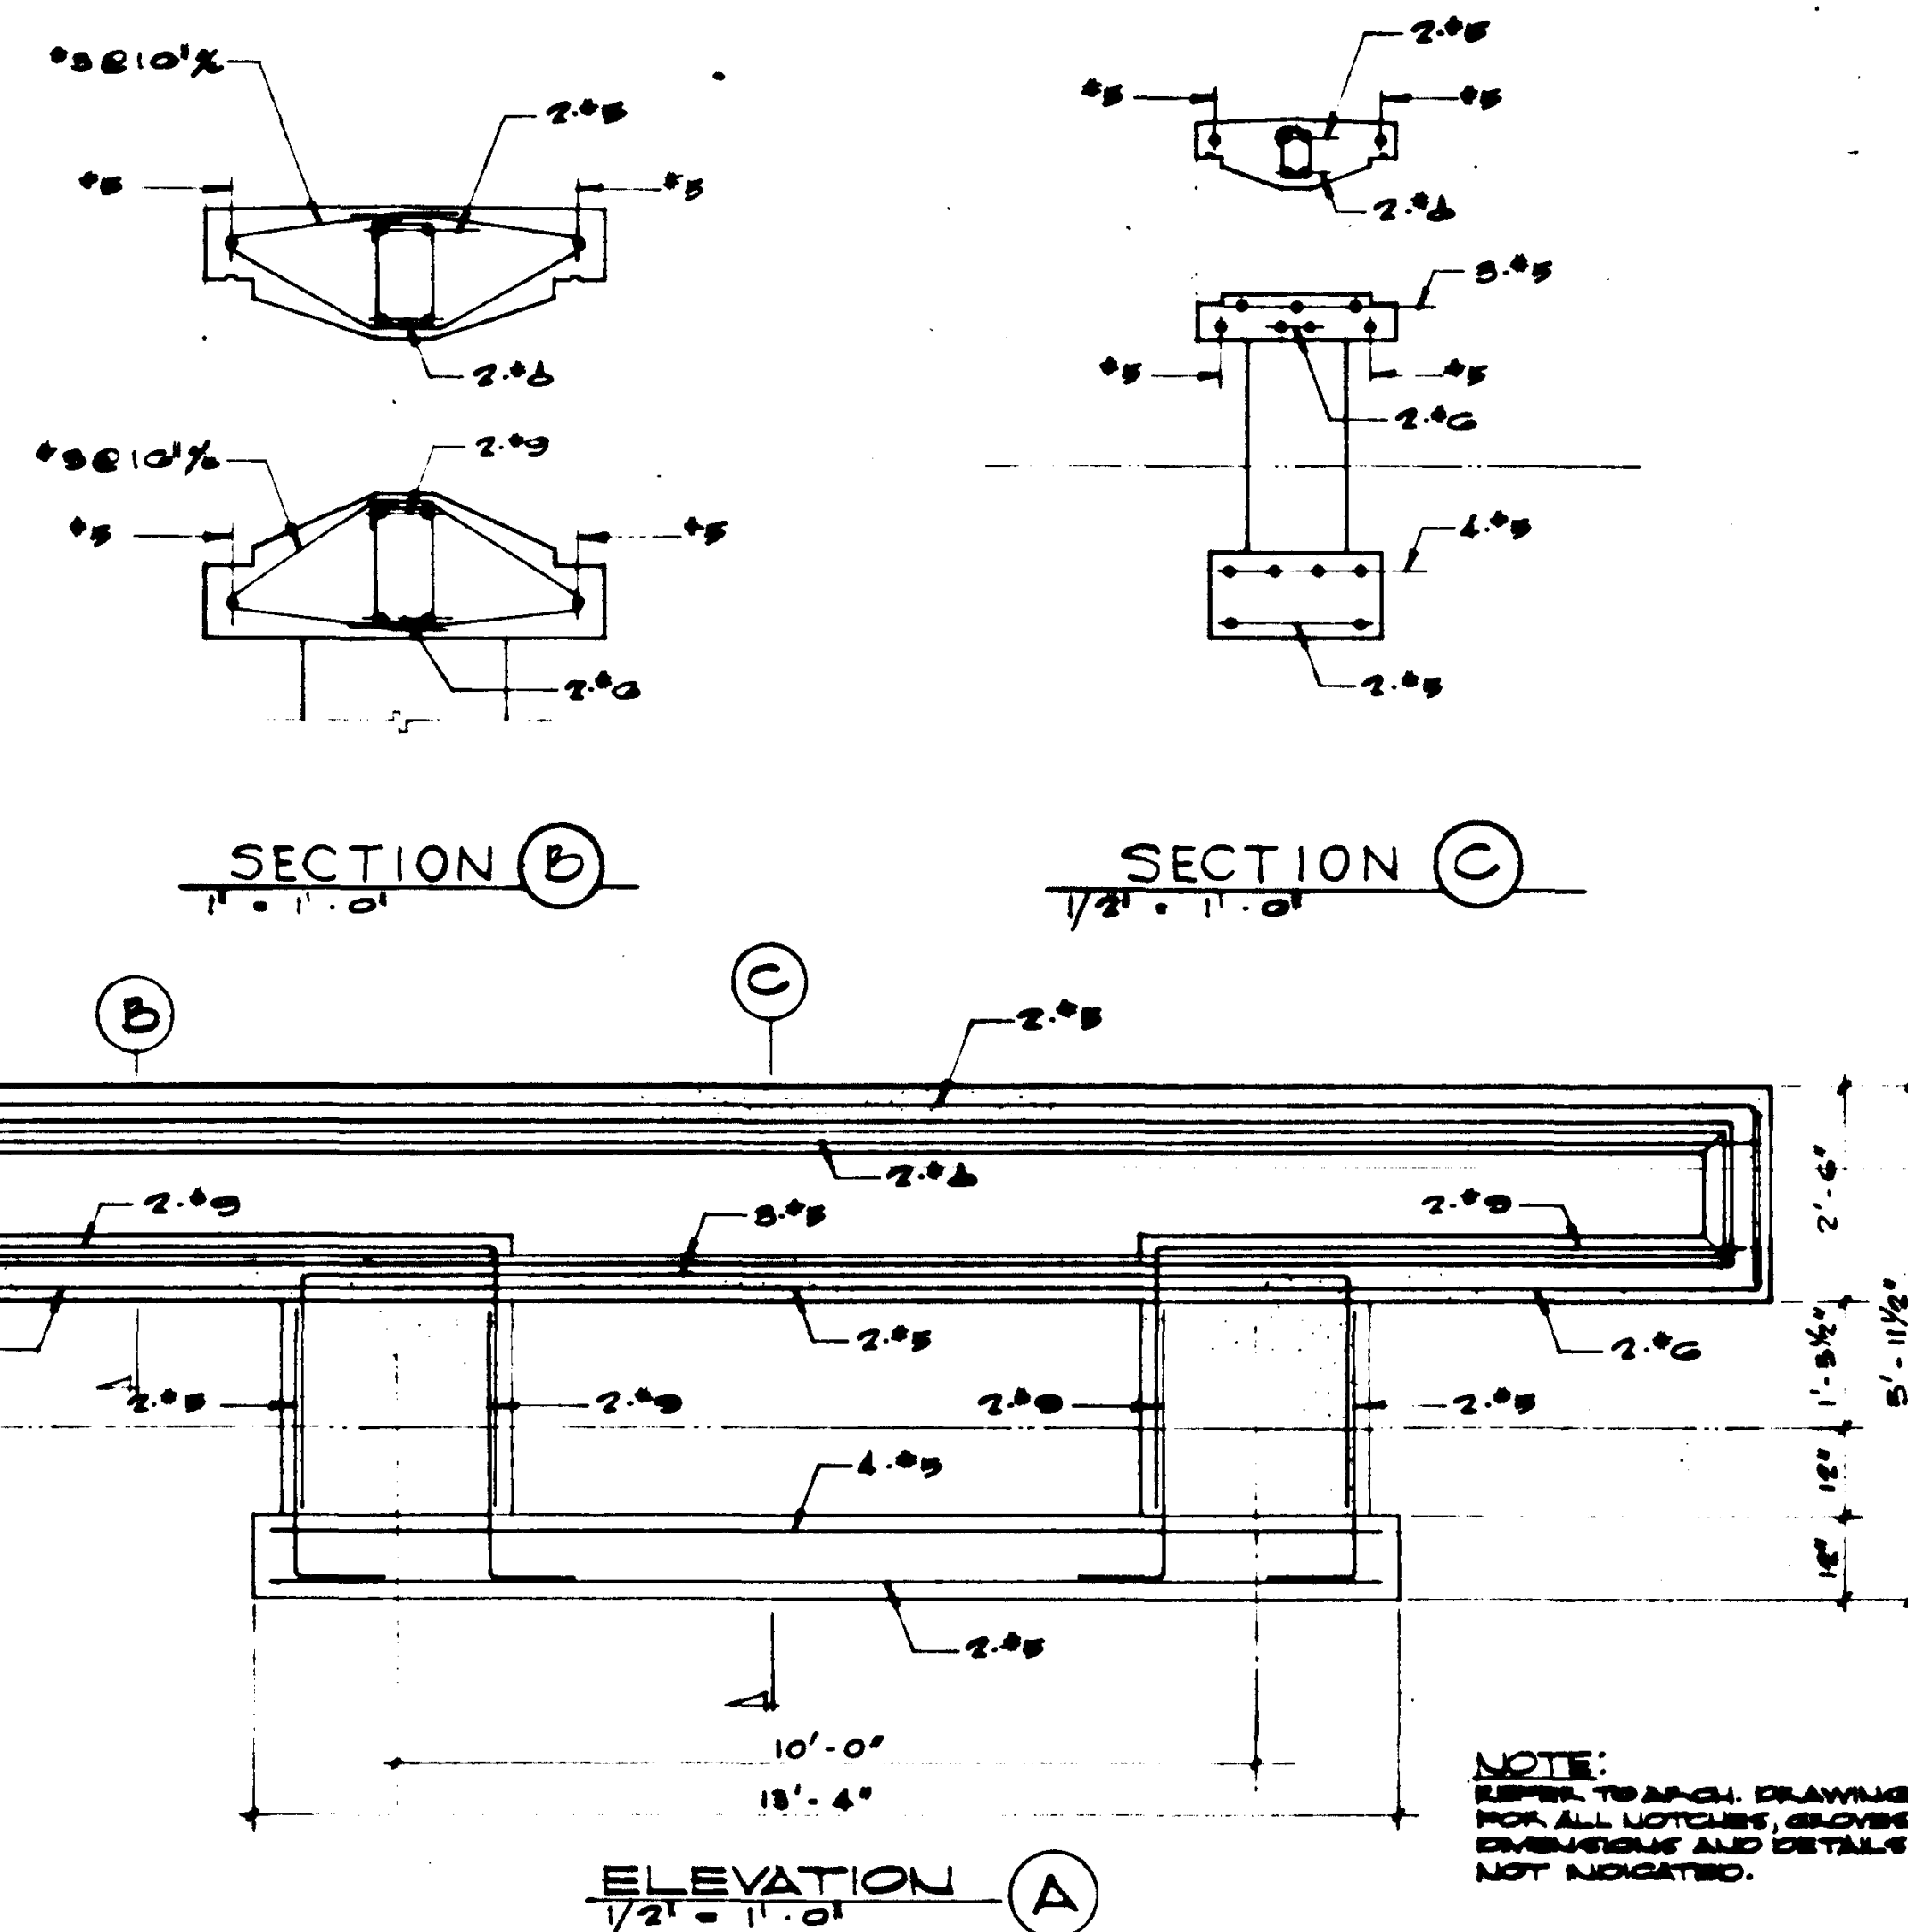
REMOVABLE CONC. SLAB DETAILS

SCALE AS NOTED

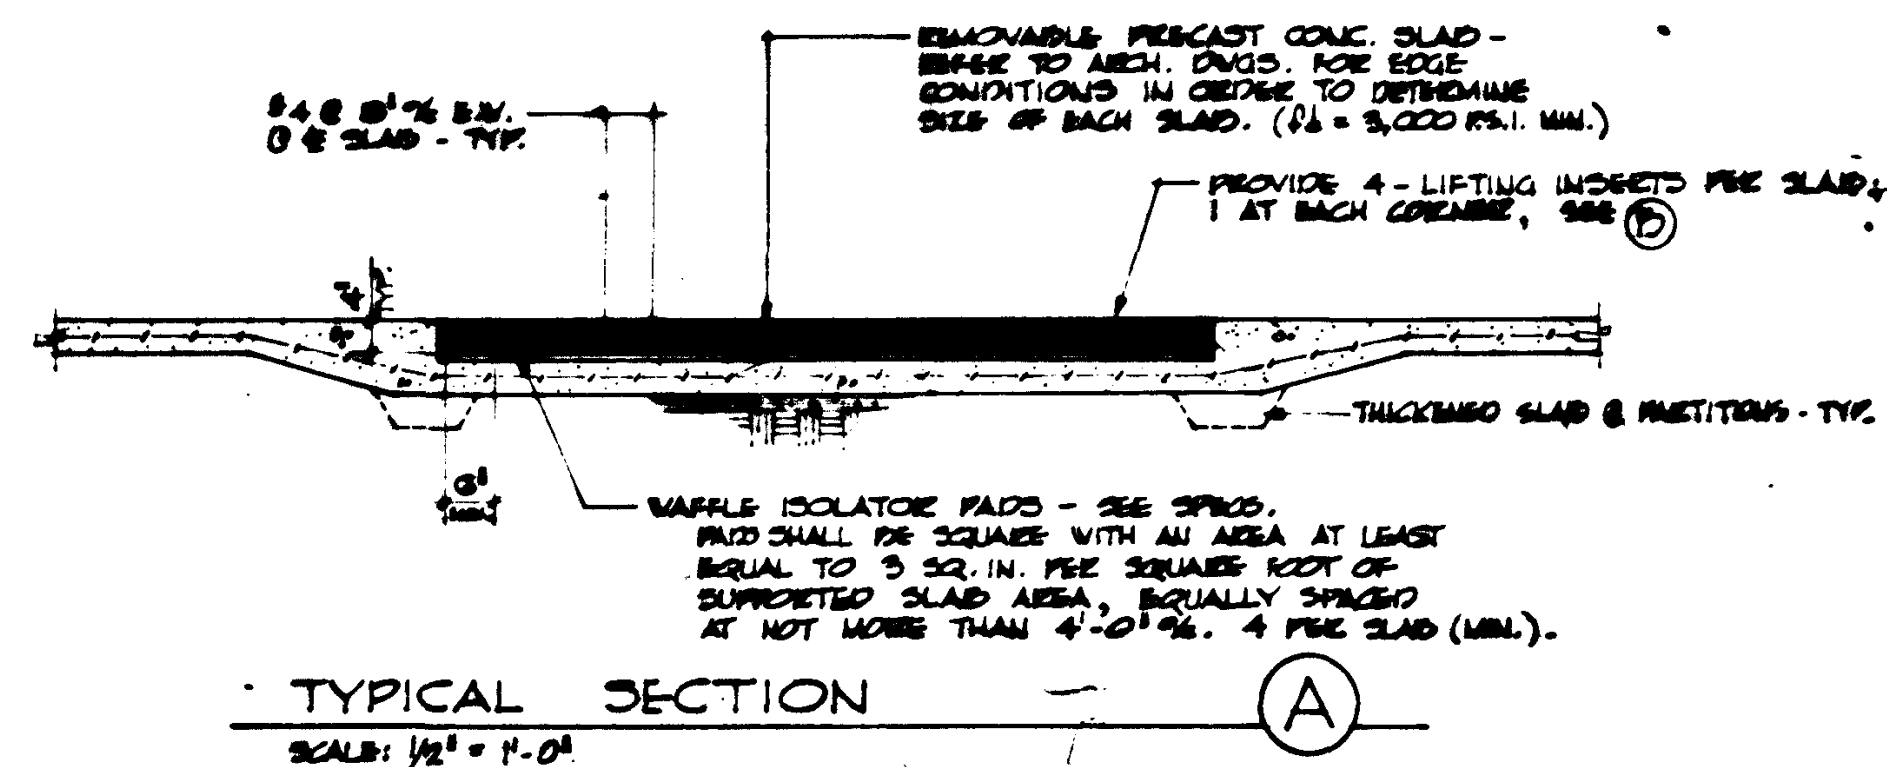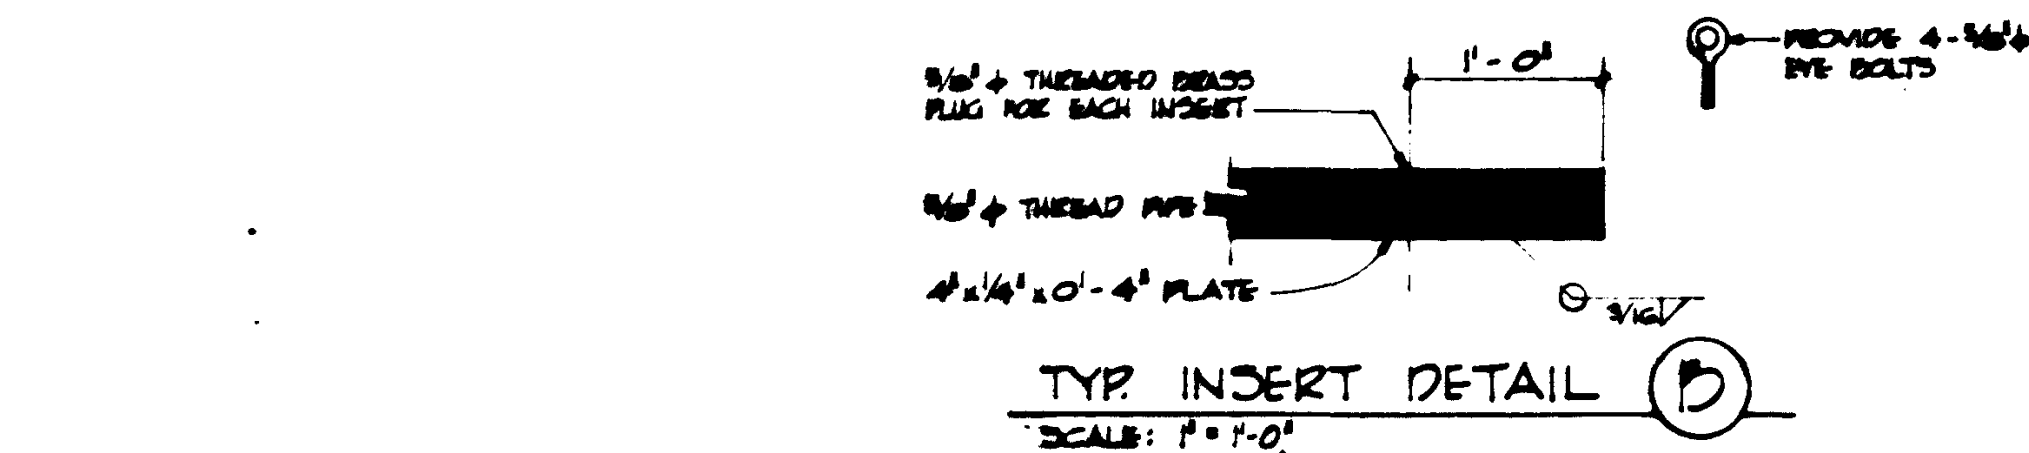

LANTERN DETAILS

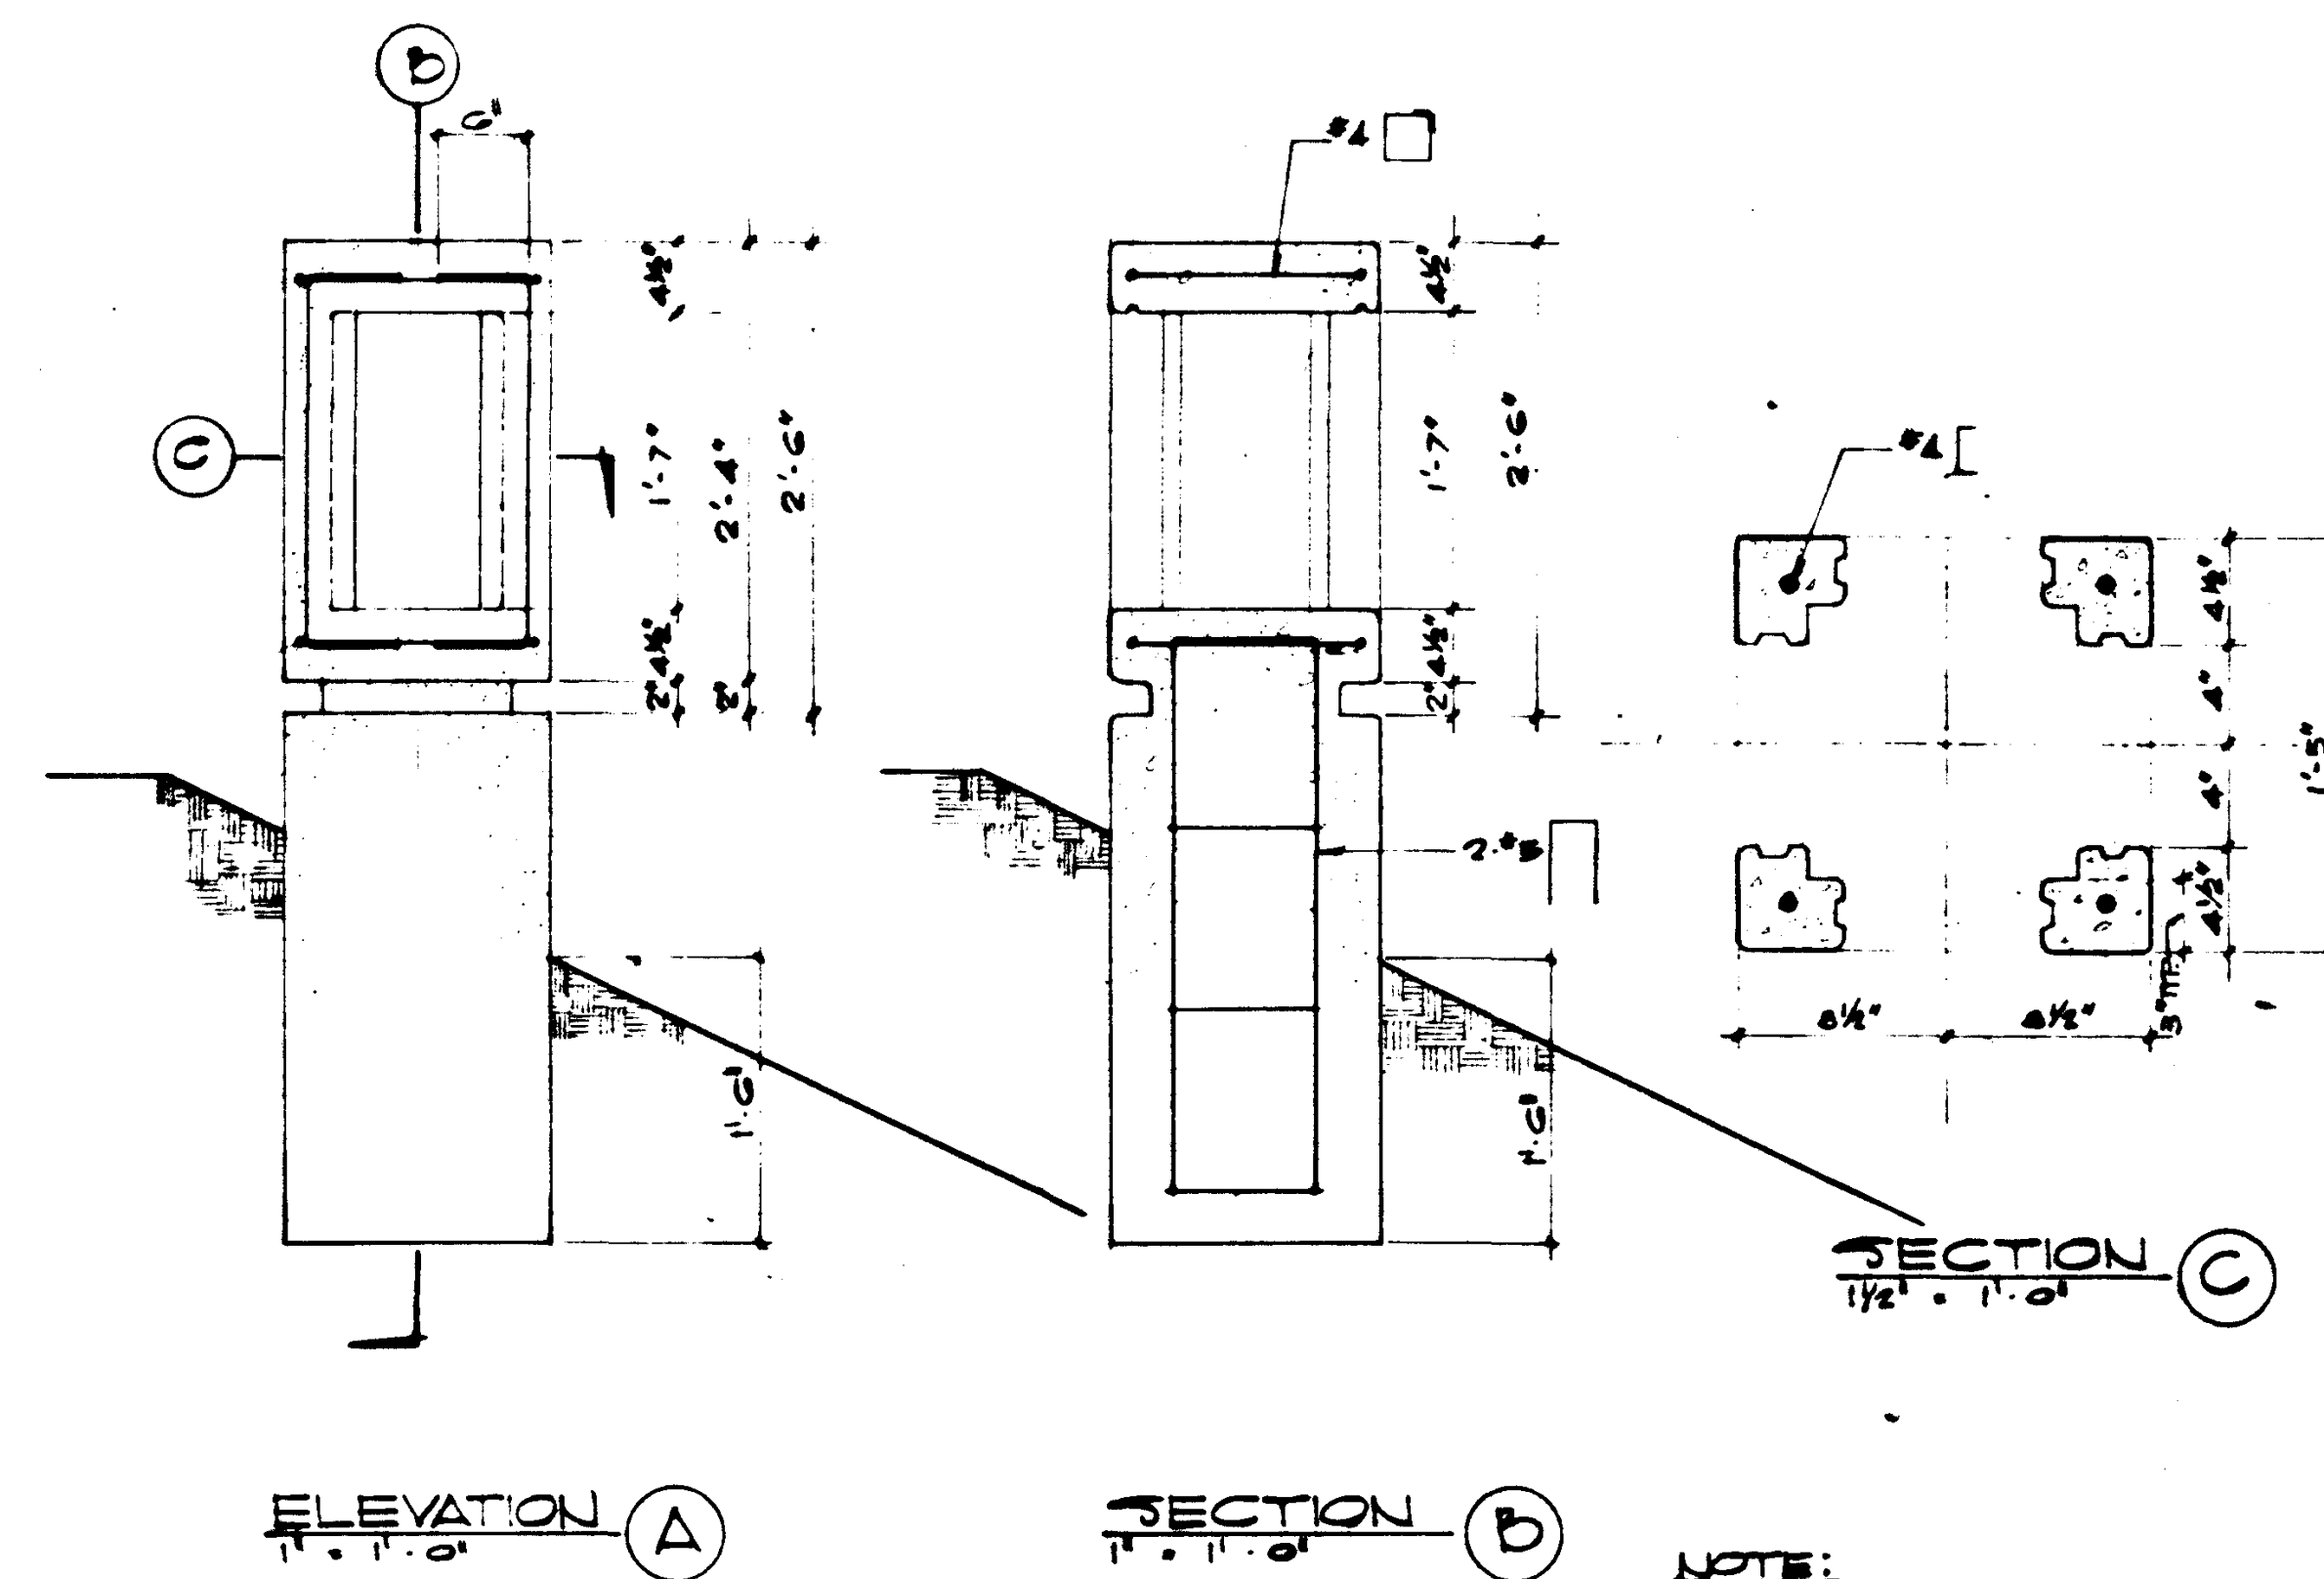SCALE AS NOTED



ENTRANCE SIGN DETAILS

SCALE AS NOTED

<p>REVISIONS</p>	<p>STRUCTURAL ENGINEERS BRANDOW & JOHNSTON S.A. MARTIN & ASSOCIATES</p> <p>MECHANICAL ENGINEERS RALPH E. PHILLIPS, INC.</p> <p>ELECTRICAL ENGINEERS RALPH E. PHILLIPS, INC.</p> <p>CIVIL ENGINEERS O. SHURMAN & ASSOCIATES MOFFATT & NICHOL</p>	<p>DESIGNED IP</p> <p>DRAWN BY JO</p> <p>CHECKED BY IP</p>	<p>APPROVED STATE FIRE MARSHAL DATE: JUN 21 1965</p>	<p>ASSOCIATED ARCHITECTS: WILLIAM L. PEREIRA & ASSOCIATES A. QUINCY JONES-FREDERICK E. EMMONS & ASSOCIATES BLURCK BLERBROCK & ASSOCIATES</p> <p>URBANUS SQUARE • MACARTHUR BOULEVARD AT FORD ROAD TELEPHONE 714/675-2640 • CORONA DEL MAR, CALIFORNIA</p>	<p>GOLDEN WEST COLLEGE HUNTINGTON BEACH, CALIFORNIA ORANGE COAST JUNIOR COLLEGE DISTRICT</p>	<p>CONCRETE SECTIONS & DETAILS</p> <p>JOB NO. 10-1 DATE 16 JUN 1965 SHEET NO. S 5.3</p>
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COL. NO.	J-20	J-21	J-22	J-23	J-24	J-25	K-20	K-21	K-22	K-23	K-24	K-25	L-20	L-21	L-22	L-23	L-24	L-25
FLOOR																		
ROOF D.L. (KIPS)	111.0	239.0	187.0	—	—	177.0	318.3	189.0	—	—	—	—	111.0	177.0	194.0	—	—	—
SIZE	32" x 32"	32" x 32"	32" x 32"	—	—	32" x 32"	32" x 32"	32" x 32"	—	—	—	—	32" x 32"	32" x 32"	32" x 32"	—	—	—
REINF.	8-#10	8-#10	8-#10	—	—	8-#10	8-#10	8-#10	—	—	—	—	8-#10	8-#10	8-#10	—	—	—
SPIRALS	%#2	%#2	%#2	—	—	%#2	%#2	%#2	—	—	—	—	%#2	%#2	%#2	—	—	—
2ND FL. D.L. (KIPS)	239.0	367.0	187.0	194.0	194.0	380.0	606.0	341.0	194.0	190.0	194.0	194.0	239.0	367.0	262.0	189.0	141.0	111.0
OR 1-STORY SIZE	32" x 32"	32" x 32"	32" x 32"	32" x 32"	32" x 32"	32" x 32"	32" x 32"	32" x 32"	32" x 32"	32" x 32"	32" x 32"	32" x 32"	32" x 32"	32" x 32"	32" x 32"	32" x 32"	32" x 32"	32" x 32"
REINF.	15-#11	8-#10	15-#11	8-#10	8-#10	15-#11	10-#11	8-#10	8-#10	15-#11	15-#11	15-#11	8-#10	8-#10	15-#11	15-#11	15-#11	15-#11
SPIRALS	%#2	%#2	%#2	%#2	%#2	%#2	%#2	%#2	%#2	%#2	%#2	%#2	%#2	%#2	%#2	%#2	%#2	%#2
DETAIL																		
NO. PILES	2	4	2	1	2	3	6	3	2	2	2	2	3	2	1	2	1	1
FLOOR																		
COL. NO.	J-20	J-21	J-22	J-23	J-24	J-25	K-20	K-21	K-22	K-23	K-24	K-25	L-20	L-21	L-22	L-23	L-24	L-25

UNIT 4

Scale: None

COL. NO.	J-26	J-27	J-28	J-29	K-26	K-27	K-28	K-29	L-26	L-27	L-28	L-29	M-26	M-27	M-28	M-29
FLOOR																
ROOF D.L. (KIPS)	177.0	177.0	177.0	177.0	—	—	—	—	—	—	—	—	111.0	239.0	111.0	—
SIZE	32" x 32"	32" x 32"	32" x 32"	32" x 32"	—	—	—	—	—	—	—	—	32" x 32"	32" x 32"	32" x 32"	—
REINF.	8-#10	8-#10	8-#10	8-#10	—	—	—	—	—	—	—	—	8-#10	8-#10	8-#10	—
SPIRALS	%#2	%#2	%#2	%#2	—	—	—	—	—	—	—	—	%#2	%#2	%#2	—
2ND FL. D.L. (KIPS)	308.0	388.0	388.0	308.0	178.0	239.0	239.0	180.0	178.0	239.0	239.0	239.0	308.0	388.0	308.0	—
OR 1-STORY SIZE	32" x 32"	32" x 32"	32" x 32"	32" x 32"	32" x 32"	32" x 32"	32" x 32"	32" x 32"	32" x 32"	32" x 32"	32" x 32"	32" x 32"	32" x 32"	32" x 32"	32" x 32"	—
REINF.	8-#10	8-#10	8-#10	8-#10	8-#10	8-#10	8-#10	8-#10	8-#10	8-#10	8-#10	8-#10	8-#10	8-#10	8-#10	—
SPIRALS	%#2	%#2	%#2	%#2	%#2	%#2	%#2	%#2	%#2	%#2	%#2	%#2	%#2	%#2	%#2	—
DETAIL																—
NO. PILES	3	3	3	3	2	2	2	2	2	2	2	2	3	3	3	—
FLOOR																—
COL. NO.	J-26	J-27	J-28	J-29	K-26	K-27	K-28	K-29	L-26	L-27	L-28	L-29	M-26	M-27	M-28	M-29

UNIT 5

Scale: None

COL. NO.	H-32	J-30	J-31	J-32	K-30	K-31	K-32	L-31	L-32
FLOOR									
ROOF D.L. (KIPS)	338.0	250.0	177.0	239.0	187.0	—	—	239.0	190.0
SIZE	32" x 32"	32" x 32"	32" x 32"	32" x 32"	32" x 32"	—	—	32" x 32"	32" x 32"
REINF.	16-#11	10-#11	15-#11	15-#11	8-#10	—	—	15-#11	8-#10
SPIRALS	%#2	%#2	%#2	%#2	%#2	—	—	%#2	%#2
2ND FL. D.L. (KIPS)	338.0	250.0	308.0	350.0	187.0	123.0	350.0	190.0	250.0
OR 1-STORY SIZE	32" x 32"	32" x 32"	32" x 32"	32" x 32"	32" x 32"	32" x 32"	32" x 32"	32" x 32"	32" x 32"
REINF.	16-#11	10-#11	15-#11	15-#11	8-#10	15-#11	8-#10	15-#11	10-#11
SPIRALS	%#2	%#2	%#2	%#2	%#2	%#2	%#2	%#2	%#2
DETAIL									
NO. PILES	3	2	3	3	2	1	3	2	2
FLOOR									
COL. NO.	H-32	J-30	J-31	J-32	K-30	K-31	K-32	L-31	L-32

UNIT 6

Scale: None

COL. NO.	Z-21	Z-22	Z-23	A-21	A-22	A-23	B-21	B-22	C-21	C-22	C-23	D-21	D-22	D-23
FLOOR														
ROOF D.L. (KIPS)	259.0	328.0	328.0	189.0	239.0	111.0	177.0	177.0	189.0	239.0	111.0	177.0	328.0	111.0
SIZE	32" x 32"	32" x 32"	32" x 32"	32" x 32"	32" x 32"	32" x 32"	32" x 32"	32" x 32"	32" x 32"	32" x 32"	32" x 32"	32" x 32"	32" x 32"	32" x 32"
REINF.	8-#10	8-#10	8-#10	8-#10	8-#10	8-#10	8-#10	8-#10	8-#10	8-#10	8-#10	8-#10	8-#10	8-#10
SPIRALS	%#2	%#2	%#2	%#2	%#2	%#2	%#2	%#2	%#2	%#2	%#2	%#2	%#2	%#2
2ND FL. D.L. (KIPS)	367.0	591.0	367.0	391.0	512.0	239.0	380.0	380.0	591.0	512.0	239.0	380.0	308.0	591.0
OR 1-STORY SIZE	32" x 32"	32" x 32"	32" x 32"	32" x 32"	32" x 32"	32" x 32"	32" x 32"	32" x 32"	32" x 32"	32" x 32"	32" x 32"	32" x 32"	32" x 32"	32" x 32"
REINF.	10-#11	10-#11	10-#11	10-#11	8-#10	8-#10	8-#10	8-#10	8-#10	8-#10	8-#10	8-#10	8-#10	8-#10
SPIRALS	%#2	%#2	%#2	%#2	%#2	%#2	%#2	%#2	%#2	%#2	%#2	%#2	%#2	%#2
DETAIL														
NO. PILES	3	5	3	3	4	2	3	3	5	4	2	3	5	2
FLOOR														
COL. NO.	Z-21	Z-22	Z-23	A-21	A-22	A-23	B-21	B-22	C-21	C-22	C-23	D-21	D-22	D-23

UNIT 3

Scale: None

COL. NO.	Y-22	Y-23	Y-24	Y-25	X-22	X-23	X-24	W-22	W-23	W-24	V-22	V-23	V-24	V-25	A	B	C
FLOOR																	
ROOF D.L. (KIPS)	318.0	250.0	250.0	250.0	250.0	114.0	250.0	114.0	250.0	114.0	137.0	137.0	137.0	137.0	—	—	—
SIZE	32" x 32"	32" x 32"	32" x 32"	32" x 32"	32" x 32"	32" x 32"	32" x 32"	32" x 32"	32" x 32"	32" x 32"	32" x 32"	32" x 32"	32" x 32"	32" x 32"	—	—	—
VERT. REINF.	8-#10	8-#10	8-#10	8-#10	8-#10	8-#10	8-#10	8-#10	8-#10	8-#10	8-#10	8-#10	8-#10	8-#10	—	—	—
SPIRALS	%#2	%#2	%#2	%#2	%#2	%#2	%#2	%#2	%#2	%#2	%#2	%#2	%#2	%#2	—	—	—
2ND FL. D.L. (KIPS)	—	—	—	—	—	21.0	91.0	75.0	—	—	—	—	—	—	—	—	—
OR 1-STORY SIZE	—	—	—	—	—	18" x 18"	18" x 18"	18" x 18"	—	—	—	—	—	—	—	—	—
REINF.	—	—	—	—	—	4-#6	4-#6	4-#6	—	—	—	—	—	—	—	—	—
TIES	—	—	—	—	—	3" x 3"	3" x 3"	3" x 3"	—	—	—	—	—	—	—	—	—
GR. FL. D.L. (KIPS)	—	—	—	—	—	87.0	126.0	100.0	—	—	—	—	—	—	—	—	—
OR 1-STORY SIZE	—	—	—	—	—	18" x 18"	18" x 18"	18" x 18"	—	—	—	—	—	—	—	—	—
REINF.	—	—	—	—	—	4-#6	4-#6	4-#6	—	—	—	—	—	—	—	—	—
TIES	—	—	—	—	—	3" x 3"	3" x 3"	3" x 3"	—	—	—	—	—	—	—	—	—
DETAIL																	
NO. PILES	5	2	2	2	2	1	2	1	2	1	1	2	1	1	1	1	1
FLOOR																	
COL. NO.	Y-22	Y-23	Y-24	Y-25	X-22	X-23	X-24	W-22	W-23	W-24	V-22	V-23	V-24	V-25	A	B	C


UNIT 2

Scale: None

COL. NO.	Q-32	Q-33	Q-34	R-32	R-33	R-34	S-30	S-31	S-32	S-33	S-34	T-30	T-31	T-32	T-33	T-34	U-32
FLOOR																	
ROOF D.L. (KIPS)	328.0	328.0	328.0	328.0	328.0	328.0	—	—	177.0	328.0	328.0	—	—	111.0	177.0	189.0	31.0
SIZE	32" x 32"	32" x 32"	32" x 32"	32" x 32"	32" x 32"	32" x 32"	—	—	32" x 32"	32" x 32"	32" x 32"	—	—	32" x 32"	32" x 32"	32" x 32"	32" x 32"
VERT. REINF.	8-#10	8-#10	8-#10	8-#10	8-#10	8-#10	—	—	8-#10	8-#10	8-#10	—	—	8-#10	8-#10	8-#10	8-#10
SPIRALS	%#2	%#2	%#2	%#2	%#2	%#2	—	—	%#2	%#2	%#2	—	—	%#2	%#2	%#2	%#2
2ND FL. D.L. (KIPS)	710.0	512.0	380.0	512.0	710.0	710.0	113.0	178.0	430.0	710.0	710.0	178.0	380.0	363.0	591.0	591.0	31.0
OR 1-STORY SIZE	32" x 32"	32" x 32"	32" x 32"	32" x 32"	32" x 32"	32" x 32"	32" x 32"	32" x 32"	32" x 32"	32" x 32"	32" x 32"	32" x 32"	32" x 32"	32" x 32"	32" x 32"	32" x 32"	32" x 32"
REINF.	16-#14	8-#11	8-#11	8-#11	16-#14	16-#14	10-#11	8-#10	8-#11	16-#14	16-#14	10-#11	8-#10	8-#11	8-#11	10-#11	8-#10
SPIRALS	%#2	%#2	%#2	%#2	%#2	%#2	%#2	%#2	%#2	%#2	%#2	%#2	%#2	%#2	%#2	%#2	%#2
DETAIL																	
NO. PILES	6	5	3	5	6	6	1	2	4	6	6	2	3	4	4	3	1
FLOOR																	
COL. NO.	Q-32	Q-33	Q-34	R-32	R-33	R-34	S-30	S-31	S-32	S-33	S-34	T-30	T-31	T-32	T-33	T-34	U-32


UNIT 1

Scale: None

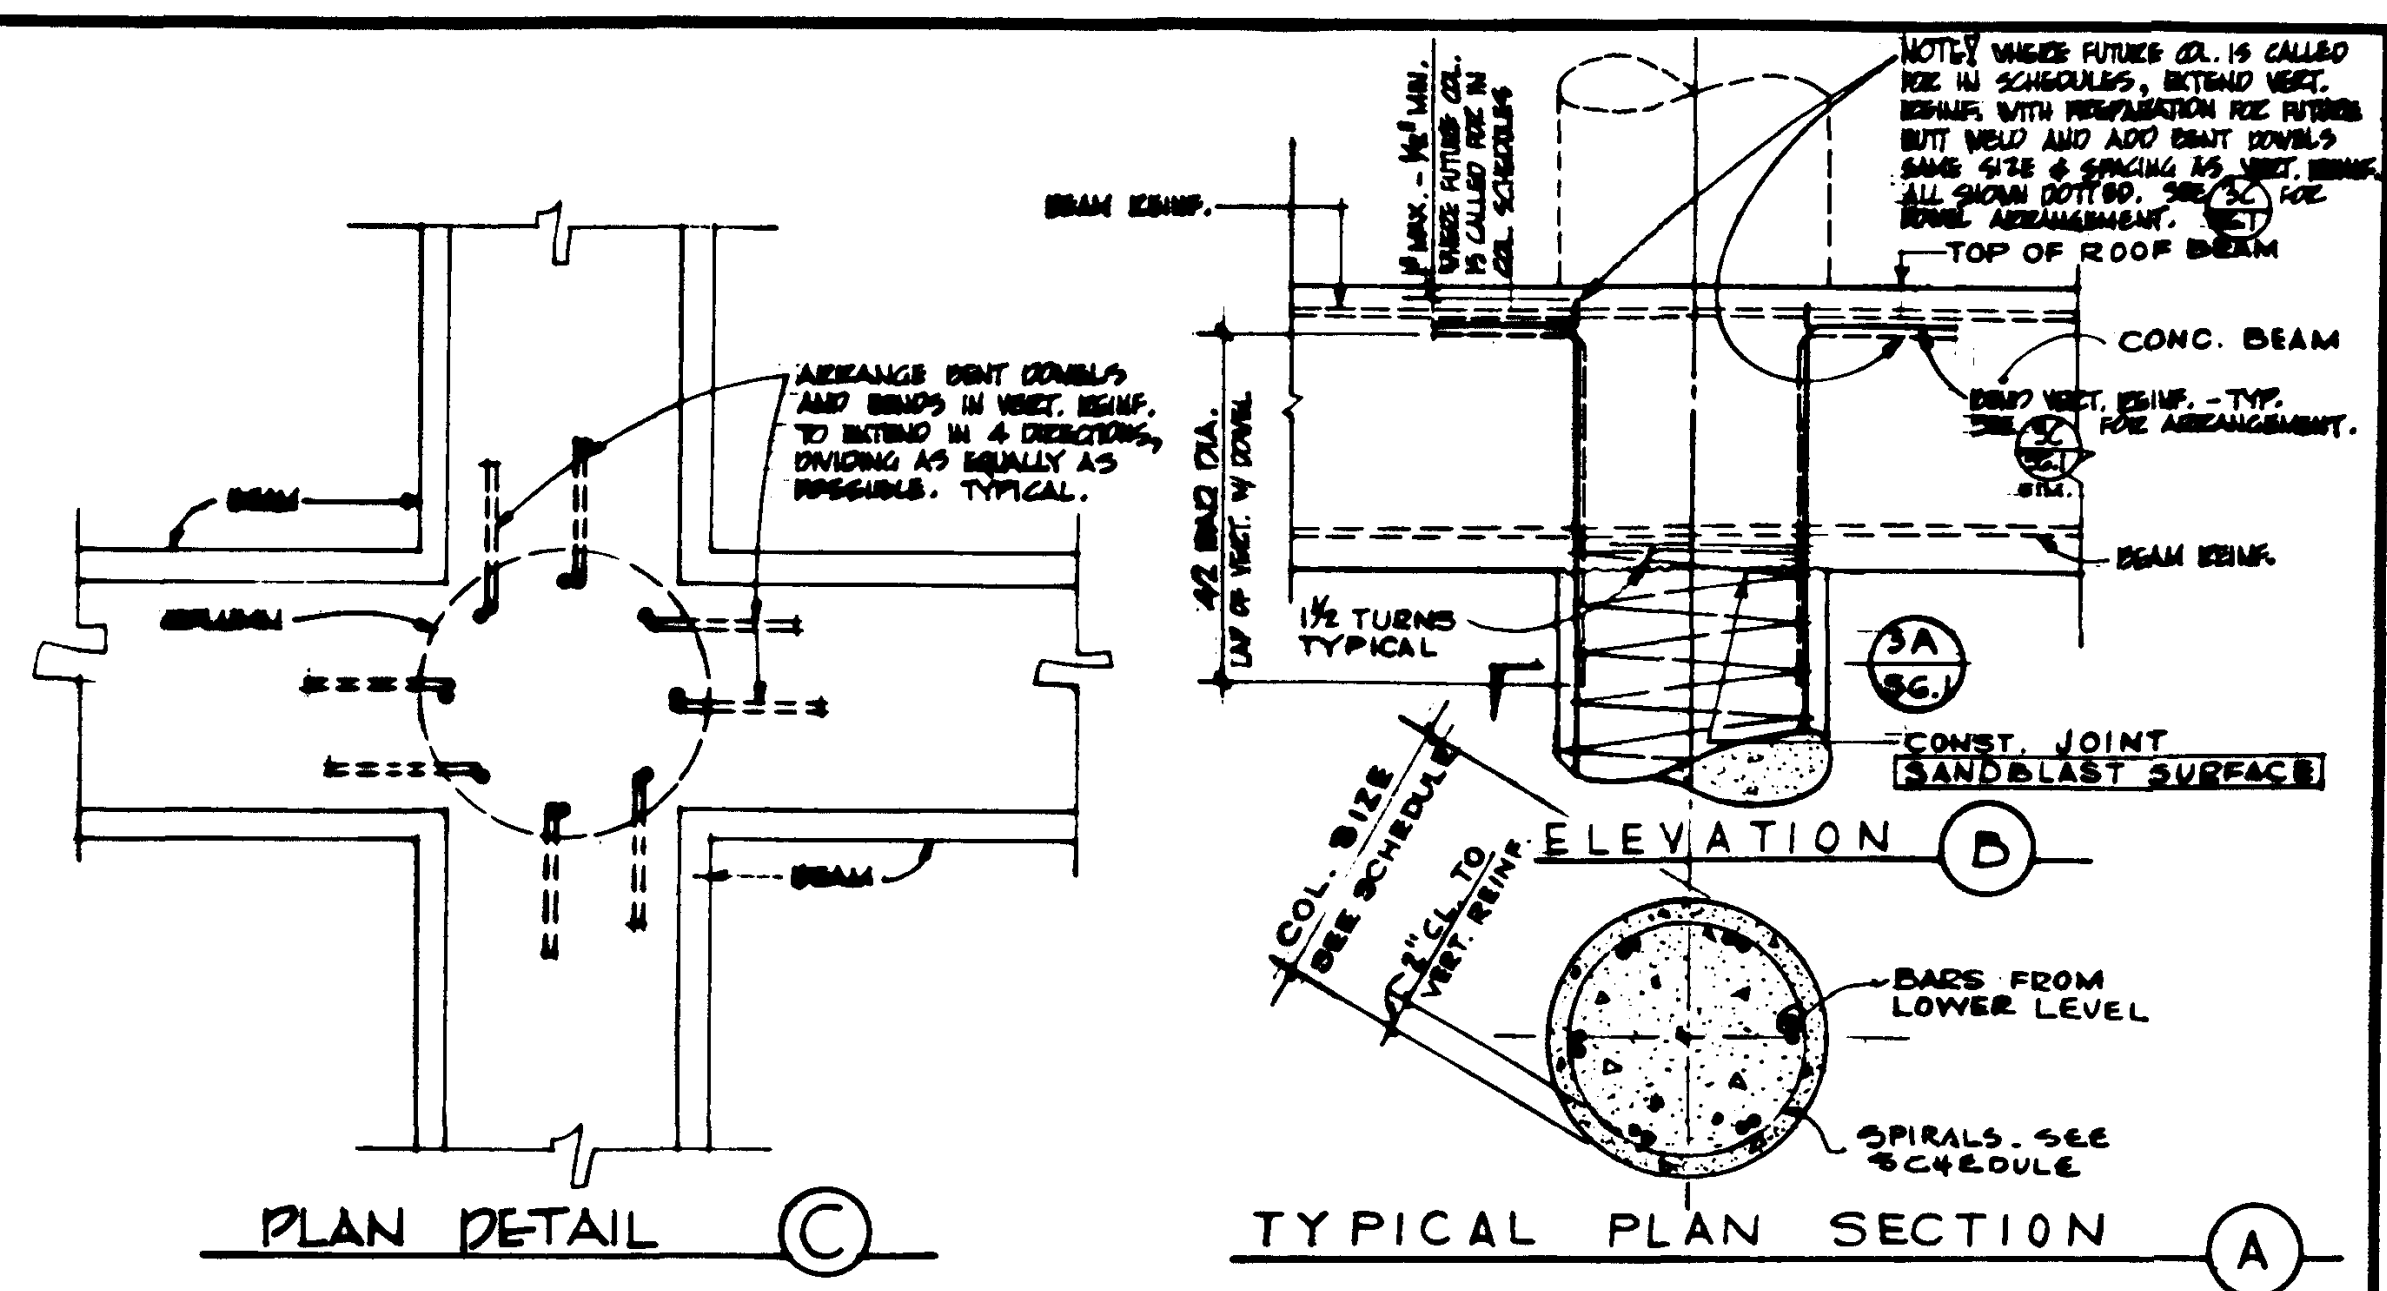


TYP. COLUMN DETAILS AT ROOF

Scale: 3/4"

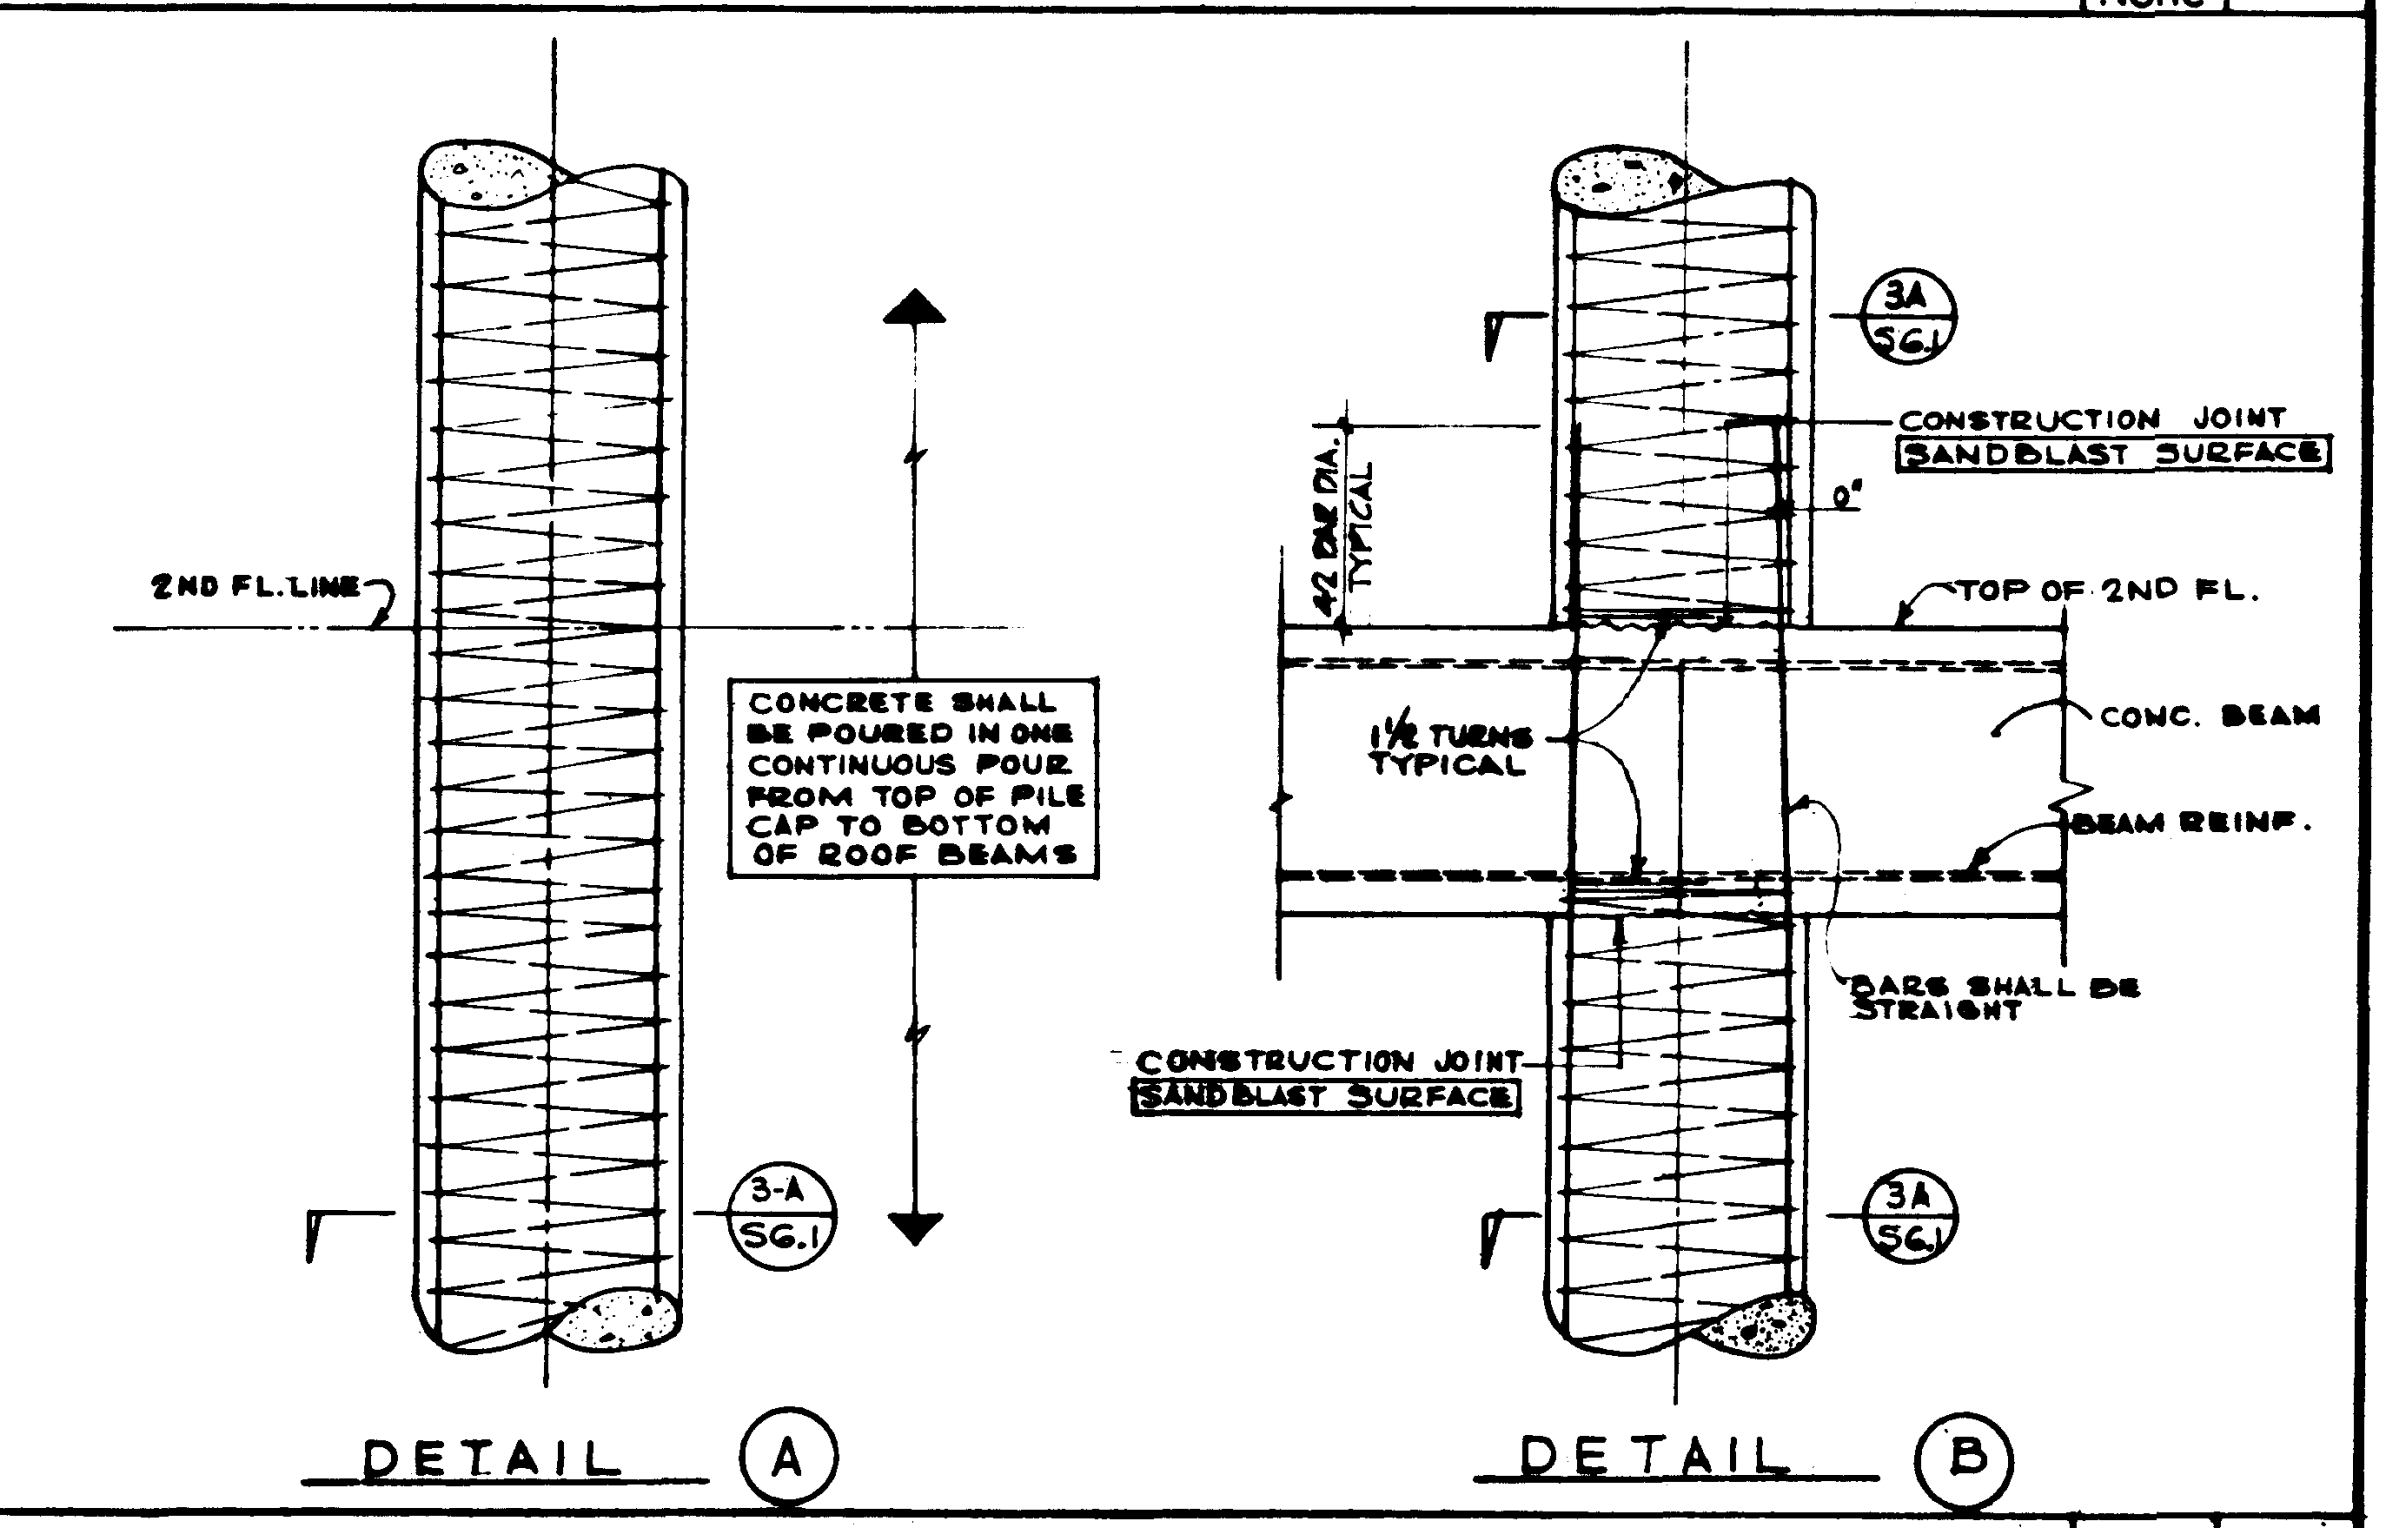


TYP. COLUMN DETAILS AT 2ND FLR.


Scale: 2"

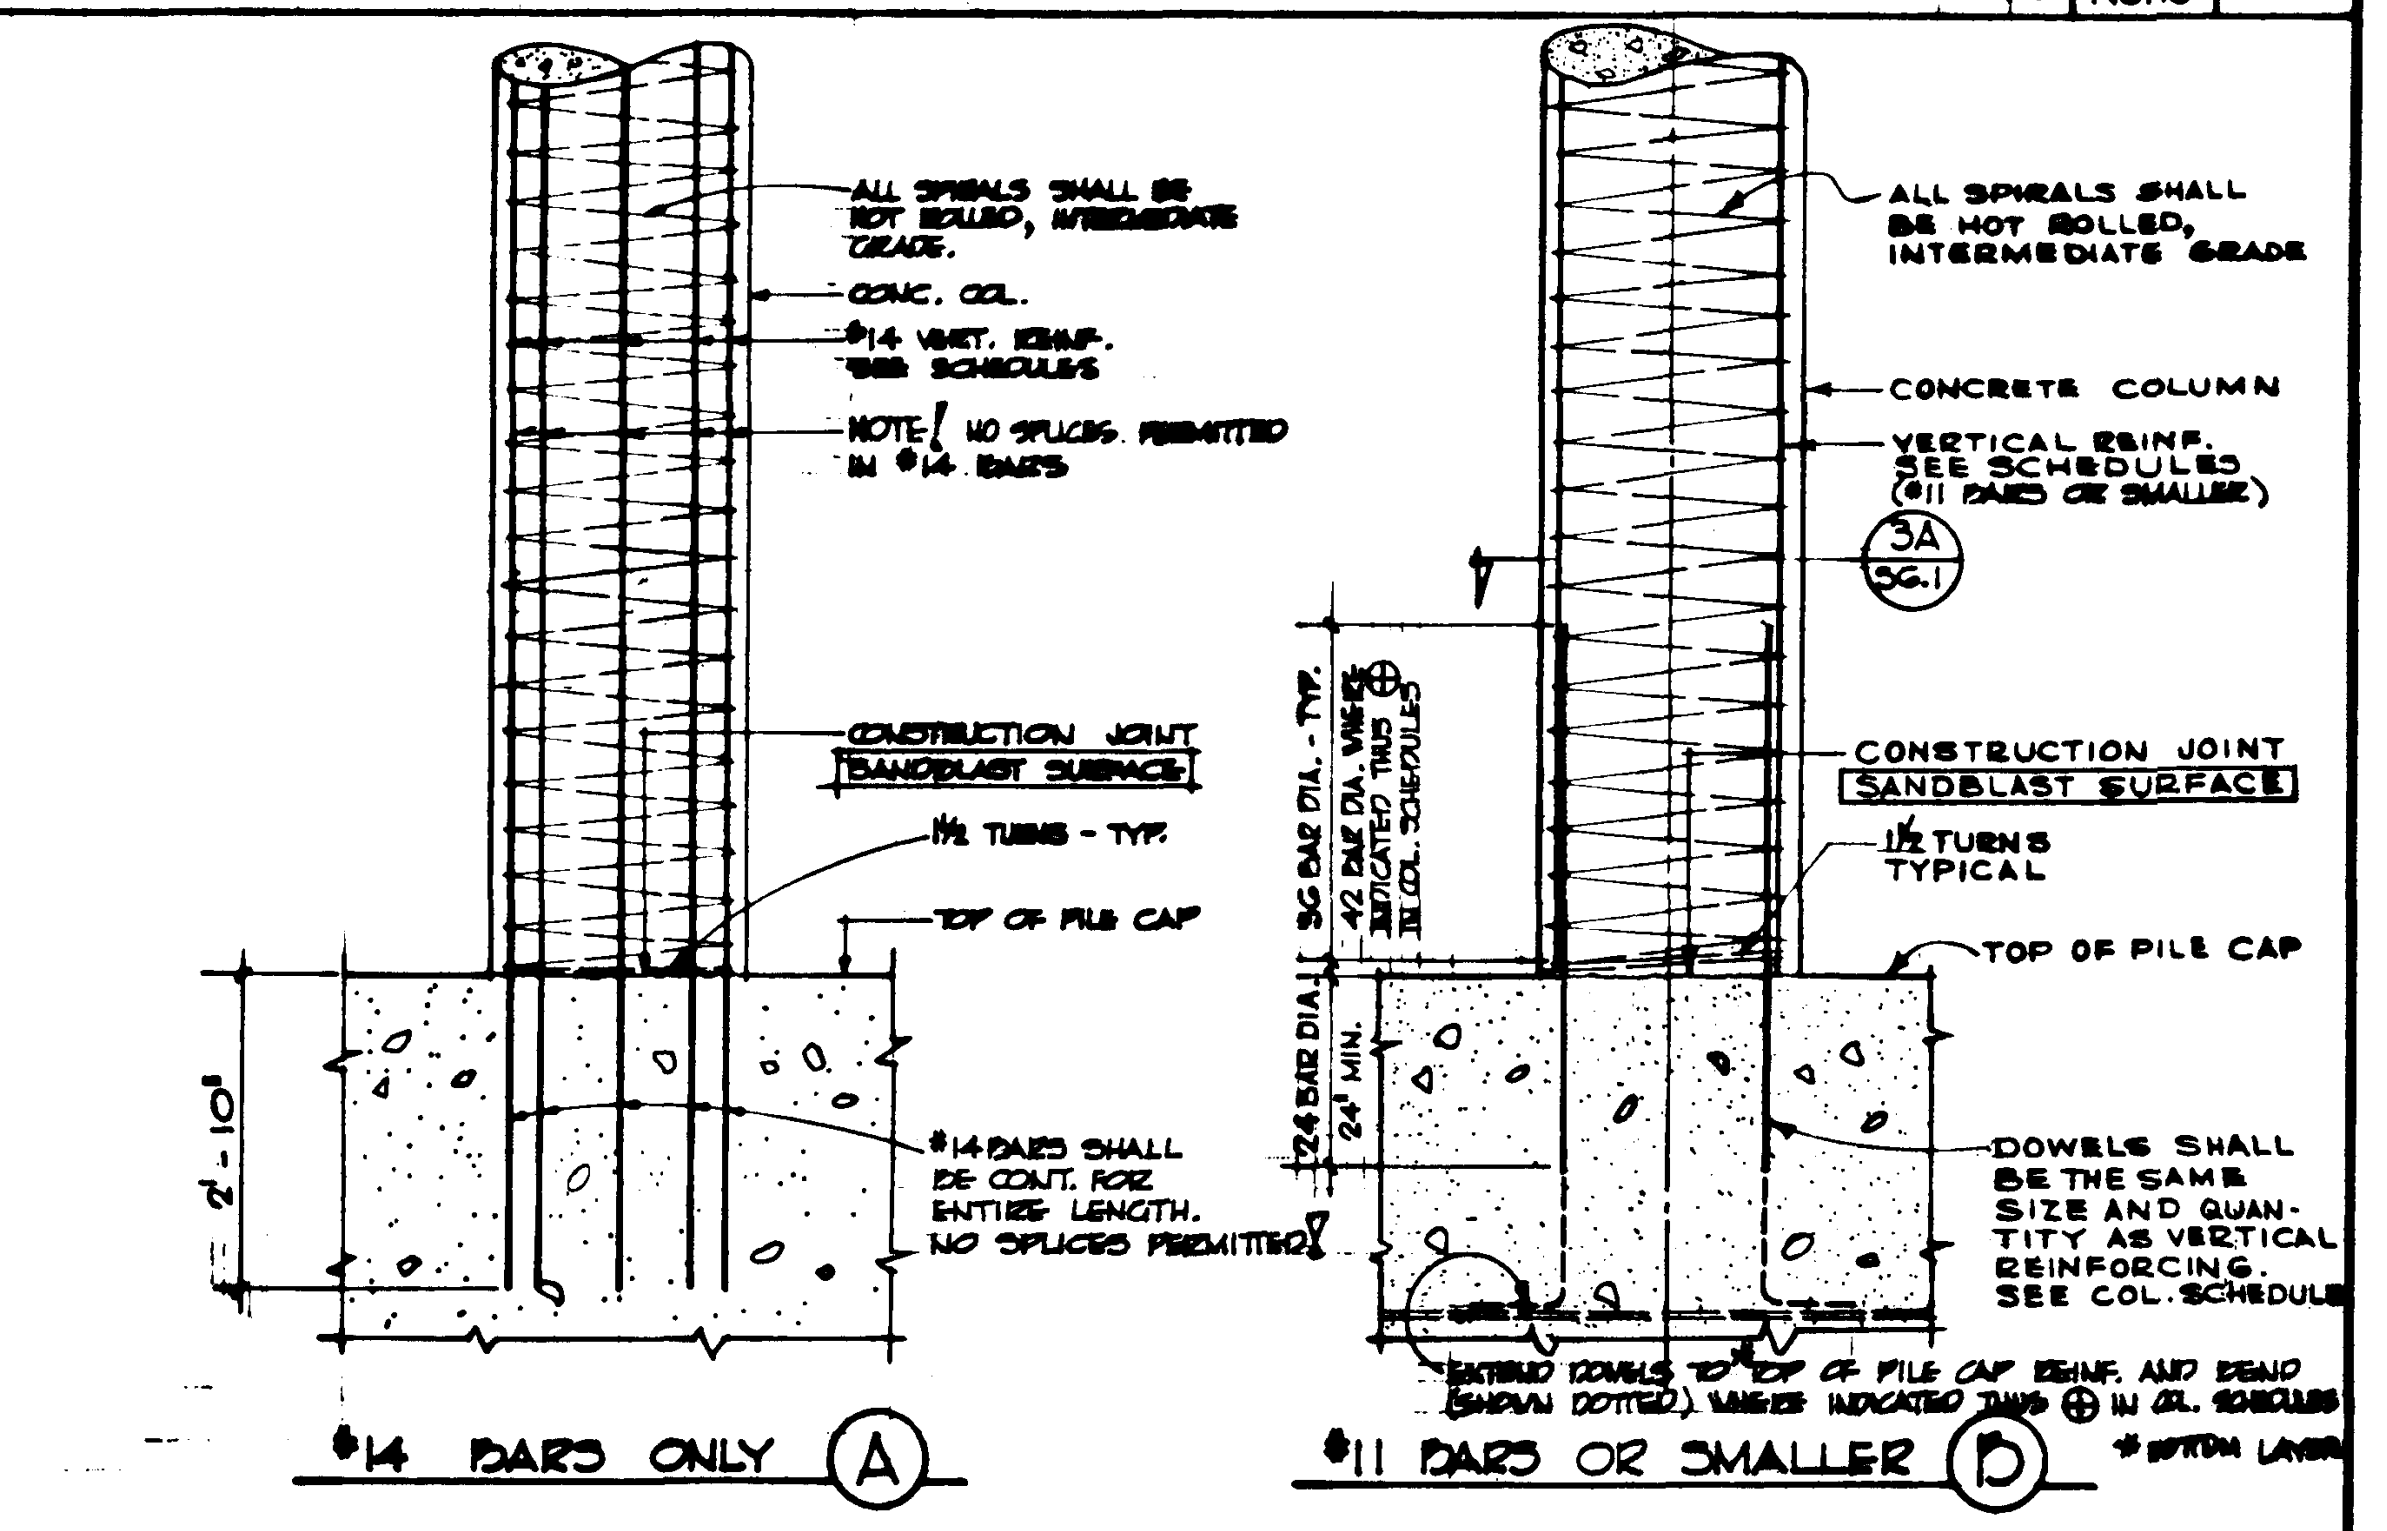

TYP. COLUMN DETAILS

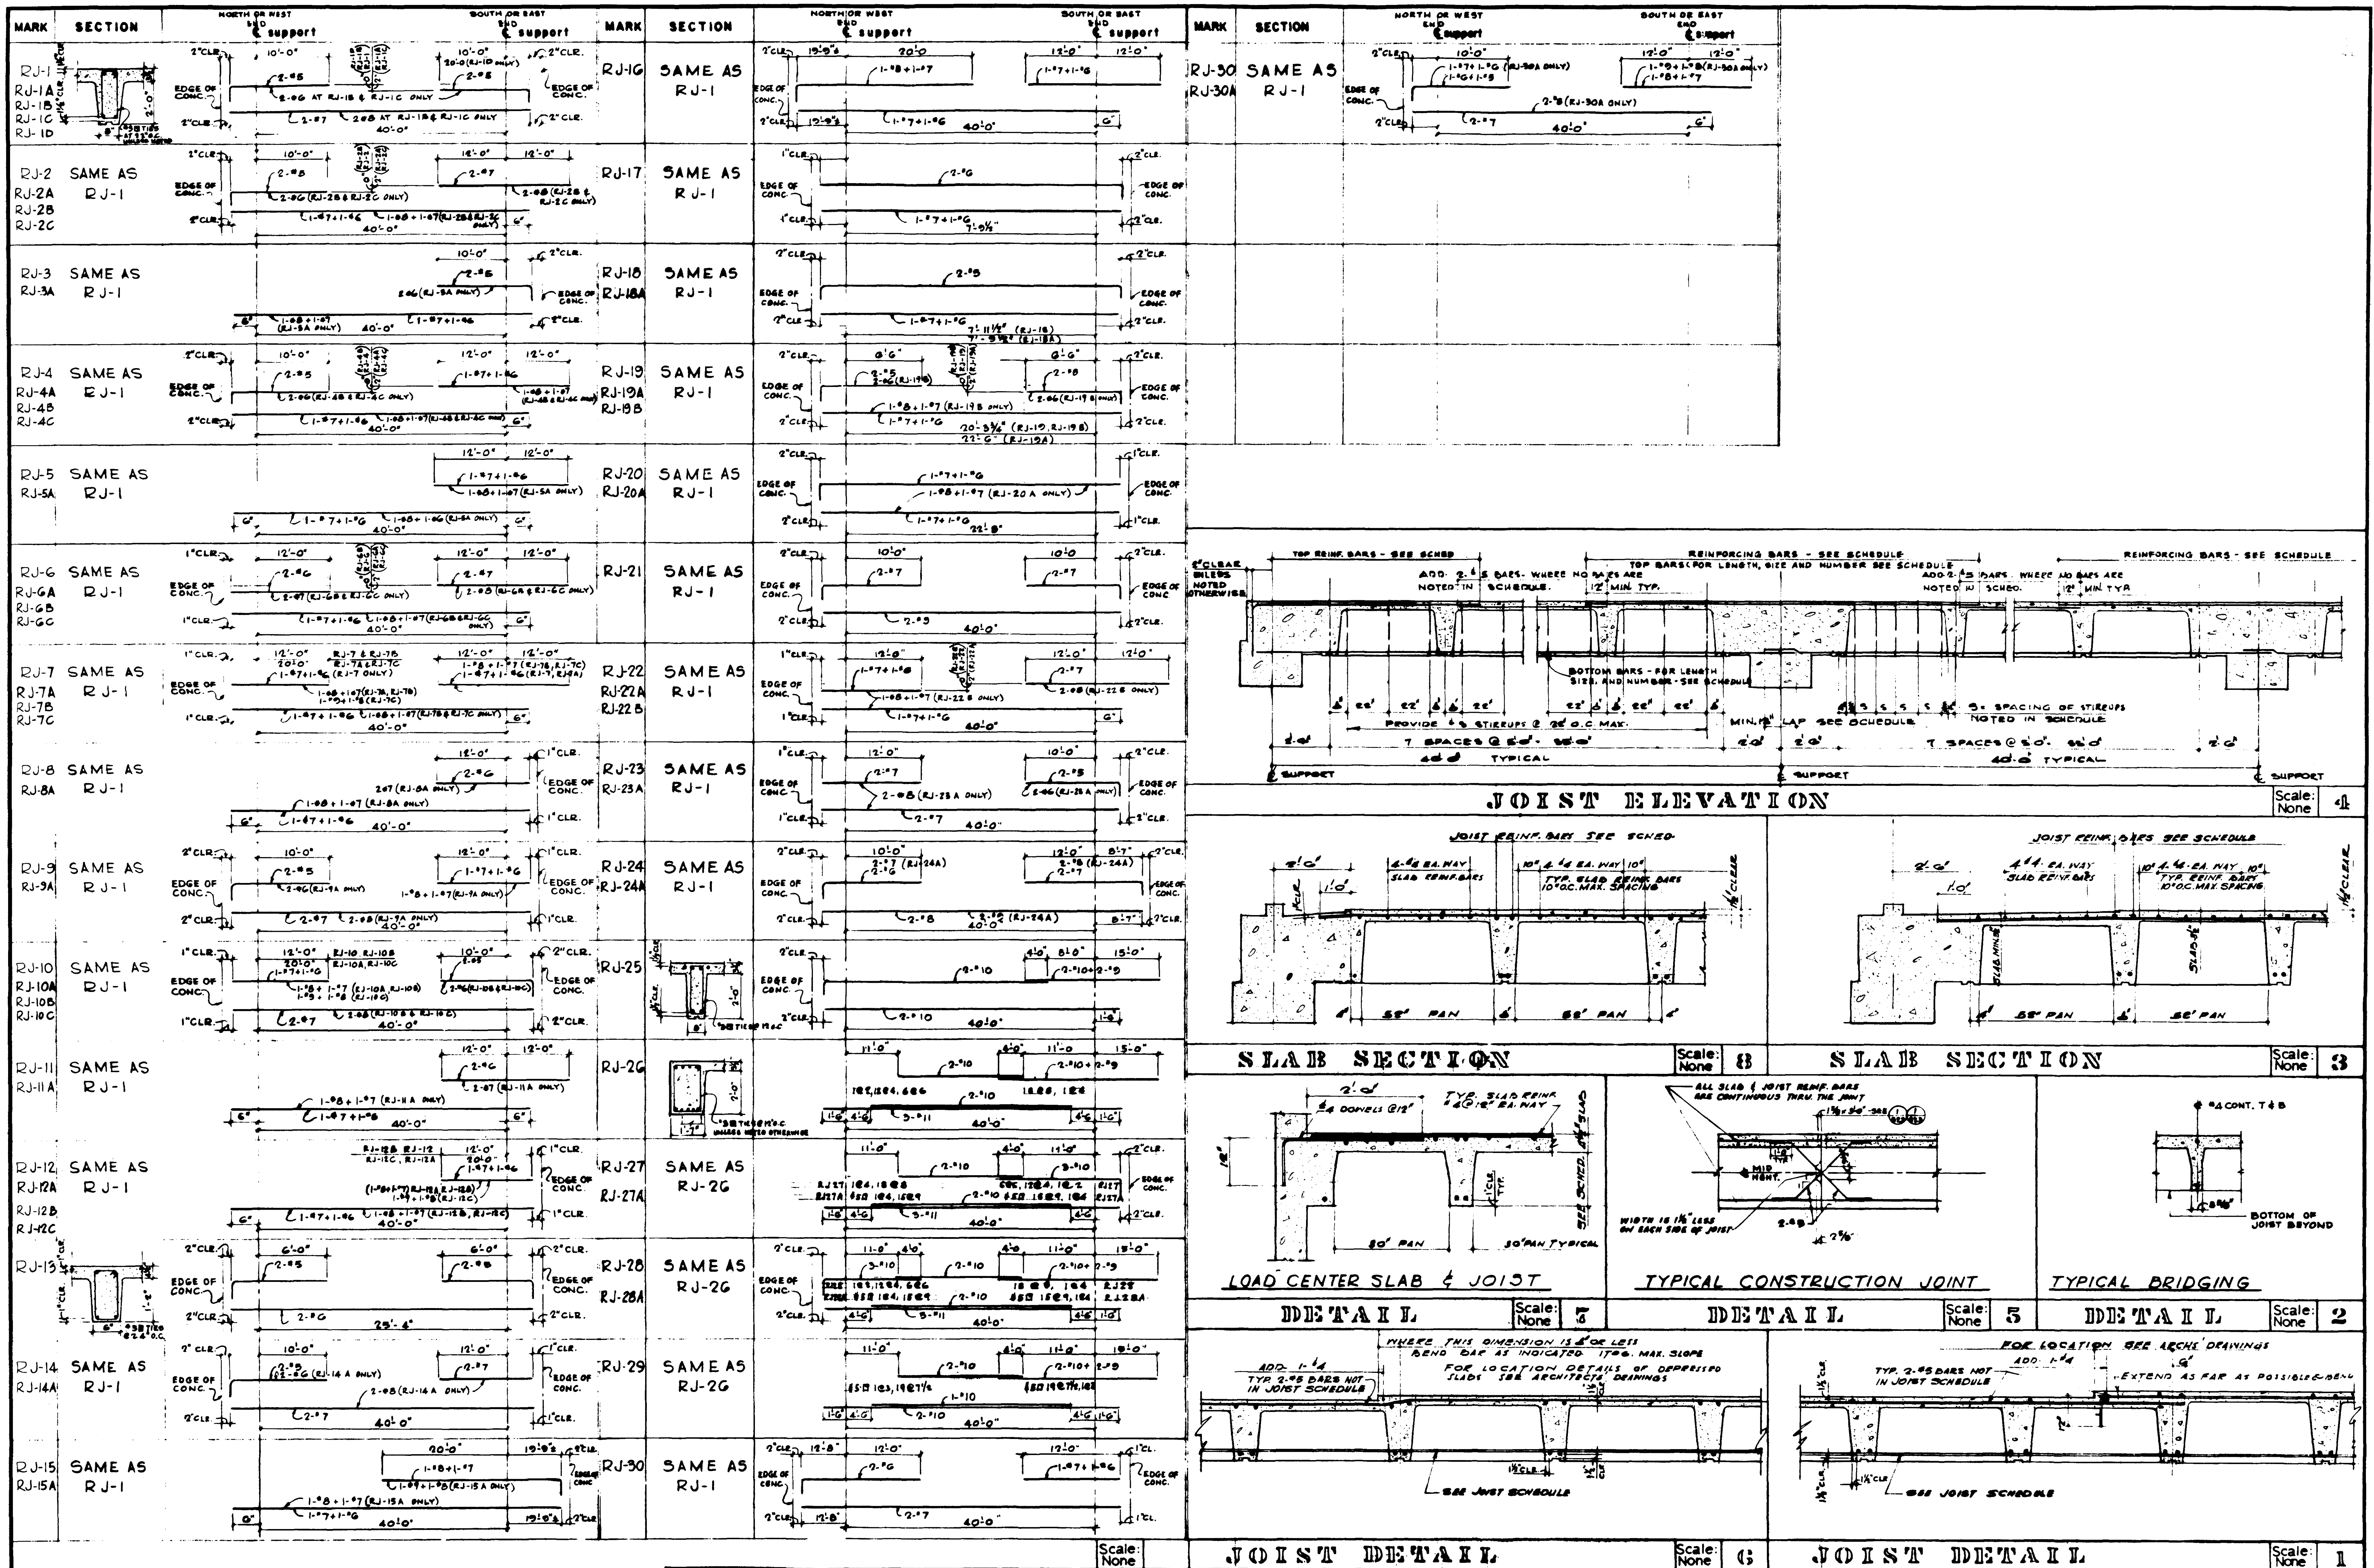

STRUCTURAL ENGINEERS RANDOLPH & JOHNSON 244 MARTIN & ASSOCIATES MECHANICAL ENGINEERS RALPH E. PHILLIPS, INC. ELECTRICAL ENGINEERS RALPH E. PHILLIPS, INC. CIVIL ENGINEERS G. HUBBARD & ASSOCIATES BOFFA & NICHOL	DESIGNED G.H.J. CHECKED G.H.J.	APPROVED STATE FIRE MARSHAL STATE OF CALIFORNIA JUN 21 1955	ASSOCIATED ARCHITECTS: WILLIAM L. PEREIRA & ASSOCIATES A. QUINN JONES-FREDERICK H. EDMONS & ASSOCIATES BLUENOCK HILLENBRONK & ASSOCIATES URBANUS SQUARE • MACARTHUR BOULEVARD AT FORD ROAD TELEPHONE 714/675-2640 • CORONA DEL MAR, CALIFORNIA	GOLDEN WEST COLLEGE HUNTINGTON BEACH, CALIFORNIA ORANGE COAST JUNIOR COLLEGE DISTRICT	JOIST SCHEDULE & TYP. DETAILS JOB NO. 104 DATE 10 JUN 1955 SHEET NO. S 7.1
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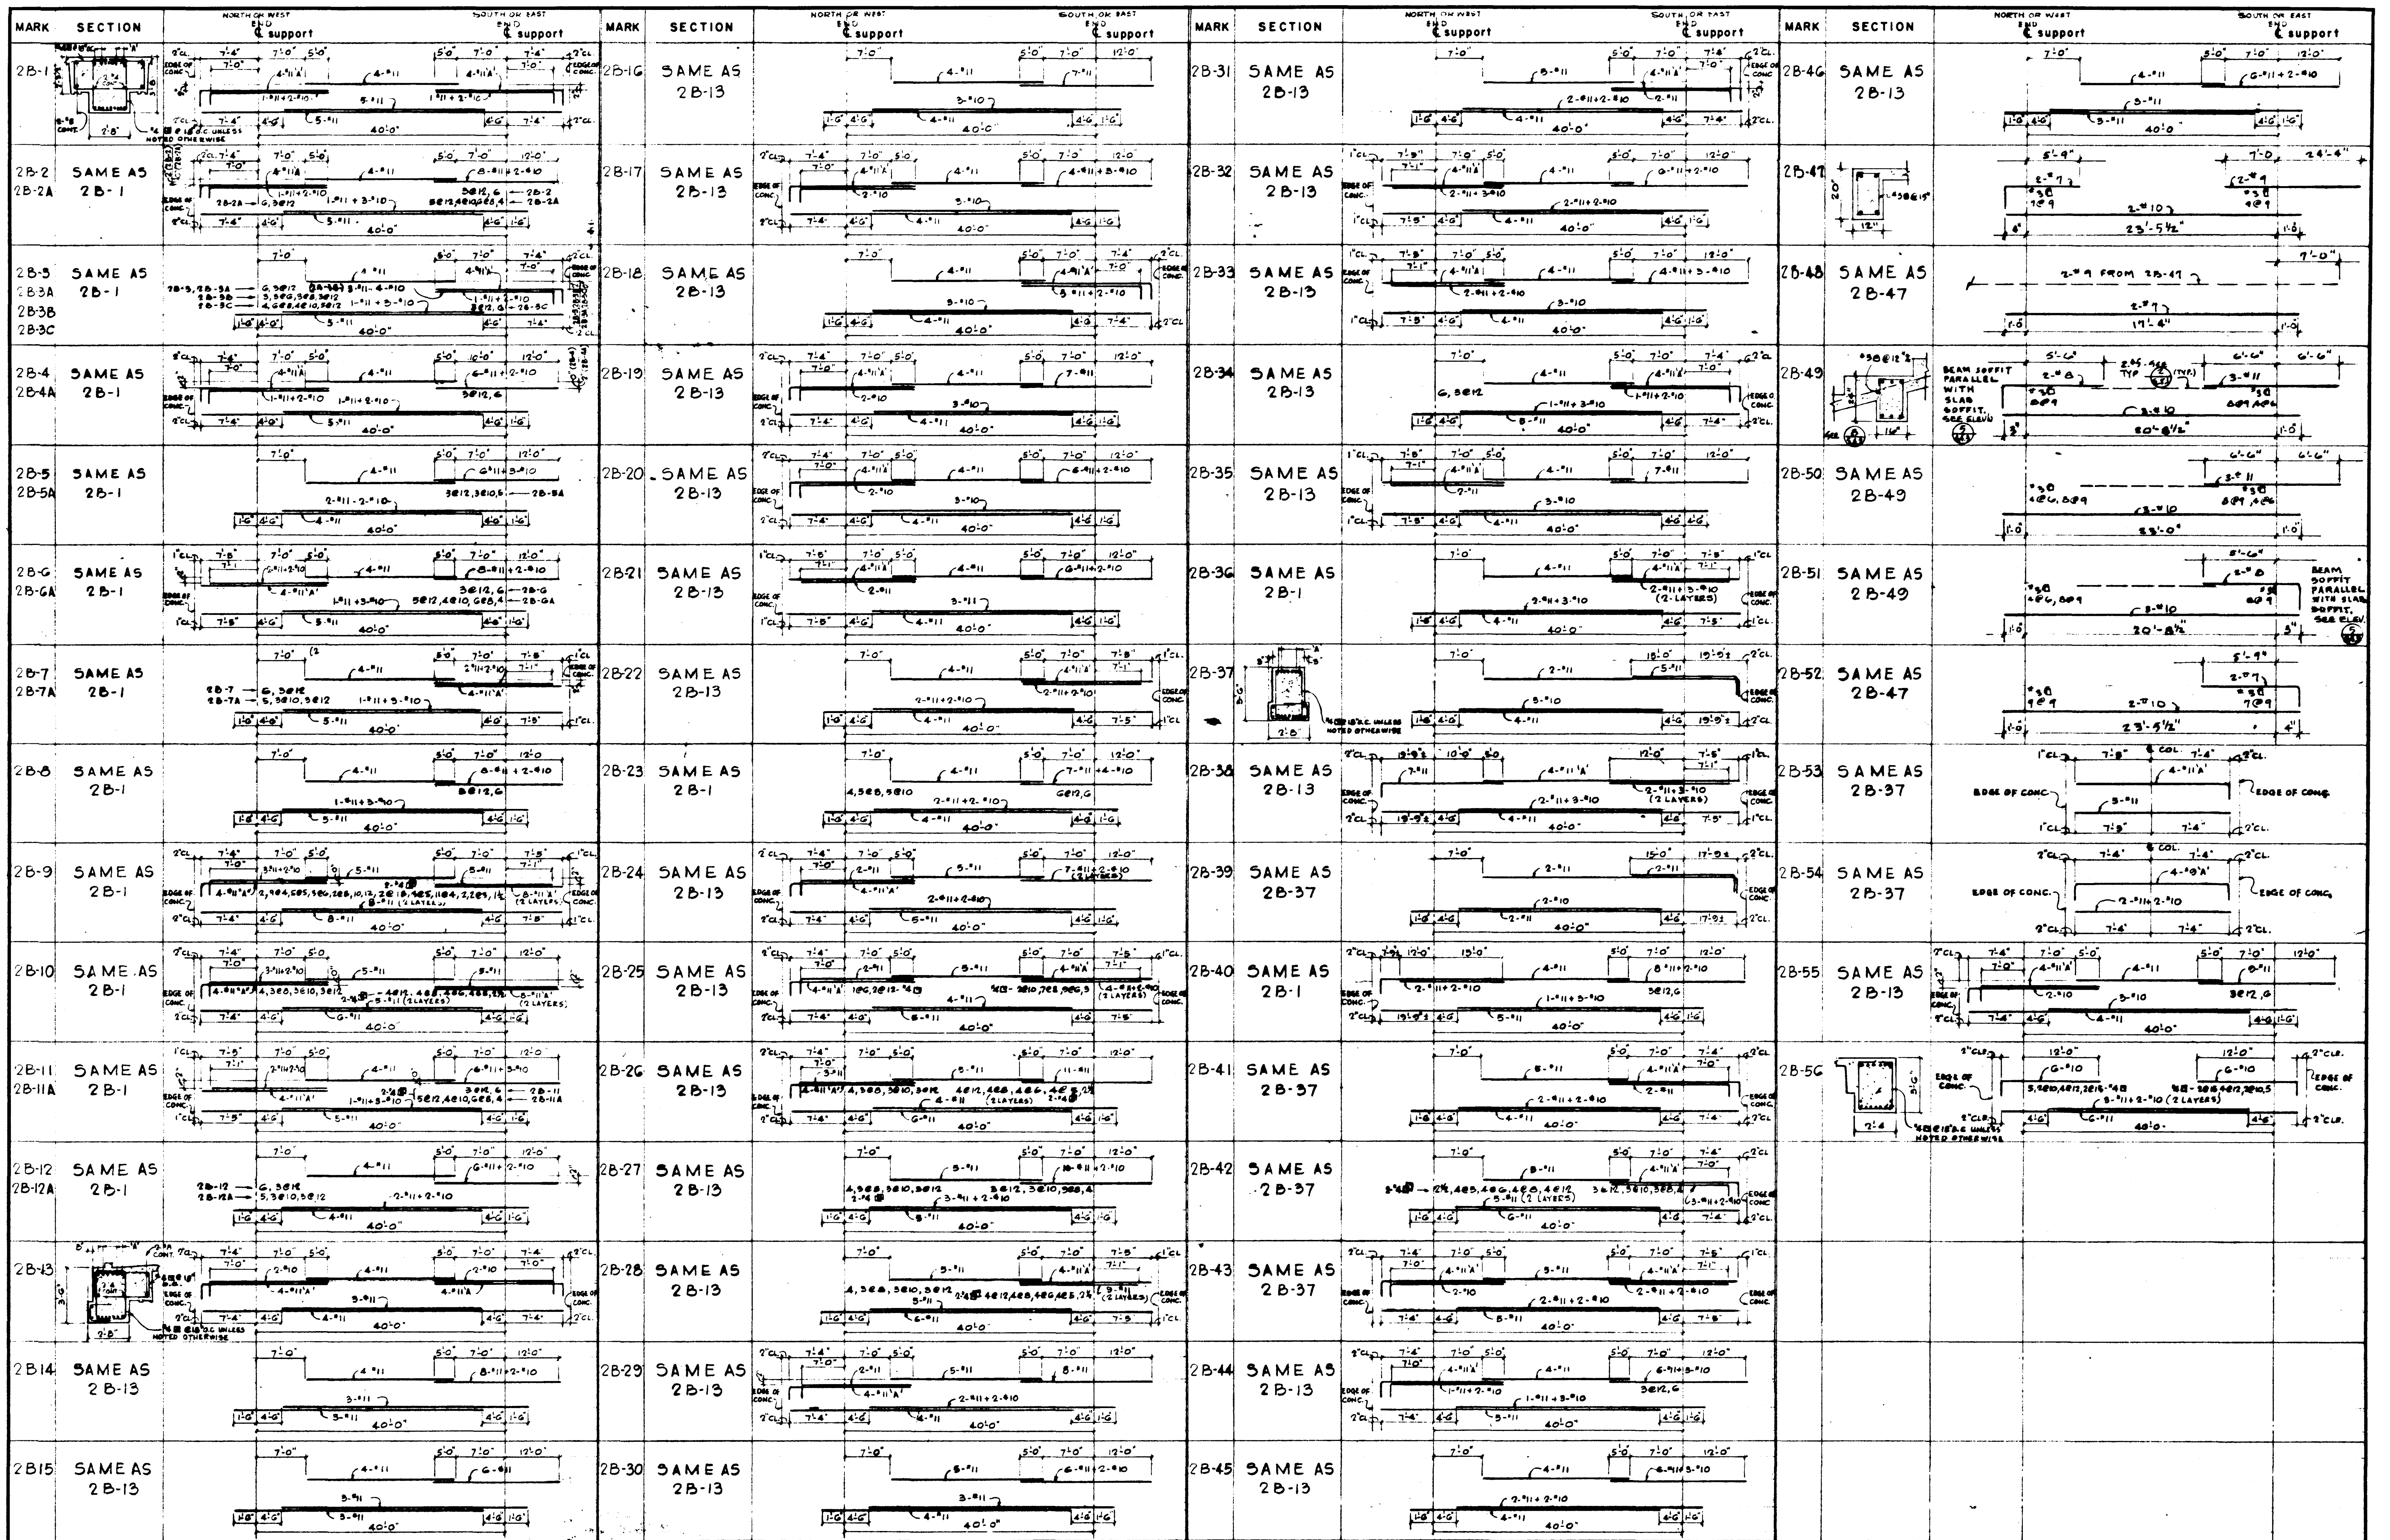


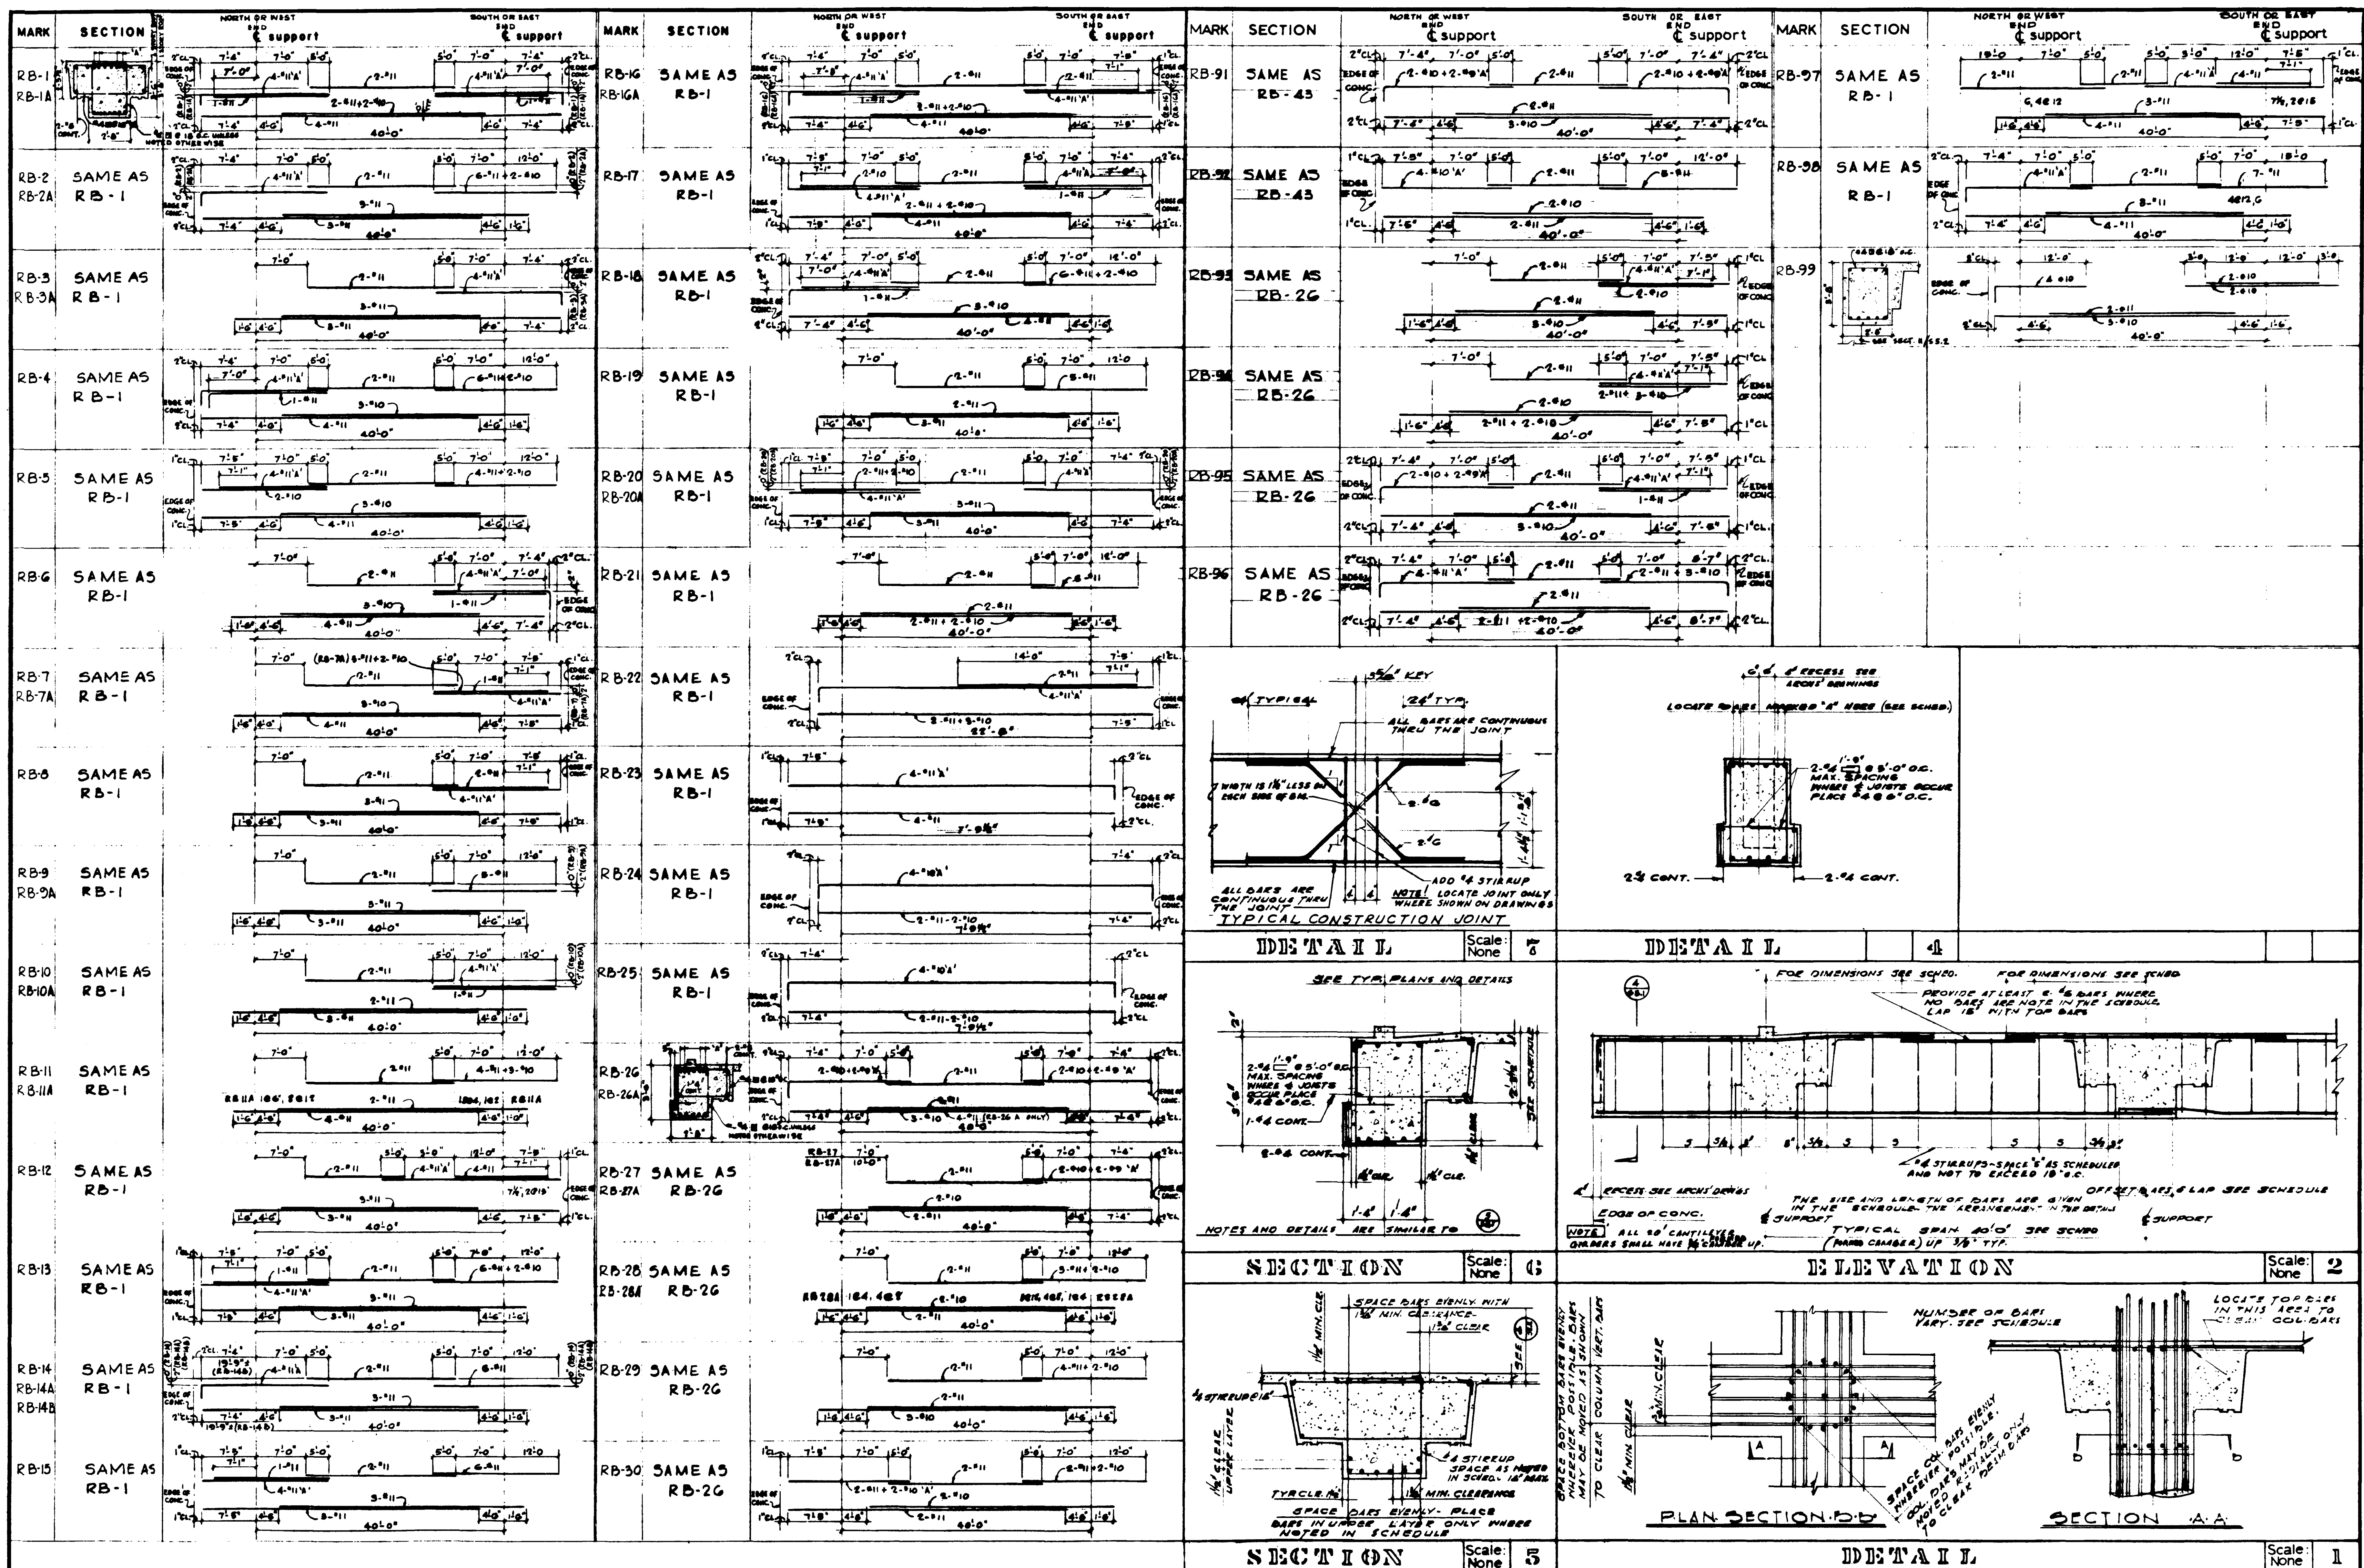
STRUCTURAL ENGINEERS SHANDOW & JOHNSON 1440 N. GARDEN ST. ANAHEIM, CALIF. 92805		DESIGNED GU		APPROVED 85874		ASSOCIATED ARCHITECTS: WILLIAM L. FERRERA & ASSOCIATES A. QUINCY JONES-FREDERICK E. HENSON & ASSOCIATES BLUEBOOK BLUEBOOK & ASSOCIATES URBANUS SQUARE • MACARTHUR BOULEVARD AT FORD ROAD TELEPHONE 714/675-2540 • CORONA DEL MAR, CALIFORNIA		GOLDEN WEST COLLEGE HUNTINGTON BEACH, CALIFORNIA ORANGE COAST JUNIOR COLLEGE DISTRICT		BEAM SCHEDULE & TYP. DETAILS 104 10 JUN 1980 S8.1	
MECHANICAL ENGINEERS RALPH E. PHILLIPS, INC. 1440 N. GARDEN ST. ANAHEIM, CALIF. 92805		DRAWN GU		APPROVED STATE FIRE MARSHAL STATE OF CALIFORNIA DATE JUN 21 1980							
ELECTRICAL ENGINEERS RALPH E. PHILLIPS, INC. 1440 N. GARDEN ST. ANAHEIM, CALIF. 92805		CHECKED GU									
CIVIL ENGINEERS G. SHUIMAN & ASSOCIATES 1440 N. GARDEN ST. ANAHEIM, CALIF. 92805											

MARK	SECTION	NORTH OR WEST END support	SOUTH OR EAST END support	MARK	SECTION	NORTH OR WEST END support	SOUTH OR EAST END support	MARK	SECTION	NORTH OR WEST END support	SOUTH OR EAST END support	MARK	SECTION	NORTH OR WEST END support	SOUTH OR EAST END support
RB-31	SAME AS RB-2G			RB-46	SAME AS RB-43			RB-61	SAME AS RB-2G			RB-76	SAME AS RB-1		
RB-32	SAME AS RB-2G			RB-47	SAME AS RB-2G			RB-62	SAME AS RB-2G			RB-77	SAME AS RB-2G		
RB-33	SAME AS RB-2G			RB-47A	SAME AS RB-43			RB-63	SAME AS RB-2G			RB-77A	SAME AS RB-1		
RB-34	SAME AS RB-2G			RB-48	SAME AS RB-2G			RB-64	SAME AS RB-2G			RB-78	SAME AS RB-2G		
RB-35	SAME AS RB-2G			RB-49	SAME AS RB-43			RB-65	SAME AS RB-43			RB-78A	SAME AS RB-43		
RB-36	SAME AS RB-2G			RB-50	SAME AS RB-2G			RB-66	SAME AS RB-2G			RB-79	SAME AS RB-43		
RB-37	SAME AS RB-2G			RB-51				RB-66A	SAME AS RB-1			RB-79A	SAME AS RB-2G		
RB-38	SAME AS RB-2G			RB-52	SAME AS RB-2G			RB-67	SAME AS RB-43			RB-80	SAME AS RB-2G		
RB-39	SAME AS RB-2G			RB-53	SAME AS RB-43			RB-67A	SAME AS RB-2G			RB-80A	SAME AS RB-2G		
RB-40	SAME AS RB-2G			RB-54	SAME AS RB-43			RB-68	SAME AS RB-2G			RB-81	SAME AS RB-2G		
RB-41	SAME AS RB-2G			RB-54A	SAME AS RB-2G			RB-68A	SAME AS RB-2G			RB-82	SAME AS RB-43		
RB-42	SAME AS RB-2G			RB-55	SAME AS RB-2G			RB-69	SAME AS RB-43			RB-83	SAME AS RB-2G		
RB-43				RB-55A	SAME AS RB-43			RB-70	SAME AS RB-43			RB-84	SAME AS RB-2G		
RB-44	SAME AS RB-43			RB-56	SAME AS RB-2G			RB-70A	SAME AS RB-43			RB-84A	SAME AS RB-1		
RB-45	SAME AS RB-43			RB-57	SAME AS RB-2G			RB-71	SAME AS RB-43			RB-85	SAME AS RB-43		
				RB-58	SAME AS RB-2G			RB-72	SAME AS RB-2G			RB-86	SAME AS RB-2G		
				RB-59	SAME AS RB-2G			RB-73	SAME AS RB-2G			RB-87	SAME AS RB-2G		
				RB-60	SAME AS RB-2G			RB-74	SAME AS RB-1			RB-88	SAME AS RB-2G		
								RB-75	SAME AS RB-2G			RB-89	SAME AS RB-1		
												RB-90	SAME AS RB-2G		


NOTE: FOR CONTINUATION OF ROOF BEAM SCHEDULE, SEE SHEET 58.1.

STRUCTURAL ENGINEERS BRADY & JOHNSON J.A. MARTIN & ASSOCIATES MECHANICAL ENGINEERS RALPH E. PHILLIPS, INC. ELECTRICAL ENGINEERS RALPH E. PHILLIPS, INC. CIVIL ENGINEERS G. SHURMAN & ASSOCIATES MOFFATT & NICHOL	DESIGNED GU DRAWN BY GU CHECKED BY GU	ARCHITECT WILLIAM L. PEREIRA & ASSOCIATES A. QUINCY JONES-FREDERICK E. EMMONS & ASSOCIATES BLUROCK ELLERBROCK & ASSOCIATES URBANUS SQUARE • MACARTHUR BOULEVARD AT FORD ROAD TELEPHONE 714/675-2640 • CORONA DEL MAR, CALIFORNIA	25874 APPROVED JUN 21 1966 2 APR	GOLDEN WEST COLLEGE HUNTINGTON BEACH, CALIFORNIA ORANGE COAST JUNIOR COLLEGE DISTRICT	JOB NO. 1004 DATE 16 JUNE 1966 SHEET NO. S 8.2
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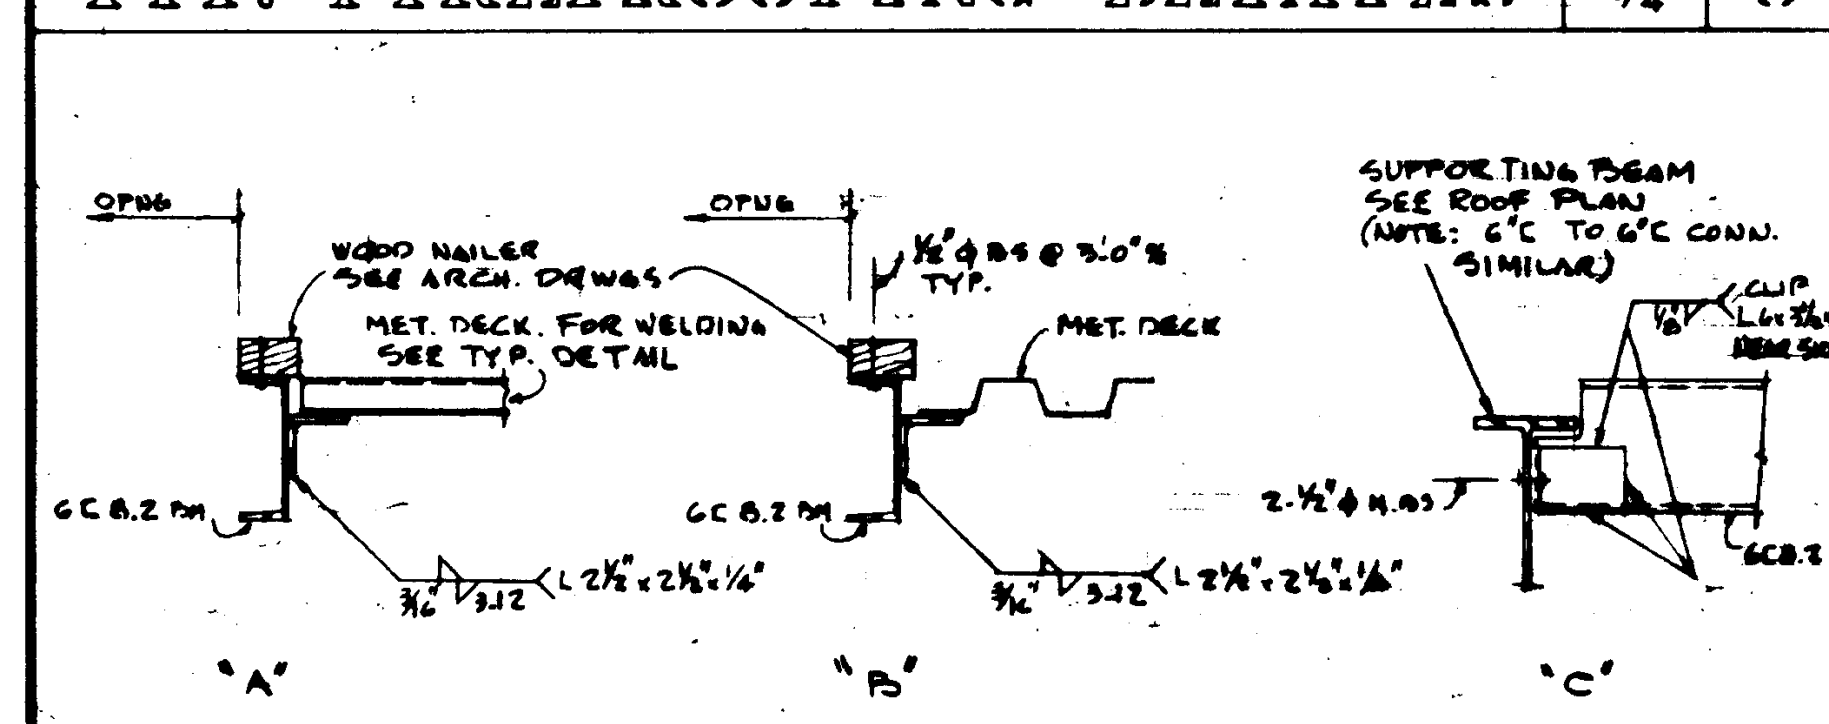


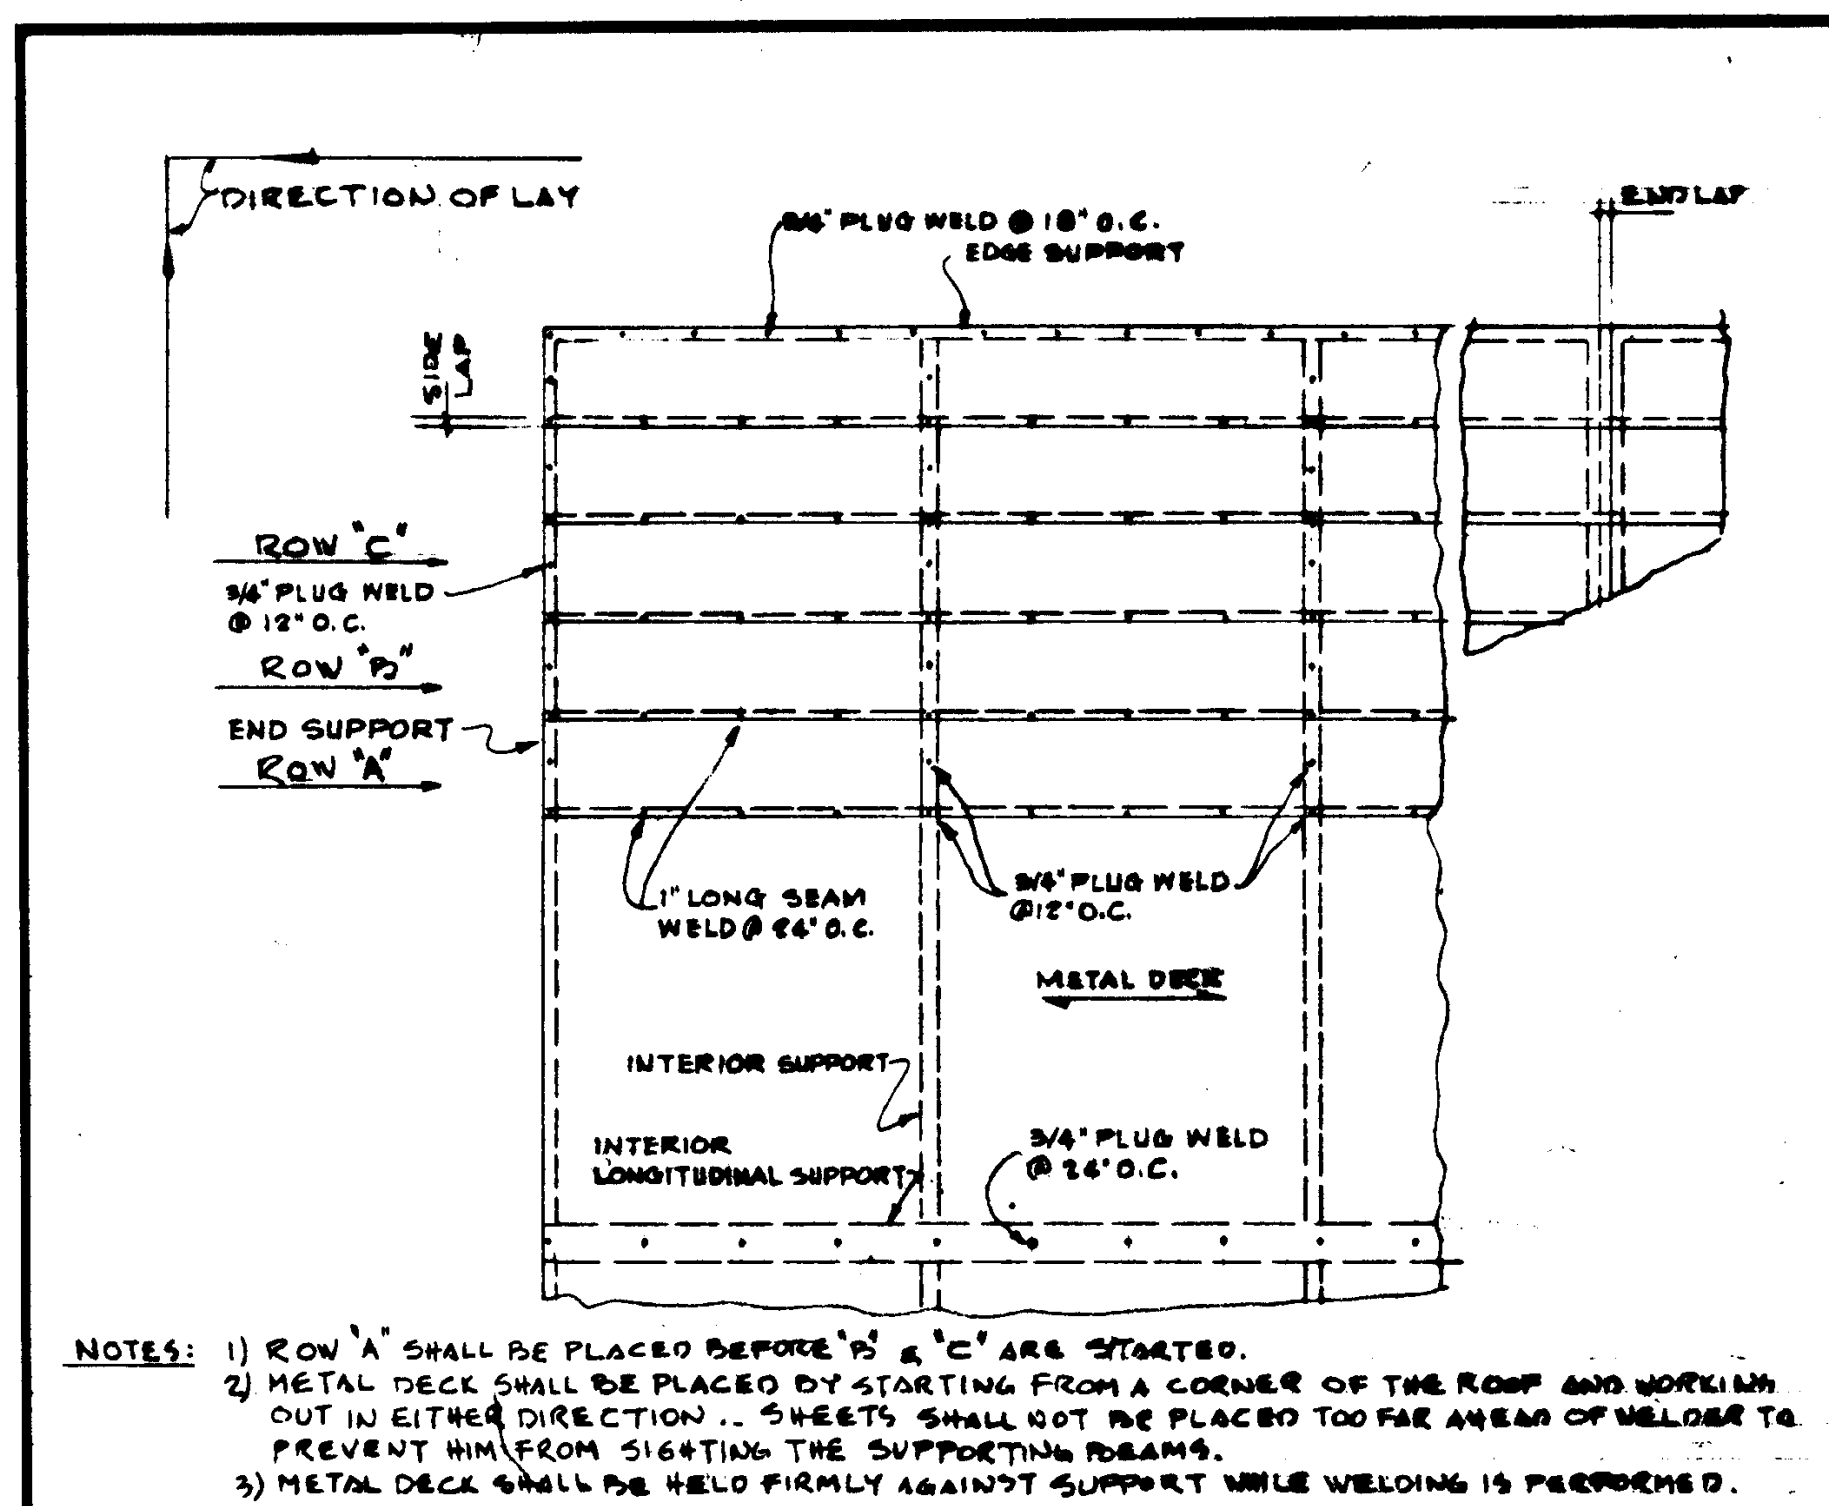


TYP. METAL DECK DETAIL SCALE 1/4" = 1'-0"

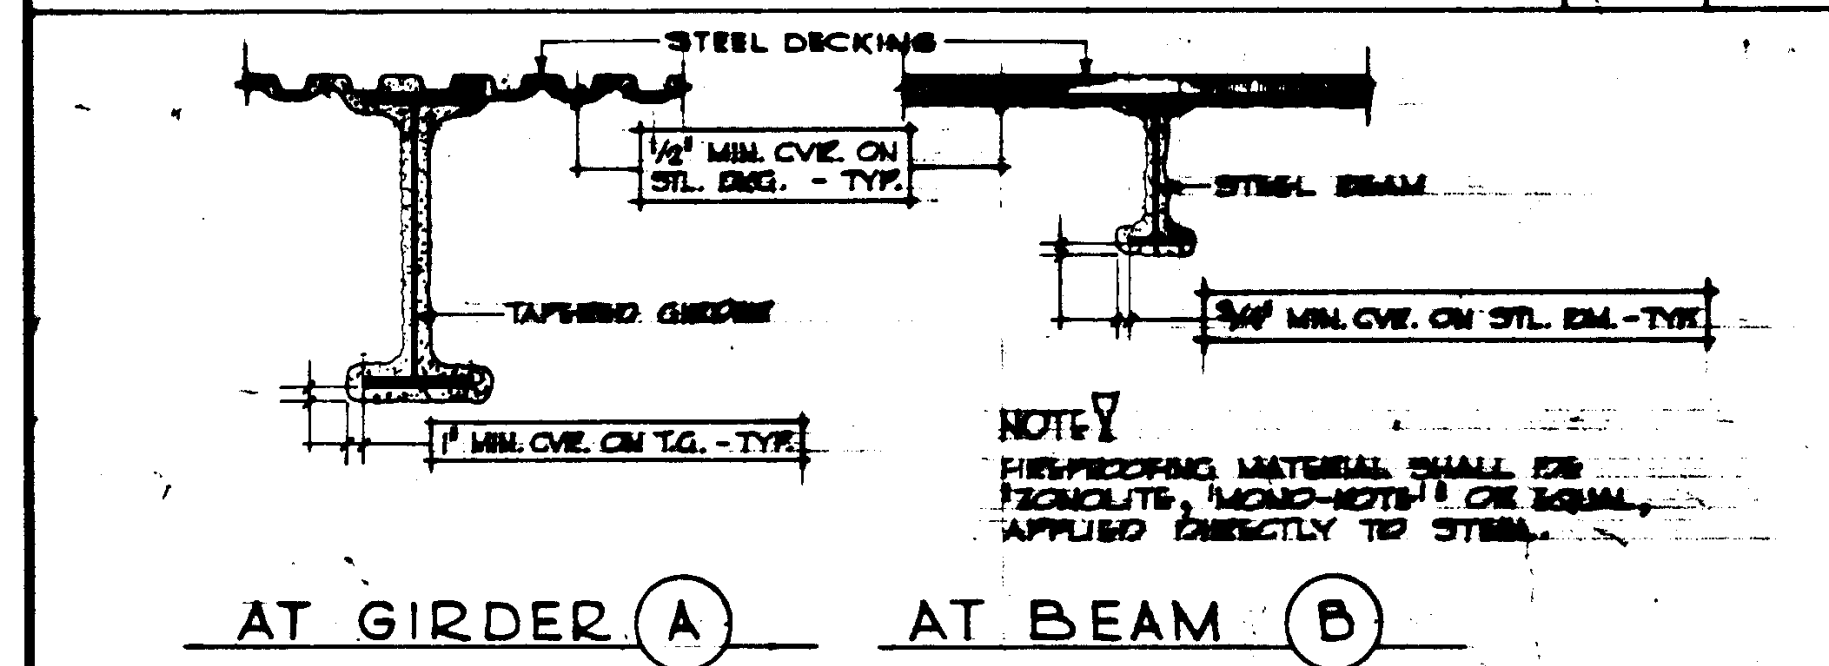


TYP. FIREPROOFING DETAILS SCALE 1/4" = 1'-0"




TYP. ROOF DPG. DETAILS SCALE 1/4" = 1'-0"

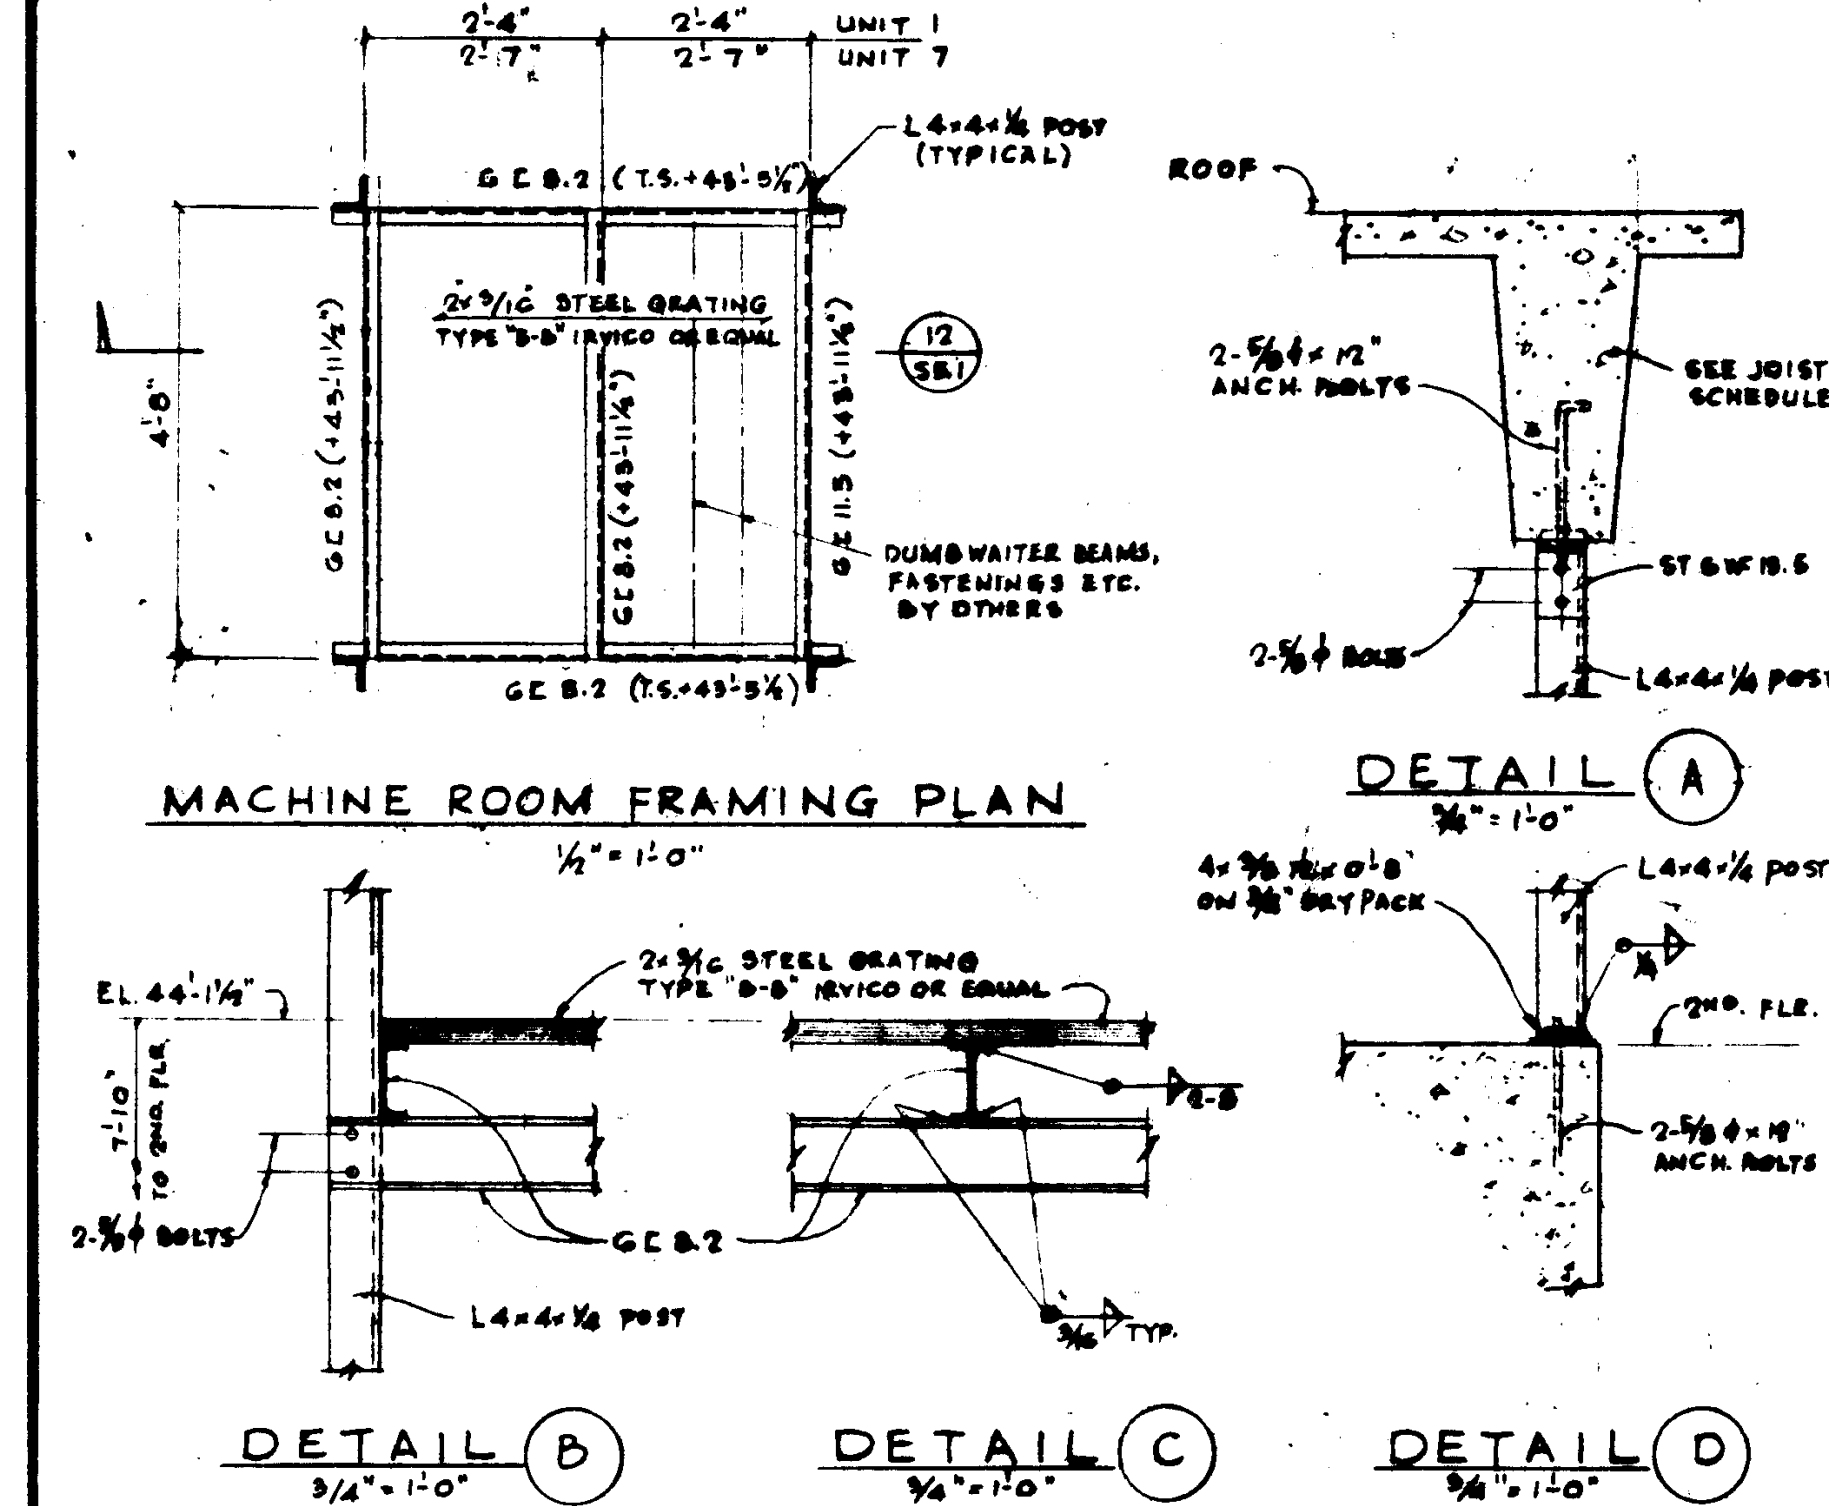


MACHINE ROOM FRAMING PLAN SCALE 1/4" = 1'-0"

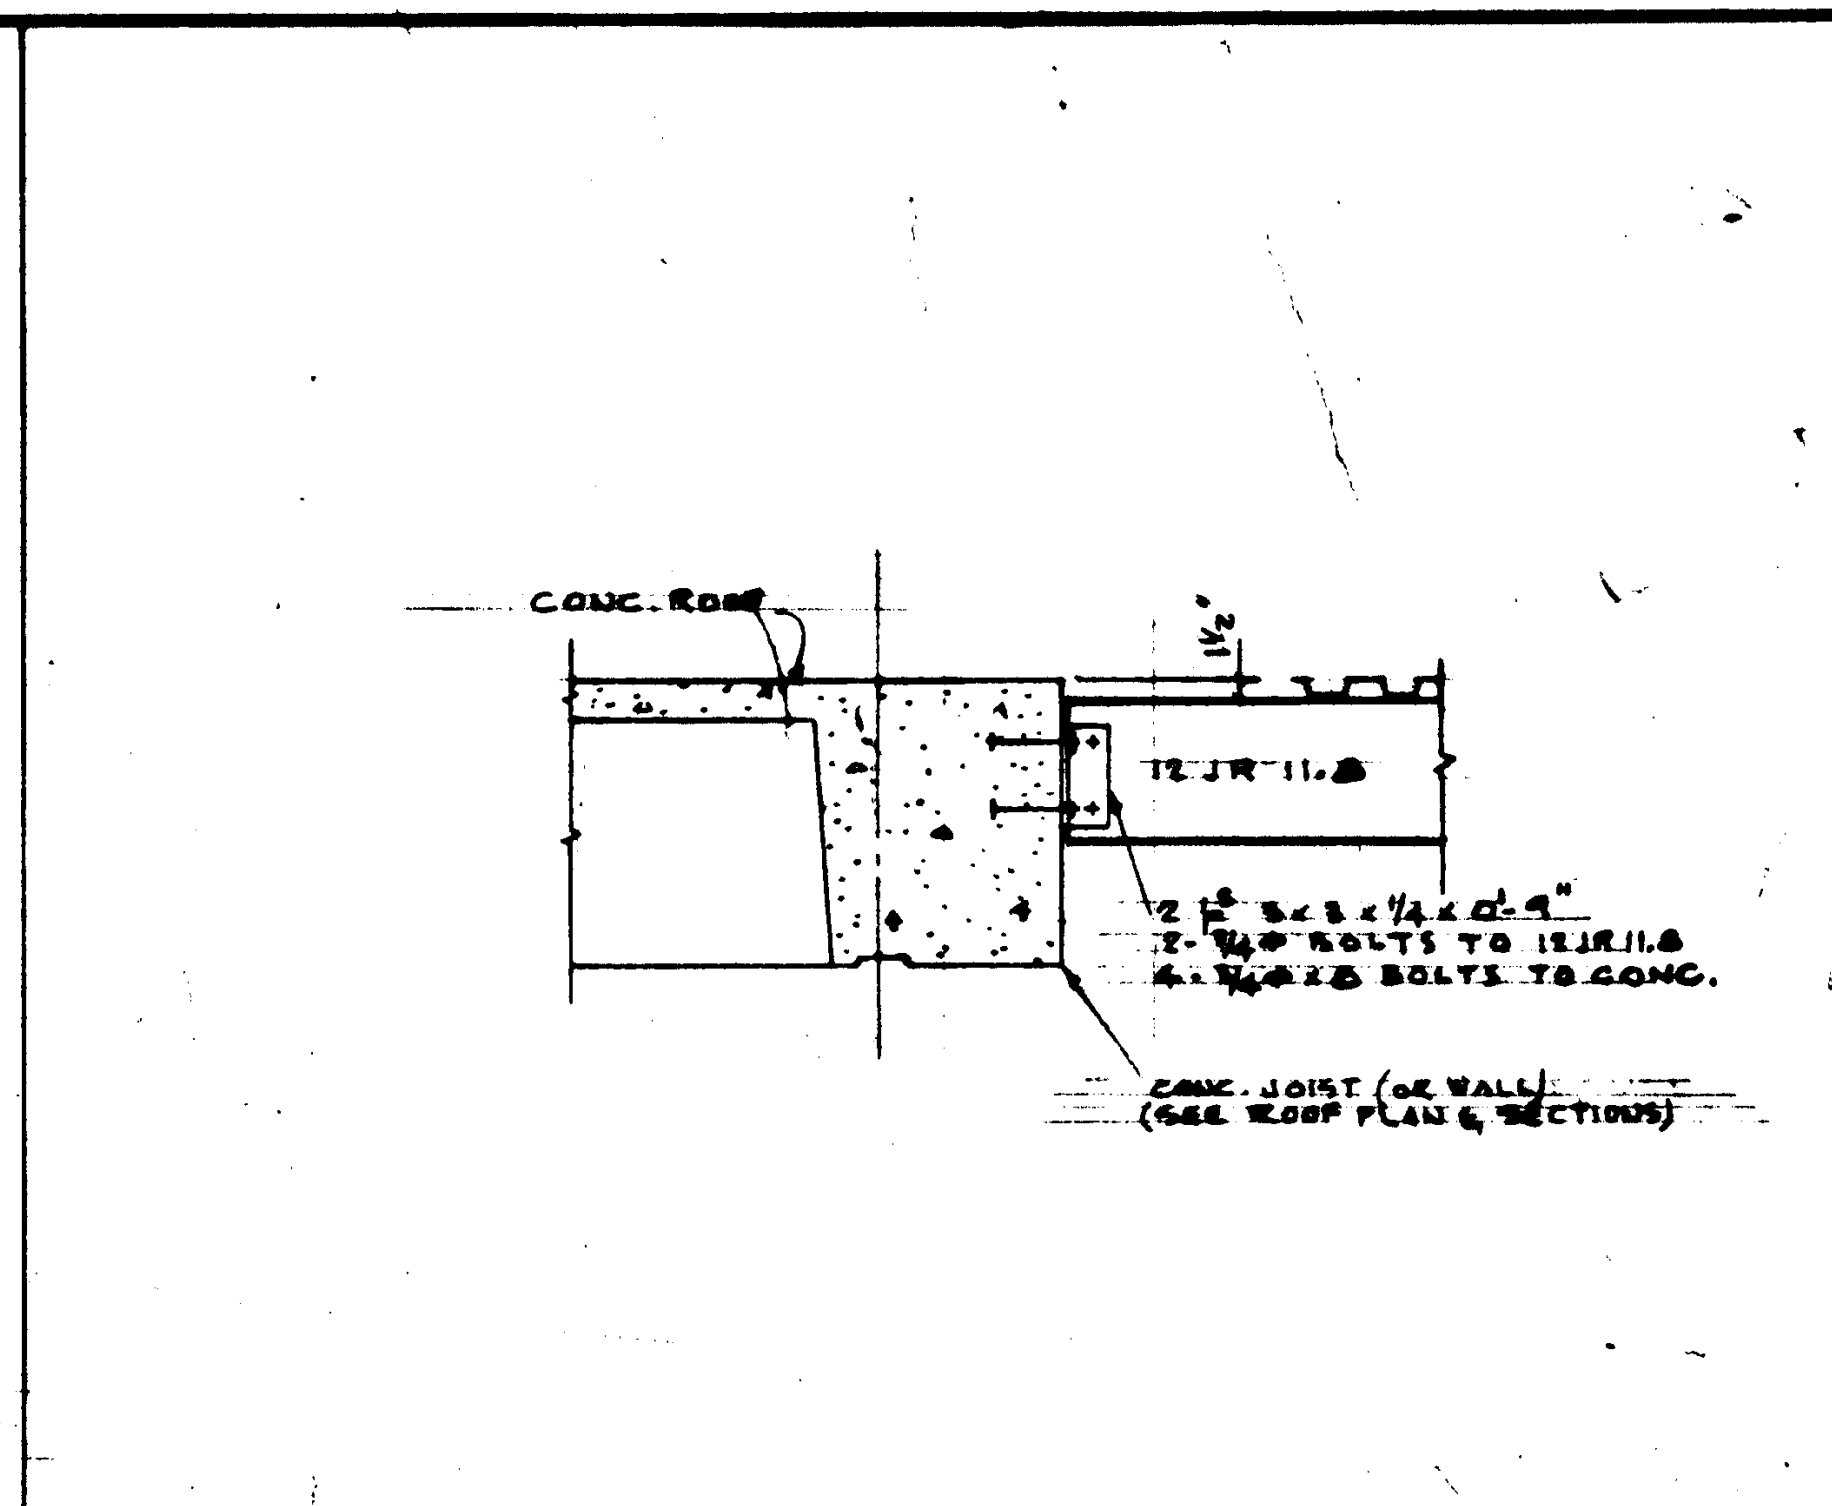


SECTION SCALE 1/4" = 1'-0"

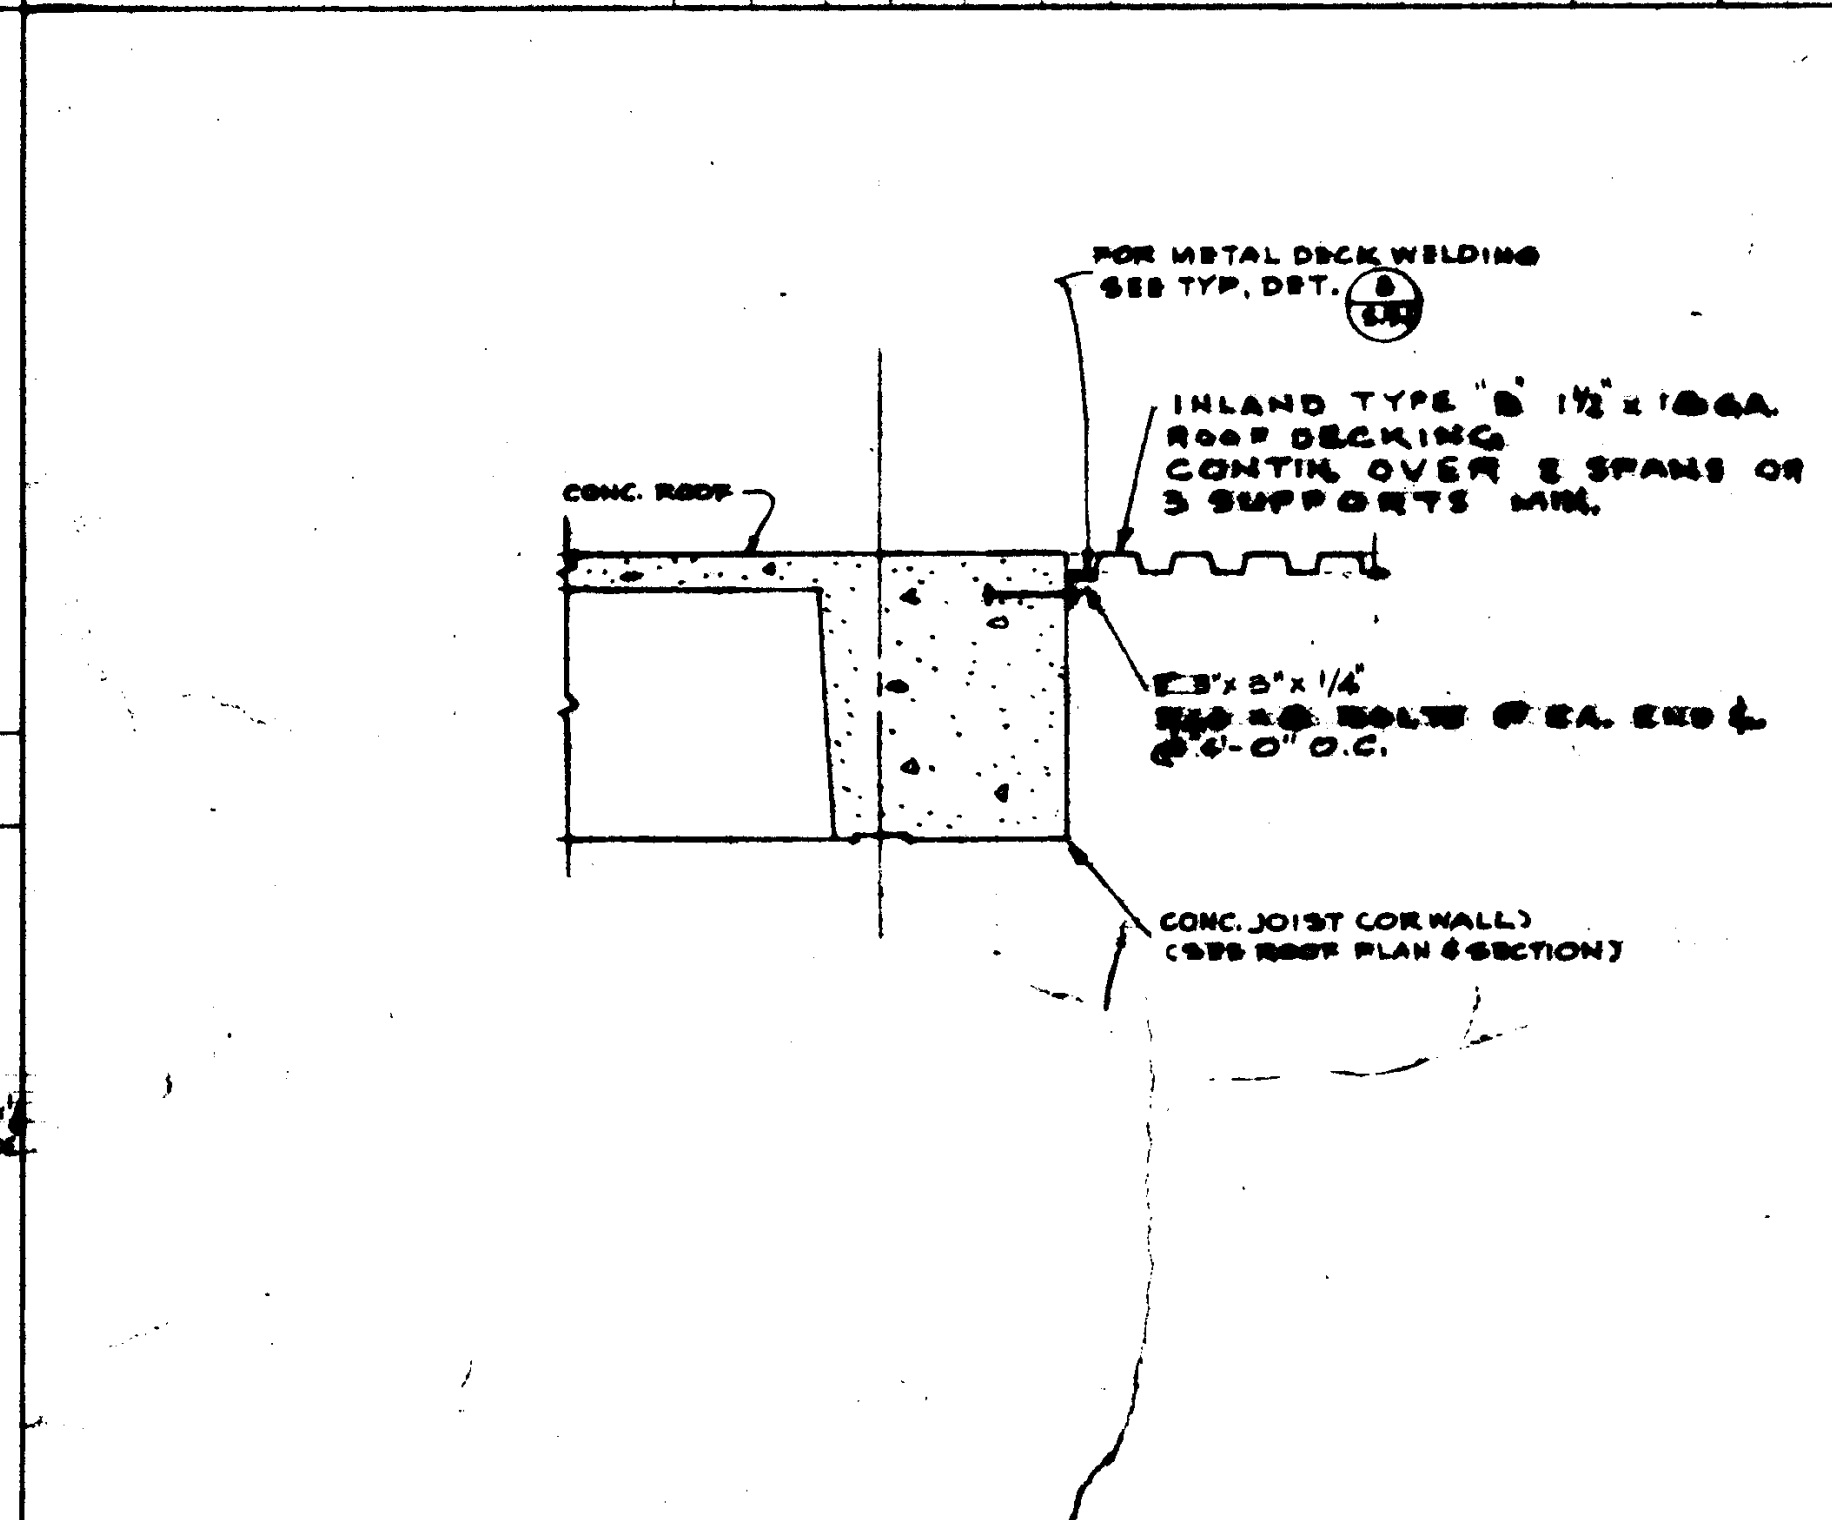


SECTION SCALE 1/4" = 1'-0"

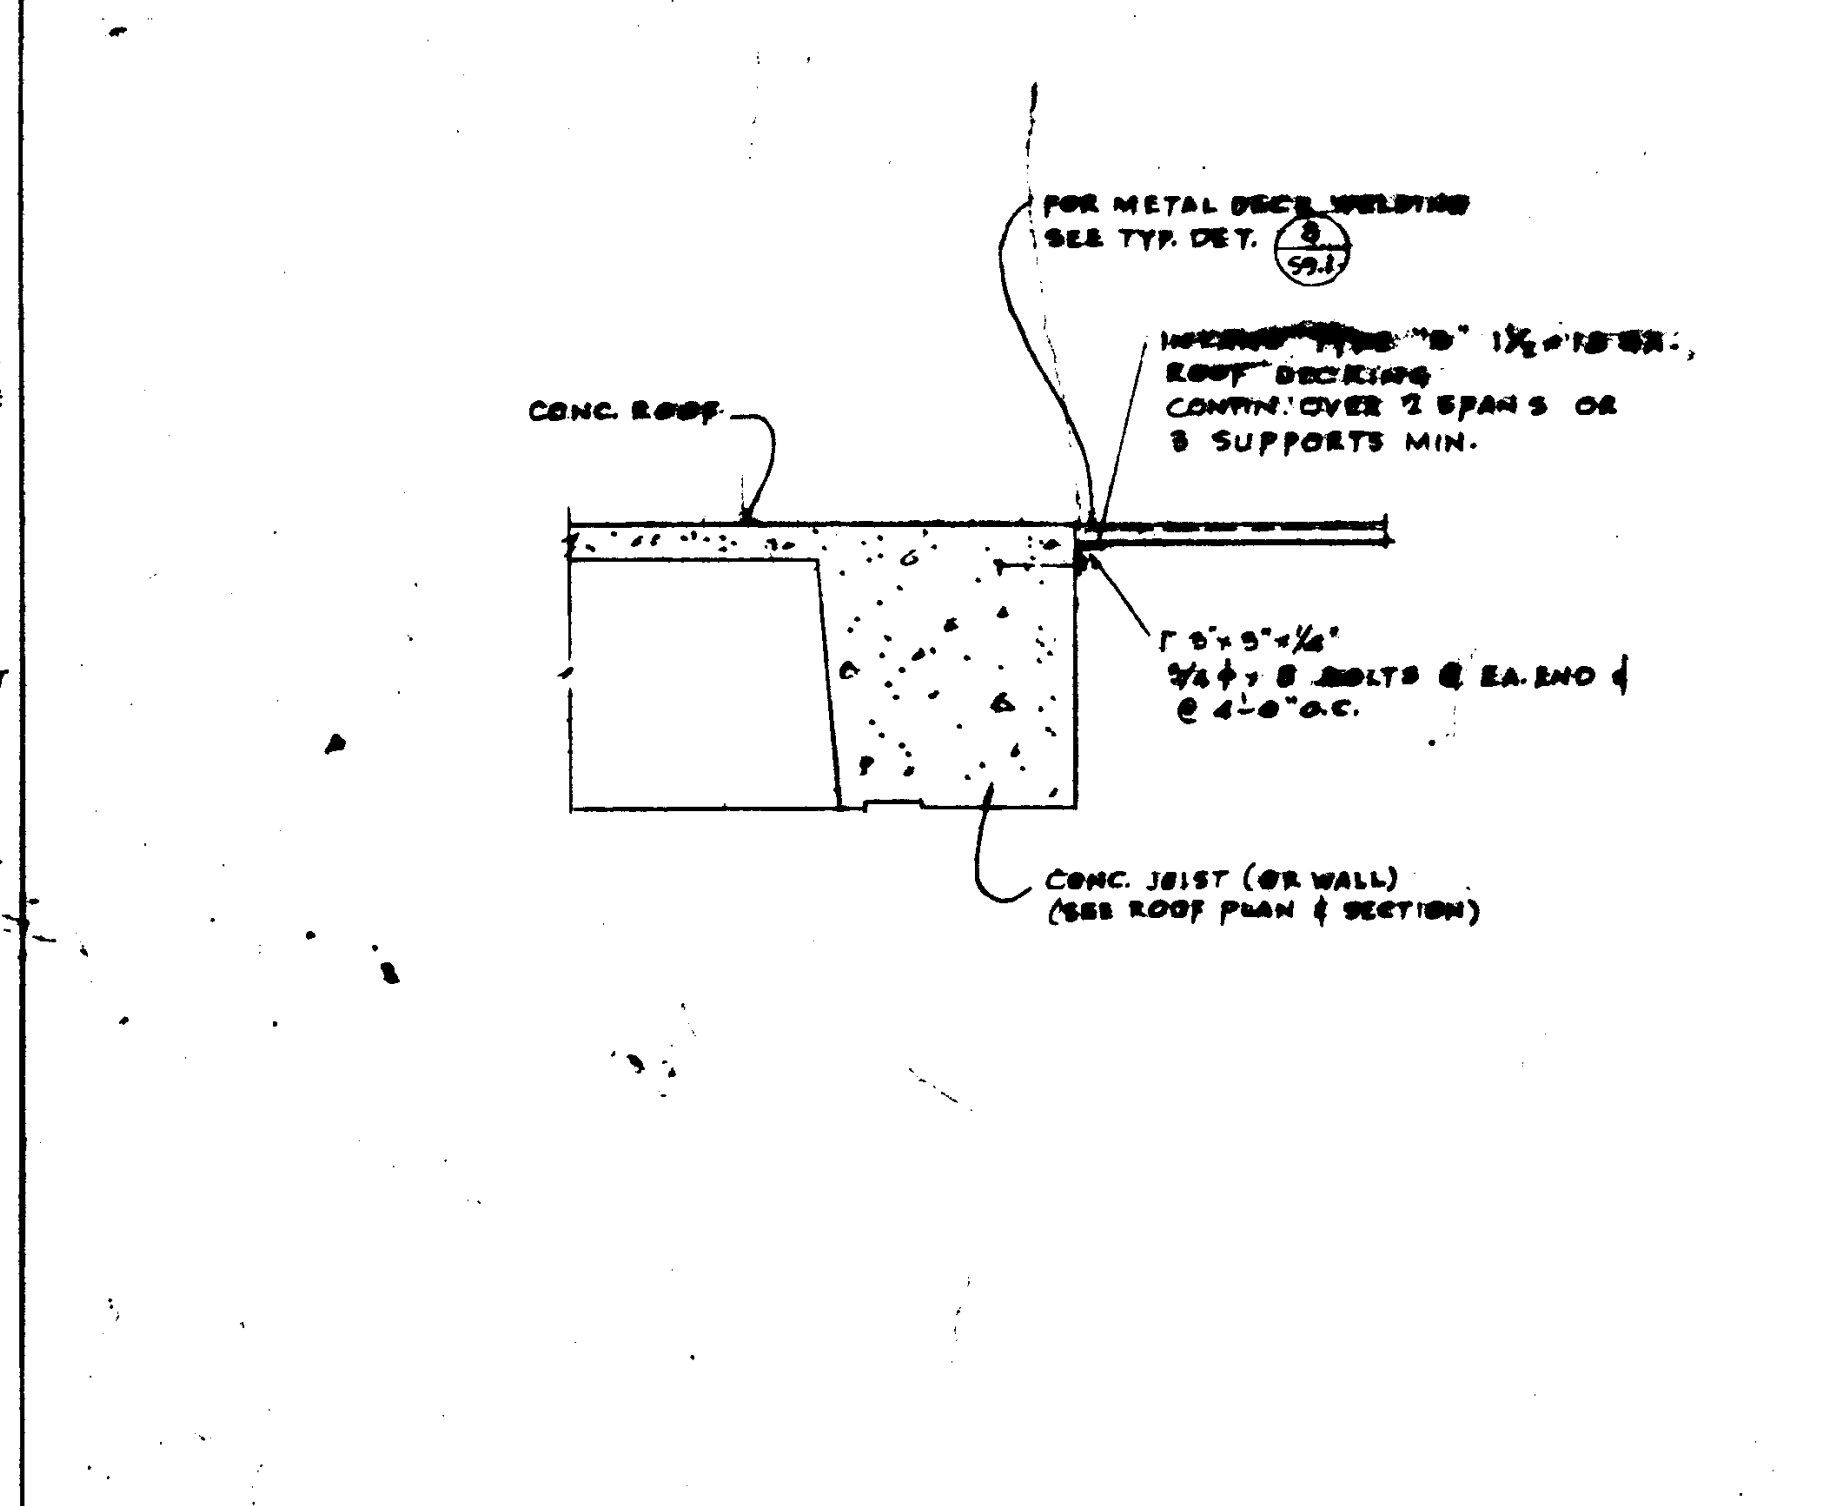


SECTION SCALE 1/4" = 1'-0"

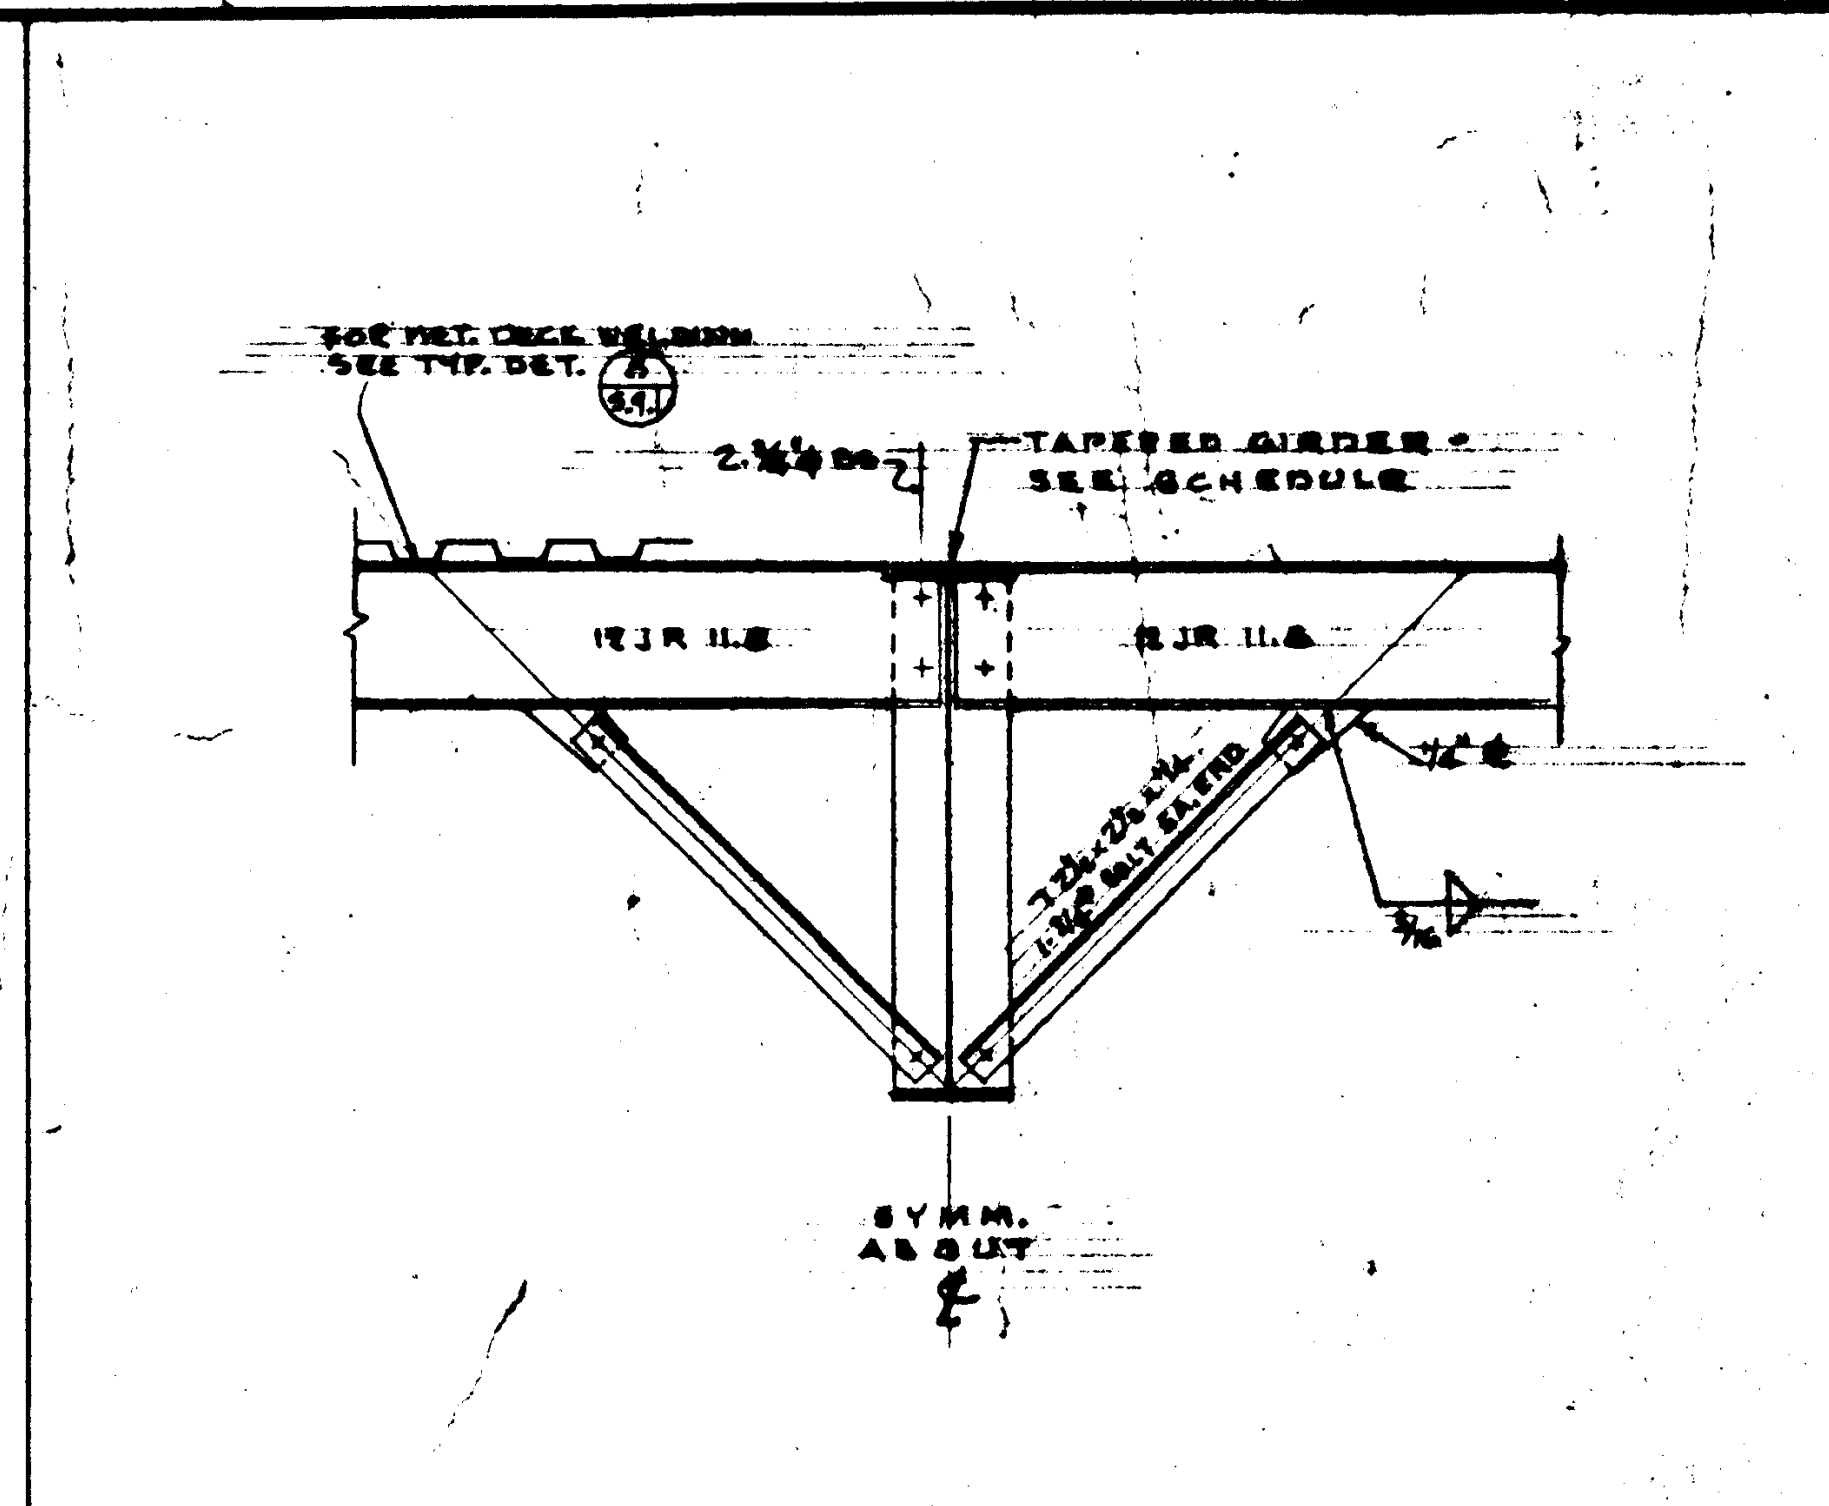


SECTION SCALE 1/4" = 1'-0"

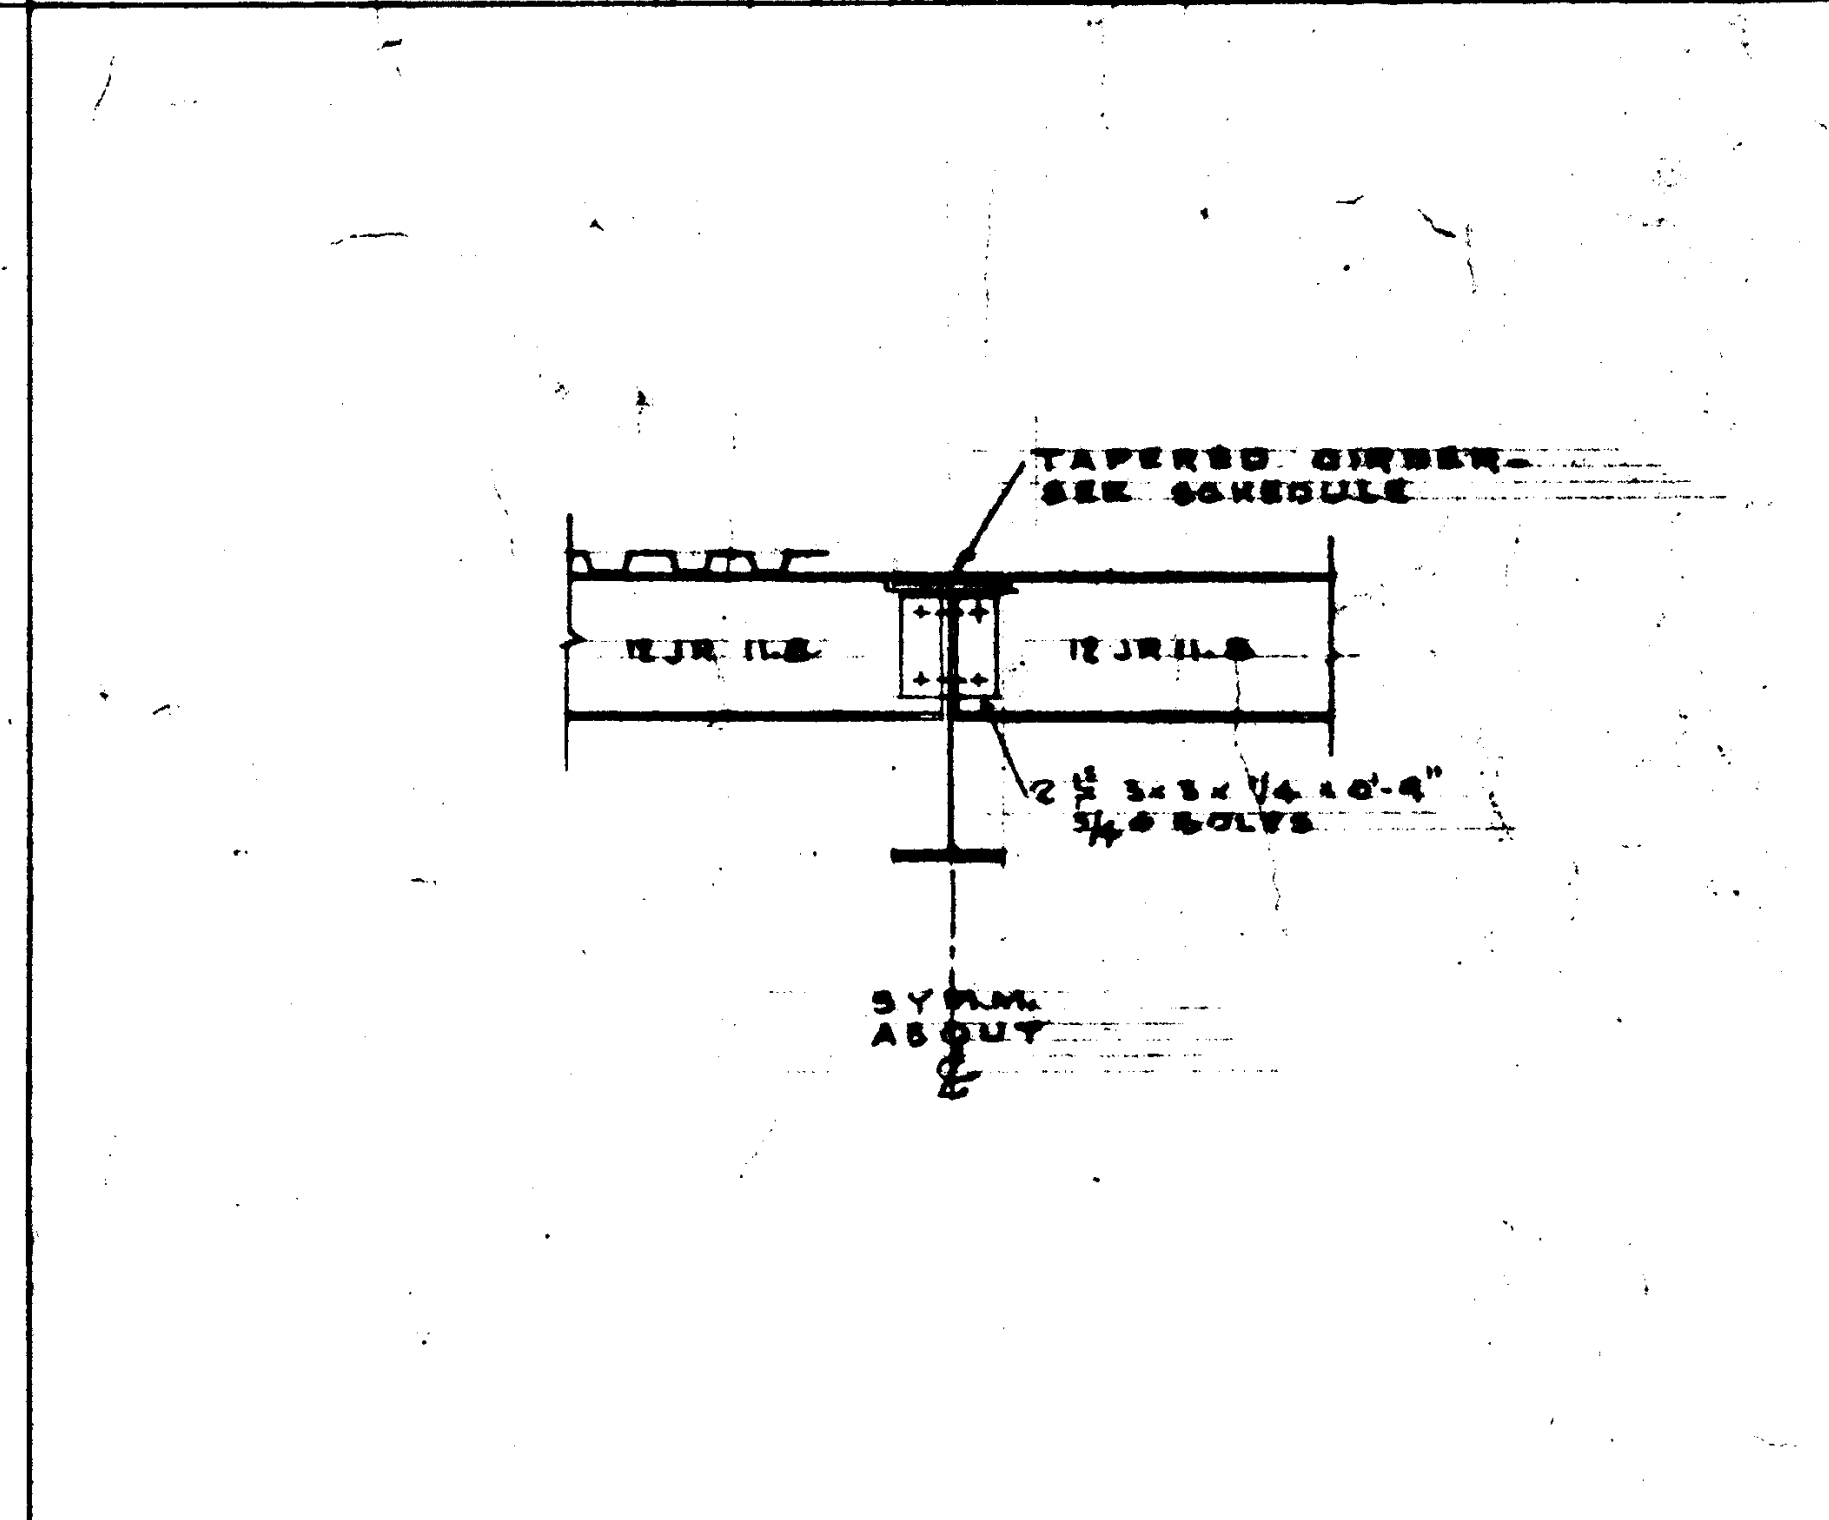


SECTION SCALE 1/4" = 1'-0"

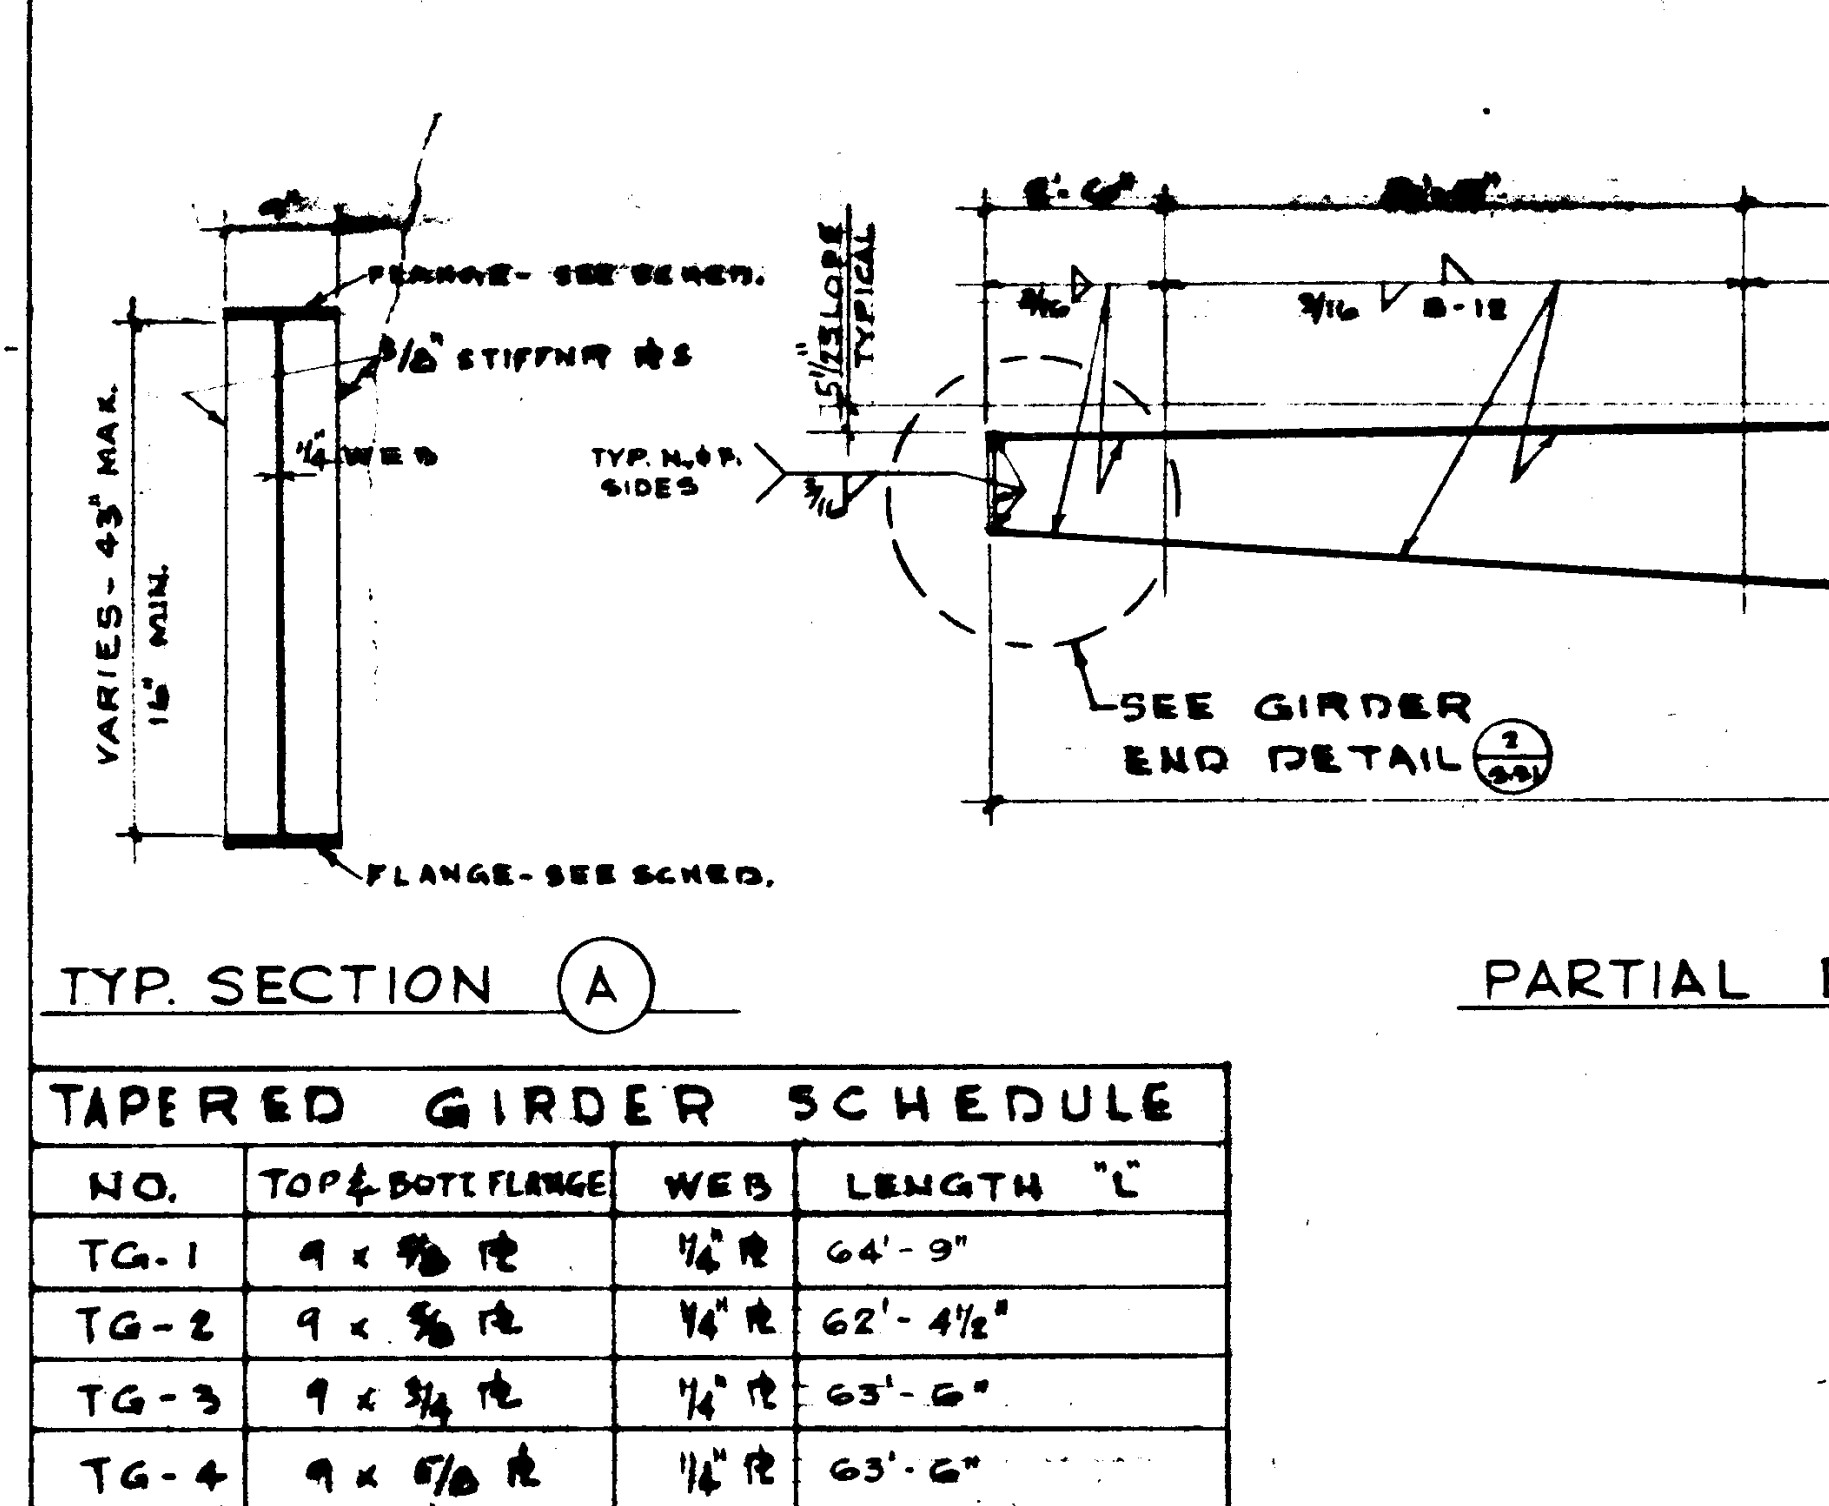


TYP. SECTION (A) and PARTIAL ELEVATION (B) SCALE 1/4" = 1'-0"

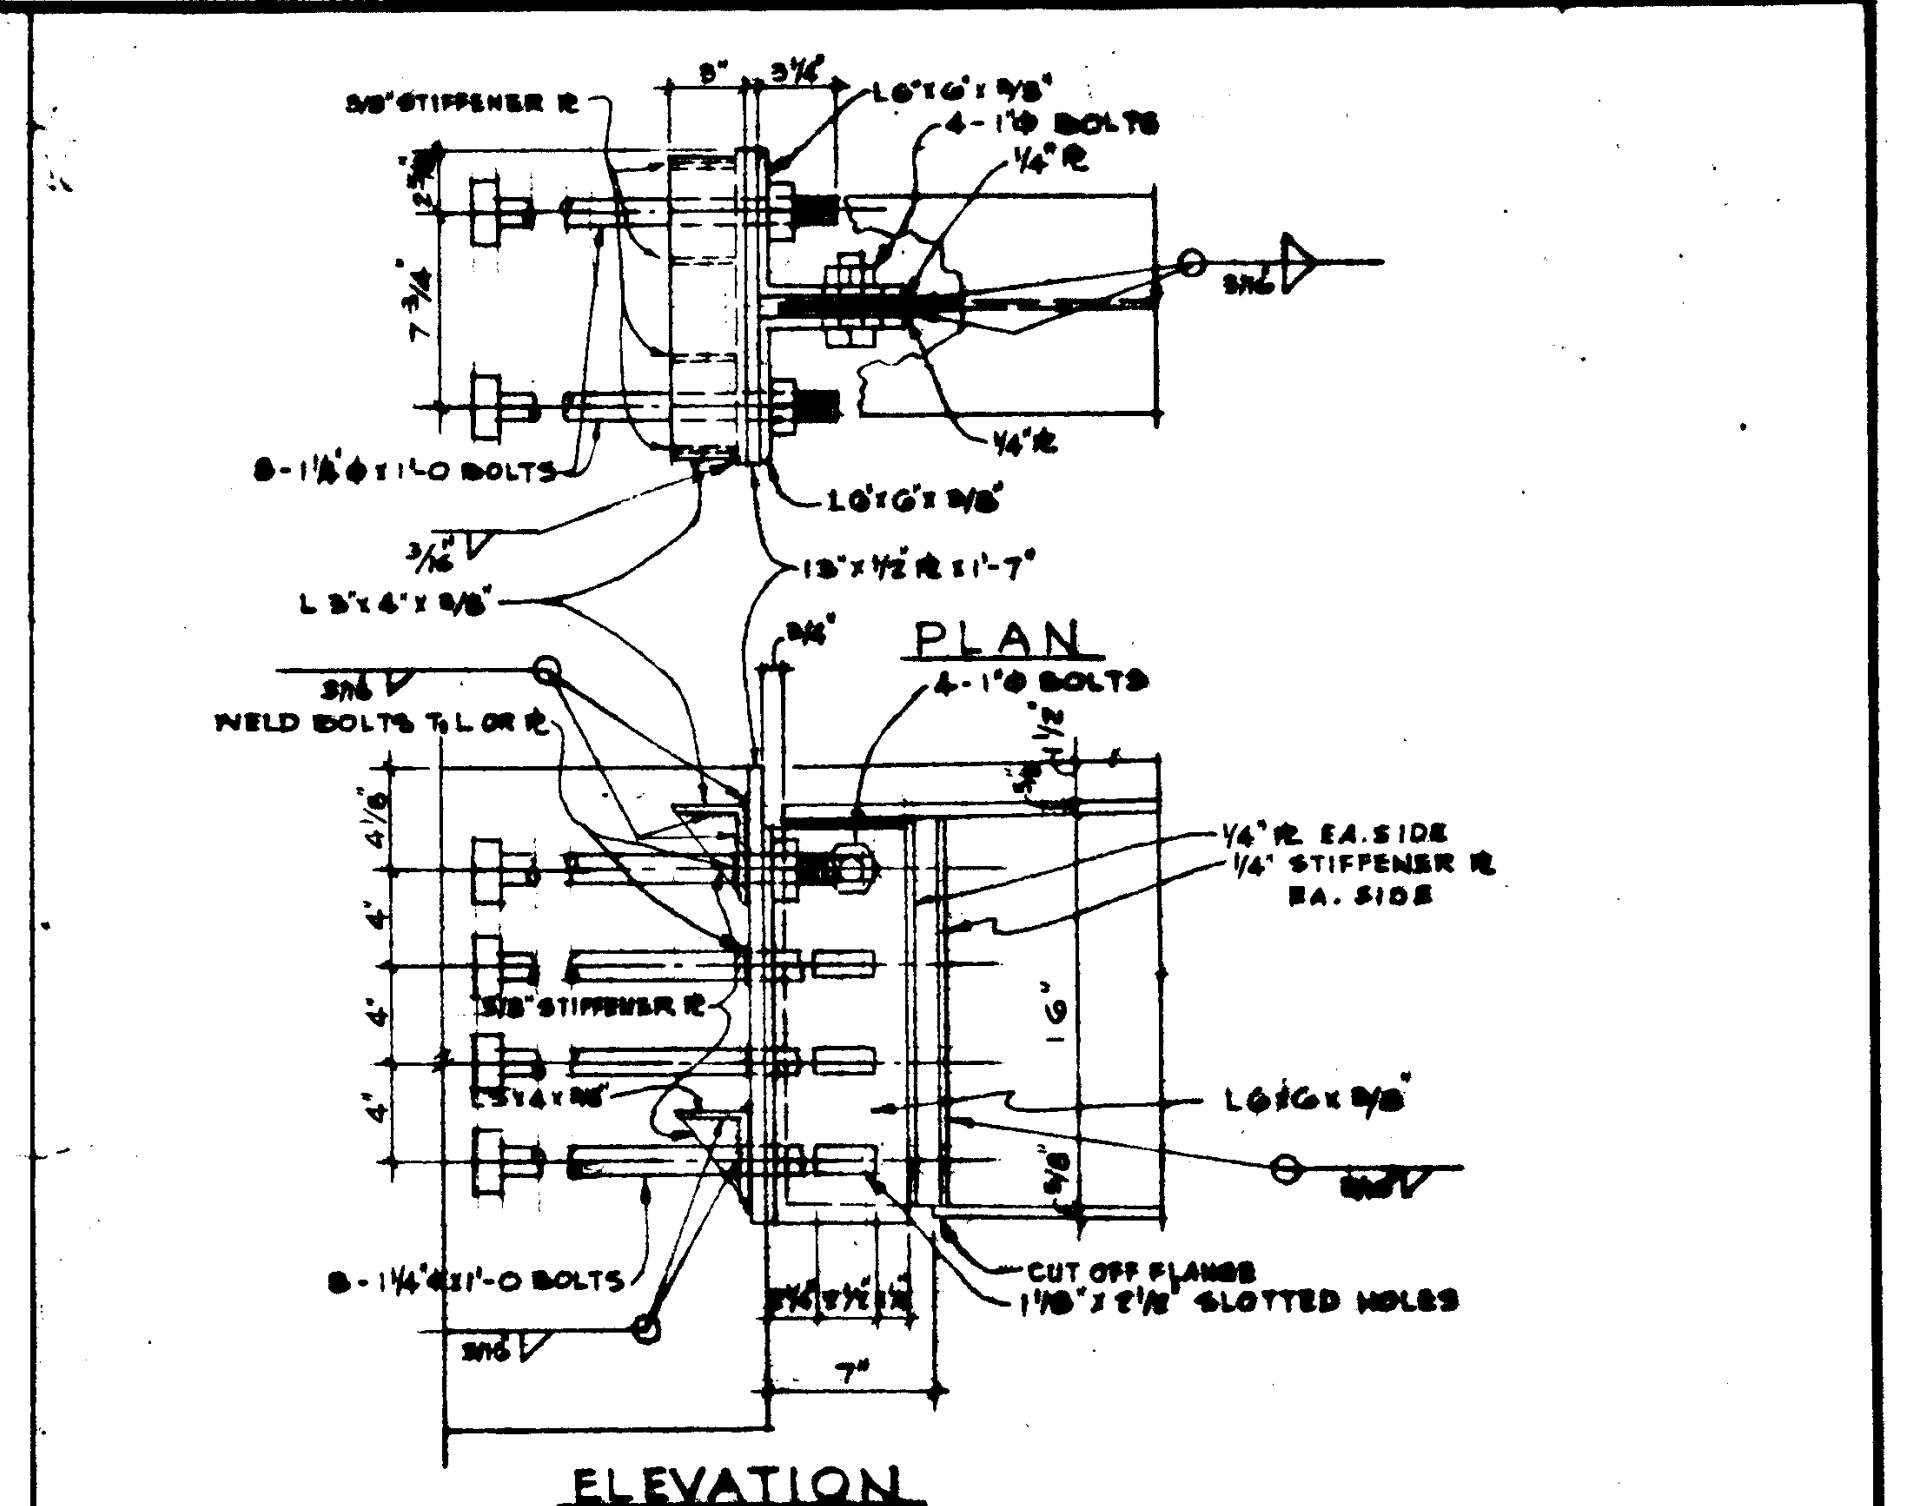

ELEVATION SCALE 1/4" = 1'-0"

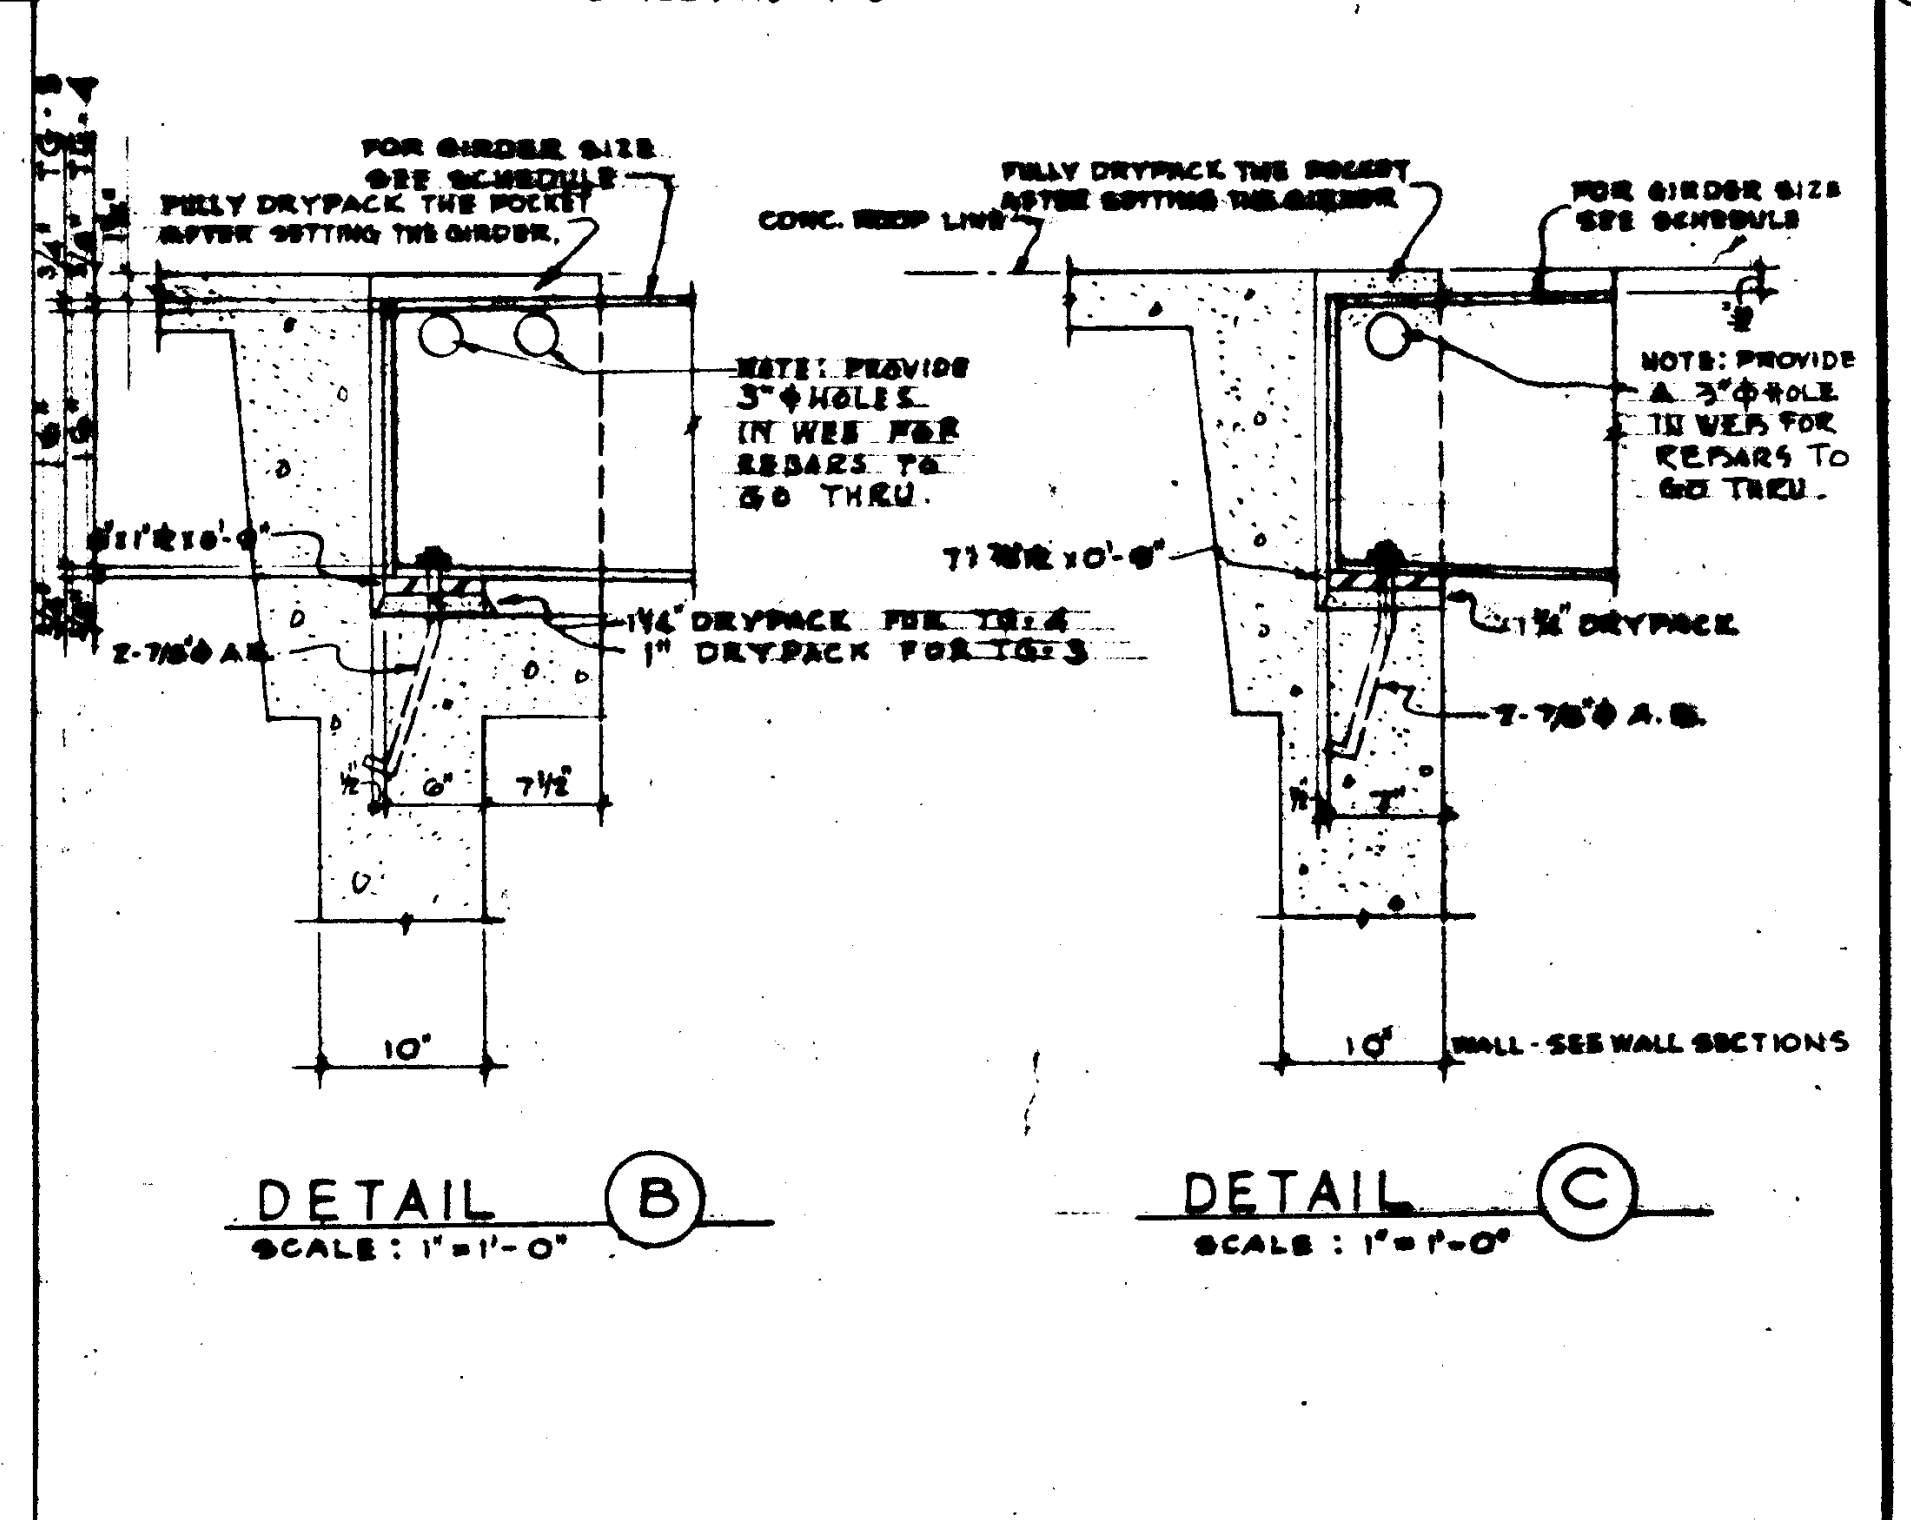

DETAIL (B) and DETAIL (C) SCALE 1/4" = 1'-0"

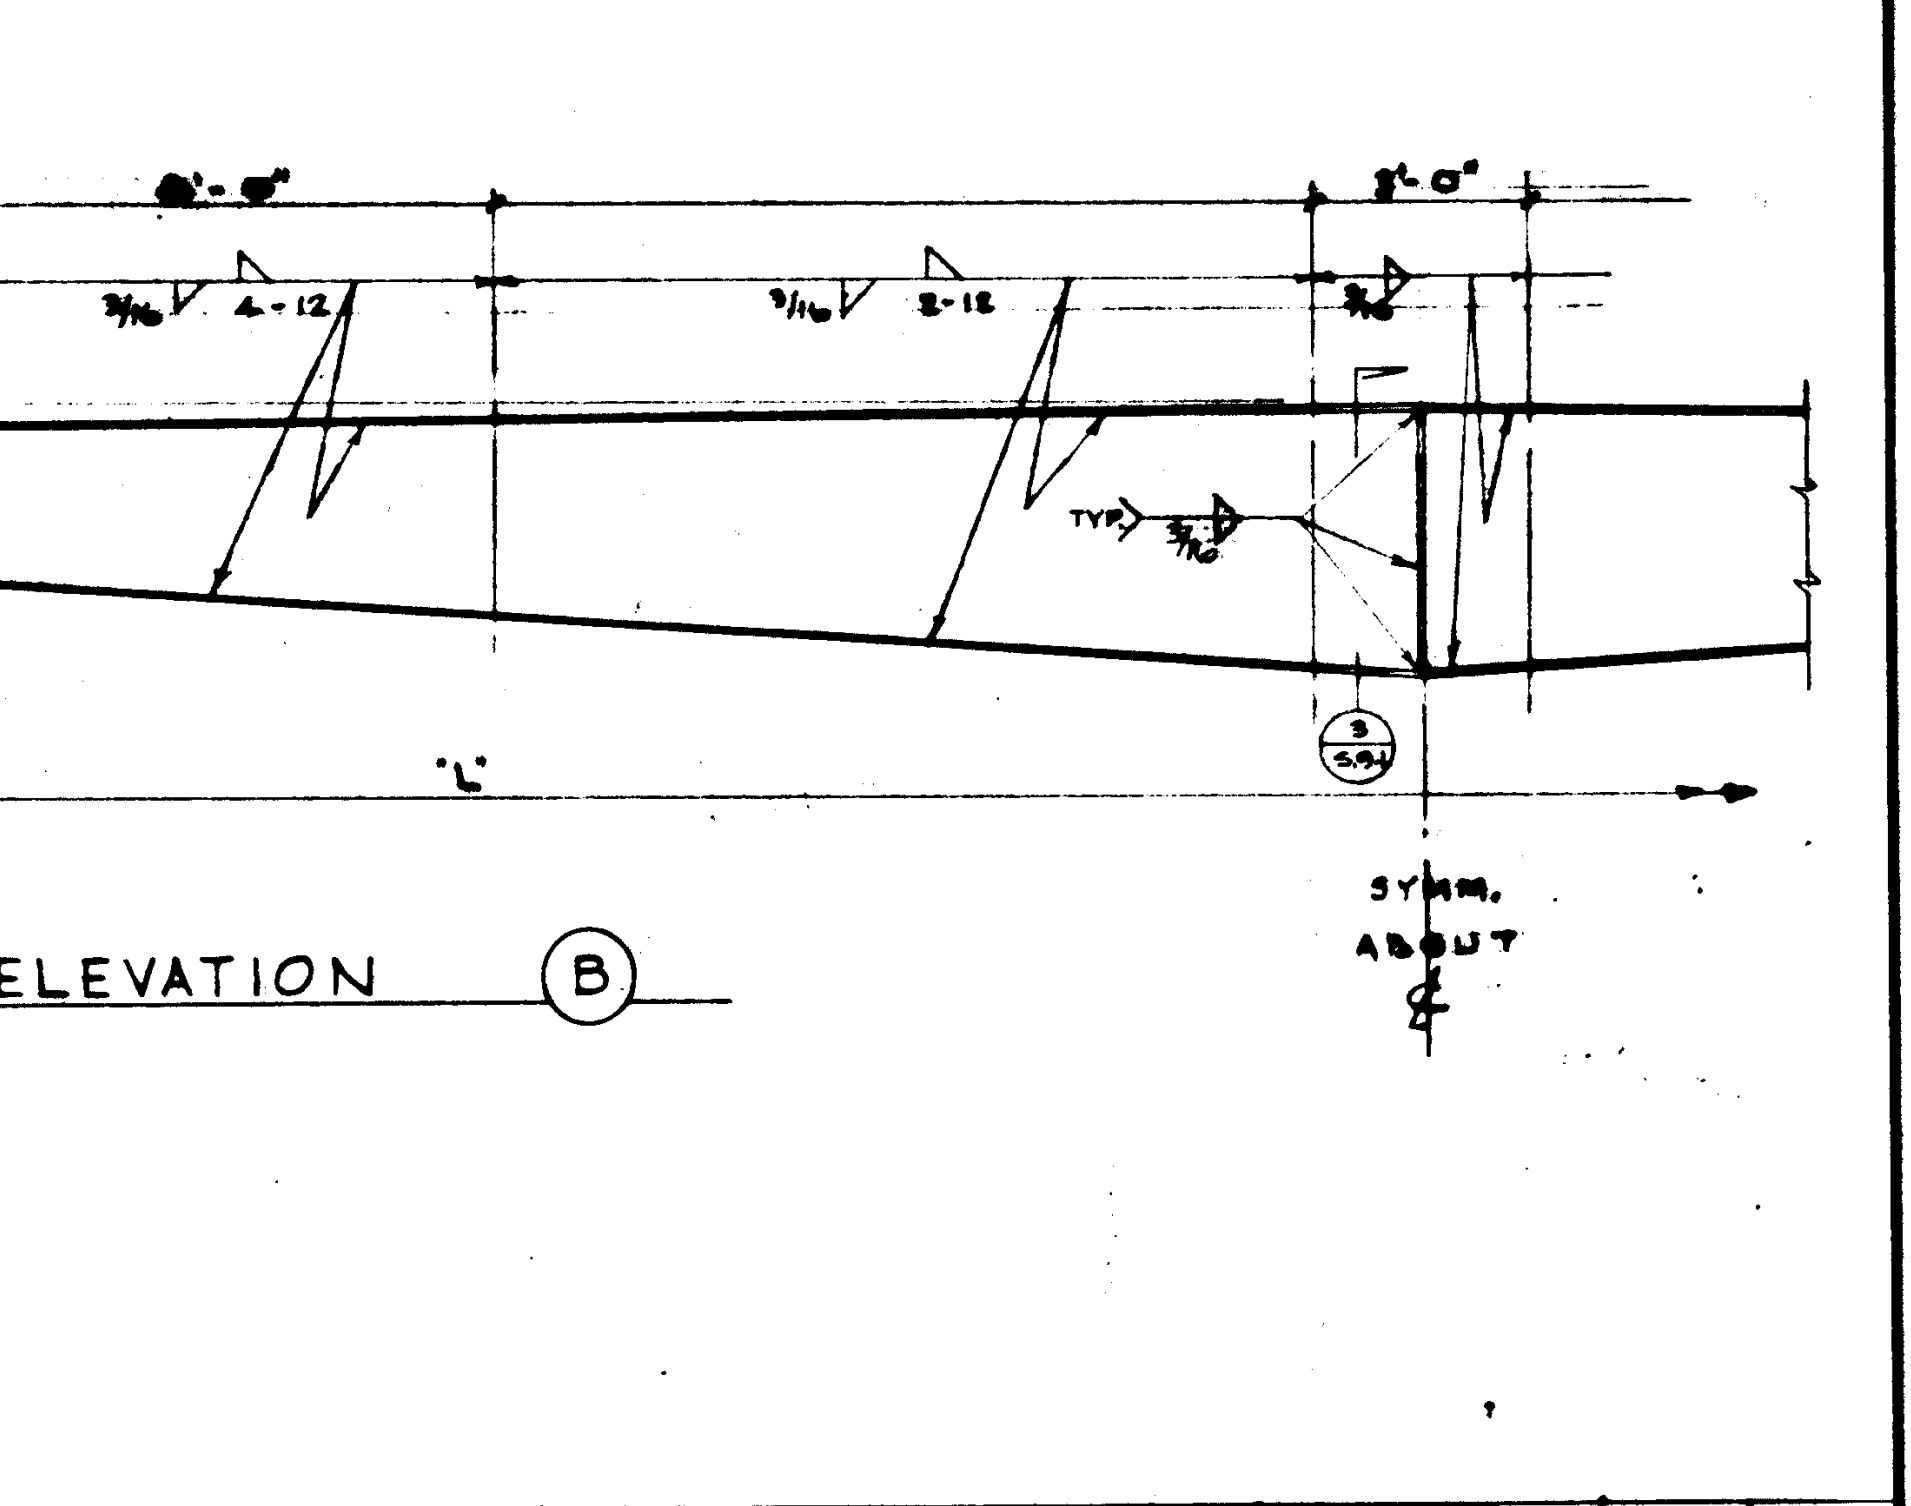

GIRDER END DETAILS SCALE 1/4" = 1'-0"

NO.	TOP & BOTTOM FLANGE	WEB	LENGTH 'L'
TG-1	9 x 3/8" F	1/2" F	64'-9"
TG-2	9 x 3/8" F	1/2" F	62'-4 1/2"
TG-3	9 x 3/8" F	1/2" F	63'-6"
TG-4	9 x 3/8" F	1/2" F	63'-6"


DATE	REVISIONS


STRUCTURAL ENGINEERS	DESIGNED	ARCHITECT	APPROVED
BRANDON & JOHNSON	A.L. & A.C.	W.L. & A.C.	APPROVED JUN 21 1965
J.A. MARTIN & ASSOCIATES			
MECHANICAL ENGINEERS			
RALPH E. PHILLIPS, INC.			
ELECTRICAL ENGINEERS			
RALPH E. PHILLIPS, INC.			
CIVIL ENGINEERS			
G. SHURMAN & ASSOCIATES			
MOFFATT & NICOL			

ASSOCIATED ARCHITECTS:
 WILLIAM L. PEREIRA & ASSOCIATES
 A. QUINCY JONES, FREDERICK E. HEMMONS & ASSOCIATES
 BLUROCK ELLERBROOK & ASSOCIATES
 URBANUS SQUARE MACARTHUR BOULEVARD AT FORD ROAD
 TELEPHONE 718/675-2640 CORONA DEL MAR, CALIFORNIA


STEEEL	JOB NO.
	MD-1

GOLDEN WEST COLLEGE
 HUNTINGTON BEACH, CALIFORNIA
 ORANGE COAST JUNIOR COLLEGE DISTRICT

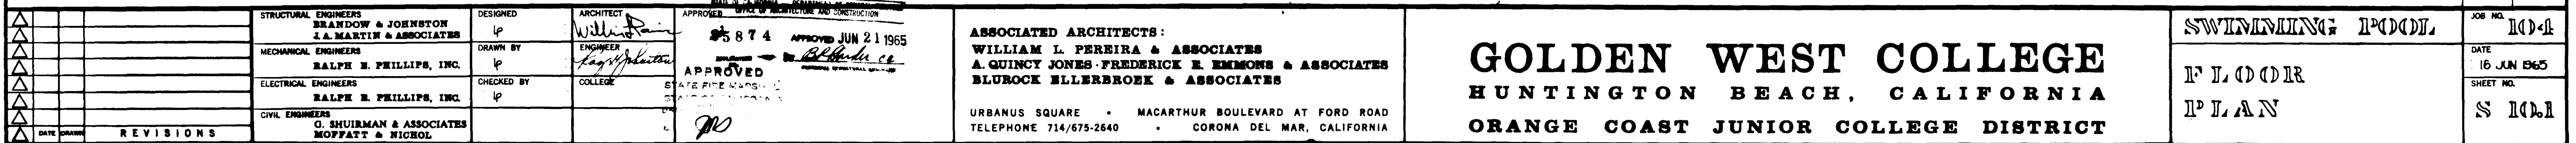


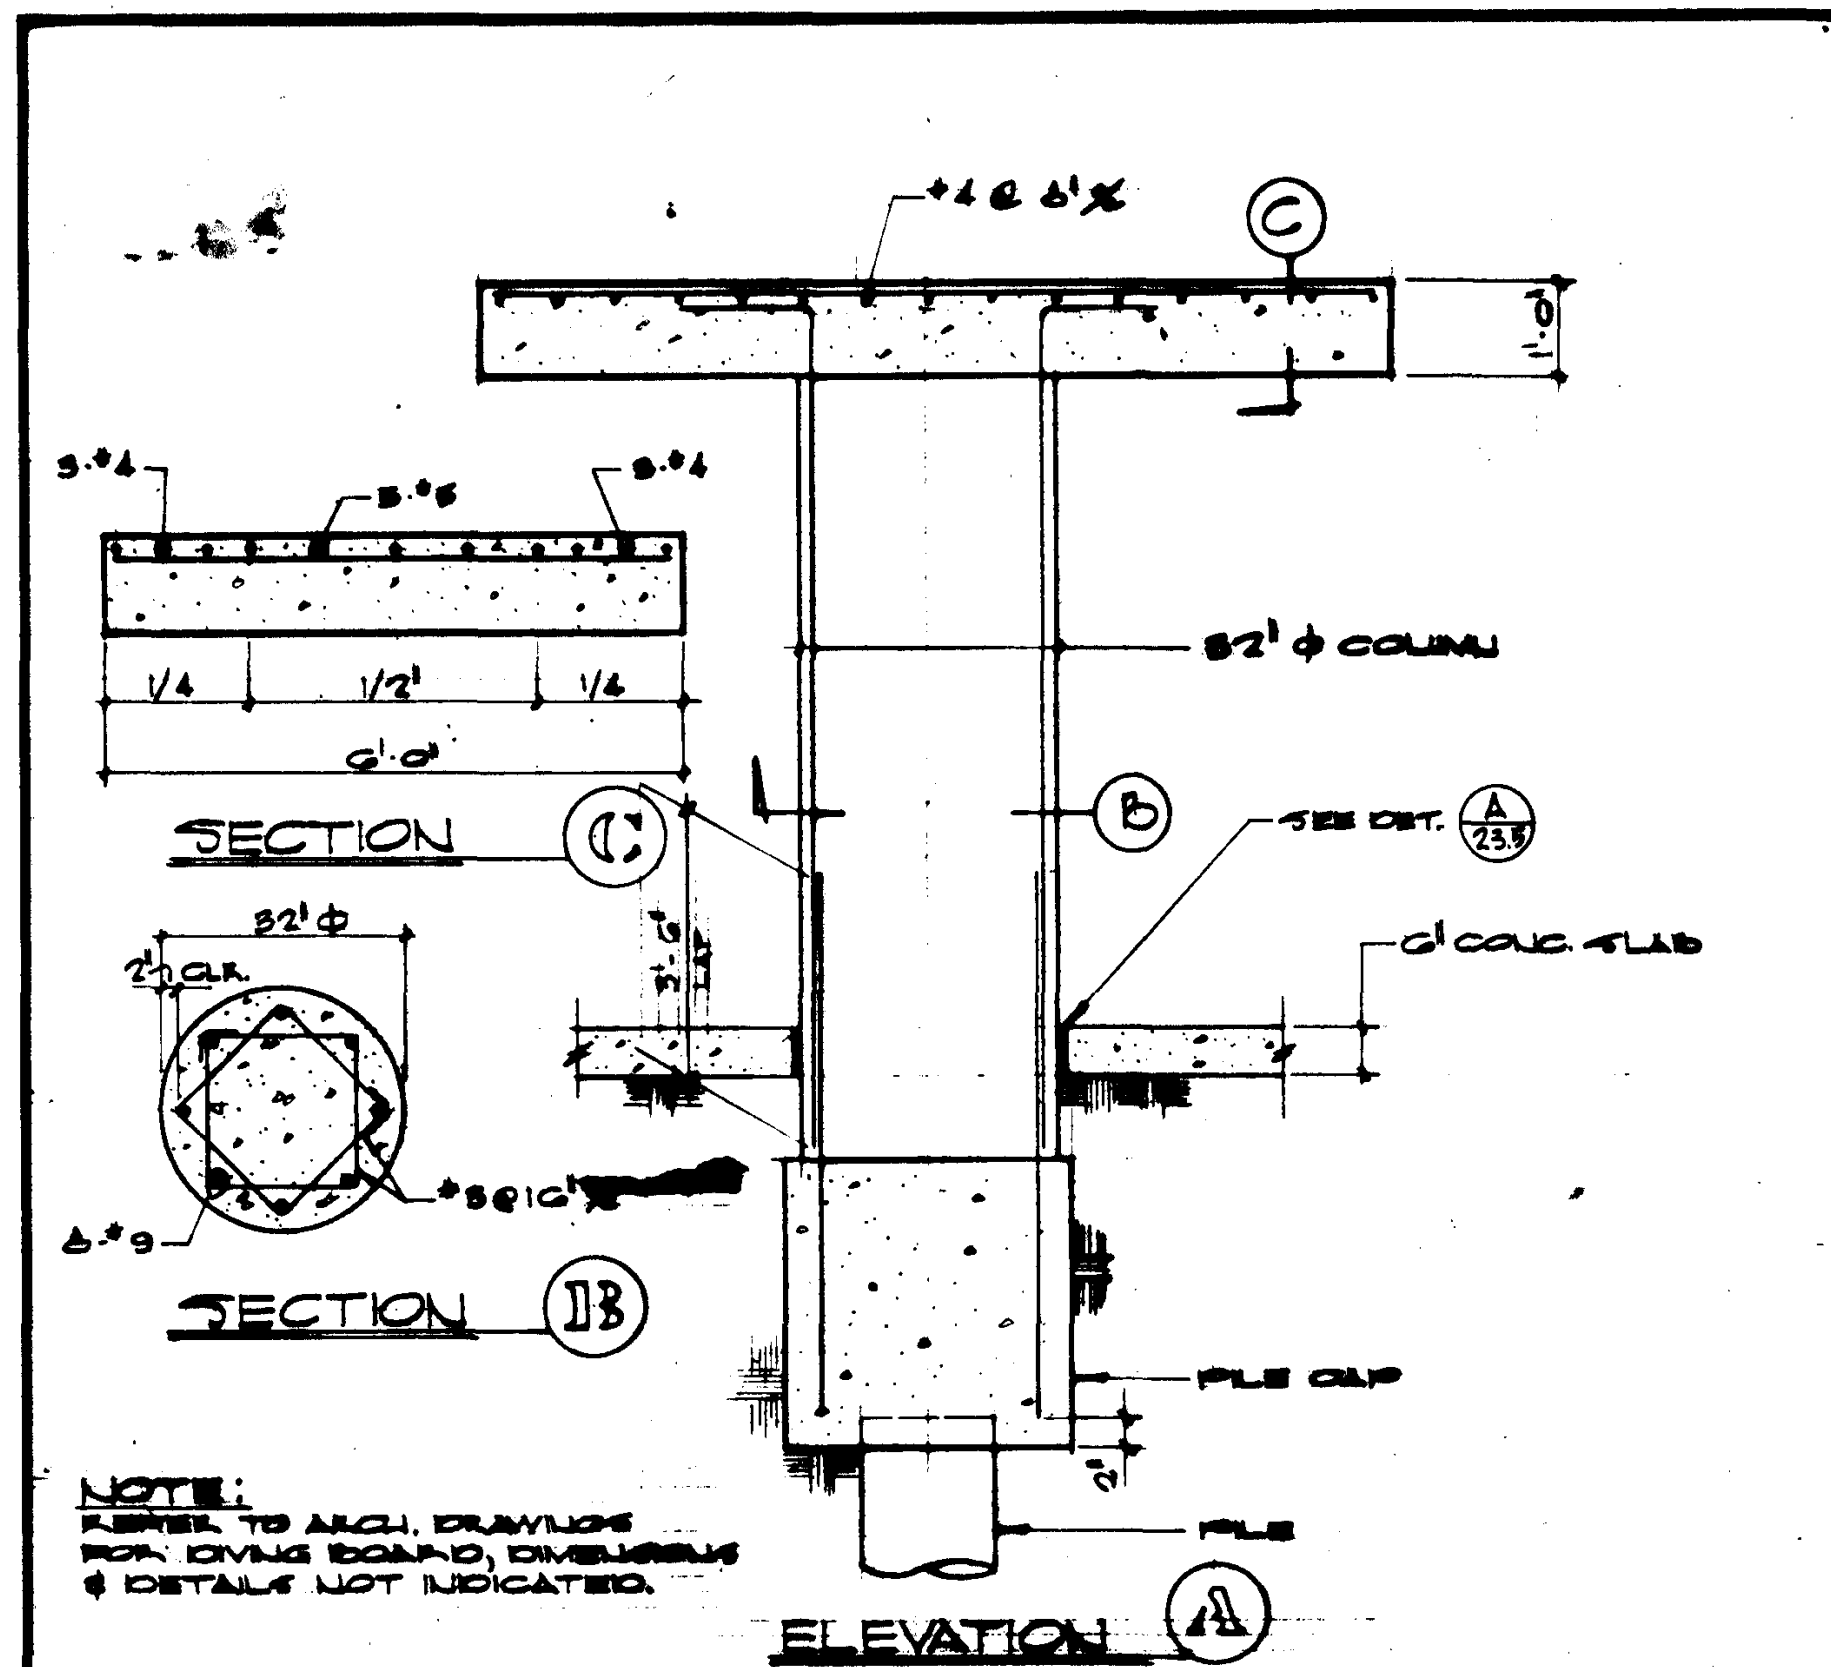


3' NINETEER PLATFORM SCALE 1/4" = 1'-0"

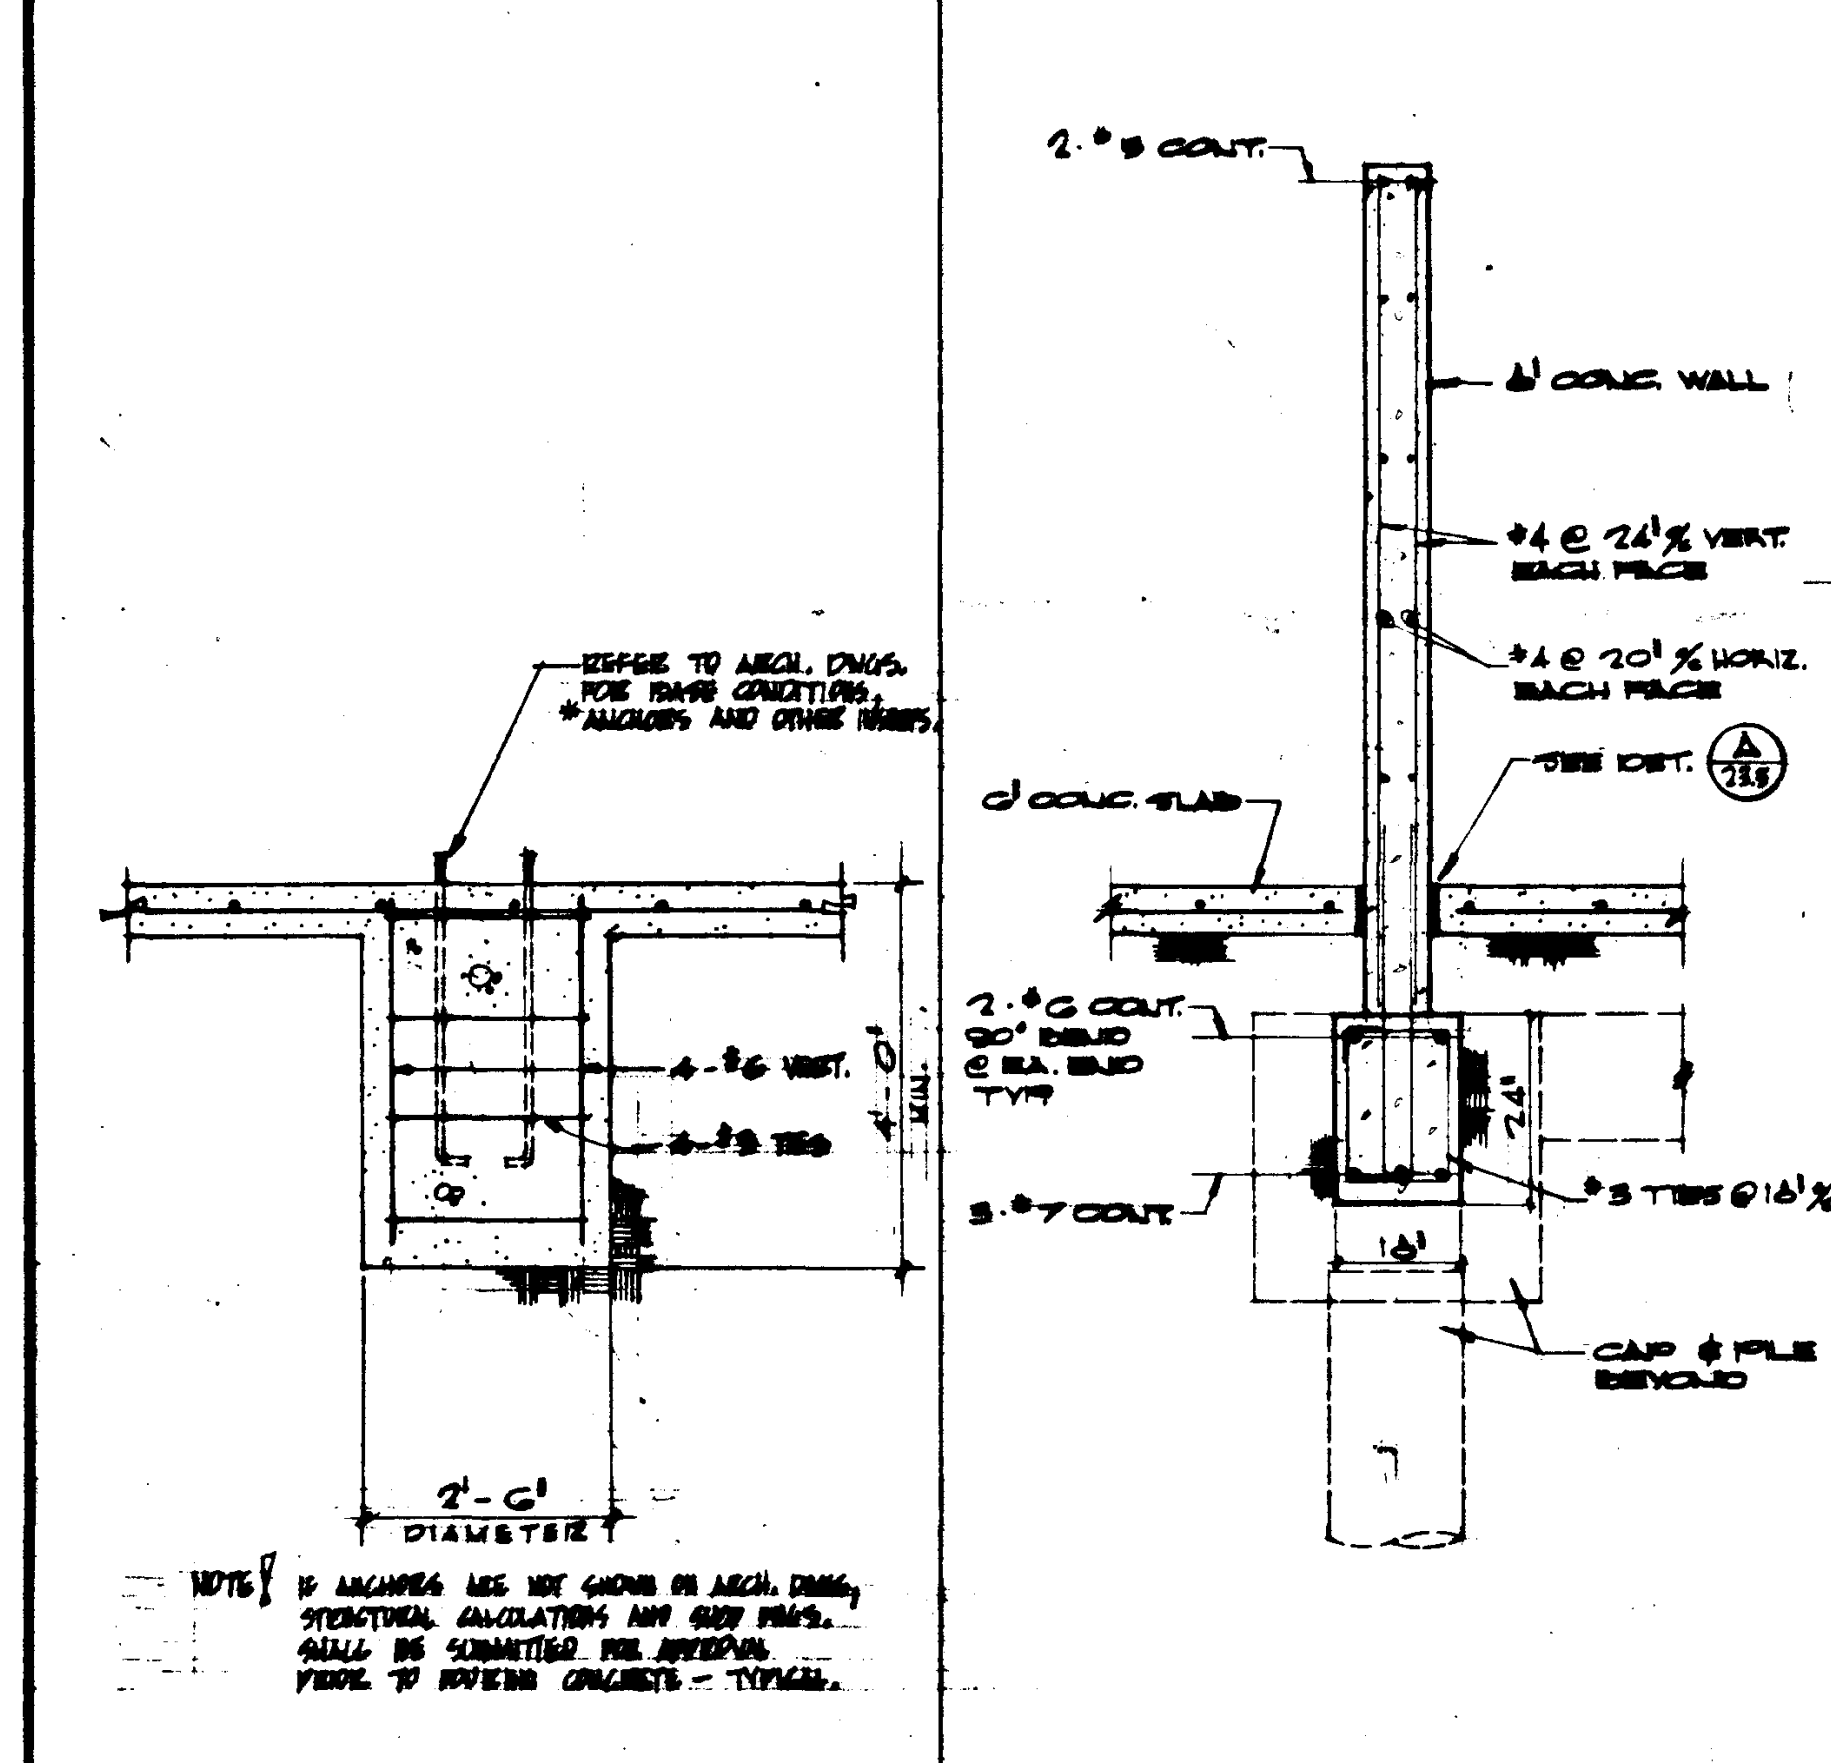


SECTION 12 SCALE 1/4" = 1'-0"

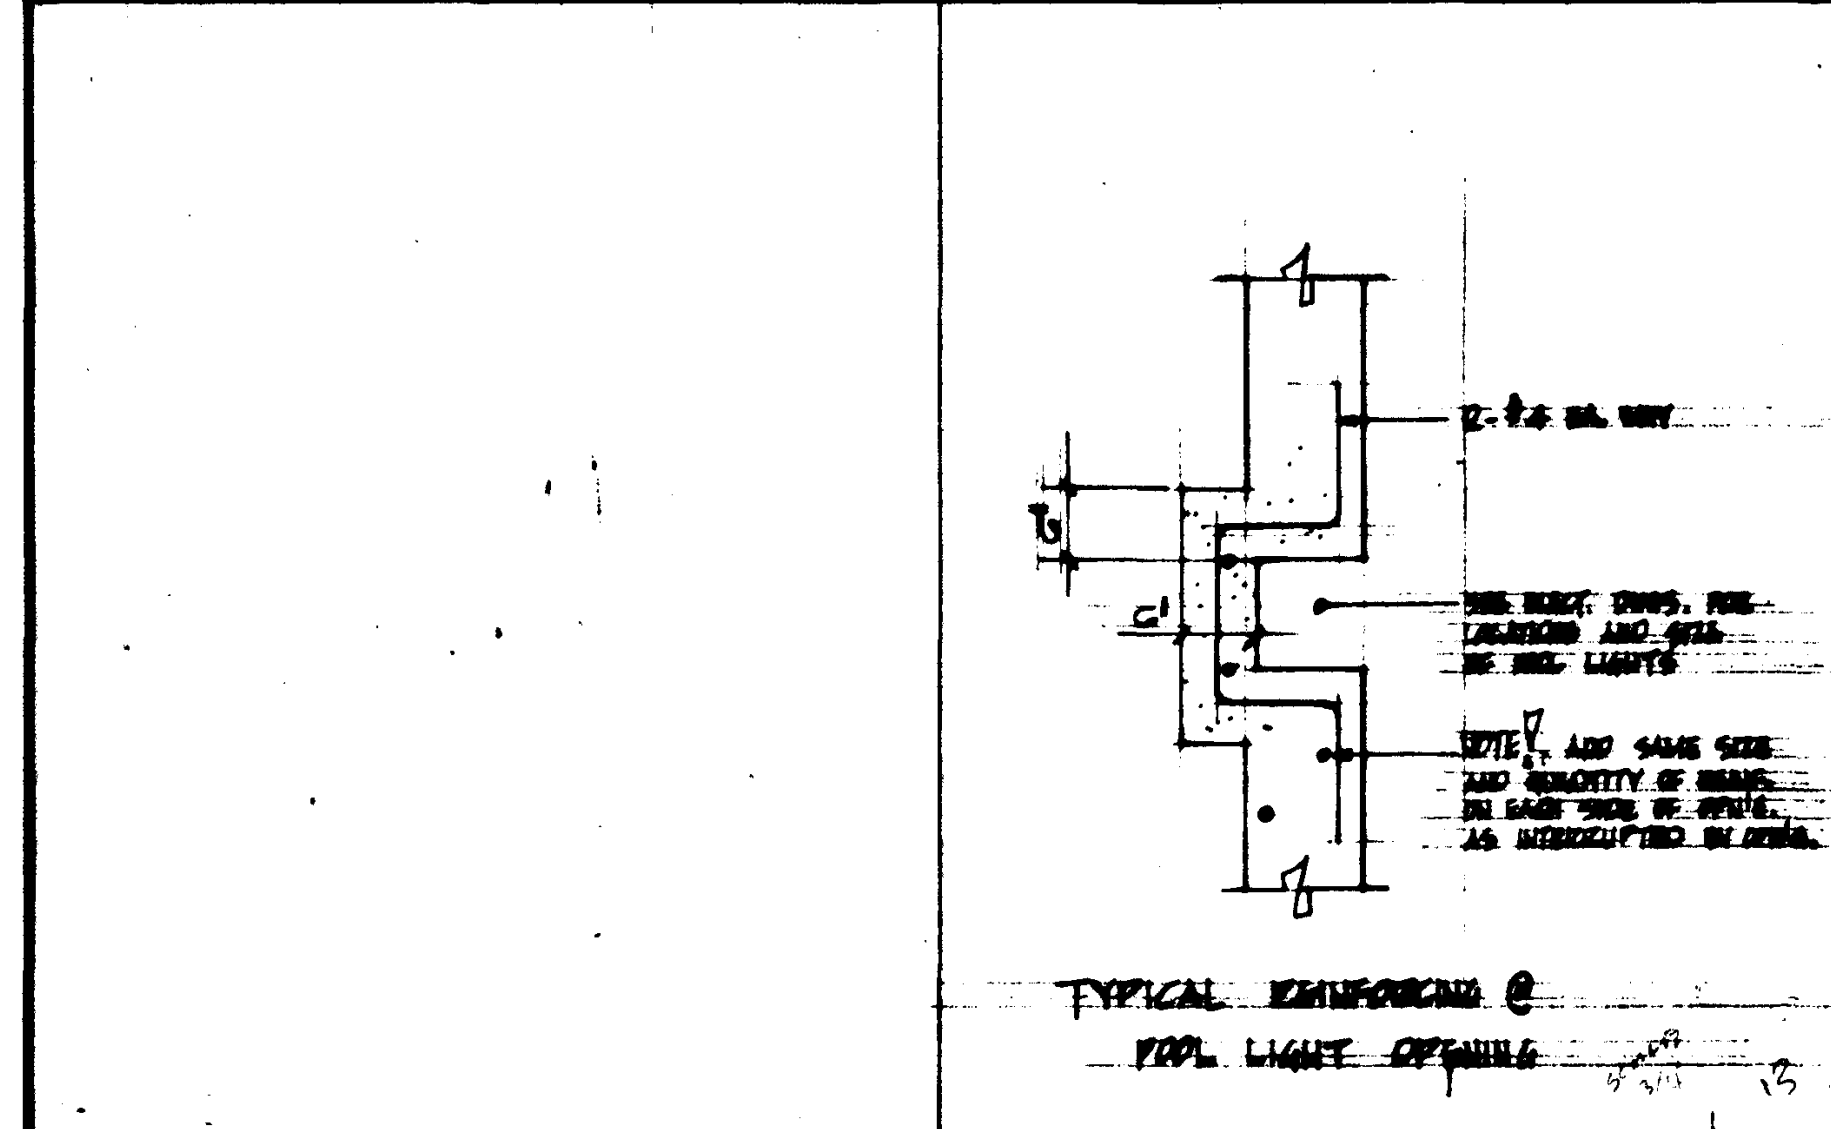


SECTION 13 SCALE 1/4" = 1'-0"

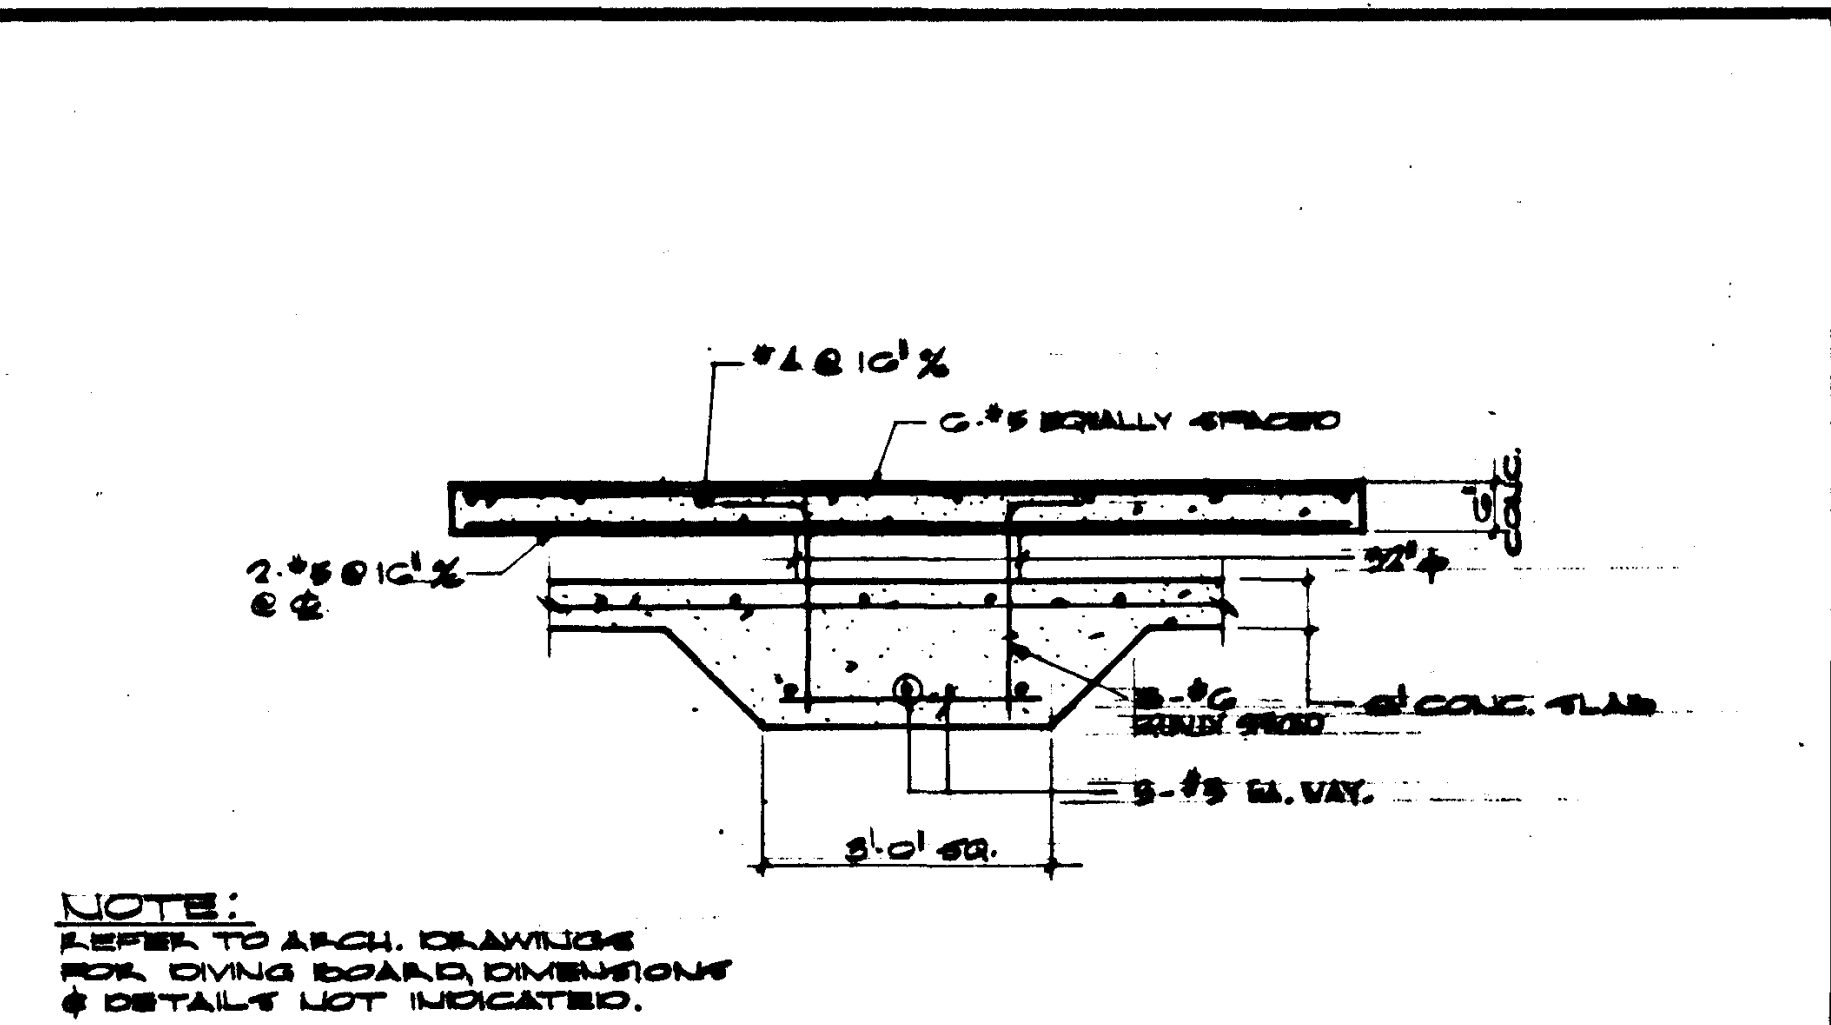


1' NINETEER PLATFORM SCALE 1/4" = 1'-0"

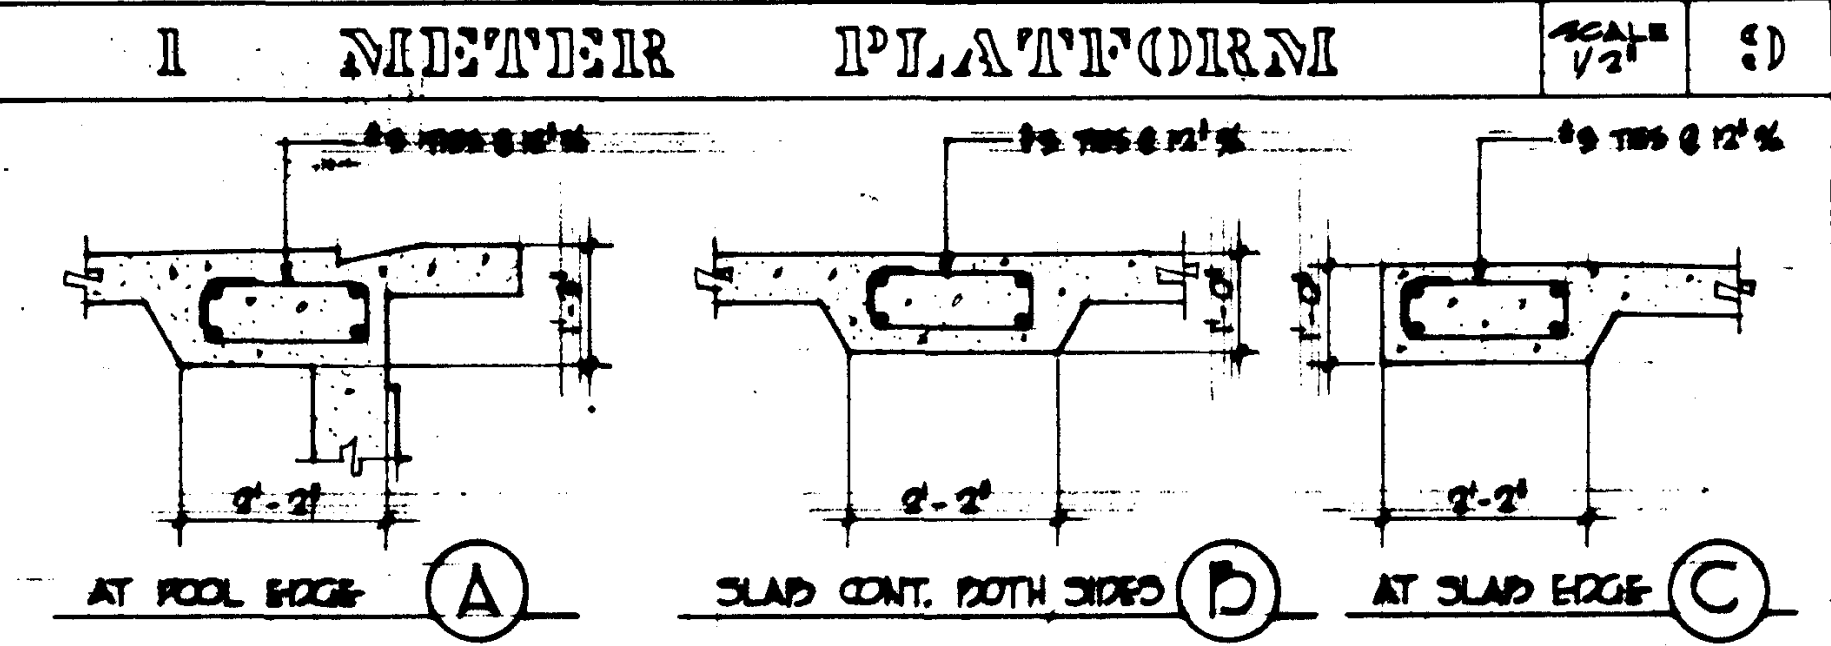


SECTION 14 SCALE 1/4" = 1'-0"

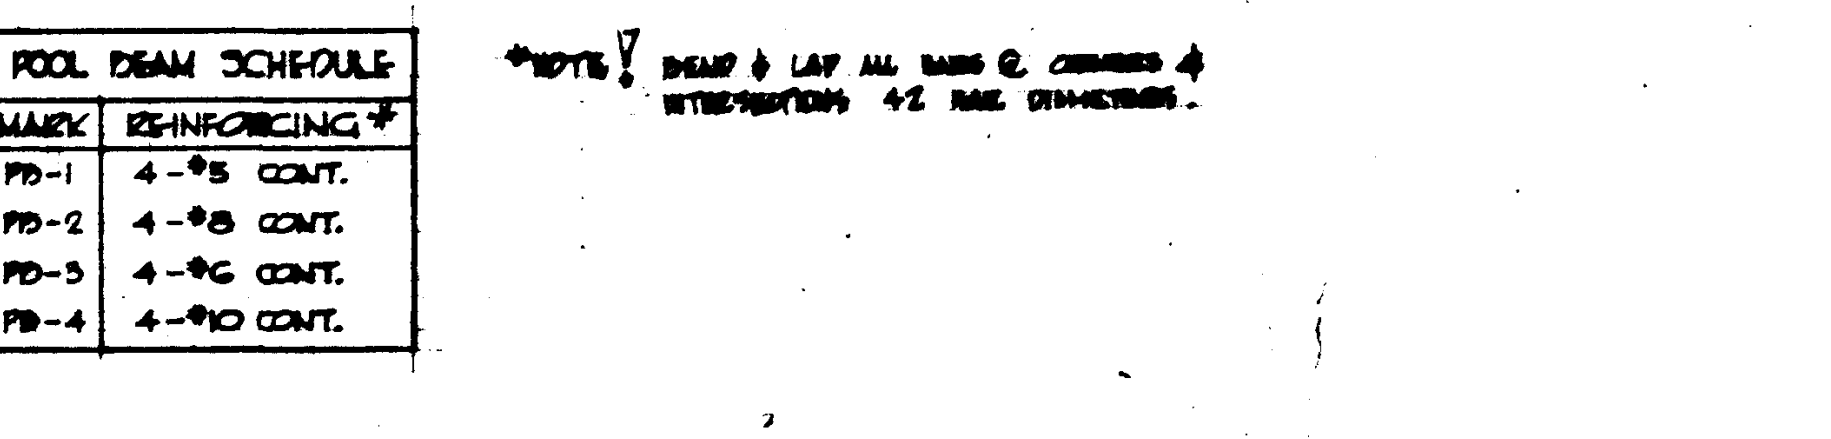


SECTION 15 SCALE 1/4" = 1'-0"

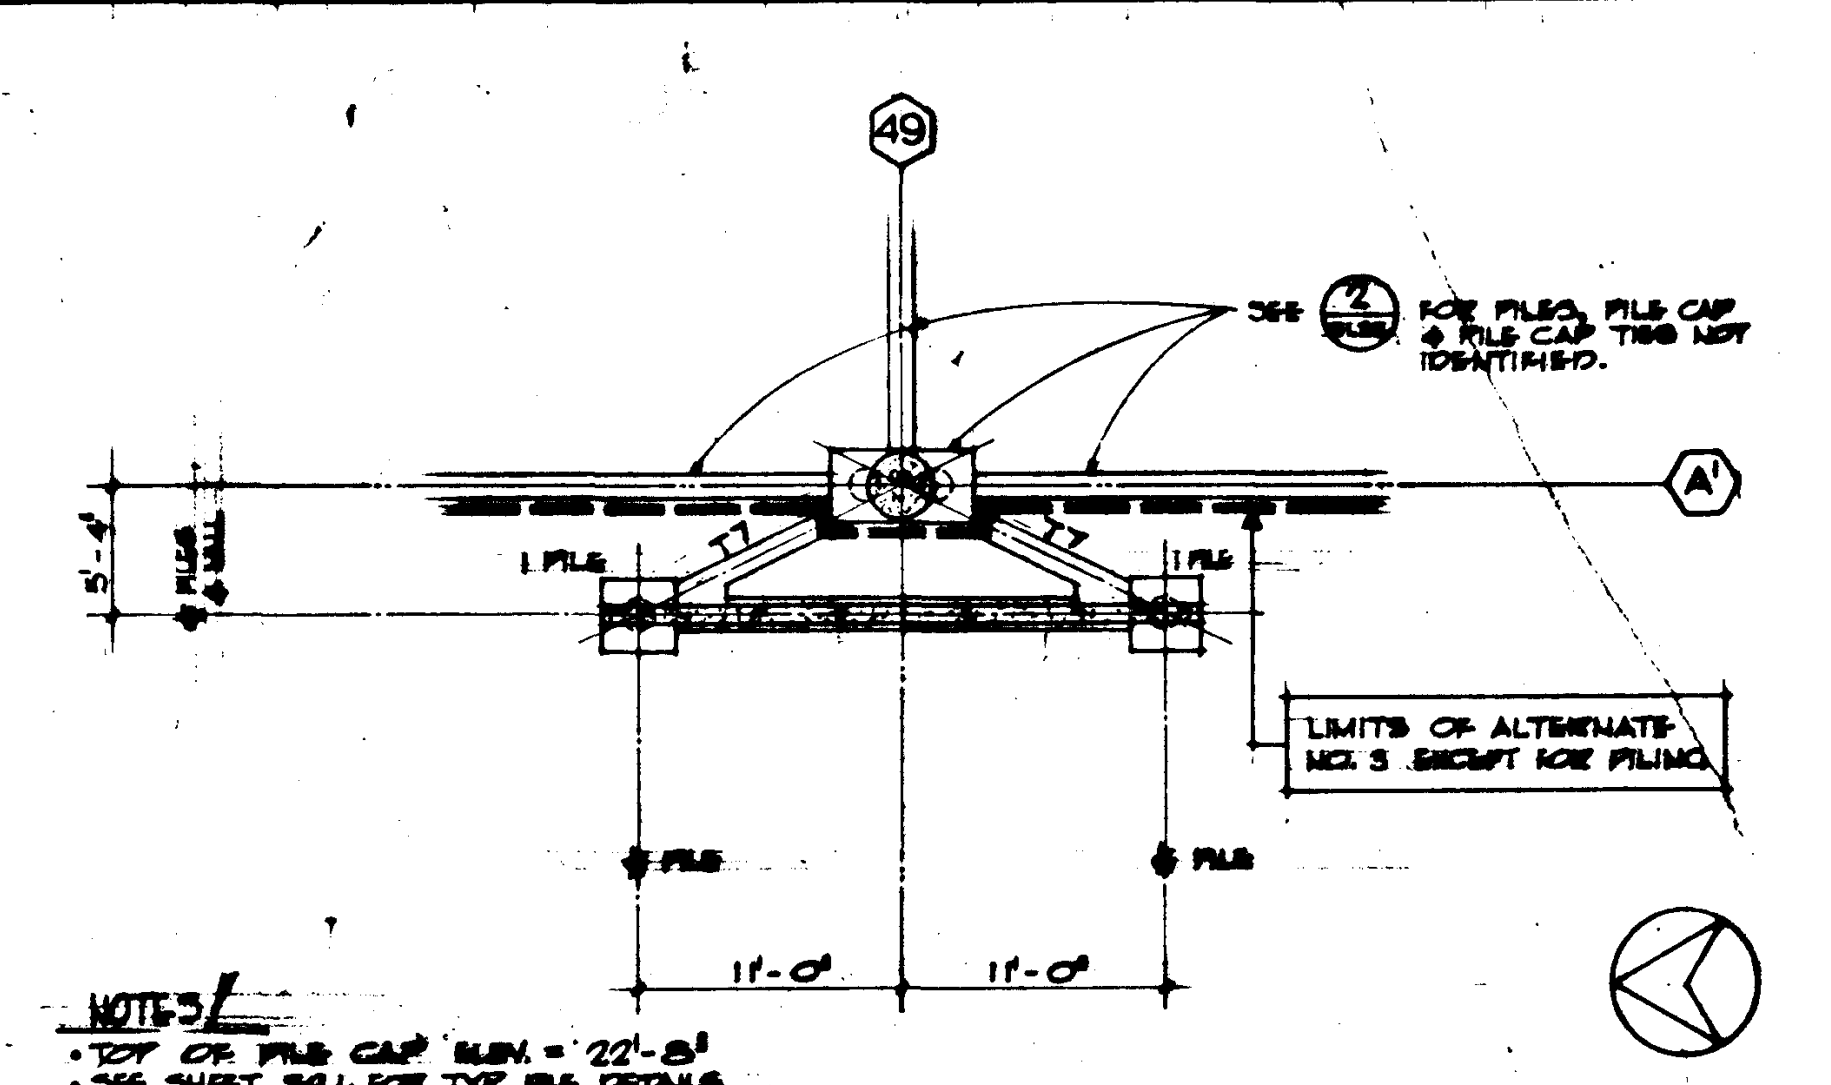


SECTION 16 SCALE 1/4" = 1'-0"

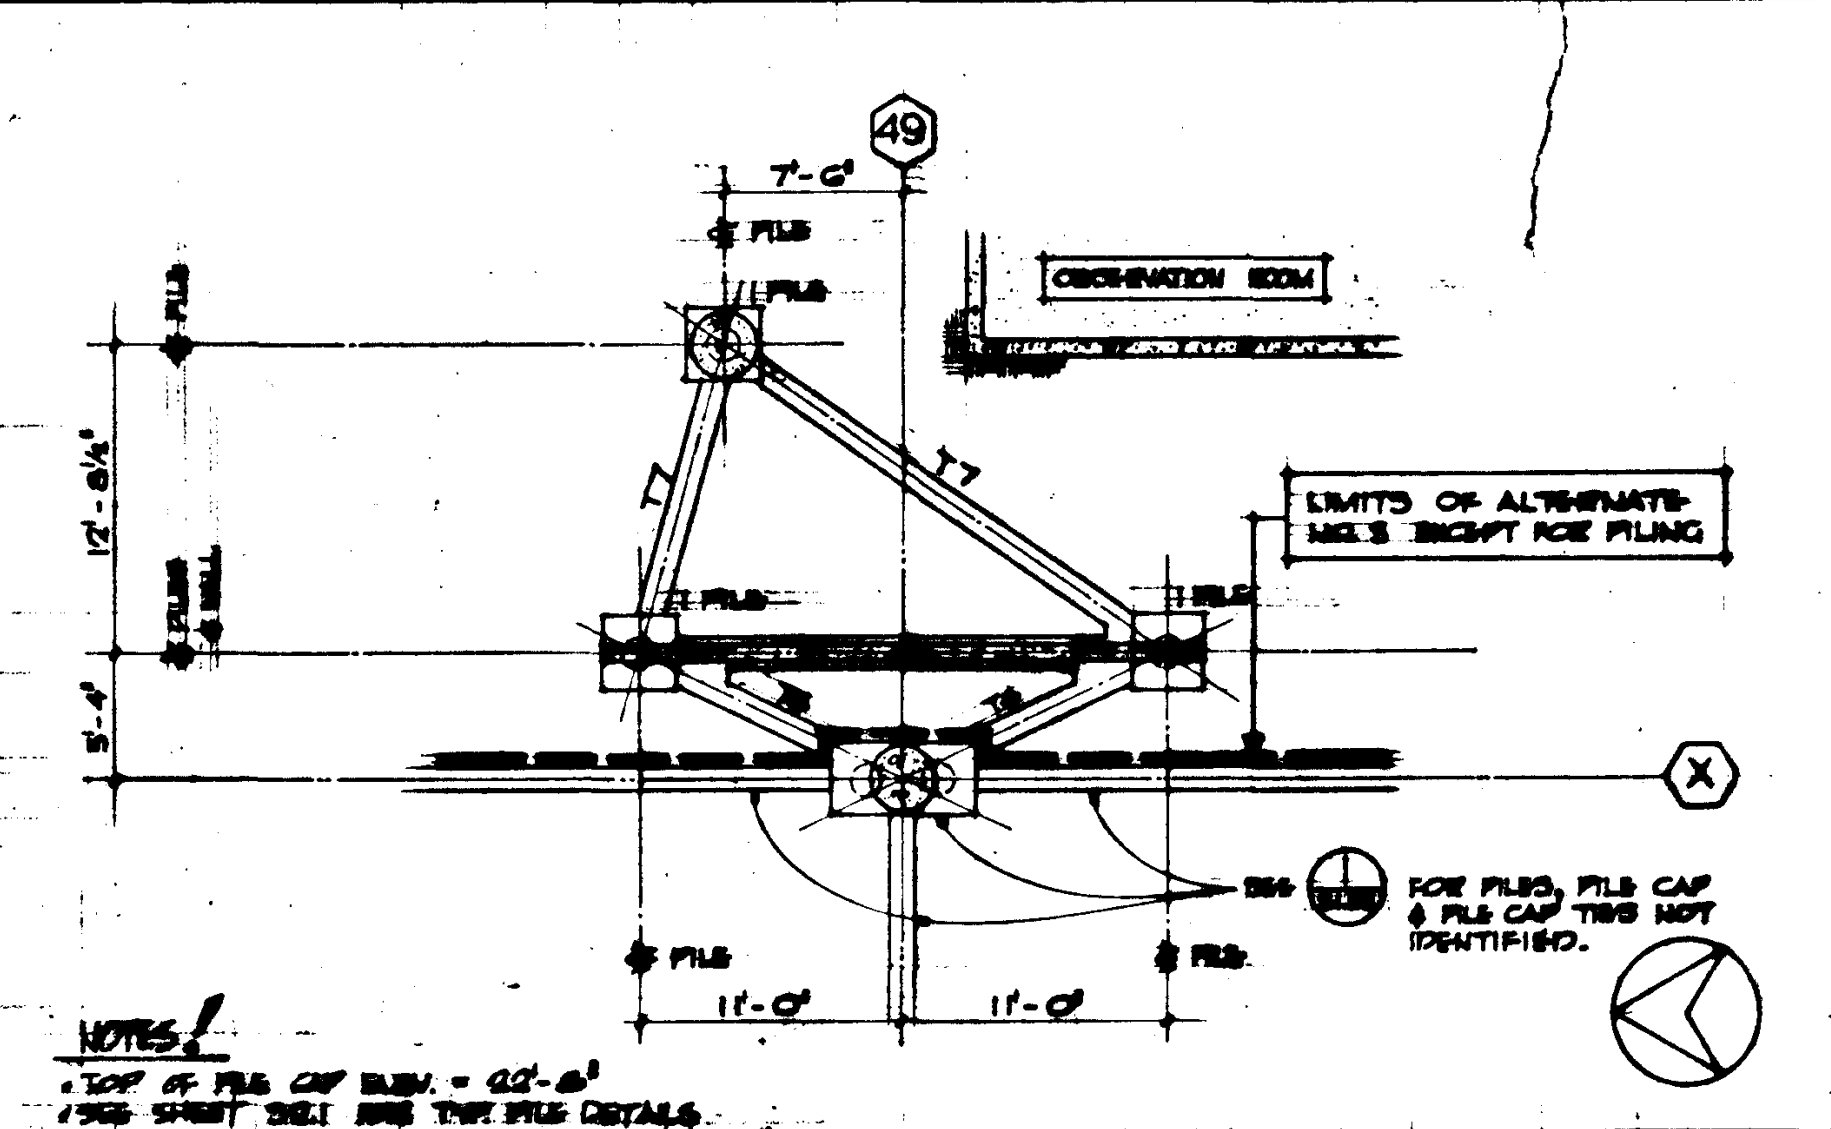


SECTION 17 SCALE 1/4" = 1'-0"

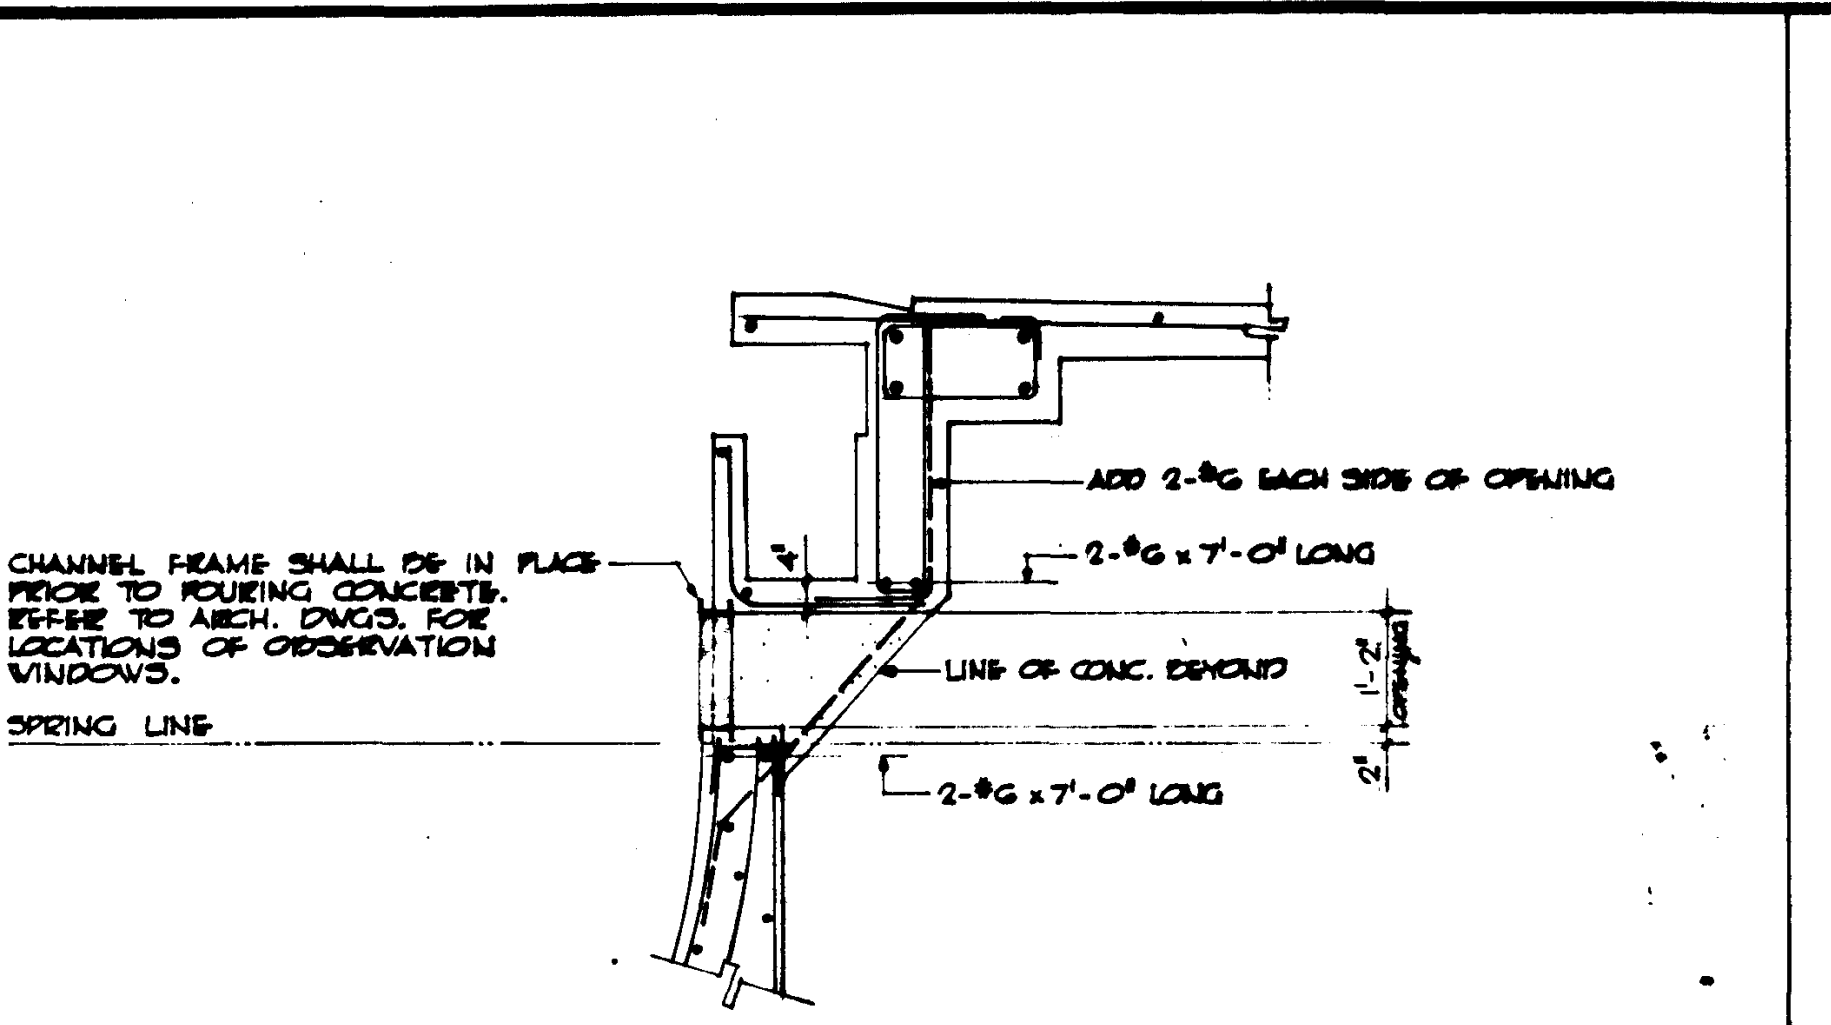


SECTION 18 SCALE 1/4" = 1'-0"

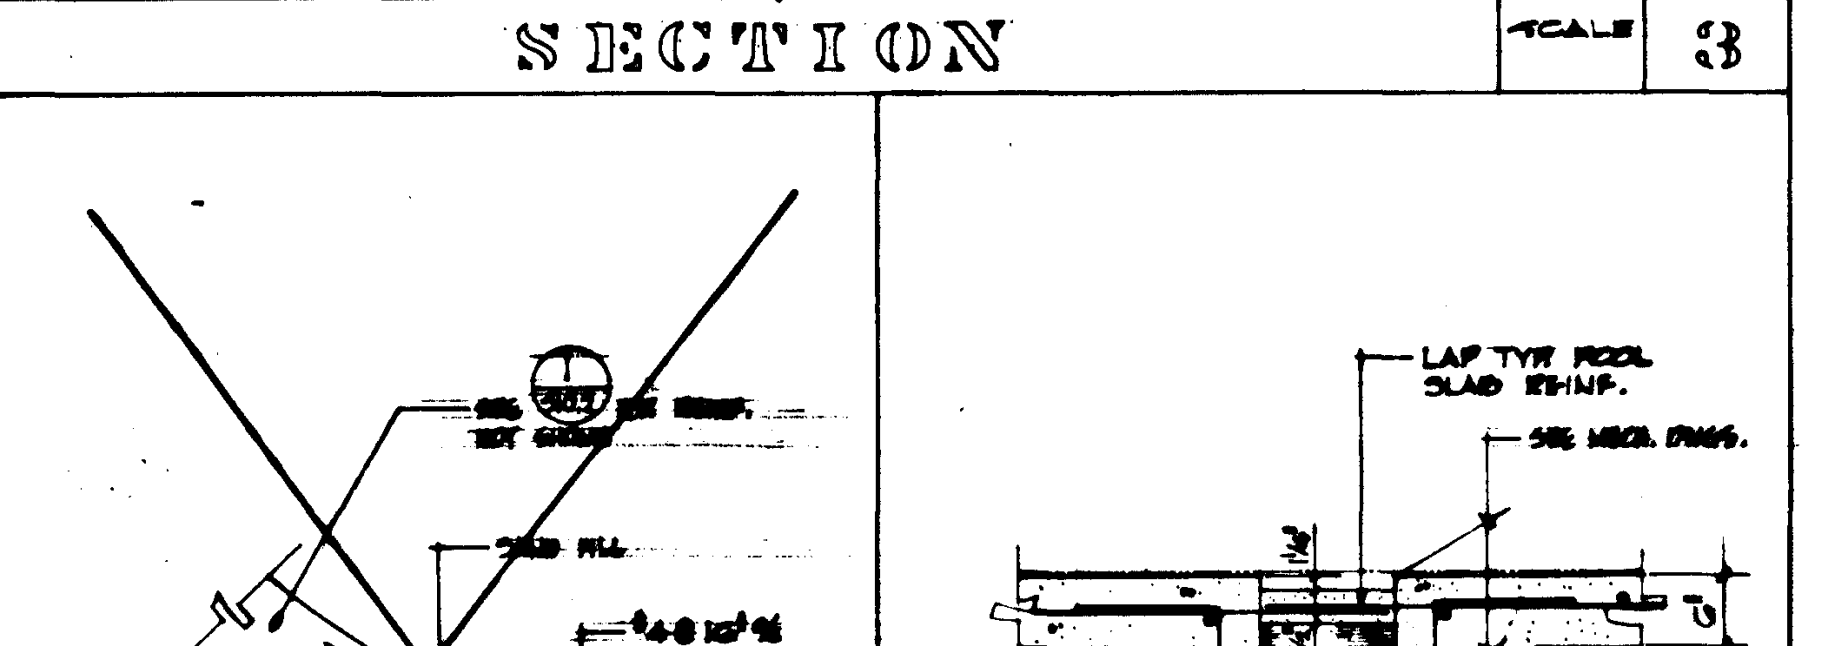


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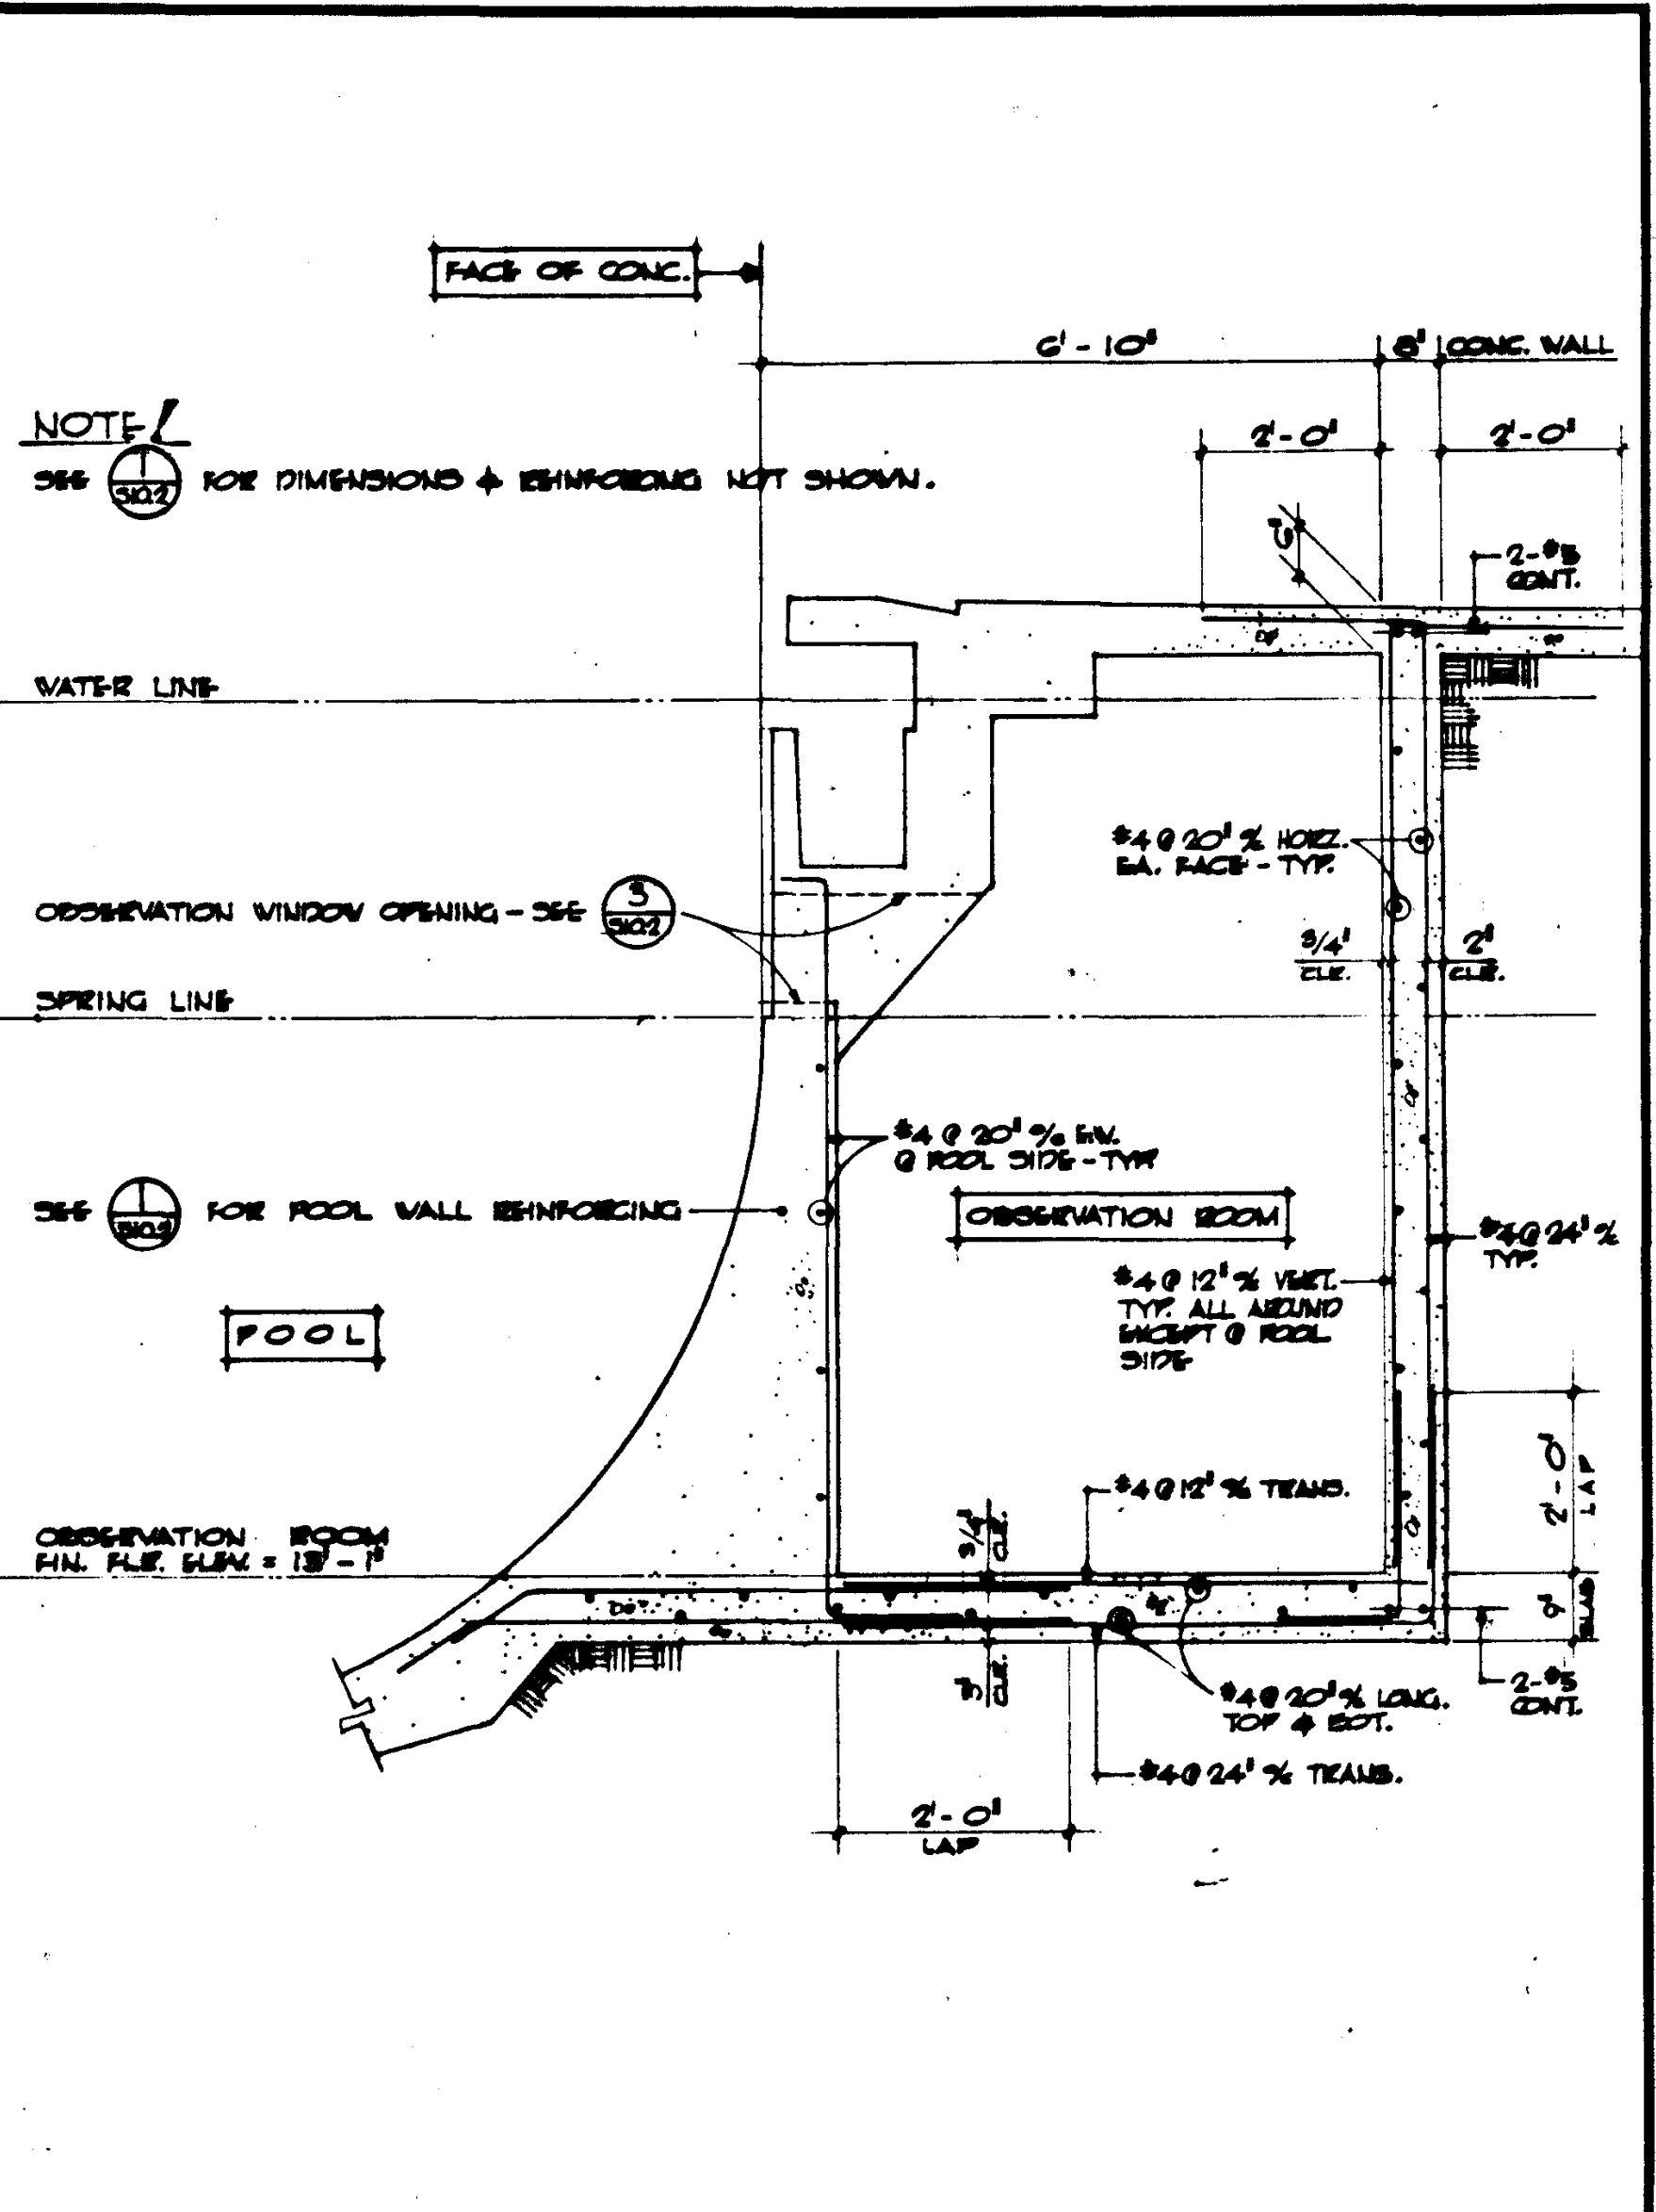
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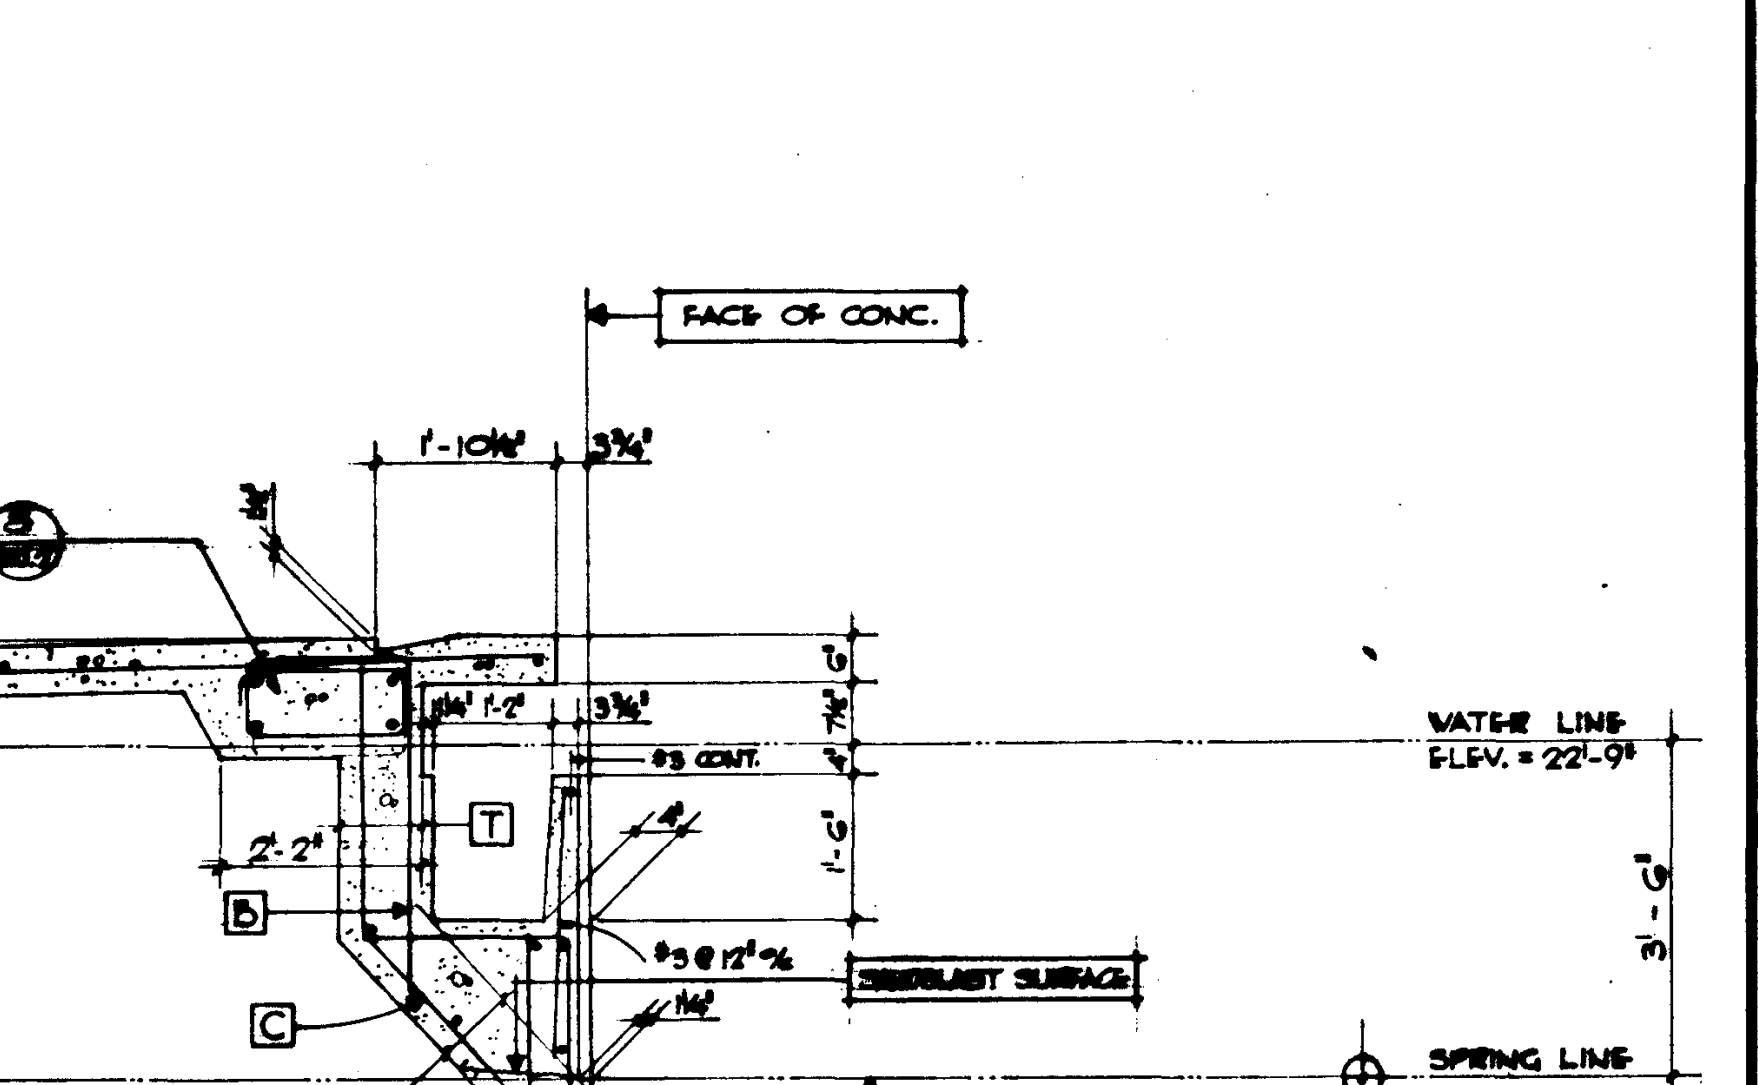
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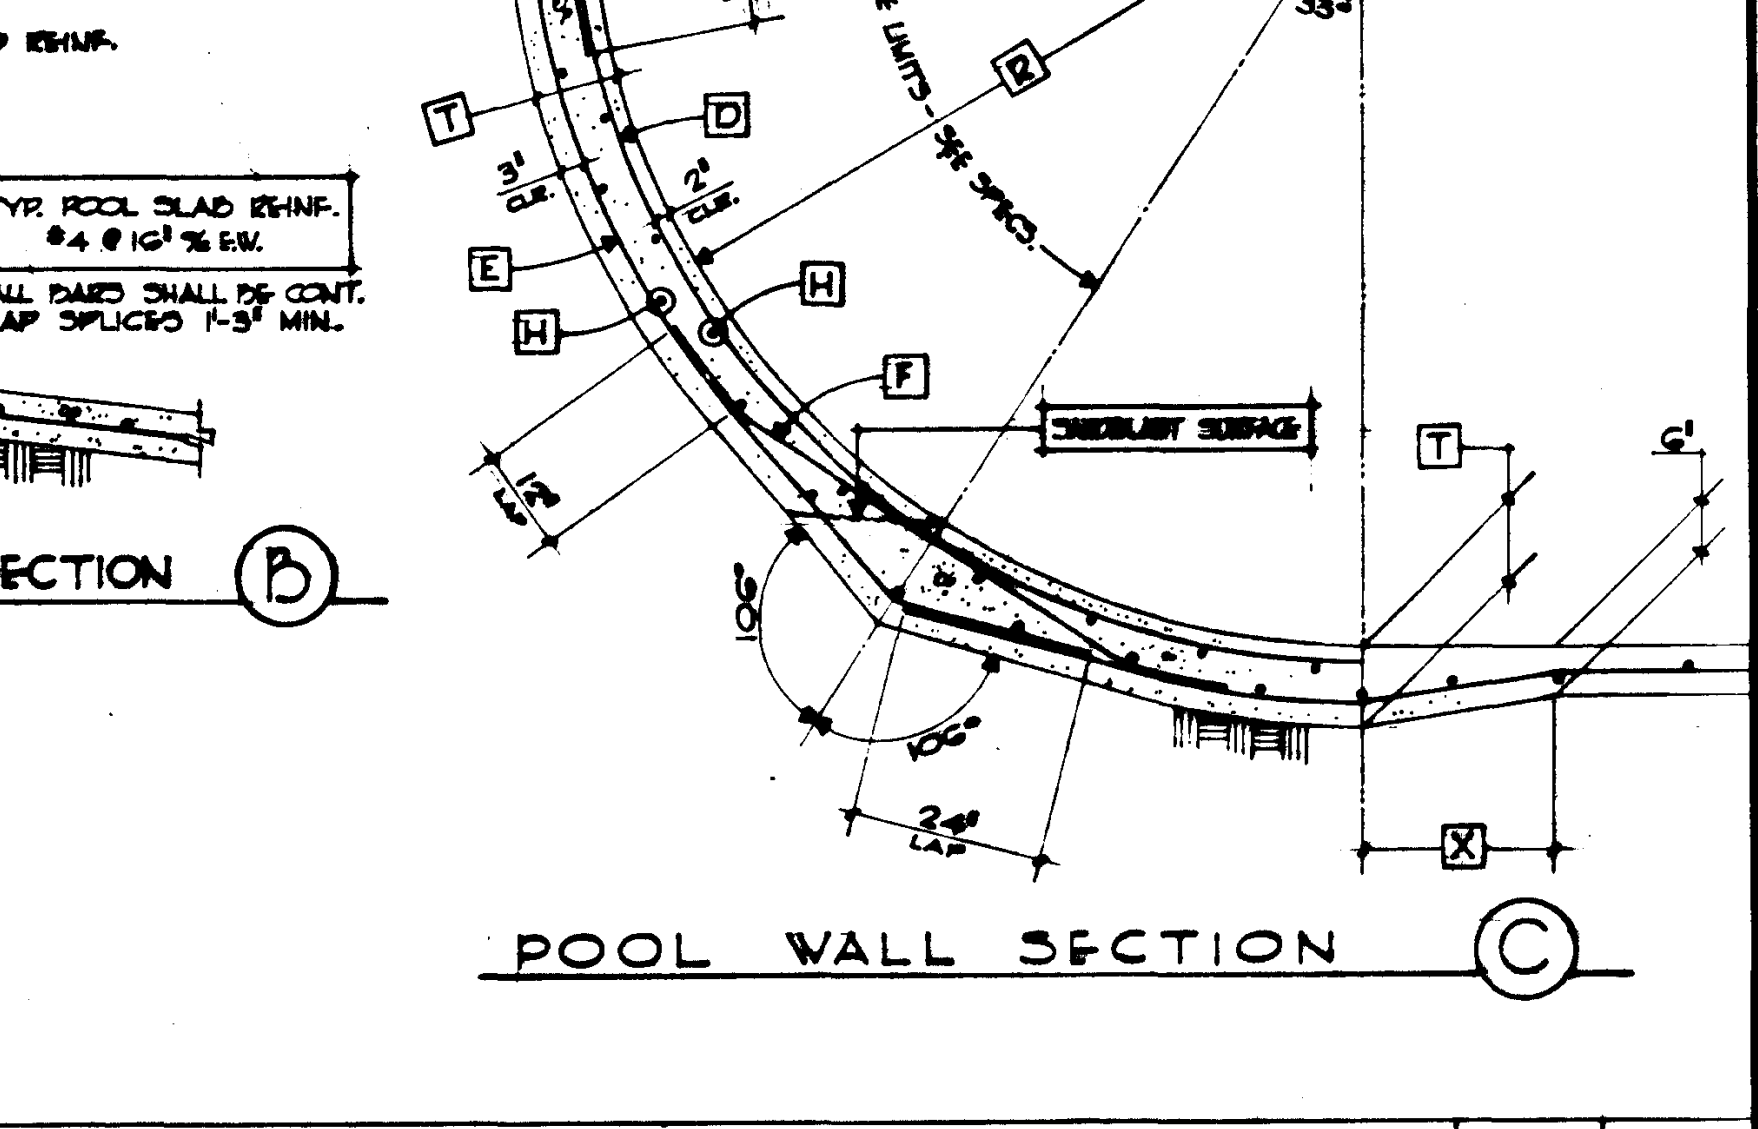
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SECTION 23 SCALE 1/4" = 1'-0"

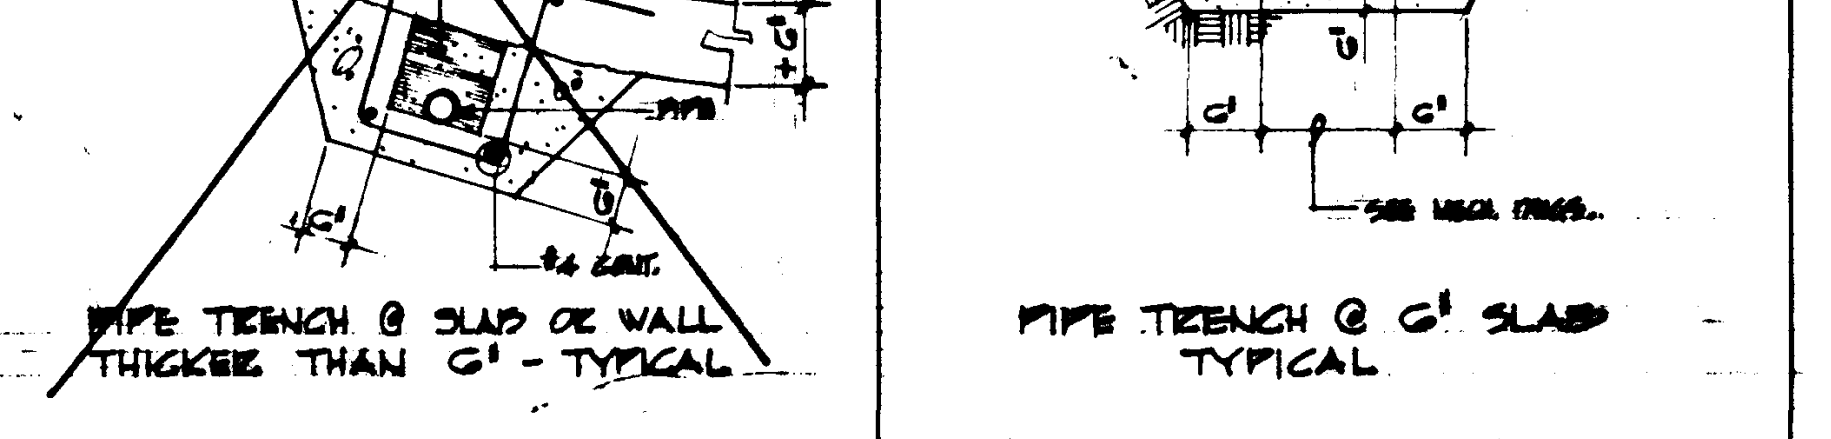


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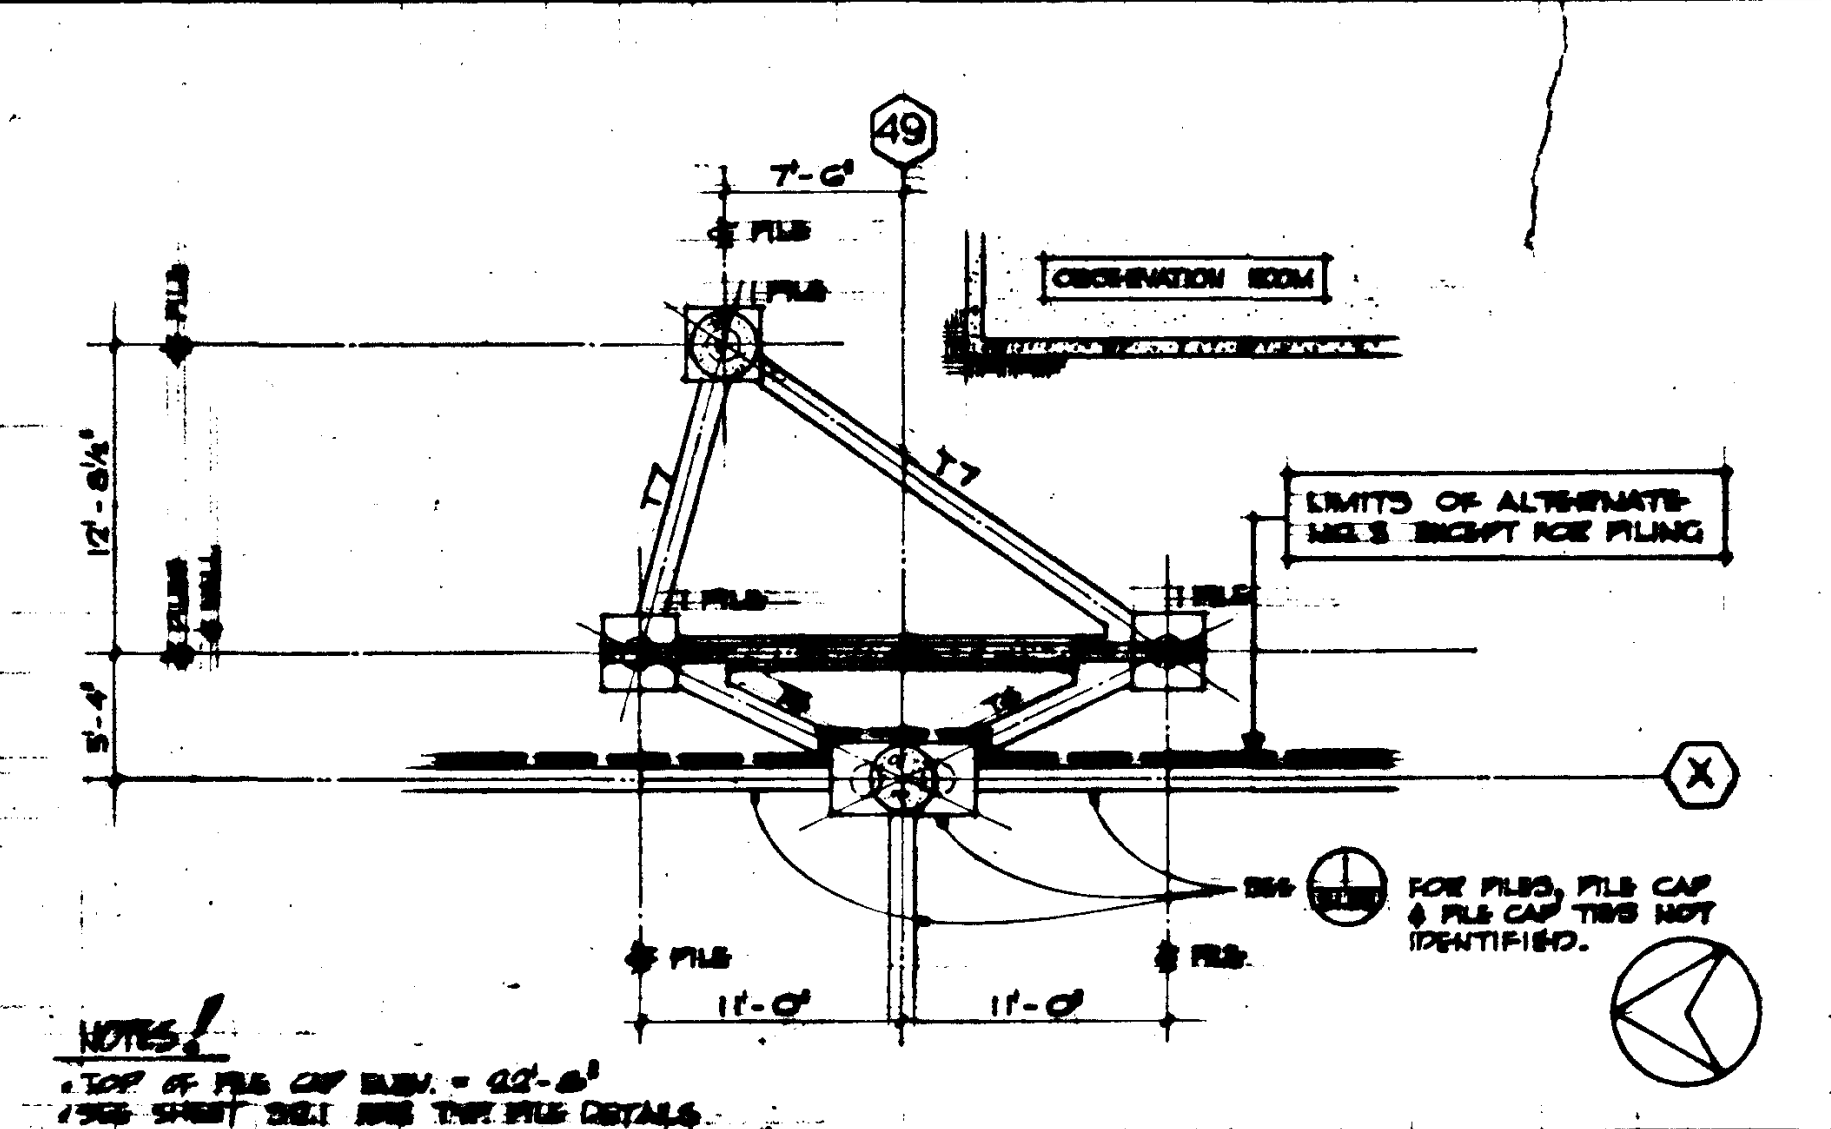


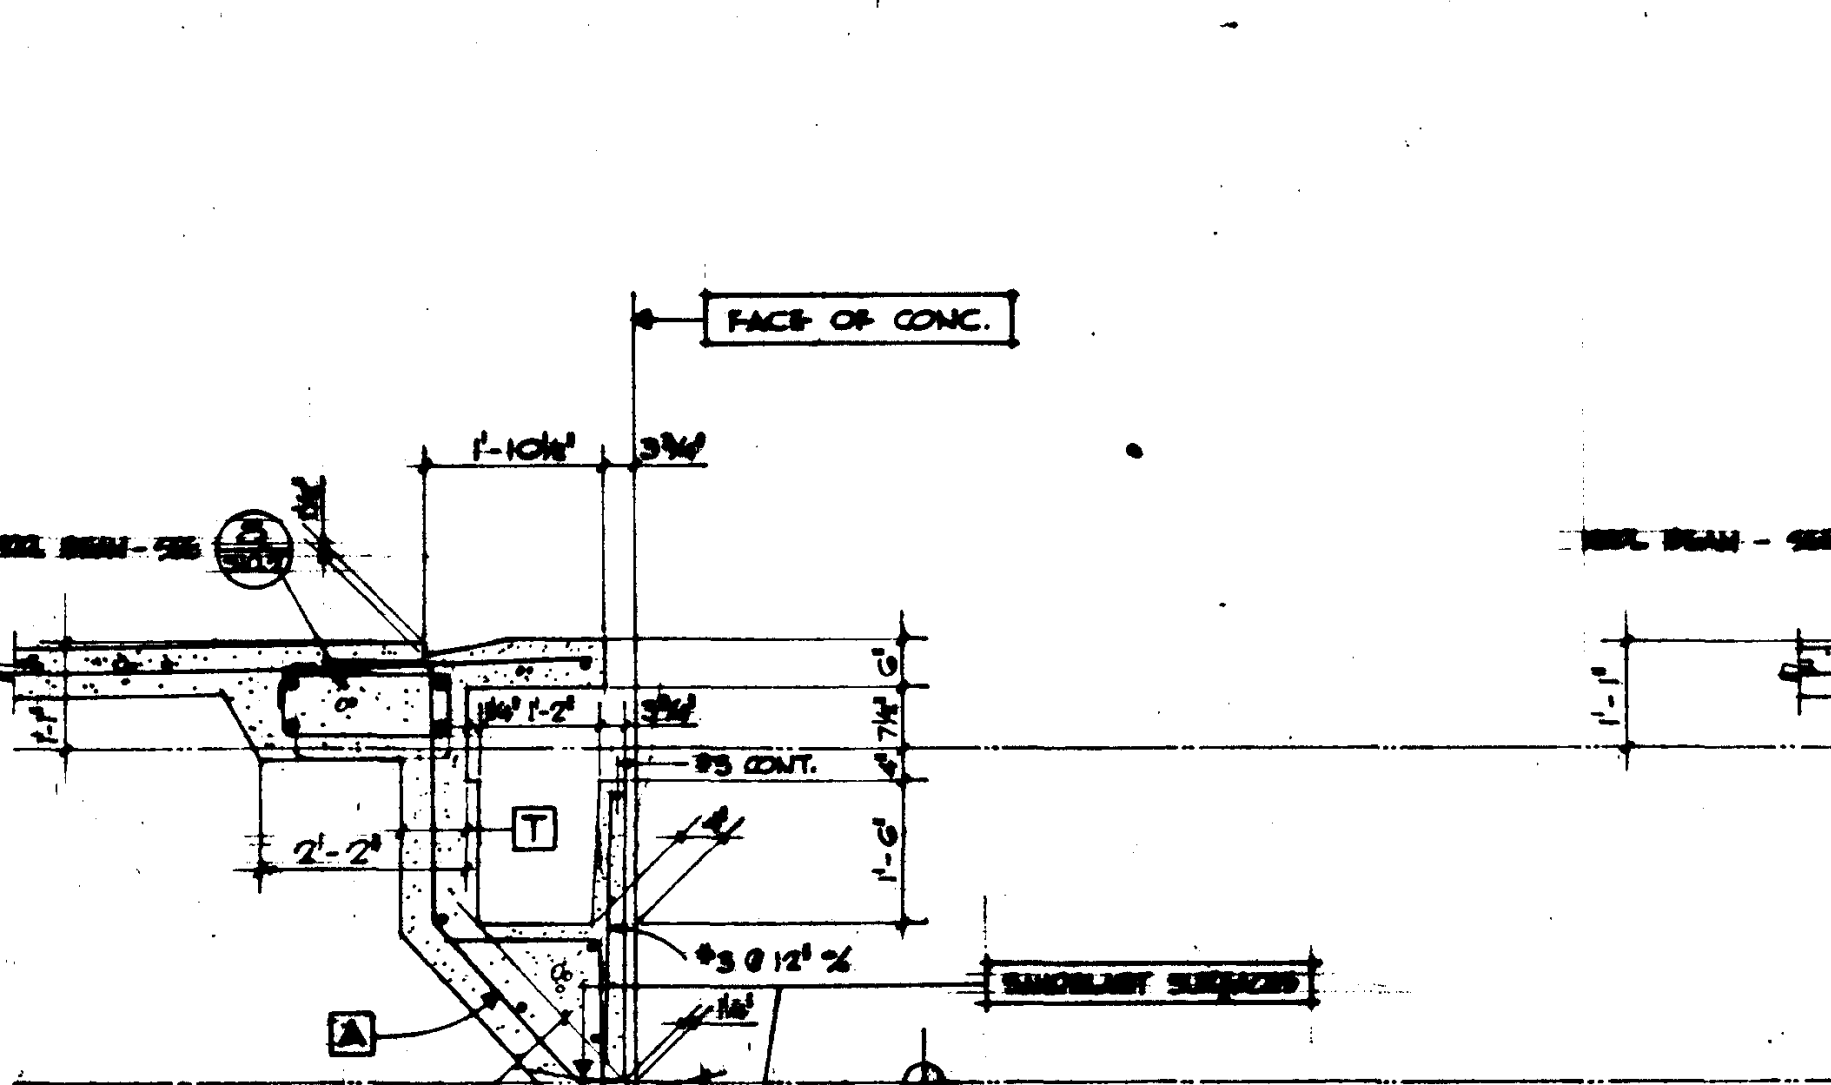SECTION 25 SCALE 1/4" = 1'-0"

POOL DEAM SCHEDULE SCALE 1/4" = 1'-0"

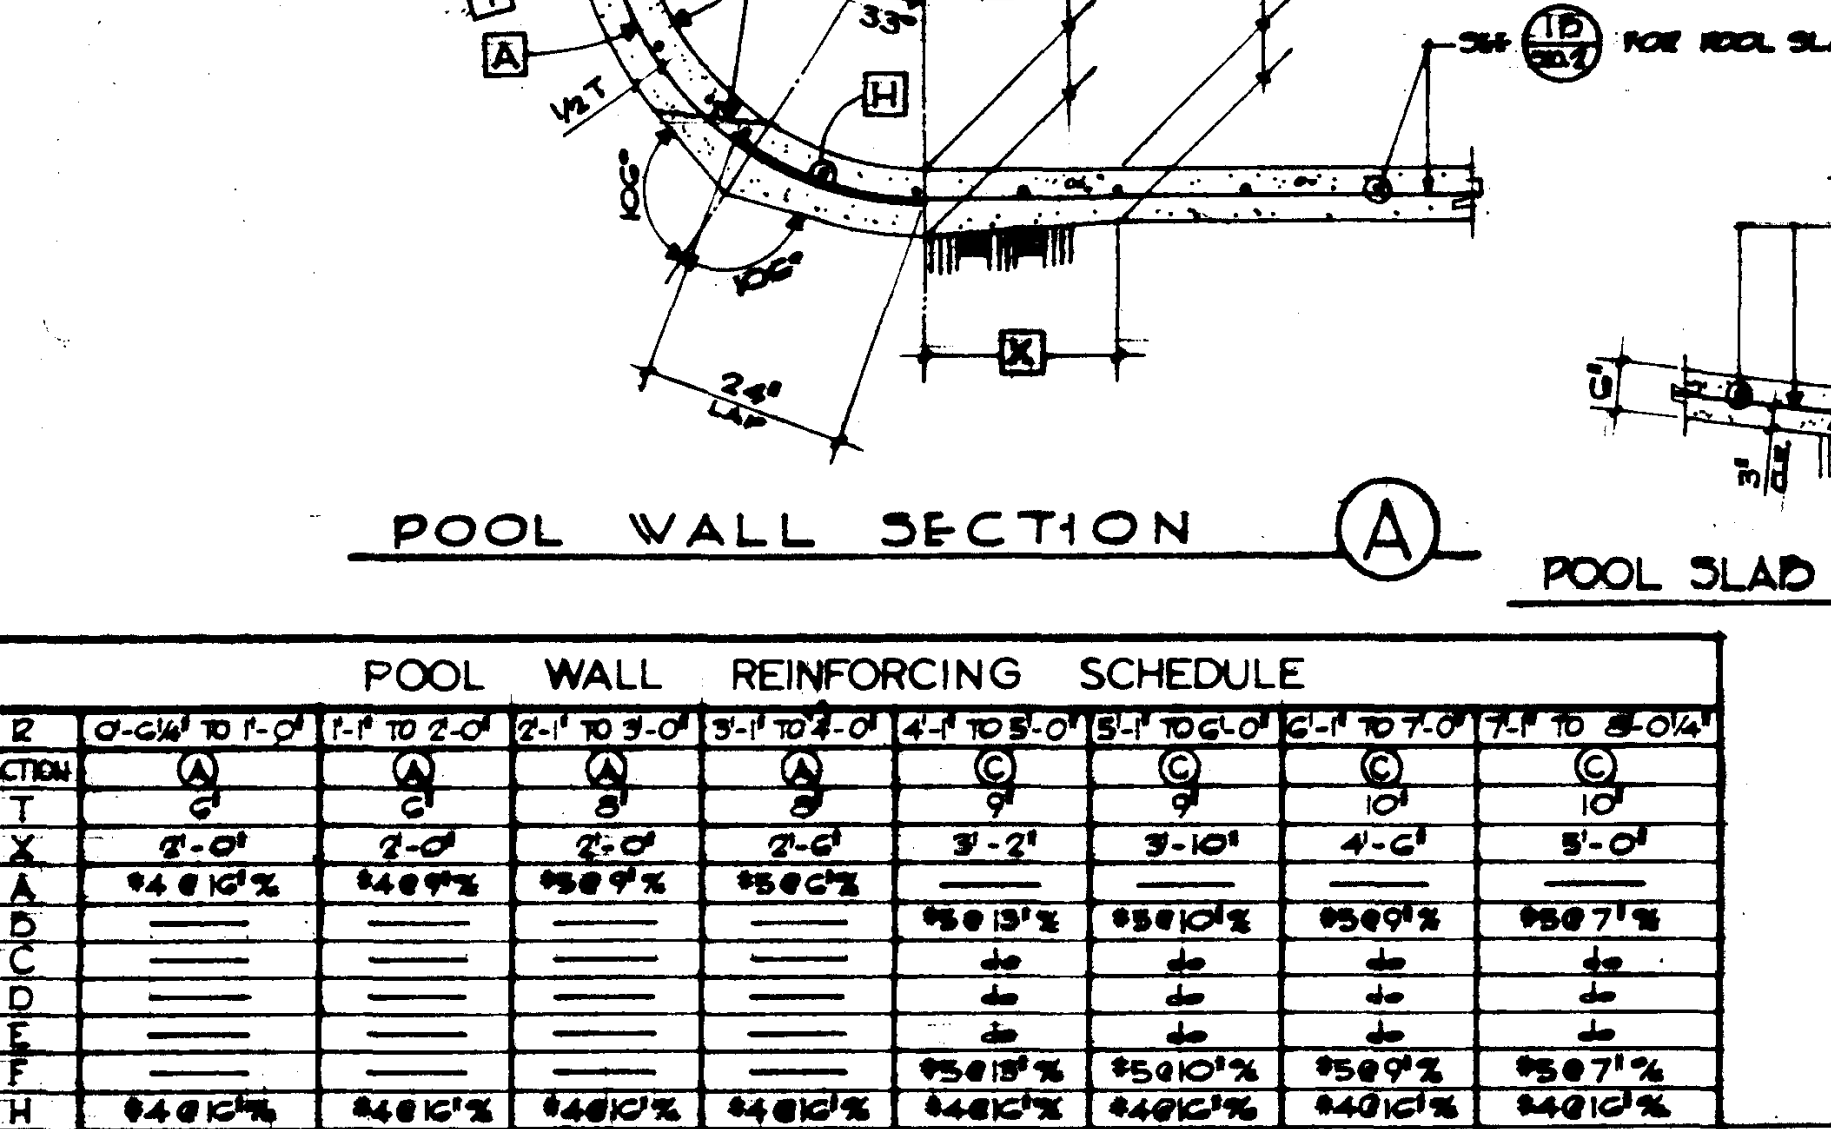

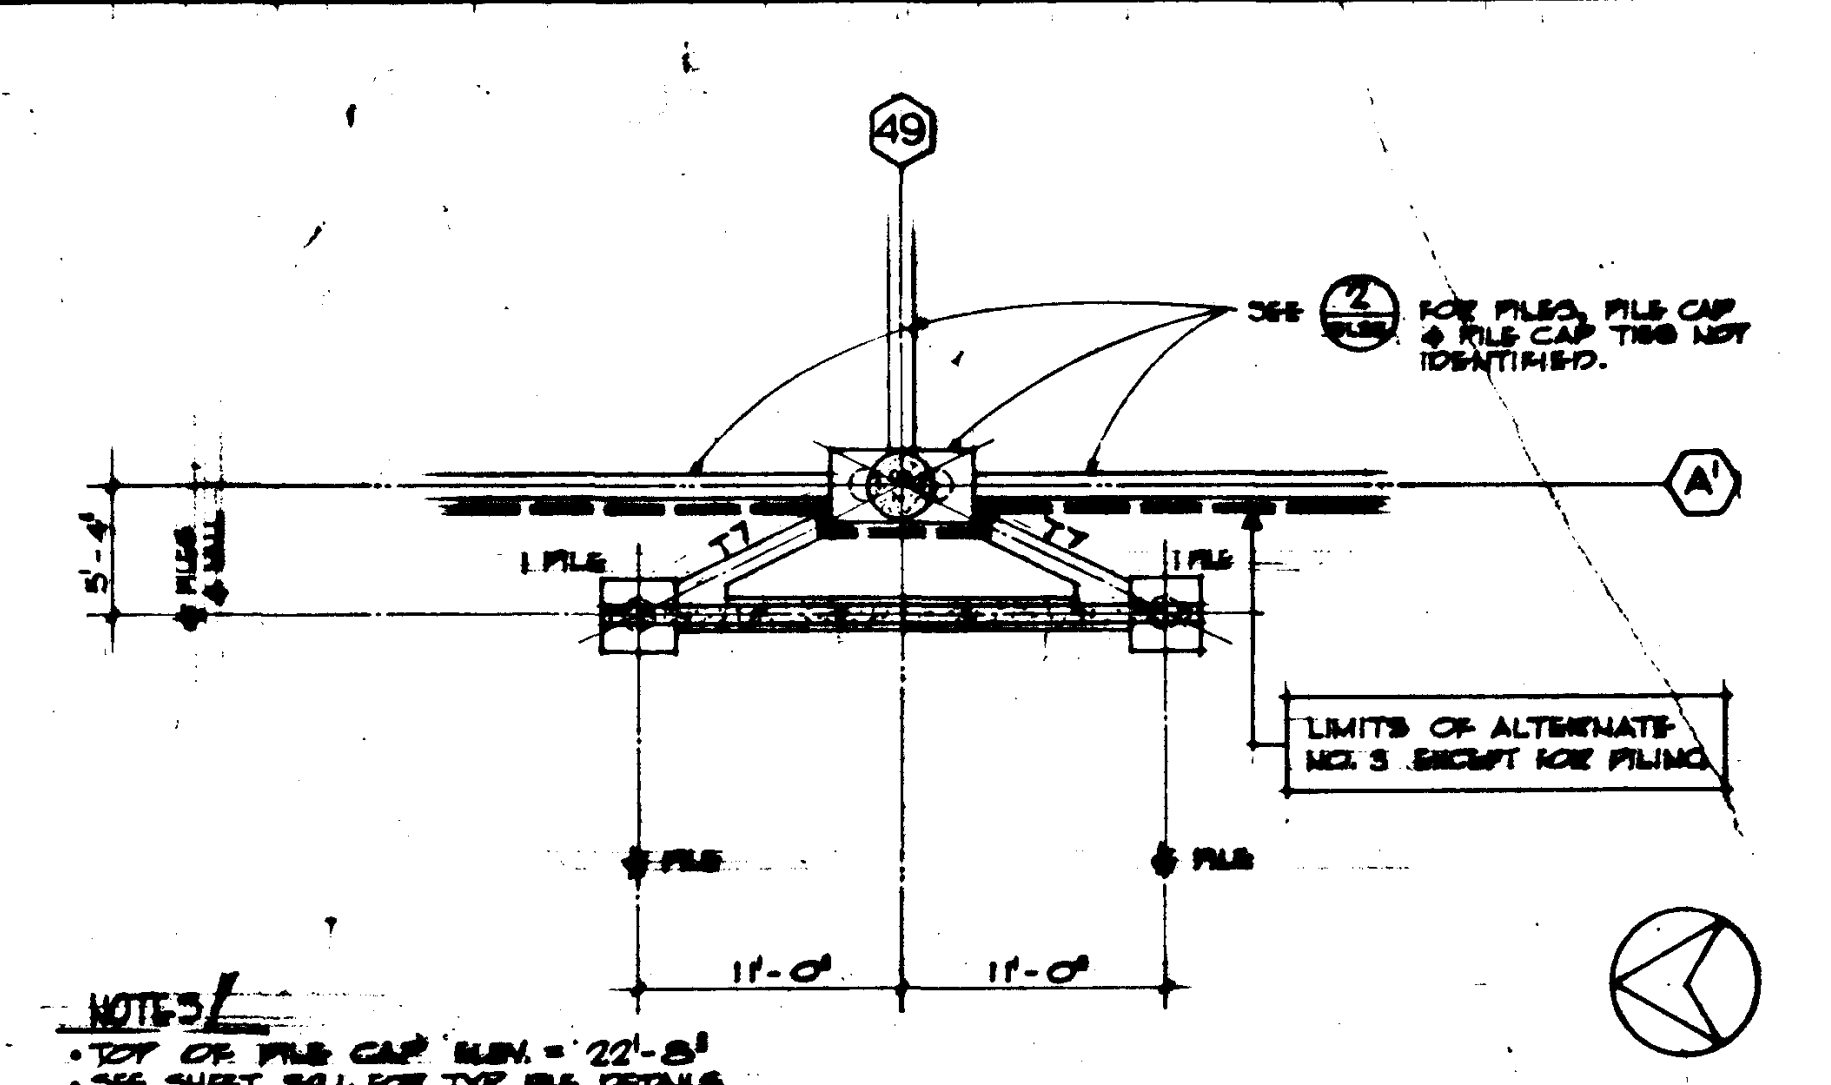
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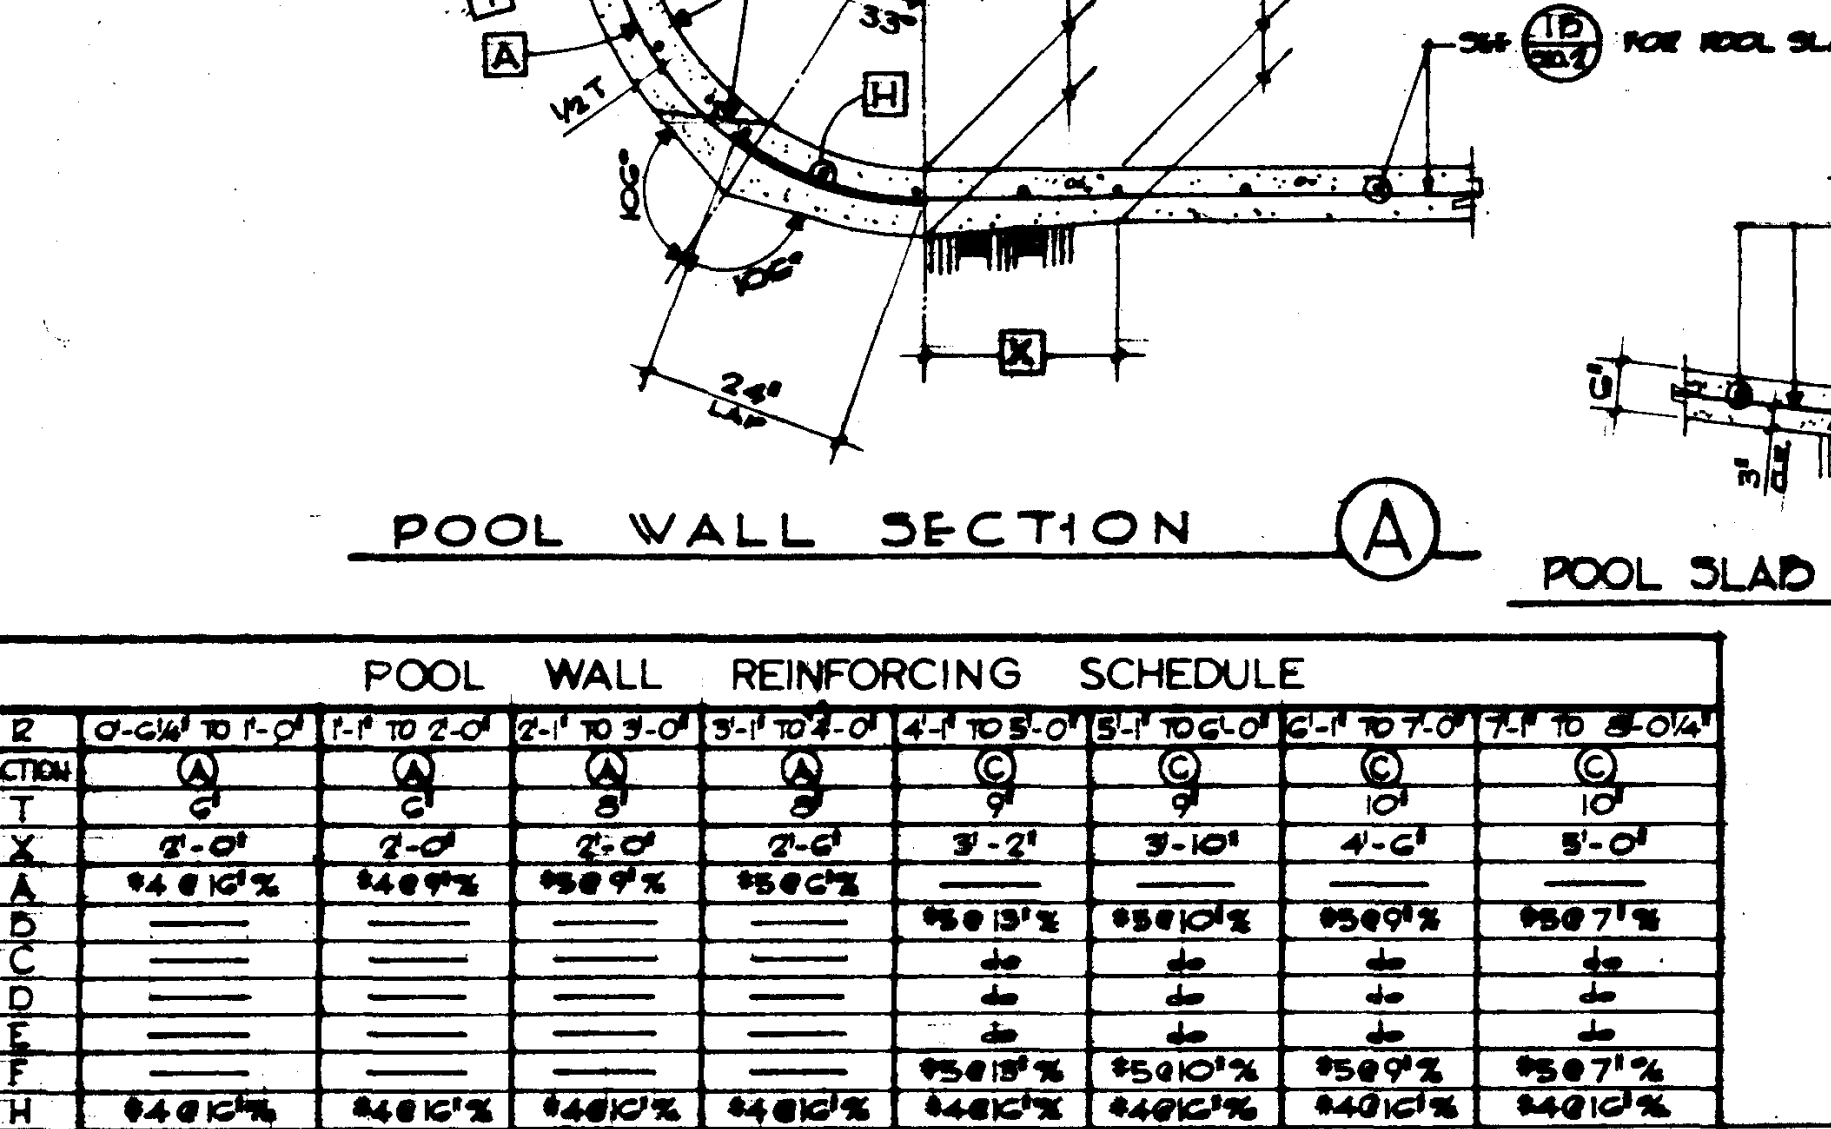


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SECTION 28 SCALE 1/4" = 1'-0"




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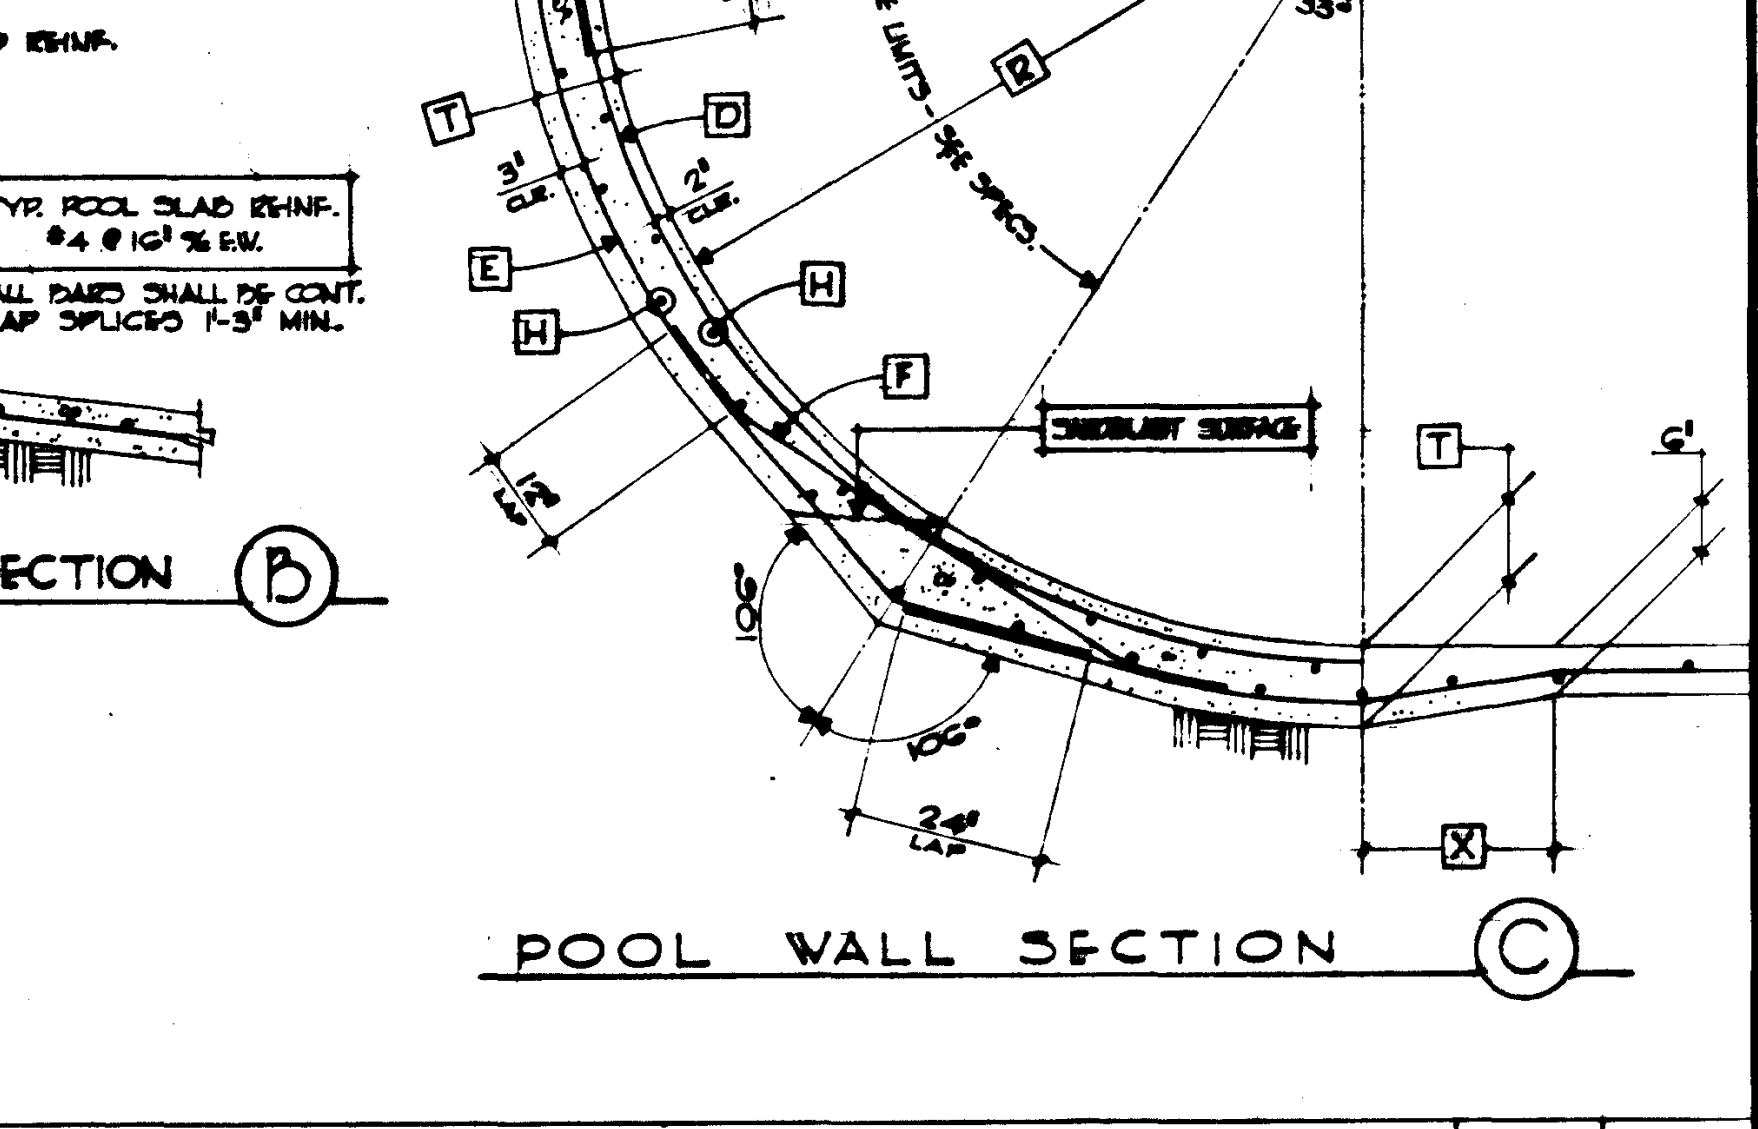

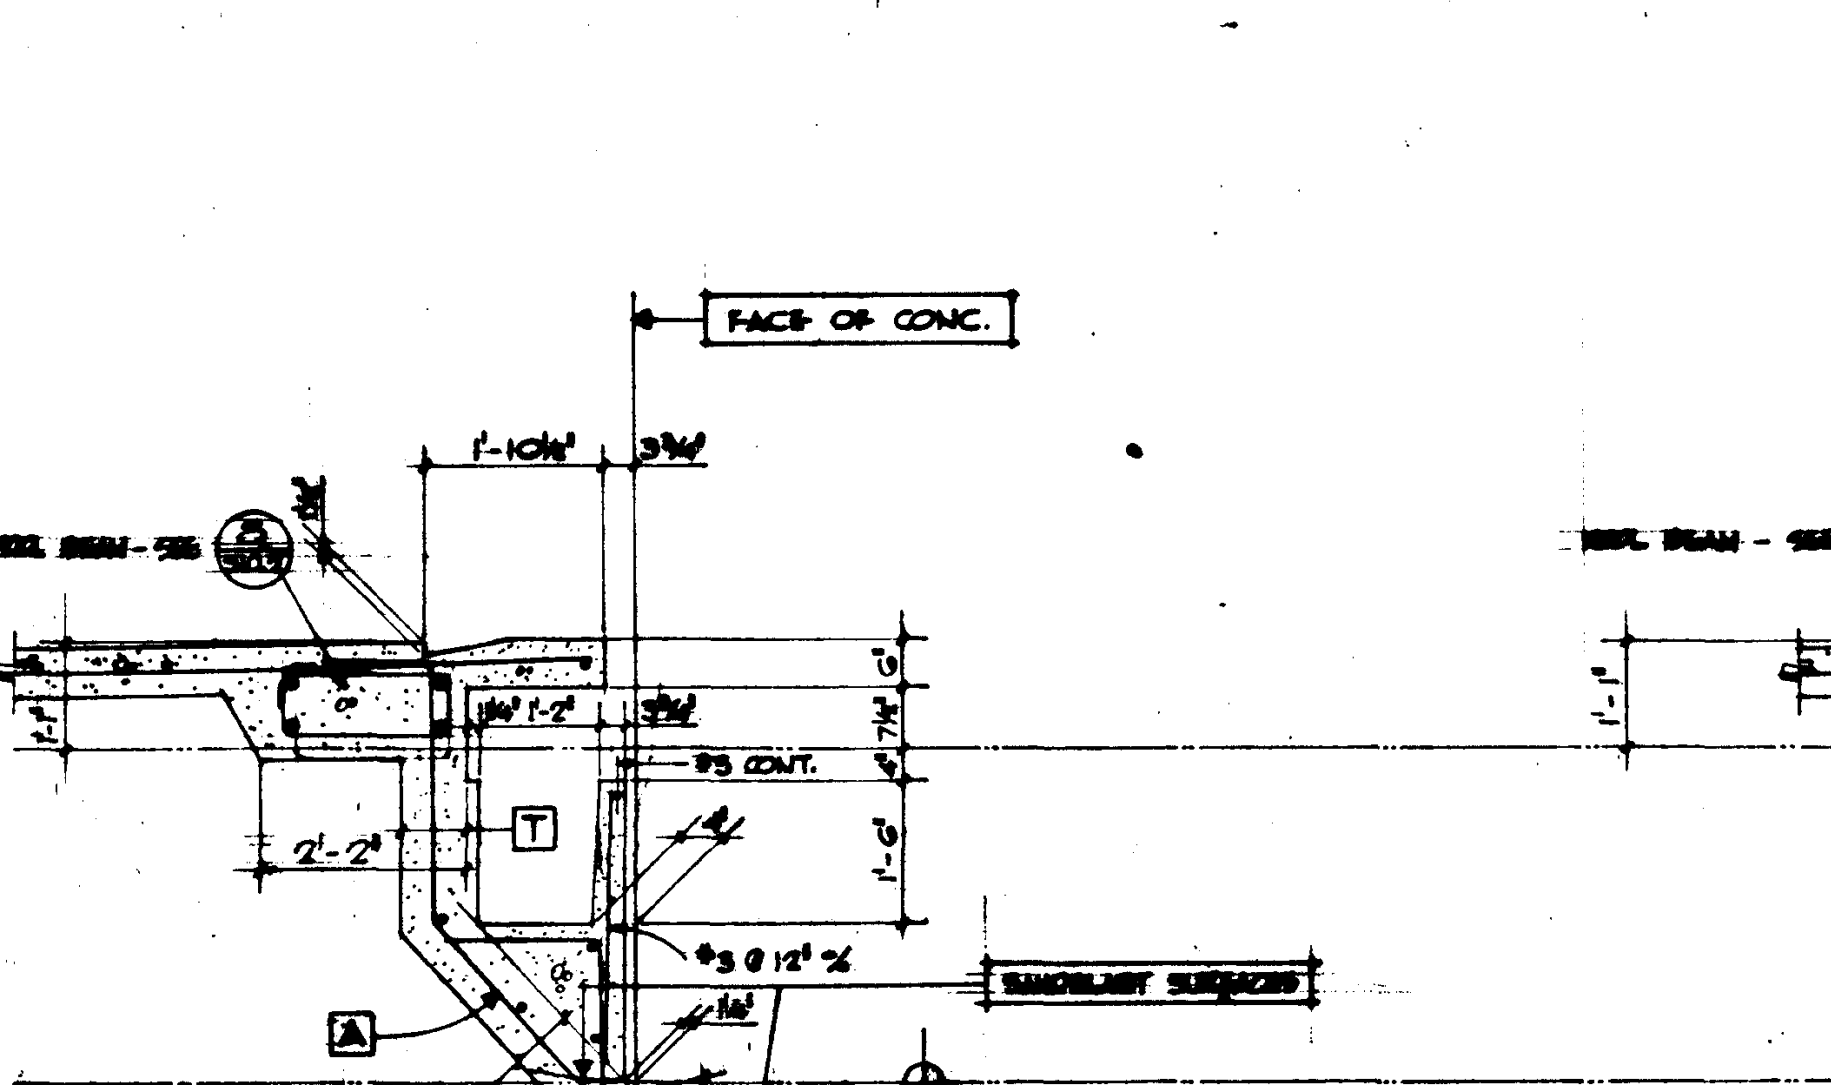
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SECTION 31 SCALE 1/4" = 1'-0"




SECTION 32 SCALE 1/4" = 1'-0"

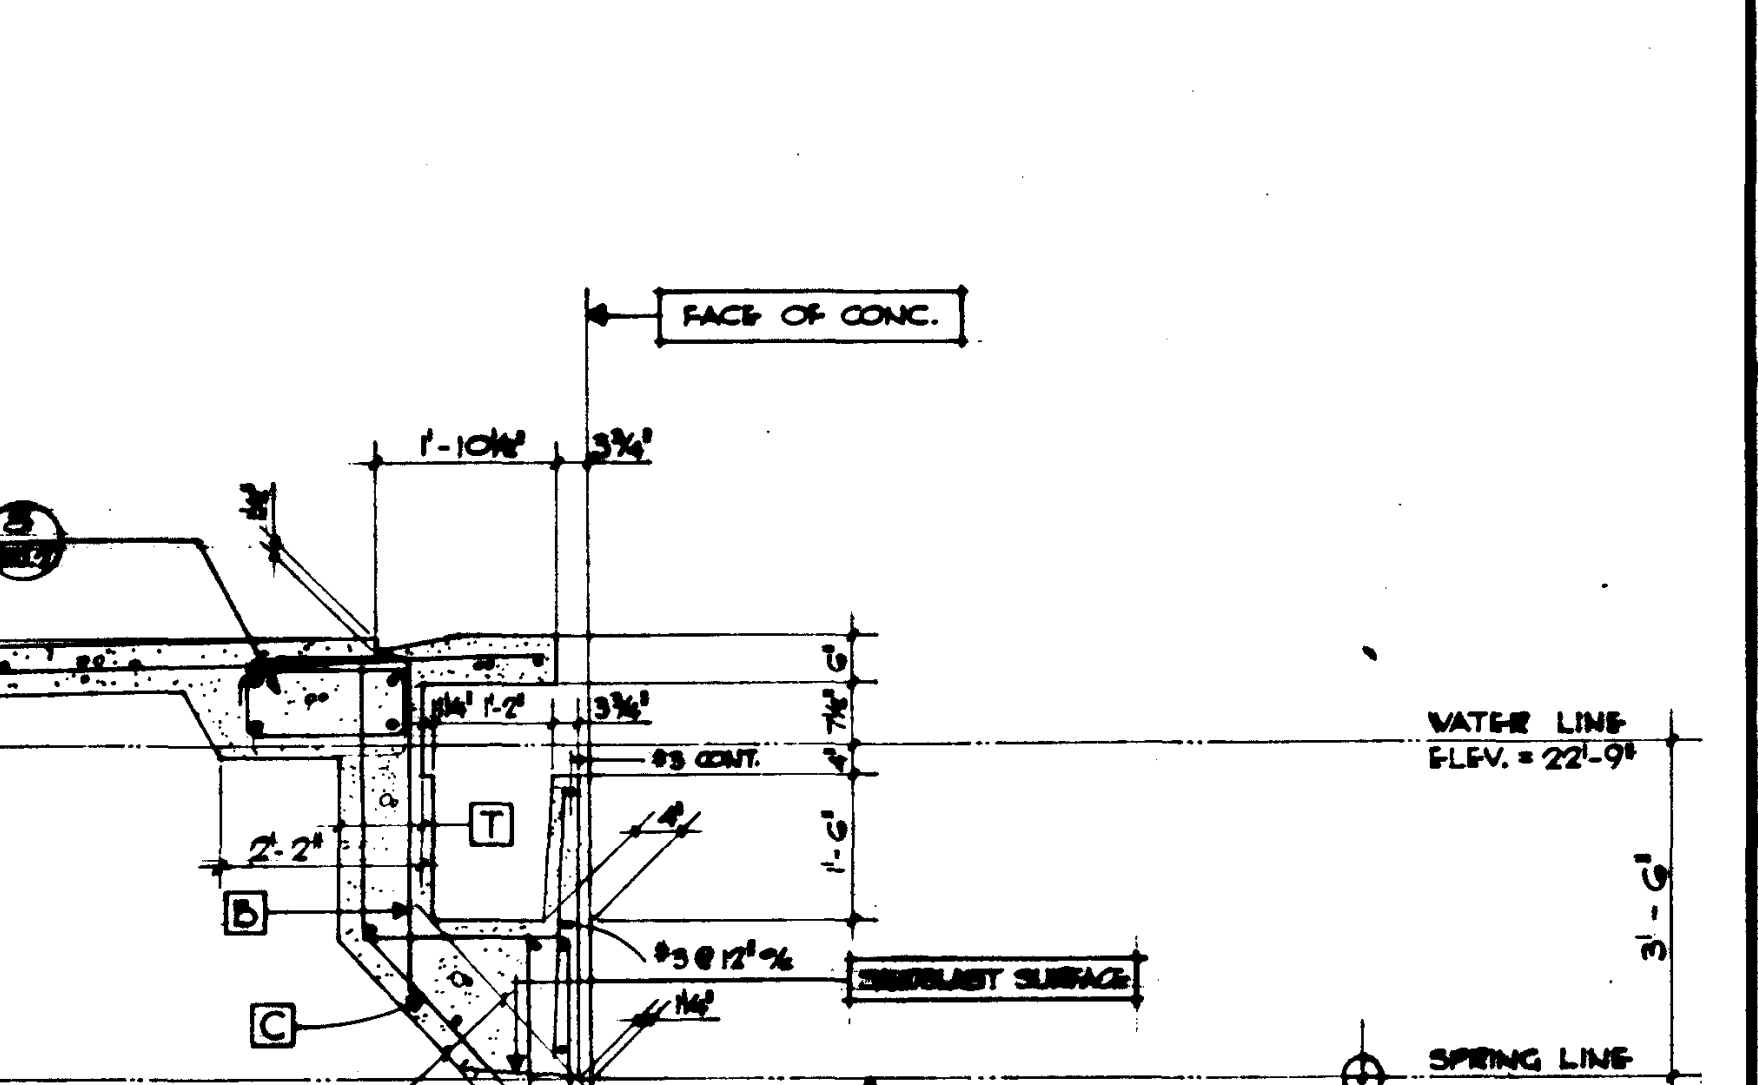

SECTION 33 SCALE 1/4" = 1'-0"

POOL DEAM SCHEDULE SCALE 1/4" = 1'-0"

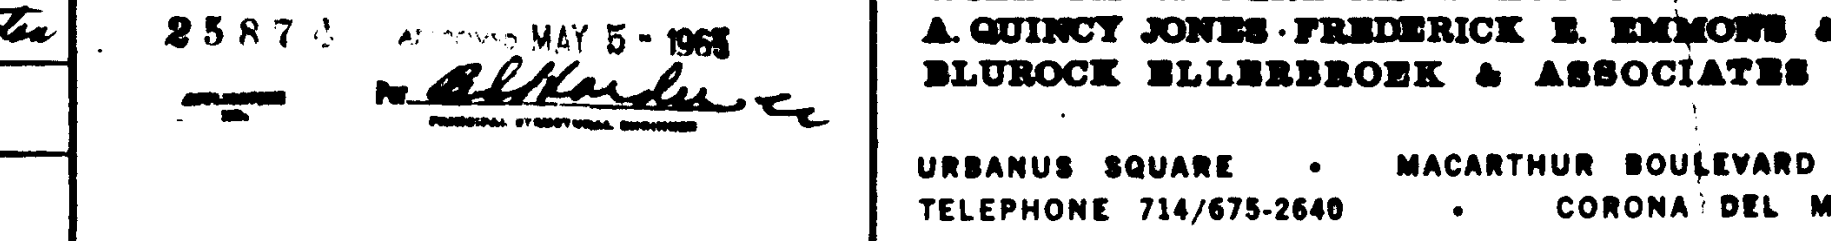


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SECTION 35 SCALE 1/4" = 1'-0"



SECTION 36 SCALE 1/4" = 1'-0"

SECTION 37 SCALE 1/4" = 1'-0"

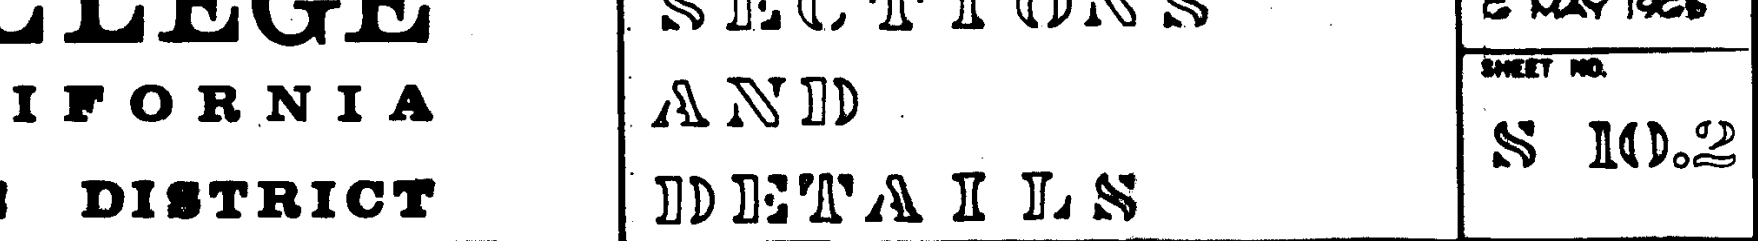

SECTION 38 SCALE 1/4" = 1'-0"

REVISIONS	DATE	BY	REASON
1			
2			
3			
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8			
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10			

STRUCTURAL ENGINEER	DESIGNED	ARCHITECT	APPROVED
W. L. PEREIRA & ASSOCIATES	W. L. PEREIRA	W. L. PEREIRA	W. L. PEREIRA
M. J. MARTIN & ASSOCIATES	M. J. MARTIN	M. J. MARTIN	M. J. MARTIN
R. S. PHILLIPS, INC.	R. S. PHILLIPS	R. S. PHILLIPS	R. S. PHILLIPS
ELECTRICAL ENGINEER	CHECKED	DATE	
R. S. PHILLIPS, INC.			
CIVIL ENGINEER			
G. SHUTMAN & ASSOCIATES			
MOFFATT & NICHOL			


POOL WALL REINFORCING SCHEDULE	SECTION	REINFORCING	SCALE
1	1-10'	2#4 @ 12" VERT. EACH FACE	1/4" = 1'-0"
2	1-10'	2#4 @ 20" HORIZ. EACH FACE	1/4" = 1'-0"
3	1-10'	2#4 @ 12" VERT. EACH FACE	1/4" = 1'-0"
4	1-10'	2#4 @ 20" HORIZ. EACH FACE	1/4" = 1'-0"
5	1-10'	2#4 @ 12" VERT. EACH FACE	1/4" = 1'-0"
6	1-10'	2#4 @ 20" HORIZ. EACH FACE	1/4" = 1'-0"
7	1-10'	2#4 @ 12" VERT. EACH FACE	1/4" = 1'-0"
8	1-10'	2#4 @ 20" HORIZ. EACH FACE	1/4" = 1'-0"
9	1-10'	2#4 @ 12" VERT. EACH FACE	1/4" = 1'-0"
10	1-10'	2#4 @ 20" HORIZ. EACH FACE	1/4" = 1'-0"

POOL WALL REINFORCING SCHEDULE	SECTION	REINFORCING	SCALE
1	1-10'	2#4 @ 12" VERT. EACH FACE	1/4" = 1'-0"
2	1-10'	2#4 @ 20" HORIZ. EACH FACE	1/4" = 1'-0"
3	1-10'	2#4 @ 12" VERT. EACH FACE	1/4" = 1'-0"
4	1-10'	2#4 @ 20" HORIZ. EACH FACE	1/4" = 1'-0"
5	1-10'	2#4 @ 12" VERT. EACH FACE	1/4" = 1'-0"
6	1-10'	2#4 @ 20" HORIZ. EACH FACE	1/4" = 1'-0"
7	1-10'	2#4 @ 12" VERT. EACH FACE	1/4" = 1'-0"
8	1-10'	2#4 @ 20" HORIZ. EACH FACE	1/4" = 1'-0"
9	1-10'	2#4 @ 12" VERT. EACH FACE	1/4" = 1'-0"
10	1-10'	2#4 @ 20" HORIZ. EACH FACE	1/4" = 1'-0"


GOLDEN WEST COLLEGE
HUNTINGTON BEACH, CALIFORNIA
ORANGE COAST JUNIOR COLLEGE DISTRICT

SWIMMING POOL
SECTIONS
AND
DETAILS


DATE
15 MAY 1965
SHEET NO.
S 10.2

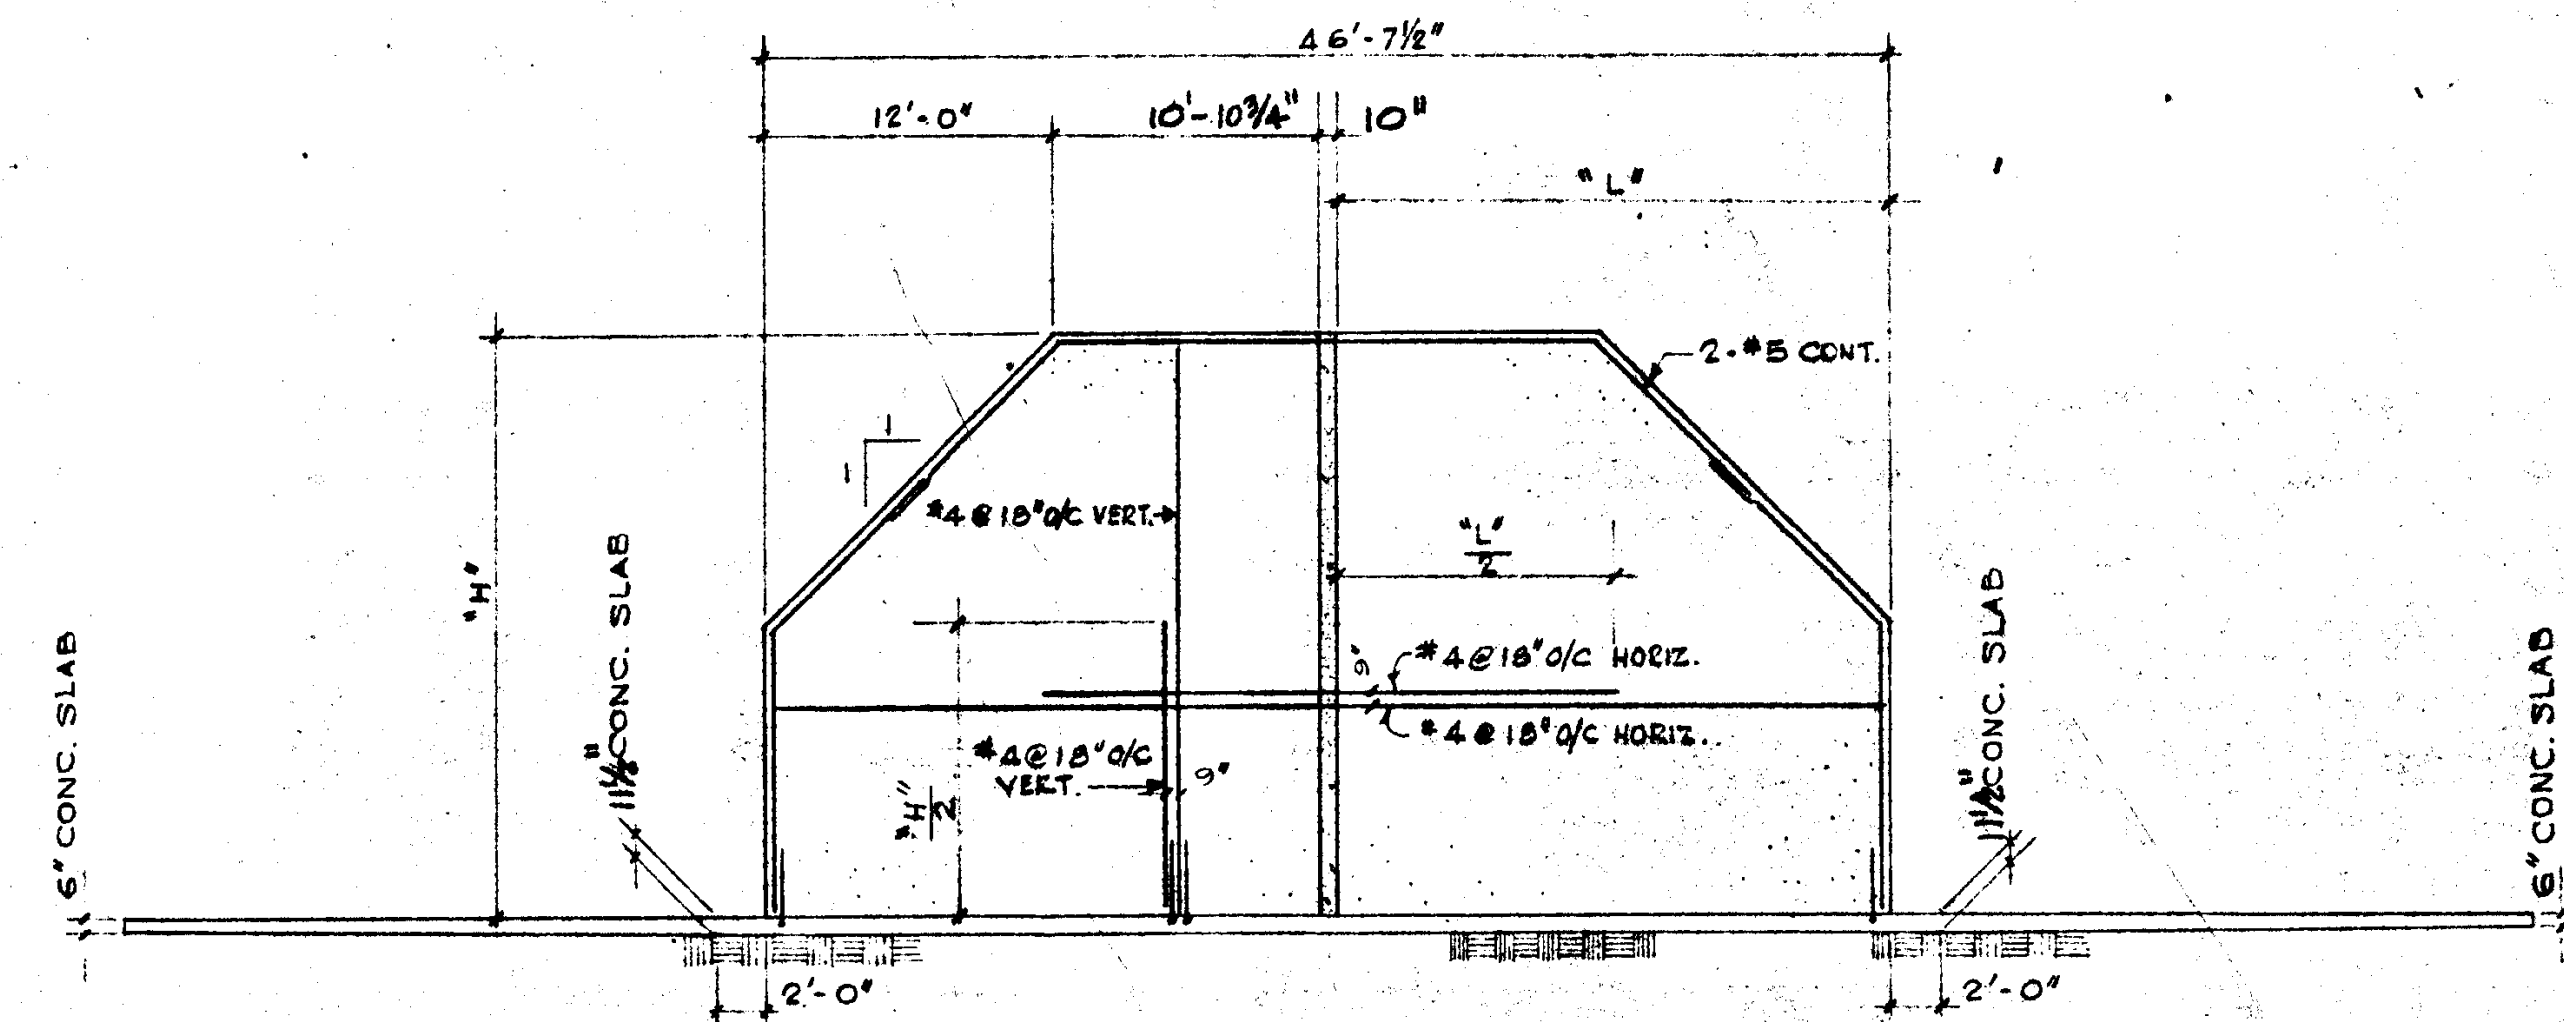

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1/8"	

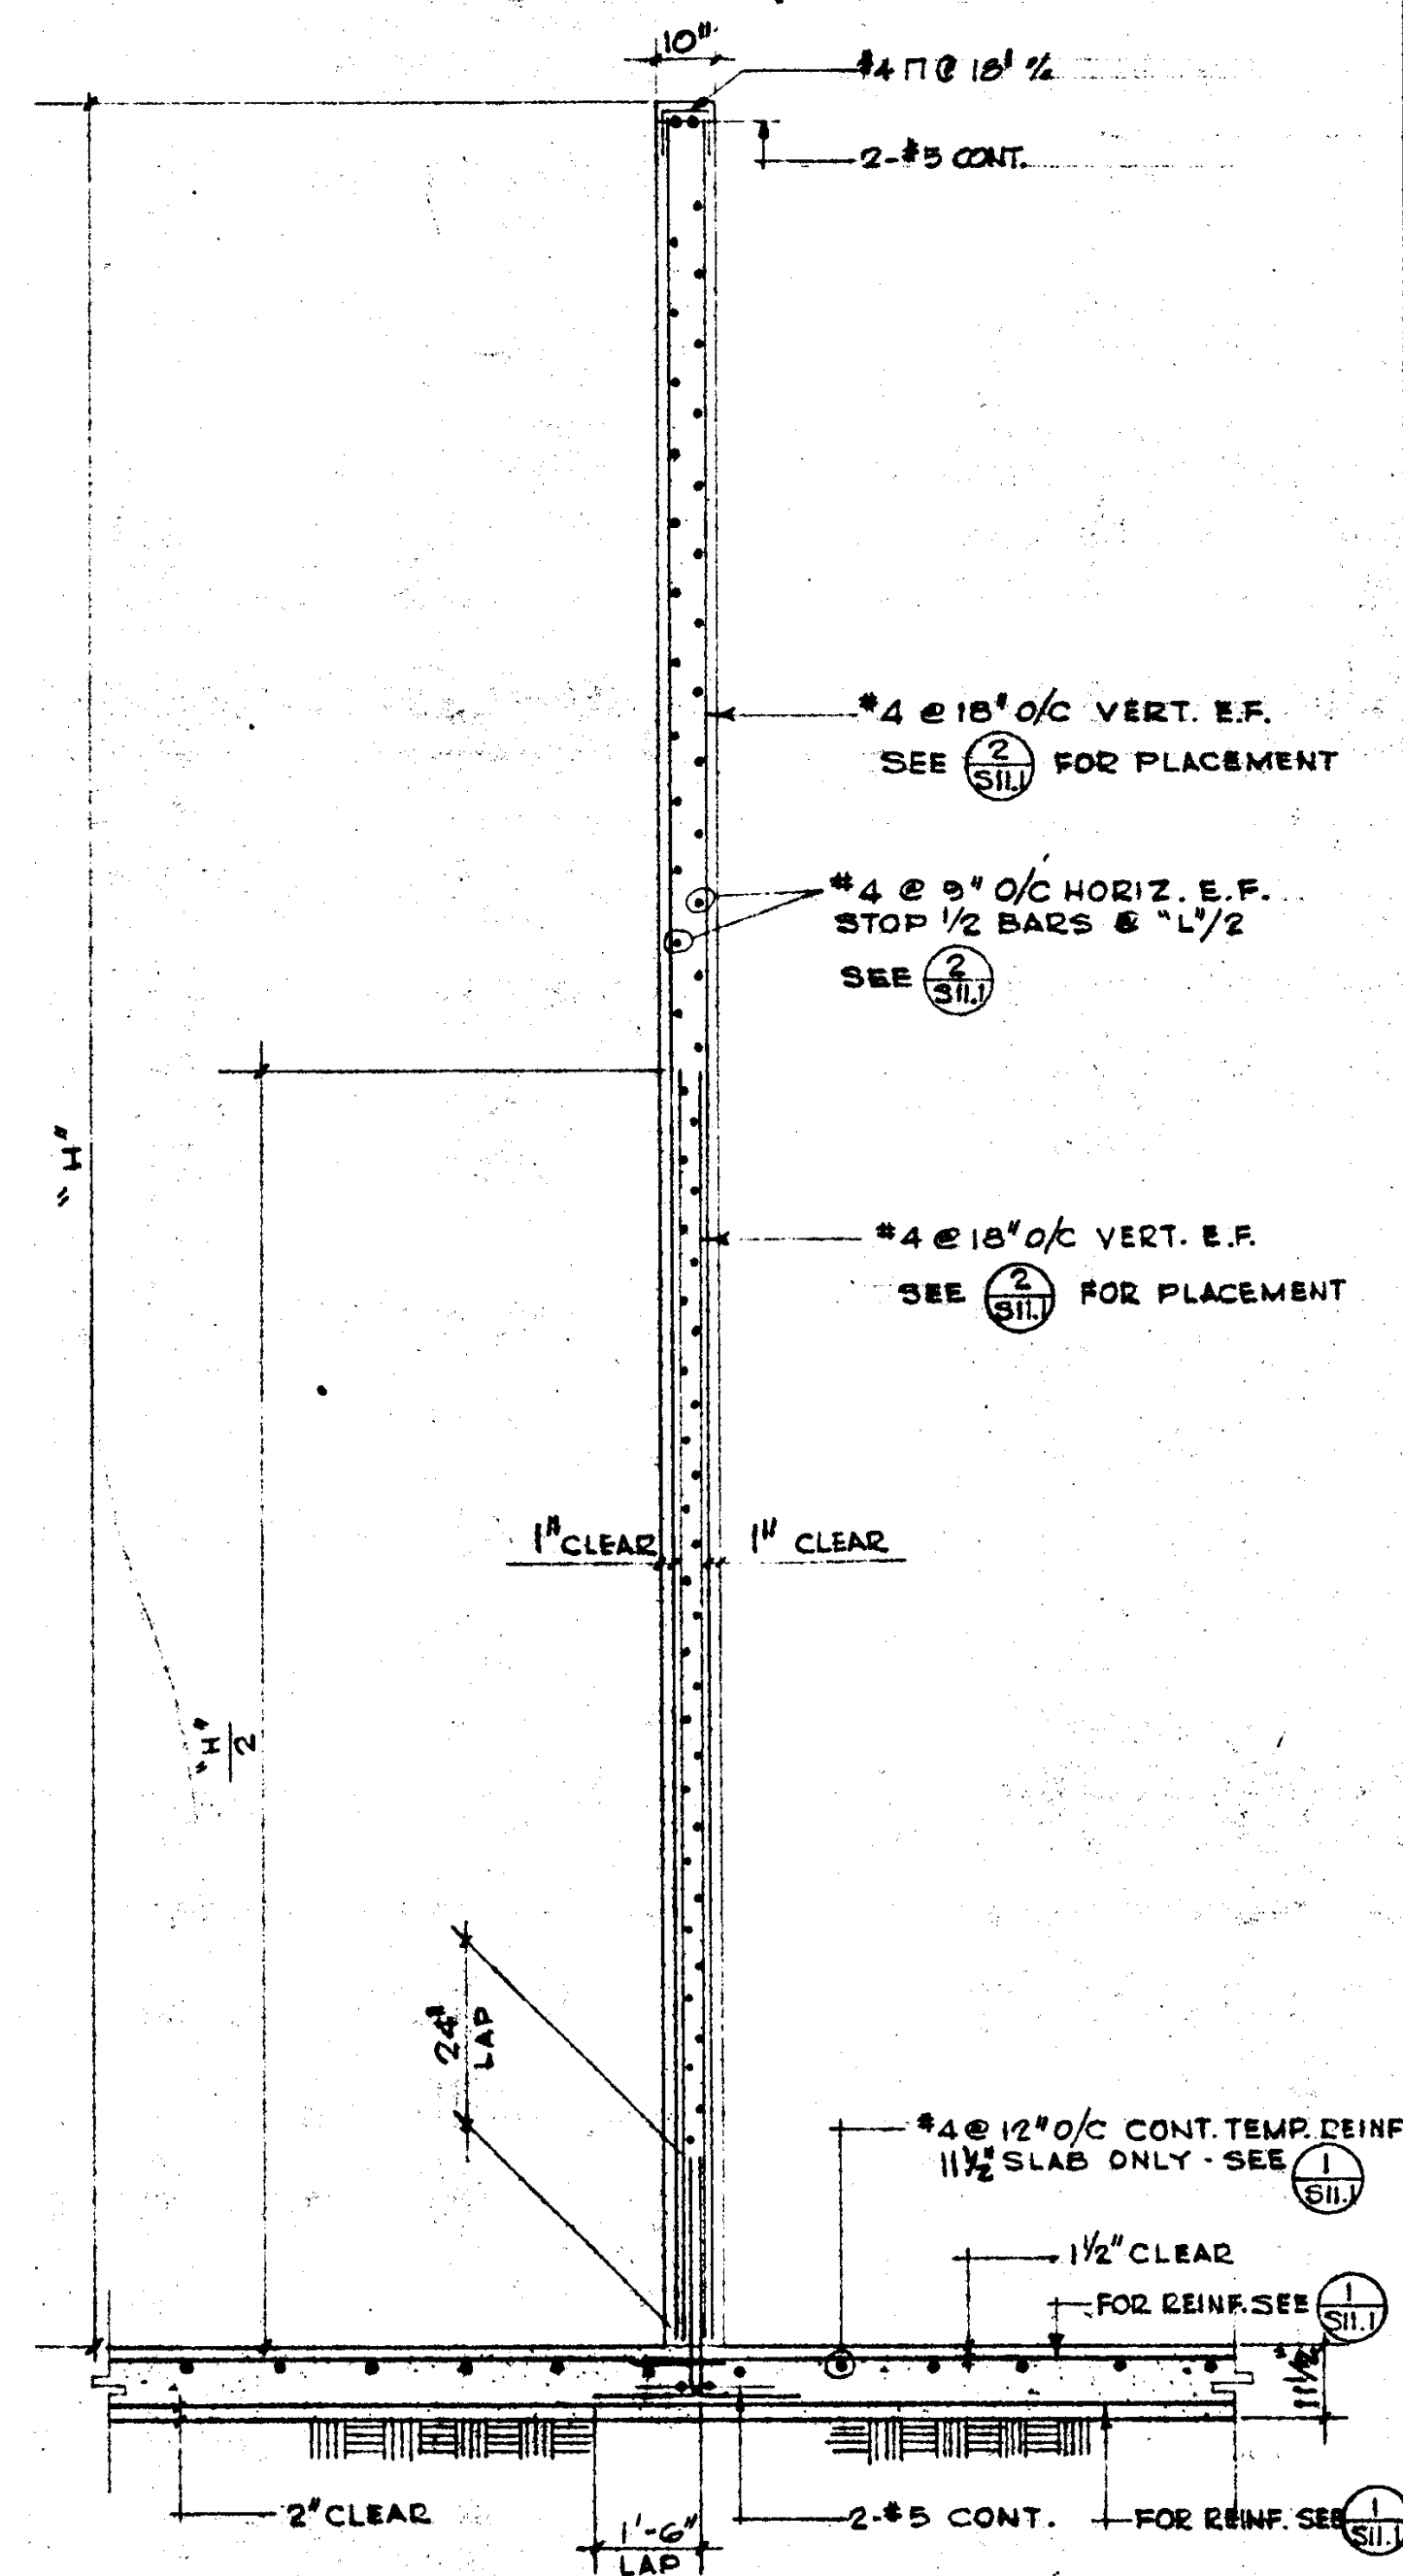



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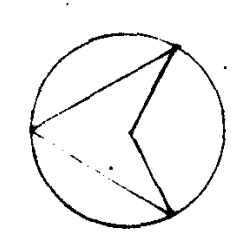
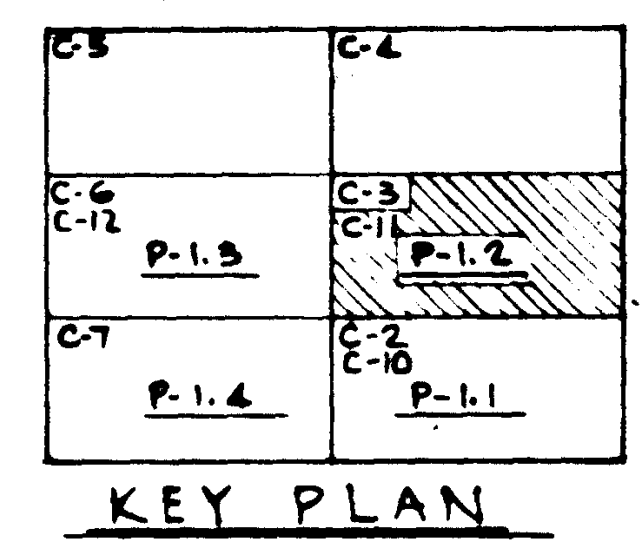
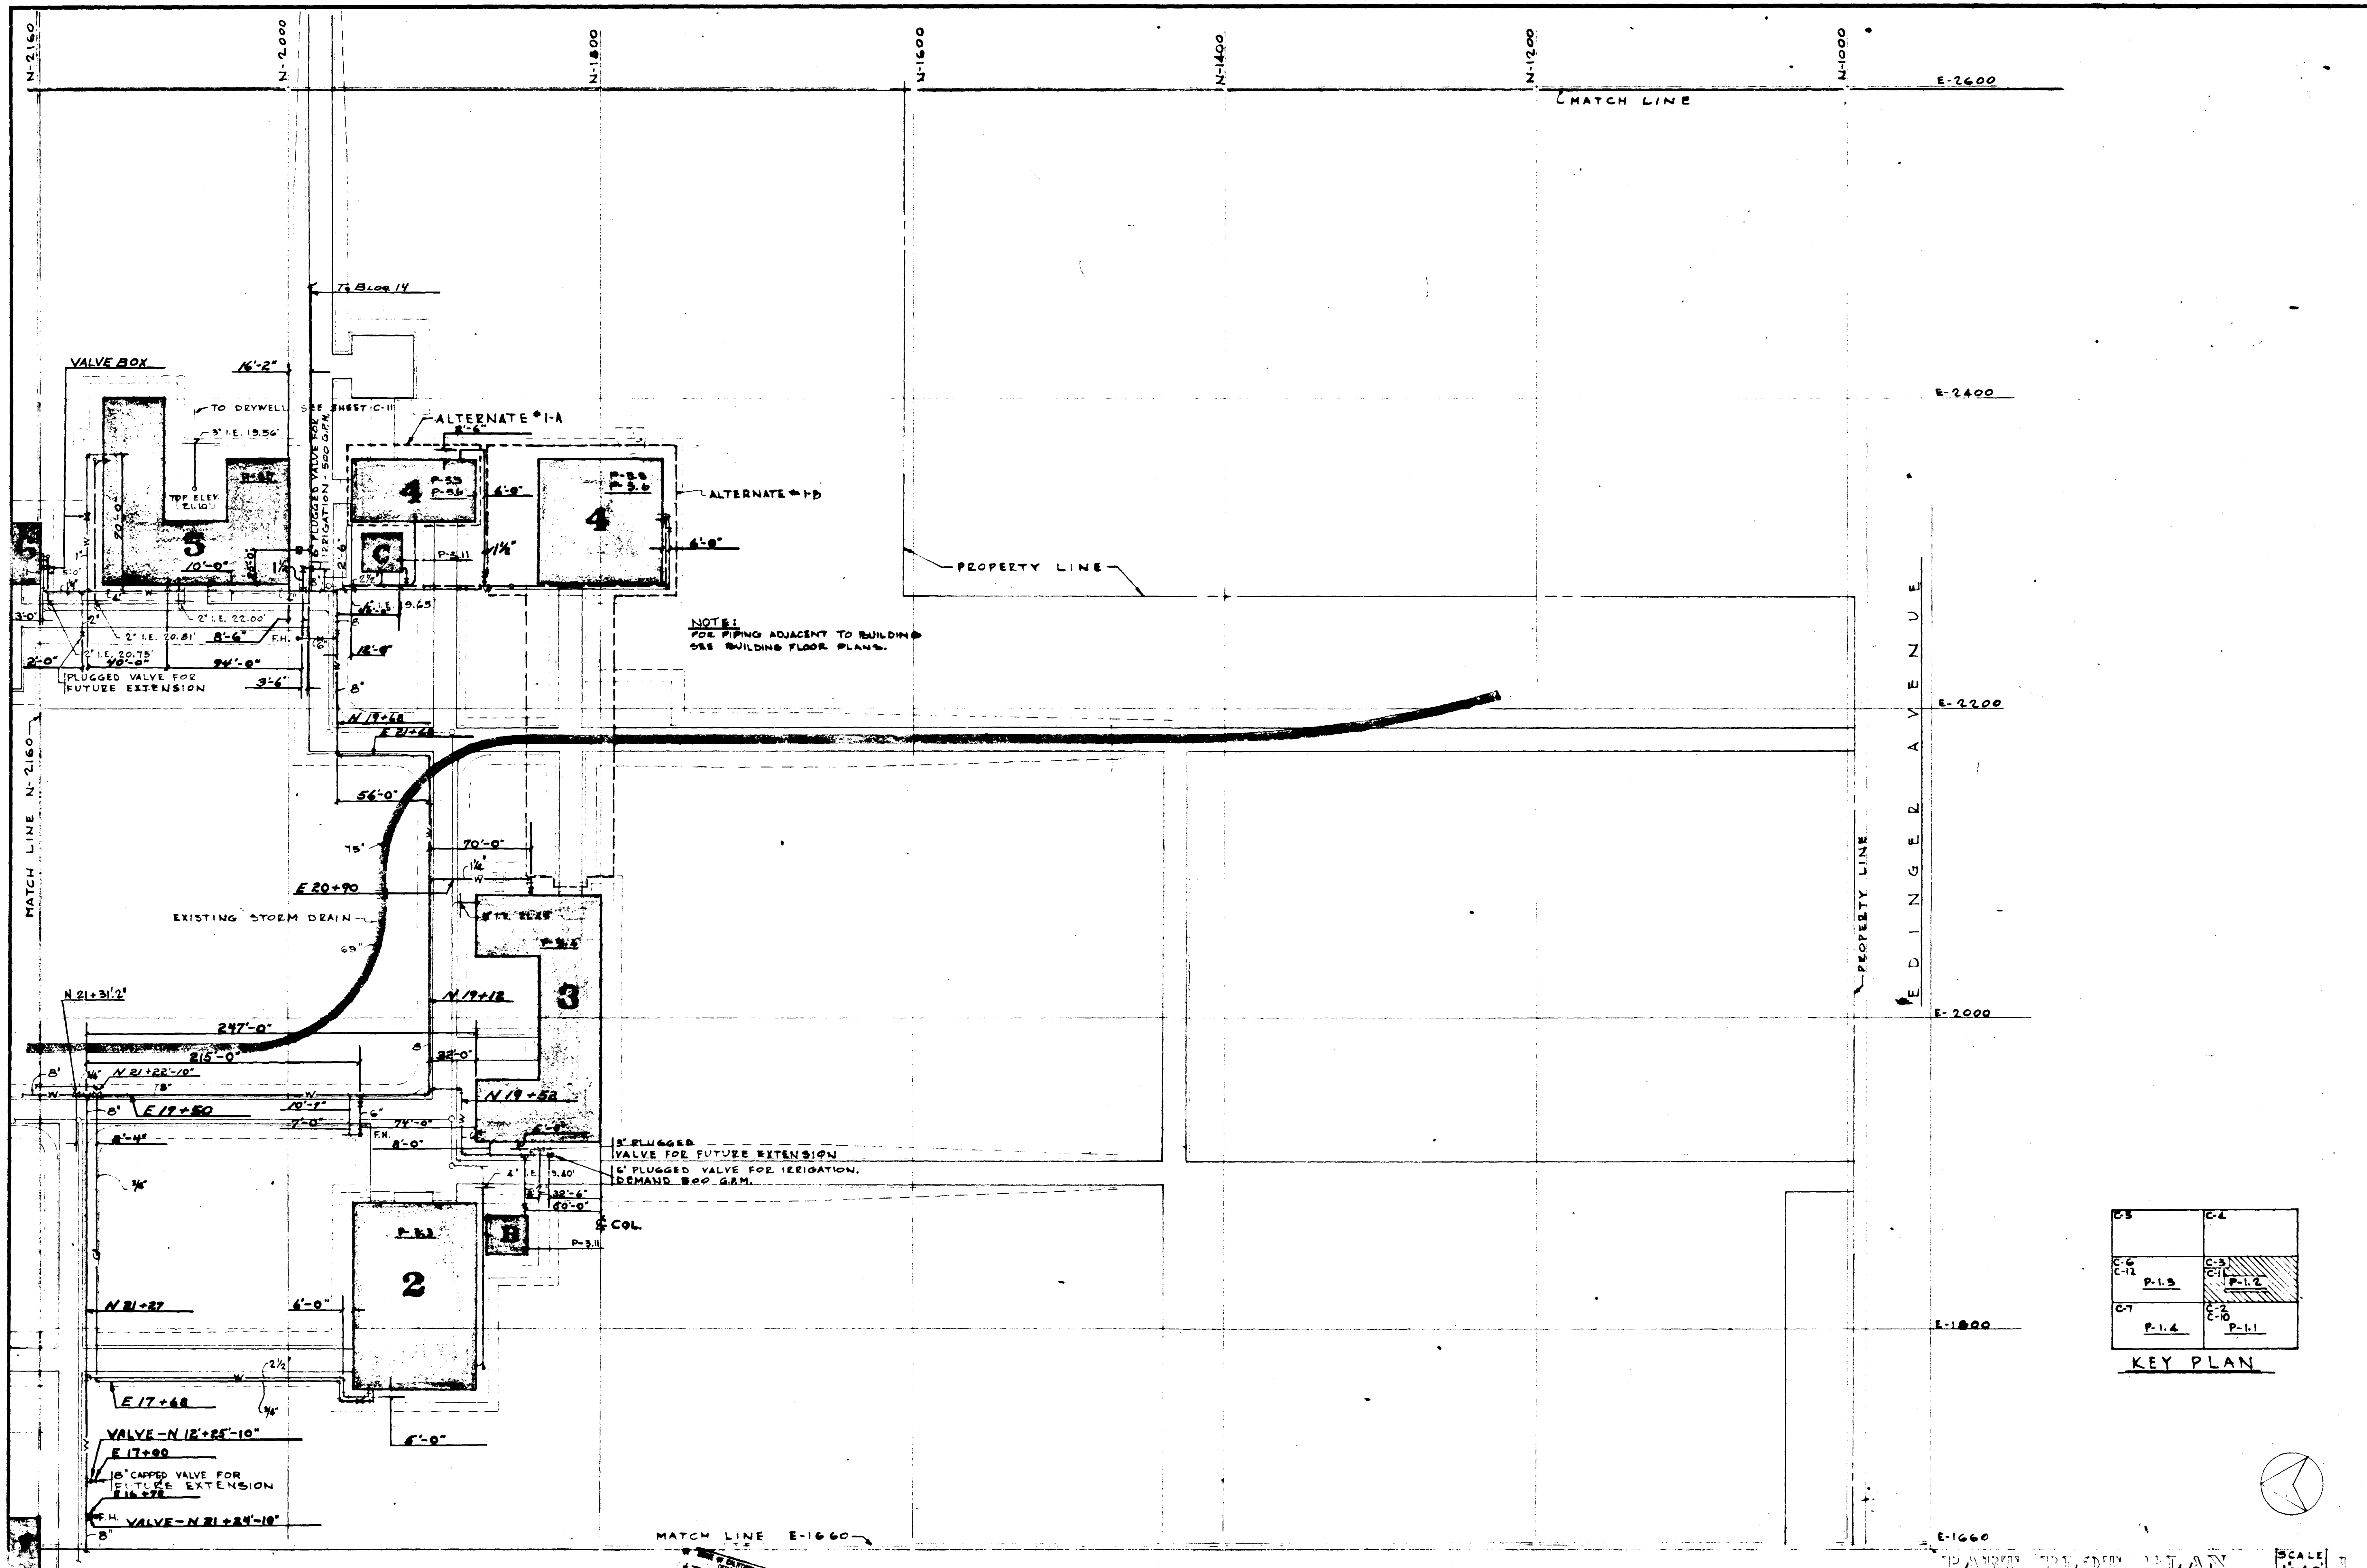
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SCALE	1
1/8"	

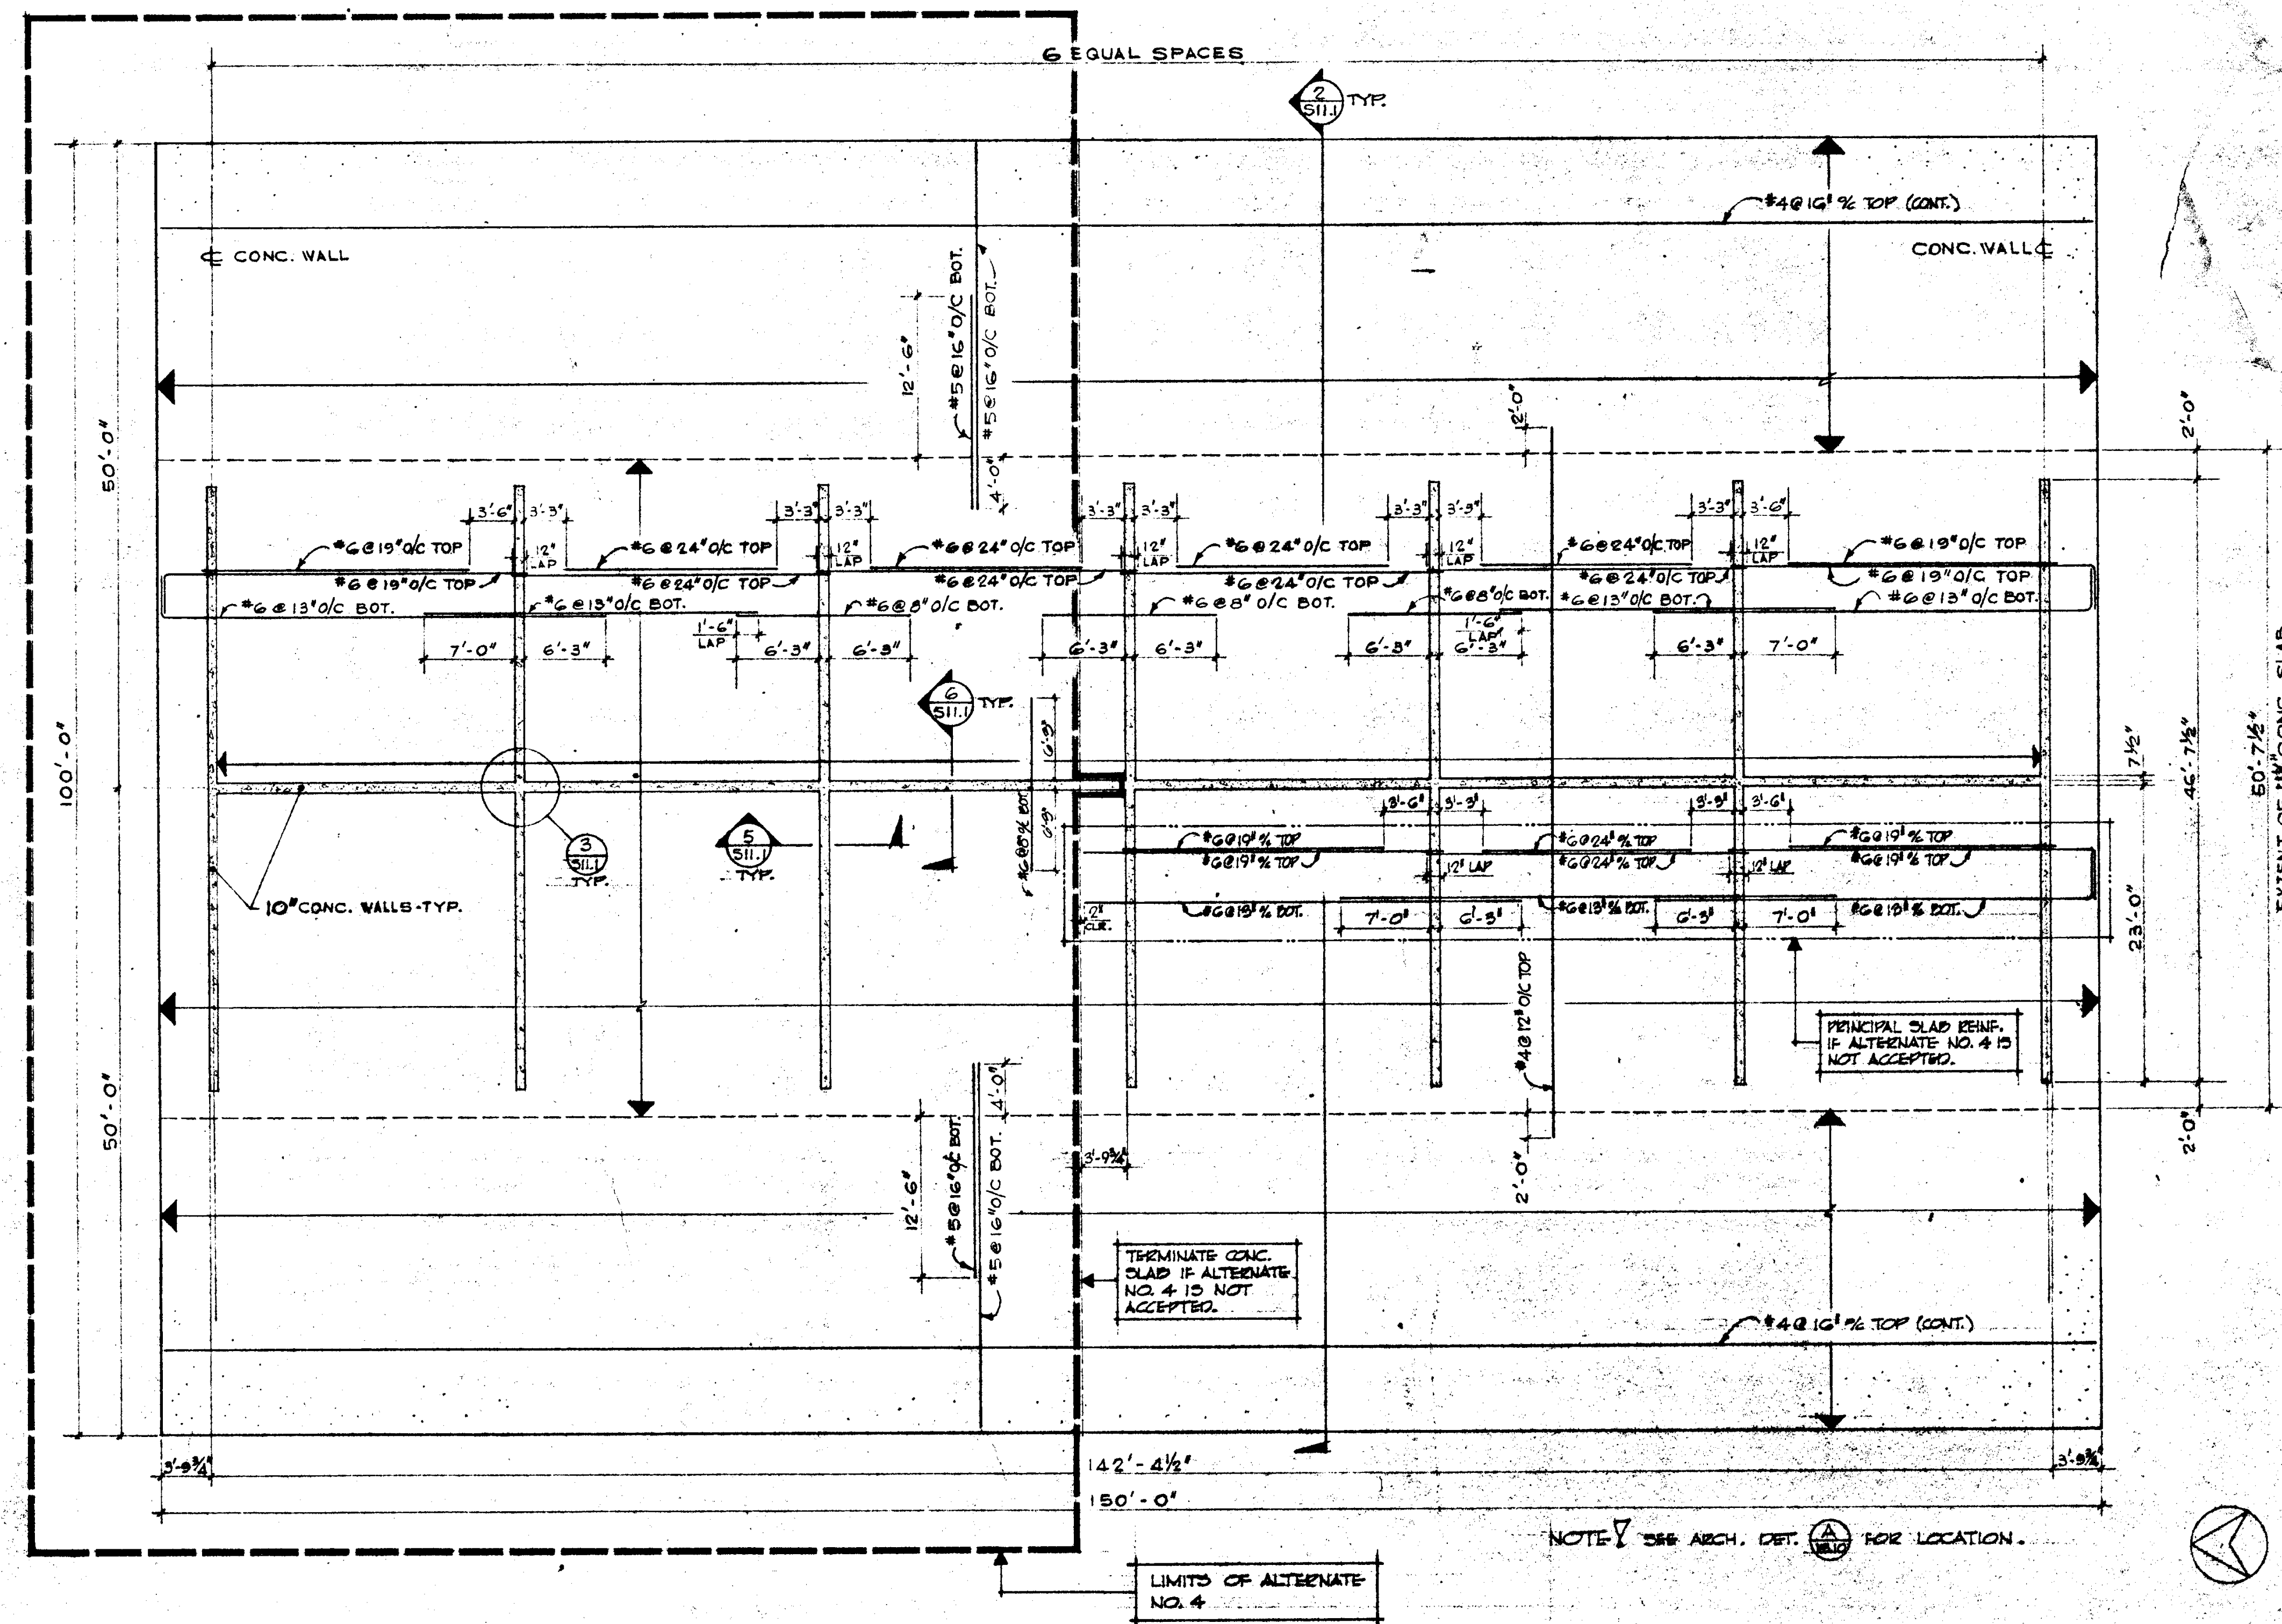
PLANNING SECTIONS & DETAILS	JOB NO. 104
	DATE 16 JUN 1965
	SHEET NO. 511.





STRUCTURAL ENGINEERS BEANOW & JOHNSON J.A. BEANOW & ASSOCIATES RALPH E. PHILLIPS, INC. RALPH E. PHILLIPS, INC. CIVIL ENGINEERS G. SHURMAN & ASSOCIATES MOFFATT & NICOL		DESIGNED BY L. J. E. DRAWN BY L. J. E. CHECKED BY L. J. E.	ARCHITECT WILLIAM L. PEREIRA & ASSOCIATES A. QUINCY JONES, FREDERICK E. EMMONS & ASSOCIATES BLUROCK ELLERBROEK & ASSOCIATES	APPROVED JUN 21 1966 STATE FIRE MARSHAL STATE OF CALIFORNIA DATE JUN 21 1966	ASSOCIATED ARCHITECTS: WILLIAM L. PEREIRA & ASSOCIATES A. QUINCY JONES, FREDERICK E. EMMONS & ASSOCIATES BLUROCK ELLERBROEK & ASSOCIATES URBANUS SQUARE • MACARTHUR BOULEVARD AT FORD ROAD TELEPHONE 714/675-2640 • CORONA DEL MAR, CALIFORNIA	GOLDEN WEST COLLEGE HUNTINGTON BEACH, CALIFORNIA ORANGE COAST JUNIOR COLLEGE DISTRICT	PART PLOT PLAN UTILITIES PLOT PLAN	SCALE 1" = 40' 1 DATE 6-15-65 SHEET NO. P-1.1
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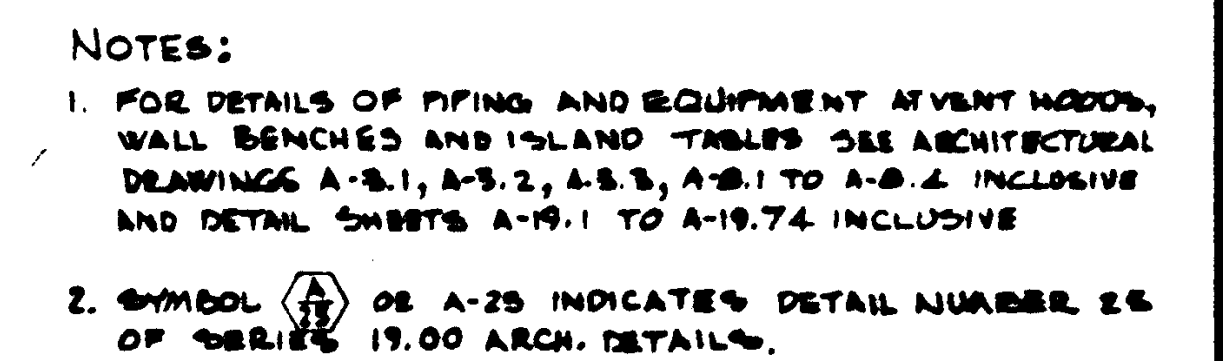
REVISIONS 1 2 3 100	STRUCTURAL ENGINEERS BRADY & JOHNSON J.A. MARTIN & ASSOCIATES MECHANICAL ENGINEERS RALPH E. PHILLIPS, INC. ELECTRICAL ENGINEERS RALPH E. PHILLIPS, INC. CIVIL ENGINEERS G. SHUURMAN & ASSOCIATES MOFFATT & NICHOL	DESIGNED [Signature] DRAWN BY [Signature] CHECKED BY [Signature]	ARCHITECT [Signature] ENGINEER [Signature] COLL. [Signature]	APPROVED [Signature] JUN 21 1968 JUN 21 1968	ASSOCIATED ARCHITECTS: WILLIAM L. PEREIRA & ASSOCIATES A. QUINCY JONES-FREDERICK E. HEMMONS & ASSOCIATES BLUROCK ELLERBROOK & ASSOCIATES URBANUS SQUARE • MACARTHUR BOULEVARD AT FORD ROAD TELEPHONE 714/675-2640 • CORONA DEL MAR, CALIFORNIA	GOLDEN WEST COLLEGE HUNTINGTON BEACH, CALIFORNIA ORANGE COAST JUNIOR COLLEGE DISTRICT	UTILITIES SECTION PLAN SCALE 1"=40' DATE 6-15-68 SHEET NO. P-1.1
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* PLUMBING FIXTURE SCHEDULE *									
FIXTURE	ADMT.	P.N.O.	SPRV.	V	CW	HW	REMARKS		
WATER CLOSET	WC	P1	2"	1/2"	1/2"	-	WALL HUNG - FL. VA. INTEG. TRAP		
WATER CLOSET	WC	P2	2"	1/2"	1/2"	-	WALL HUNG - FL. TANK. INTEG. TRAP.		
URINAL	UR	P3	1"	1/2"	1"	-	WALL HUNG - FL. VA. INTEG. TRAP		
LAVATORY	LAV	P4	2"	1/2"	1/2"	1/2"	24"x18" - 2"ADJ. TRAP STD.		
LAVATORY	LAV	P5	2"	1/2"	1/2"	1/2"	C.T. 1/2" PT.		
SERVICE SINK	S.S	P6	2"	1/2"	1/2"	1/2"	24"x18" - 2"ADJ. TRAP STD.		
ELECT. DRNG-FIN. EDF	EDF	P7	2"	1/2"	1/2"	1/2"	24"x18" - 2"ADJ. TRAP STD. PAR. COOLED - YEM. 116V. 60HZ.		
SINK	S	P8	2"	1/2"	1/2"	1/2"	C.T. 24"x21"		
SINK	S	P9	1"	1/2"	1/2"	1/2"	2-COMPT. 32"x21" C.T.		
SINK	S	P10	2"	1/2"	1/2"	1/2"	24"x18"		
SINK	S	P11	2"	1/2"	1/2"	1/2"	30"x20" - C.T. W/ GN. SPOUT		
SINK	S	P12	2"	1/2"	1/2"	1/2"	SPECIAL - W/ GN. SPOUT		
SHOWER	SH	P13	1/2"	1/2"	1/2"	1/2"	GROUP		
SHOWER	SH	P14	1/2"	1/2"	1/2"	1/2"	PRIVATE		
SHOWER	SH	P15	1/2"	1/2"	1/2"	1/2"	COACHES		
DRINKING FFR.	DF	P16	2"	1/2"	1/2"	1/2"	COMBINATION - WALL AOUT. BRNH. PRESSD		
CUSPIDOR	CUSPD	-	2"	1/2"	1/2"	1/2"	W/ INTERCONNECTING SUPPL. FR DF TO CUSPD - 1/2" PT.		
FAUCET	P17	-	1/2"	1/2"	1/2"	1/2"	SPLY. - HYDROTHERAPY - UNIT-105		
SHOWER	SH	P18	1/2"	1/2"	1/2"	1/2"	POOL		
SHOWER	SH	P19	1/2"	1/2"	1/2"	1/2"	EMERGENCY		

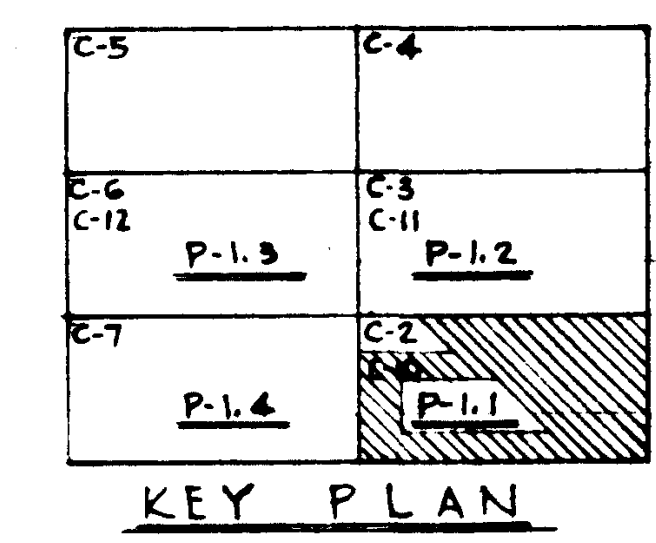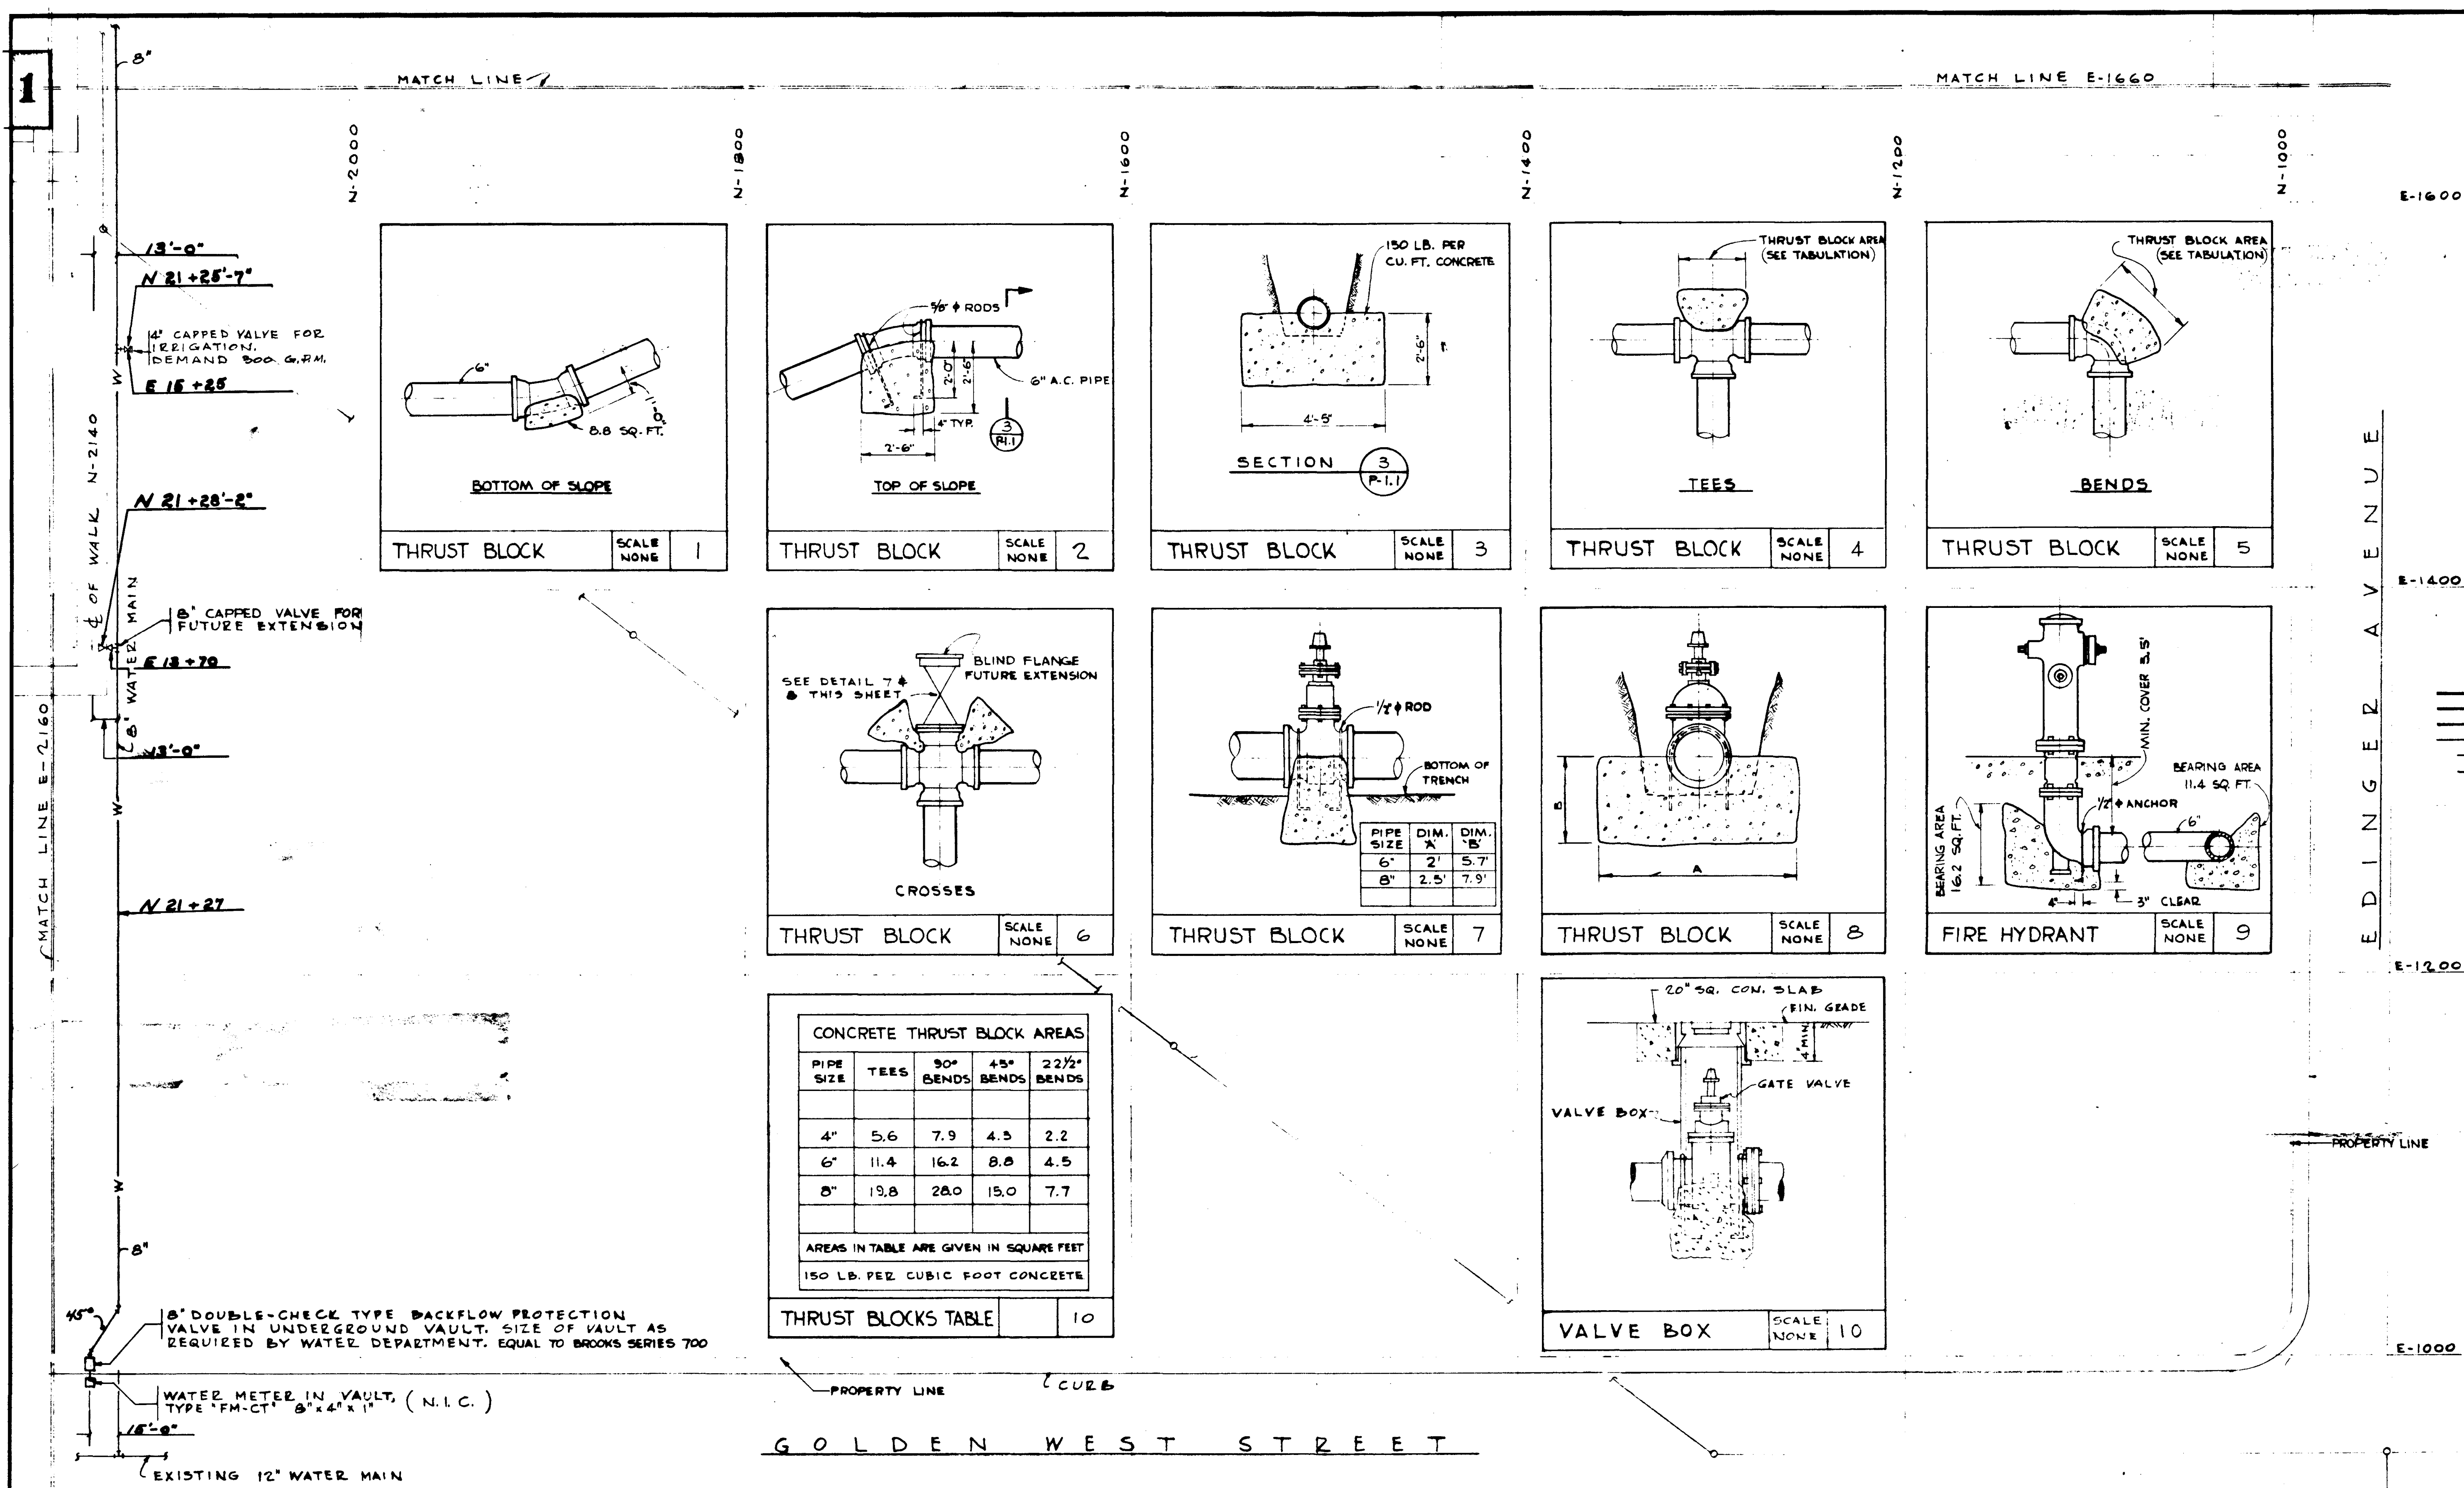

<div style="display: flex; flex-direction: column; align-items: center;"> <div style="margin-bottom: 5px;"> <div style="border: 1px solid black; padding: 2px;">17604</div> <div style="border: 1px solid black; padding: 2px;">HMA</div> <div style="border: 1px solid black; padding: 2px;">SEE ADDENDUM NO. 17-17604-4</div> </div> <div style="border: 1px solid black; padding: 2px; width: 100%;"> <div style="display: flex; justify-content: space-between;"> <div> <p>STRUCTURAL ENGINEERS BRADDOCK & JOHNSON J.A. MARTIN & ASSOCIATES</p> <p>MECHANICAL ENGINEERS RALPH E. PHILLIPS, INC.</p> <p>ELECTRICAL ENGINEERS RALPH E. PHILLIPS, INC.</p> <p>CIVIL ENGINEERS G. SHUURMAN & ASSOCIATES MORTIMER & ASSOCIATES</p> </div> <div> <p>DESIGNED</p> <p>DRAWN BY</p> <p>CHECKED BY</p> </div> <div> <p>ARCHITECT WILLIAM L. PEREIRA</p> <p>ENGINEER STATE OF CALIFORNIA DATE 1/1/65</p> </div> </div> </div> </div>	<div style="display: flex; justify-content: space-between;"> <div> <p>APPROVED</p> <p>STATE FIRE MARSHAL STATE OF CALIFORNIA DATE 1/1/65</p> </div> <div> <p>APPROVED</p> <p>STATE FIRE MARSHAL STATE OF CALIFORNIA DATE 1/1/65</p> </div> </div>	<p>ASSOCIATED ARCHITECTS:</p> <p>WILLIAM L. PEREIRA & ASSOCIATES</p> <p>A. GUINCY JONES, FREDERICK R. HENRICH & ASSOCIATES</p> <p>BLUROCK HILBROOK & ASSOCIATES</p>	<p>URBAN SQUARE • MACARTHUR BOULEVARD AT FORD ROAD</p> <p>TELEPHONE 714/678-2840 • CORONA DEL MAR, CALIFORNIA</p>	<p>GOLDEN WEST COLLEGE</p> <p>HUNTINGTON BEACH, CALIFORNIA</p> <p>ORANGE COAST JUNIOR COLLEGE DISTRICT</p>	<div style="display: flex; justify-content: space-between;"> <div> <p>PLUMBING</p> <p>MECHANICALS</p> </div> <div> <p>JOB NO. 104</p> <p>DATE 6-15-65</p> <p>SHEET NO. P. 2.1</p> </div> </div>
	<p>REVISIONS</p>				

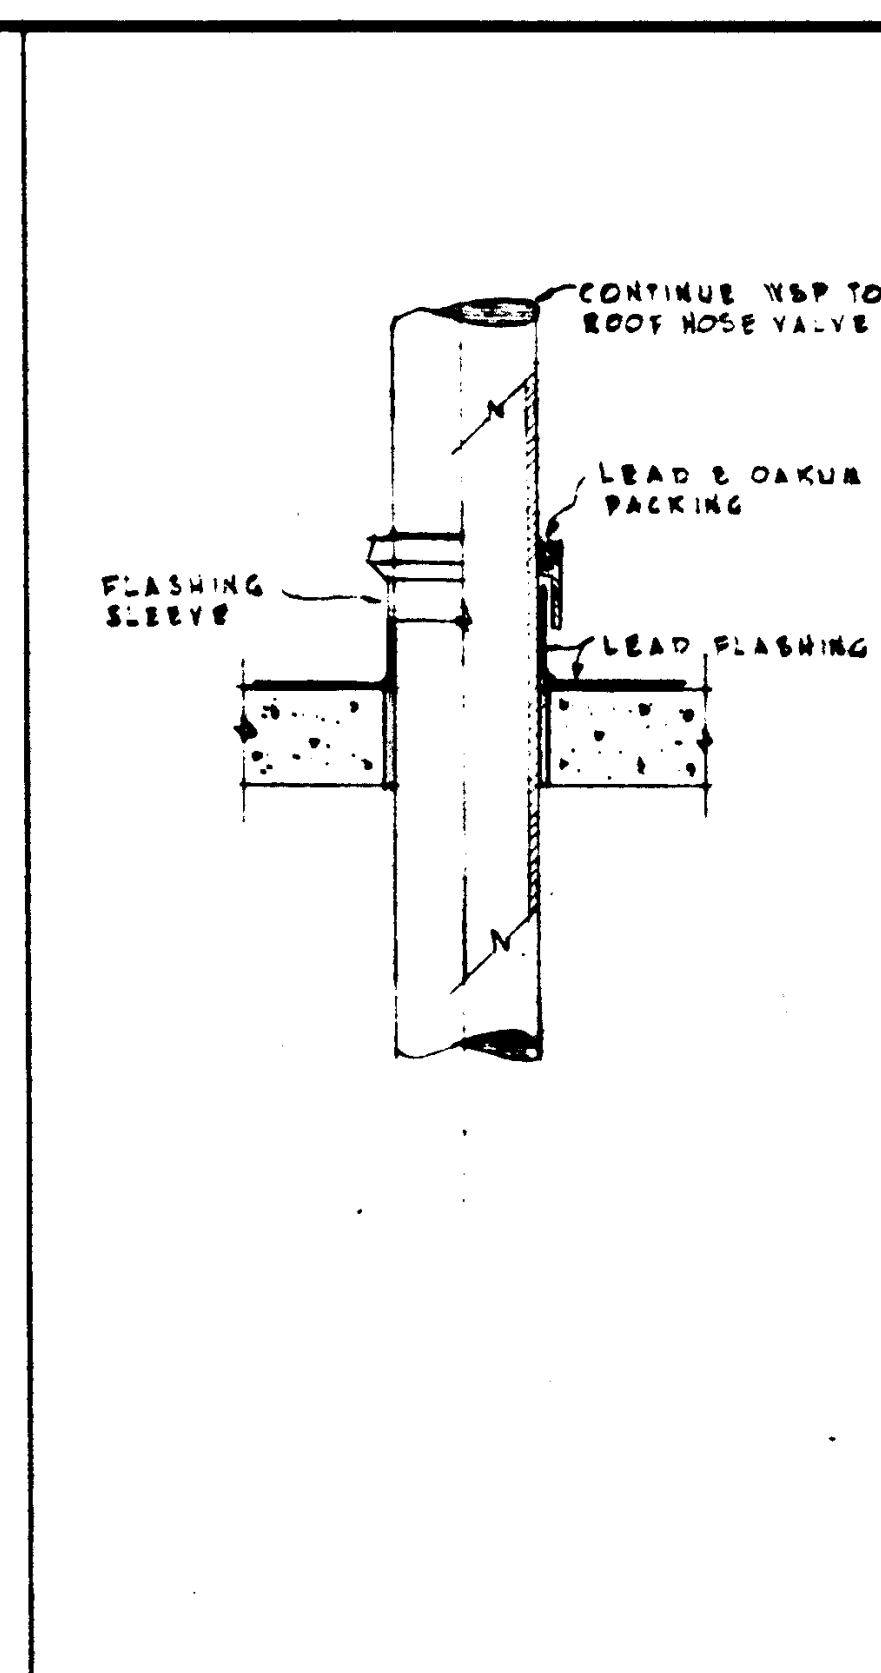

1. DEMONSTRATION TABLES:
 - (a). ON SECOND FLOOR TRAP SHALL BE 1 1/2" SIZE CAST BRASS NON-SYPHON "P" TRAP WITH NUMBER 17 GAUGE TUBING, CHROME PLATED FINISH, WITH CONNECTIONS TO 2" PIPE THRU FLOOR.
 - (b). ON FIRST FLOOR NUMBER 17 GAUGE C.P. TUBING SHALL CONNECT TO 2" CAST IRON "P" TRAP UNDER FLOOR.
2. WALL BENCHES:

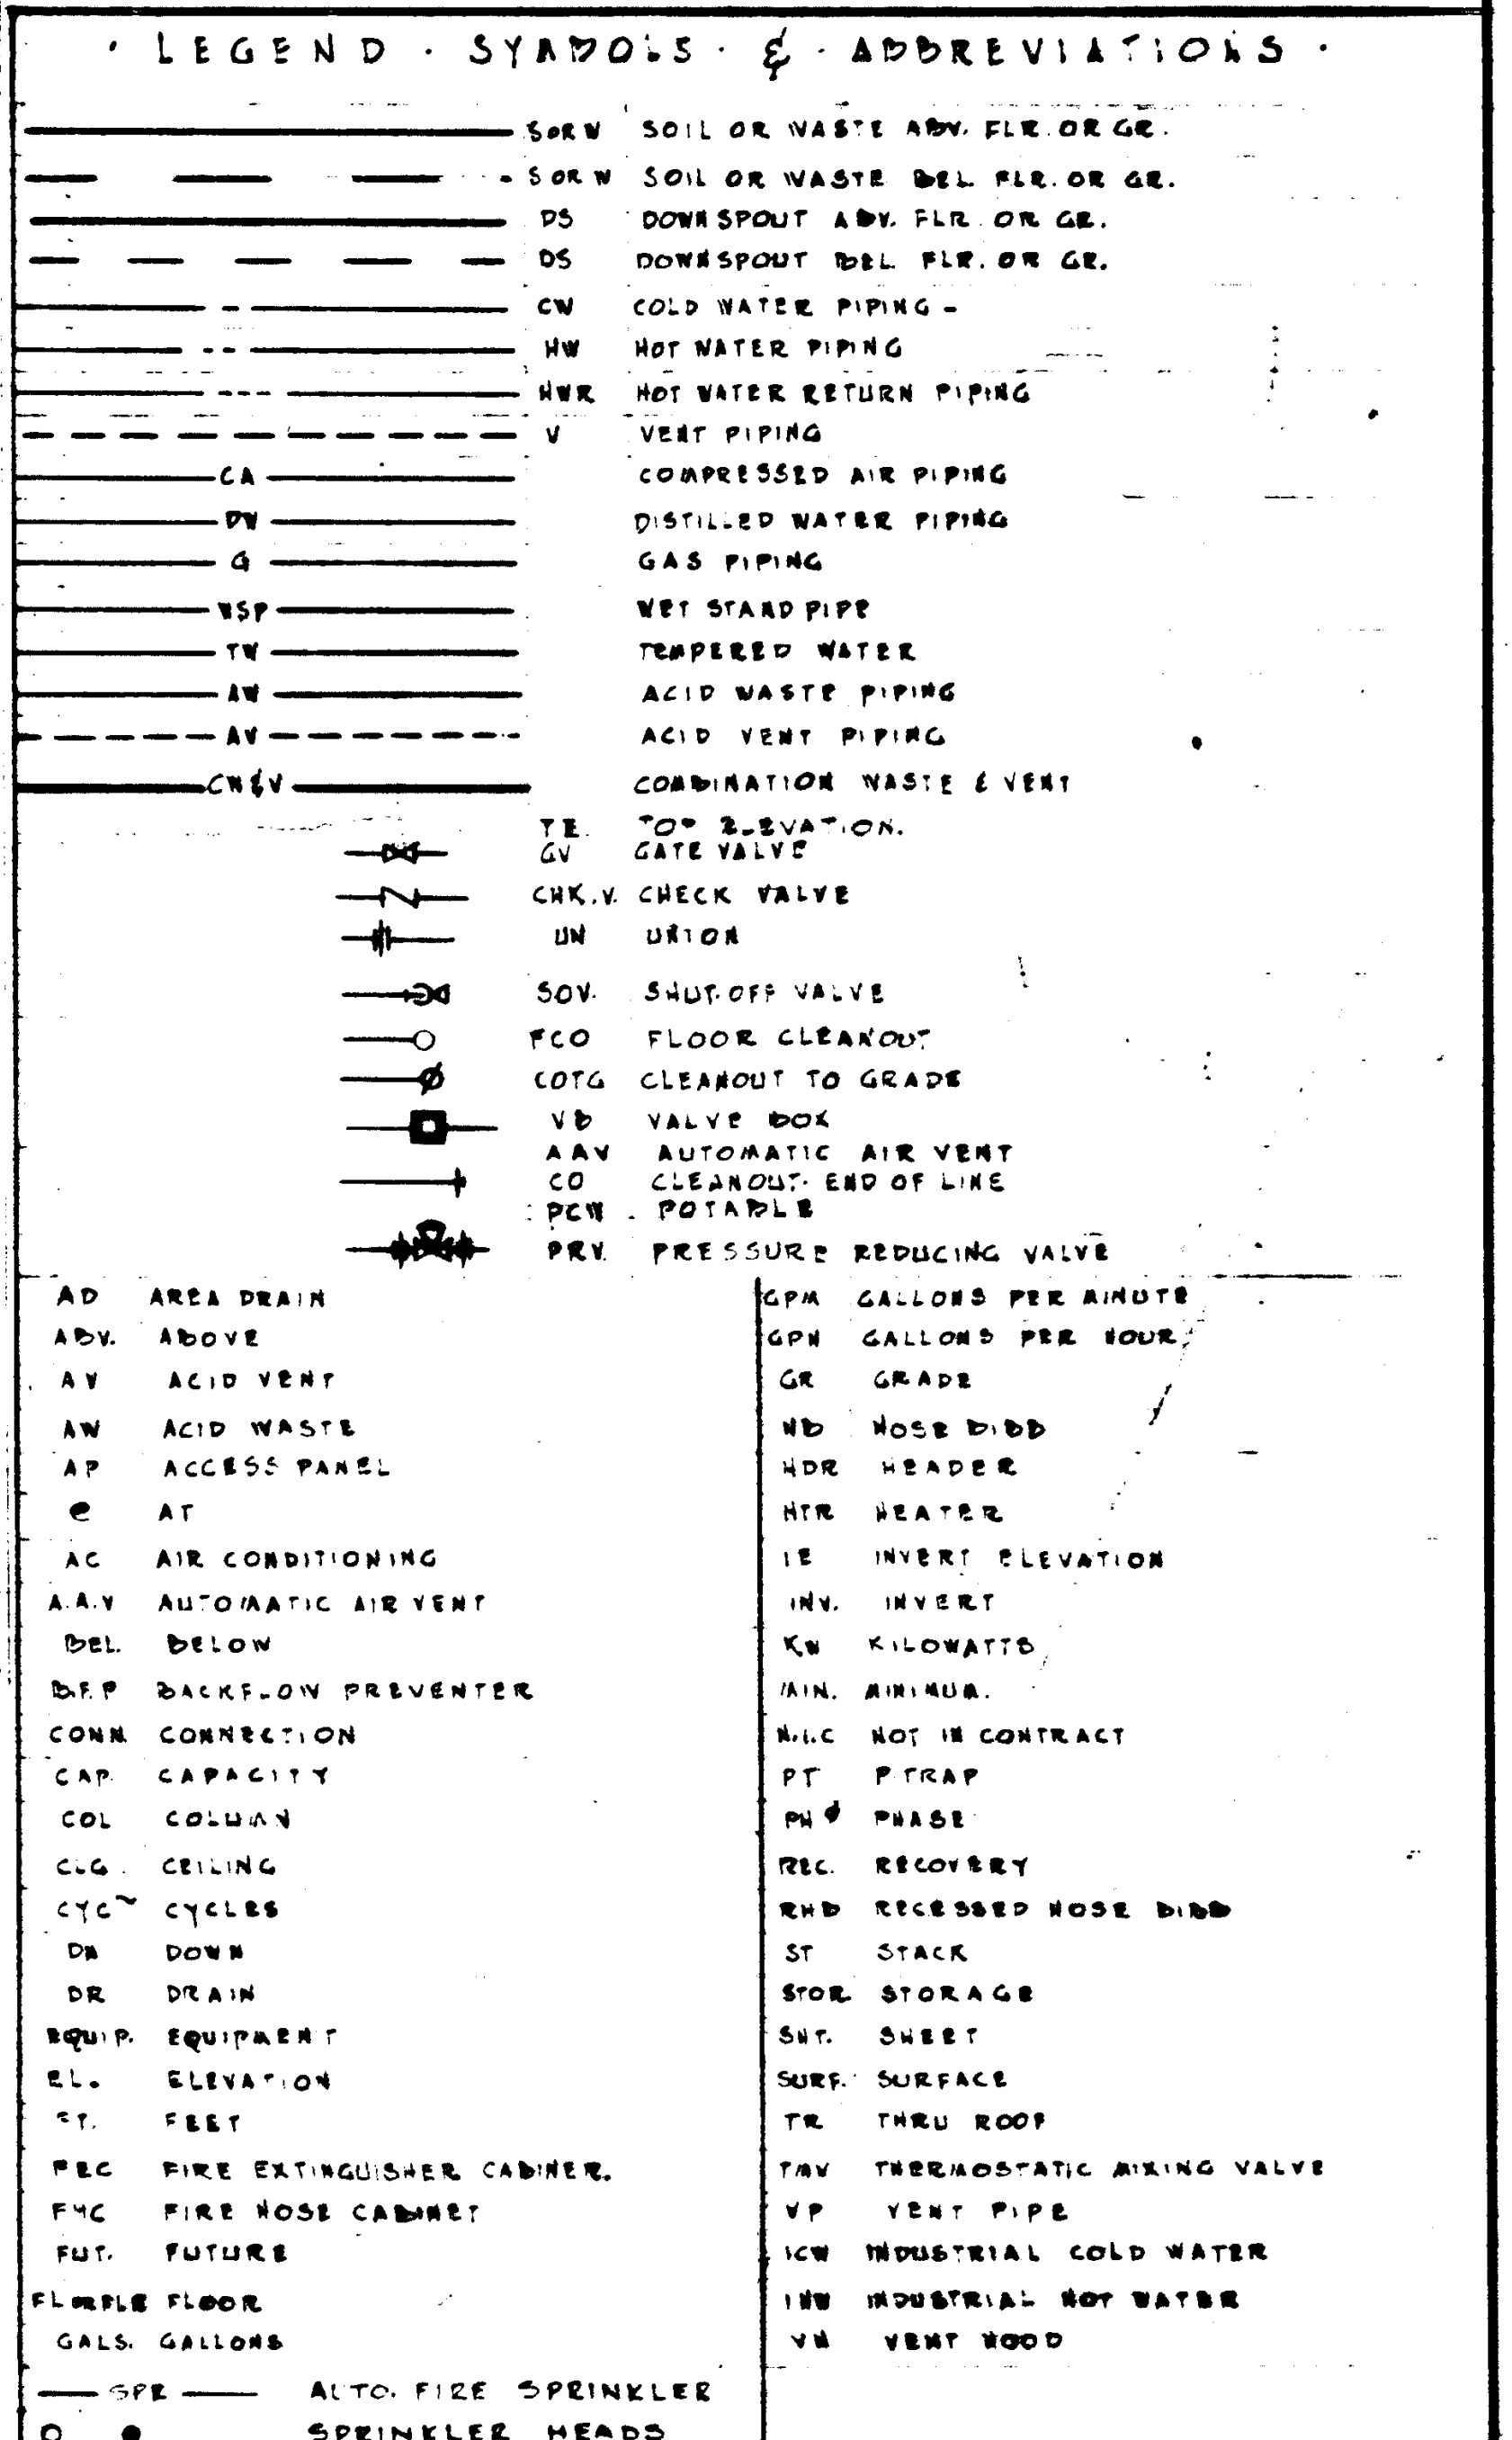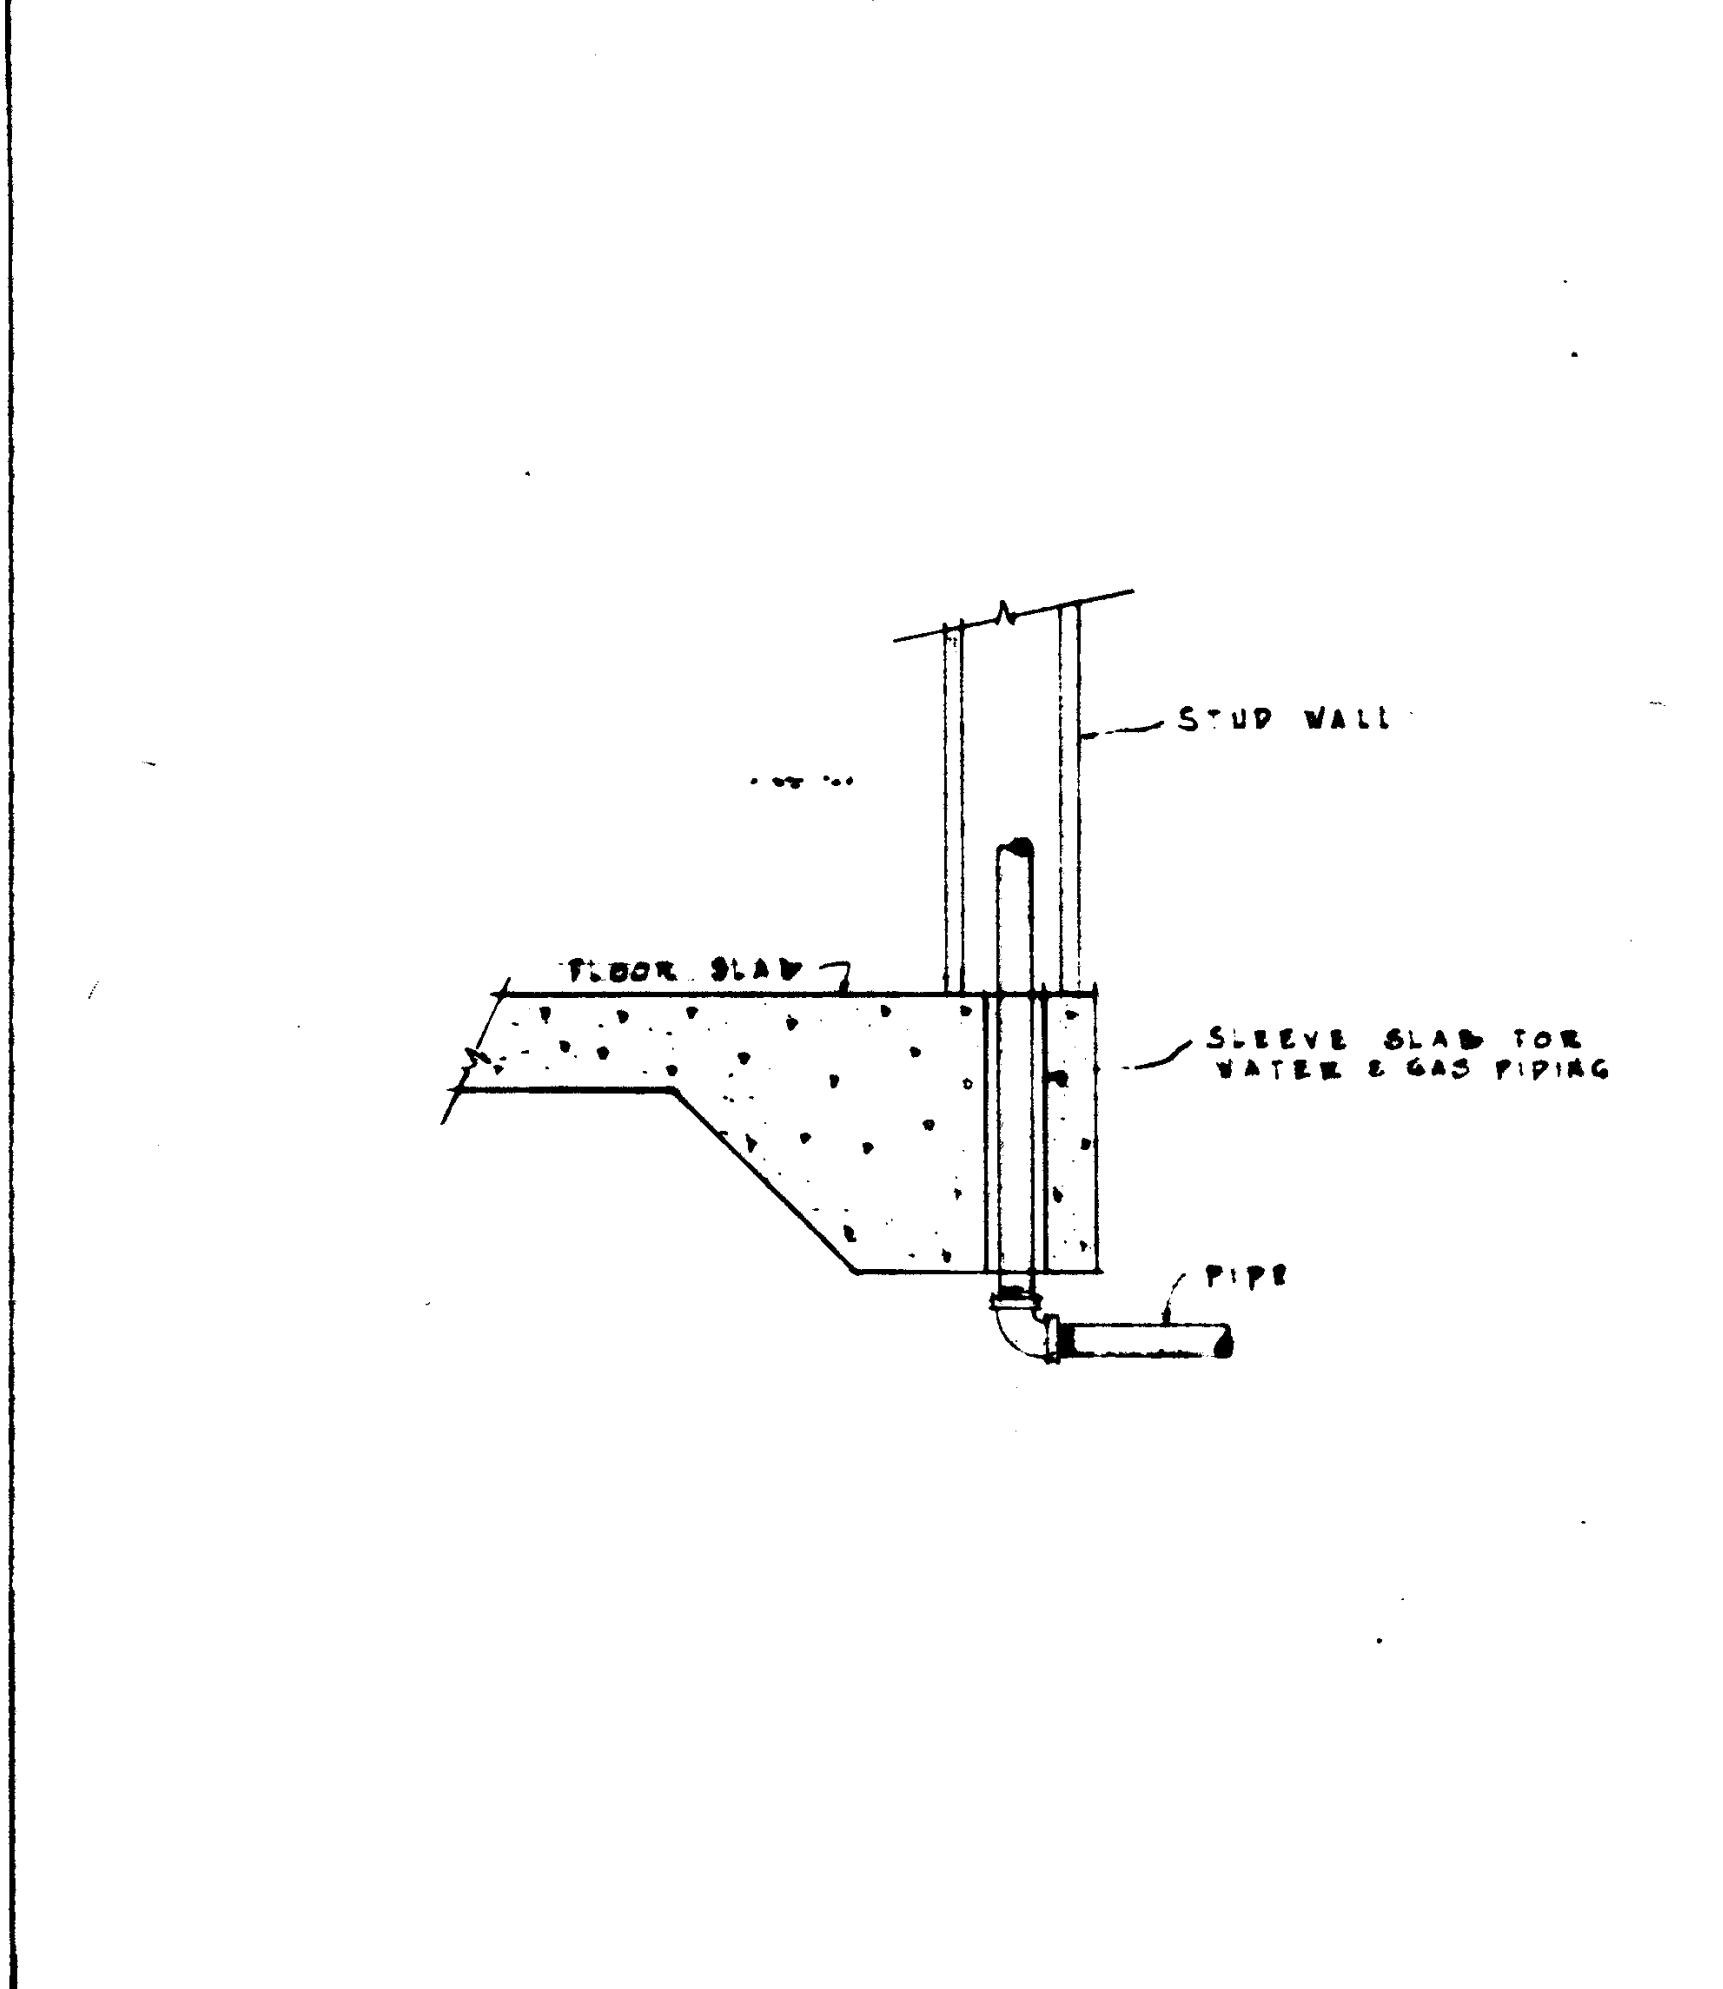SINKS IN WALL BENCHES SHALL HAVE 1 1/2" SIZE LA. PATTEEN CAST BRASS "P" TRAP WITH 1/2" BRASS NIPPLE TO WALL AND WALL FLANGE. ALL CHROME PLATED FINISH. TRAP FOR A-20 SHALL BE 6" 2" SIZE. TRAP FOR SINKS ON EAST WALL OF ROOM #210 SHALL BE 1 1/2" SIZE ACID RESISTANT "P" TRAP.
3. VENT HOODS:
 - (a). ON SECOND FLOOR TRAP SHALL BE 1 1/2" SIZE ACID RESISTING CAST IRON NON-SYPHON "P" TRAP WITH CONNECTION TO 2" ACID WASTE THRU FLOOR.
 - (b). ON FIRST FLOOR SHALL BE 1 1/2" SIZE LA. PATTEEN CAST BRASS "P" TRAP WITH 1/2" BRASS NIPPLE TO WALL AND WALL FLANGE. ALL CHROME PLATED FINISH.
4. ISLAND TABLE A-25: SHALL BE 2" SIZE ACID RESISTING CAST IRON NON-SYPHON "P" TRAP WITH WASTE CONNECTION AS DETAILED ON THE DRAWINGS.
5. ISLAND TABLE A-30: SHALL BE 1 1/2" SIZE CAST BRASS NON-SYPHON "P" TRAP WITH NUMBER 17 GAUGE TUBING, C.P. FINISH, AND CONNECTION TO 2" PIPE THRU FLOOR.
6. ISLAND TABLE A-7: SINK OUTLETS SHALL CONSIST OF STRAINER THREADED INTO AN 1 1/2" SIZE "P" FLANGED 90° CAST BRASS ELBOW WITH FINE THREAD OR SOLDER TYPE 1 1/2" TUBING OUTLET. PROVIDE NO. 17 GAUGE TUBING EXTENSION AND CONNECT TWO OF SINKS THRU A CAST BRASS TWIN ELBOW TO AN 1 1/2" SIZE CAST BRASS NON-SYPHON "P" TRAP WITH NO. 17 GAUGE TUBING, ALL C.P. FINISH. CONNECT TRAP TO 2" WASTE THRU FLOOR. THE THIRD SINK SHALL BE CONNECTED IN LIKE MANNER TO A SECOND TRAP EXCEPT OMITTING TWIN WASTE ELBOW. TRAPS SHALL BE CONCEALED IN CABINET BEHIND DRAWER SECTION.

- ① UP TO P.C.O.
- ② 2" W.P. UP
- ③ 5" W.P. UP
- ④ UP TO 2" F.D.
- ⑤ 1 1/2" V.P. UP
- ⑥ 2" V.P. UP
- ⑦ COMB. WASTE & VENT
- ⑧ 5" A.W. UP
- ⑨ 1/2" C., A. & C.W. TO A-4
- ⑩ 3/4" H. & C.W. TO A-13
- ⑪ 3/4" G. TO A-11
- ⑫ 1/4" G. UP
- ⑬ 3/4" C.W. & 5/8" G. UP TO A-7
- ⑭ 1/2" C.W. & 1" G. UP
- ⑮ 1/4" C.W. & 1" G.
- ⑯ 1 1/4" GAS
- ⑰ 5" A.W. TERMINATES W/ THIS FITTING
- ⑱ 2" A.W. UP

REF #32
REINFORCED WEIGHT BELOW FITTING

1. CONSULT FINAL ARCHITECTURAL & STRUCTURAL DRAWINGS, BUILDING DIMENSIONS, LOCATION OF FIXTURES, R.H.B. AND OTHER EQUIPMENT.
2. SECURE SHOP DRAWINGS FOR LABORATORY, KITCHEN AND OTHER EQUIPMENT AND PROVIDE PIPING CONNECTIONS AS REQUIRED FOR THEIR PROPER INSTALLATION.
3. ALL R.H.B. TO BE CENTERED ON 5'-0" PLASTER MODULE

FIRST FLOOR ————— UNDER FLOOR PAVING

GOLDEN WEST COLLEGE
HUNTINGTON BEACH, CALIFORNIA
ORANGE COAST JUNIOR COLLEGE DISTRICT

GAS DEMAND
PRESENT — 1014 C.F.M.
FUTURE — 1000 C.F.M.

FOR PIPING SEE SHEET P-11.1

REDUCED PRESSURE TYPE
BACKFLOW PROTECTION VALVE
IN PRECAST CONCRETE VALVE BOX

ISLAND TABLE PIPING

- ITEM A-7: 3/4" I.C.W. & 3/4" G.A.S. SHALL RUN IN PIPE SPACE AT REAR OF TABLE TO OUTLETS.
- ITEM A-11: 3/4" G.A.S. SHALL RUN IN PIPE SPACE AT REAR OF TABLE TO OUTLETS.
- ITEM A-15: 3/4" I.C.W. & 1" C.W. SHALL RUN UNDER COUNTER TOP TO COMBINATION FAUCETS.
- ITEM A-25: 1" I.C.W. & TWO 3/4" G.A.S. LINES SHALL RUN UNDER REAGENT SHELF TO OUTLETS.

WALL BENCH PIPING LEGEND


- 1" OR 1" INDICATES 1/2" DN. TO OUTLET
- 1" OR 1" INDICATES 1/2" UP TO OUTLET

NOTES:

- FOR DETAIL OF PIPING AND EQUIPMENT AT VENT KODDS, WALL BENCHES AND ISLAND TABLES SEE ARCHITECTURAL DRAWINGS A-3.1, A-3.2, A-3.3, A-4.1 TO A-4.8 INCLUSIVE AND DETAIL SHEETS A-19.1 TO A-19.72 INCLUSIVE

LEGEND

- 1/2" A.G. CW & 2" WP UP TO A-36
- 2" V.P. UP
- 3" COMB. WASTE & VENT
- 3/4" G. FROM TRENCH TO SIX OUTLETS ON A-11 (TYP. SIX TABLES)
- 1/2" H.W. CW & 2" WP DN. & 1/2" V.P. UP
- 1/2" G.A. CW & 2" WP UP TO A-4
- 1/2" G.A. CW. DN. TO TRENCH
- 1/2" O.W. DN.
- 1/2" V.P. DN.
- 1/2" V.P. DN. & UP
- 1/2" H.W. CW & 2" AW UP & 2" AW DN.
- 1/2" D.W. UP
- 3/4" H & CW DN. TO TRENCH TO A-15
- 1/2" H & CW & 2" AW UP TO V.M.
- 2" AW. UP TO A-25
- 2" AW. UP
- 3" ACID COMB. WASTE & VENT
- 1" CW & 1" GAS UP TO A-25
- 1/2" CW & 1" GAS DN. TO TRENCH TO A-7
- 1/2" H & CW DN. TO STERILIZER
- 3/4" G. & 3/4" CW. FROM TRENCH TO (6) G. & (6) CW. OUTLET ON TABLE (TYPICAL FOR EACH OF FIVE A-7 TABLES)
- 2" WP. DN. FROM NON-WYOM "S" TRAP (TYPICAL 5-TABLES)
- 1/2" V.P. UP
- 2" UP TO F.S.
- 2" WP. DN. 1/2" V.P. UP
- 1/2" G. DN. TO TRENCH
- 3" WP. DN.
- 1/2" W.P. UP & DN., 1/2" V.P. UP, 3/4" POTABLE WATER UP & DN.
- 2" W.P. UP & DN., 1/2" H & CW UP
- 2" W.P., 1/2" H & CW DN., 1/2" V.P. UP
- 2" W.P., 1/2" CW. DN. & 1/2" V.P. UP
- 2" W.P. UP & DN. & 1/2" CW. UP
- 2" W.P. & 1/2" CW. UP
- 3/4" H & CW. DN. TO TRENCH (RUN UNDER SINK TO BOTH FAUCETS)
- 1/2" H & CW., 2" WP. DN. & 2" V.P. UP
- 3/4" D.W. DN. TO TANK
- 1/2" CW. UP TO H.B.
- 3/4" POTABLE WATER TO ICE MACHINE
- R.H.B. WITH 3/4" CW. SUPPLY
- 3/4" CW. UP
- 2" WP. DN.
- 3" ACID WASTE DN.
- 3/4" CW. UP & DN.
- 2 1/2" GATE VALVE, DRAIN, & FLOW SWITCH WITH RELAY.
- 2 1/2" SPRINKLER RISER UP
- 360° SPRINKLER HEAD IN INCINERATOR ROOM.

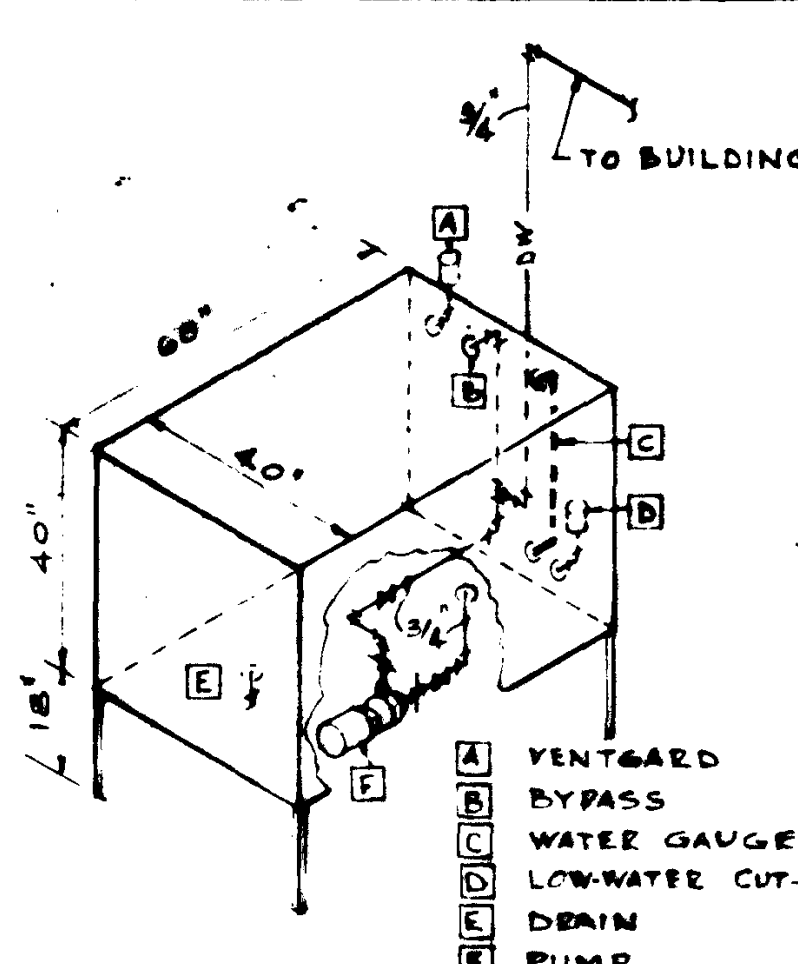

AIR COMPRESSOR, CAP. 8 SCFM.
AT 100 P.S.I., 10.8 CFM. D.P.
WITH 2 H.P., 120V., 50/60 CY
1750 R.P.M. MOTOR, 60 GAL.
200 LB. RECEIVER

DISTILLATE WATER TANK
AND PUMP


SCALE
NONE 2

REVISIONS	DATE	BY	REASON


ASSOCIATED ARCHITECTS:
WILLIAM L. FERREIRA & ASSOCIATES
A. QUINCY JONES-FREDERICK E. EMMONS & ASSOCIATES
BLURCK ELLERBROCK & ASSOCIATES
URBANUS SQUARE • MACARTHUR BOULEVARD AT FORD ROAD
TELEPHONE 714/675-2640 • CORONA DEL MAR, CALIFORNIA

GOLDEN WEST COLLEGE
HUNTINGTON BEACH, CALIFORNIA
ORANGE COAST JUNIOR COLLEGE DISTRICT


DATE	10-10-68
SHEET NO.	12-3.1
SCALE	1/8" = 1'
JOB NO.	104
DESIGNER	W. L. FERREIRA
CHECKED	W. L. FERREIRA
APPROVED	W. L. FERREIRA

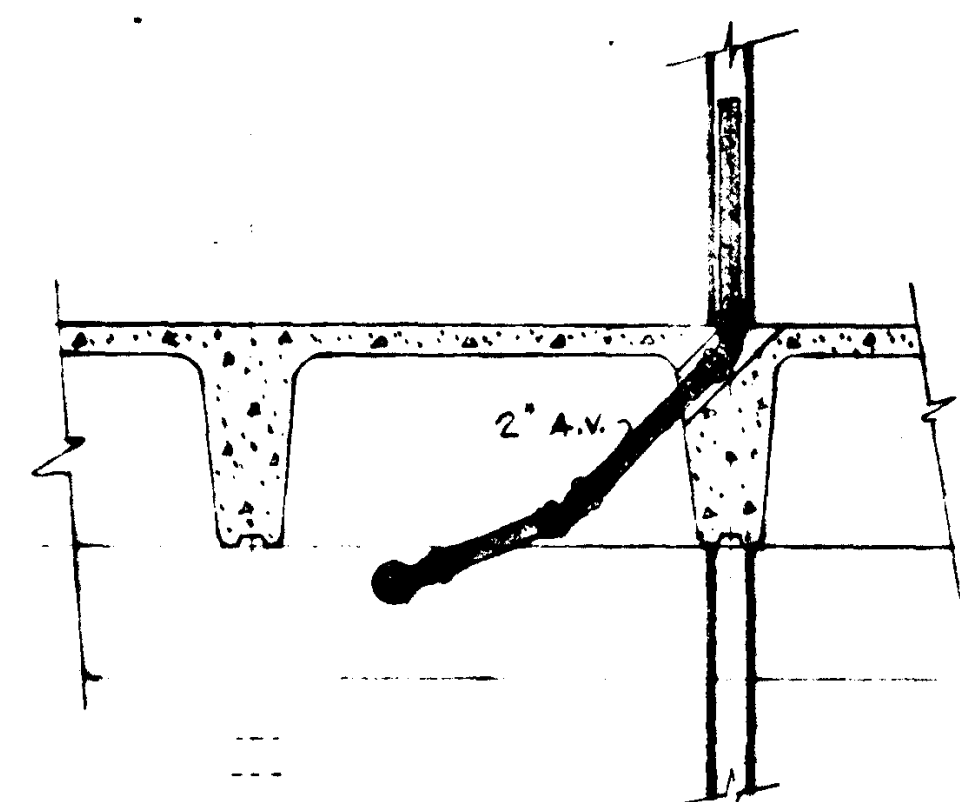


SECTION SCALE 1/8"=1'-0" 3

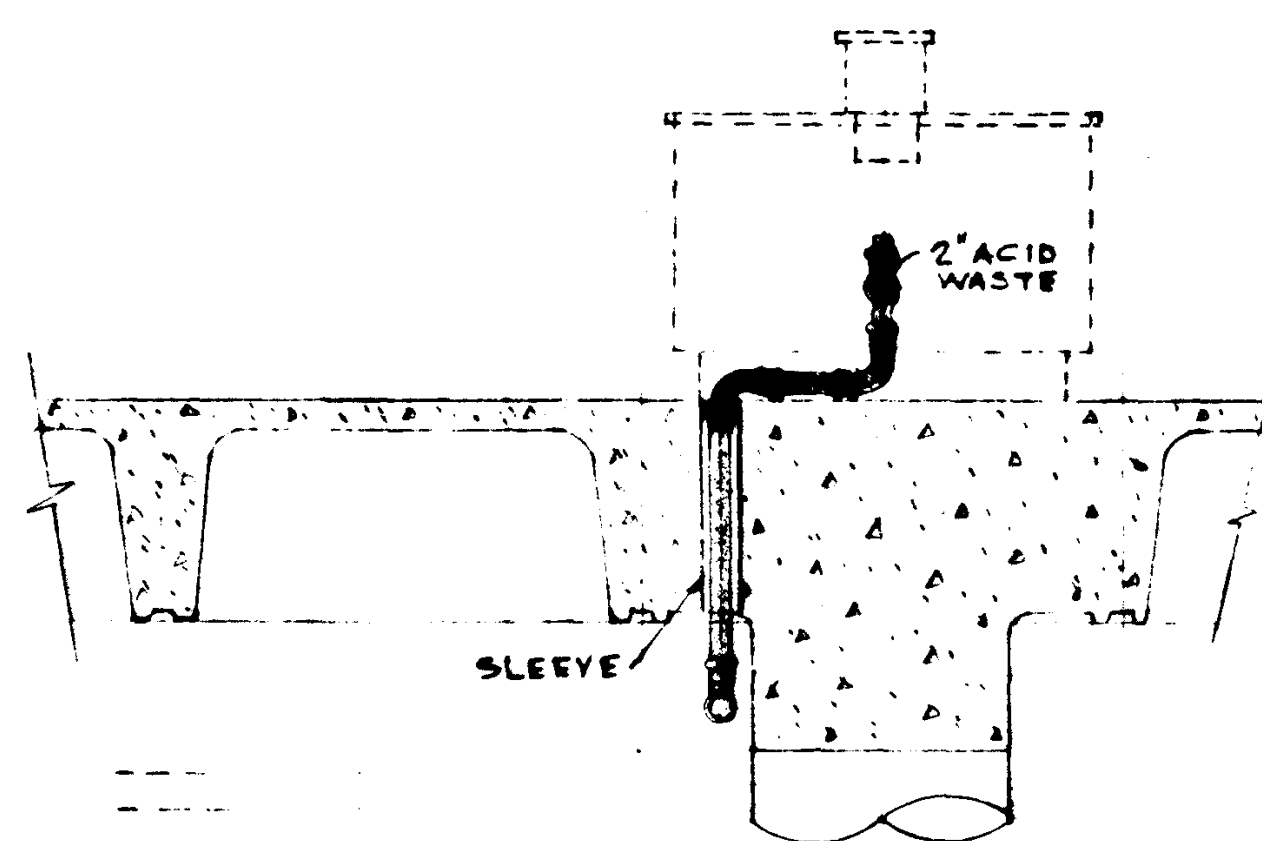


SECTION SCALE 1/8"=1'-0" 2

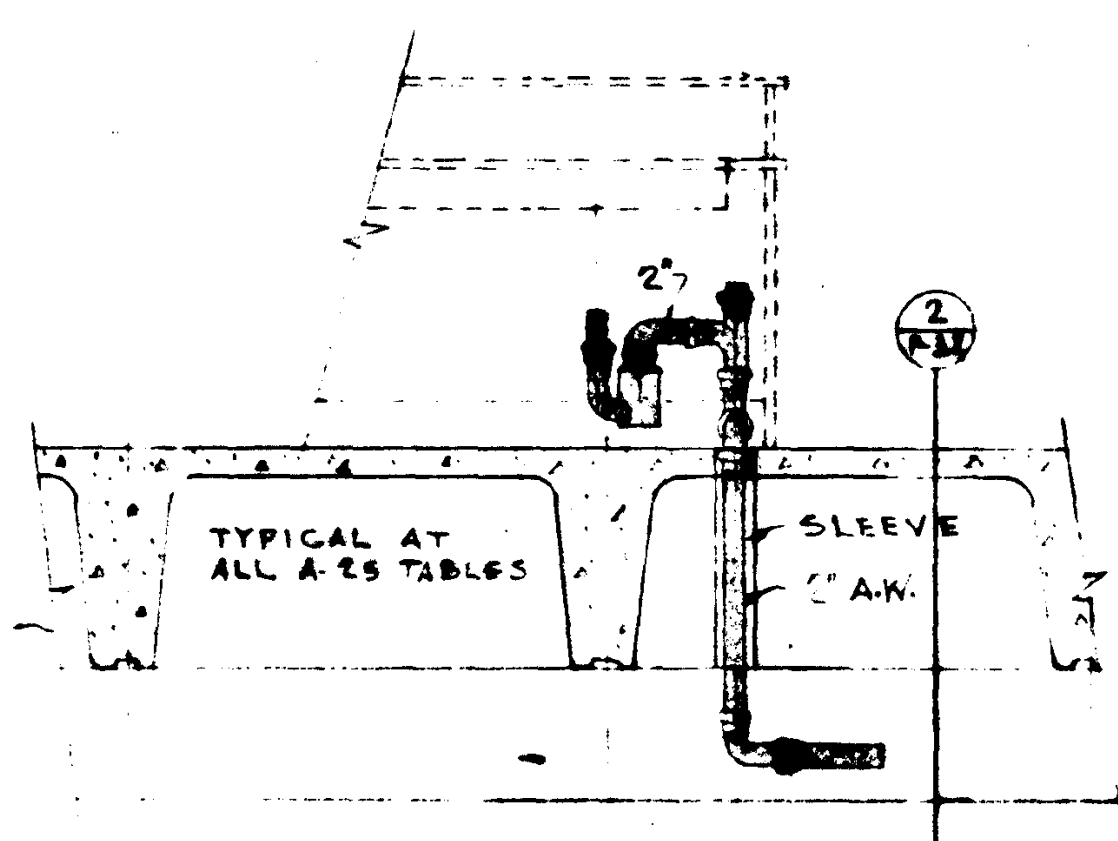


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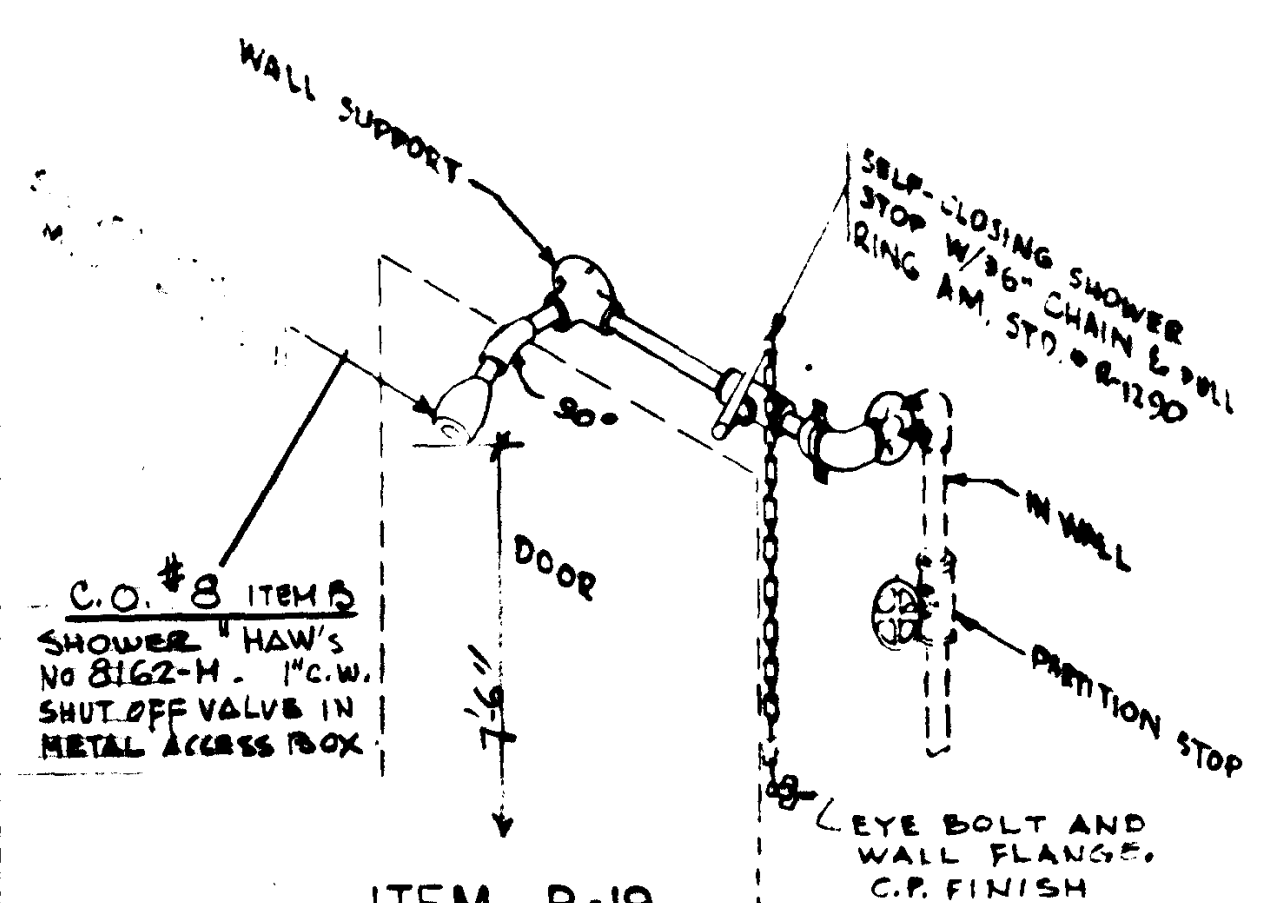
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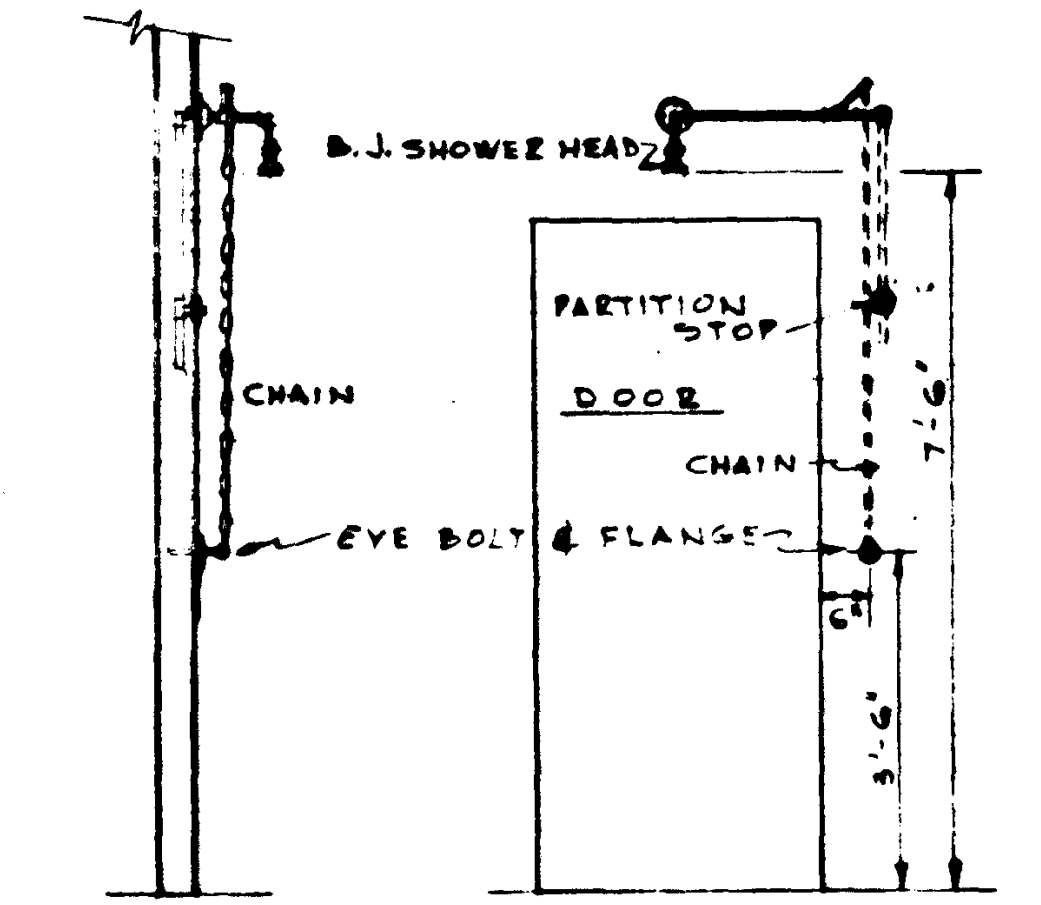
SECTION SCALE 1/8"=1'-0" 5

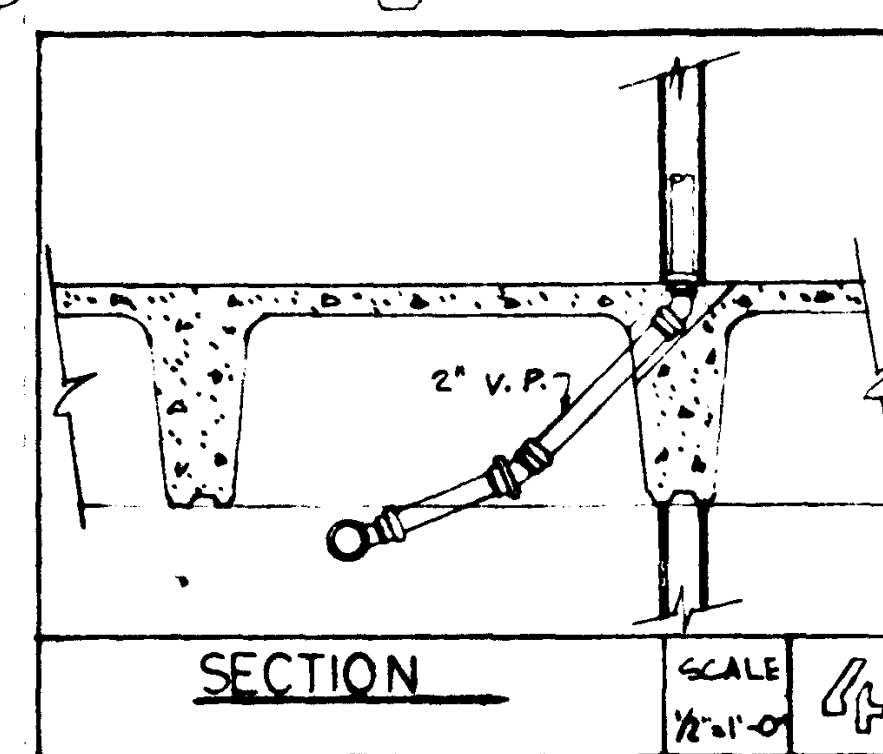


SECTION SCALE 1/8"=1'-0" 6

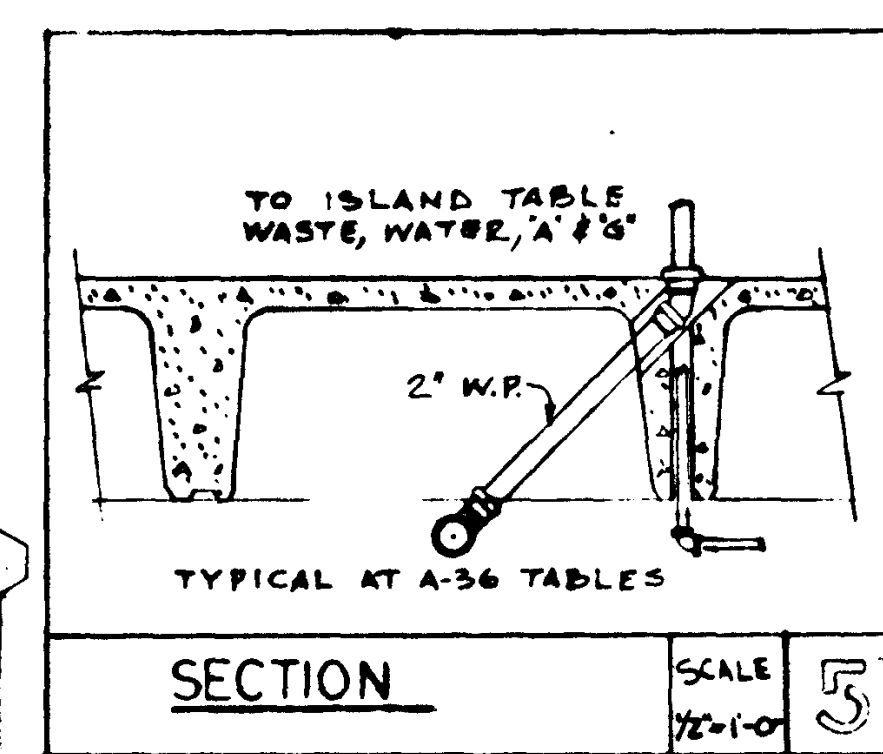

ITEM P-19 TYPICAL EMERGENCY SHOWER NO SCALE 7

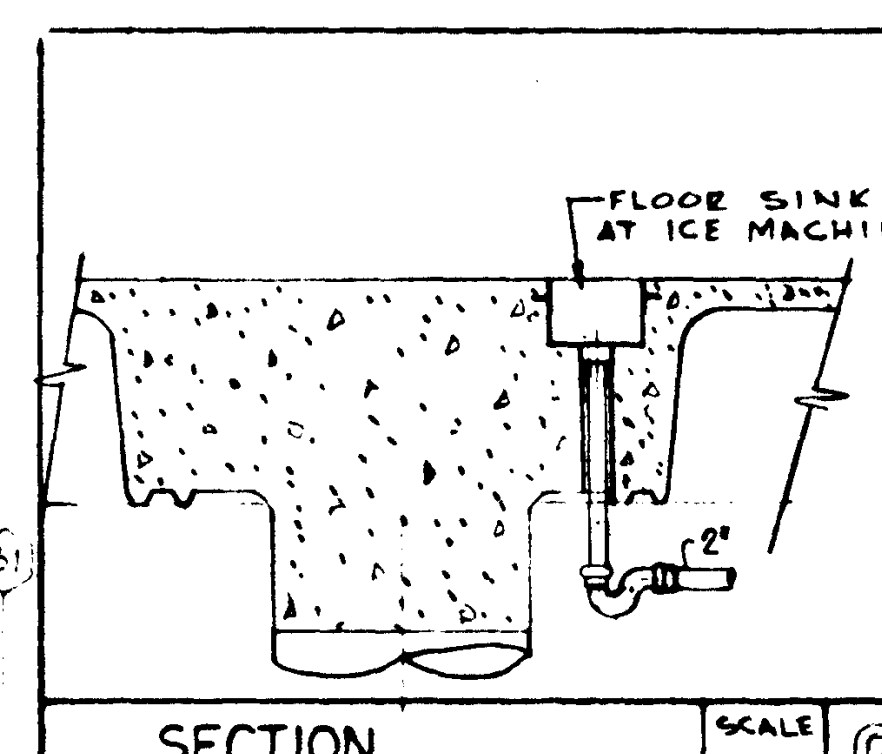

SECTION ELEVATION ITEM P-19 SHOWER EMERGENCY SHOWER SCALE NONE 8

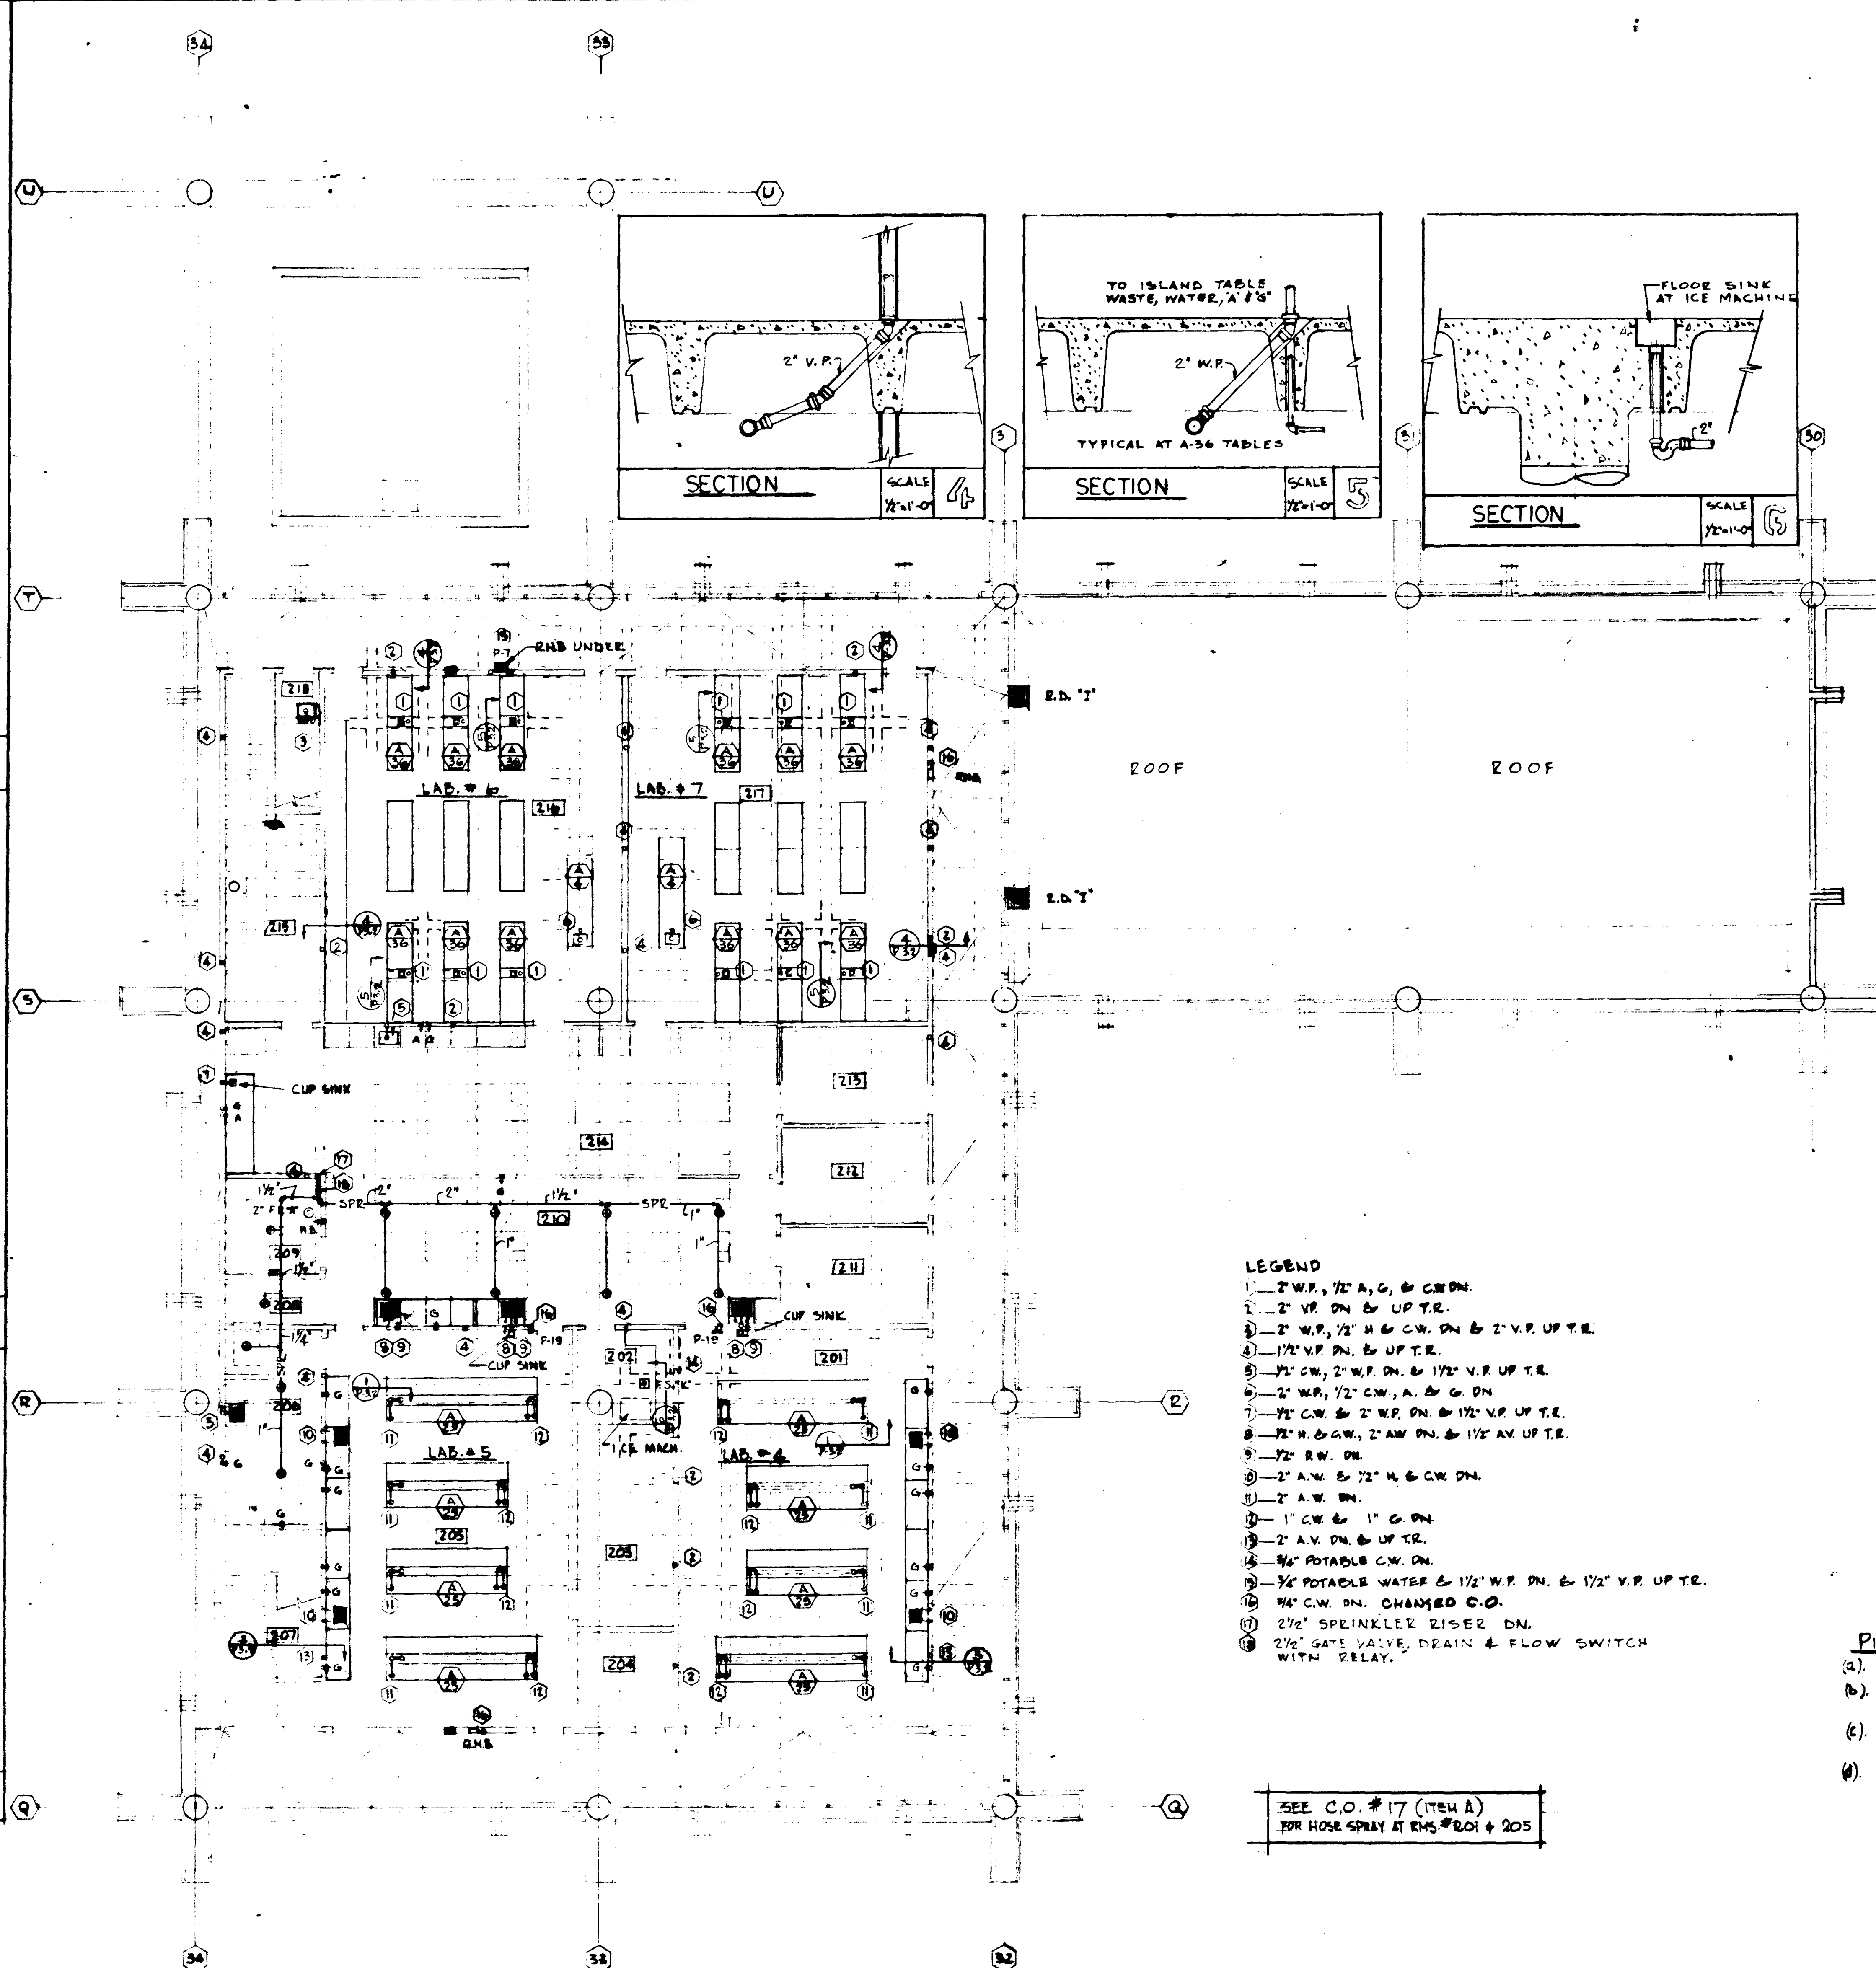

- LEGEND
- 1- 2" W.P., 1/2" A.G. & C.W. DN.
 - 2- 2" V.P. DN. & UP T.R.
 - 3- 2" W.P., 1/2" H. & C.W. DN. & 2" V.P. UP T.R.
 - 4- 1 1/2" V.P. DN. & UP T.R.
 - 5- 1/2" C.W., 2" W.P. DN. & 1 1/2" V.P. UP T.R.
 - 6- 2" W.P., 1/2" C.W., A. & G. DN.
 - 7- 1/2" C.W. & 2" W.P. DN. & 1 1/2" V.P. UP T.R.
 - 8- 1/2" H. & C.W., 2" W.P. DN. & 1 1/2" V.P. UP T.R.
 - 9- 1/2" R.W. DN.
 - 10- 2" A.W. & 1/2" H. & C.W. DN.
 - 11- 2" A.W. DN.
 - 12- 1" C.W. & 1" G. DN.
 - 13- 2" A.W. DN. & UP T.R.
 - 14- 3/4" POTABLE C.W. DN.
 - 15- 3/4" POTABLE WATER & 1 1/2" W.P. DN. & 1 1/2" V.P. UP T.R.
 - 16- 3/4" C.W. DN. CHANGED C.O.
 - 17- 2 1/2" SPEINKLER RISER DN.
 - 18- 2 1/2" GATE VALVE, DRAIN & FLOW SWITCH WITH DELAY.



SEE C.O. #17 (ITEM A) FOR HOSE SPRAY AT RMS #201 & 205

NOTES:
1. FOR DETAIL OF PIPING AND EQUIPMENT AT VENT HOODS, WALL BENCHES AND ISLAND TABLES SEE ARCHITECTURAL DRAWINGS A-31, A-32, A-33, A-34 TO A-38 INCLUSIVE AND DETAIL SHEETS A-19.1 TO A-19.23 INCLUSIVE


PIPE SLEEVES

- (a). DOTTED LINES INDICATE CONCRETE JOISTS & BEAMS ON CEILING BELOW.
- (b). PROVIDE VERTICAL SLEEVES THRU JOISTS FOR PIPES PASSING THRU FLOOR AT PARTITION FROM PIPE IN PARTITION BELOW. SEE DETAIL P-2.1.
- (c). PROVIDE ANGULAR SLEEVE THRU JOIST WHERE SPACE WILL NOT PERMIT VERTICAL SLEEVING. SEE DETAIL P-2.2.
- (d). WHERE ISLAND TABLES OR EQUIPMENT ARE INSTALLED OVER JOIST OR BEAM VERTICAL OR ANGULAR SLEEVES AS REQUIRED SHALL BE PROVIDED FOR PIPING. SEE DETAIL P-2.3.

STRUCTURAL ENGINEER BRADY & JOHNSON J.A. MARTIN & ASSOCIATES 1000 N. GARDEN ST. ANAHEIM, CALIF. 92805		DESIGNED BY RALPH E. PHILLIPS, INC. 1000 N. GARDEN ST. ANAHEIM, CALIF. 92805		APPROVED STATE FIRE MARSHAL STATE OF CALIFORNIA DATE: JUN 15 1965		ASSOCIATED ARCHITECTS: WILLIAM L. PEREIRA & ASSOCIATES A. QUINCY JONES-FREDERICK E. HEDGECOCK & ASSOCIATES BLUMSBACH BLUMSBACH & ASSOCIATES 1000 N. GARDEN ST. ANAHEIM, CALIF. 92805		GOLDEN WEST COLLEGE HUNTINGTON BEACH, CALIFORNIA ORANGE COAST JUNIOR COLLEGE DISTRICT		UNIT 1 FLOOR PLAN DATE: 6-15-65 SHEET NO. 1022	
REVISIONS		CIVIL ENGINEER G. SHUURMAN & ASSOCIATES 1000 N. GARDEN ST. ANAHEIM, CALIF. 92805		APPROVED STATE FIRE MARSHAL STATE OF CALIFORNIA DATE: JUN 15 1965		URBANUS SQUARE 1000 N. GARDEN ST. ANAHEIM, CALIF. 92805		MACARTHUR BOULEVARD AT FORD ROAD CORDONA DEL MAR, CALIFORNIA		SCALE 1/8"=1'-0"	

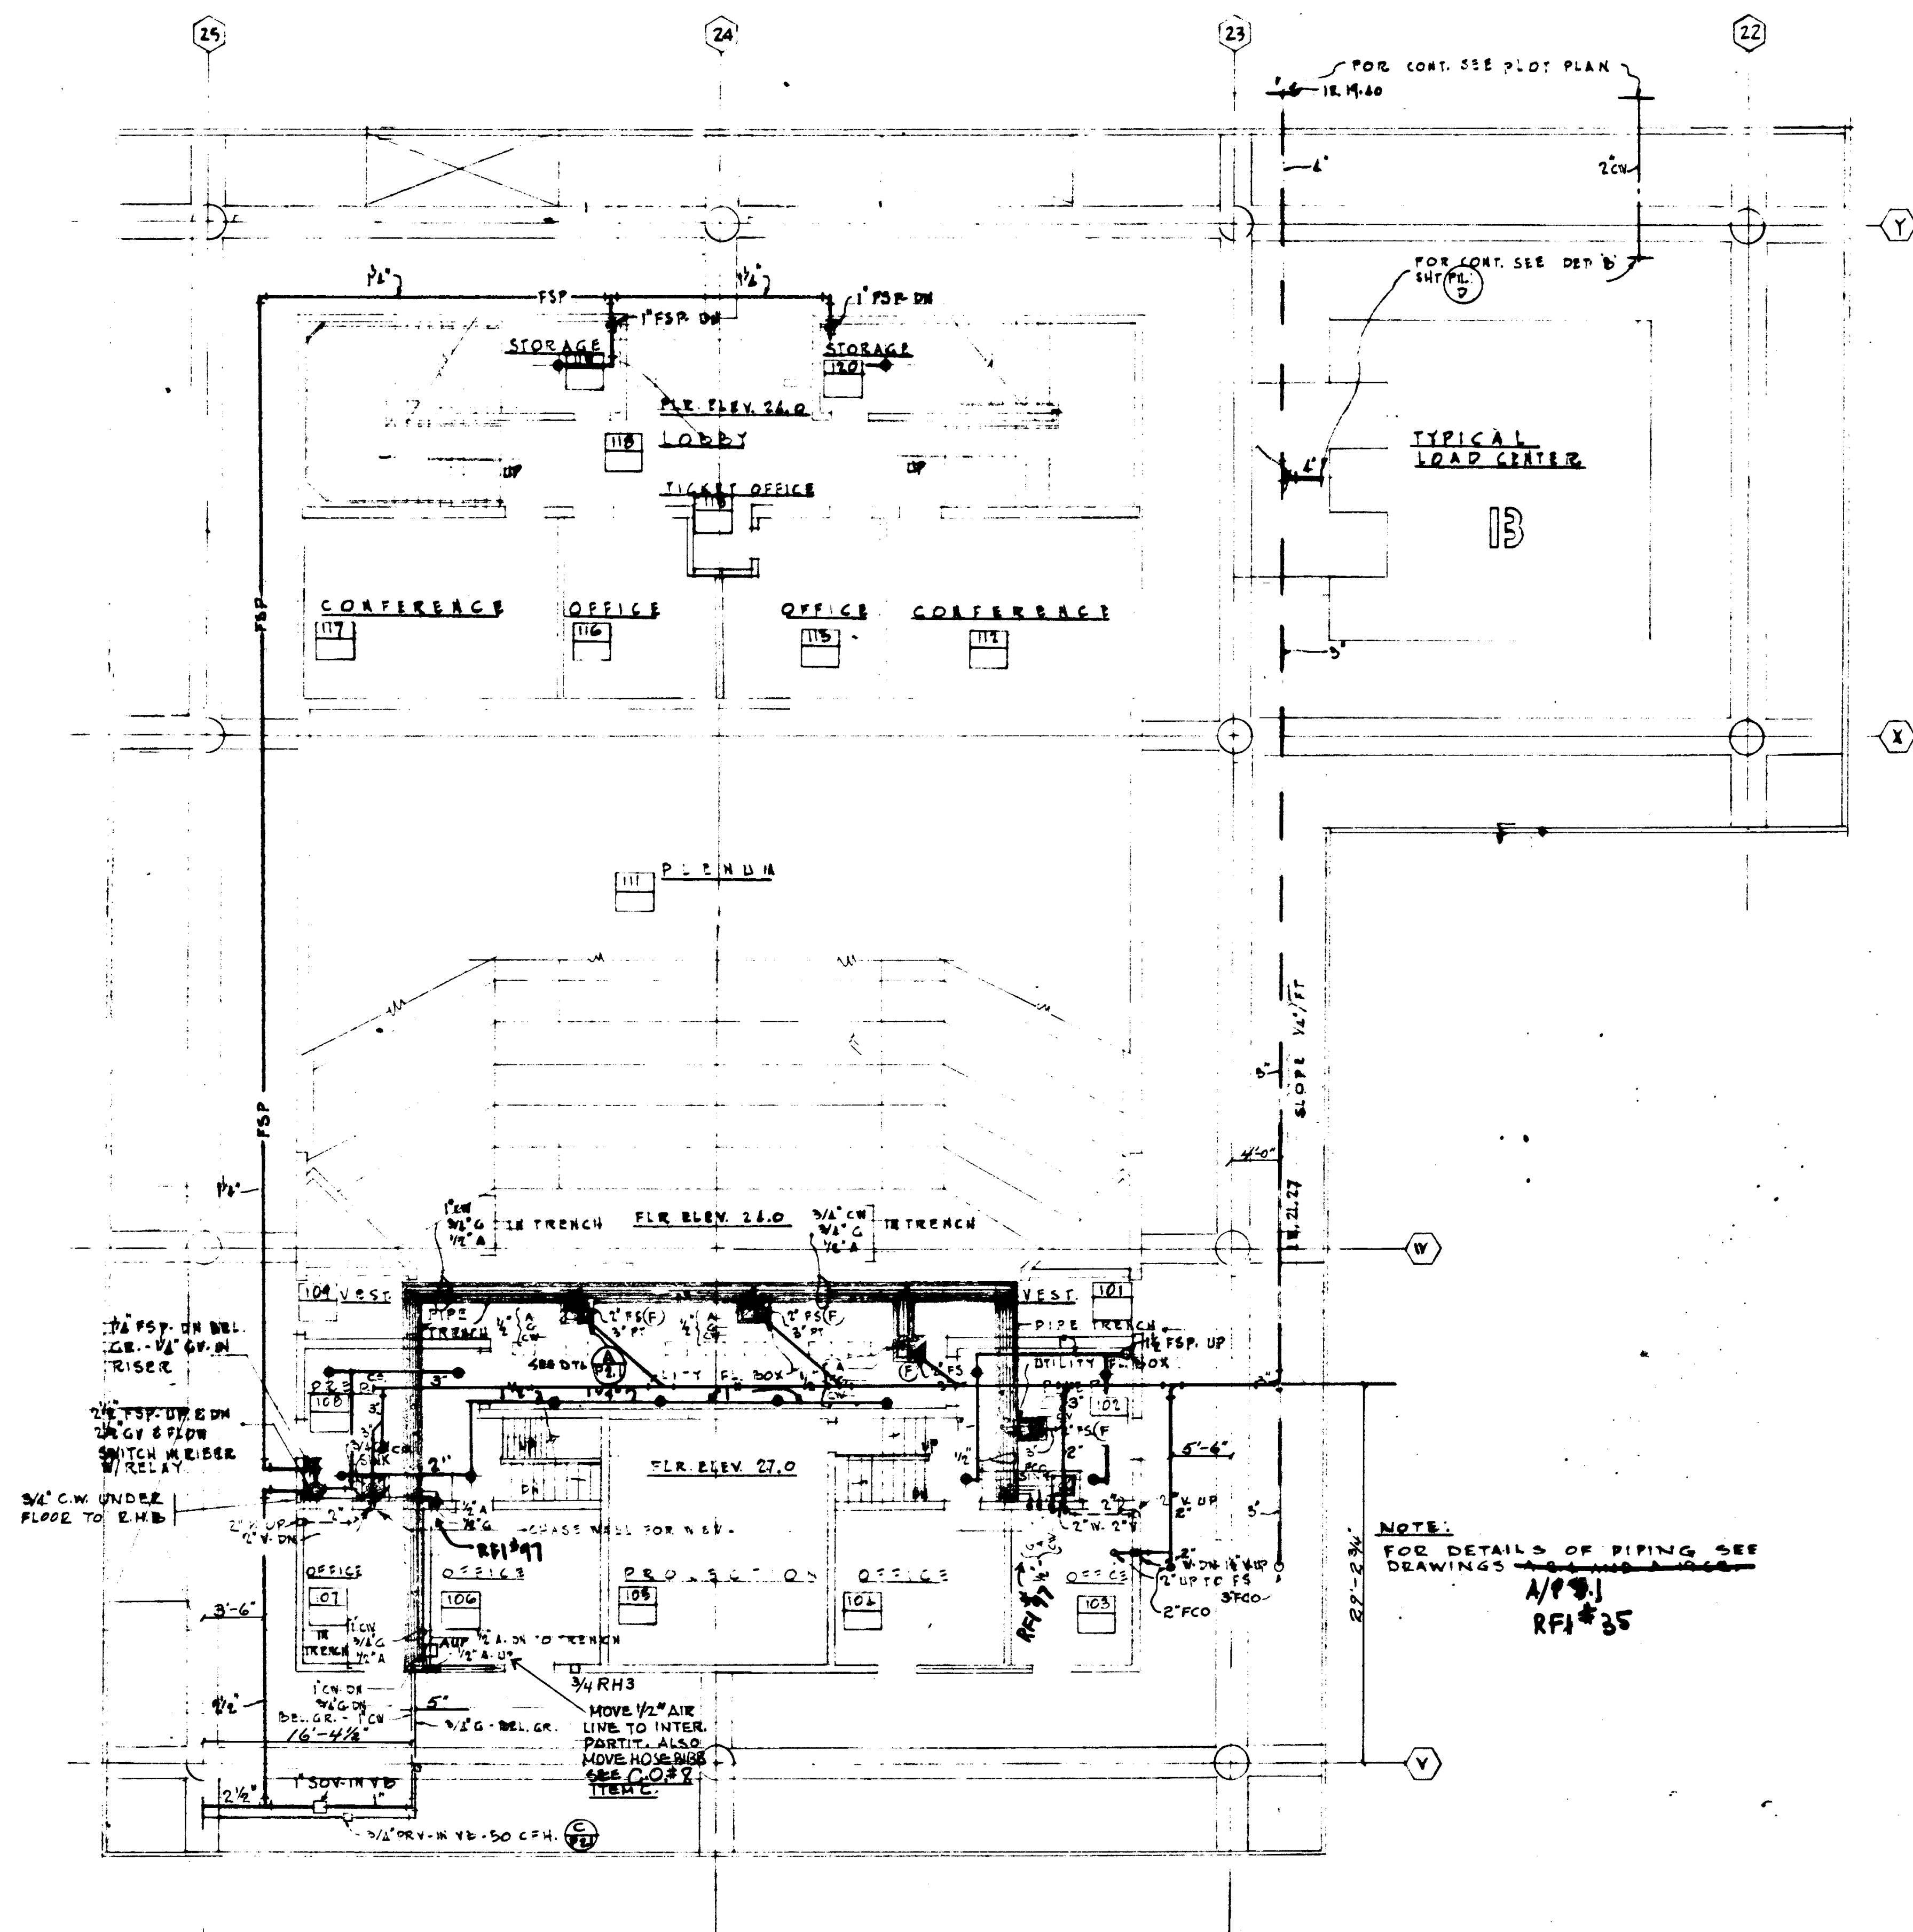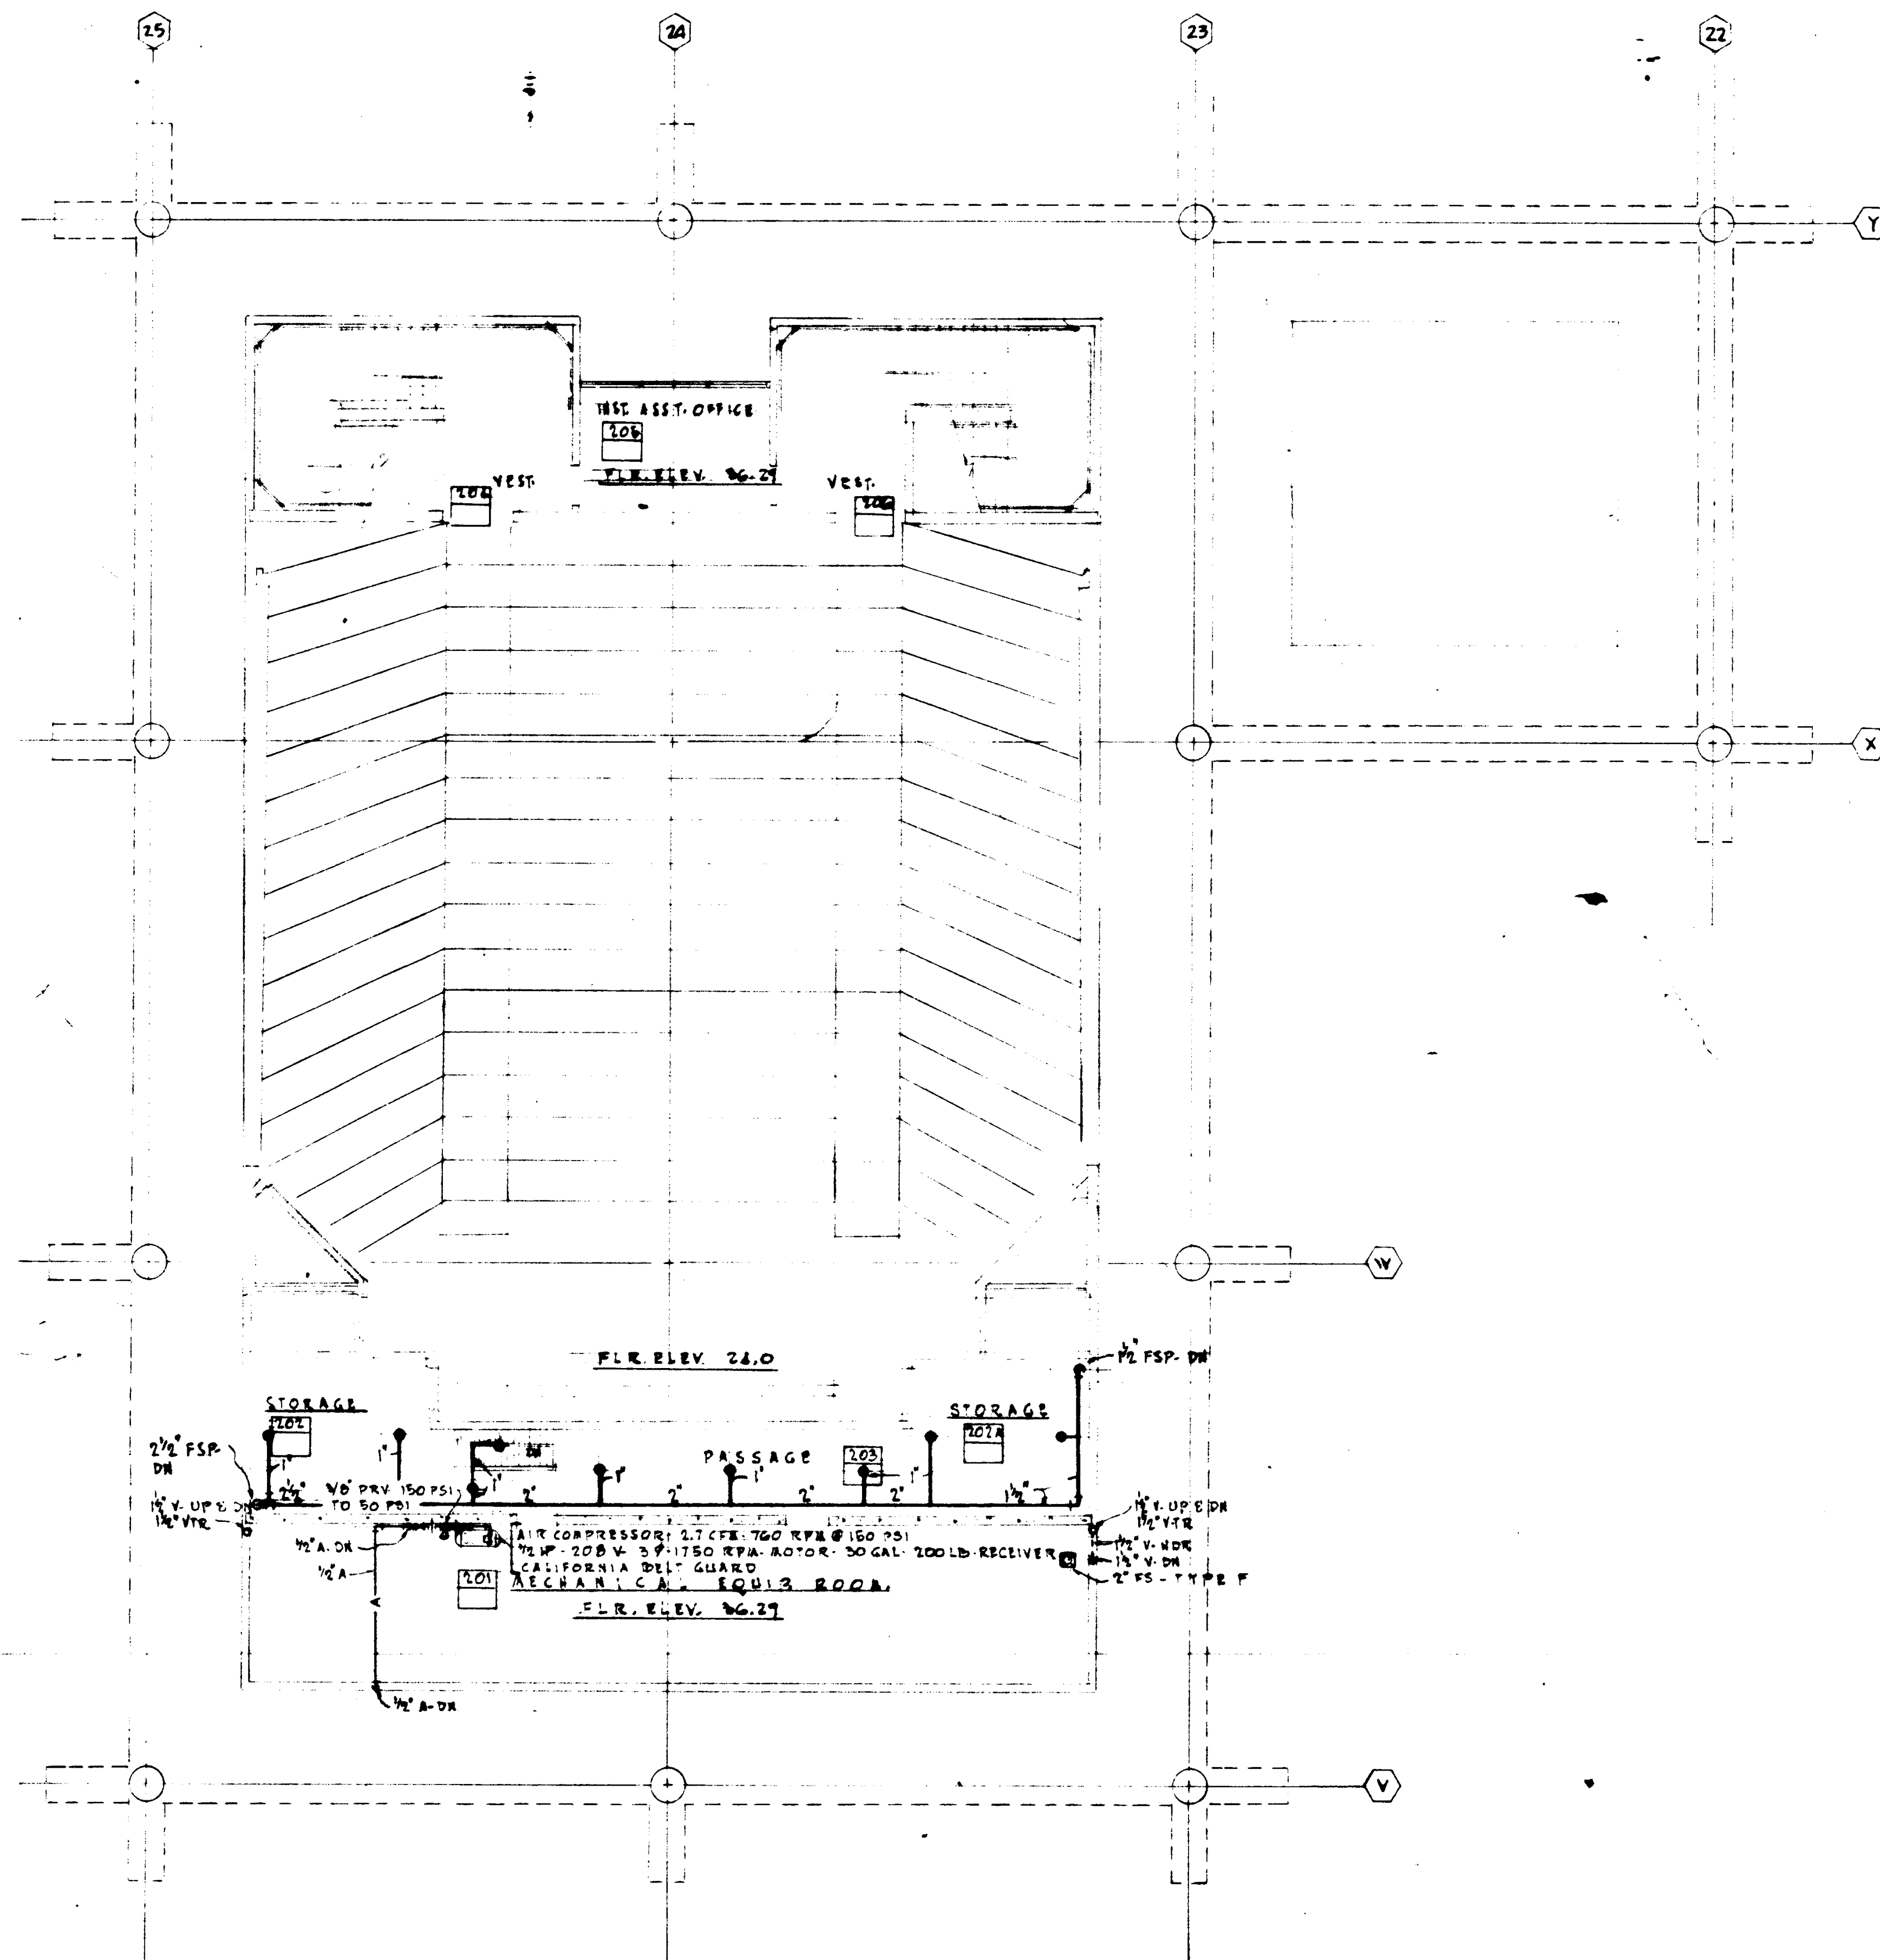


SECTION 2				FIRST FLOOR				UNIT 2			
STRUCTURAL ENGINEERS BRANDOW & JOHNSTON 2 & MARTIN & ASSOCIATES				DESIGNED ARCHITECT WILLIAM L. PEREIRA & ASSOCIATES				JOB NO. 104			
MECHANICAL ENGINEERS RALPH R. PHILLIPS, INC.				DRAWN BY A. QUINCY JONES-FREDERICK R. EDMONDS & ASSOCIATES				DATE 6-16-65			
ELECTRICAL ENGINEERS RALPH R. PHILLIPS, INC.				CHECKED BY COLLEGE				SHEET NO. 2-3-63			
CIVIL ENGINEERS G. SHURMAN & ASSOCIATES MOFFATT & NICHOL				APPROVED STATE FIRE MARSHAL STATE OF CALIFORNIA DATE JUN 21 1965							
REVISIONS				ASSOCIATED ARCHITECTS: WILLIAM L. PEREIRA & ASSOCIATES A. QUINCY JONES-FREDERICK R. EDMONDS & ASSOCIATES BLUROCK ELLERBROCK & ASSOCIATES				GOLDEN WEST COLLEGE HUNTINGTON BEACH, CALIFORNIA ORANGE COAST JUNIOR COLLEGE DISTRICT			
				URBANUS SQUARE • MACARTHUR BOULEVARD AT FORD ROAD TELEPHONE 714/675-2540 • CORONA DEL MAR, CALIFORNIA							

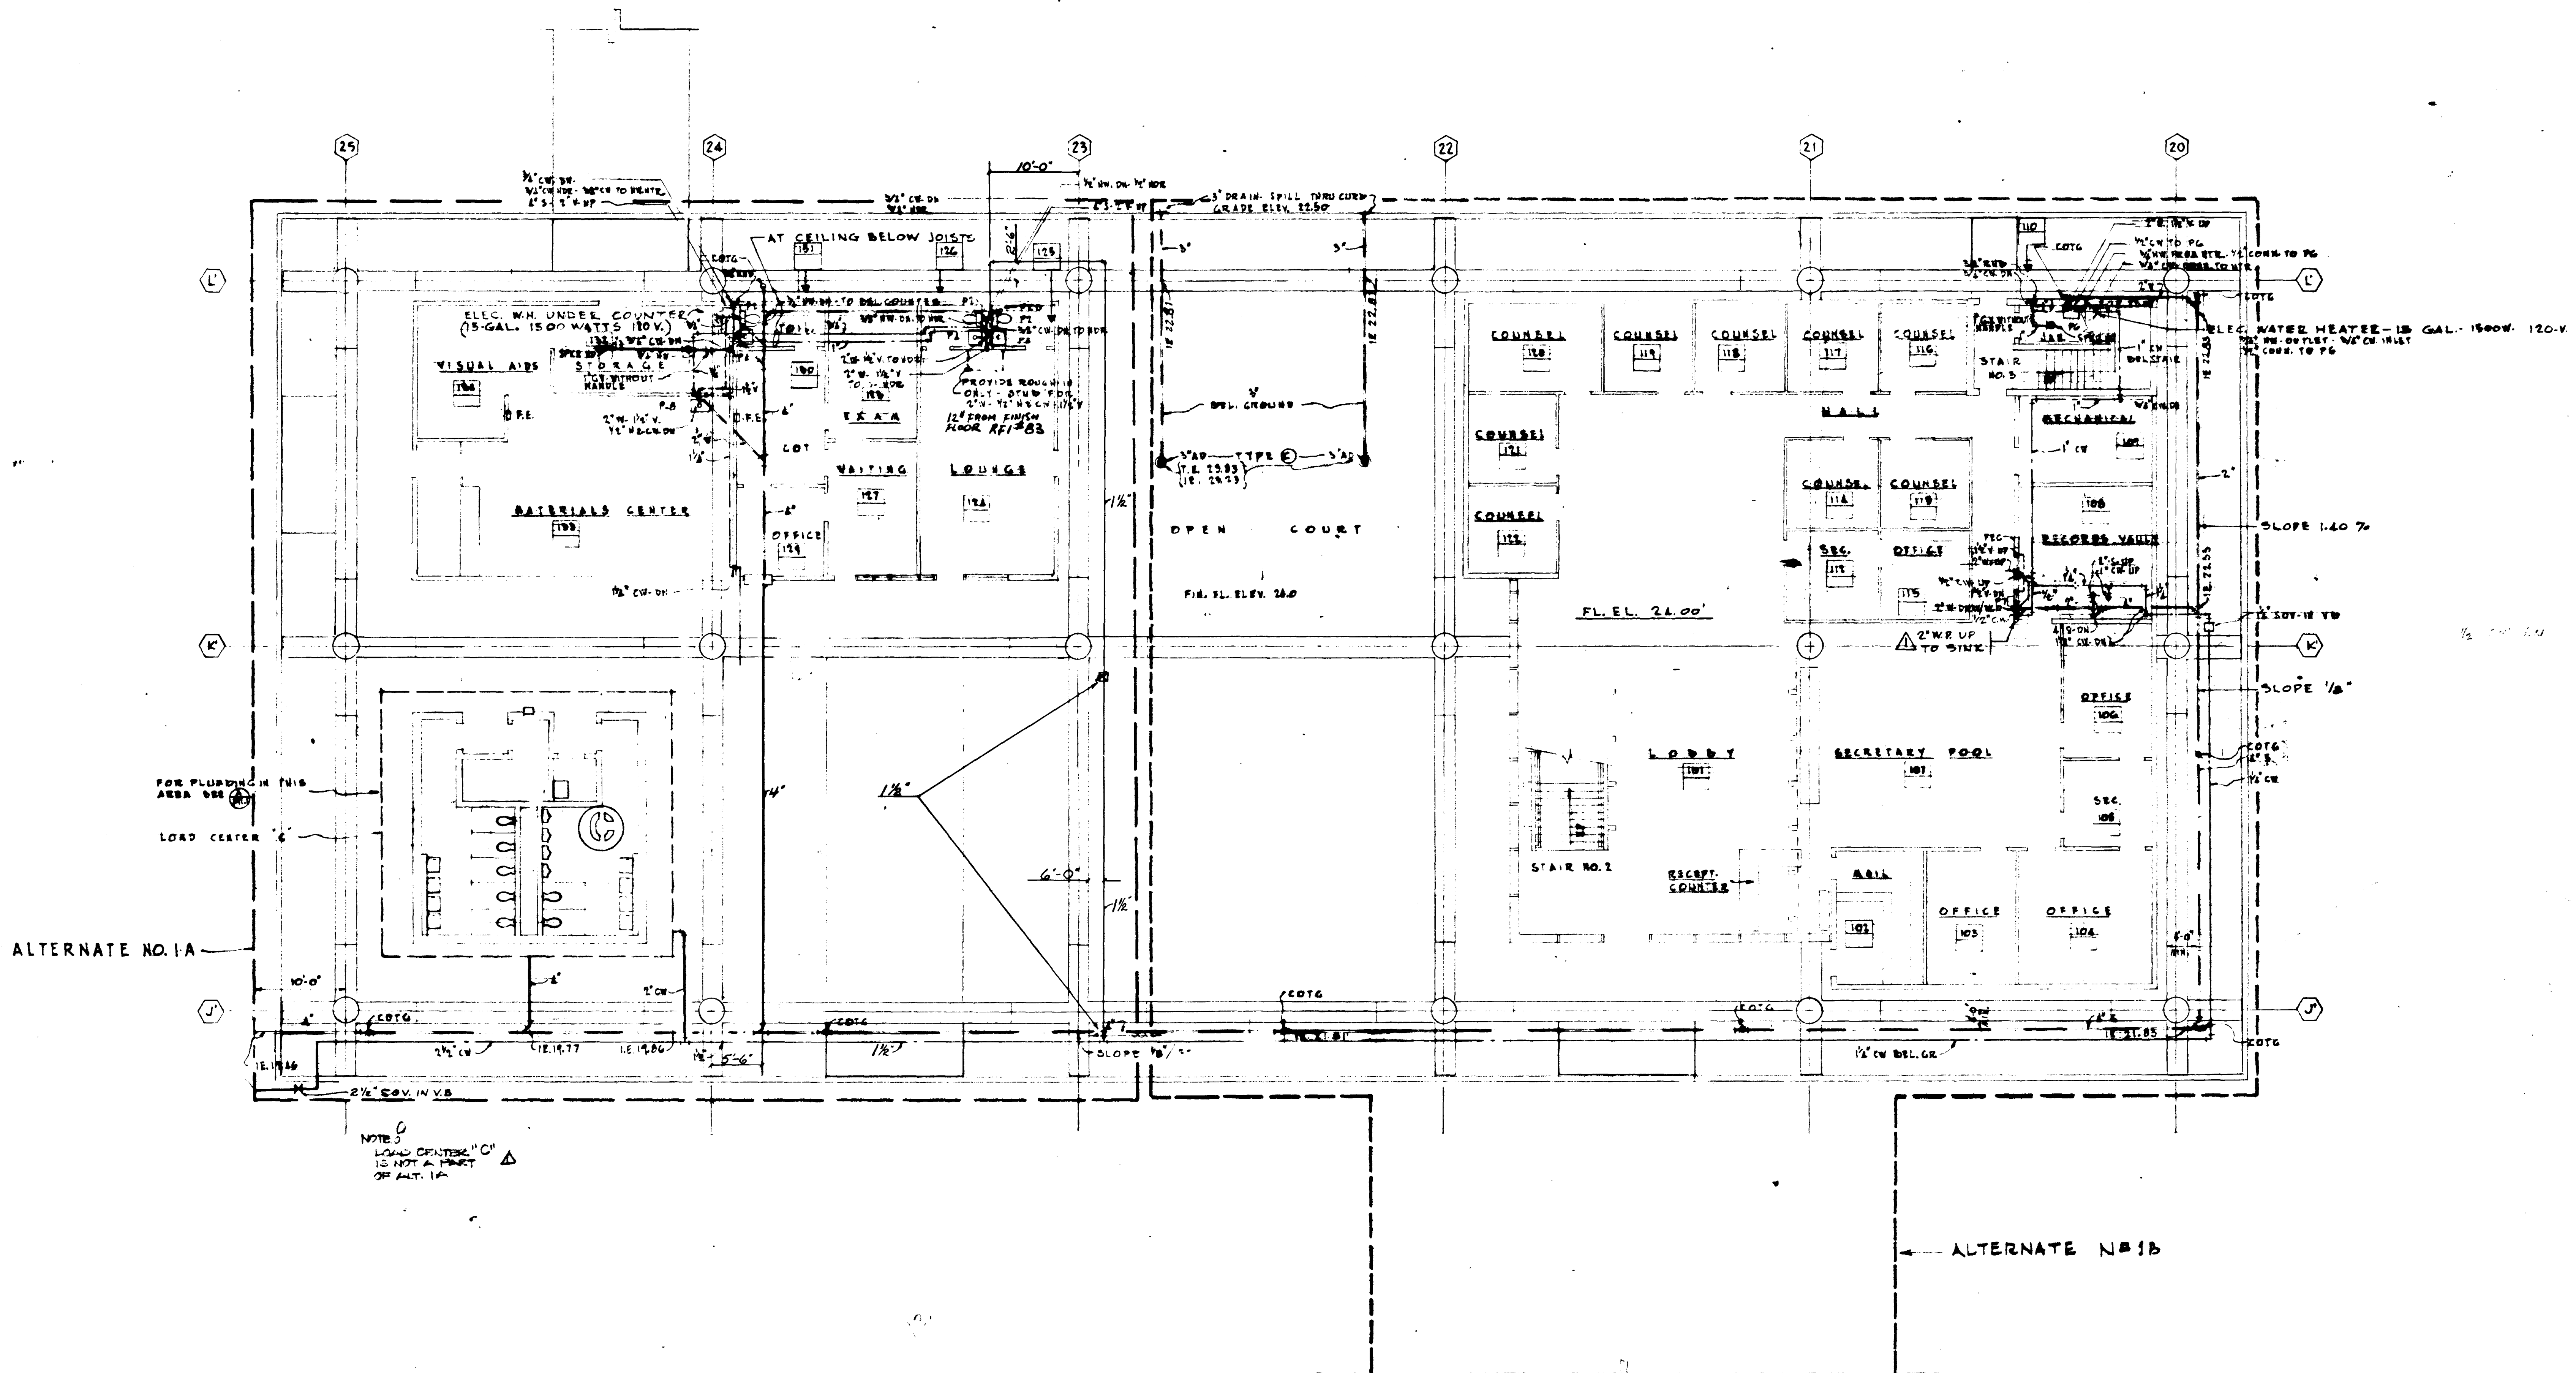

ALTERNATE NO. 1A


ALTERNATE NO. 1B

STATE OF CALIFORNIA
 PRELIMINARY
 25874

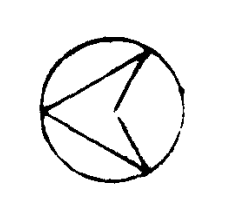


UNIT 4 FIRST FLOOR

REVISIONS 1. ADD PIPING FOR SINK 2. ... 3. ...	STRUCTURAL ENGINEER BRANDON & JOHNSON 214 MARVIN & ASSOCIATES MECHANICAL ENGINEER RALPH E. PHILLIPS, INC. ELECTRICAL ENGINEER RALPH E. PHILLIPS, INC. CIVIL ENGINEER G. SHULMAN & ASSOCIATES SHUFFLETT & SIEGEL	DESIGNED DRAWN BY CHECKED BY APPROVED STATE OF CALIFORNIA DATE 11/15/65 AS ORDERED NOV 24 1965	ASSOCIATED ARCHITECTS: WILLIAM L. PEREIRA & ASSOCIATES A. QUENT JAMES FREDERICK E. KIMMONS & ASSOCIATES BLURCKE ELLERBROOK & ASSOCIATES URBANUS SQUARE • MACARTHUR BOULEVARD AT FORD ROAD TELEPHONE 714/673-2640 • CORONA DEL MAR, CALIFORNIA	GOLDEN WEST COLLEGE HUNTINGTON BEACH, CALIFORNIA ORANGE COAST JUNIOR COLLEGE DISTRICT	UNIT 4 FLOOR PLANS	SCALE 1/8" = 1'-0" JOB NO. 104 DATE 6-15-65 SHEET NO. 1-35
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25874

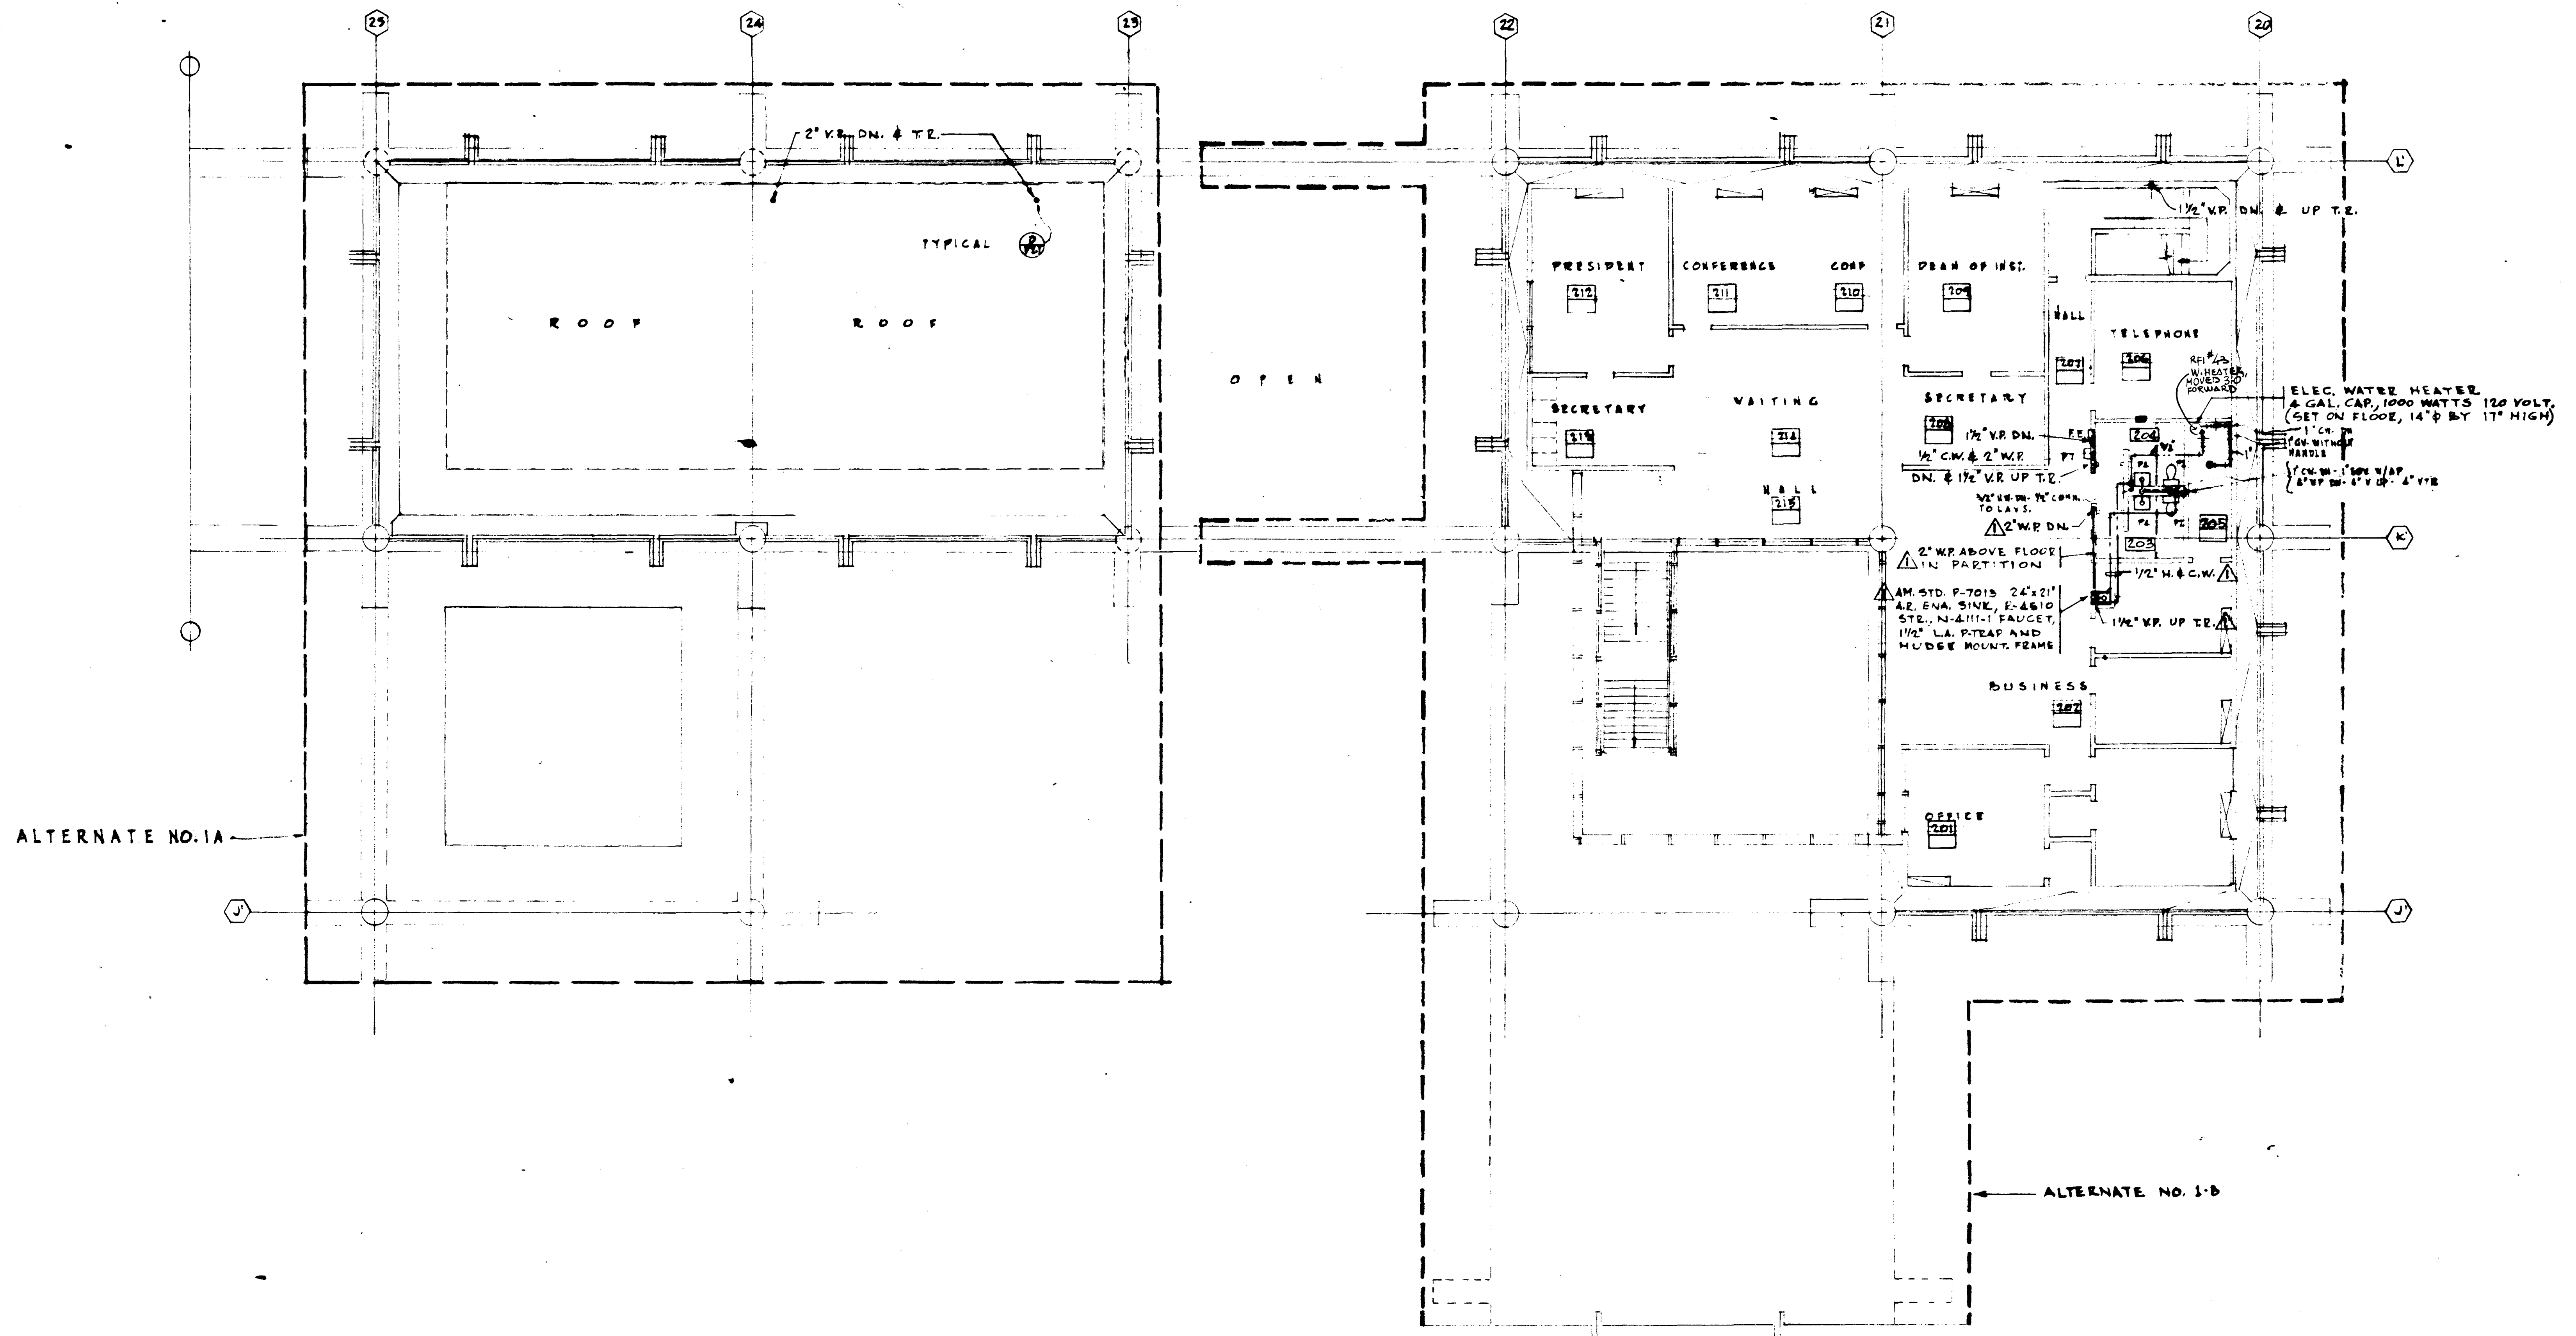

UNIT 4 SECOND FLOOR

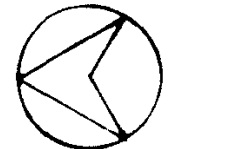SCALE 1/8" = 1'

STRUCTURAL ENGINEER	BRANDOW & JOHNSON
DESIGNED BY	J.A. MARTIN & ASSOCIATES
MECHANICAL ENGINEER	RALPH B. PHILLIPS, INC.
ELECTRICAL ENGINEER	RALPH B. PHILLIPS, INC.
CIVIL ENGINEER	G. BRIDGMAN & ASSOCIATES
MECHANICAL ENGINEER	MOFFATT & RICHES



APPROVED	STATE FIRE MARSHAL
DATE	JUN 21 1965
AS REVISED	NOV 24 1965

APPROVED
STATE FIRE MARSHAL
DATE JUN 21 1965
AS REVISED NOV 24 1965

ASSOCIATED ARCHITECTS:
WILLIAM L. PEREIRA & ASSOCIATES
A. QUINCY JONES, FREDERICK E. EMMONS & ASSOCIATES
BLUNCK ELLERBROCK & ASSOCIATES
URBANUS SQUARE • MACARTHUR BOULEVARD AT FORD ROAD
TELEPHONE 714/975-2640 • CORONA DEL MAR, CALIFORNIA

GOLDEN WEST COLLEGE
HUNTINGTON BEACH, CALIFORNIA
ORANGE COAST JUNIOR COLLEGE DISTRICT

UNIT 4	FLOOR PLANS
DATE	6-15-65
SHEET NO.	10-30

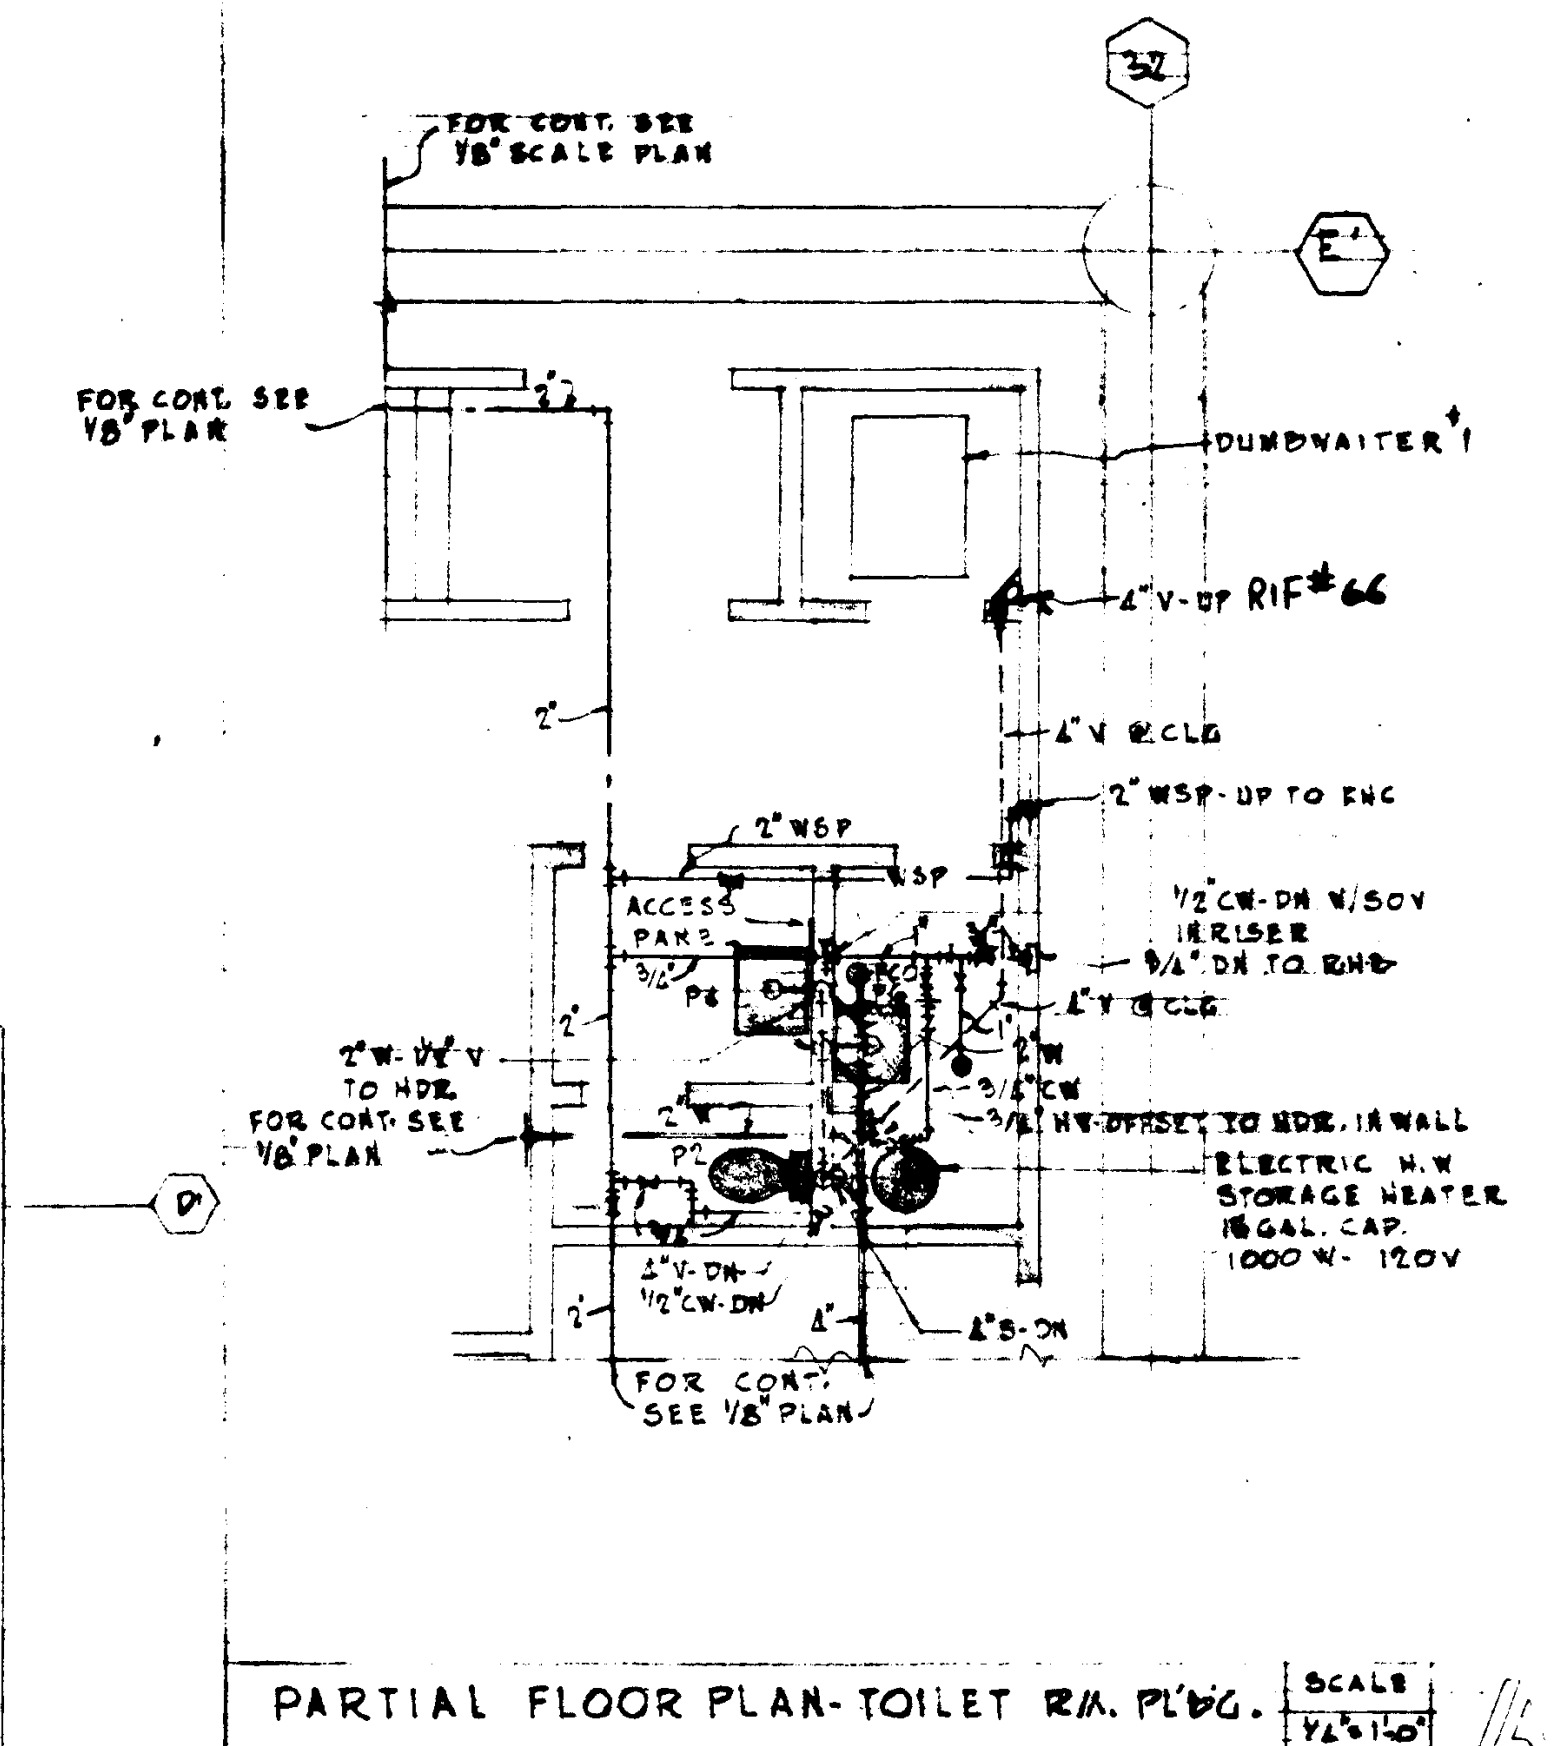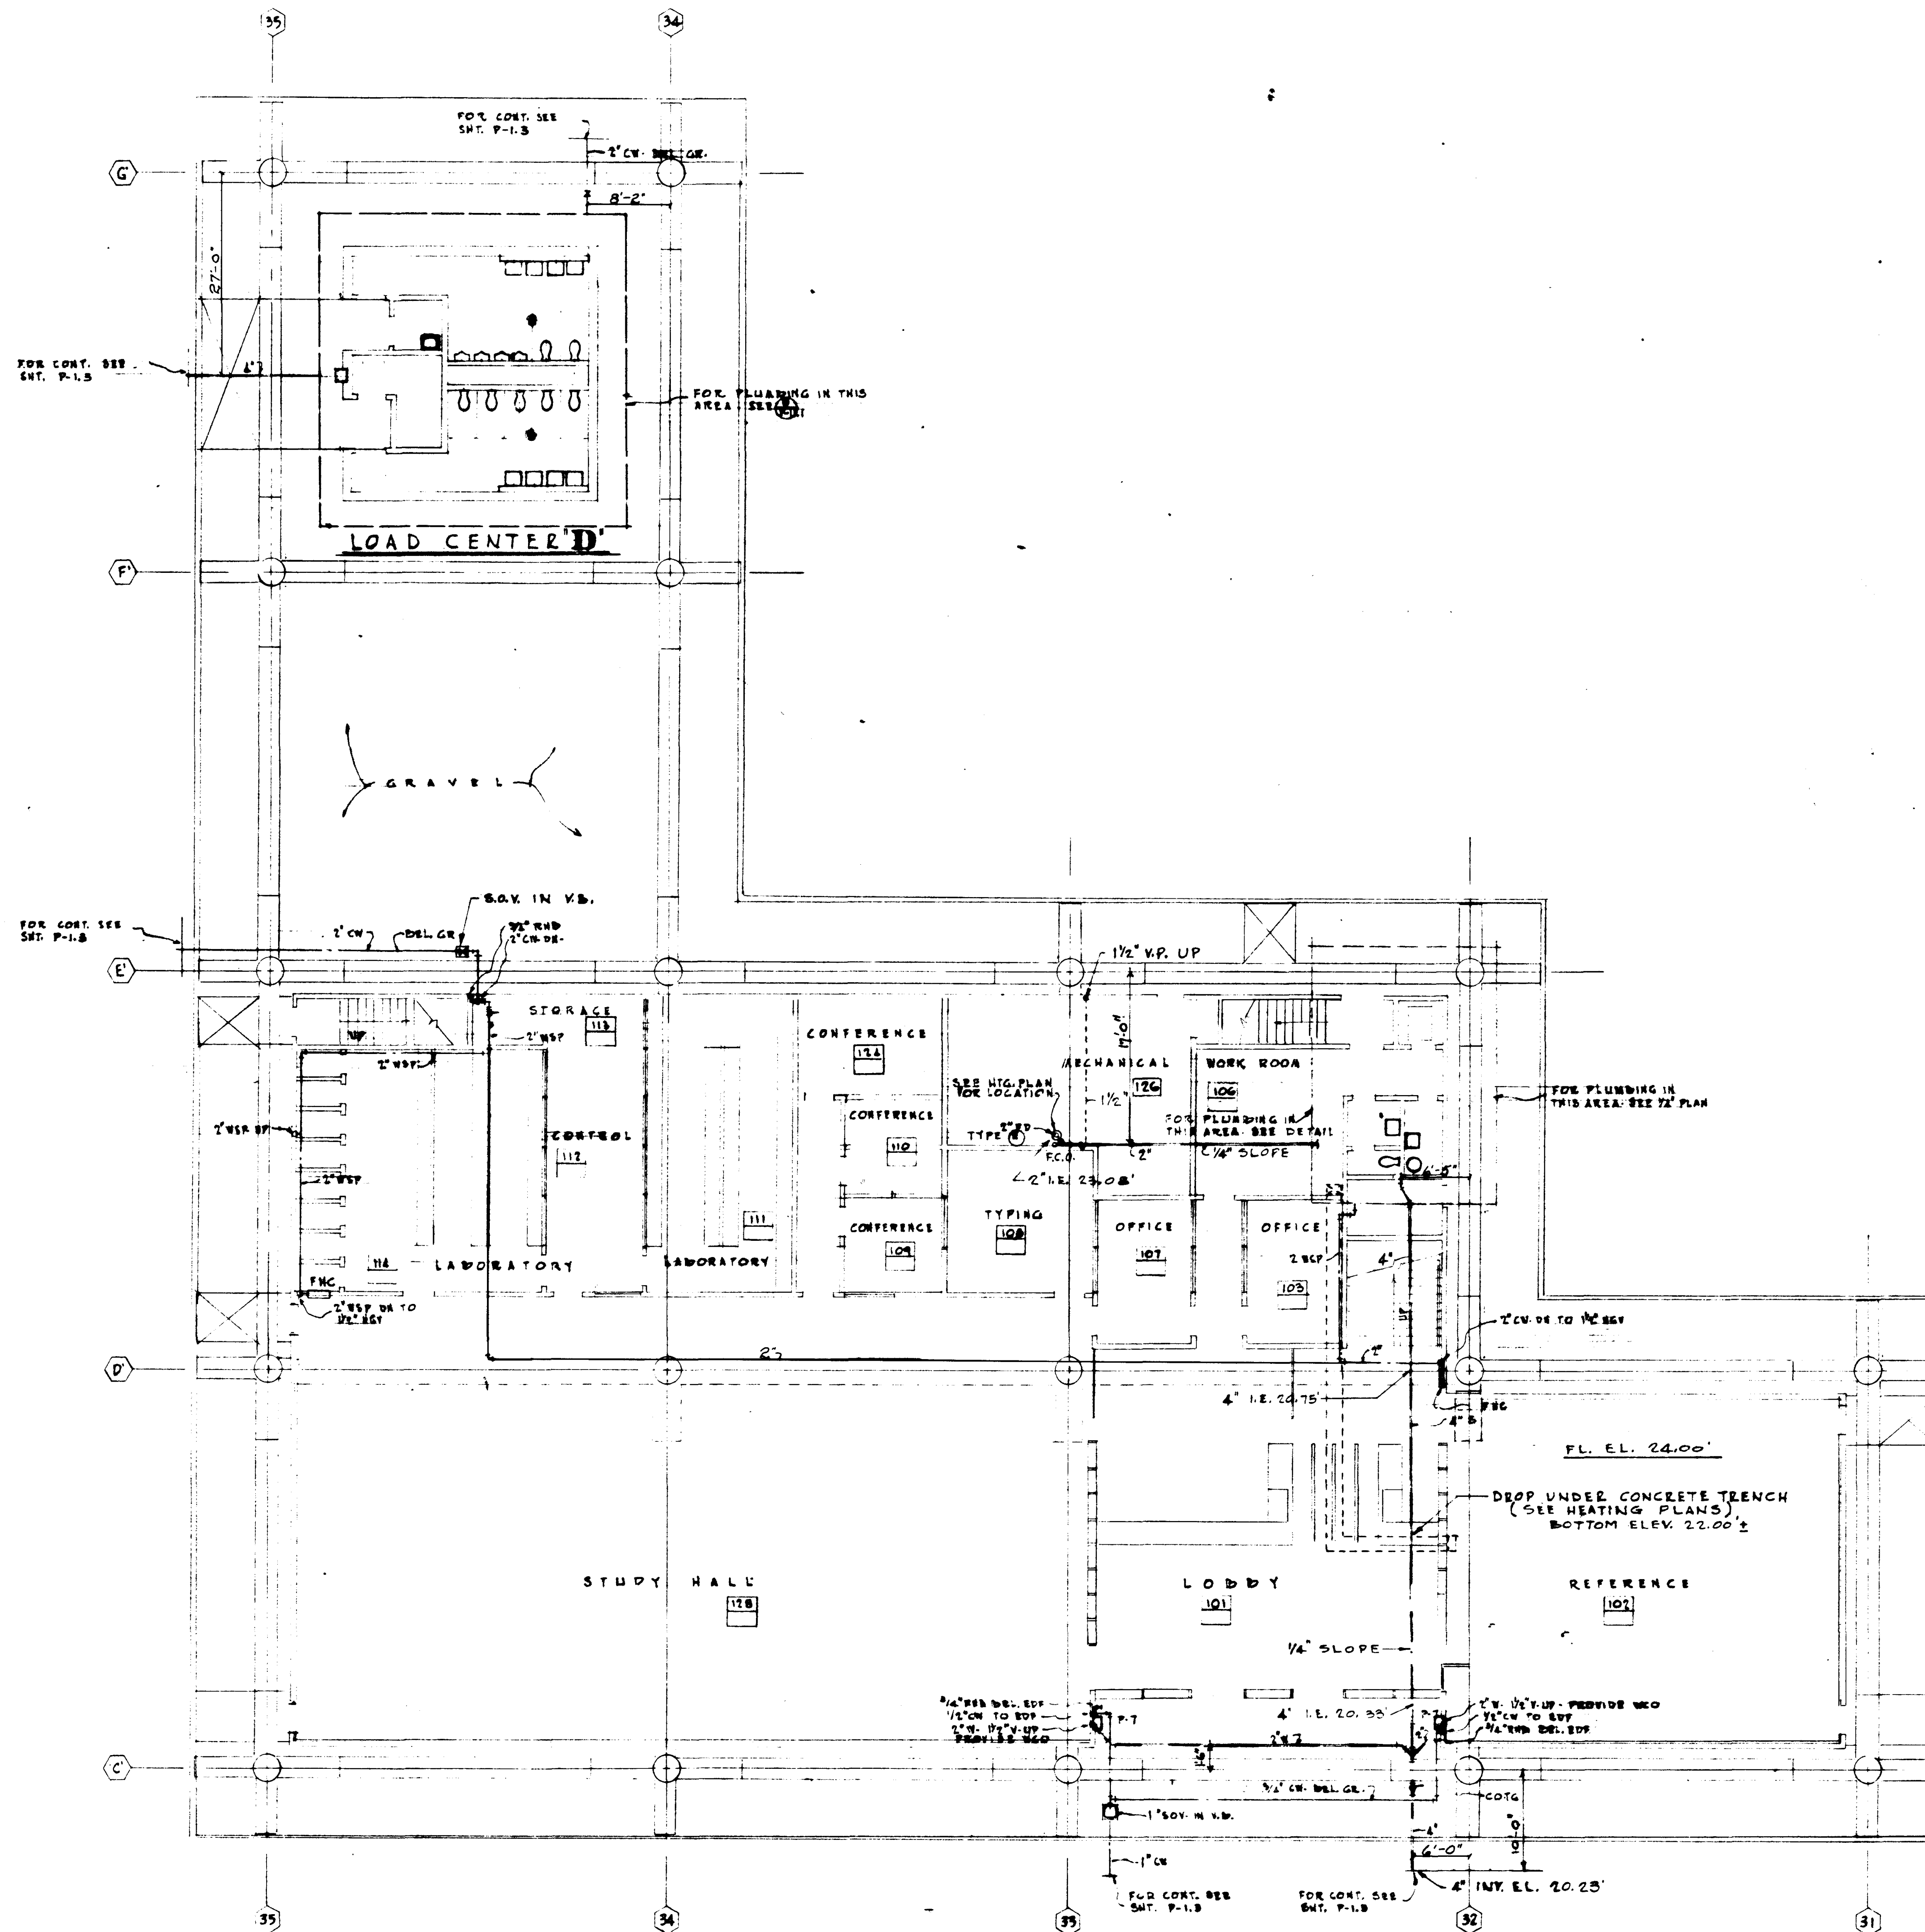

F I R S T F L O O R


REVISIONS	DATE	BY	REASON

ASSOCIATED ARCHITECTS:
 WILLIAM L. PEREIRA & ASSOCIATES
 A. QUINCY JONES-FREDERICK E. EMMONS & ASSOCIATES
 BLUEBOOK ELLERBROOK & ASSOCIATES
 URBANUS SQUARE • MACARTHUR BOULEVARD AT FORD ROAD
 TELEPHONE 714/675-2040 • CORONA DEL MAR, CALIFORNIA

GOLDEN WEST COLLEGE
 HUNTINGTON BEACH, CALIFORNIA
 ORANGE COAST JUNIOR COLLEGE DISTRICT

UNIT 7
 FLOOR
 PLAN


SCALE: 1/8" = 1'-0"
 JOB NO. 1004
 DATE 6-15-65
 SHEET NO. 13 OF 23

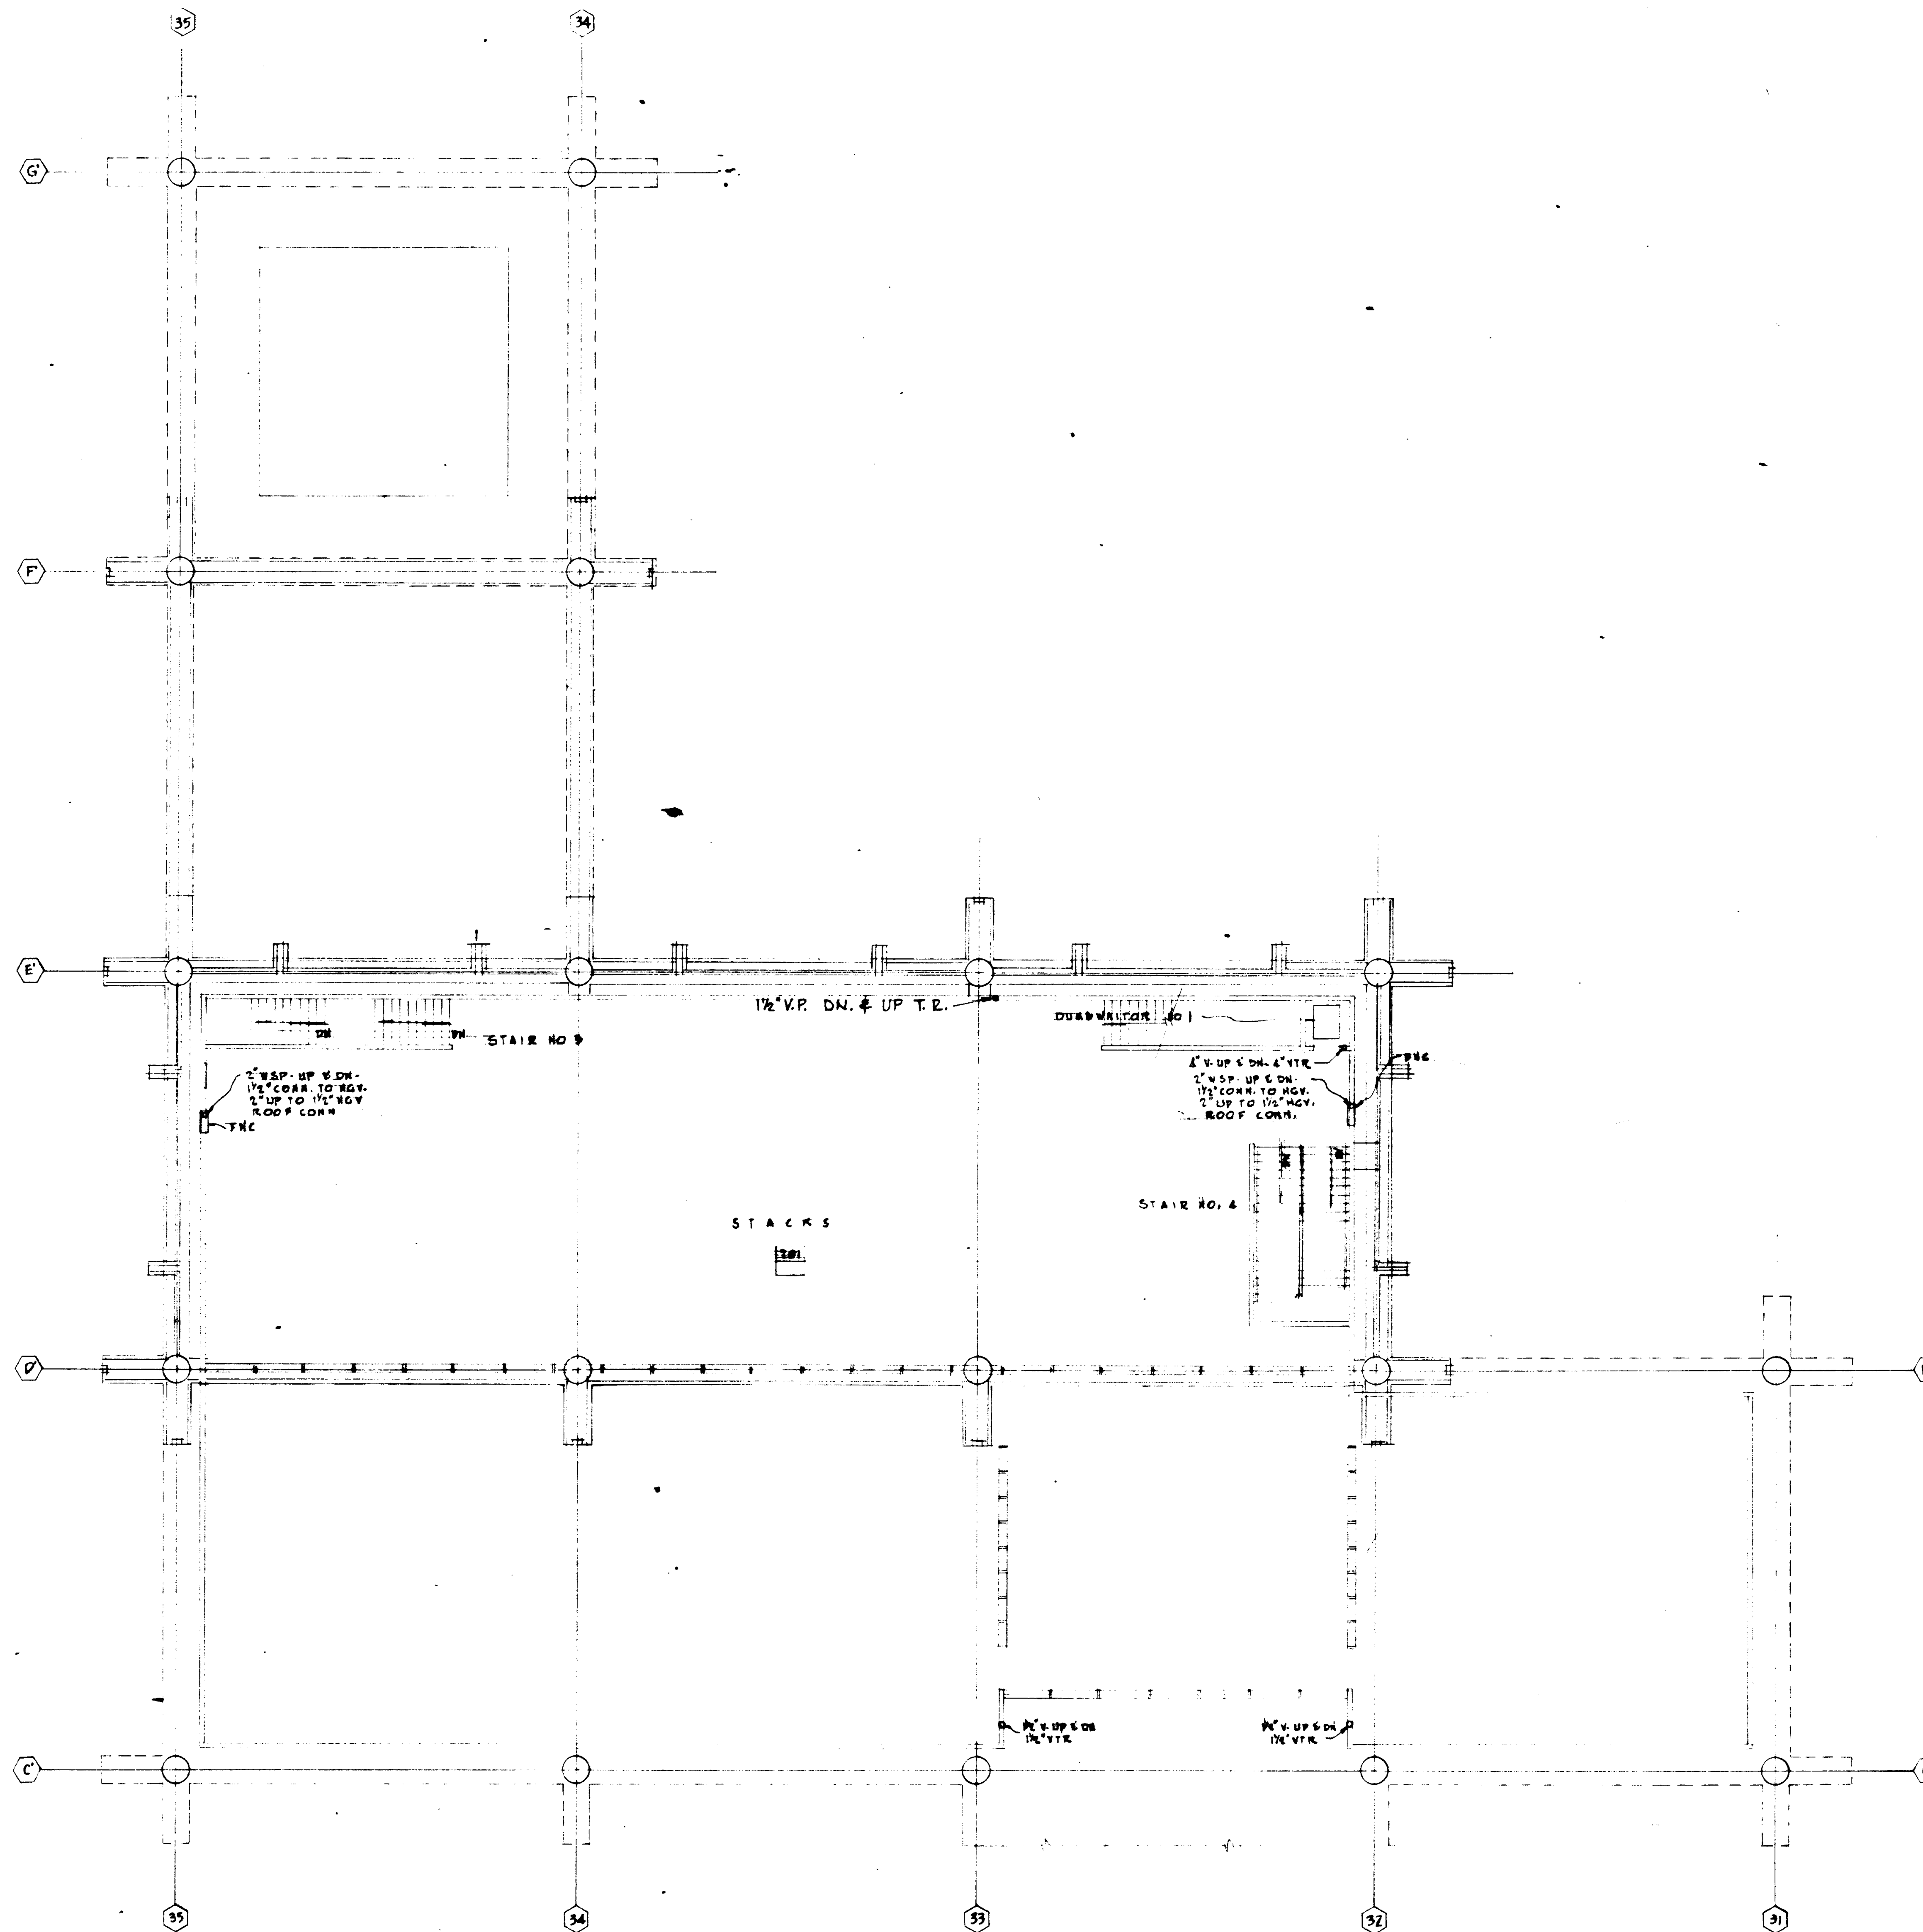

SECOND FLOOR


SCALE 1/8" = 1'

<div> <div>REVISIONS</div> <div> <div>1</div> <div>2</div> <div>3</div> <div>100</div> </div> </div>	<div> <div>STRUCTURAL ENGINEERS</div> <div>SHAWDON & JOHNSON</div> <div>J.A. MARTIN & ASSOCIATES</div> <div>MECHANICAL ENGINEERS</div> <div>RALPH E. PHILLIPS, INC.</div> <div>ELECTRICAL ENGINEERS</div> <div>RALPH E. PHILLIPS, INC.</div> <div>CIVIL ENGINEERS</div> <div>G. SHUTEMAN & ASSOCIATES</div> <div>MOFFATT & WICKOL</div> </div>	<div> <div>DESIGNED</div> <div>ARCHITECT</div> <div>APPROVED</div> <div>STATE OF CALIFORNIA</div> <div>DATE: JUN 21 1965</div> </div>	<div> <div>ASSOCIATED ARCHITECTS:</div> <div>WILLIAM J. PEREIRA & ASSOCIATES</div> <div>A. QUINCY JONES-FREDERICK E. EMMONS & ASSOCIATES</div> <div>BLUROCK ELLERBROCK & ASSOCIATES</div> <div>URBANUS SQUARE • MACARTHUR BOULEVARD AT FORD ROAD</div> <div>TELEPHONE 714/675-2640 • CORONA DEL MAR, CALIFORNIA</div> </div>	<div> <div>GOLDEN WEST COLLEGE</div> <div>HUNTINGTON BEACH, CALIFORNIA</div> <div>ORANGE COAST JUNIOR COLLEGE DISTRICT</div> </div>	<div> <div>UNIT 7</div> <div>FLOOR</div> <div>PLAN</div> </div>	<div> <div>JOB NO.</div> <div>104</div> <div>DATE</div> <div>6-15-65</div> <div>SHEET NO.</div> <div>1030</div> </div>
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NOTES
 1-ROUGH-IN ONLY FOR N.L.C. ITEMS L-1, L-2 AND L-3.

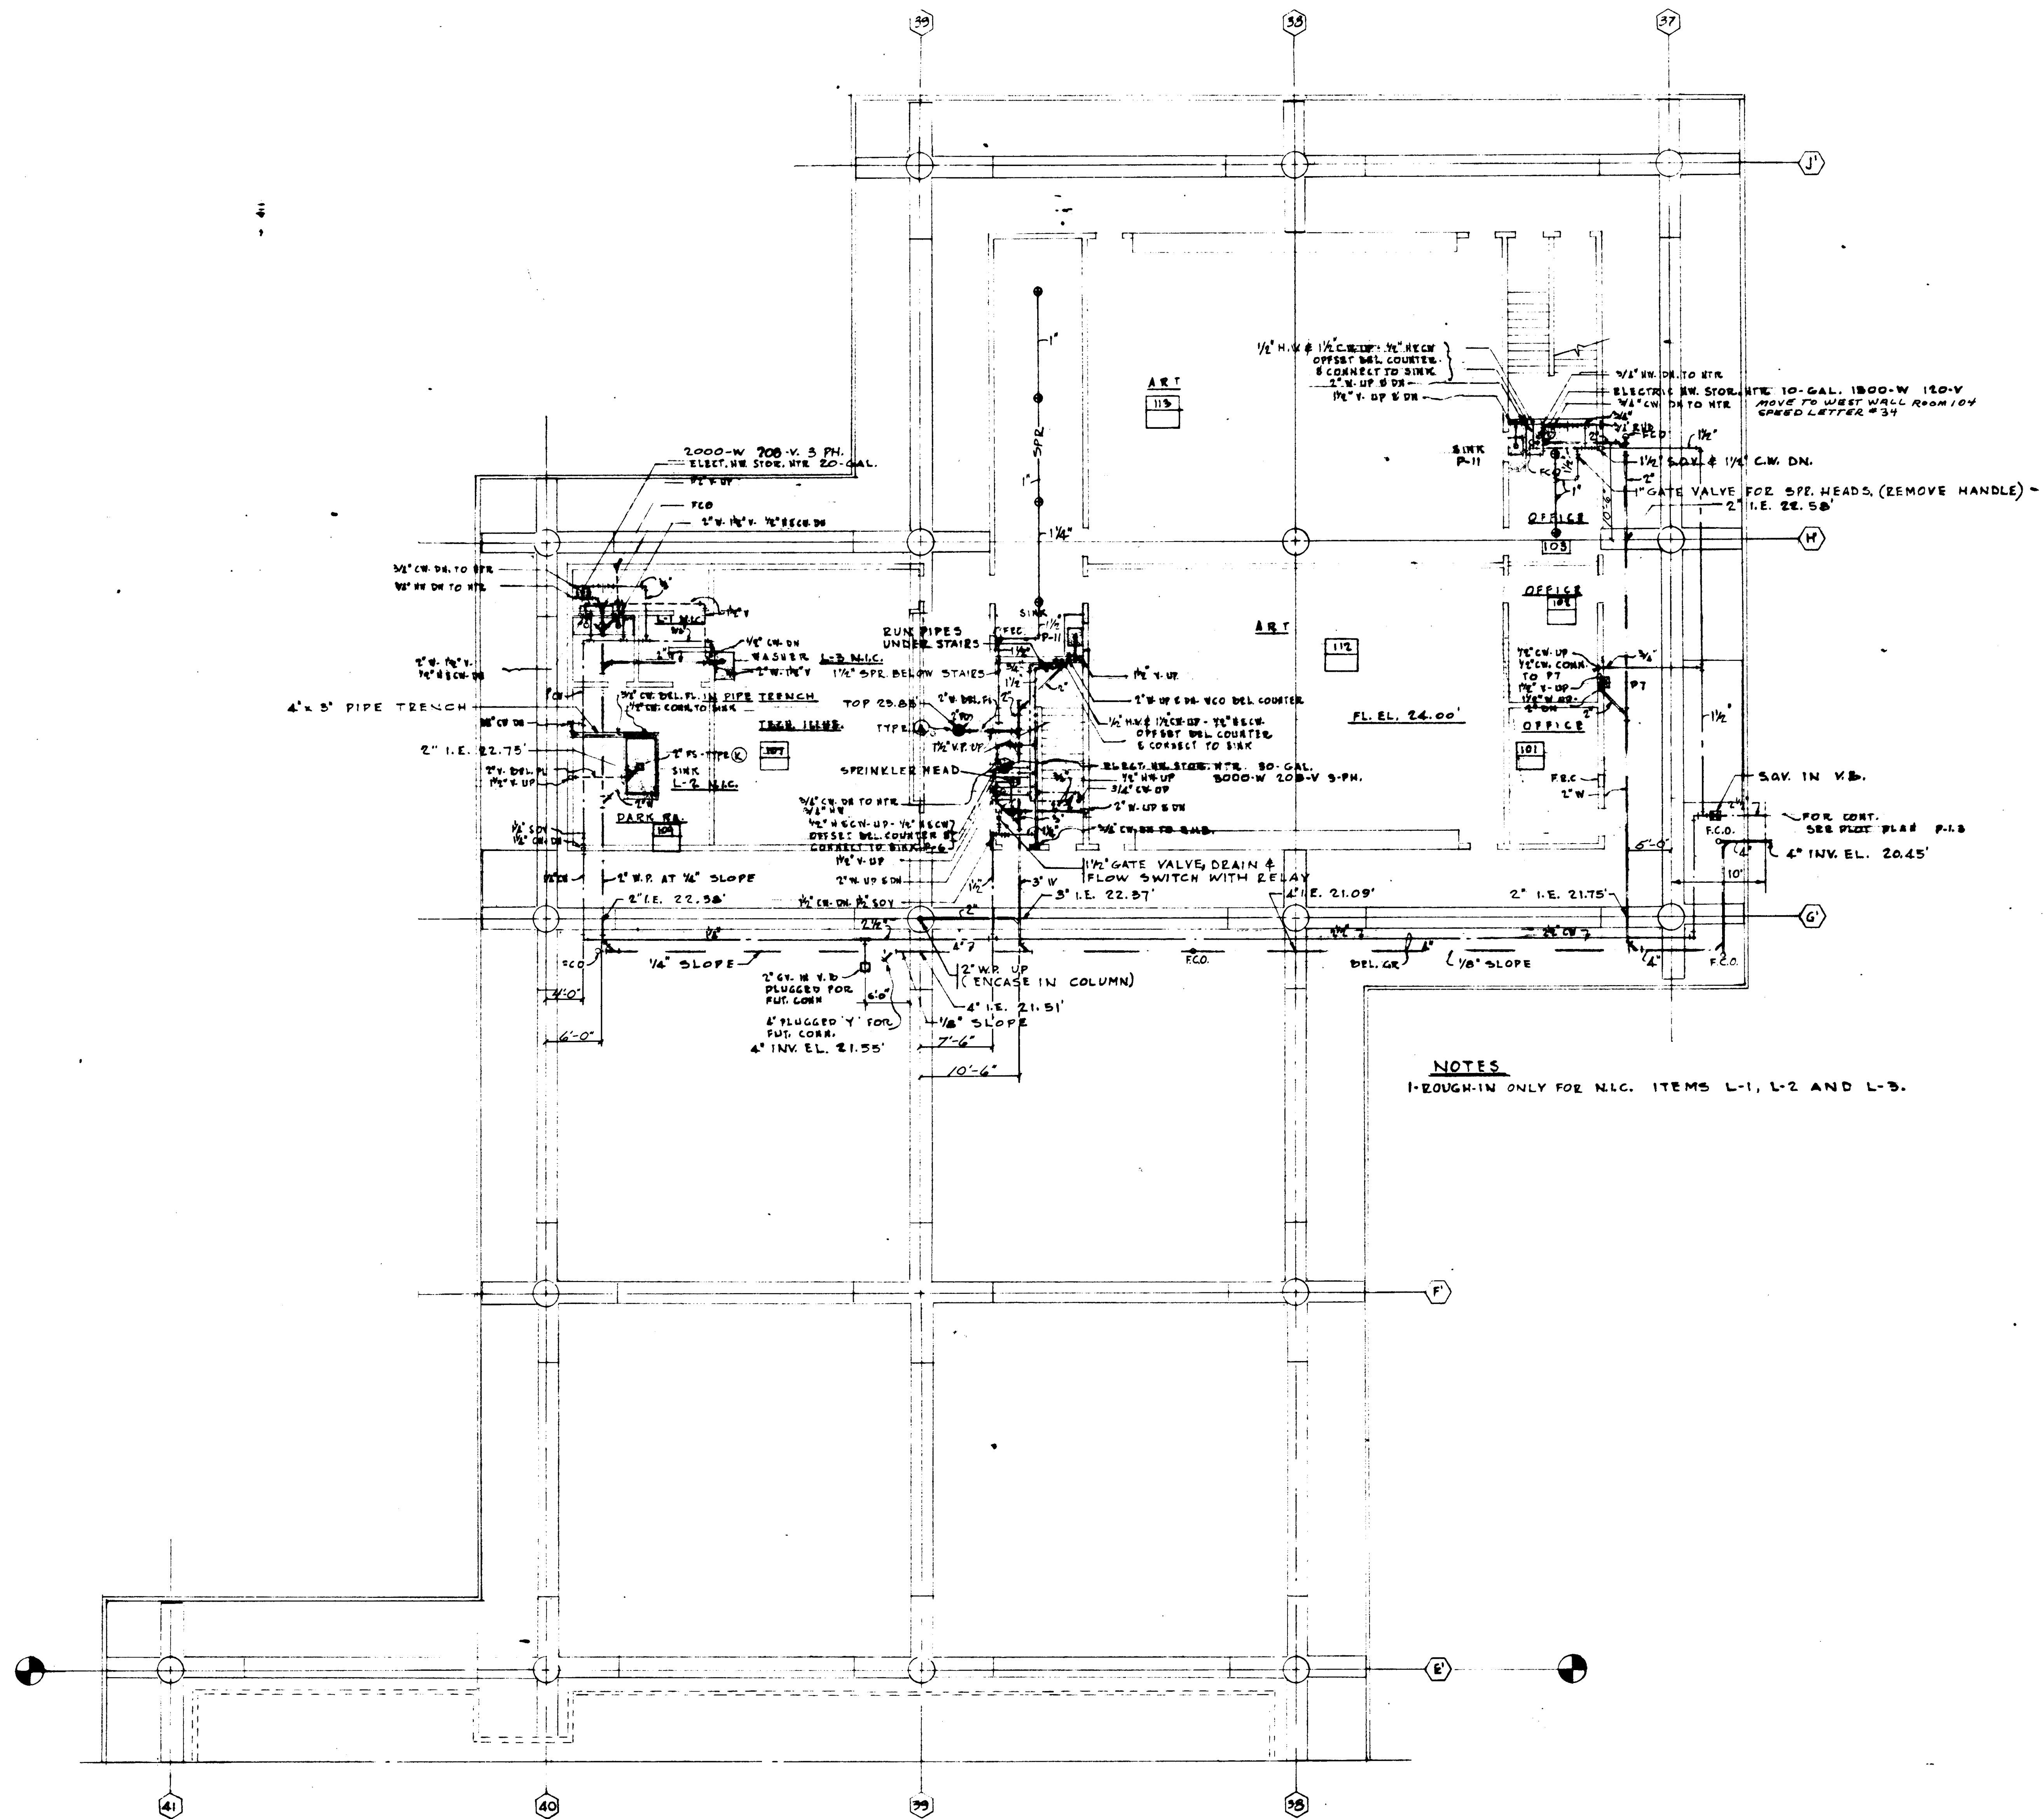STRUCTURAL ENGINEERS BRANDOW & JOHNSON J.A. MARTIN & ASSOCIATES MECHANICAL ENGINEERS RALPH E. PHILLIPS, INC. ELECTRICAL ENGINEERS RALPH E. PHILLIPS, INC. CIVIL ENGINEERS O. SHURMAN & ASSOCIATES MOFFATT & NICHOL				DESIGNED DRAWN BY CHECKED BY	ARCHITECT WILLIAM L. FERREIRA ASSOCIATED ARCHITECTS WILLIAM L. FERREIRA & ASSOCIATES A. QUINCY JONES - FREDERICK E. REMONDS & ASSOCIATES BLUROCK ELLERBROCK & ASSOCIATES URBANUS SQUARE • MACARTHUR BOULEVARD AT FORD ROAD TELEPHONE 714/879-2640 • CORONA DEL MAR, CALIFORNIA	APPROVED STATE FIRE MARSHAL STATE OF CALIFORNIA DATE: JUN 2, 1965	GOLDEN WEST COLLEGE HUNTINGTON BEACH, CALIFORNIA ORANGE COAST JUNIOR COLLEGE DISTRICT	UNIT 3A FLOOR PLAN	SCALE 1/8" = 1' JOB NO. 1004 DATE 6-18-65 SHEET NO. 10310
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SECOND FLOOR

SCALE
1/8" = 1'

NO.	REVISIONS
1	
2	
3	
4	
5	
6	
7	
8	
9	
10	

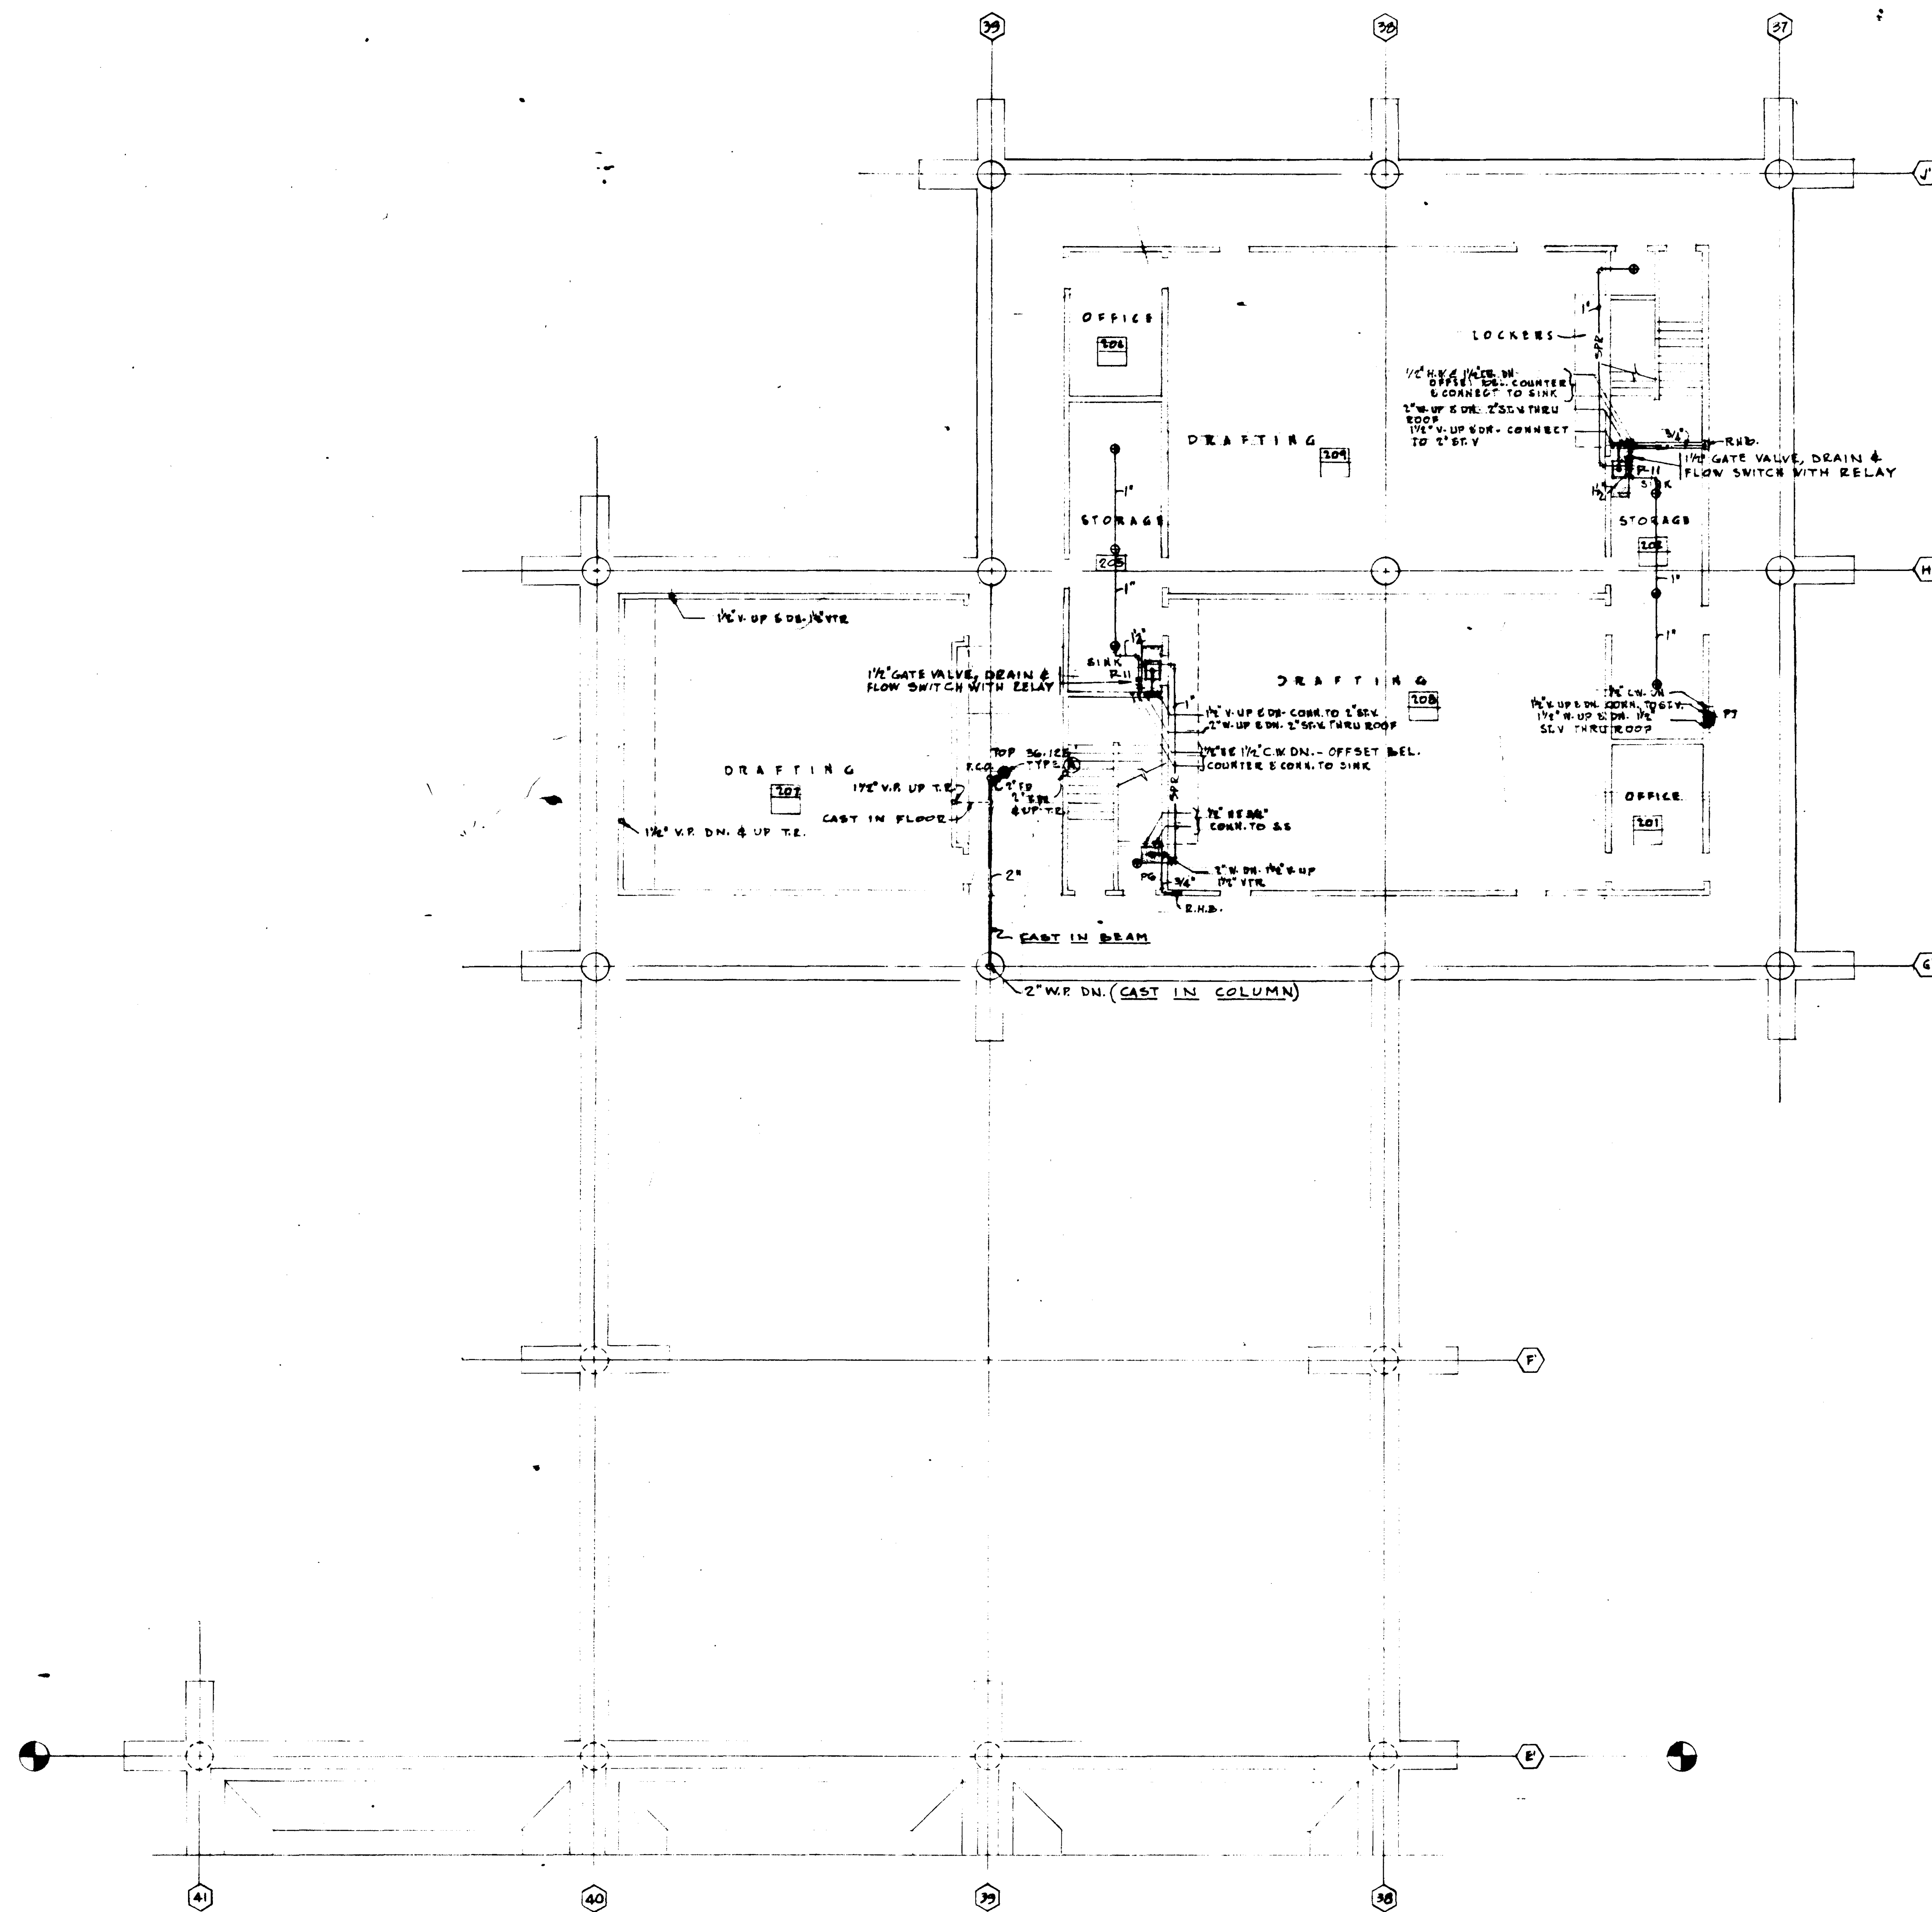STRUCTURAL ENGINEERS BEARDOW & JOHNSTON J. A. MARTIN & ASSOCIATES	DESIGNED W. L. PEREIRA
MECHANICAL ENGINEERS RALPH E. PHILLIPS, INC.	DRAWN BY W. L. PEREIRA
ELECTRICAL ENGINEERS RALPH E. PHILLIPS, INC.	CHECKED BY W. L. PEREIRA
CIVIL ENGINEERS G. SHUURMAN & ASSOCIATES MOFFATT & NICHOL	APPROVED W. L. PEREIRA




APPROVED
STATE FIRE MARSHAL
DATE JUN 21 1965

ASSOCIATED ARCHITECTS:
WILLIAM L. PEREIRA & ASSOCIATES
A. QUINCY JONES-FREDERICK E. EDMONDS & ASSOCIATES
BLUROCK ELLERBROOK & ASSOCIATES

URBANUS SQUARE • MACARTHUR BOULEVARD AT FORD ROAD
TELEPHONE 714/675-2640 • CORONA DEL MAR, CALIFORNIA

GOLDEN WEST COLLEGE
HUNTINGTON BEACH, CALIFORNIA
ORANGE COAST JUNIOR COLLEGE DISTRICT

UNIT 8A	JOB NO. 1004
FLOOR	DATE 6-15-65
PLAN	SHEET NO. 13.11

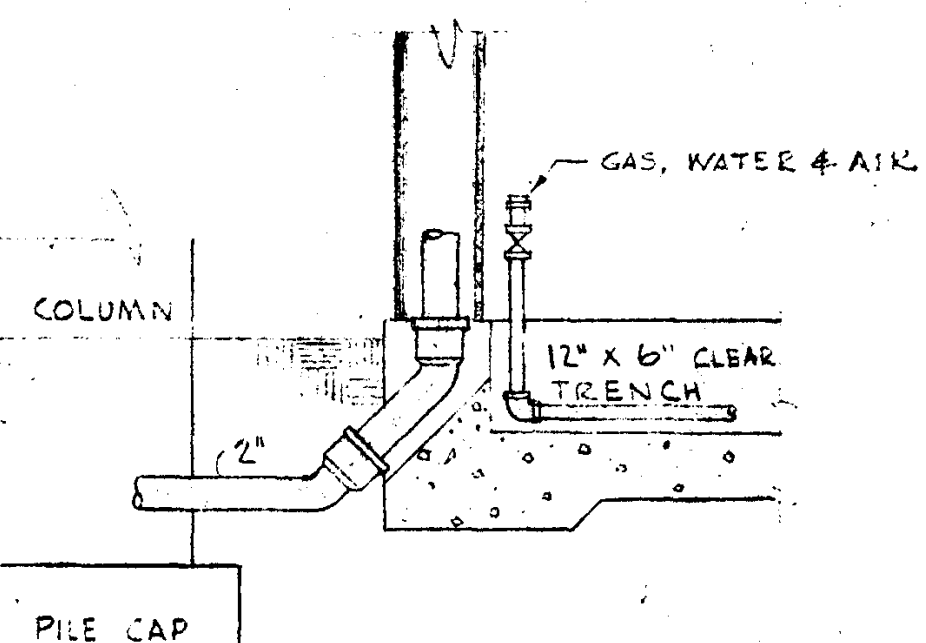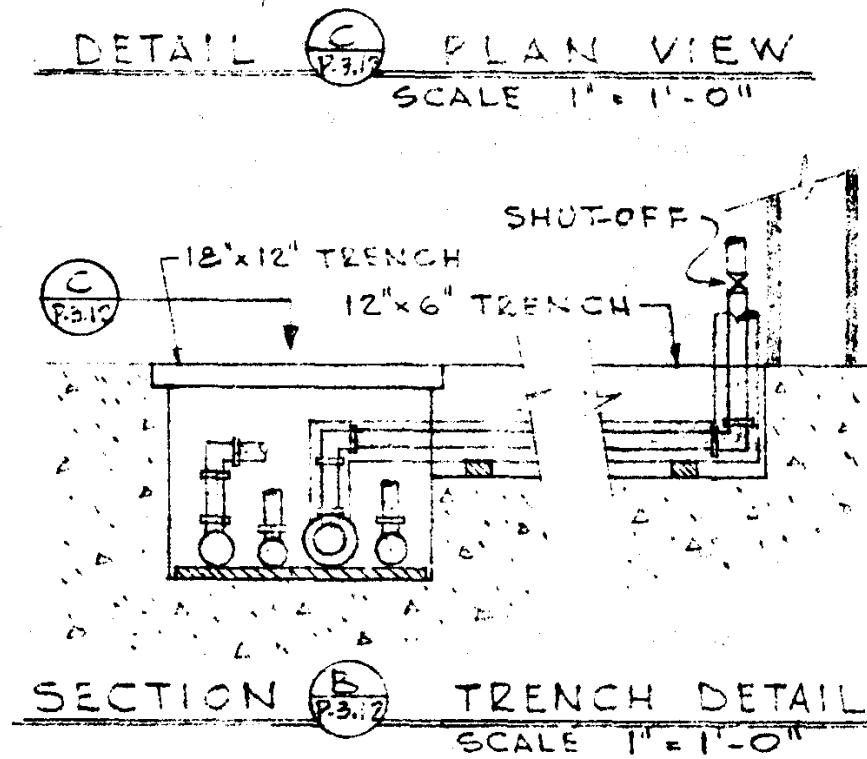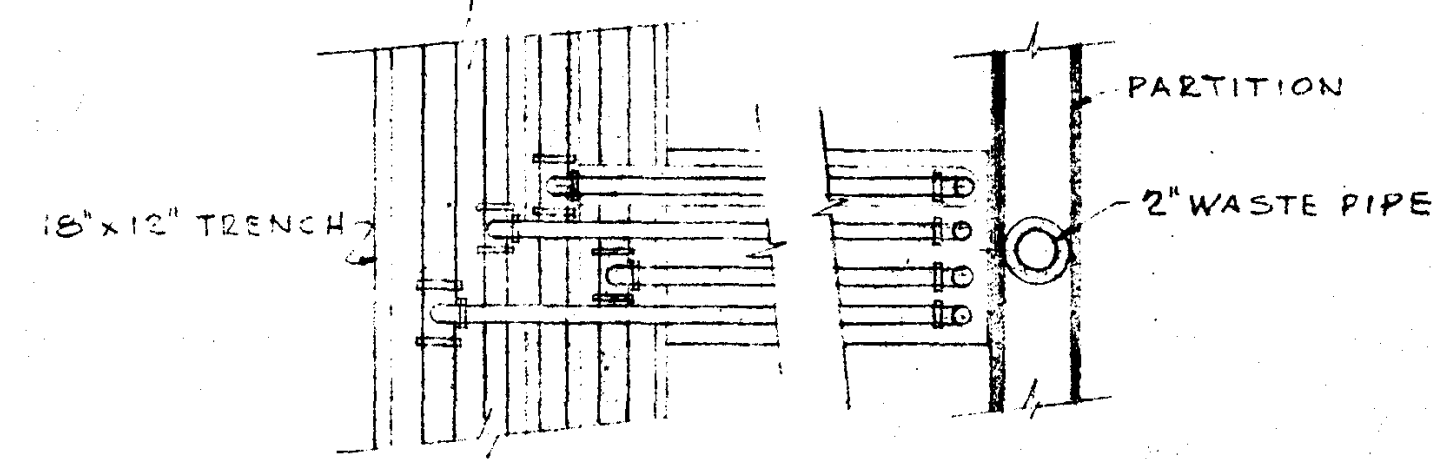


SECTION 'A'
(TYPICAL FOR ALL SINKS ON
COLUMN LINE #4)

NOTE:
ALL SERVICE TRENCH
BRANCHES SHALL BE ON
CENTER LINE OF SINKS. (TYPICAL)
BRANCH TRENCHES ARE
12"x6" SIZE.

ALTERNATE NO. 2

ALTERNATE NO. 2

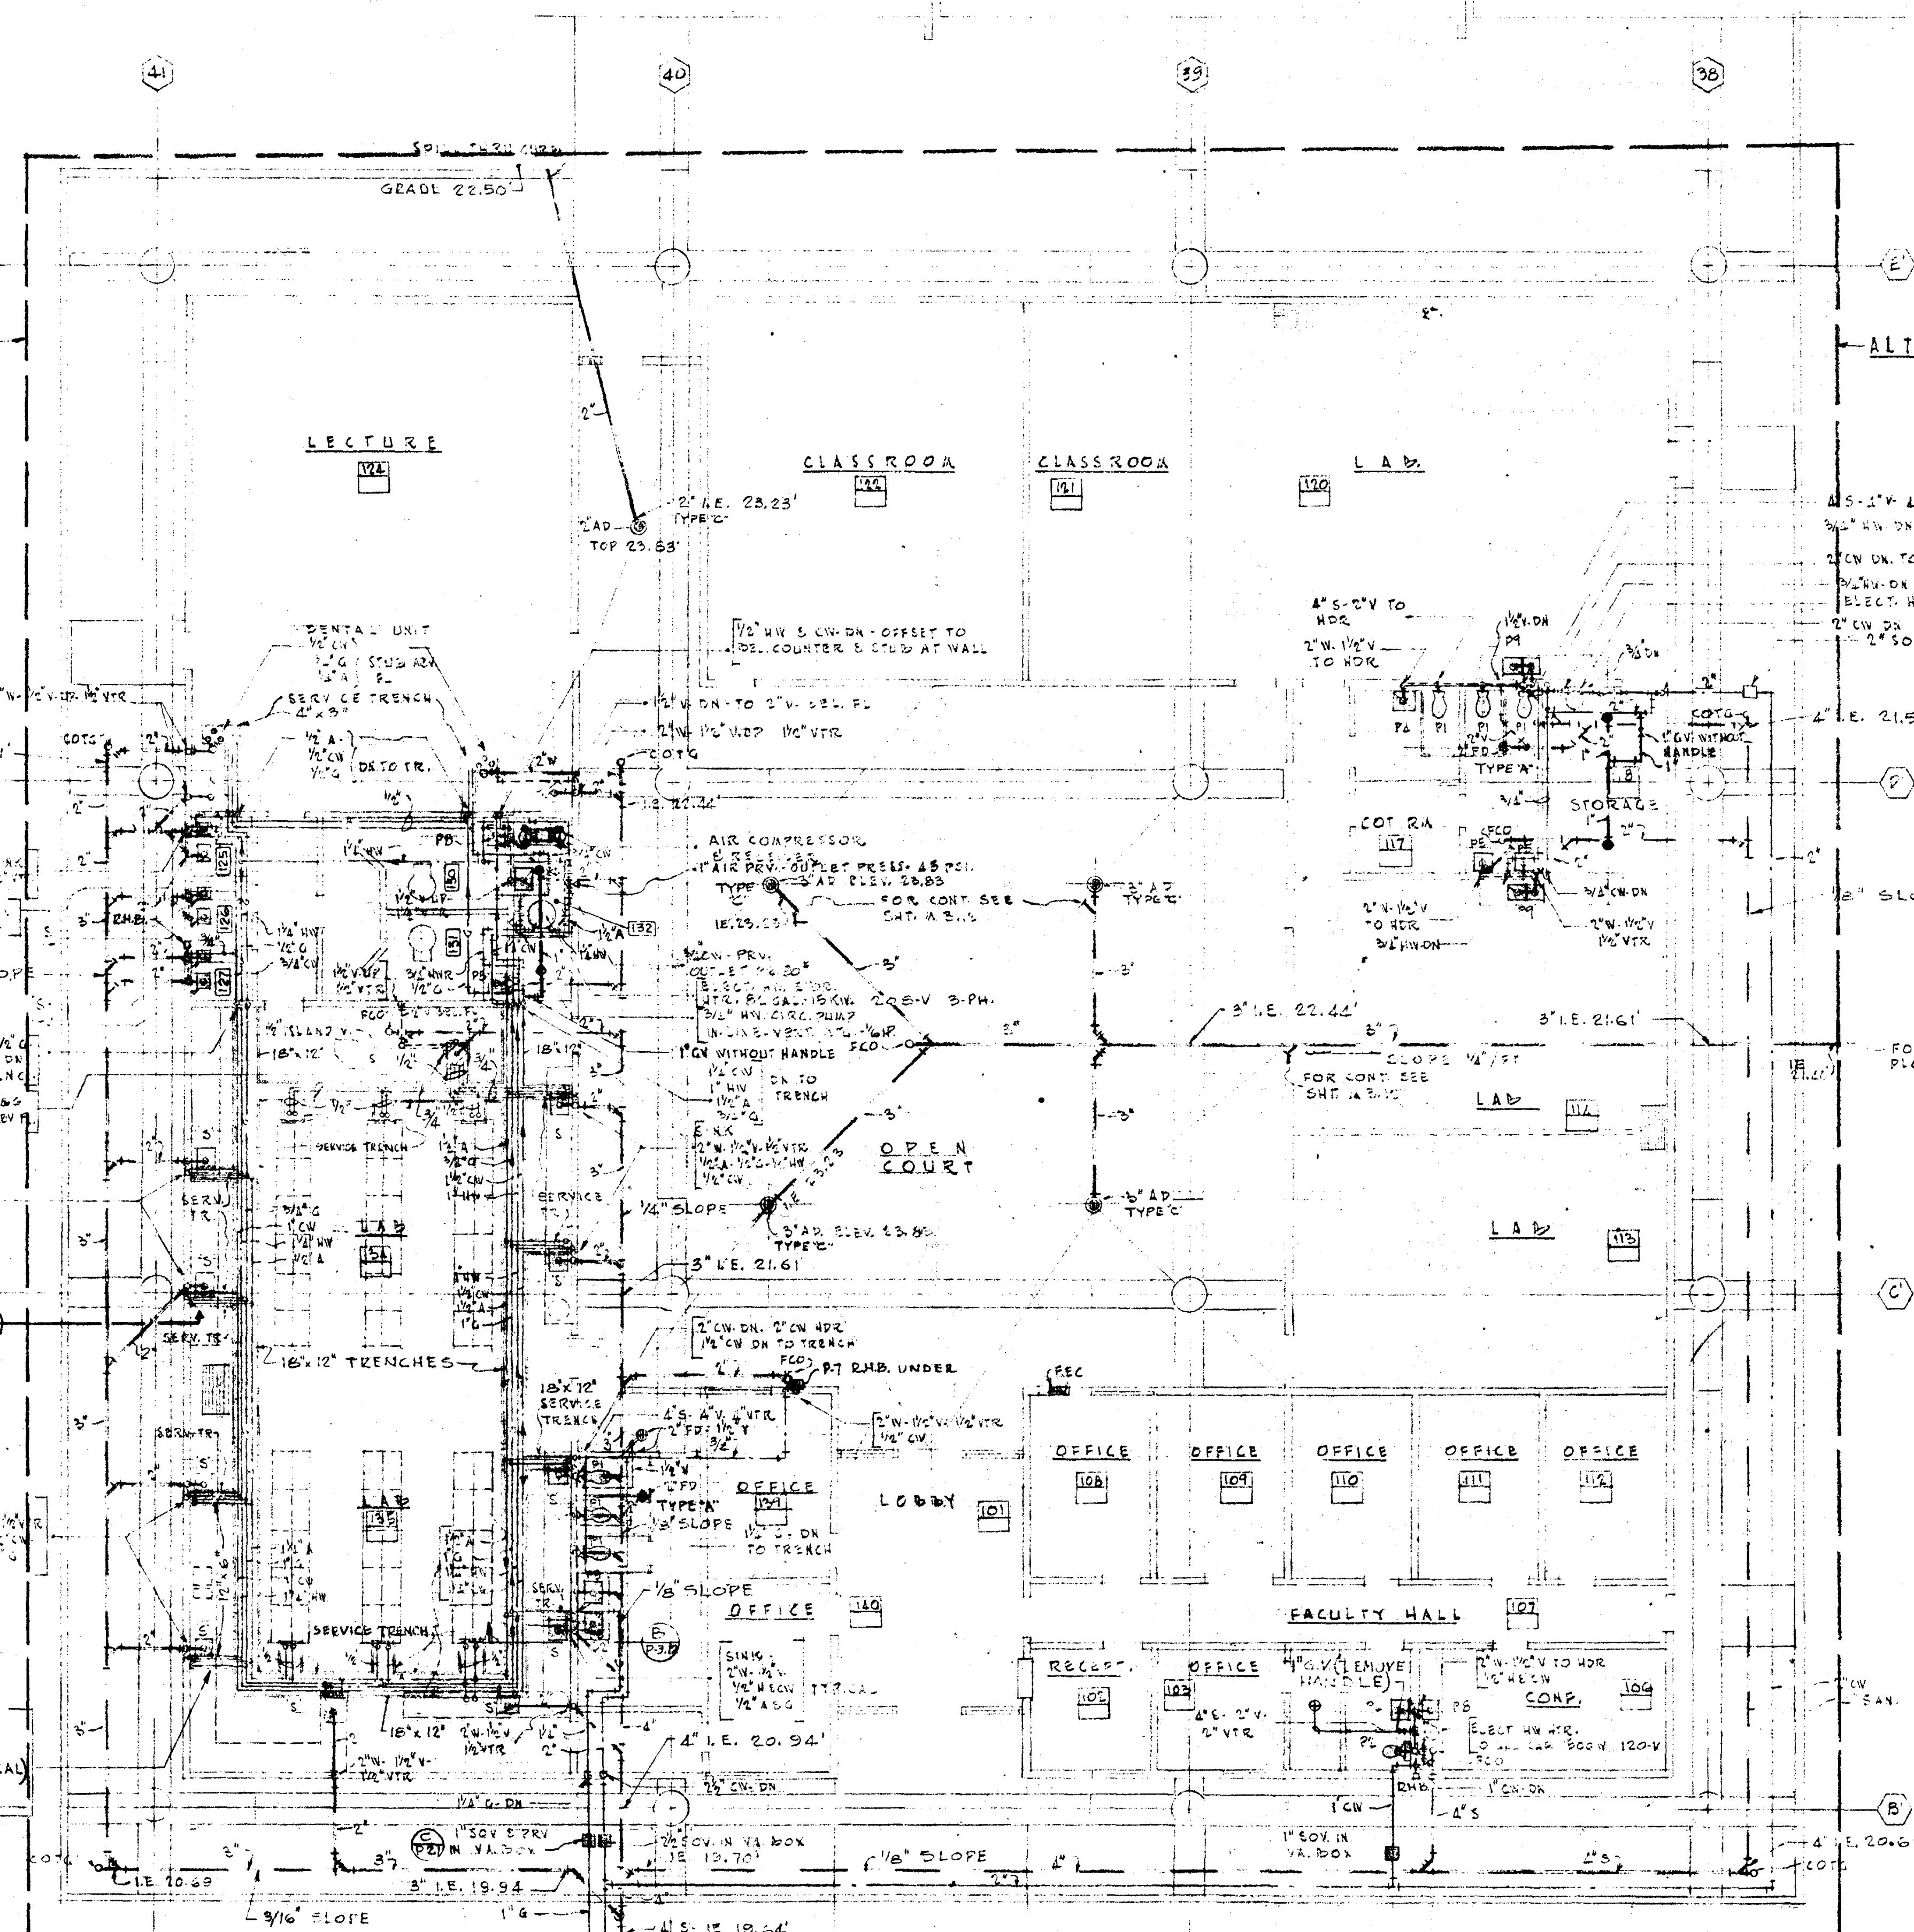

- NOTES:
- 1- WASTE AND VENT PIPING FOR LABORATORY SINKS, DENTAL CHAIRS AND DARK ROOM SINKS IN ROOMS 124, 125, 126, 127, 134 AND 135 SHALL ONLY BE ROUGHED-IN EQUIPMENT INSTALLATION AND FINAL CONNECTION IS NOT IN THIS CONTRACT.
 - 2- WATER, GAS AND AIR PIPING IN ROOMS 124, 125, 126, 127, 134 AND 135 FOR LABORATORY SINKS, DENTAL CHAIRS, WALL BENCHES, ISLAND TABLES AND DARK ROOM SINKS SHALL BE ROUGHED-IN FOR AS INDICATED ON THE DRAWINGS. PIPING IN ROOMS 124, 125, 126, 127, 134 AND 135 SHALL BE RUN IN FLOOR TRENCHES. IN ROOMS 125, 126, 127, 130, 131 AND 132, PIPING SHALL BE RUN ABOVE SUSPENDED CEILING. WATER, GAS AND AIR PIPING FROM TRENCHES TO EQUIPMENT SHALL EXTEND AT LEAST 6" ABOVE FLOOR AND BE PROVIDED WITH A SHUT-OFF VALVE AND CAP. THE PIPING BEYOND VALVED AND CAPPED EXTENSIONS AND FINAL CONNECTIONS IS NOT IN THIS CONTRACT.
 - 3- CONTRACTOR SHALL SECURE SHOP DRAWINGS OF ALL PIPING EQUIPMENT TO BE INSTALLED AND ROUGH-IN PIPING AS REQUIRED SO EXTENSIONS AND/OR CONNECTIONS TO THIS EQUIPMENT CAN BE MADE EASILY. EXTENSION AND CONNECTION OF THIS PIPING IS NOT IN THIS CONTRACT.
 - 4- AIR COMPRESSOR IN JANITOR'S CLOSET AND ITS INSTALLATION IS NOT IN THIS CONTRACT. PROVIDE COMPRESSED AIR PIPING FROM OUTLET OF RECEIVER TO PIPING SYSTEM.
 - 5- AIR TO DENTAL CHAIRS SHALL BE FULL PRESSURE FROM RECEIVER. PROVIDE AN AIR PRESSURE REDUCING VALVE ON AIR SUPPLY LINE. FOR ALL OTHER LABORATORY EQUIPMENT, REDUCE PRESSURE TO 45 POUNDS.
 - 6- WATER SUPPLY LINE TO DENTAL CHAIRS SHALL BE REDUCED TO 50 POUNDS. INSTALL 1/2" SHUT-OFF VALVE IN SUB-BASE OF EACH CHAIR.
 - 7- SEE ARCHITECTURAL DETAIL A-18.1 FOR PARTIAL LABORATORY EQUIPMENT LAYOUT.



STRUCTURAL ENGINEERS BRANDOW & JOHNSTON J.A. MARTIN & ASSOCIATES	DESIGNED J.A. MARTIN	ARCHITECT WILLIAM L. PEREIRA & ASSOCIATES	APPROVED WILLIAM L. PEREIRA
MECHANICAL ENGINEERS RALPH E. PHILLIPS, INC.	DRAWN BY RALPH E. PHILLIPS	ENGINEER RALPH E. PHILLIPS	CHECKED BY RALPH E. PHILLIPS
ELECTRICAL ENGINEERS RALPH E. PHILLIPS, INC.	CHECKED BY RALPH E. PHILLIPS	CIVIL ENGINEERS G. SHULMAN & ASSOCIATES	NOTED BY G. SHULMAN

ASSOCIATED ARCHITECTS:
WILLIAM L. PEREIRA & ASSOCIATES
A. QUINCY JONES, FREDERICK E. EMMONS & ASSOCIATES
BLUROCK ELLERBROEK & ASSOCIATES


URBANUS SQUARE • MACARTHUR BOULEVARD AT FORD ROAD
TELEPHONE 714/575-2640 • CORONA DEL MAR, CALIFORNIA

GOLDEN WEST COLLEGE
HUNTINGTON BEACH, CALIFORNIA
ORANGE COAST JUNIOR COLLEGE DISTRICT

UNIT 8223	JOB NO. 8223
PLAN	DATE 6-15-65
	SHEET NO. 18.12

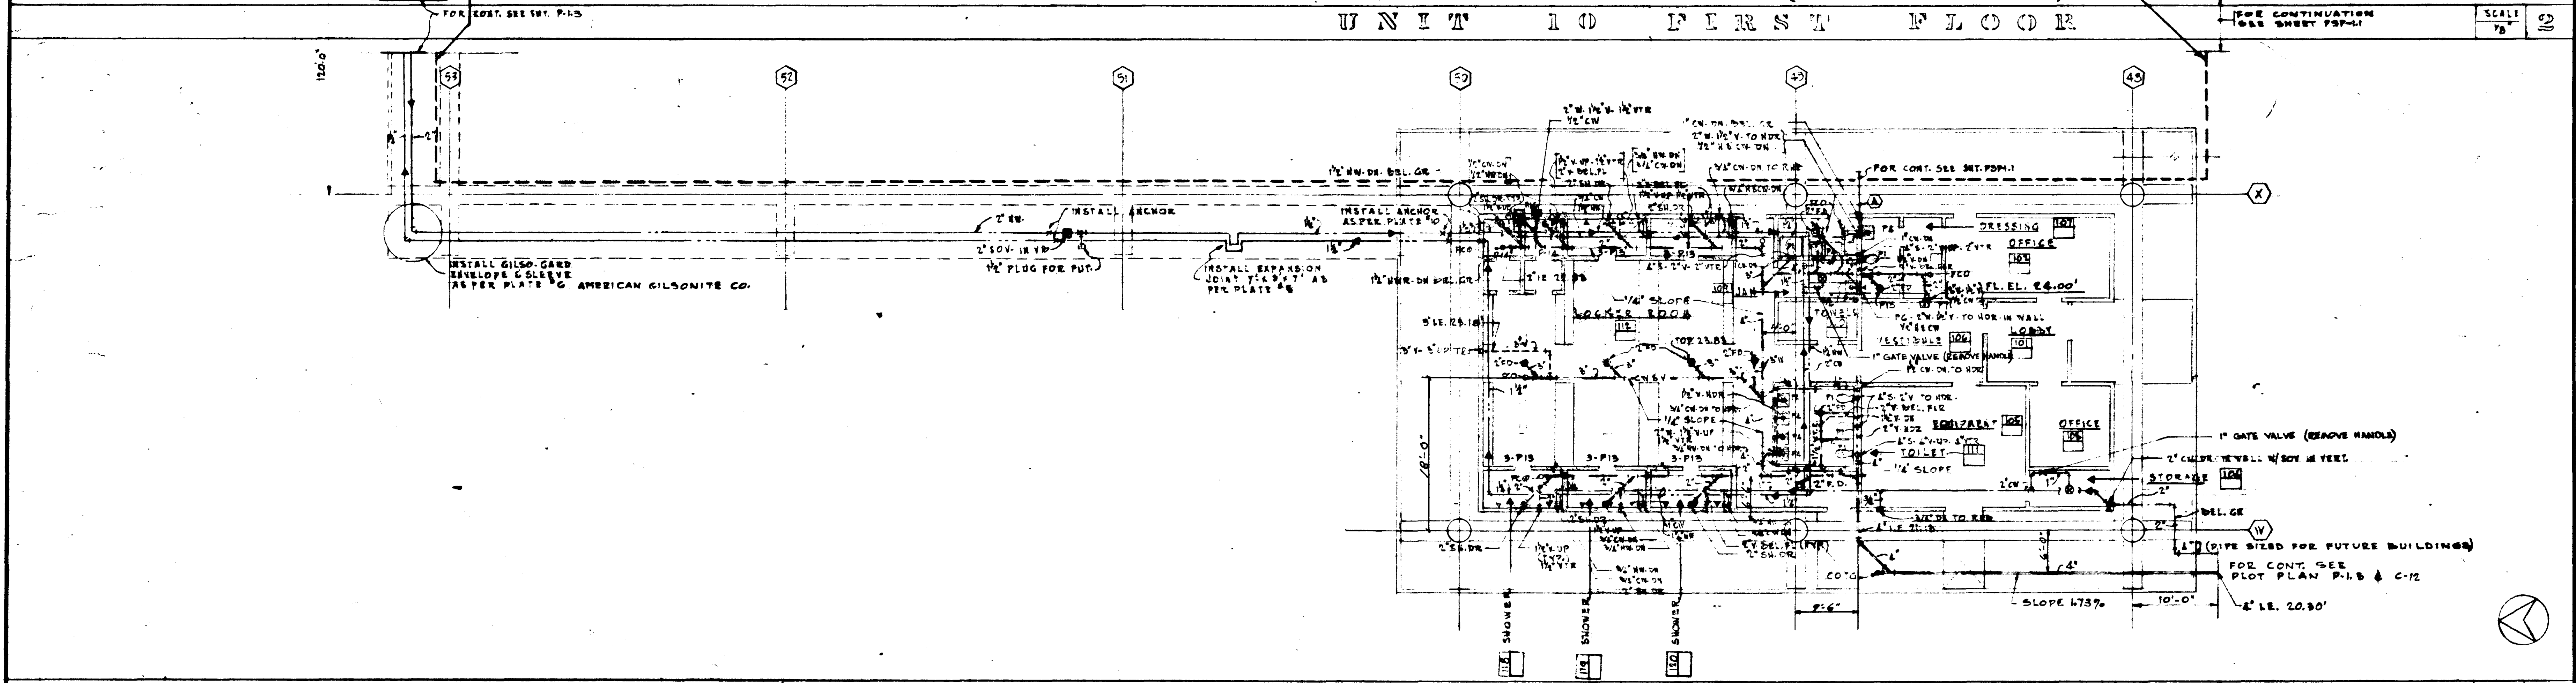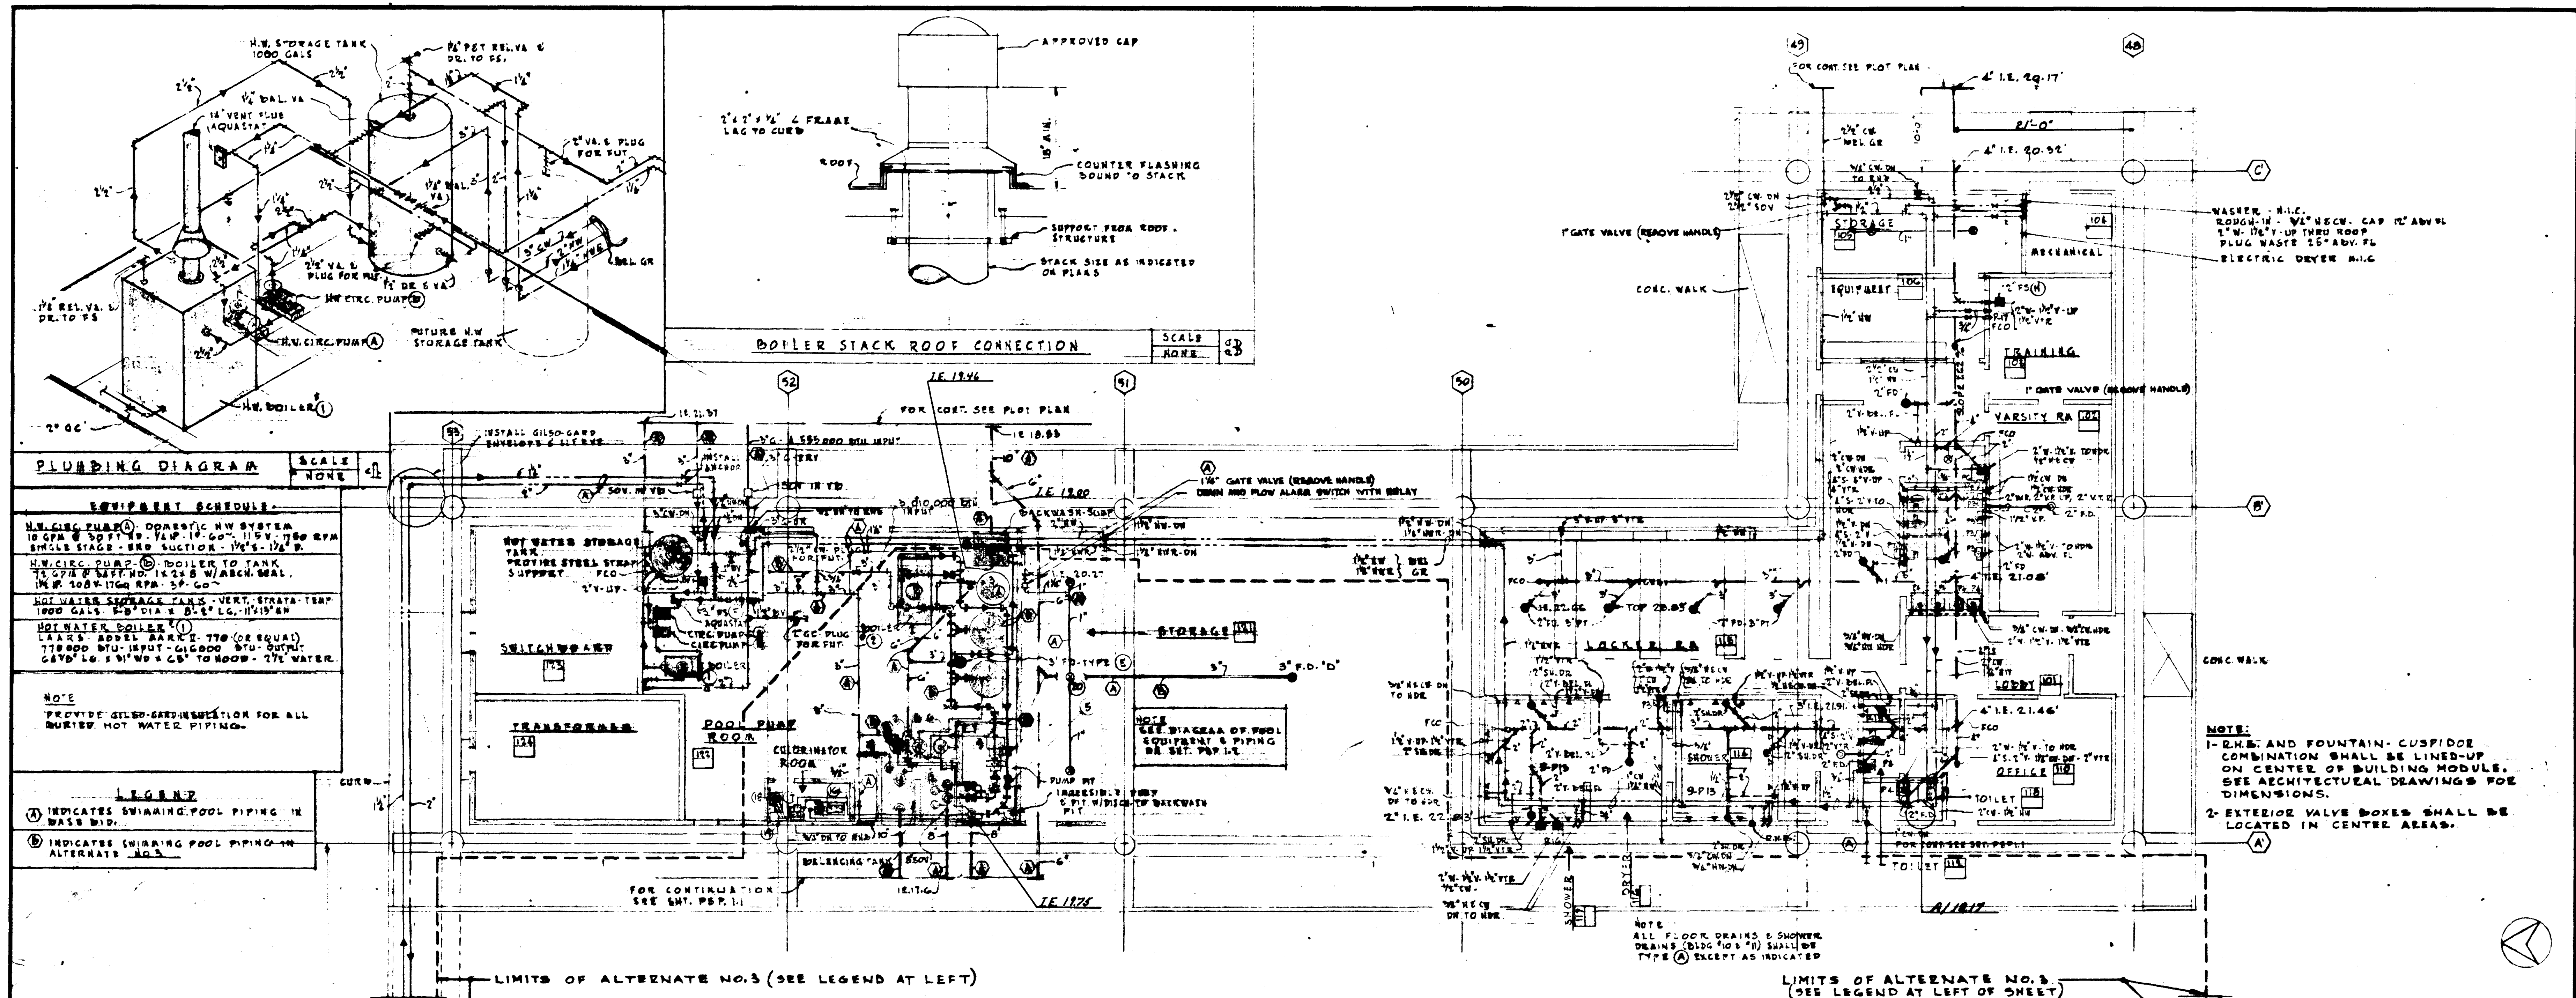


STRUCTURAL ENGINEERS BEARD & JOHNSON J.A. MARTIN & ASSOCIATES RALPH E. PHILLIPS, INC. MECHANICAL ENGINEERS RALPH E. PHILLIPS, INC. ELECTRICAL ENGINEERS RALPH E. PHILLIPS, INC. CIVIL ENGINEERS O. STEINMAN & ASSOCIATES MOFFATT & NICHOL				DESIGNED DRAWN BY CHECKED BY APPROVED STATE PIPE MARSHAL DATE: 12/1/53 BY:				ASSOCIATED ARCHITECTS: WILLIAM L. PEREIRA & ASSOCIATES A. QUINCY JONES, FREDERICK R. EMMONS & ASSOCIATES BLUROCK ELLERBROOK & ASSOCIATES URBANUS SQUARE • MACARTHUR BOULEVARD AT FORD ROAD TELEPHONE 714/675-2640 • CORONA DEL MAR, CALIFORNIA				GOLDEN WEST COLLEGE HUNTINGTON BEACH, CALIFORNIA ORANGE COAST JUNIOR COLLEGE DISTRICT				UNIT 10-11 FLOOR PLANS JOB NO. 1004 DATE 6-15-65 SHEET NO. 13.15			
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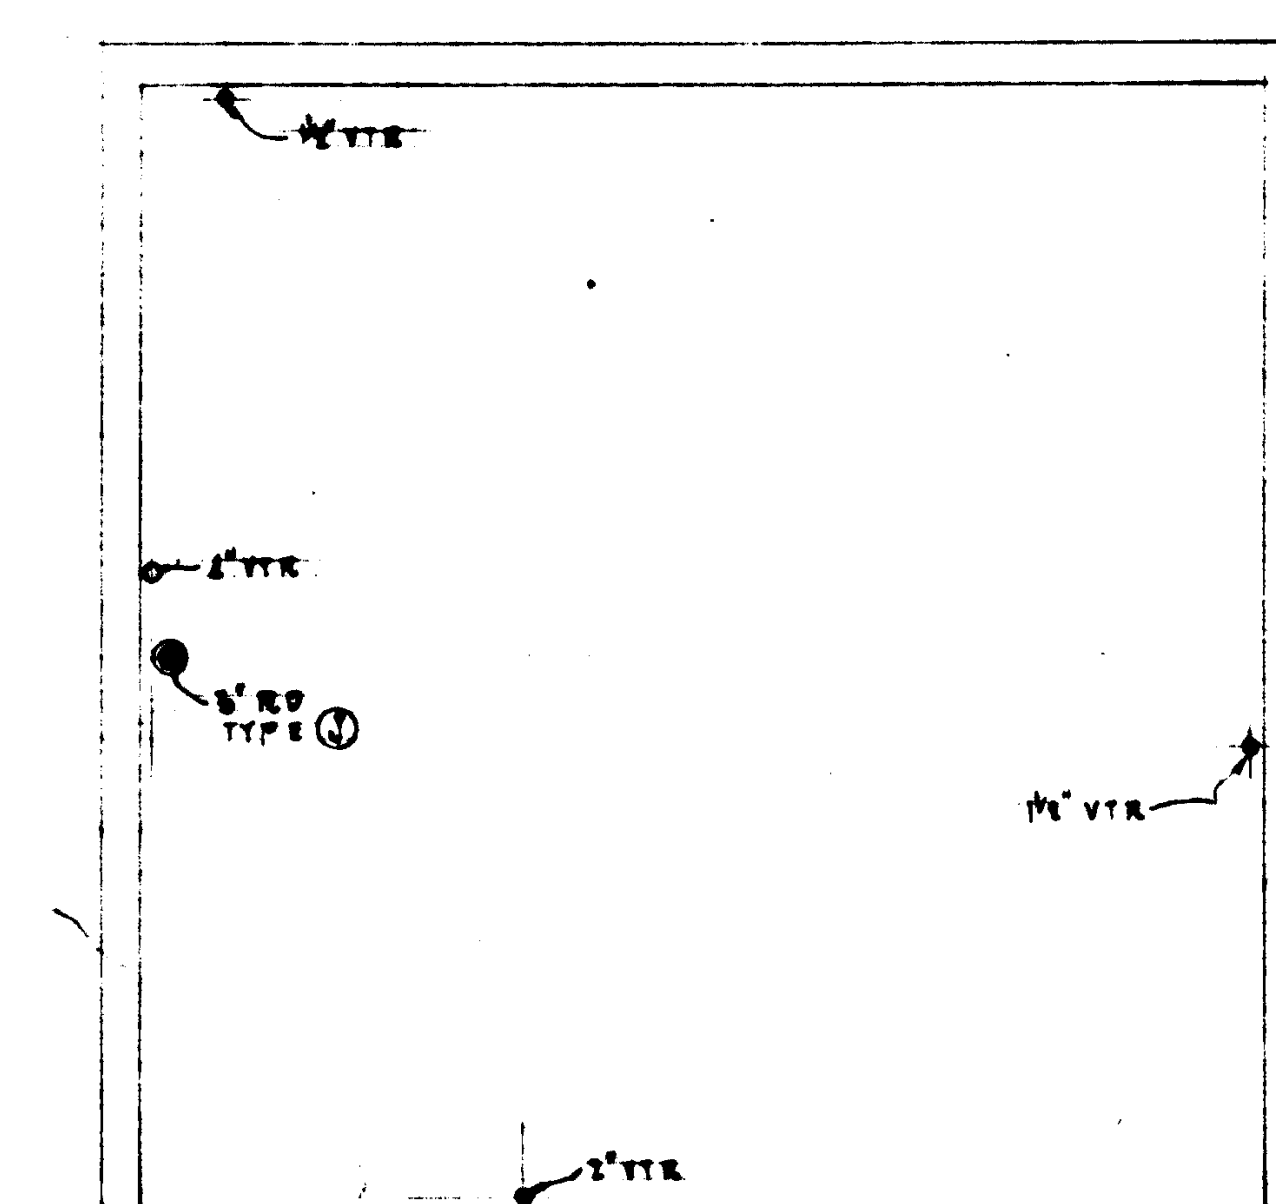
FIRST FLOOR

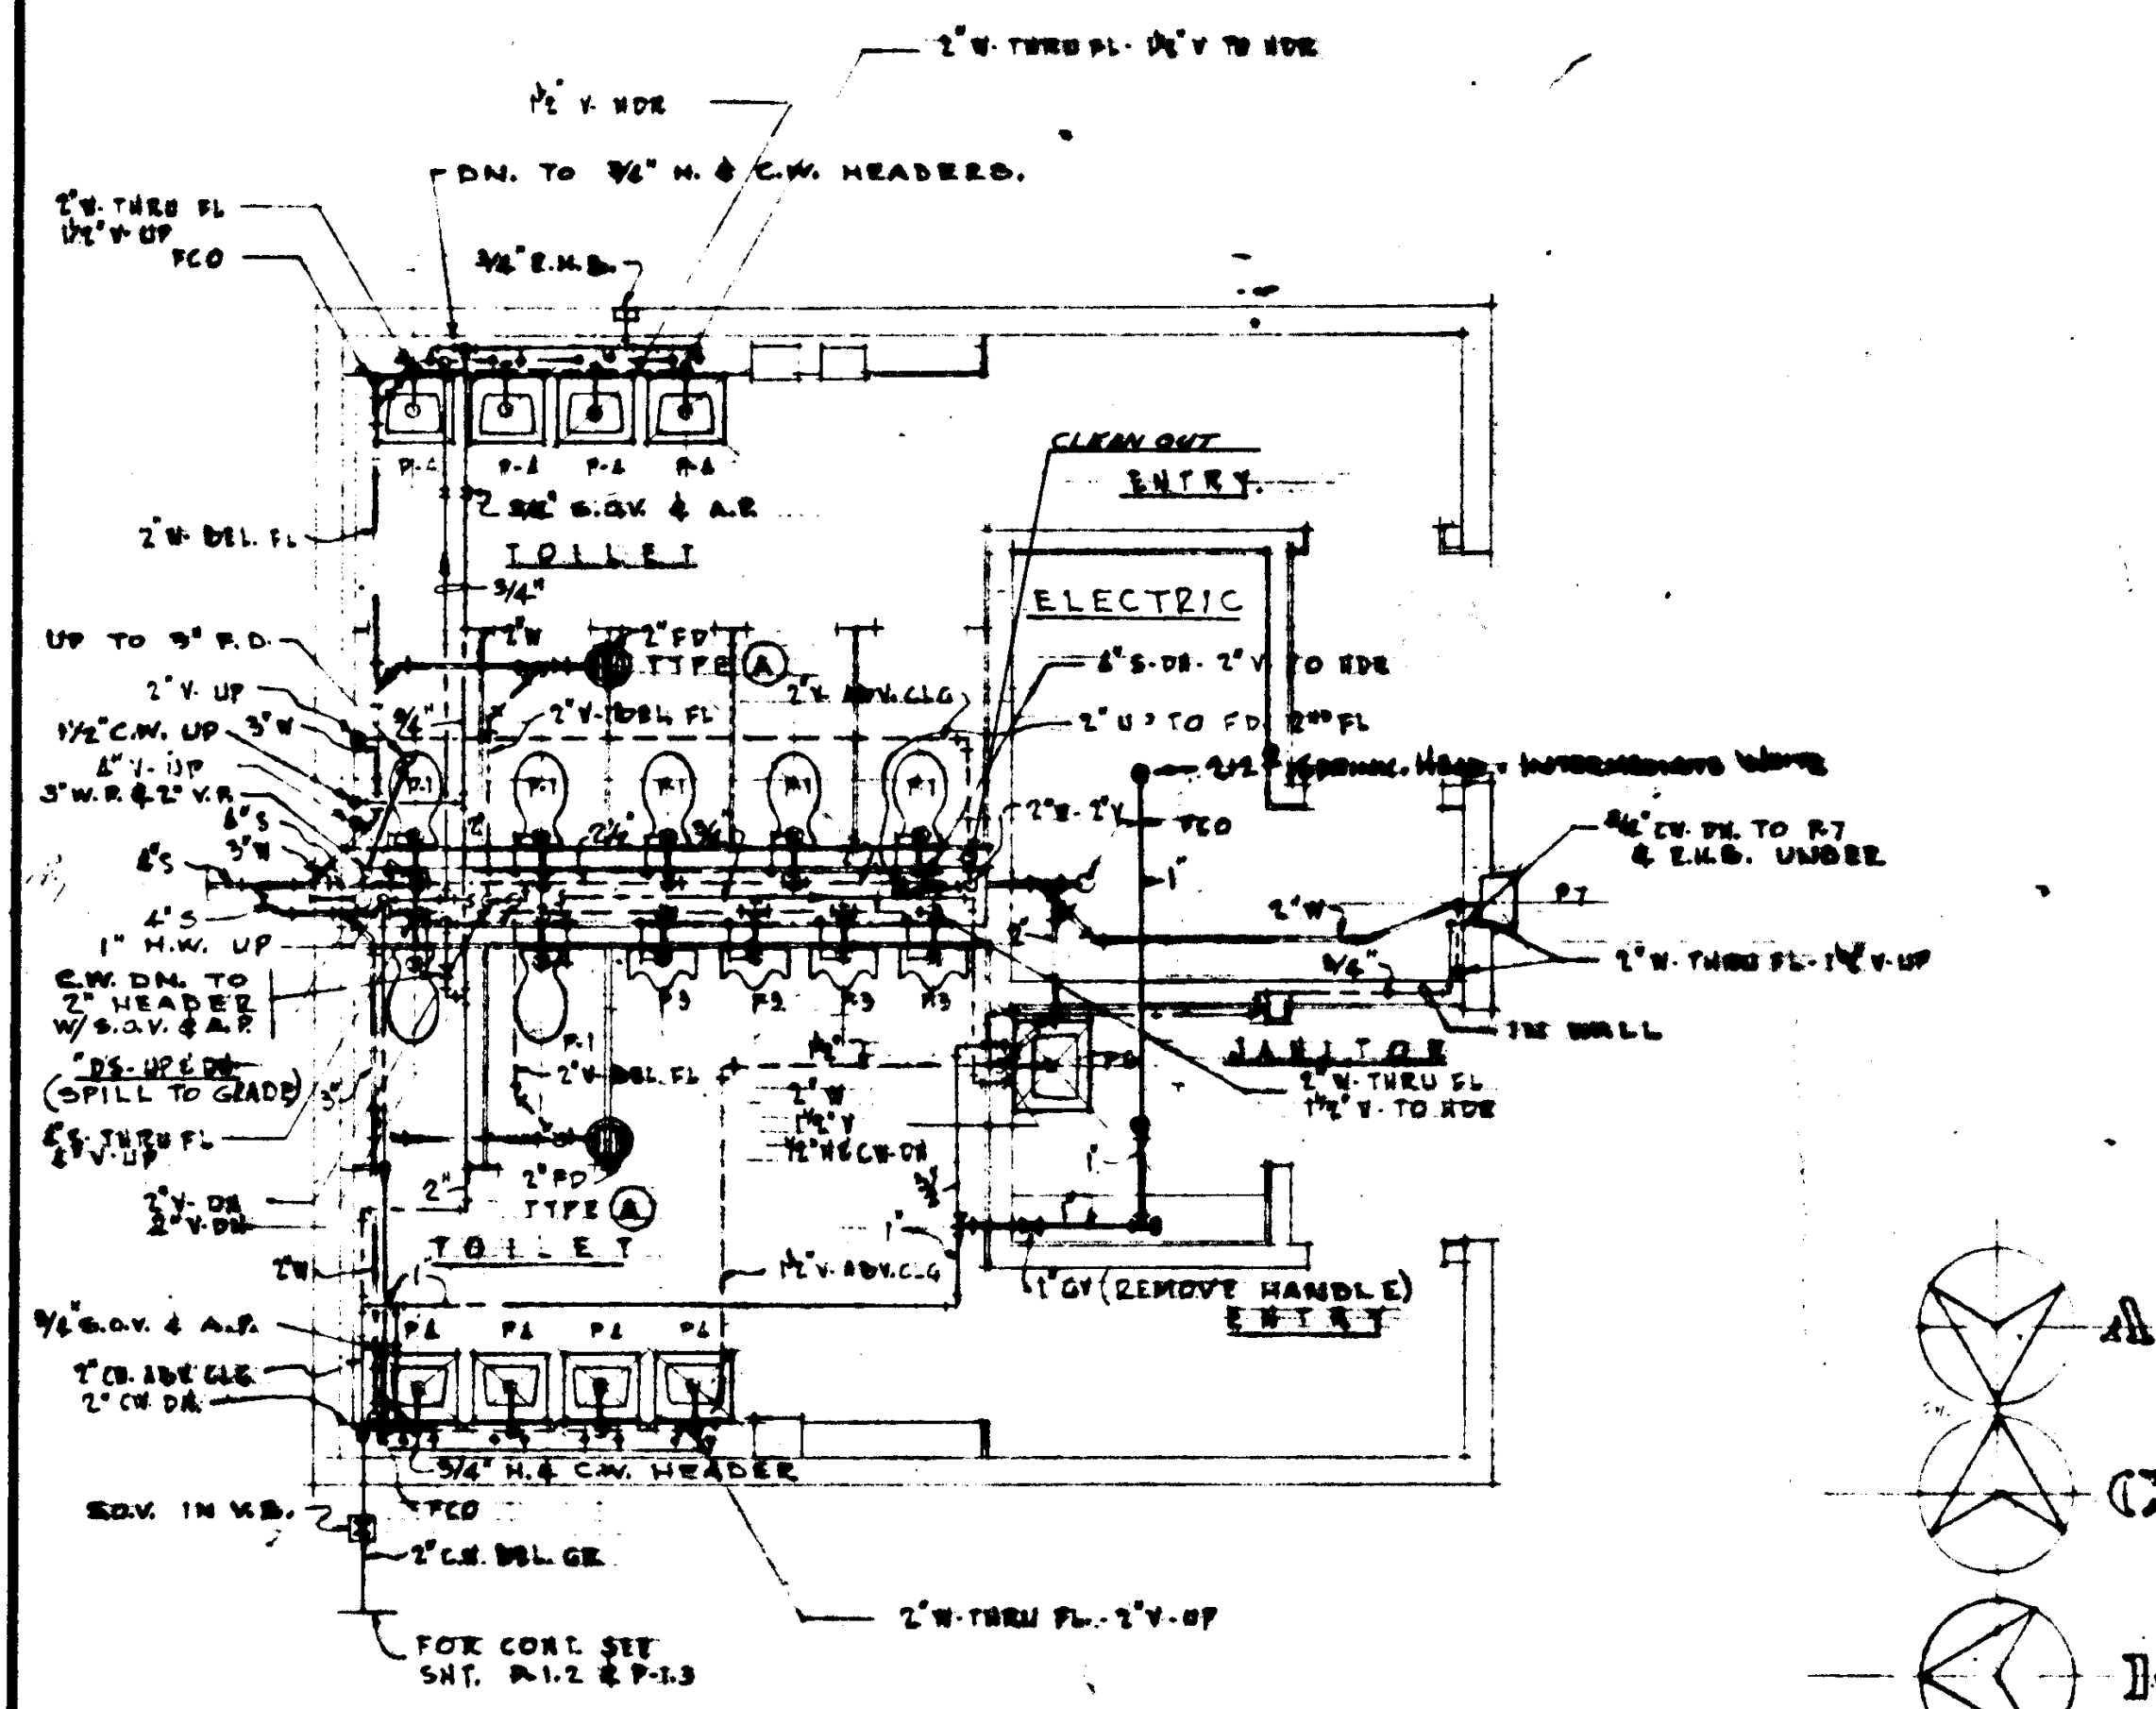SCALE 1/4" = 1'-0"




SECOND FLOOR

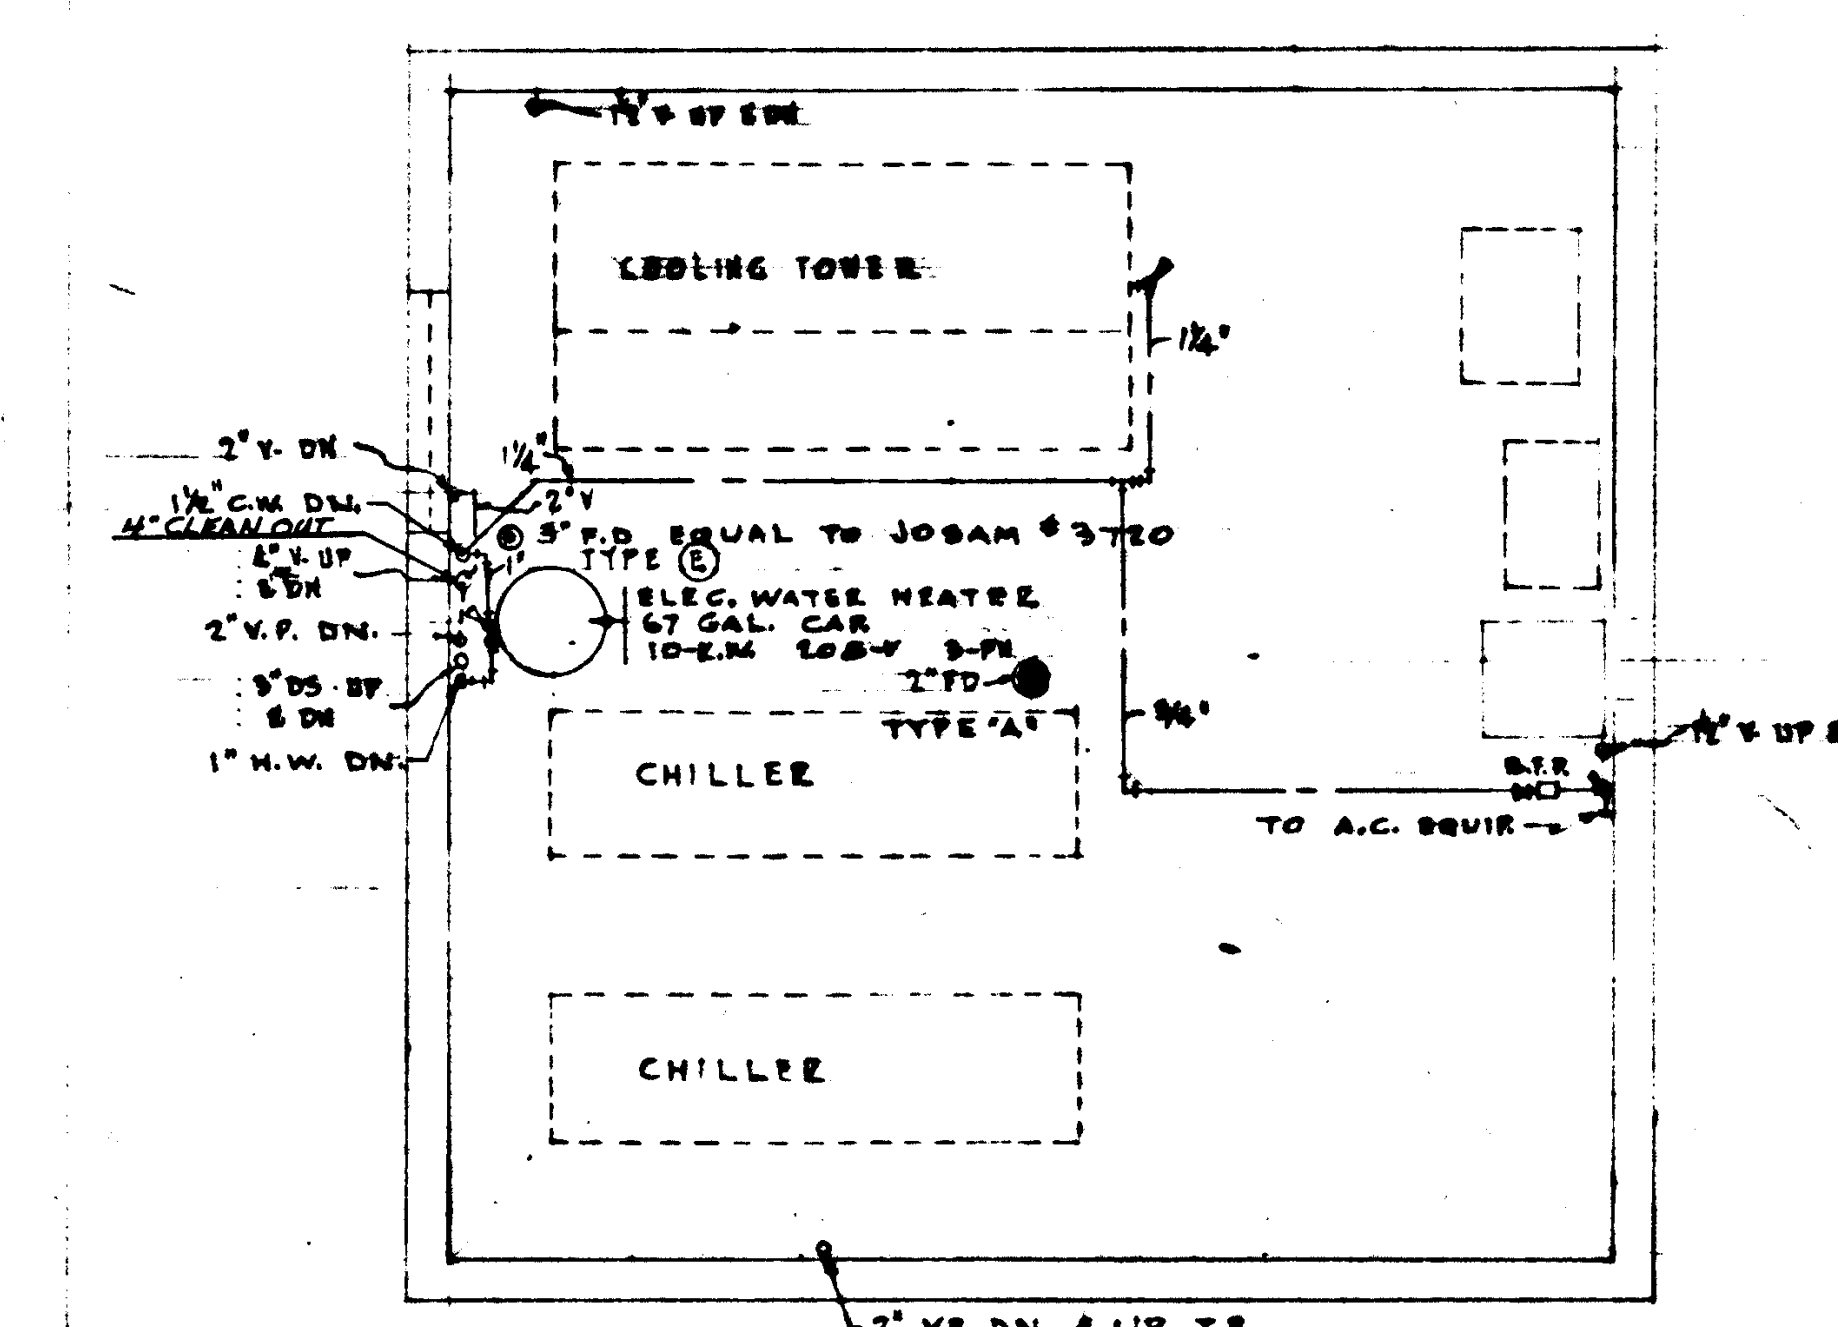SCALE 1/4" = 1'-0"



ROOF

SCALE 1/4" = 1'-0"

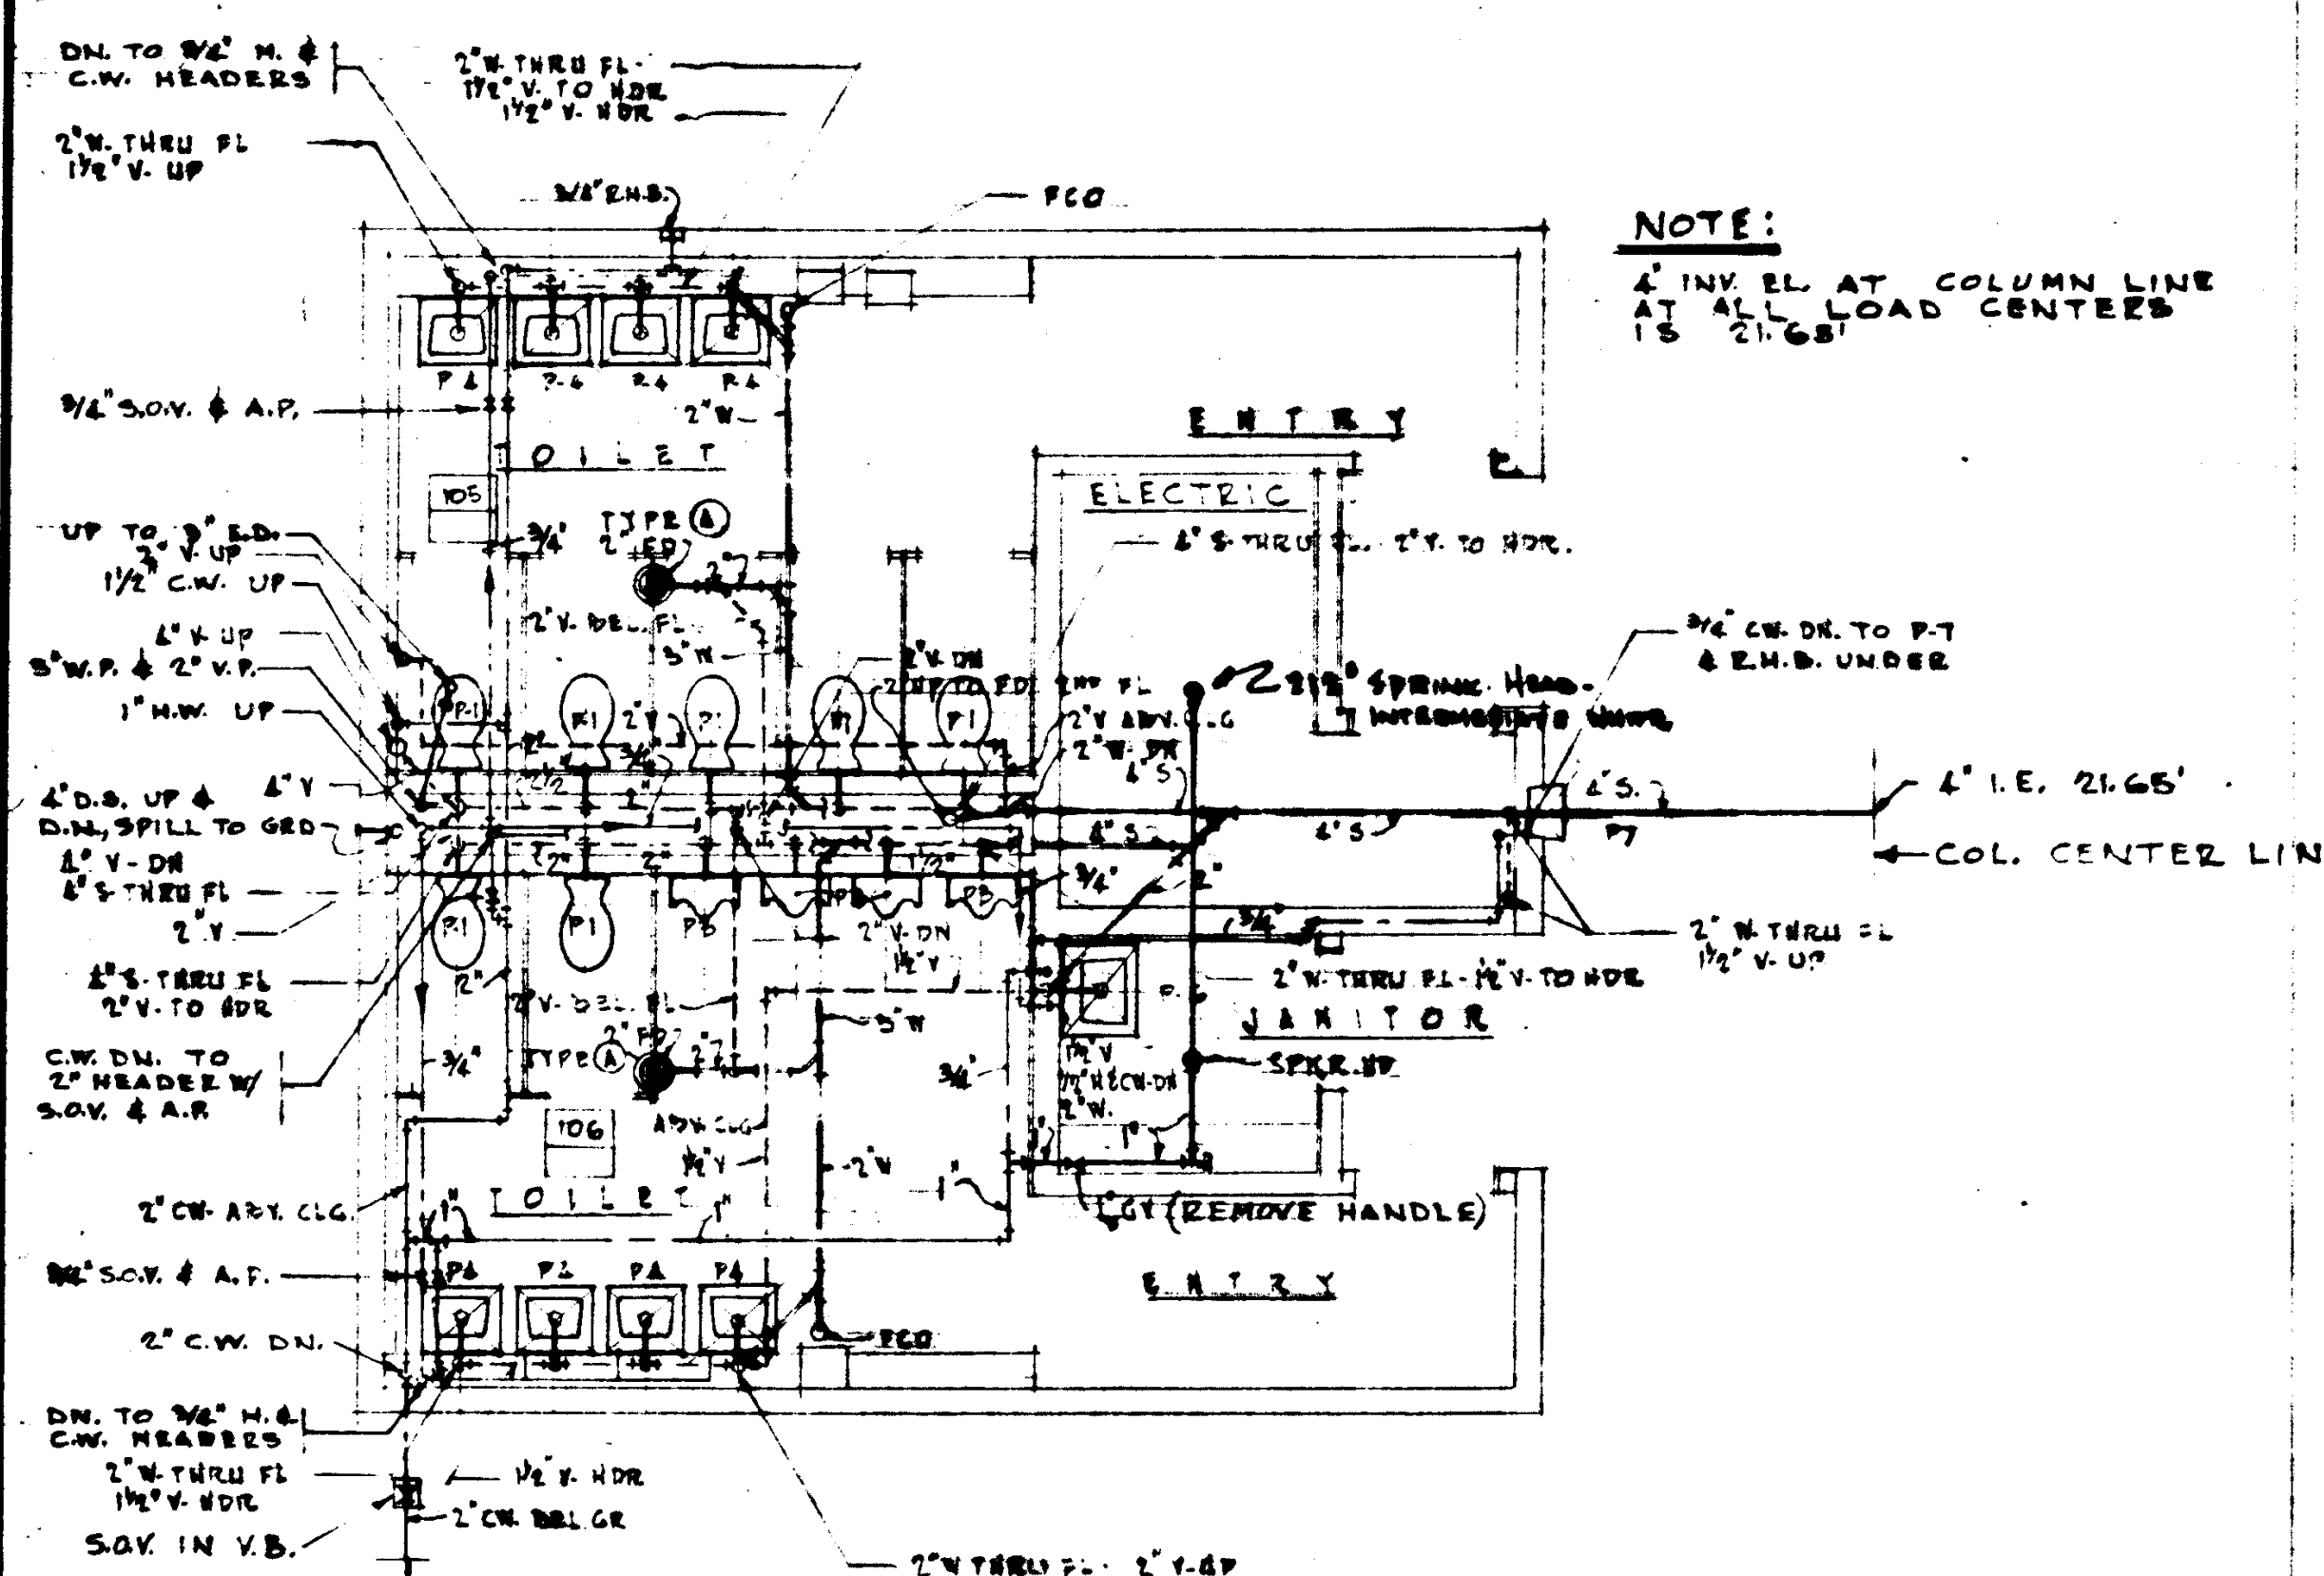

FIRST FLOOR

SCALE 1/4" = 1'-0"

NO.	REVISIONS
1	
2	
3	
4	
5	
6	
7	
8	
9	
10	


ASSOCIATED ARCHITECTS:
WILLIAM L. PEREIRA & ASSOCIATES
QUINCY JONES-FREDERICK E. EDMONDS & ASSOCIATES
BLUROCK ELLERBROOK & ASSOCIATES

APPROVED
STATE FIRE MARSHAL
DATE: JUN 21 1965

URBANUS SQUARE • MACARTHUR BOULEVARD AT FORD ROAD
TELEPHONE 714/675-2640 • CORONA DEL MAR, CALIFORNIA

GOLDEN WEST COLLEGE
HUNTINGTON BEACH, CALIFORNIA
ORANGE COAST JUNIOR COLLEGE DISTRICT

LOAD CENTER	10-4
FLOOR	6-15-65
PLAN	1-1-1

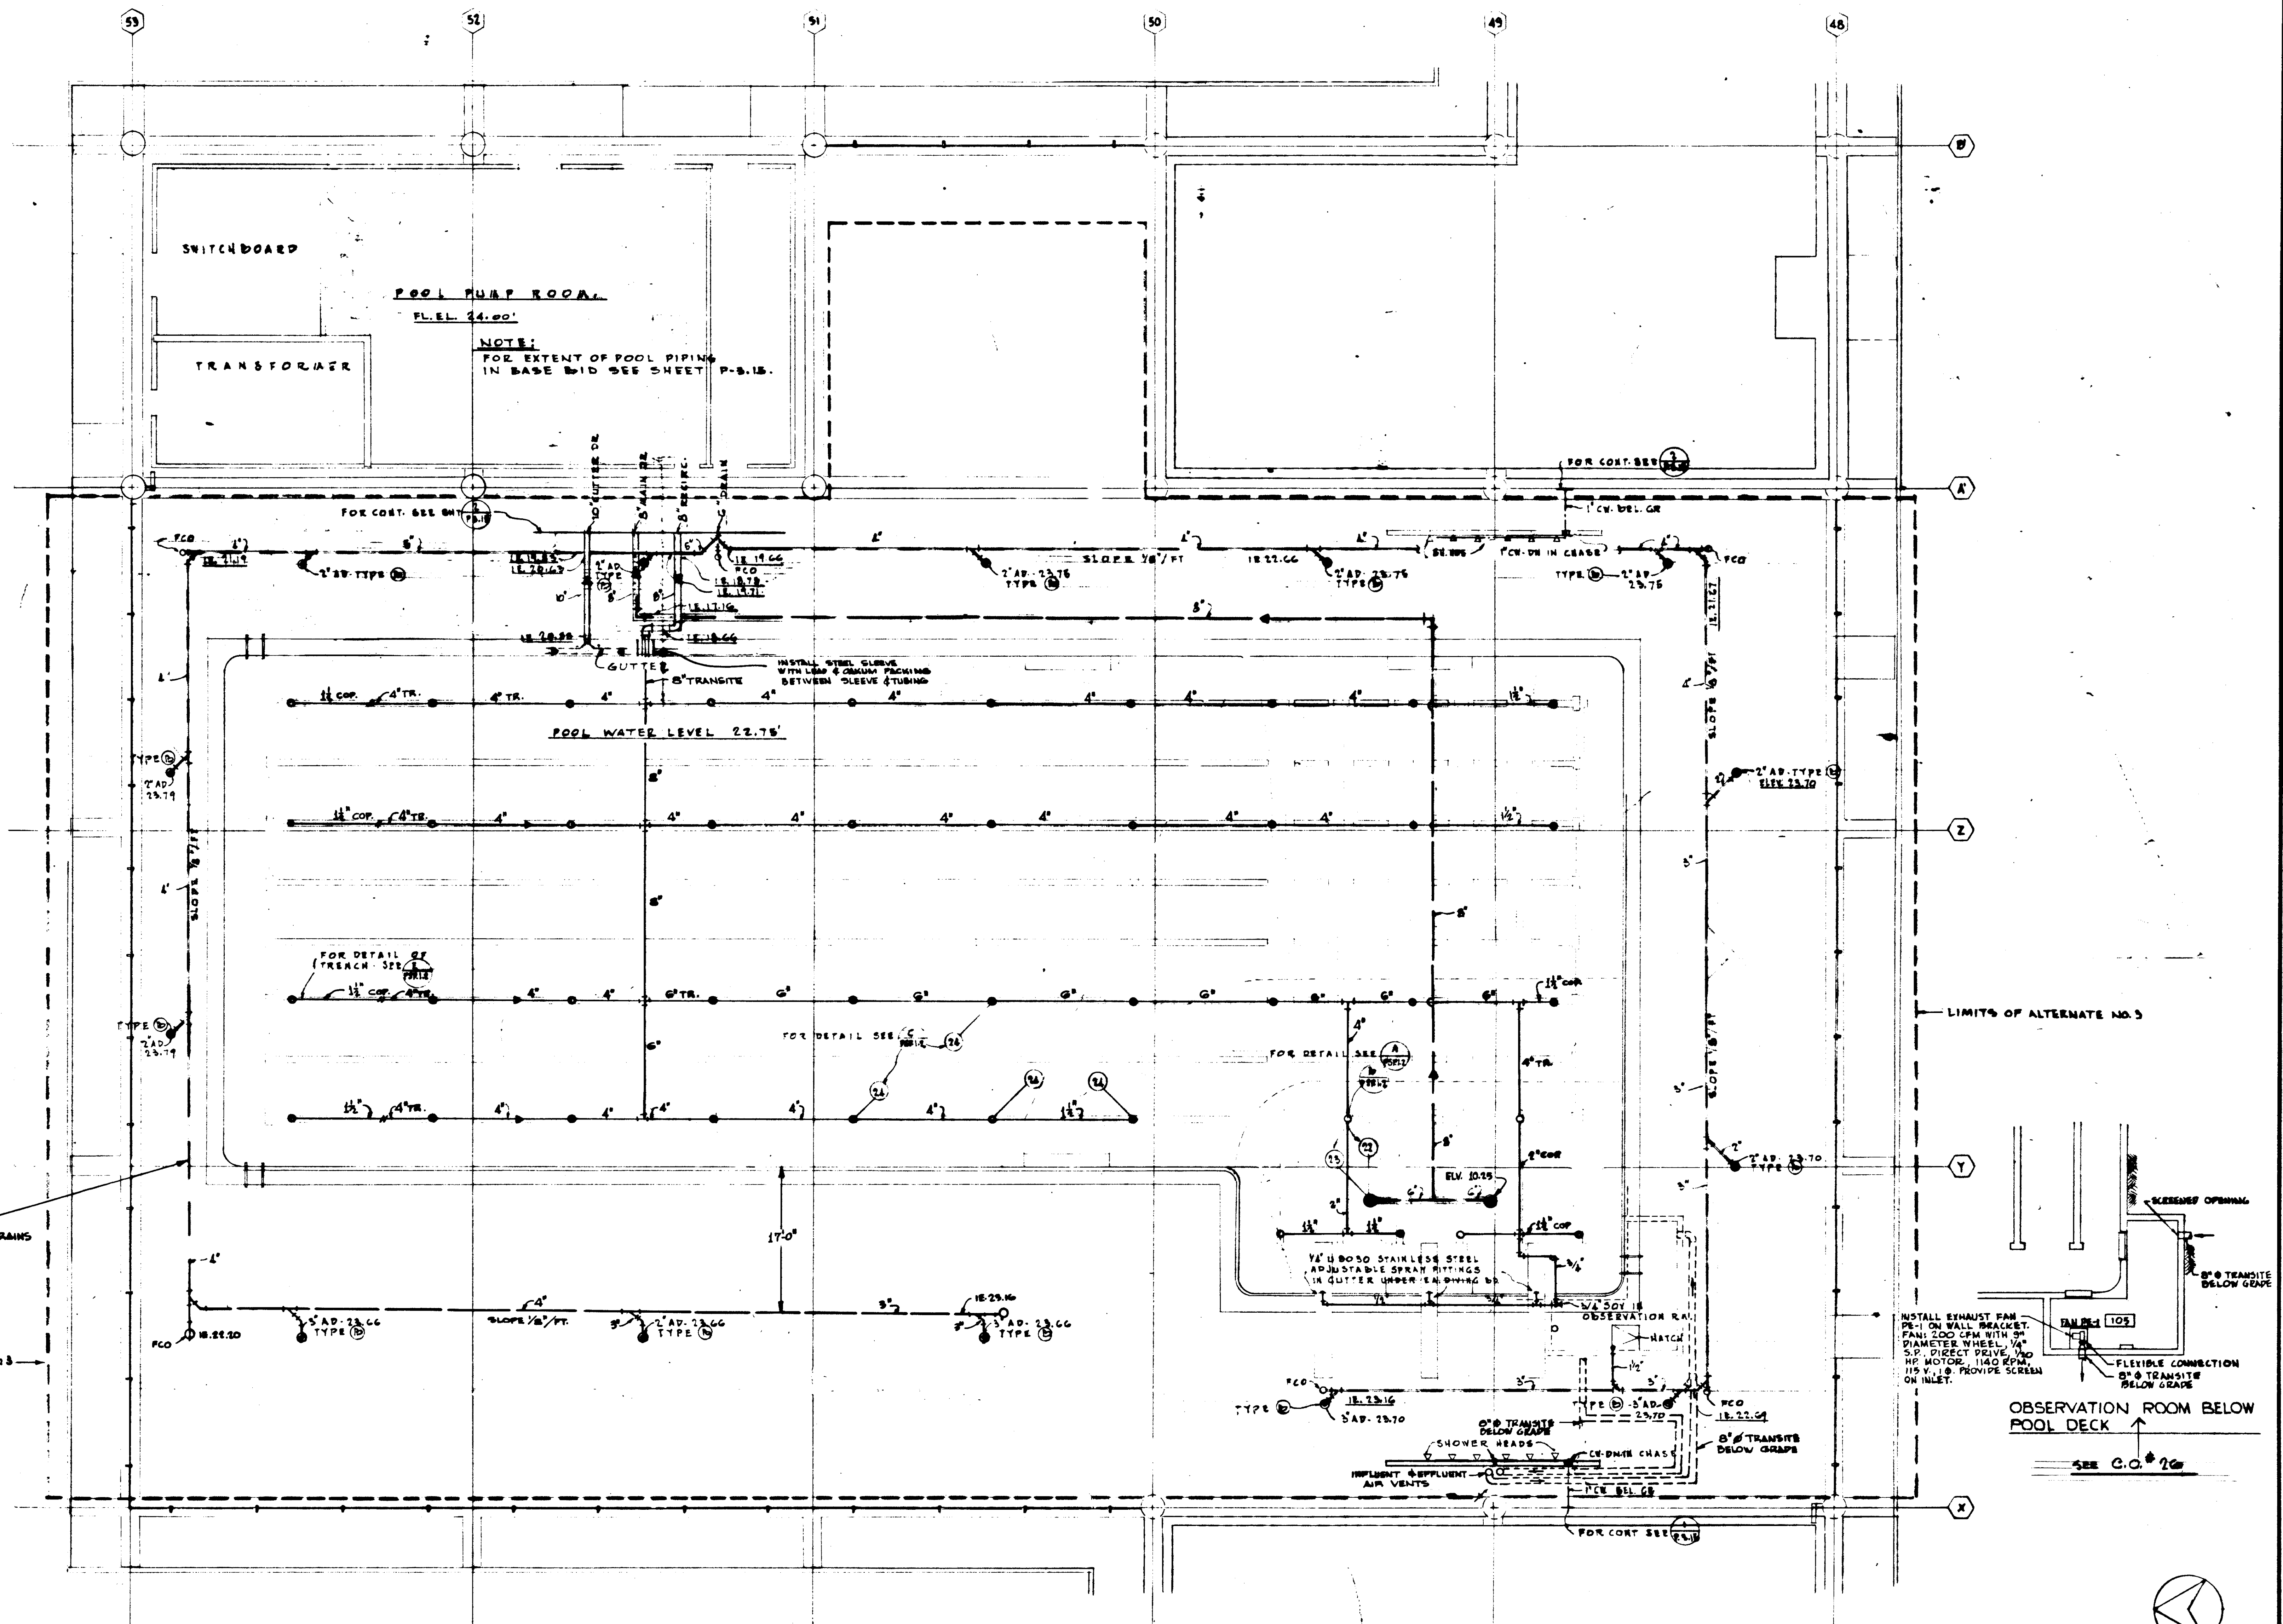

POOL DATA
 CAPACITY: 470,000 GALS.
 SURFACE AREA: 10,520 SQ. FT.
 PERIMETER: 471 LIN. FT.
 TURNOVER PERIOD: 8 HRS.
 BATHING LOAD: 517.

DRAIN LINE LOCATED
 DIRECTLY UNDER DECK DRAINS


LIMITS OF ALTERNATE NO. 3

LIMITS OF ALTERNATE NO. 3


INSTALL EXHAUST FAN
 200 CFM WITH 3\"/>

FLOOR PLAN


REVISIONS 1. 11/15/65 2. 11/15/65 3. 11/15/65 4. 11/15/65 5. 11/15/65 6. 11/15/65 7. 11/15/65 8. 11/15/65 9. 11/15/65 10. 11/15/65	STRUCTURAL ENGINEERS BRANDOW & JOHNSON J.A. MARTIN & ASSOCIATES MECHANICAL ENGINEERS RALPH E. PHILLIPS, INC. ELECTRICAL ENGINEERS RALPH E. PHILLIPS, INC. CIVIL ENGINEERS G. SHULMAN & ASSOCIATES MOFFATT & NICHOLS	DESIGNED J.A. MARTIN DRAWN BY J.A. MARTIN CHECKED BY J.A. MARTIN	ARCHITECT WILLIAM L. PEREIRA APPROVED WILLIAM L. PEREIRA STATE PIPE MARSHAL STATE OF CALIFORNIA JUN 21 1965	ASSOCIATED ARCHITECTS: WILLIAM L. PEREIRA & ASSOCIATES A. QUINCY JONES-FREDERICK & EMMONS & ASSOCIATES BLUNCK HILLENBROCK & ASSOCIATES URBANUS SQUARE • MACARTHUR BOULEVARD AT FORD ROAD TELEPHONE 714/875-2548 • CORONA DEL MAR, CALIFORNIA	GOLDEN WEST COLLEGE HUNTINGTON BEACH, CALIFORNIA ORANGE COAST JUNIOR COLLEGE DISTRICT	SWIMMING POOL FLOOR PLAN JOB NO. DATE 6-15-65 SHEET NO. TOTAL 11
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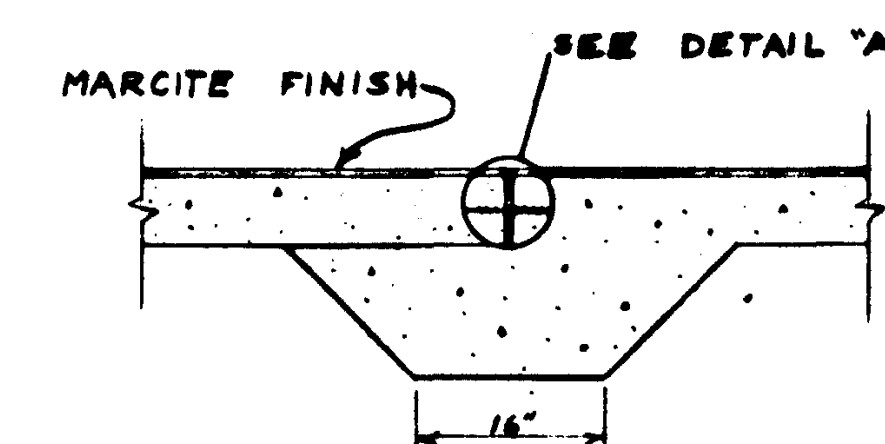
TYPICAL PIPE TRENCH
IN POOL BOTTOM
REF. S-10.2
SCALE 3/4" = 1'-0"

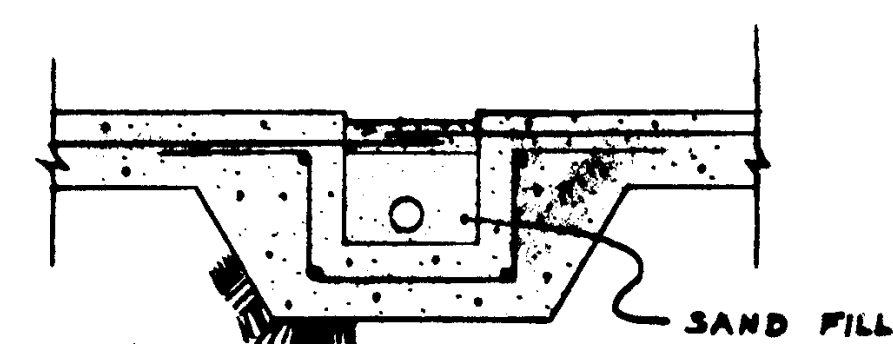


EXPANSION JOINT THROUGH
PIPE TRENCHES
SCALE 3/4" = 1'-0"

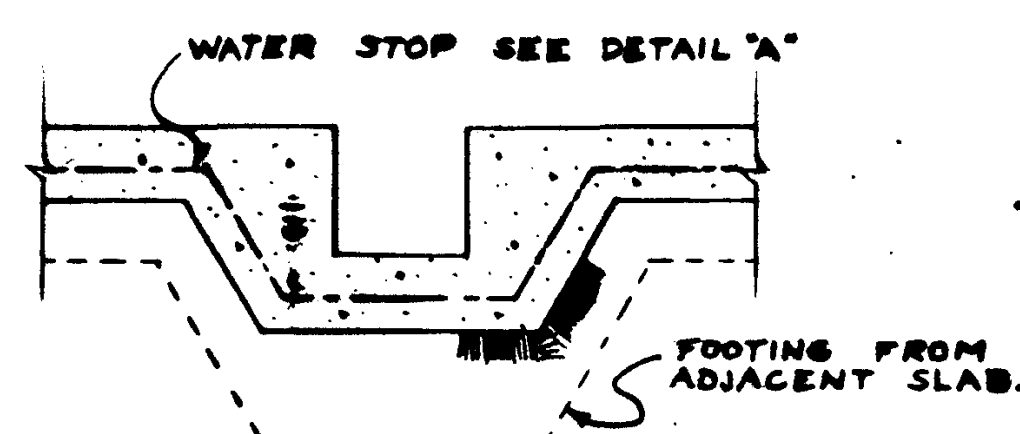

EXPANSION JOINT IN WALL
SCALE 3/4" = 1'-0"

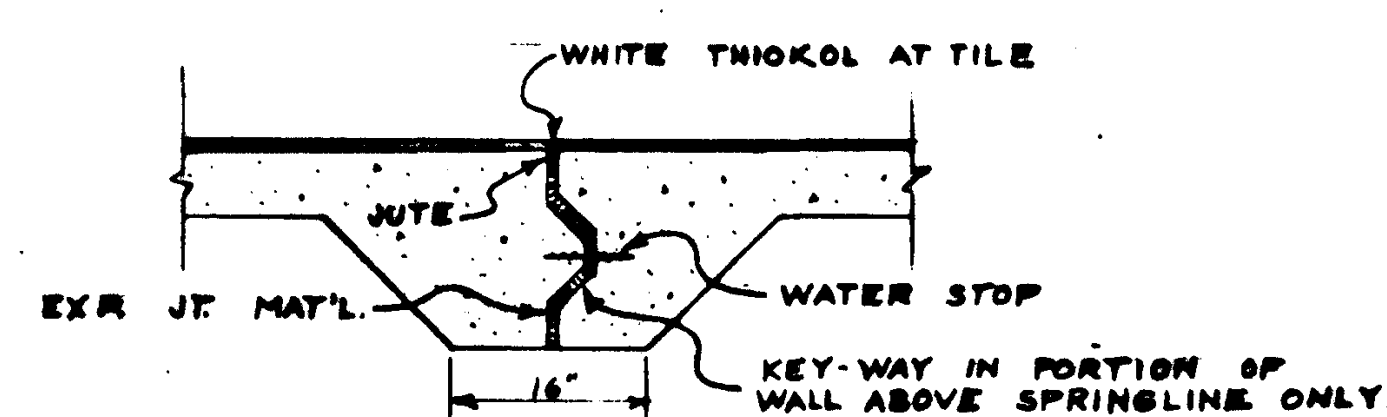

EXPANSION JOINT IN FLOOR
SCALE 3/4" = 1'-0"

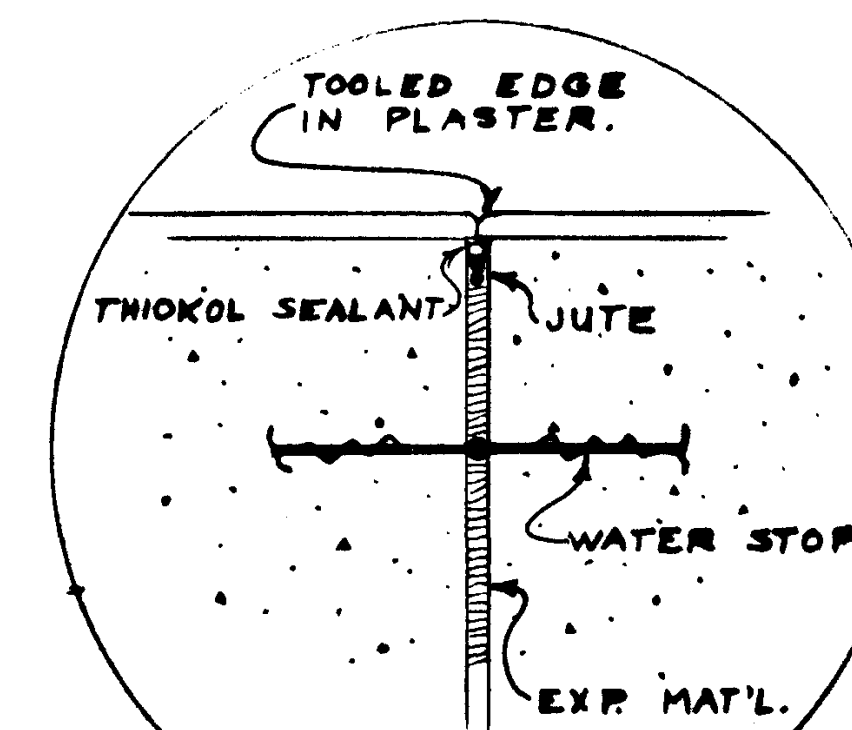


DETAIL "A"
SCALE 1/2" = 1'-0"

USE C.I. WALL FLANGE FITTING FOR TRANSITION
FROM C.I. PIPING TO TRANSITE MAINTAINING
LEAK-PROOF CONNECTION WHERE PIPING
ENTERS POOL WALL.

8" C.I. H-1 WATER MAIN

SUBSTITUTE MECHANICAL JOINT C.I. WATER MAIN
IN MAIN DRAIN PIPING FOR BELL AND SPIGOT WATER
MAIN SPEC. - TO GAIN FLEXIBILITY OF JOINTS

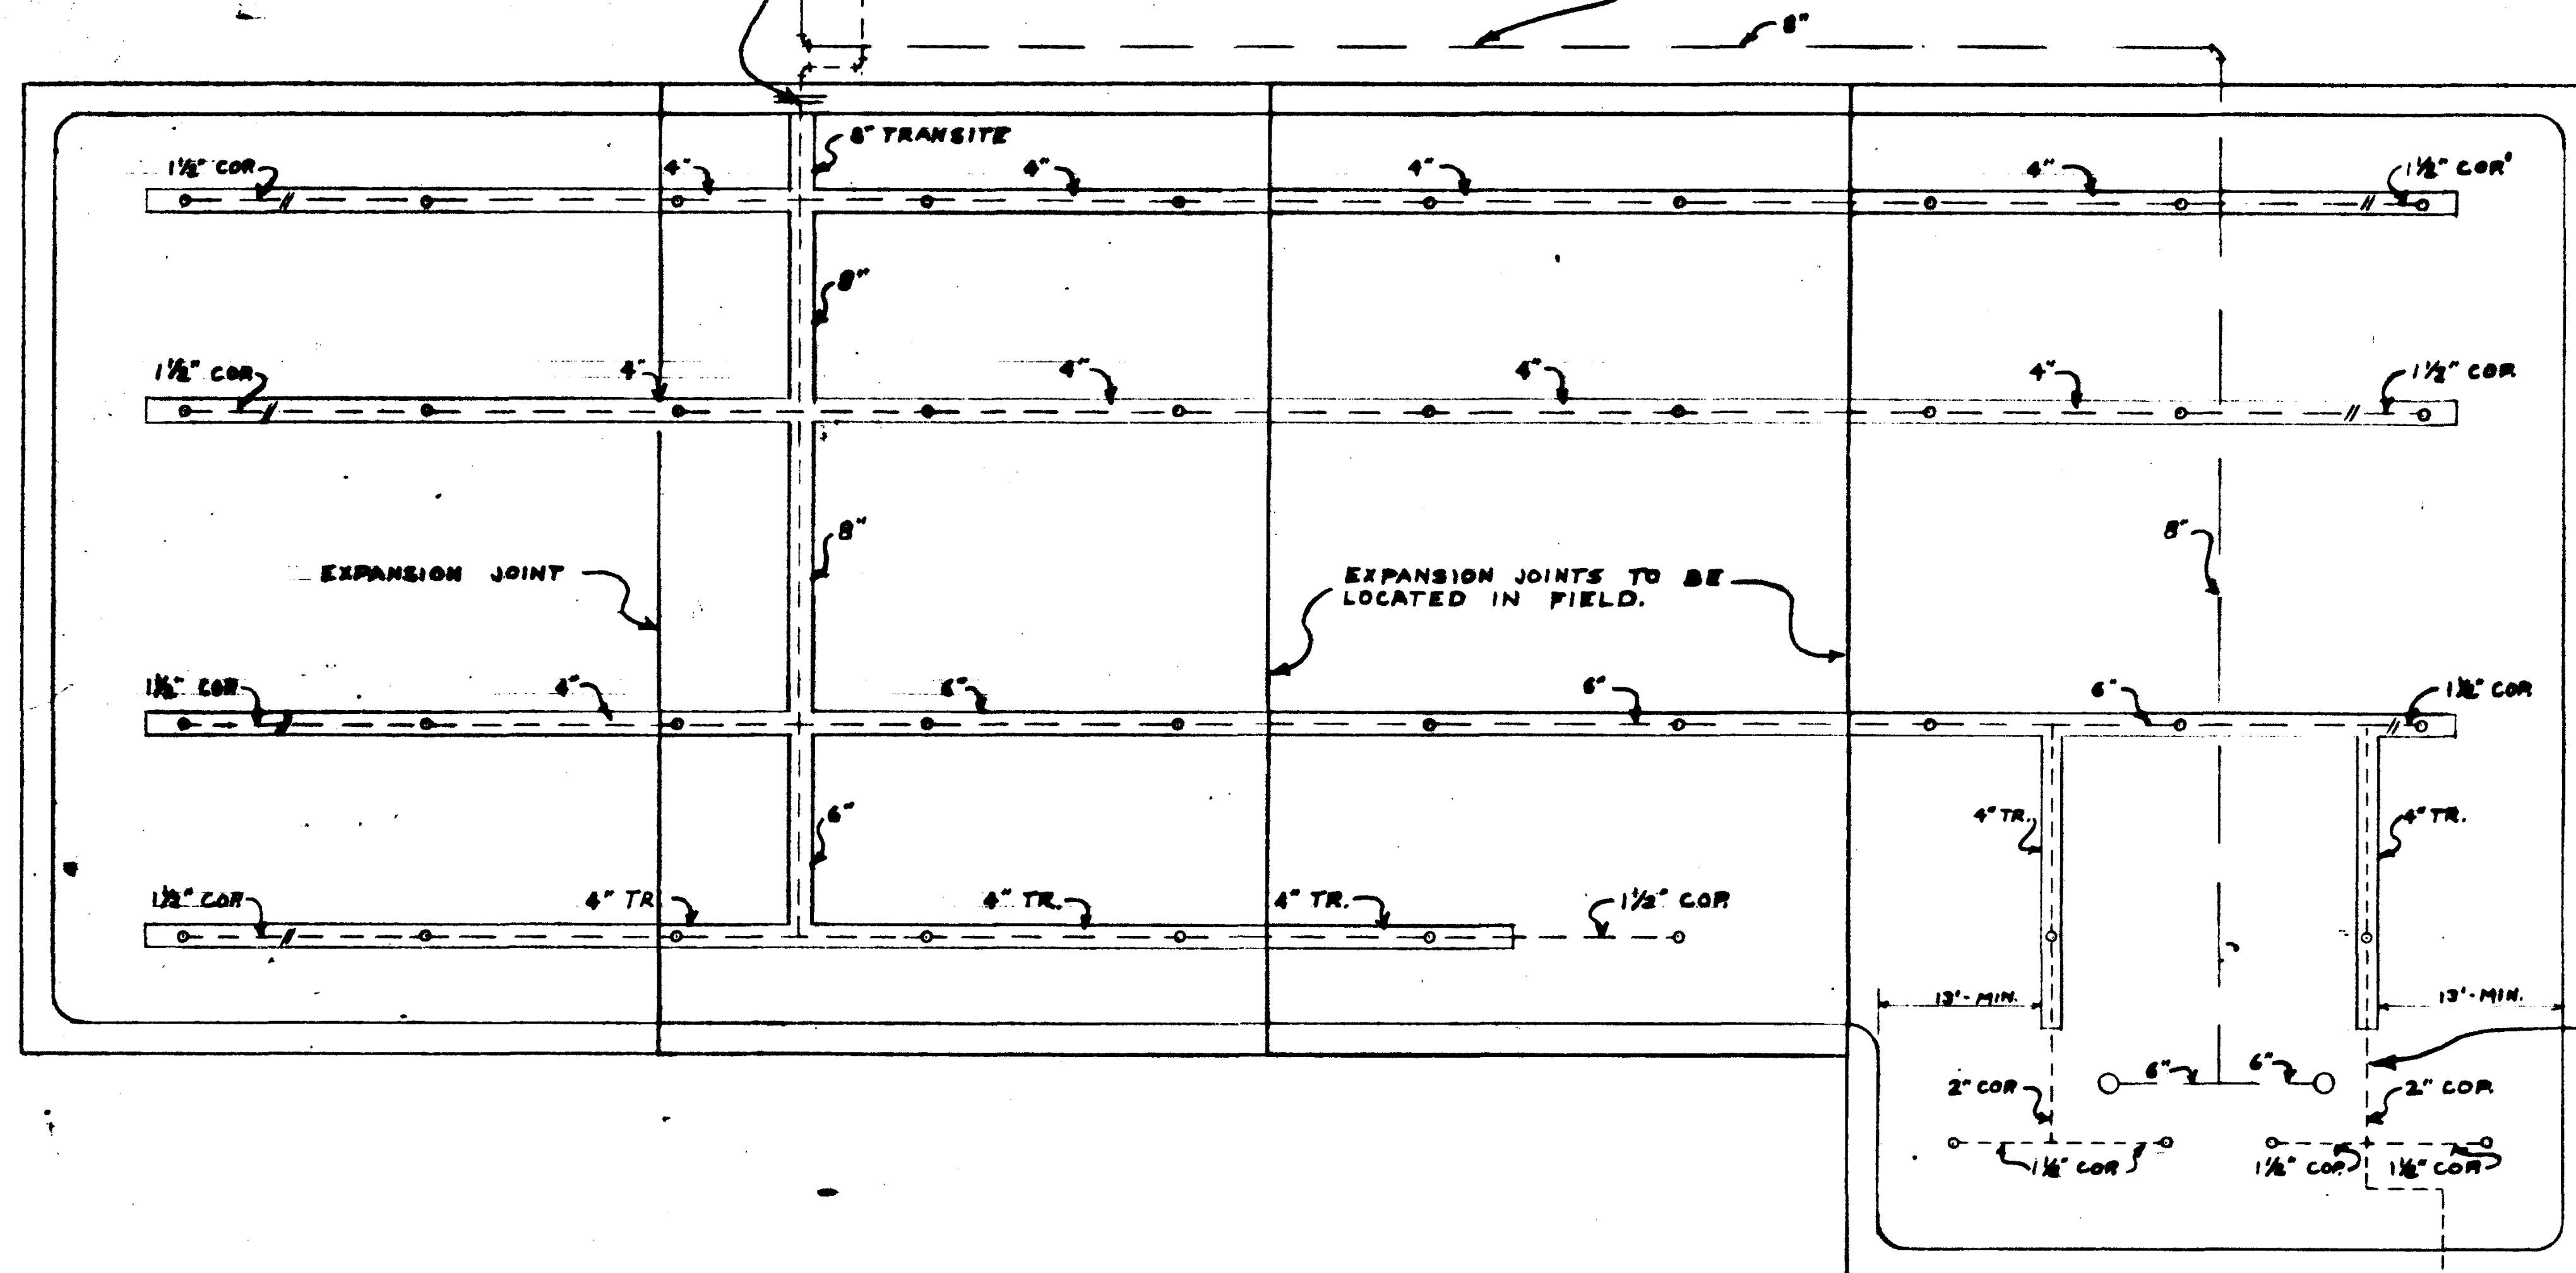


SMALL COPPER PIPING TO BE
POURED SOLID IN THICKENED
PAD UNDER STRUCTURE.

3/4" LINE TO SPRAY
FITTINGS
(NO CHANGE)

INLET LINE REVISIONS


- Line between pool and building to be mechanical joint cast iron cement lined water main (will eliminate use of steel sleeve at pool wall and substitute leak-proof connection).
- Interior pool piping larger than 2" to be glass 150 transite water pipe with R. H. Baker all-copper fittings.
 - Note increased pipe sizes to obtain better distribution at end of line fittings -- especially to diving-spray heads.
 - Makes allowance for expansion and contraction of pool piping between tight connections at pool floor.
 - Avoids necessity of connections between two different trenches as shown on structural drawings (connections as now proposed, not detailed).
- Piping 2" and smaller to be poured in structure in thickened pad below pool wall. Bulk of piping to occur in trenches in pool floor as originally contemplated.

REVISIONS				ASSOCIATED ARCHITECTS:		GOLDEN WEST COLLEGE		SWIMMING POOL		SCALE
1		STRUCTURAL ENGINEERS	DESIGNED	ARCHITECT	APPROVED	WILLIAM L. PEREIRA & ASSOCIATES	HUNTINGTON BEACH, CALIFORNIA	INLET - PIPE	REVISIONS	3/4" = 1'-0"
2		MECHANICAL ENGINEERS	DRAWN BY	ENGINEER		A. QUINCY JONES, FREDERICK E. HENMONS & ASSOCIATES	ORANGE COAST JUNIOR COLLEGE DISTRICT			JOB NO. 6314
3		ELECTRICAL ENGINEERS	CHECKED BY	COLLEGE		BLUROCK ELLERBROEK & ASSOCIATES				DATE 1-25-66
4		CIVIL ENGINEERS				URBANUS SQUARE • MACARTHUR BOULEVARD AT FORD ROAD				SHEET NO. R
5						TELEPHONE 734/675-2640 • CORONA DEL MAR, CALIFORNIA				PSP 1.1

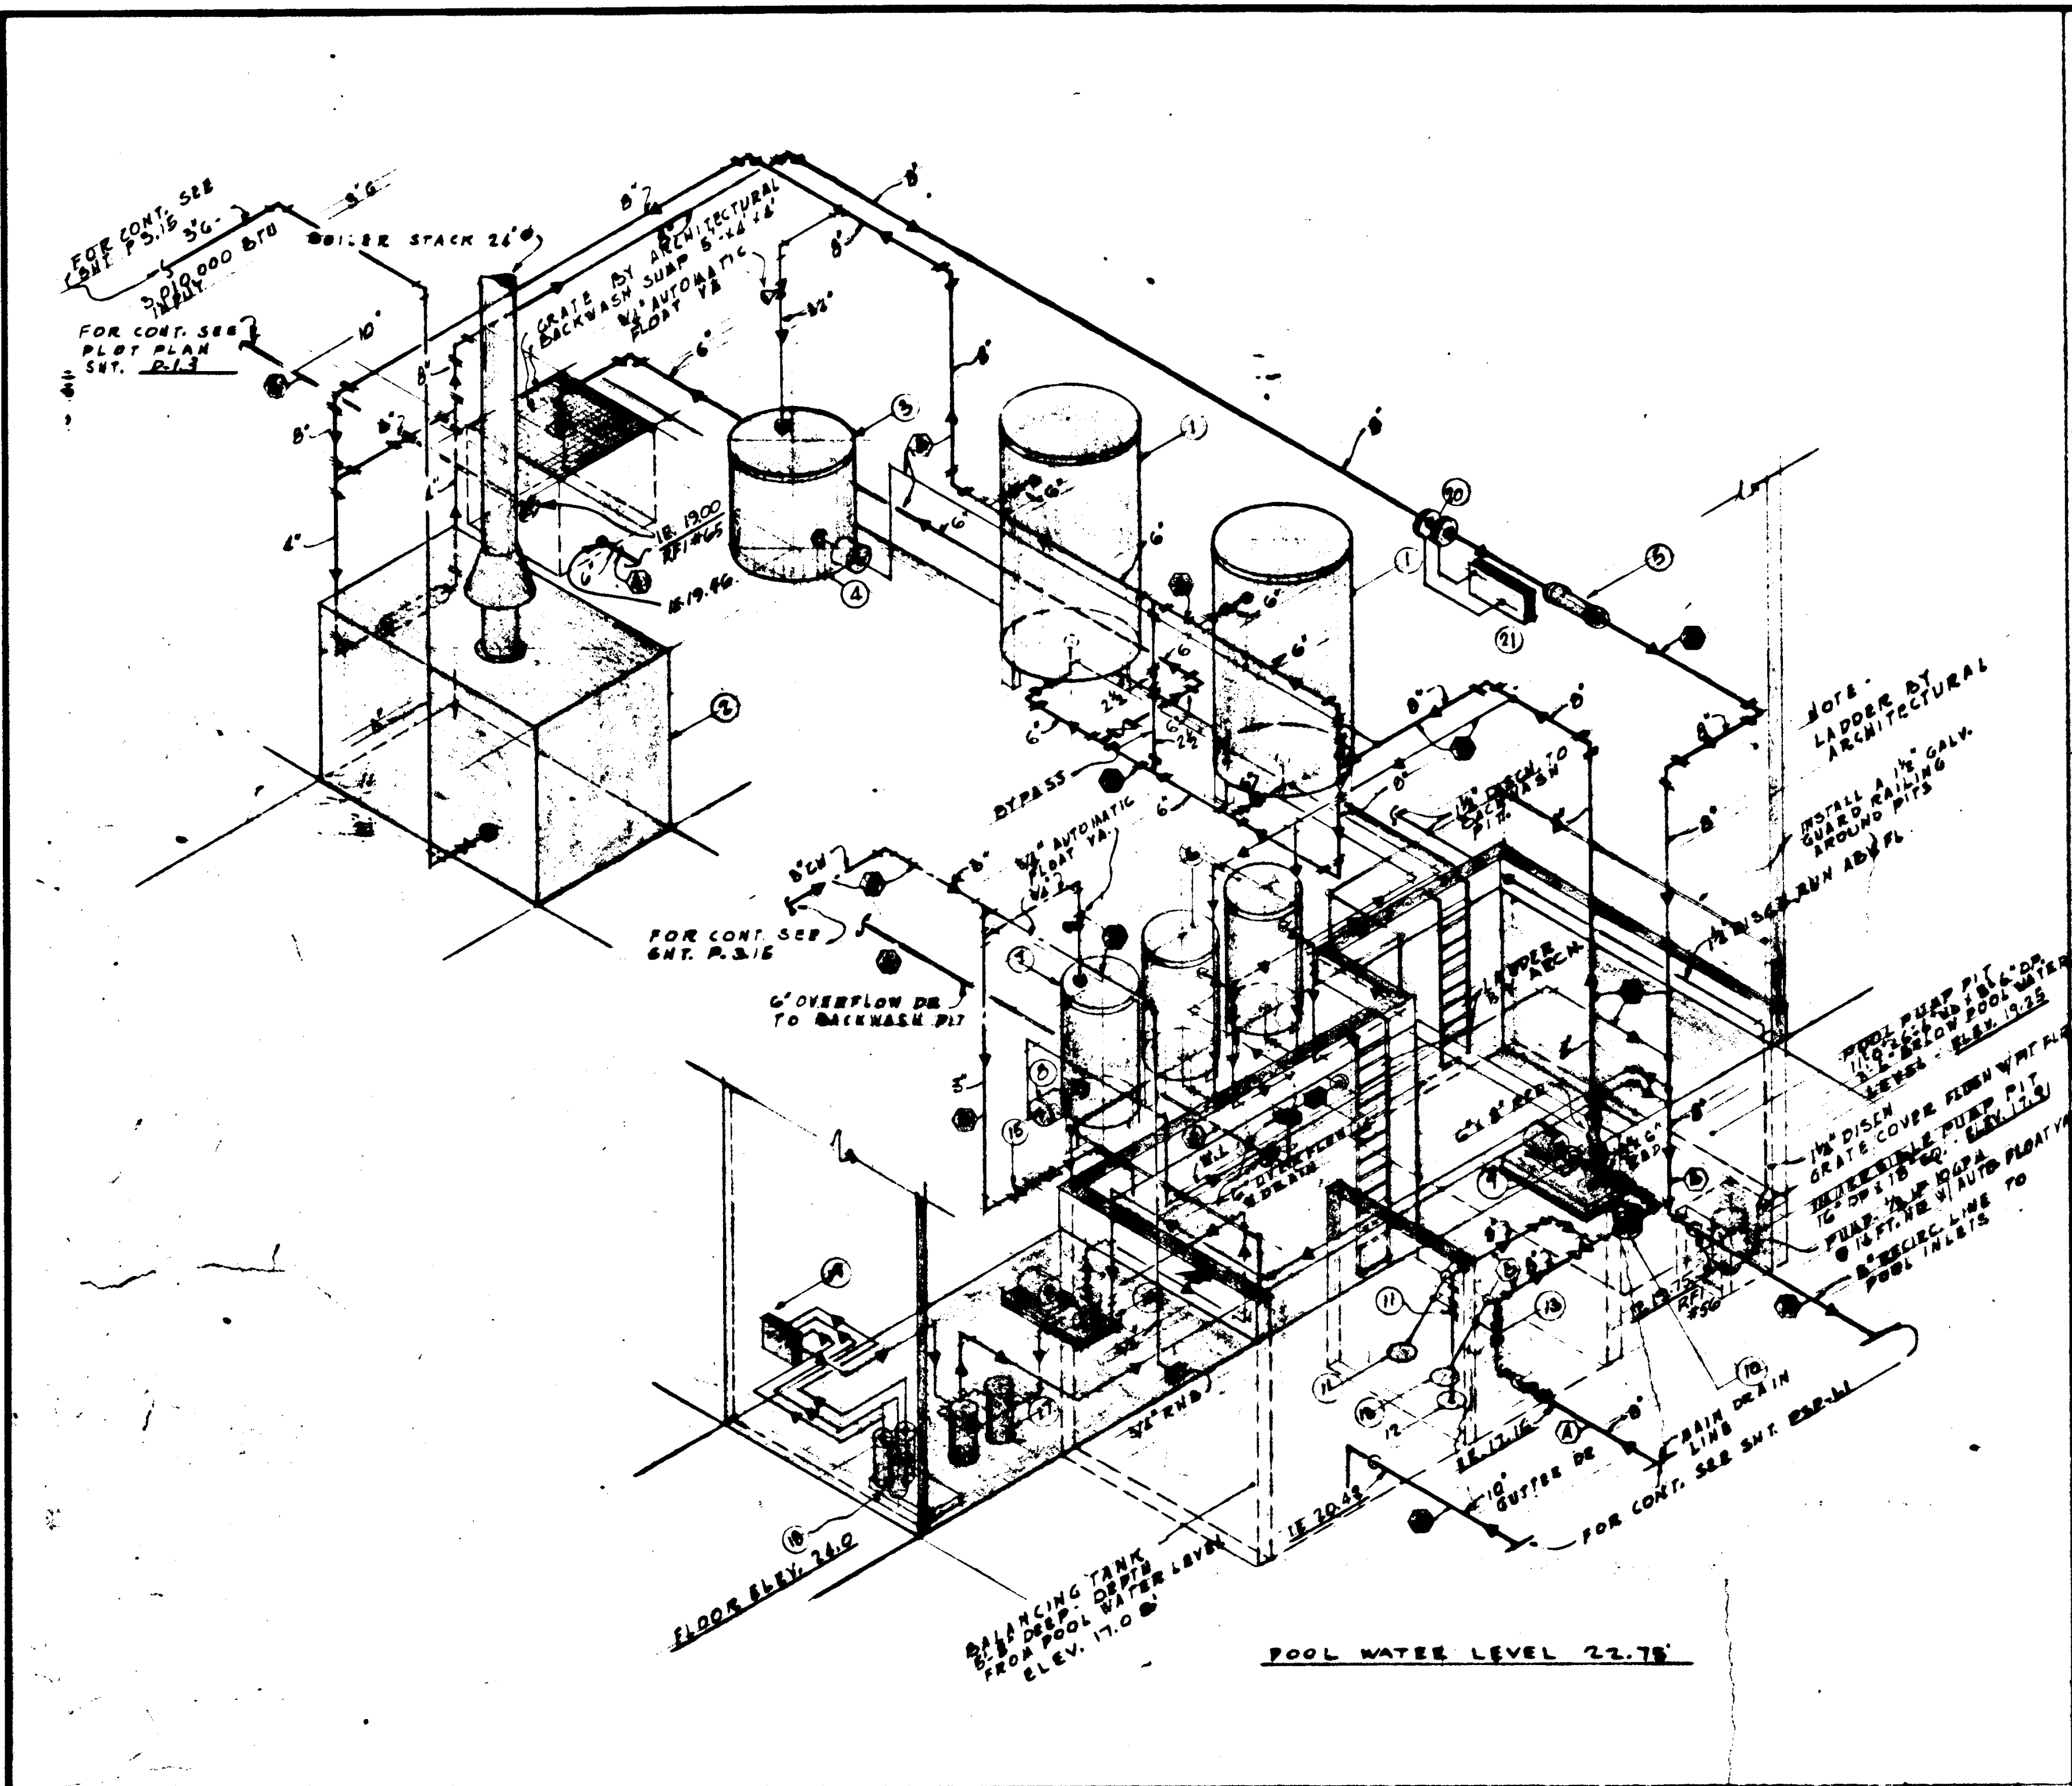


POOL EQUIPMENT DIAGRAM

SCALE NONE

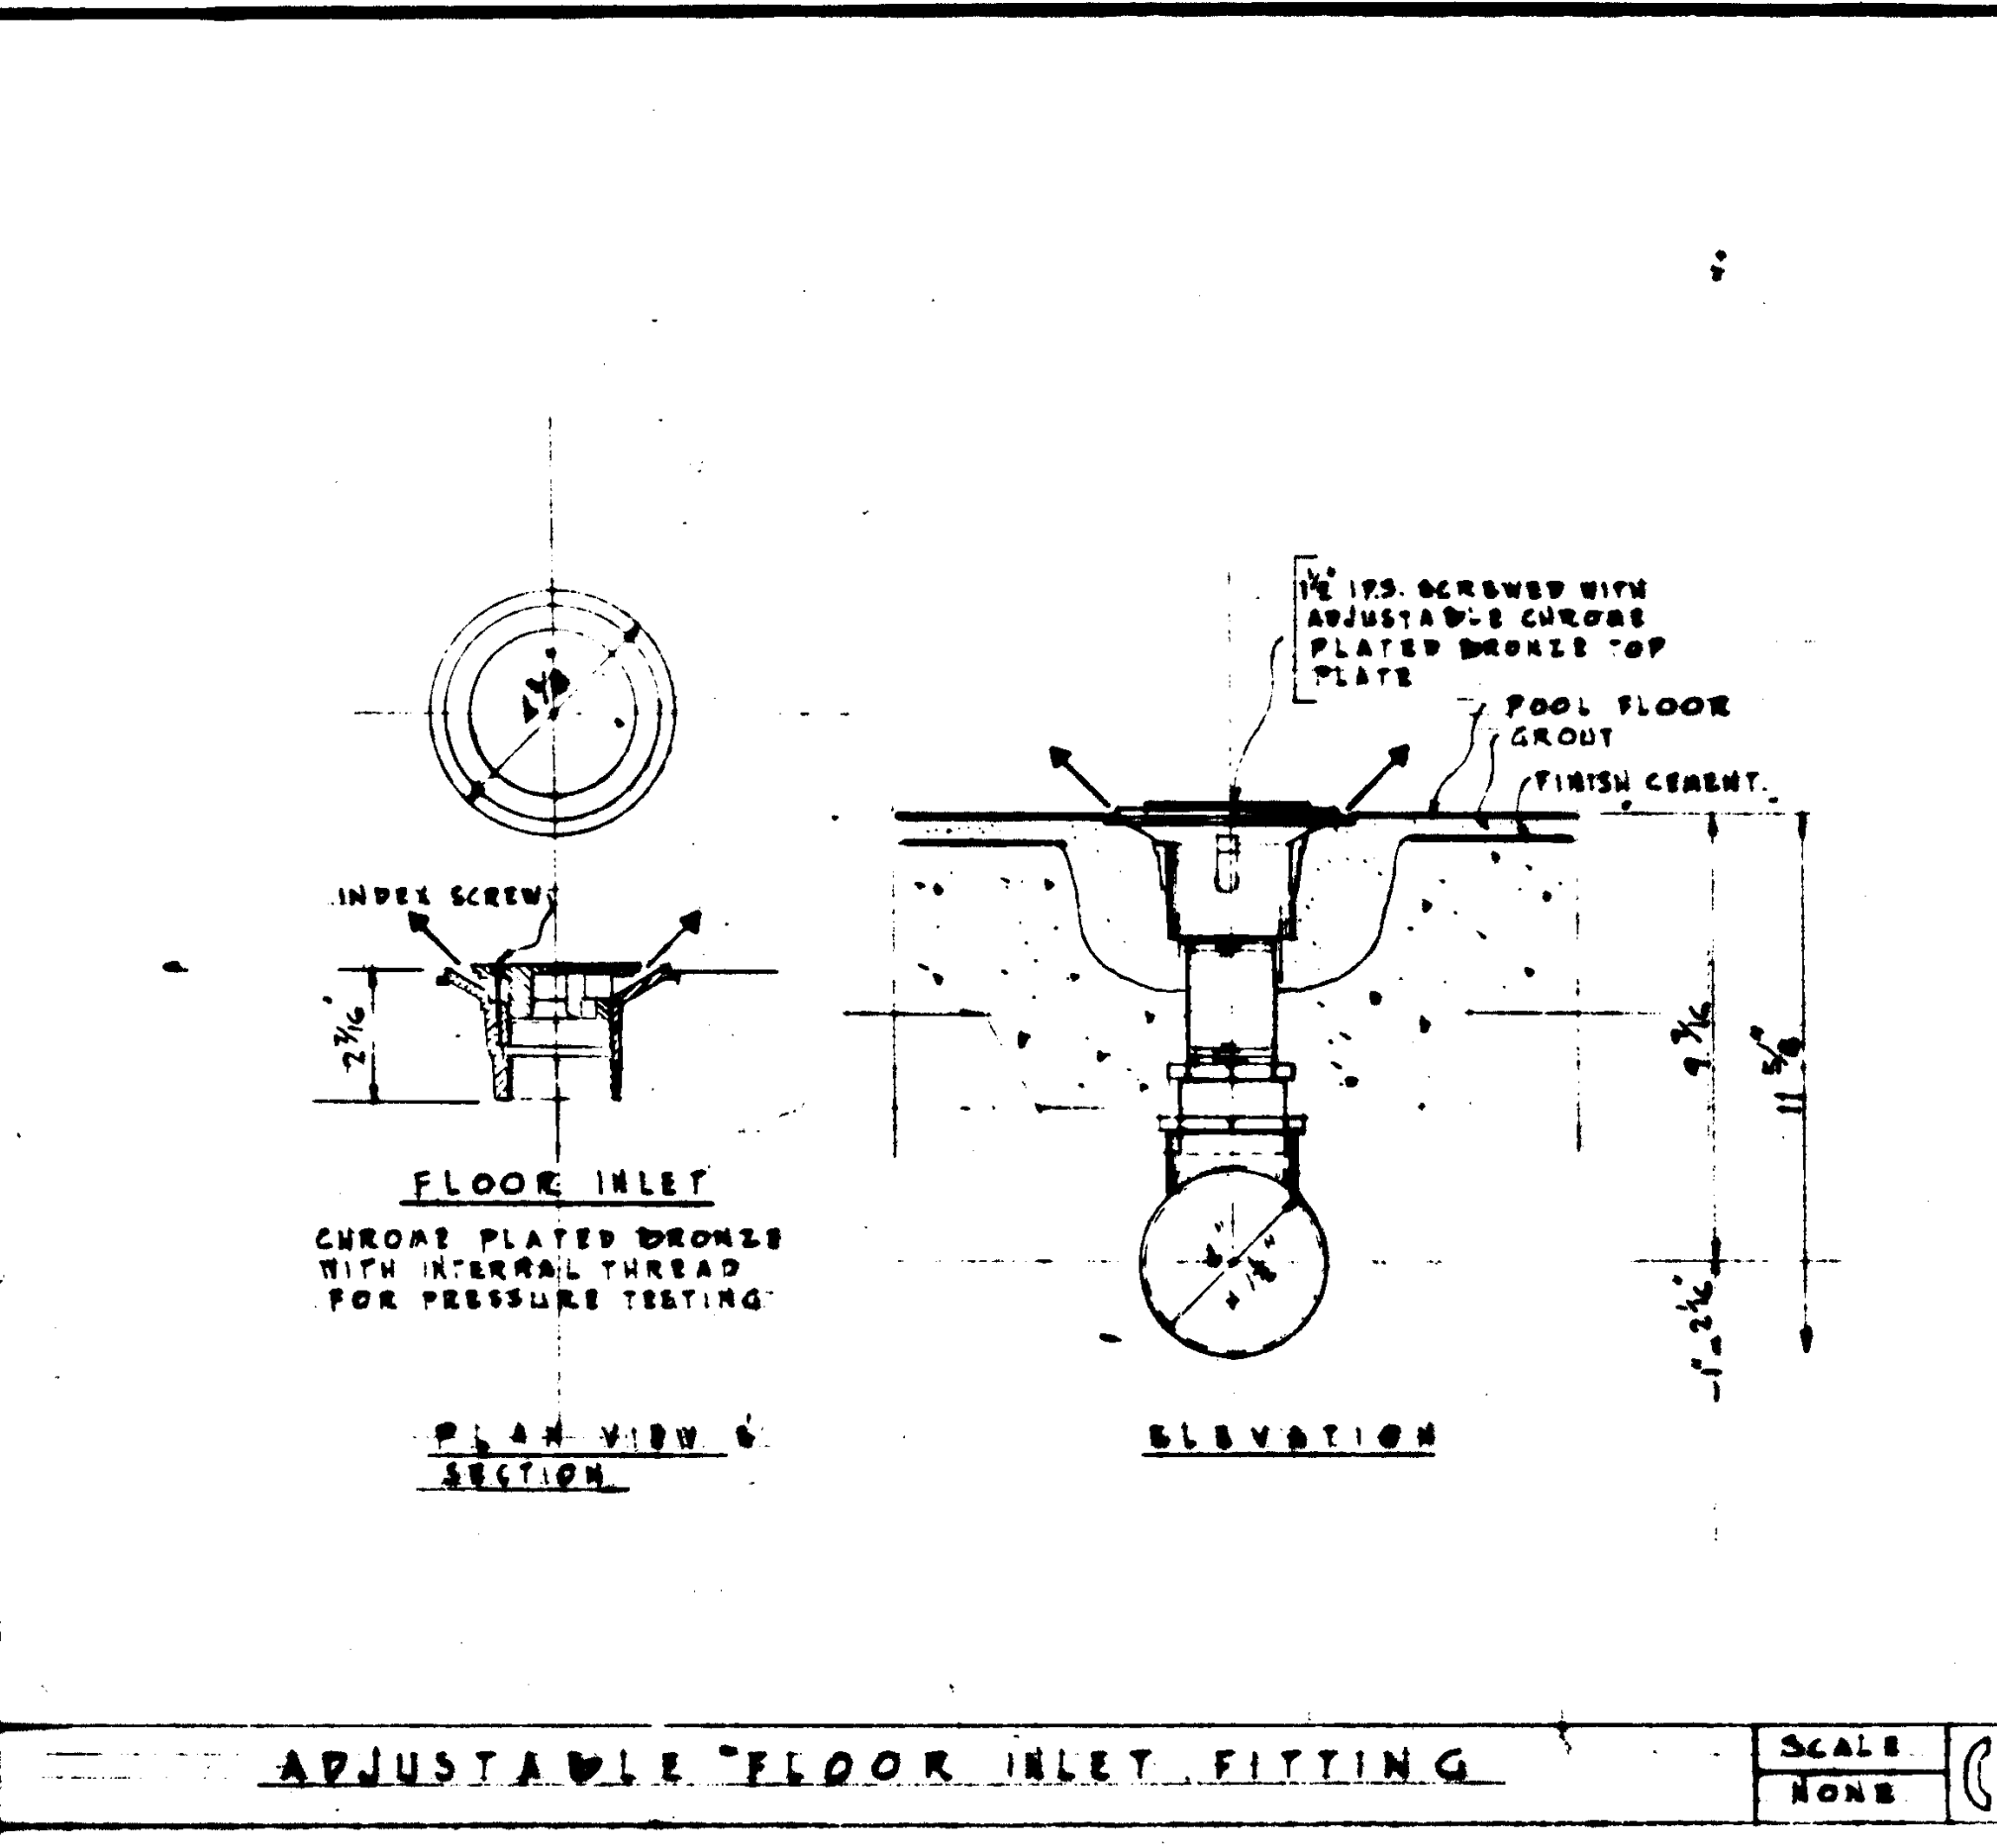

ADJUSTABLE FLOOR INLET FITTING


SCALE NONE

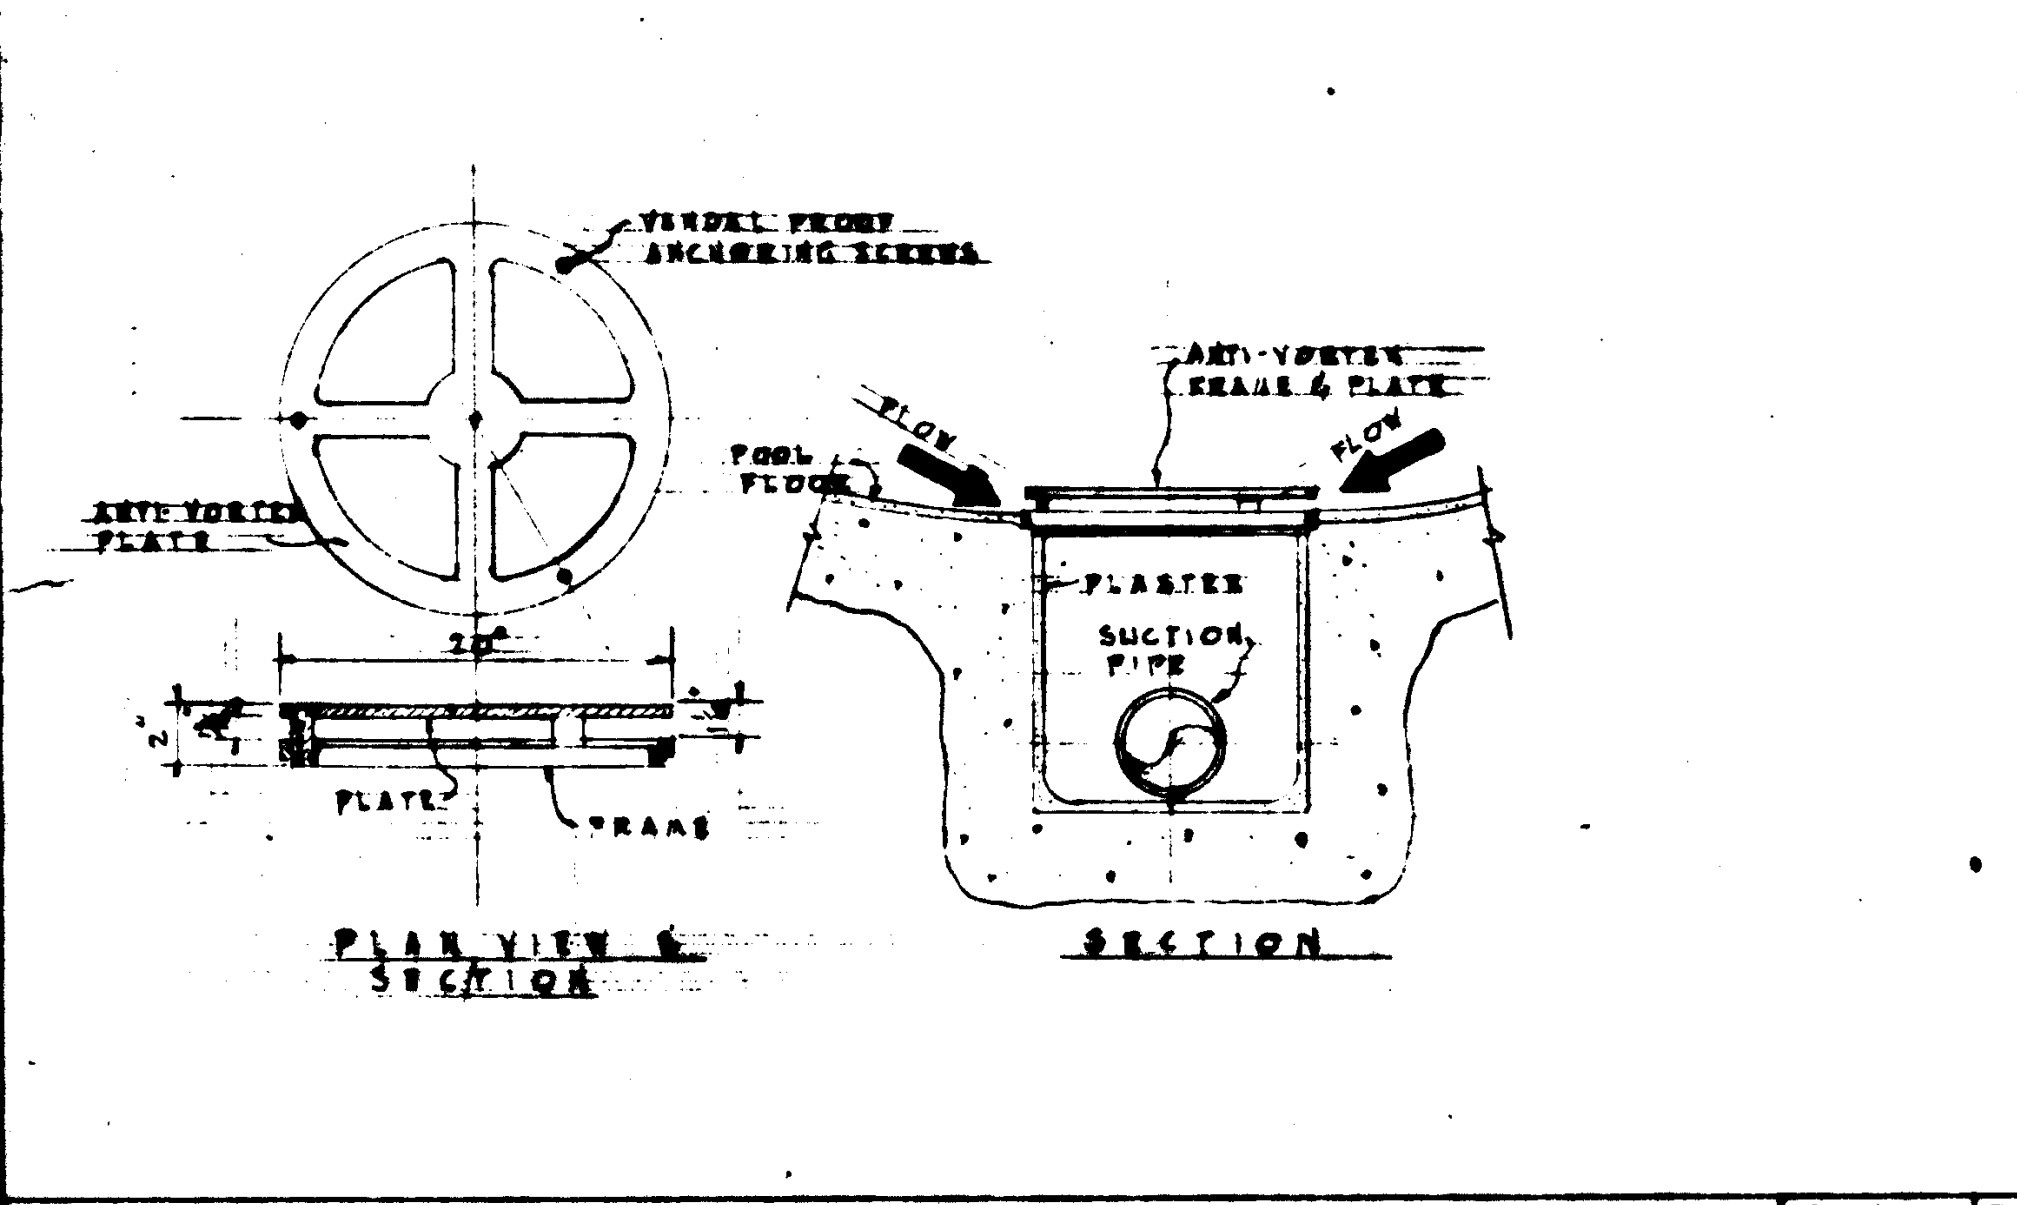

ANTI-VORTEX RAIN OUTLET FITTING


SCALE NONE

POOL EQUIPMENT SCHEDULE	
NO.	DESCRIPTION
1	VERTICAL DIAPHRAGM FILTER - 36\"/>
2	LAKE BOILER - MODEL AJP MARK II - 2/8000 - 3,010,000 BTU - 1/2\"/>
3	1,000,000 BTU - OUTPUT - 1/2\"/>
4	SLURRY TANK - W/AGITATOR - 48\"/>
5	SLURRY PUMP - 80 GPM - 1/2\"/>
6	ADJUST. ST. GRISWOLD FLOW CONTROL VALVE - 8\"/>
7	PRECOAT TANK - 18\"/>
8	SODA ASH TANK W/AGITATOR - 36\"/>
9	SODA ASH PUMP - 2.5 GPM - 1/2\"/>
10	POOL CIRC. PUMP - 400 GPM - 1/2\"/>
11	5\"/>
12	8\"/>
13	8\"/>
14	FLOAT CONTROL
15	3\"/>
16	BOOSTER PUMP - 1/2\"/>
17	GAS CHLORINATORS - 150 P.P.P.
18	WEIGHING SCALE BY ARCHITECTURAL
19	5\"/>
20	1\"/>
21	FLOW METER - BARTON OR FISHER & PORTER
22	2\"/>
23	2\"/>
24	1/2\"/>

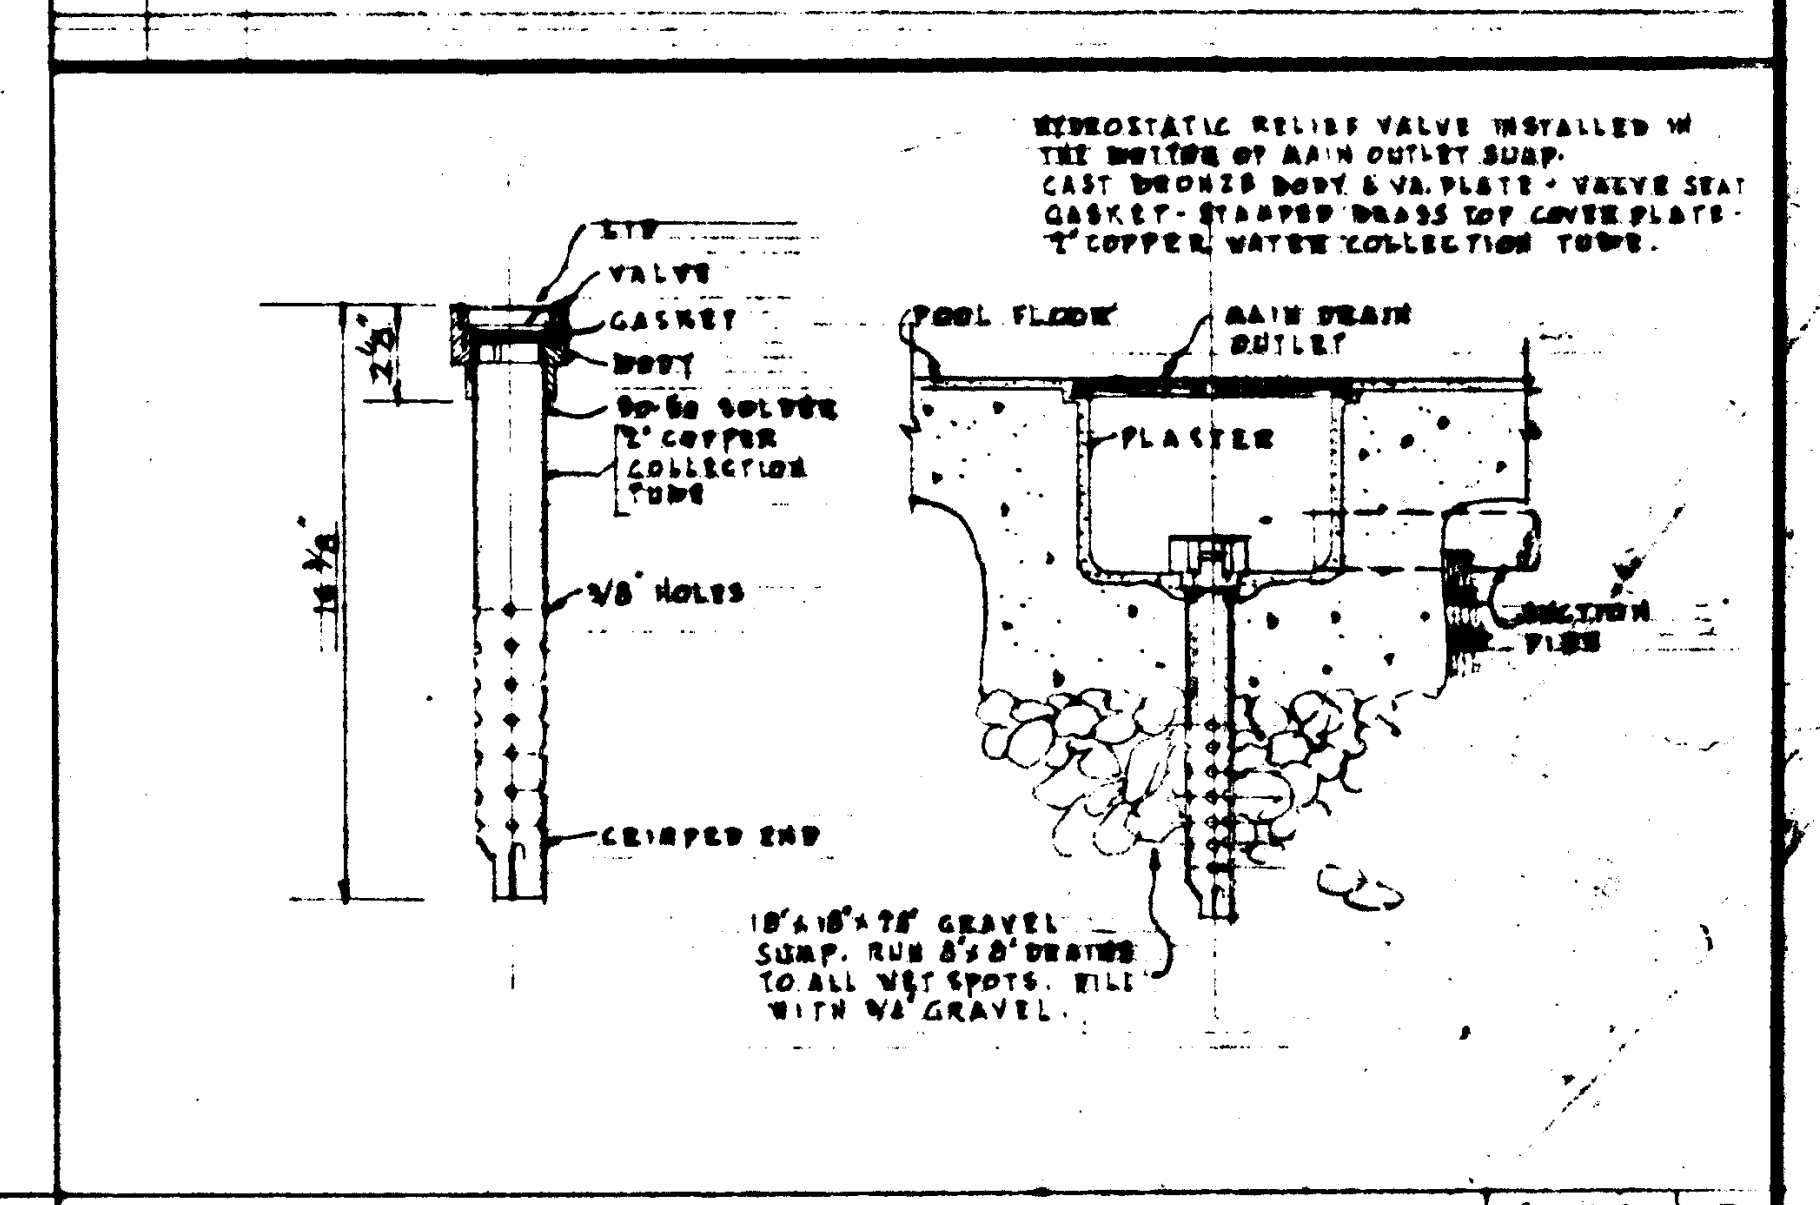

HYDROSTATIC RELIEF VALVE

SCALE NONE

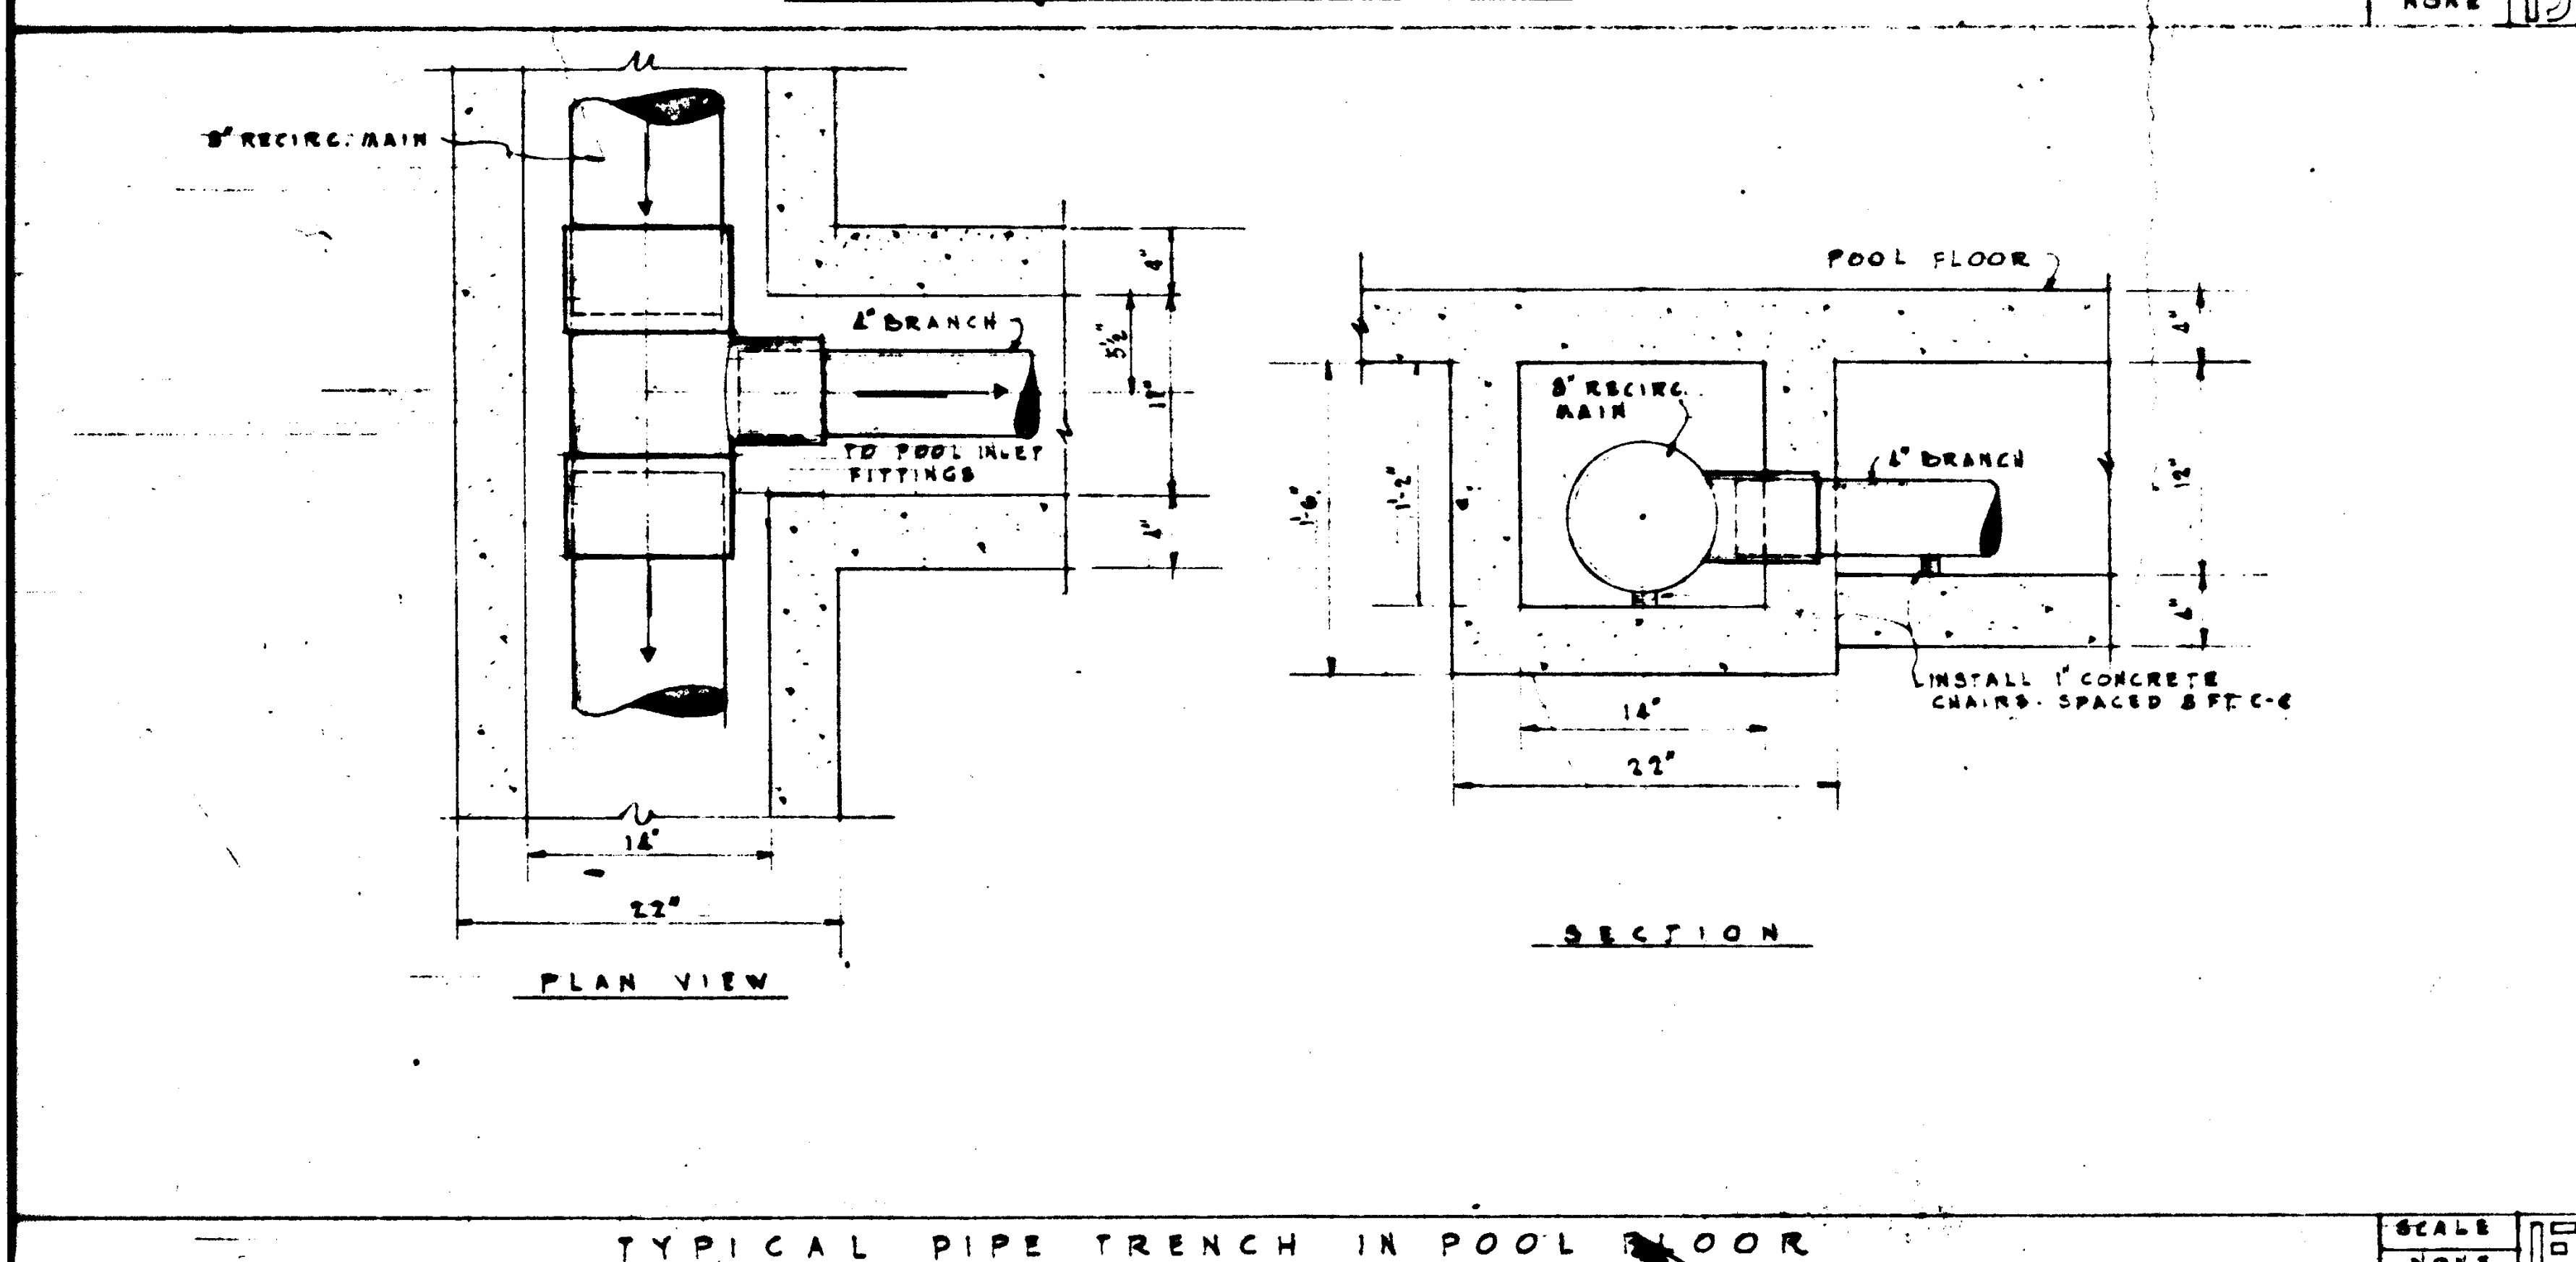

TYPICAL PIPE TRENCH IN POOL FLOOR

SCALE NONE

STRUCTURAL ENGINEER RANDOLPH & JOHNSTON J.A. MARTIN & ASSOCIATES		DESIGNED BY RALPH E. PHILLIPS, INC.		APPROVED STATE FIRE MARSHAL STATE OF CALIFORNIA JUN 31 1965		ASSOCIATED ARCHITECTS: WILLIAM L. PEREIRA & ASSOCIATES A. QUINCY JONES-FREDERICK E. EDMONDS & ASSOCIATES BLUMOCK ELLERBROCK & ASSOCIATES		GOLDEN WEST COLLEGE HUNTINGTON BEACH, CALIFORNIA ORANGE COAST JUNIOR COLLEGE DISTRICT		SWIMMING POOL DETAILS DATE 6-16-66 SHEET NO. 12	
MECHANICAL ENGINEER RALPH E. PHILLIPS, INC.		SIGNED BY RALPH E. PHILLIPS, INC.		APPROVED STATE FIRE MARSHAL STATE OF CALIFORNIA JUN 31 1965		URBANUS SQUARE • MACARTHUR BOULEVARD AT FORD ROAD TELEPHONE 714/678-2640 • OORONA DEL MAR, CALIFORNIA					
ELECTRONIC ENGINEER RALPH E. PHILLIPS, INC.		SIGNED BY RALPH E. PHILLIPS, INC.									
CIVIL ENGINEER G. SHULMAN & ASSOCIATES MOFFATT & NICKOL		SIGNED BY G. SHULMAN & ASSOCIATES MOFFATT & NICKOL									

VERTICAL FAN & COIL UNIT SCHEDULE

SYSTEM NO.	LOCATION		AREA SERVED	G.F.M.	FAN					MOTOR 60~				COOLING COIL					FILTERS							
	UNIT	ROOM			MIN. WHEEL DIA.	S.P. INCHES WATER	O.V. F.P.M.	R.P.M.	B.H.P.	DRIVE	H.P.	R.P.M.	V.	NO. ROWS	FACE AREA SQ. FT.	AIR TEMP. °F. ENT. LG.	WATER TEMP. °F. ENT. LG.	NO. REQ.	SIZE							
VFC-1	1	104	RM. 101	1600	12"	1 3/4	1400	1105	.84	V-BELT	1 1/2	1750	208	3	8	3.5	87.3	68.7	55.5	54.0	15	45	55	2	16 X 20 X 2	
2	1	103	103	1600	12"	1 3/4	1400	1105	.84		1 1/2				6	3.5	87.3	68.7	51.0	59.0	10.5			2	16 X 20 X 2	
3	1	104 & 109	104 & 109	1700	12"	1 1/2	1355	1106	.83		1 1/2				6	3.5	90.0	70.0	61.0	59.0	12			2	16 X 20 X 2	
4	1	110	110	1200	10"	1 1/2	1480	1180	.51		3/4				3		80.0	65.0	56.5	54.5	8			1	20 X 25 X 2	
5	1	104	111	1200	10"	1 1/2	1480	1180	.51		3/4				3		80.0	65.0	56.5	54.5	8			1	20 X 25 X 2	
6	1	210	201	1500	10"	1 3/4	1855	1262	.68		1				6	3	87.3	68.7	55.0	53.5	14.5			1	20 X 25 X 2	
7	1	210	203, 204 & 205	1750	12"	1 3/4	1532	1084	.87		1 1/2				8	4	87.3	68.7	55.0	54.0	16.5			2	16 X 20 X 2	
8	1	214	210, 214 & 215	1780	12"	1 1/2	1560	994	.75		1				8	4	90.0	70.0	55.0	53.5	19			2	16 X 20 X 2	
VFC-9	5	116	RM. 112, 113, 114 & 115	2200	12"	2	1925	1137	1.10	V-BELT	1 1/2	1760	208	3	8	4	82.5	66.3	55.0	53.5	17.5	45	55	2	16 X 25 X 2	
																										</

FAN & COIL UNIT SCHEDULE

SYSTEM NO.	G.F.M.	** MIN. OUTLET AREA	MOTOR - 60 ~			COOLING COIL										STRIP HEATER		
			H.P.	V.	◇	FACE AREA SQ.FT.	AIR TEMP. °F.			G.P.M.	WATER TEMP. °F.		K.W.	STEPS	V.	◇		
							ENT.	LVG.	ENT.		LVG.							
FC-1	200	52	1/20	115	1	0.9	78.8	65.5	61.0	58.2	1.0	45	55	1.0	2	208	3	
FC-2	300	73	1/20	↑	↑	1.3	↑	↑	61.0	58.2	1.5	↑	↑	1.5	↑	↑	↑	
FC-3	400	94	1/15	↑	↑	1.8	↑	↑	58.7	57.6	2.0	↑	↑	2.0	↑	↑	↑	
FC-4	600	137	1/12	↑	↑	2.2	↑	↑	61.3	58.5	3.0	↑	↑	3.0	↑	↑	↑	
FC-5	800	154	1/8	↑	↑	2.4	↑	↑	61.0	58.0	4.0	↑	↑	4.0	↑	↑	↑	
FC-6	1000	214	1/8	115	1	3.1	78.8	65.5	61.0	58.2	5.0	45	55	5.0	2	208	3	
EFC-1SR	400	94	1/20	115	1									3.5	2	208	3	

* MINIMUM FACE AREA. ** MINIMUM FREE AREA 90 INCHES.

SUPPLY & EXHAUST FAN SCHEDULE

SYSTEM NO.	LOCATION		AREA SERVED	G.F.M.	MIN. WHEEL DIA.	S.P. INCHES WATER	O.V.* F.P.M.	R.P.M.	TYPE	DISCHARGE	B.H.P.	DRIVE	MOTOR — 60 ~			
	UNIT	ROOM											H.P.	R.P.M.	V.	Ø
S-1	2	201	UNIT NO. 2	12280	33"	3 1/2	1980	994	S.I.S.W.	U.B.D.	.81	V-BELT	10	1750	208	3
S-2	4	126	MECH. RM. 107, 108, 109, 999, 1000													
S-3	6	MECH. RM.	UNIT NO. 6	6300	27"	2 3/4	1510	1046		U.B.D.	3.24		5			
S-4	7	126	7	15300	40 1/4"	3 1/4	1655	749		T.H.D.	9.18		15			
S-5	9a	MECH. RM.	9a	8525	30"	2 3/4	1655	971		T.H.D.	3.43		5			
S-6	9b	MECH. RM.	9b	20230	44 1/2"	3	1775	675		T.H.D.	11.26		15			
S-7	10	104	UNIT NO. 10	4785	20"	2 1/2	2085	1456	S.I.S.W.	U.B.D.	2.70	V-BELT	5	1750	208	3
HV-1	11	105	UNIT NO. 11 SUPPLY	3665	15"	1 1/2	1590	844	CABINET	NET FAN	1.45	V-BELT	2	1750	208	3
E-11	1	ROOF	RM. 103, 108 & 208	2500	22 1/8"	3/8	1150	640	ROOF	T TYPE	0.33	V-BELT	1/2	1750	208	3
E-12	1		RM. 109, 209 & 215	900	9"	3/8	1914	925	UTILITY SET	U.B.D.	0.18		1/3		115	1
E-21	2		RM. 105 - PROJECTION GENERAL	720	11"	1/4	1300	1215	ROOF	T TYPE	0.07		1/8			
E-22	2		GENERAL	1580	16 3/16"	1/4	1280	810			0.18		1/3			
E-41	4		RM. 215	515	11"	1/8	950	902			0.03		1/8			
E-42	4		101	515	11"	1/8	950	902			0.03		1/8			
E-51	5	ROOF	105	550	11"	1/8	920	1010	ROOF	T TYPE	0.03	V-BELT	1/6			
E-51	5a	110	110 & 111	200	6"	1/4	980	1140	S.I.S.W.	T.H.D.		DIRECT DRIVE	1/20			
E-52	5a	105	105	550	7 1/2"	1/8	1700	1140					1/6			
E-53	5a	205	205	550	7 1/2"	1/8	1700	1140								
E-54	5a	202	202	550	7 1/2"	1/8	1700	1140	S.I.S.W.	T.H.D.		DIRECT DRIVE				
E-55	5b	ROOF	125, 126 & 127	150	11"	1/4	365	903	ROOF	T TYPE	0.03	V-BELT	1/6			
E-51	5b		103	3100	24 3/8"	1/8	1120	427			0.16		1/3			
E-52	5b		102	3100	24 3/8"	1/8	1120	427			0.16		1/3		115	1
E-53	5b		104	2150	16 3/16"	3/8	1750	1047			0.33		1/2		208	3
E-101	10		105	250	11"	1/8	460	719			0.01		1/8		115	1
E-102	10		115	2550	19 7/8"	1	1445	633			0.18		1/4			
E-103	10		114, 116 & 117	820	11"	1	1510	1185			0.06		1/6			
E-111	11		114, 115, 116 & 117	1110	11"	1	2040	1398			0.09		1/6			
E-112	11	ROOF	RM. 118, 119 & 120	1110	11"	1/8	2040	1398	ROOF	T TYPE	0.09	V-BELT	1/6	1750	115	1
TX-11	LCa	ROOF	RM. 105 & 106	600	11"	1/2	1100	1478	ROOF	T TYPE	0.12	V-BELT	1/6	1750	115	1
TX-21	LCb		105 & 106	600		1/2	1100	1478			0.12					
TX-41	4		131 & 132	300		1/4	550	990			0.03					
TX-42	4		125 & 126	200		1/4	370	938			0.03					
TX-43	4		203, 204 & 205	300		1/4	530	990			0.03					
TX-44	LCc	ROOF	105 & 106	600		1/2	1100	1478	ROOF	T TYPE	0.12	V-BELT	1/6			
TX-71	7	104	103 & 104	120	4 1/8"	1/4	1490	1725	S.I.S.W.	T.H.D.		DIRECT DRIVE	1/20			
TX-72	LCd	ROOF	105 & 106	600	11"	1/2	1100	1478	ROOF	T TYPE	0.12	V-BELT	1/6			
TX-81	8b		116, 118 & 119	400		1/4	735	1034			0.04					
TX-82	8b		136 & 139	350		1/4	645	1011			0.03					
TX-83	8b		104 & 105	150		1/4	275	909			0.03					
TX-91	LCe		105 & 106	600		1/2	1100	1478			0.12					
TX-92	9b		106, 109 & 110	300		1/4	650	990			0.03					
TX-101	10		107 & 118	308			560	992			0.03					
TX-102	10		112 & 119	300			550	990			0.03					
TX-111	11	ROOF	RM. 108, 109, 118 & 113	445	11"	1/4	820	1054	ROOF	T TYPE	0.04	V-BELT	1/6	1750	115	1
VH-11	1	ROOF	RM. 205 FUME HOOD	2100	15"	5/8	1700	590	UTILITY	U.B.D.	0.41	V-BELT	3/4	1750	208	3
VH-12			206	2100	15"		1700	590			0.41		3/4	1750	208	3
VH-13			210	1400	12 1/4"		1650	720			0.32		1/2		208	3
VH-14			111	700	9"		1500	965			0.12		1/3		115	1
VH-15			204	2100	15"		1700	590			0.41		3/4		208	3
VH-16	1	ROOF	RM. 204 FUME HOOD	2100	15"	5/8	1700	590	UTILITY	U.B.D.	0.41	V-BELT	3/4	1750	208	3

ELECTRIC STRIP HEATER SCHEDULE

HEATER NO.	LOCATION		AREA SERVED	C.F.M.	APPROXIMATE SIZE		K.W.	STEPS	V	♦
	UNIT	ROOM			LENGTH	WIDTH				
VFC-1.1	1	104	ROOM 101	1600	24	12	17.5	3	208	3
2.1	1	103	103	1600	24	12	17.5	3	208	3
3.1	1	104	104	1400	24	12	17.5	3	208	3
3.2	1	109	109	150	8	6	2	2	1	1
4.1	1	110	110	1200	18	8	9	3	3	3
5.1	1	104	111	1200	18	8	9	3	3	3
6.1	1	202	201	1500	24	12	17.5	3	208	3
7.1	1	202	208	1450	24	12	17.5	3	208	3
7.2	1	202	203 & 204	300	12	6	3.75	3	208	3
VFC-8.1	1	214	210 & 214	1780	30	12	24	3	208	3
S-1.1	2	201	118 & 205	680	18	8	9	3	3	3
1.2	2	102	102	180	6	3	2	2	1	1
1.3	2	103	103	290	6	3	3	3	3	3
1.4	2	104	104	330	6	3	3	3	3	3
1.5	2	105	105	730	12	6	3	3	3	3
1.6	2	106	106	330	6	3	3	3	3	3
1.7	2	107	107	280	6	3	3	3	3	3
1.8	2	108	108	170	6	3	2	2	1	1
1.9	2	110	110	7640	36	24	60	3	3	3
1.10	2	112	112	280	6	3	2	2	1	1
1.11	2	117	117	280	6	3	2	2	1	1
1.12	2	201	113 & 118	240	6	3	2	2	1	1
2.1	4	109	208, 209 & 215	640	12	8	6	3	3	3
2.2	4	107	107 & 108	980	12	12	7.5	3	3	3
2.3	4	101, 112, 113, 114, 115	1070	18	8	9	3	3	3	3
S-2.4	4	109	101	2400	24	24	40	3	208	3
VFC-3.1	5	114	115	1500	24	12	15	3	208	3
VFC-3.2	5	112	112	410	12	6	3.75	3	208	3
VFC-3.3	5	112	113 & 114	290	12	6	3	3	3	3
S-3.1	6	MECH. RM.	105	130	6	3	2	2	1	1
3.2	6	103	103	440	12	8	6	3	3	3
3.3	6	102	102	430	12	8	6	3	3	3
3.4	6	101	101	600	12	12	7.5	3	3	3
3.5	6	117	117	1925	18	18	22.5	3	3	3
3.6	6	108	108	1760	18	18	22.5	3	3	3
3.7	6	MECH. RM.	107, 110, 111, 112, 113, 114	550	12	8	6	3	3	3
4.1	7	126	201	4700	28	18	37.5	3	3	3
4.2	7	102	102	1950	18	12	15	3	3	3
4.3	7	111, 112, 114 & 124	1350	12	12	7.5	3	3	3	3
4.4	7	101	101	2850	24	18	25	3	3	3
4.5	7	123	123	3780	24	18	25	3	3	3
4.6	7	126	105, 106, 107, 108, 109, 110	990	12	12	5	3	3	3
5.1	9*	MECH. RM.	104, 105, 106	700	12	8	6	3	208	3
5.2	9*	101	101	6400	36	36	30	45	3	3
5.3	9*	102, 103, 109	775	12	12	7.5	3	208	3	3
6.1	9*	102	102	3440	36	18	45	3	3	3
6.2	9*	103	103	3440	36	18	45	3	3	3
6.3	9*	101	101	6120	24	24	60	3	3	3
6.4	9*	101	101	5000	36	36	60	3	3	3
6.5	9*	MECH. RM.	ROOM 104, 105, 107, 112	2230	18	18	25	3	3	3
7.1	10	104	UNIT NO. 10	5250	24	24	35	3	3	3
7.2	10	105	ROOM 108	225	6	6	2	2	1	1
7.3	10	106	108, 108	450	12	6	3.75	3	3	3
7.4	10	102	102	750	12	8	6	3	3	3
7.5	10	101	101	210	6	12	2.5	2	1	1
7.6	10	109	110	400	12	8	6	3	3	3
S-7.7	10	119	ROOM 113, 114, 115	3215	36	12	22.5	3	3	3
HV-1.1	11	105	UNIT NO. 11	3665	36	12	22.5	3	3	3
1.2	11	ROOM 103	100	6	8	1	1	1	1	1
1.3	11	101	101	210	6	8	3	3	3	3
1.4	11	102	102	380	12	8	3	3	3	3
1.5	11	112	112	2505	24	12	17.5	3	3	3
HV-1.6	11	105	ROOM 105	500	12	6	3.75	3	208	3

* PRE-HEAT STRIP HEATERS

REVISIONS

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DRAWN BY
ALICE

CHECKED BY
R.W.

ARCHITECT
WILLIAM L. FERREIRA

ENGINEER
ALICE

COLLEGE
GOLDEN WEST COLLEGE

APPROVED
STATE FIRE MARSHAL
STATE OF CALIFORNIA
DATE: JUN 21 1965

APPROVED
JUN 21 1965


ASSOCIATED ARCHITECTS:
WILLIAM L. FERREIRA & ASSOCIATES
A QUINCY JONES-FREDERICK R. EMMONS & ASSOCIATES
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GOLDEN WEST COLLEGE
HUNTINGTON BEACH, CALIFORNIA
ORANGE COAST JUNIOR COLLEGE DISTRICT


ALL UNITS
SCHEDULES

JOB NO.
104
DATE
6-15-65
SHEET NO.
M 1.2




TYPICAL DOUBLE DUCT SECTION

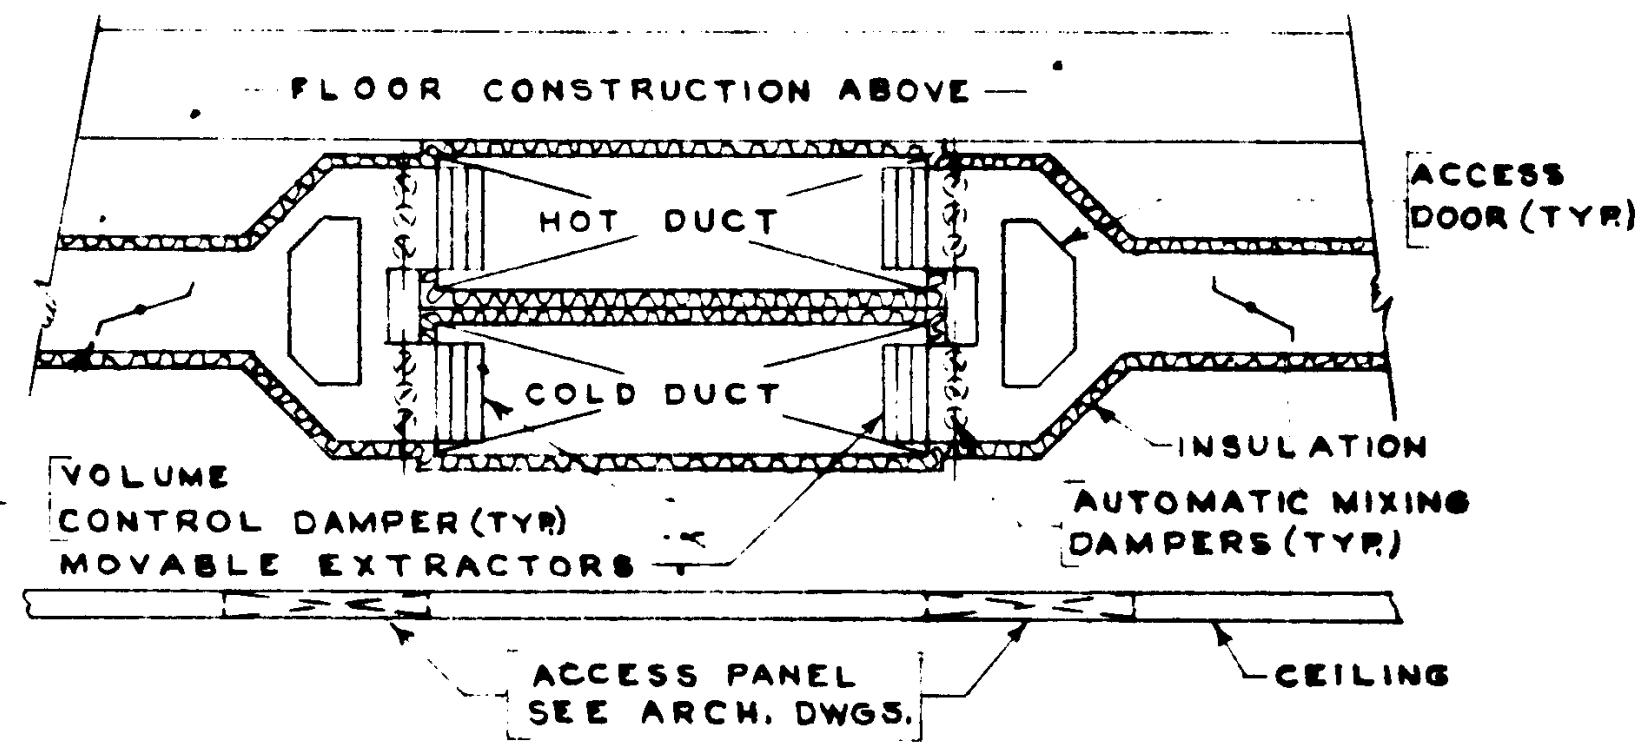SCALE NONE 1

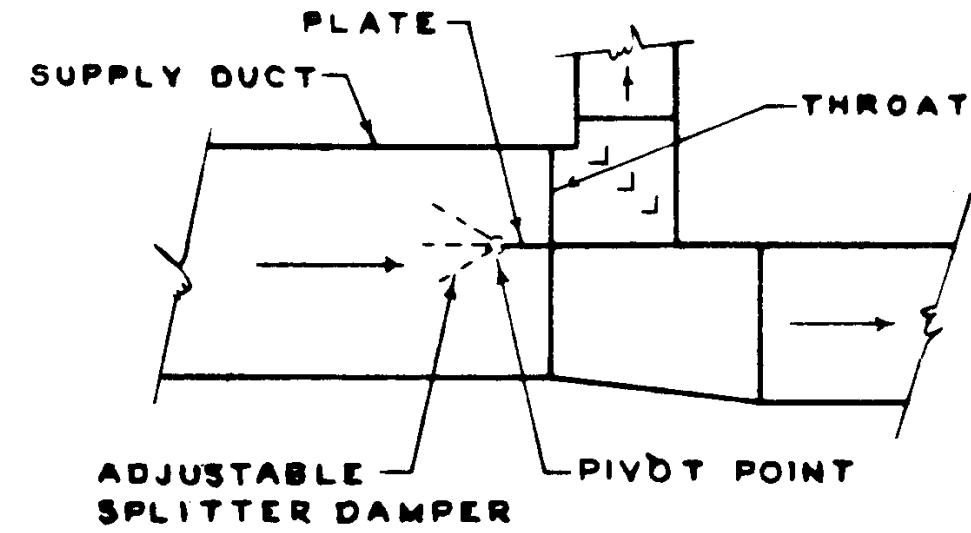


SPLIT DUCT TAKEOFF

SCALE NONE 2

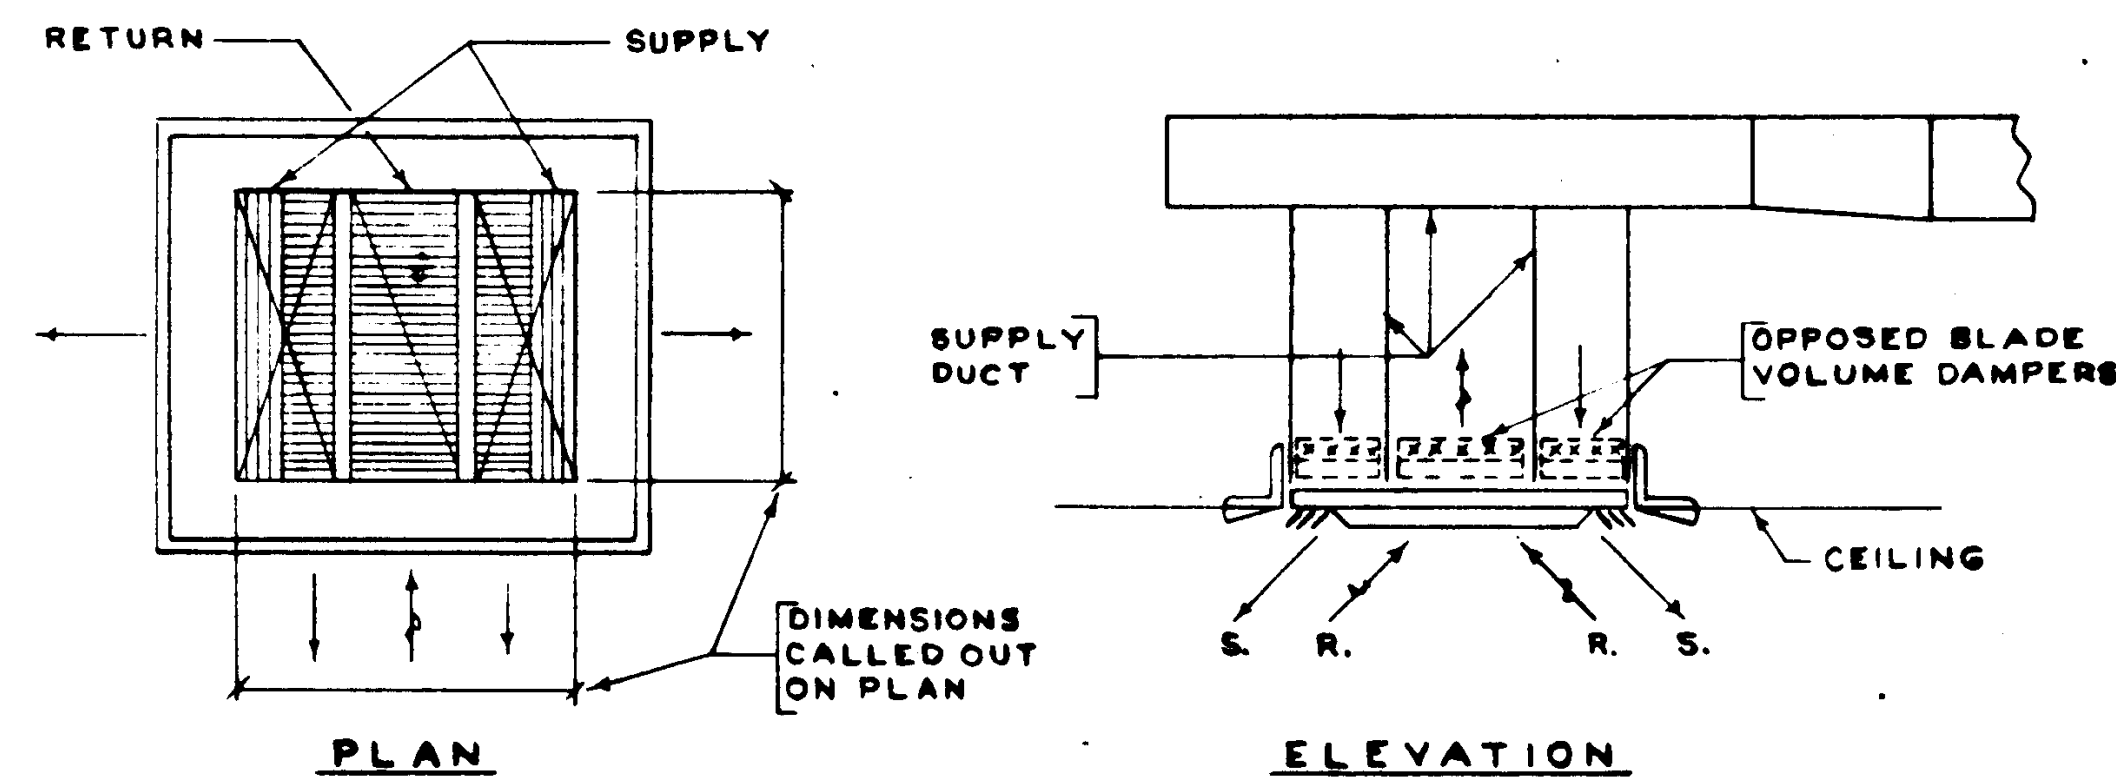


DIFFUSER DETAIL

SCALE NONE 3

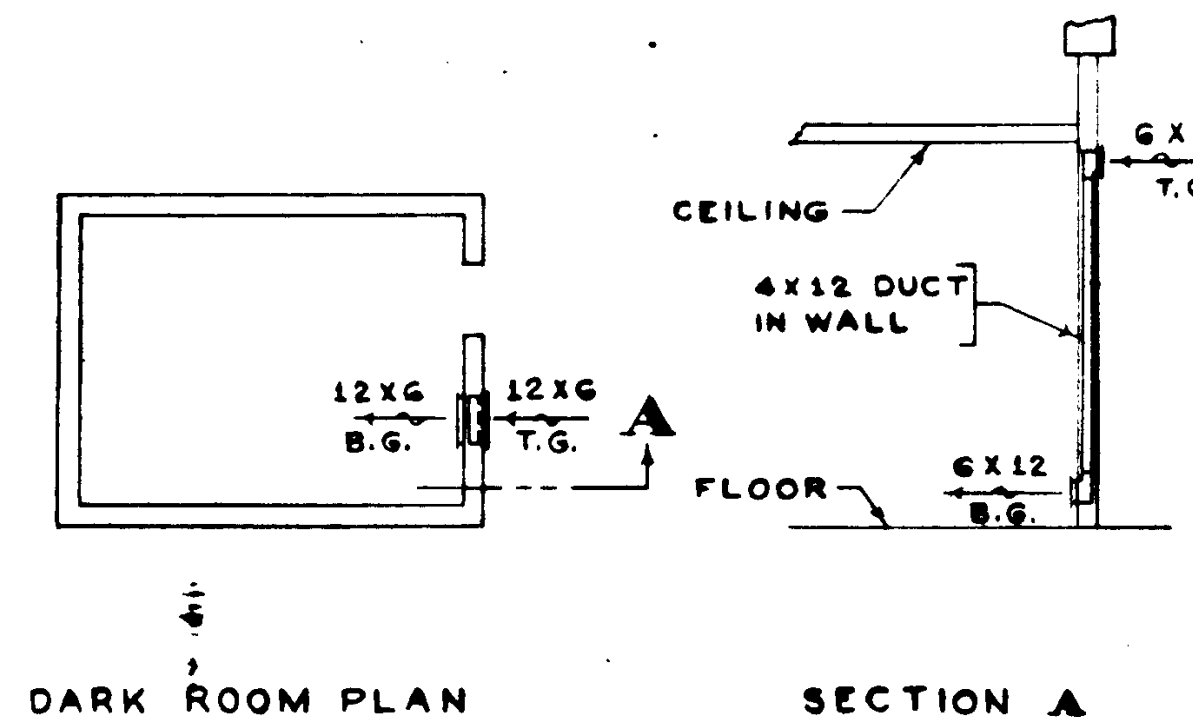


DARK ROOM PLAN

SCALE NONE 4

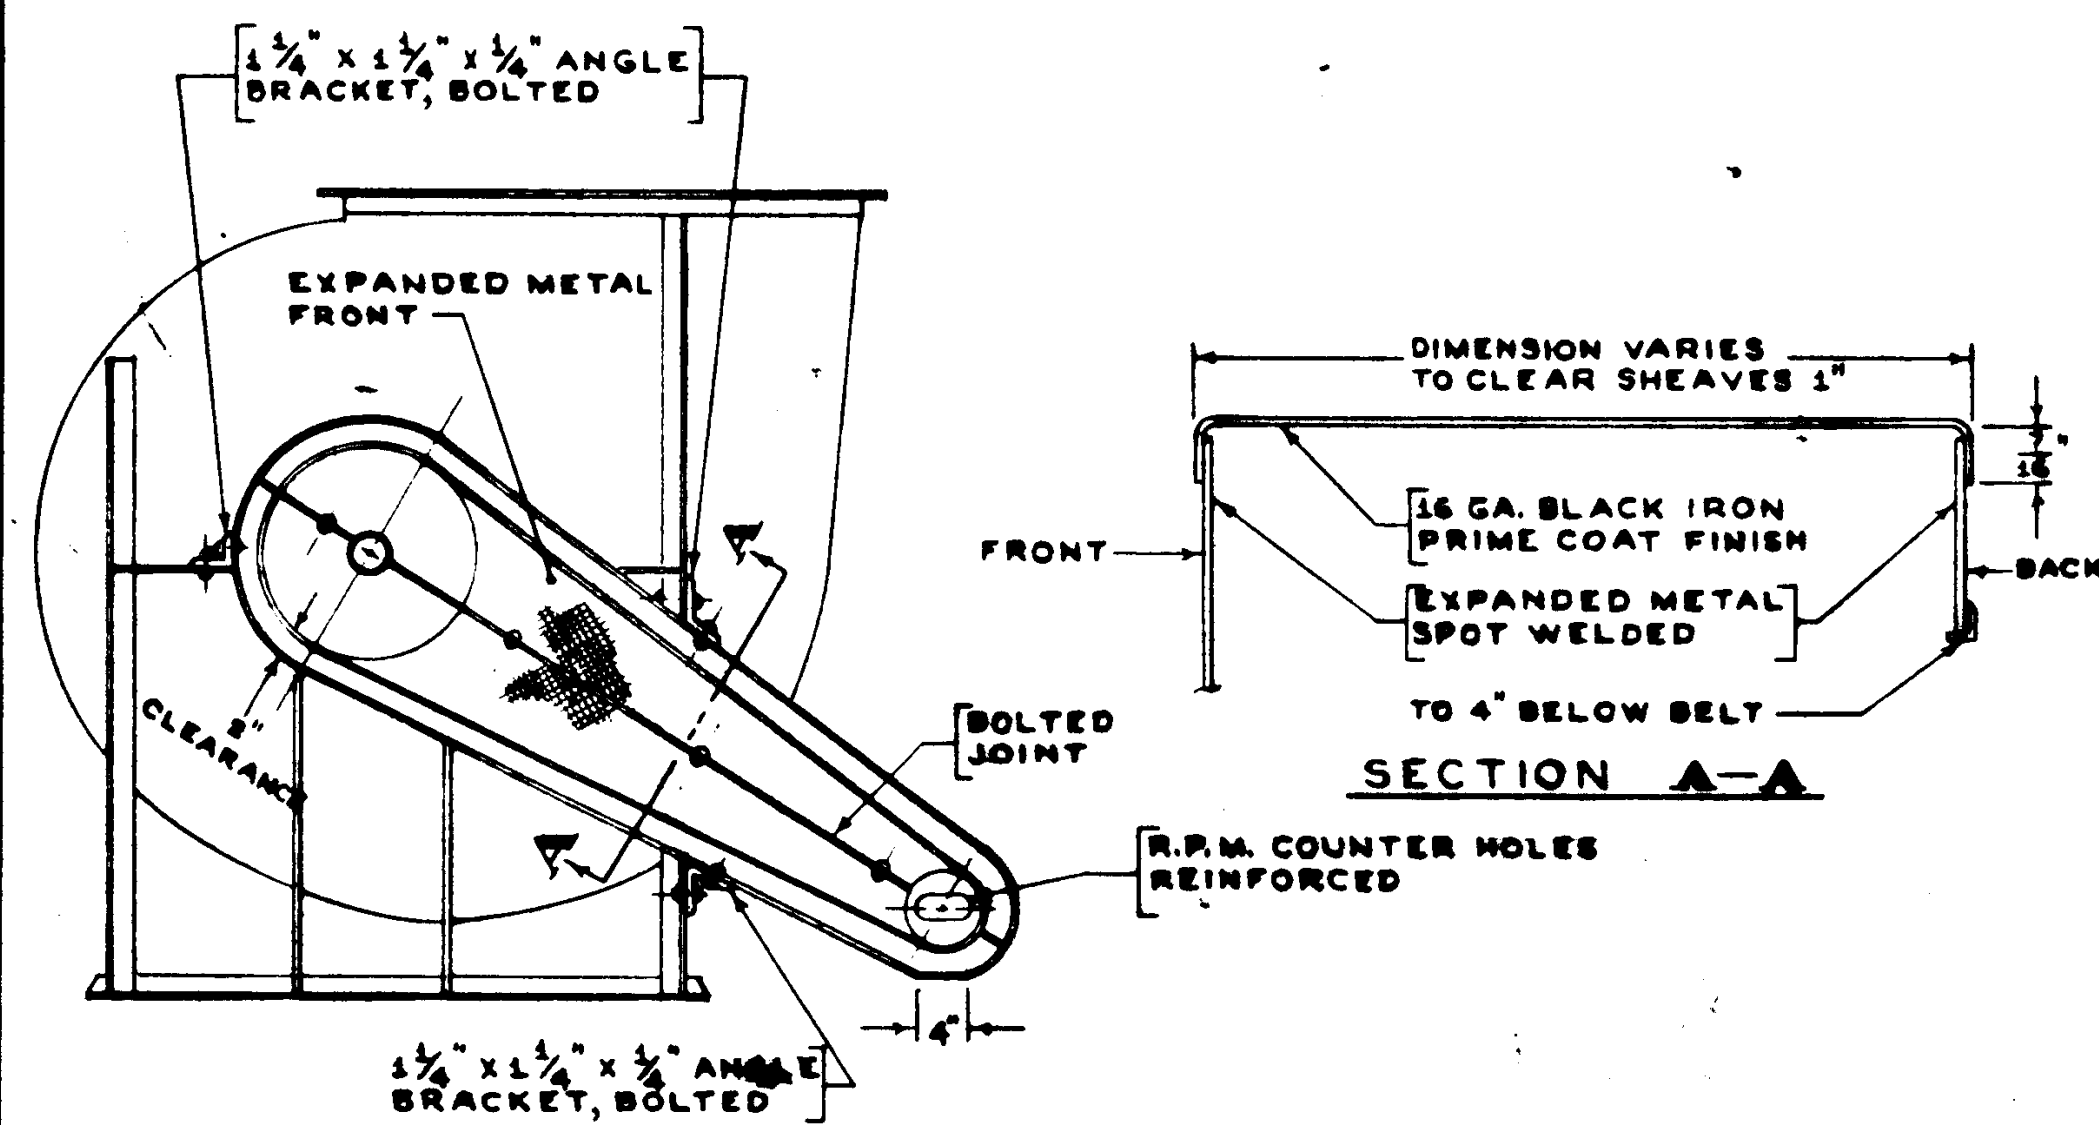


BELT GUARD DETAIL

SCALE NONE 5

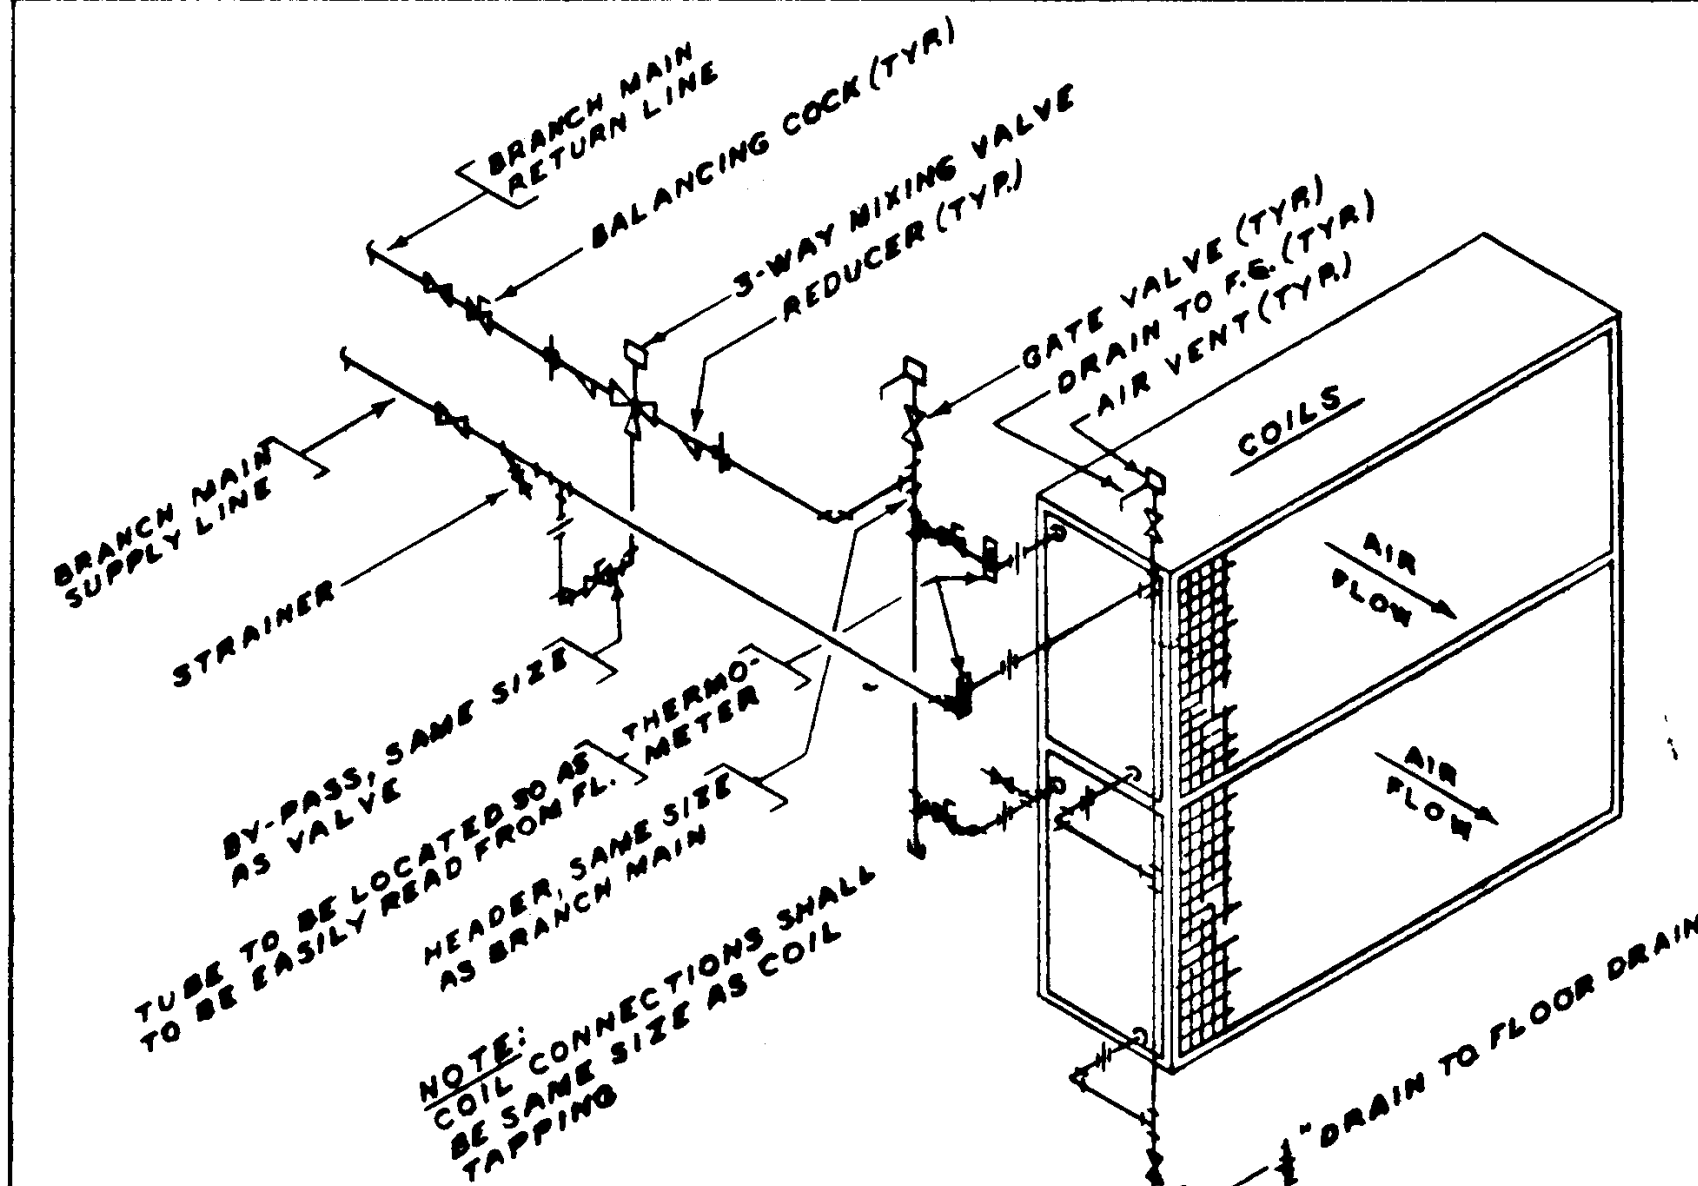


WATER COIL CONNECTIONS

SCALE NONE 6

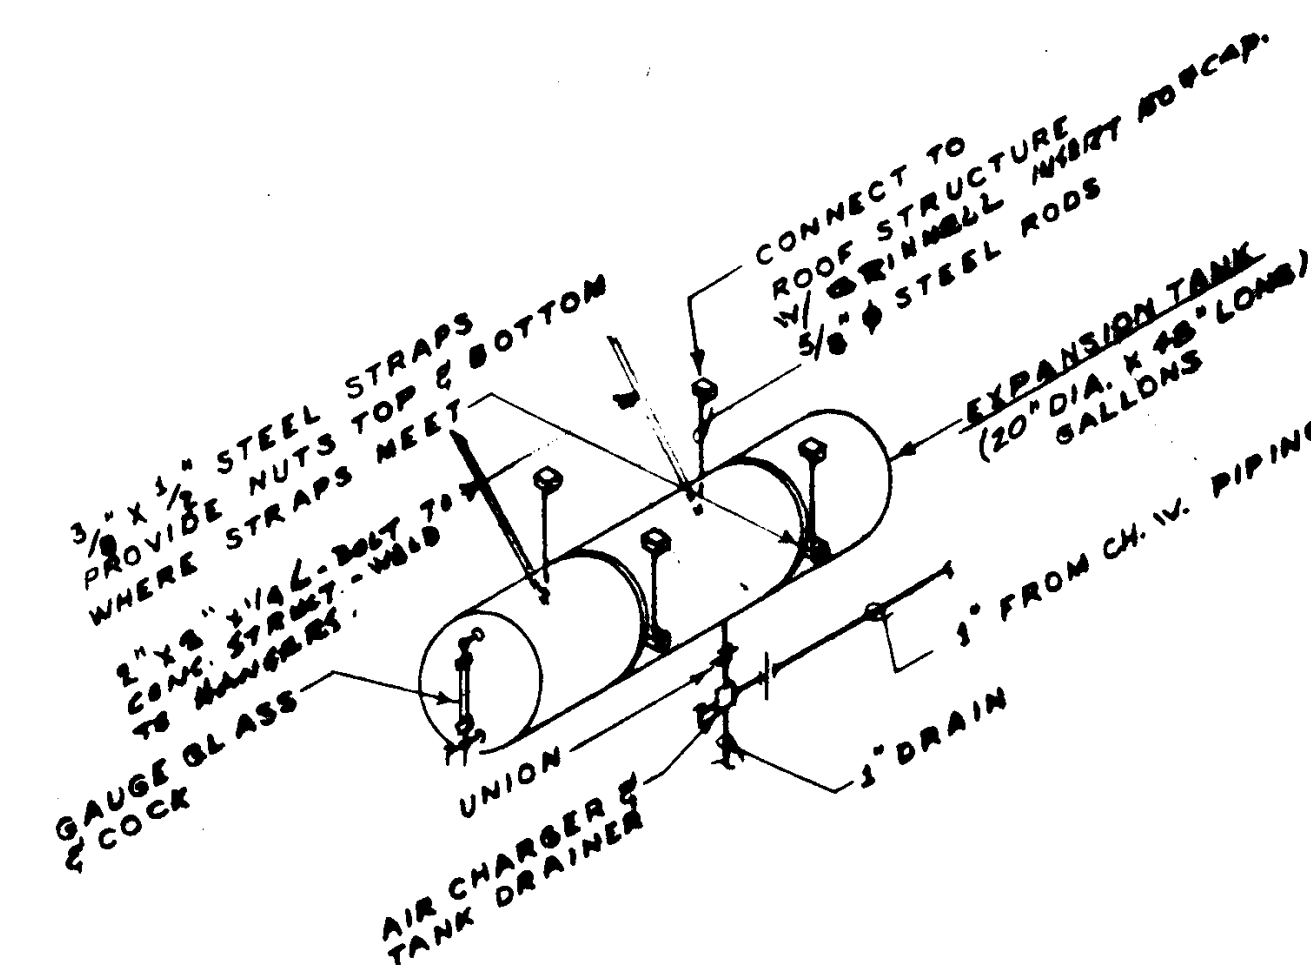


EXPANSION TANK DETAIL

SCALE NONE 7

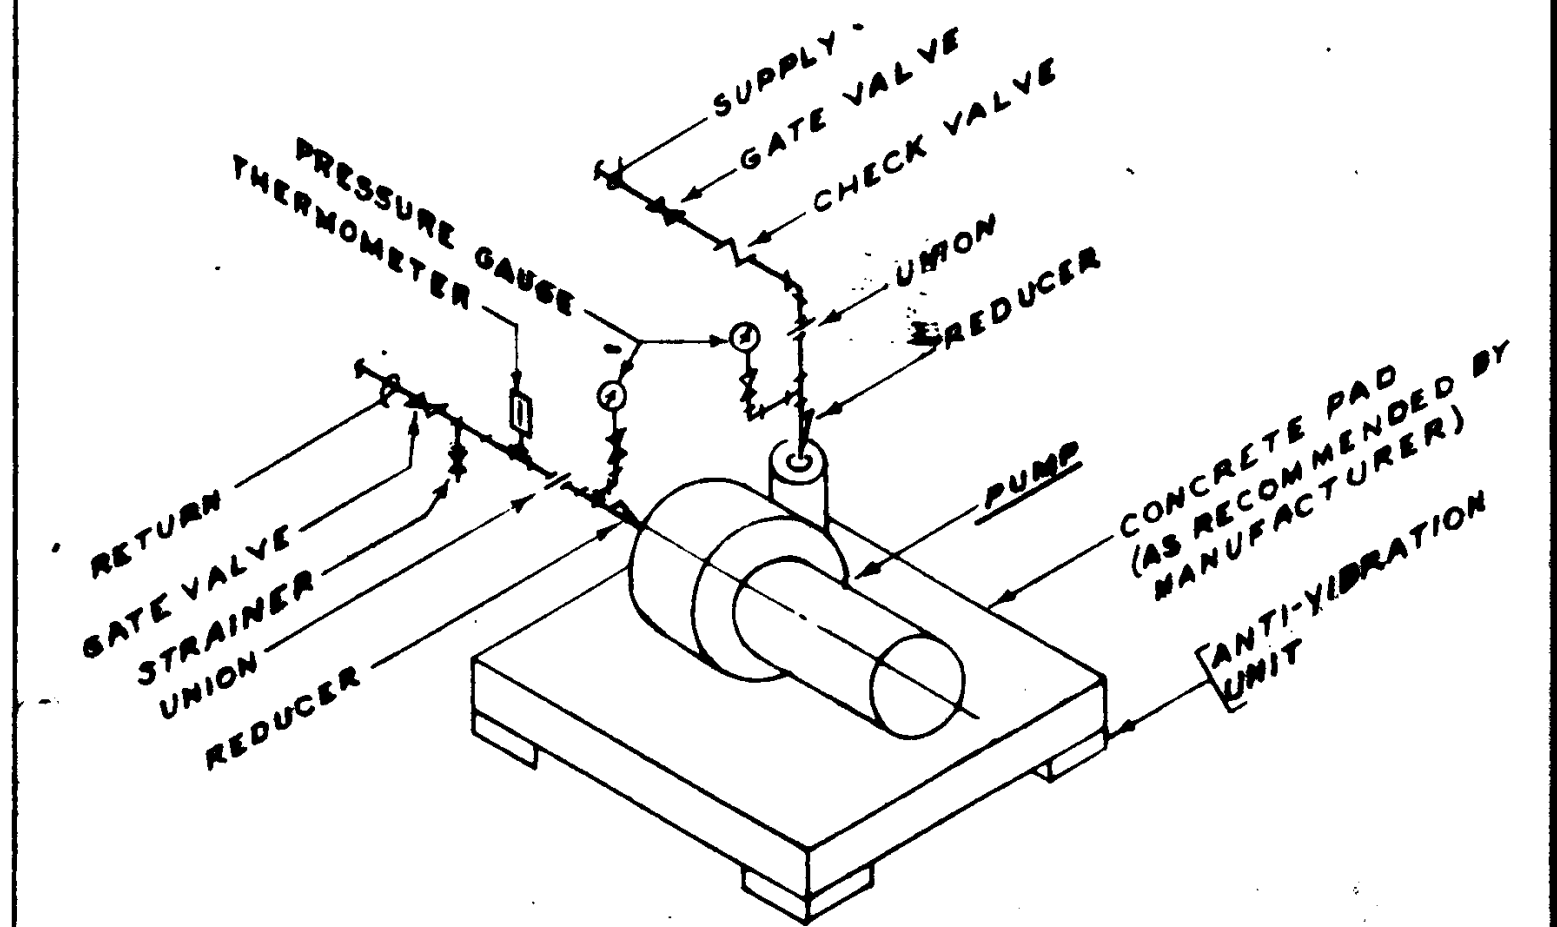


WATER PUMP PIPING DETAIL

SCALE NONE 8

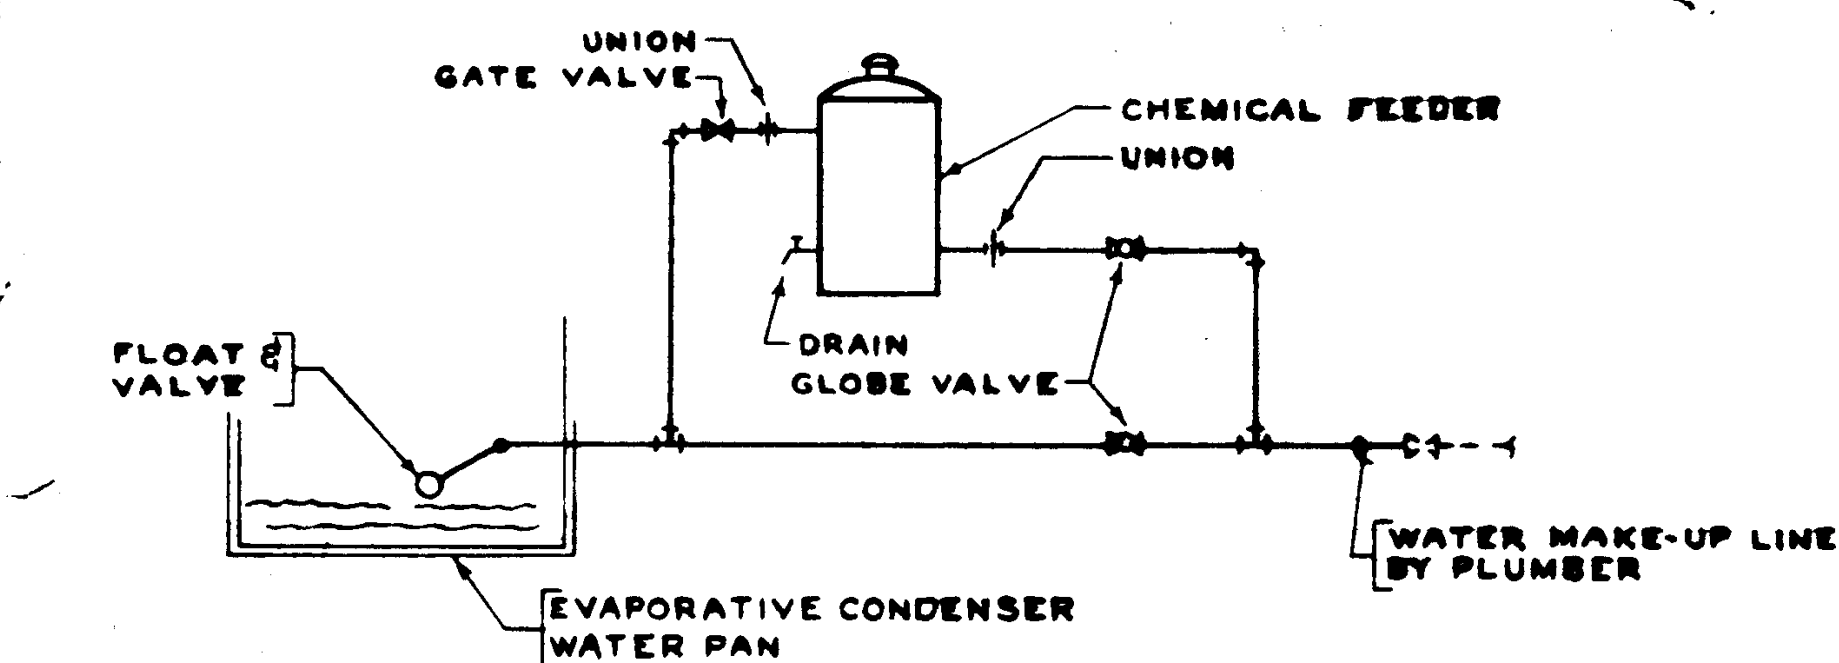

CHEMICAL FEEDER DETAIL

SCALE NONE 9

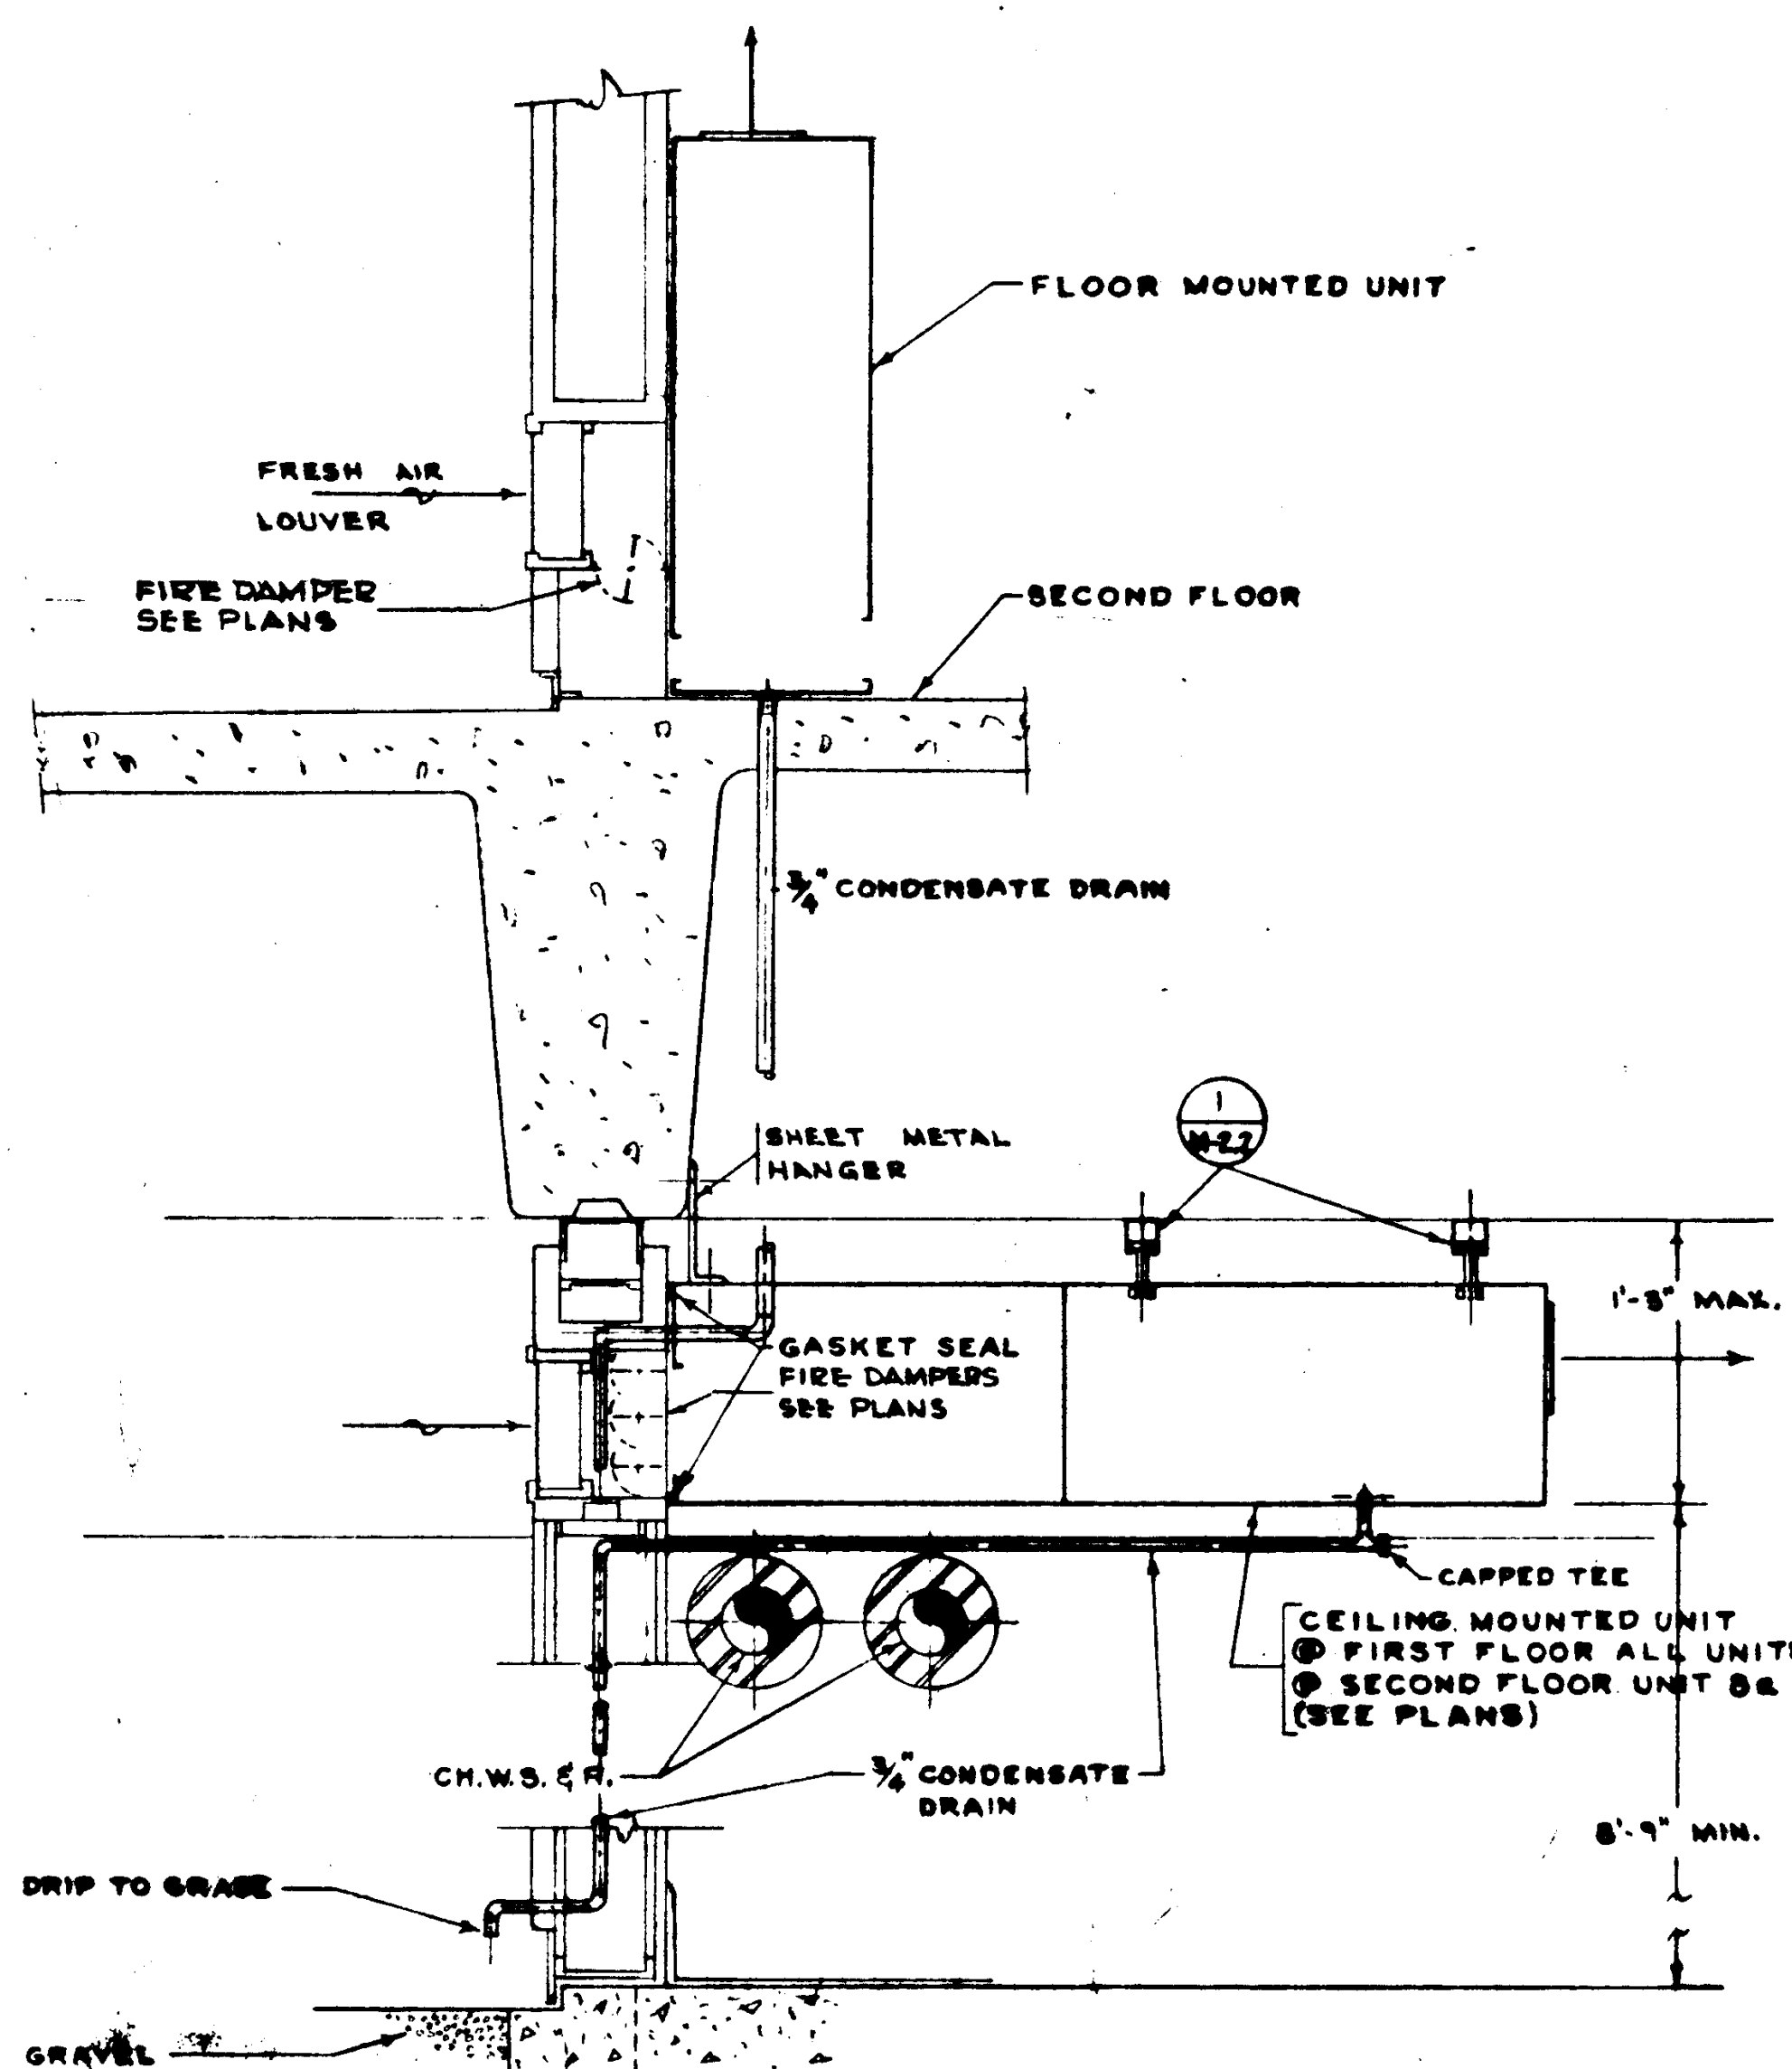


FAN SUSPENSION DETAIL

SCALE NONE 10

COIL UNIT DETAIL

SCALE NONE 11


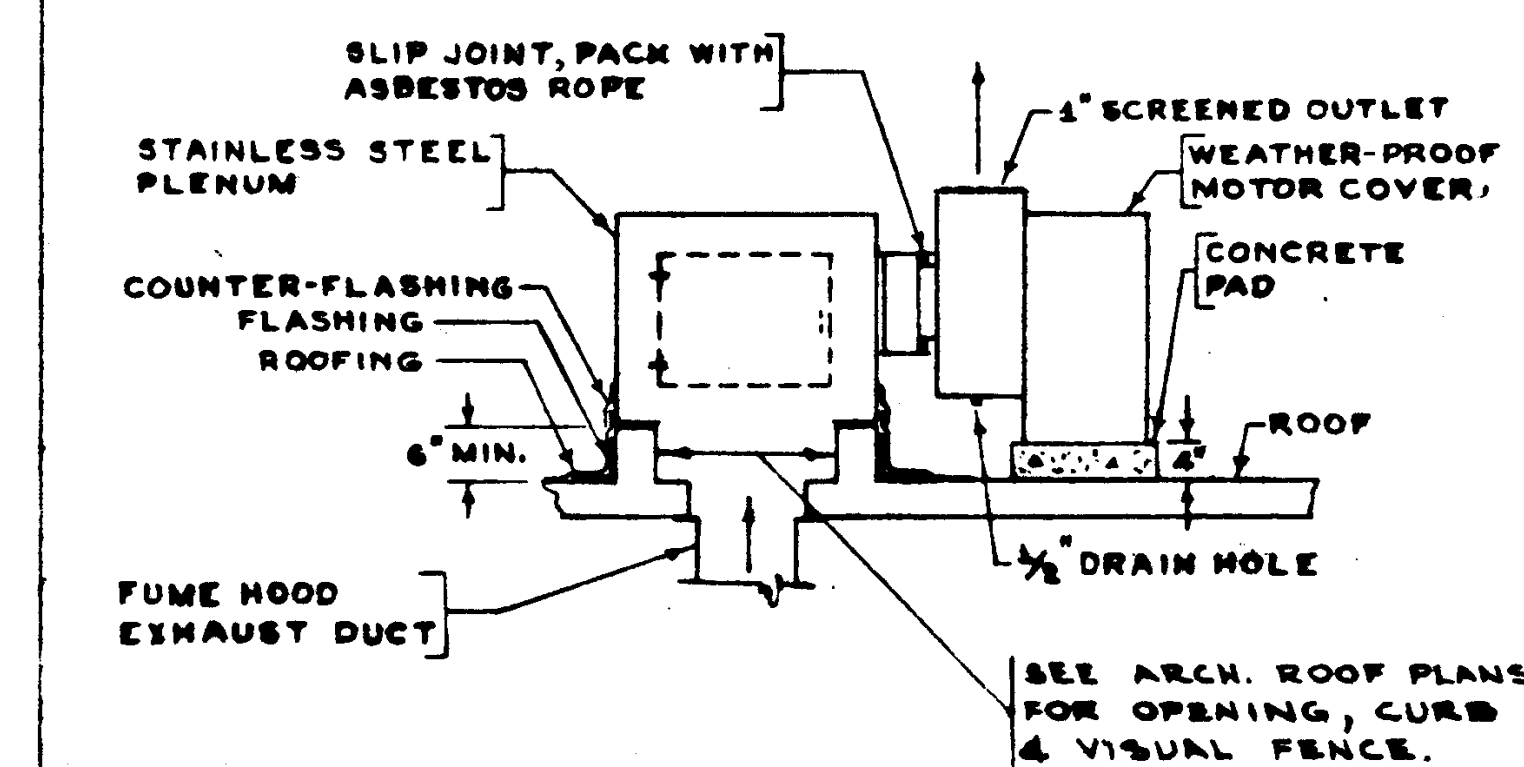


FUME HOOD EXHAUST FAN

SCALE NONE 13

LECTURE HALL RETURN

SCALE 1/2 14

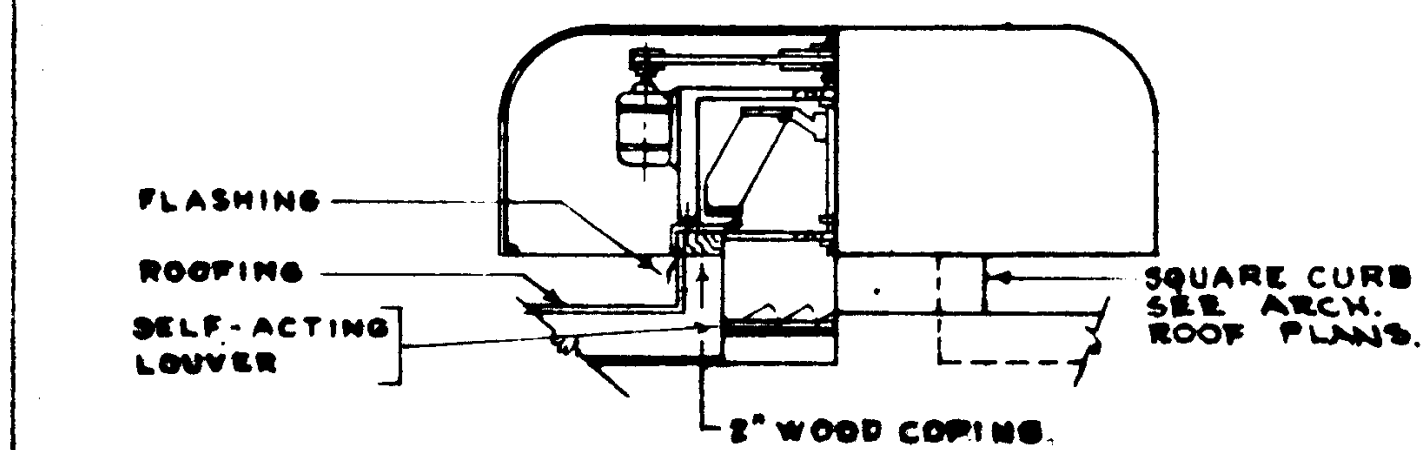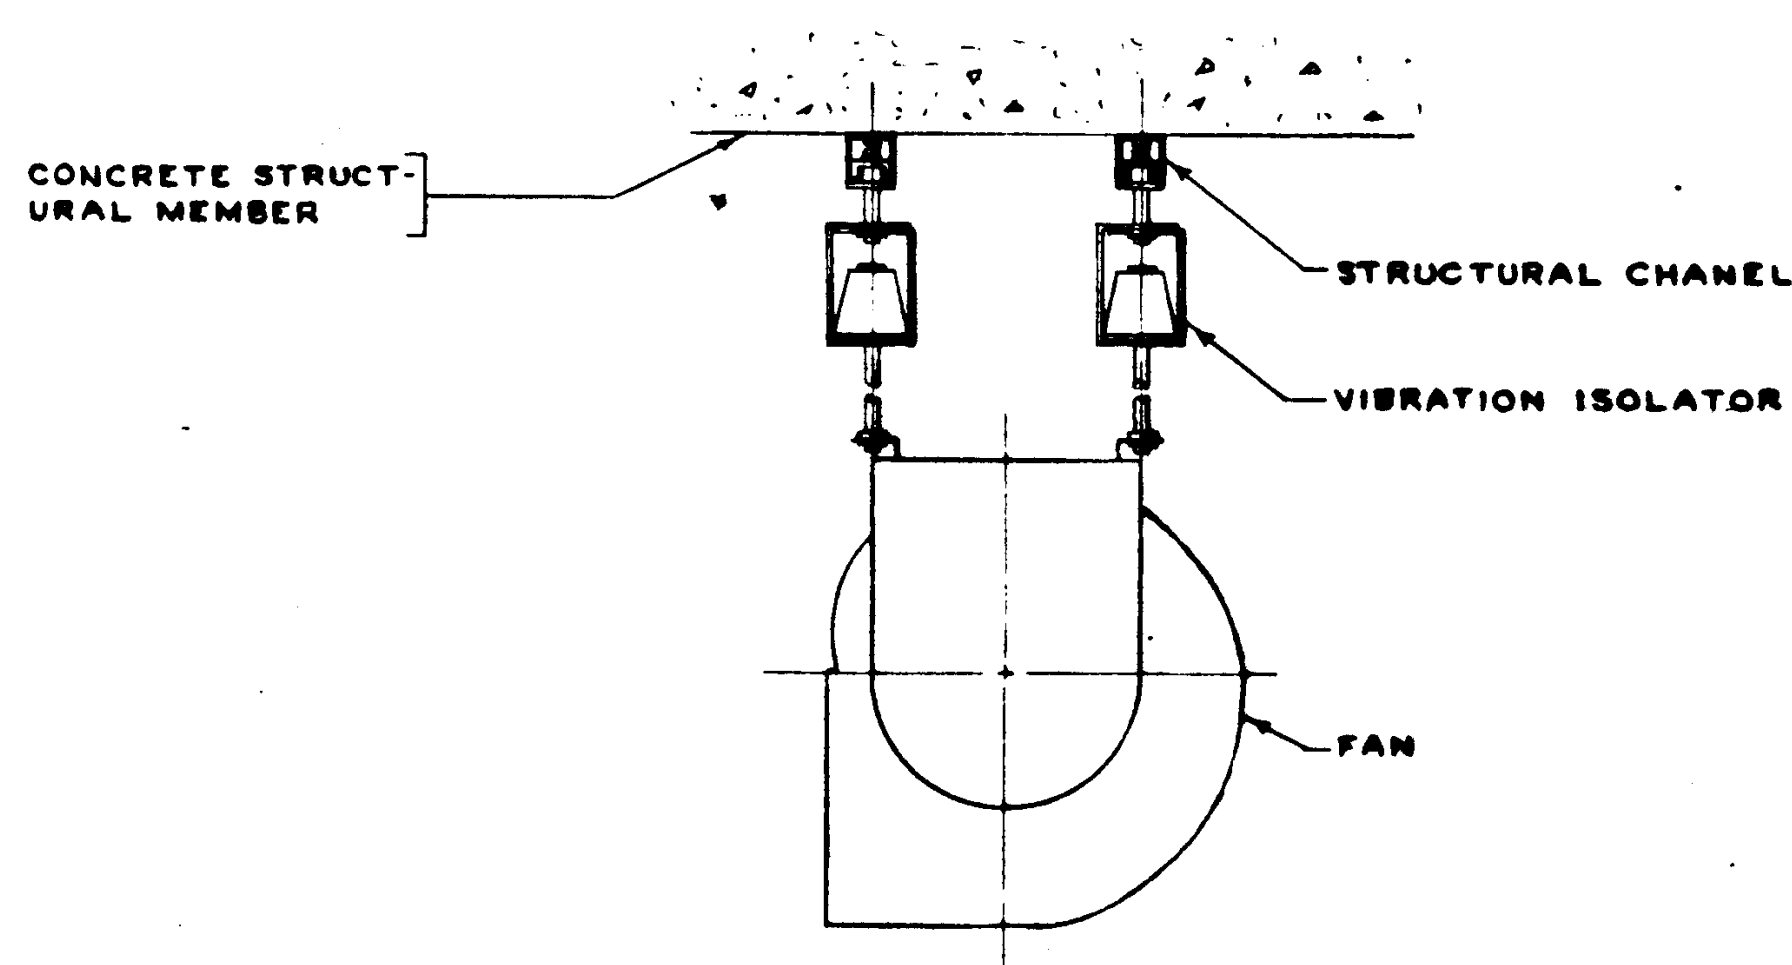


ROOF FAN DETAIL

SCALE NONE 12

UNDERGROUND PIPING

SCALE NONE 15




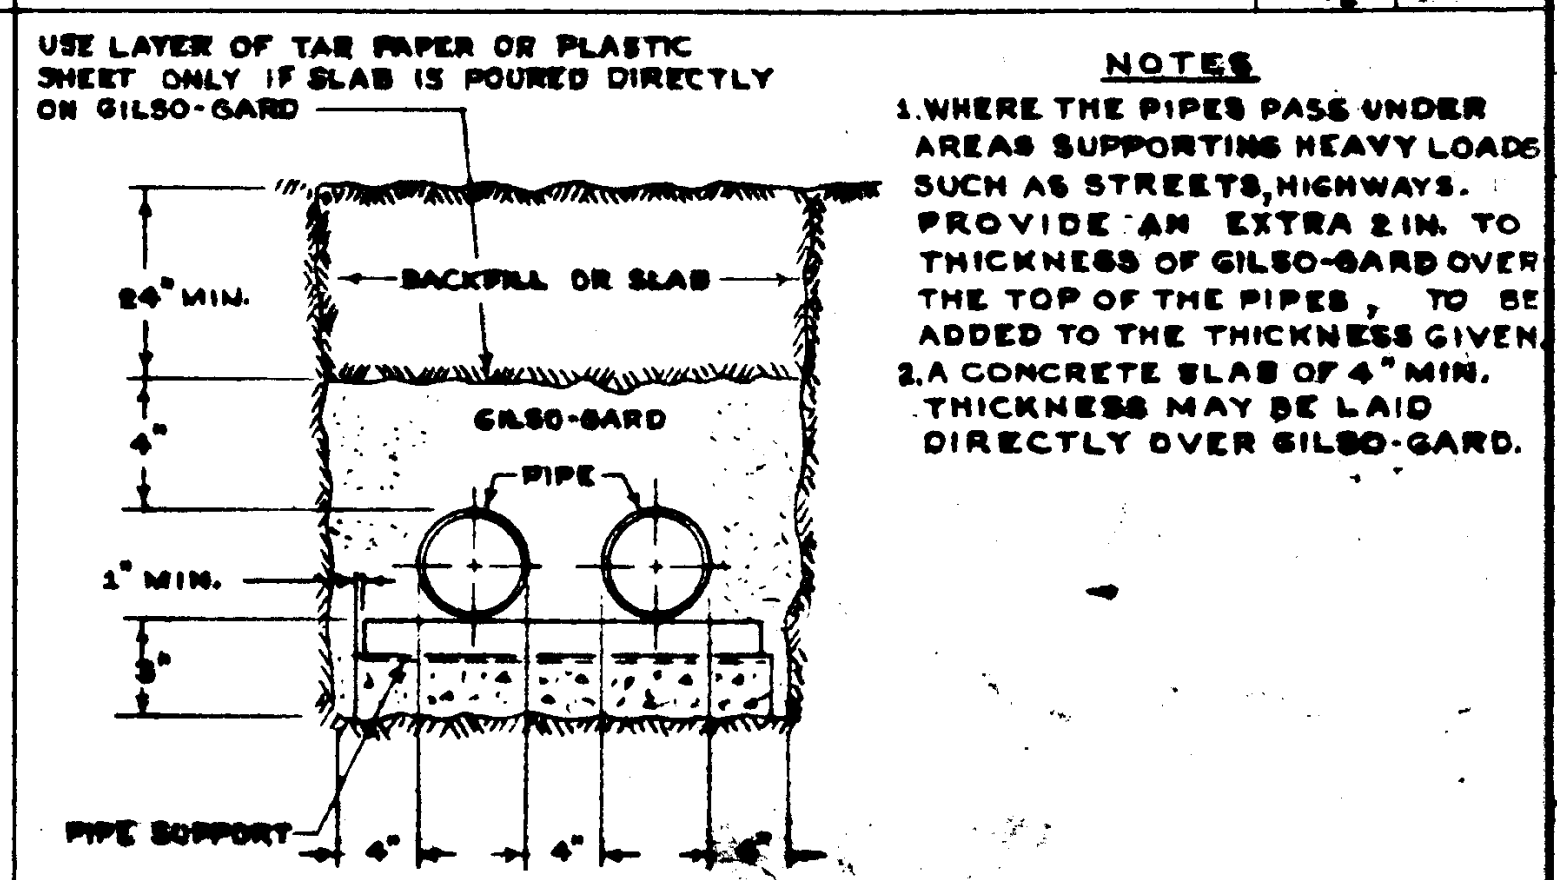


DATE	REVISIONS	DESIGNED	ARCHITECT	APPROVED
		BRANDOW & JOHNSTON J.A. MARTIN & ASSOCIATES	WILLIAM L. PEREIRA	25874 APPROVED JUN 21 1965
		Mechanical ENGINEER RALPH E. PHILLIPS, INC.	DRAWN BY ALICE	STATE FIRE MARSHAL STATE OF CALIFORNIA APR 21 1965
		Electrical ENGINEER RALPH E. PHILLIPS, INC.	CHECKED BY W.C.L.	APPROVED
		Civil ENGINEER D. SMITHMAN & ASSOCIATES MOFFATT & NIGROL		




ASSOCIATED ARCHITECTS:
WILLIAM L. PEREIRA & ASSOCIATES
A QUINCY JONES-FREDERICK E. EDMONDS & ASSOCIATES
BLUBROCK ELLERBROCK & ASSOCIATES
URBANUS SQUARE • MACARTHUR BOULEVARD AT FORD ROAD
TELEPHONE 714/675-2640 • CORONA DEL MAR, CALIFORNIA

GOLDEN WEST COLLEGE
HUNTINGTON BEACH, CALIFORNIA
ORANGE COAST JUNIOR COLLEGE DISTRICT


DETAILS
DATE 6-15-65
SHEET NO. M2.1

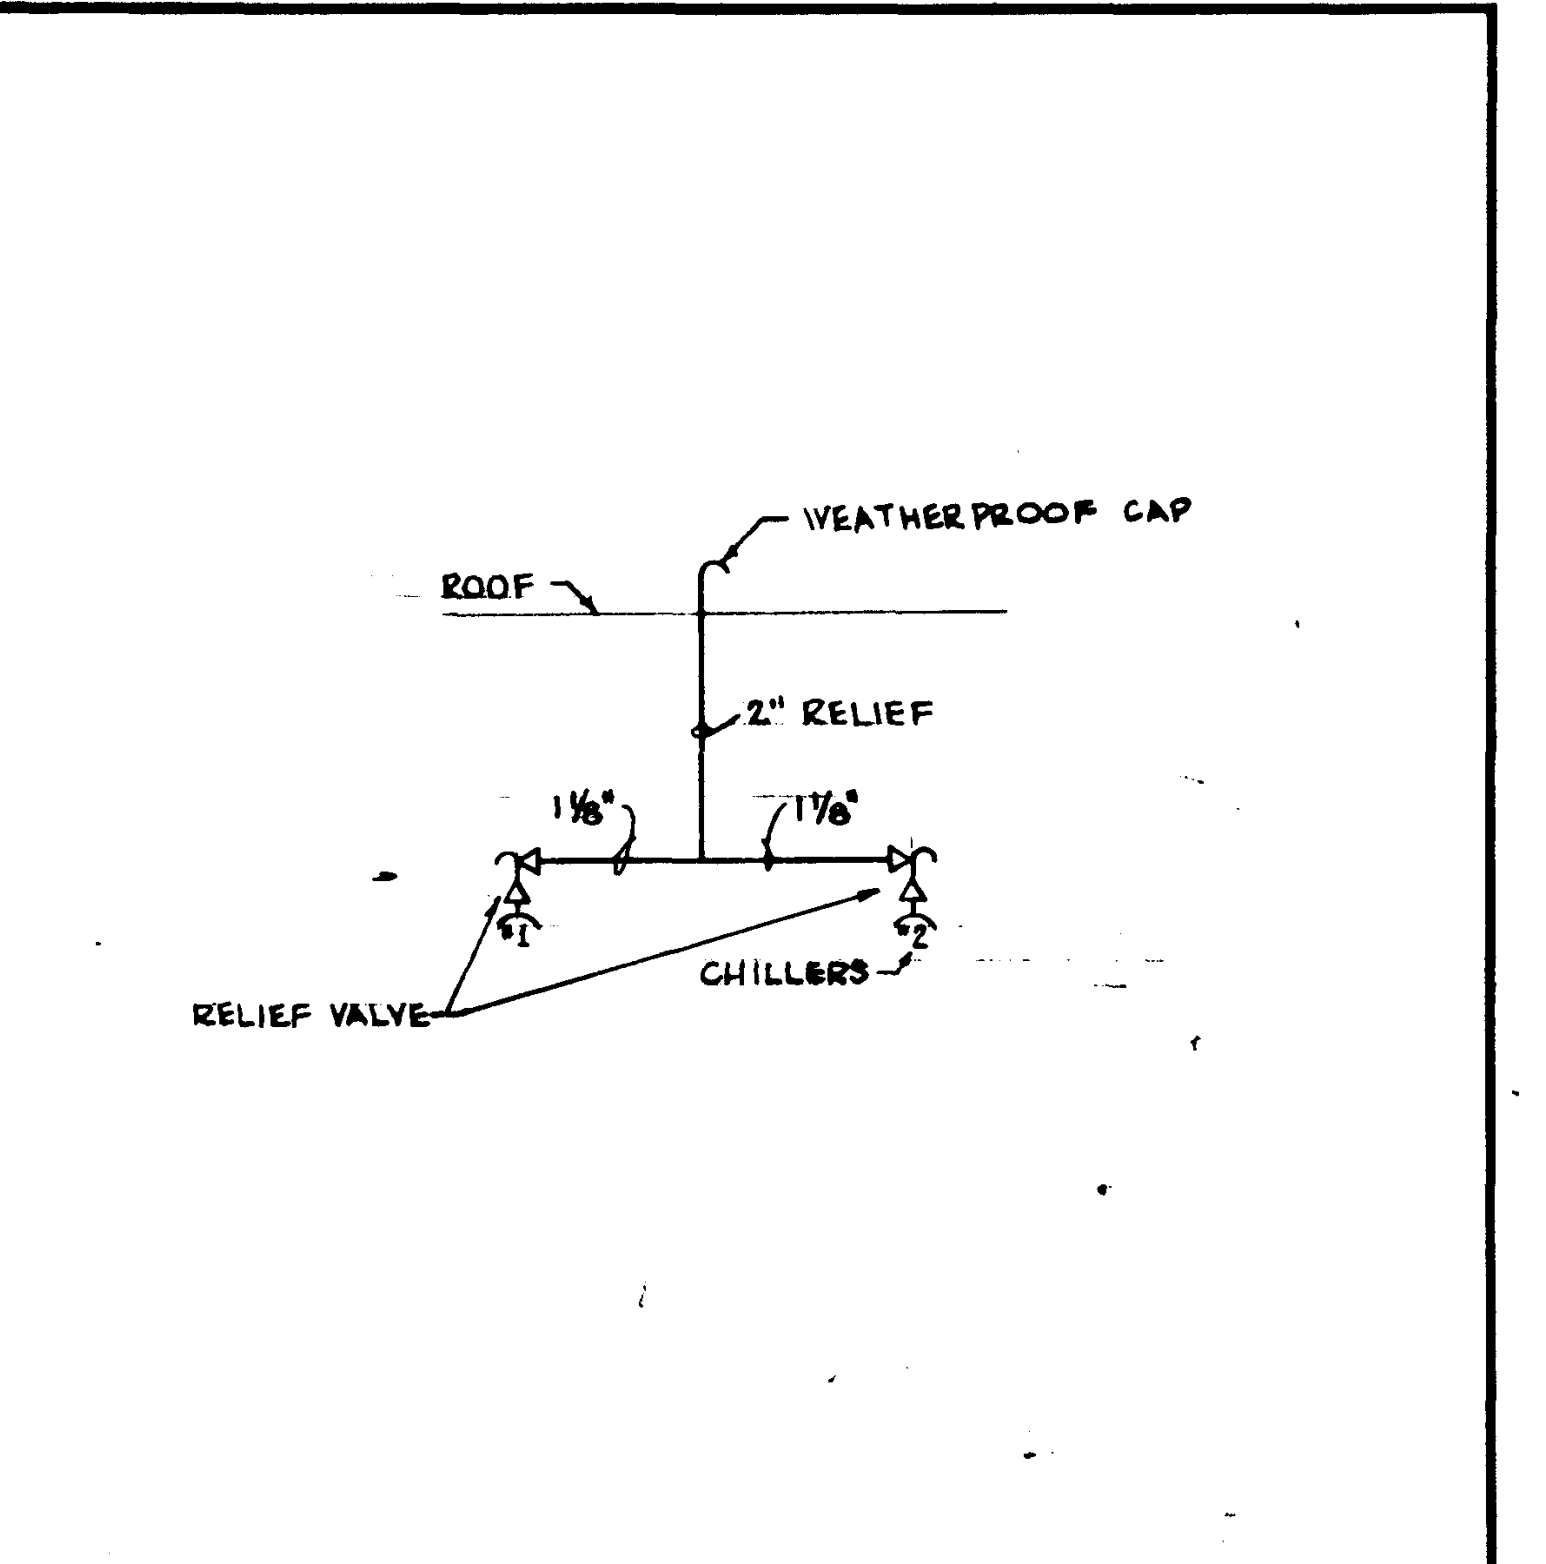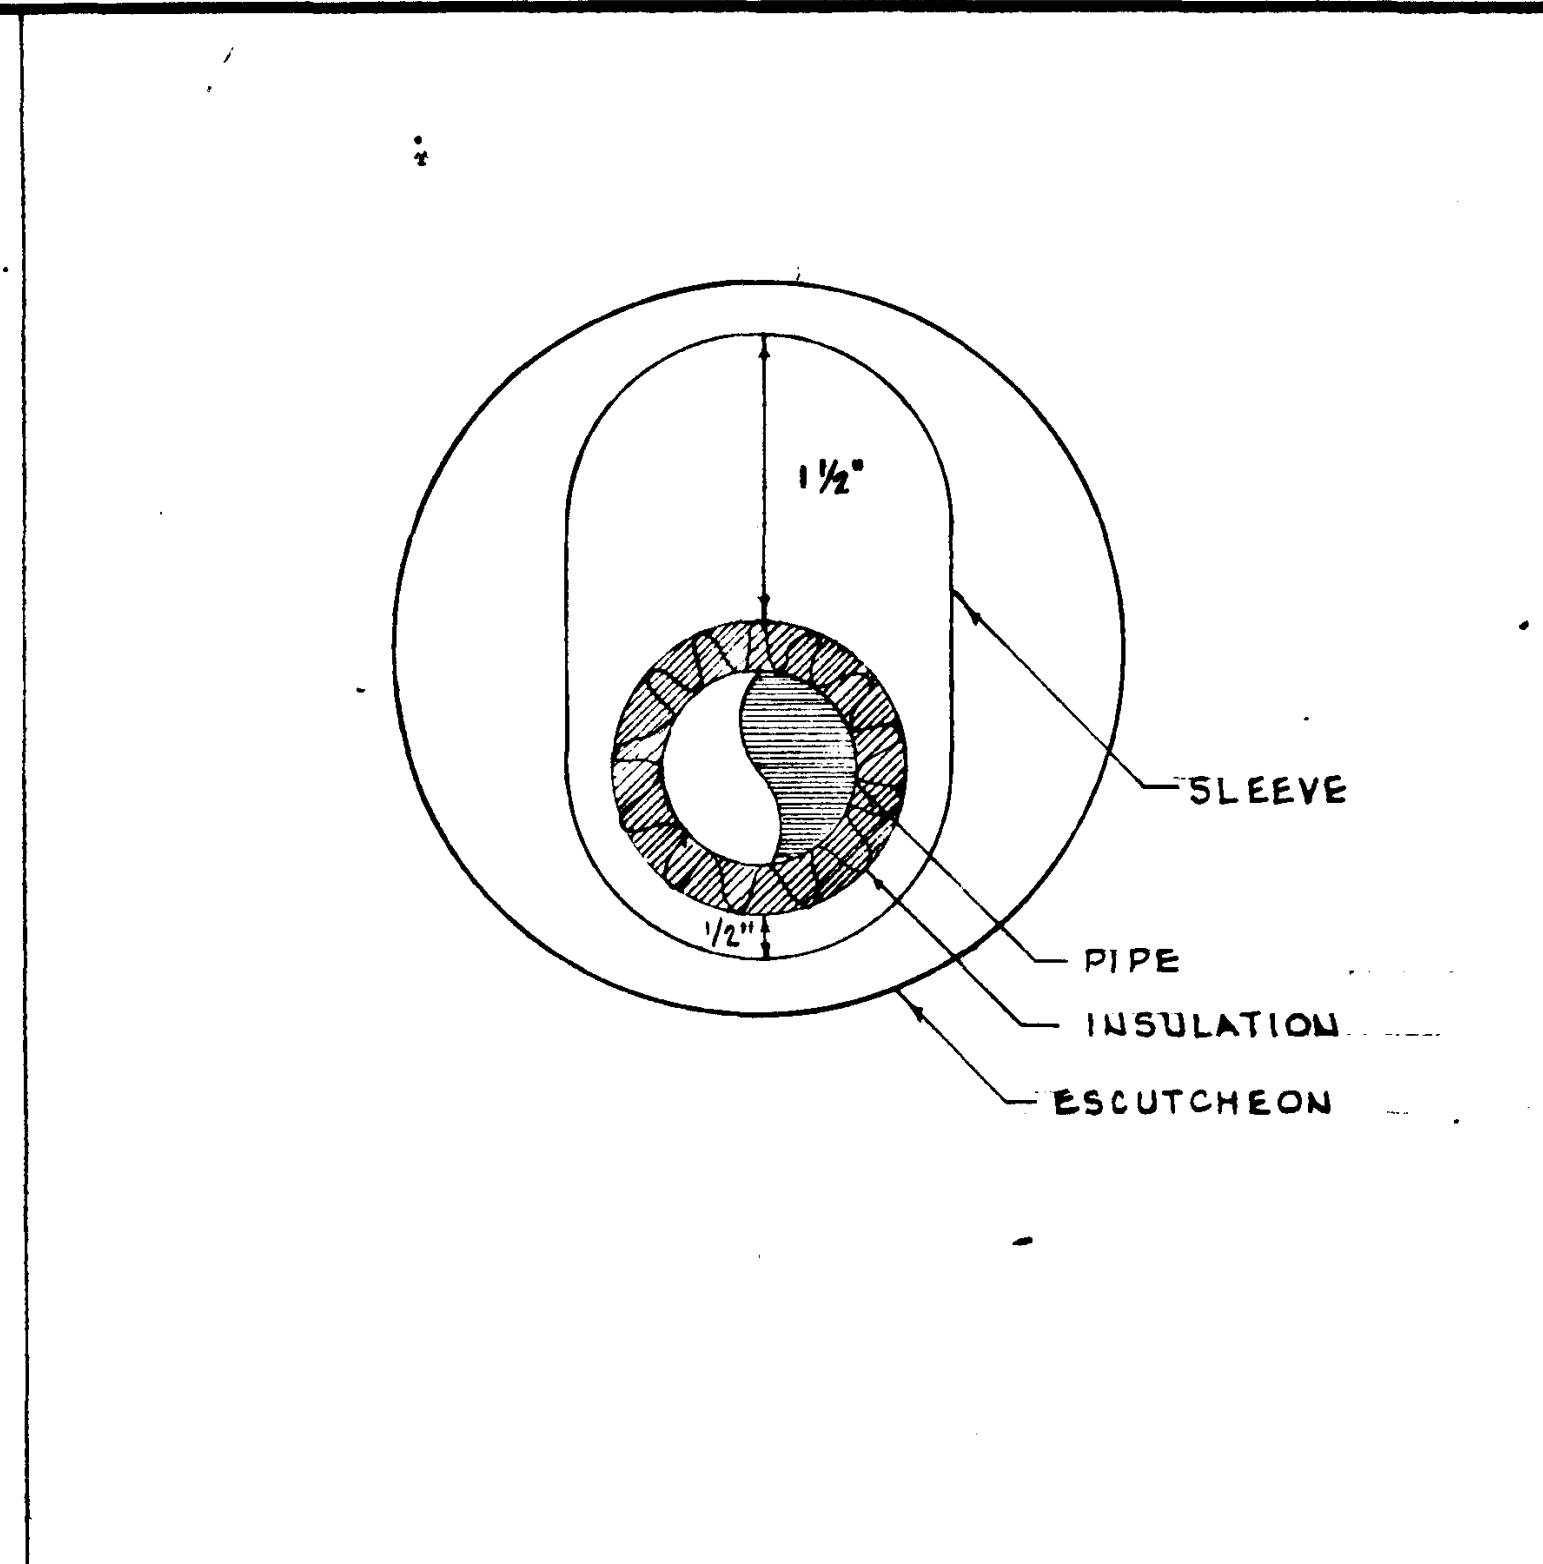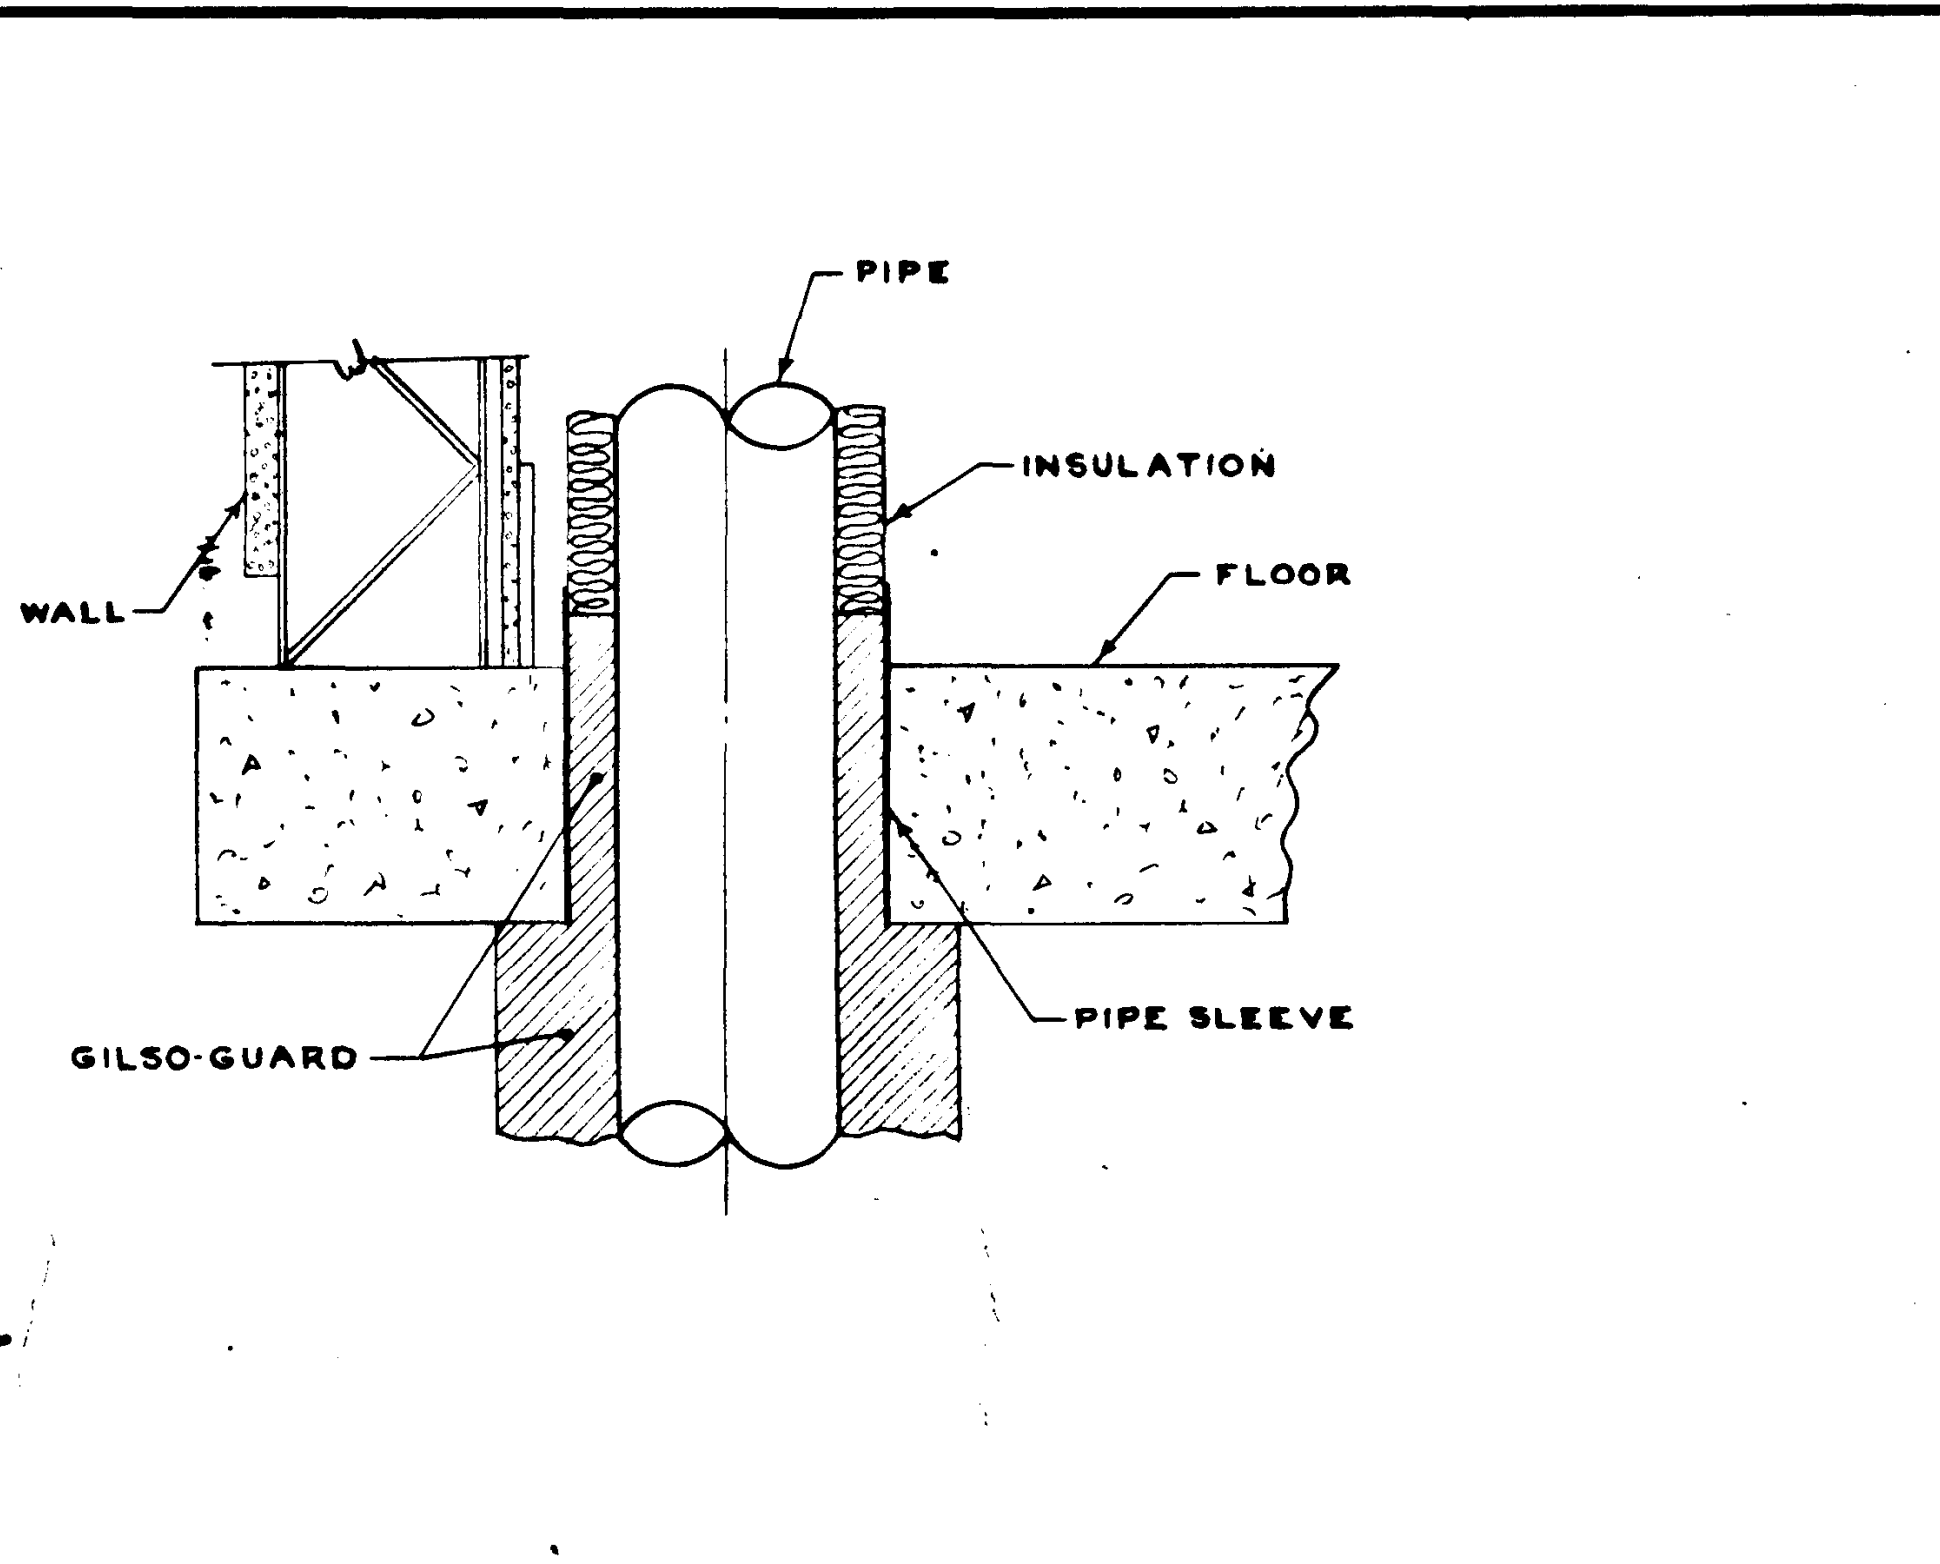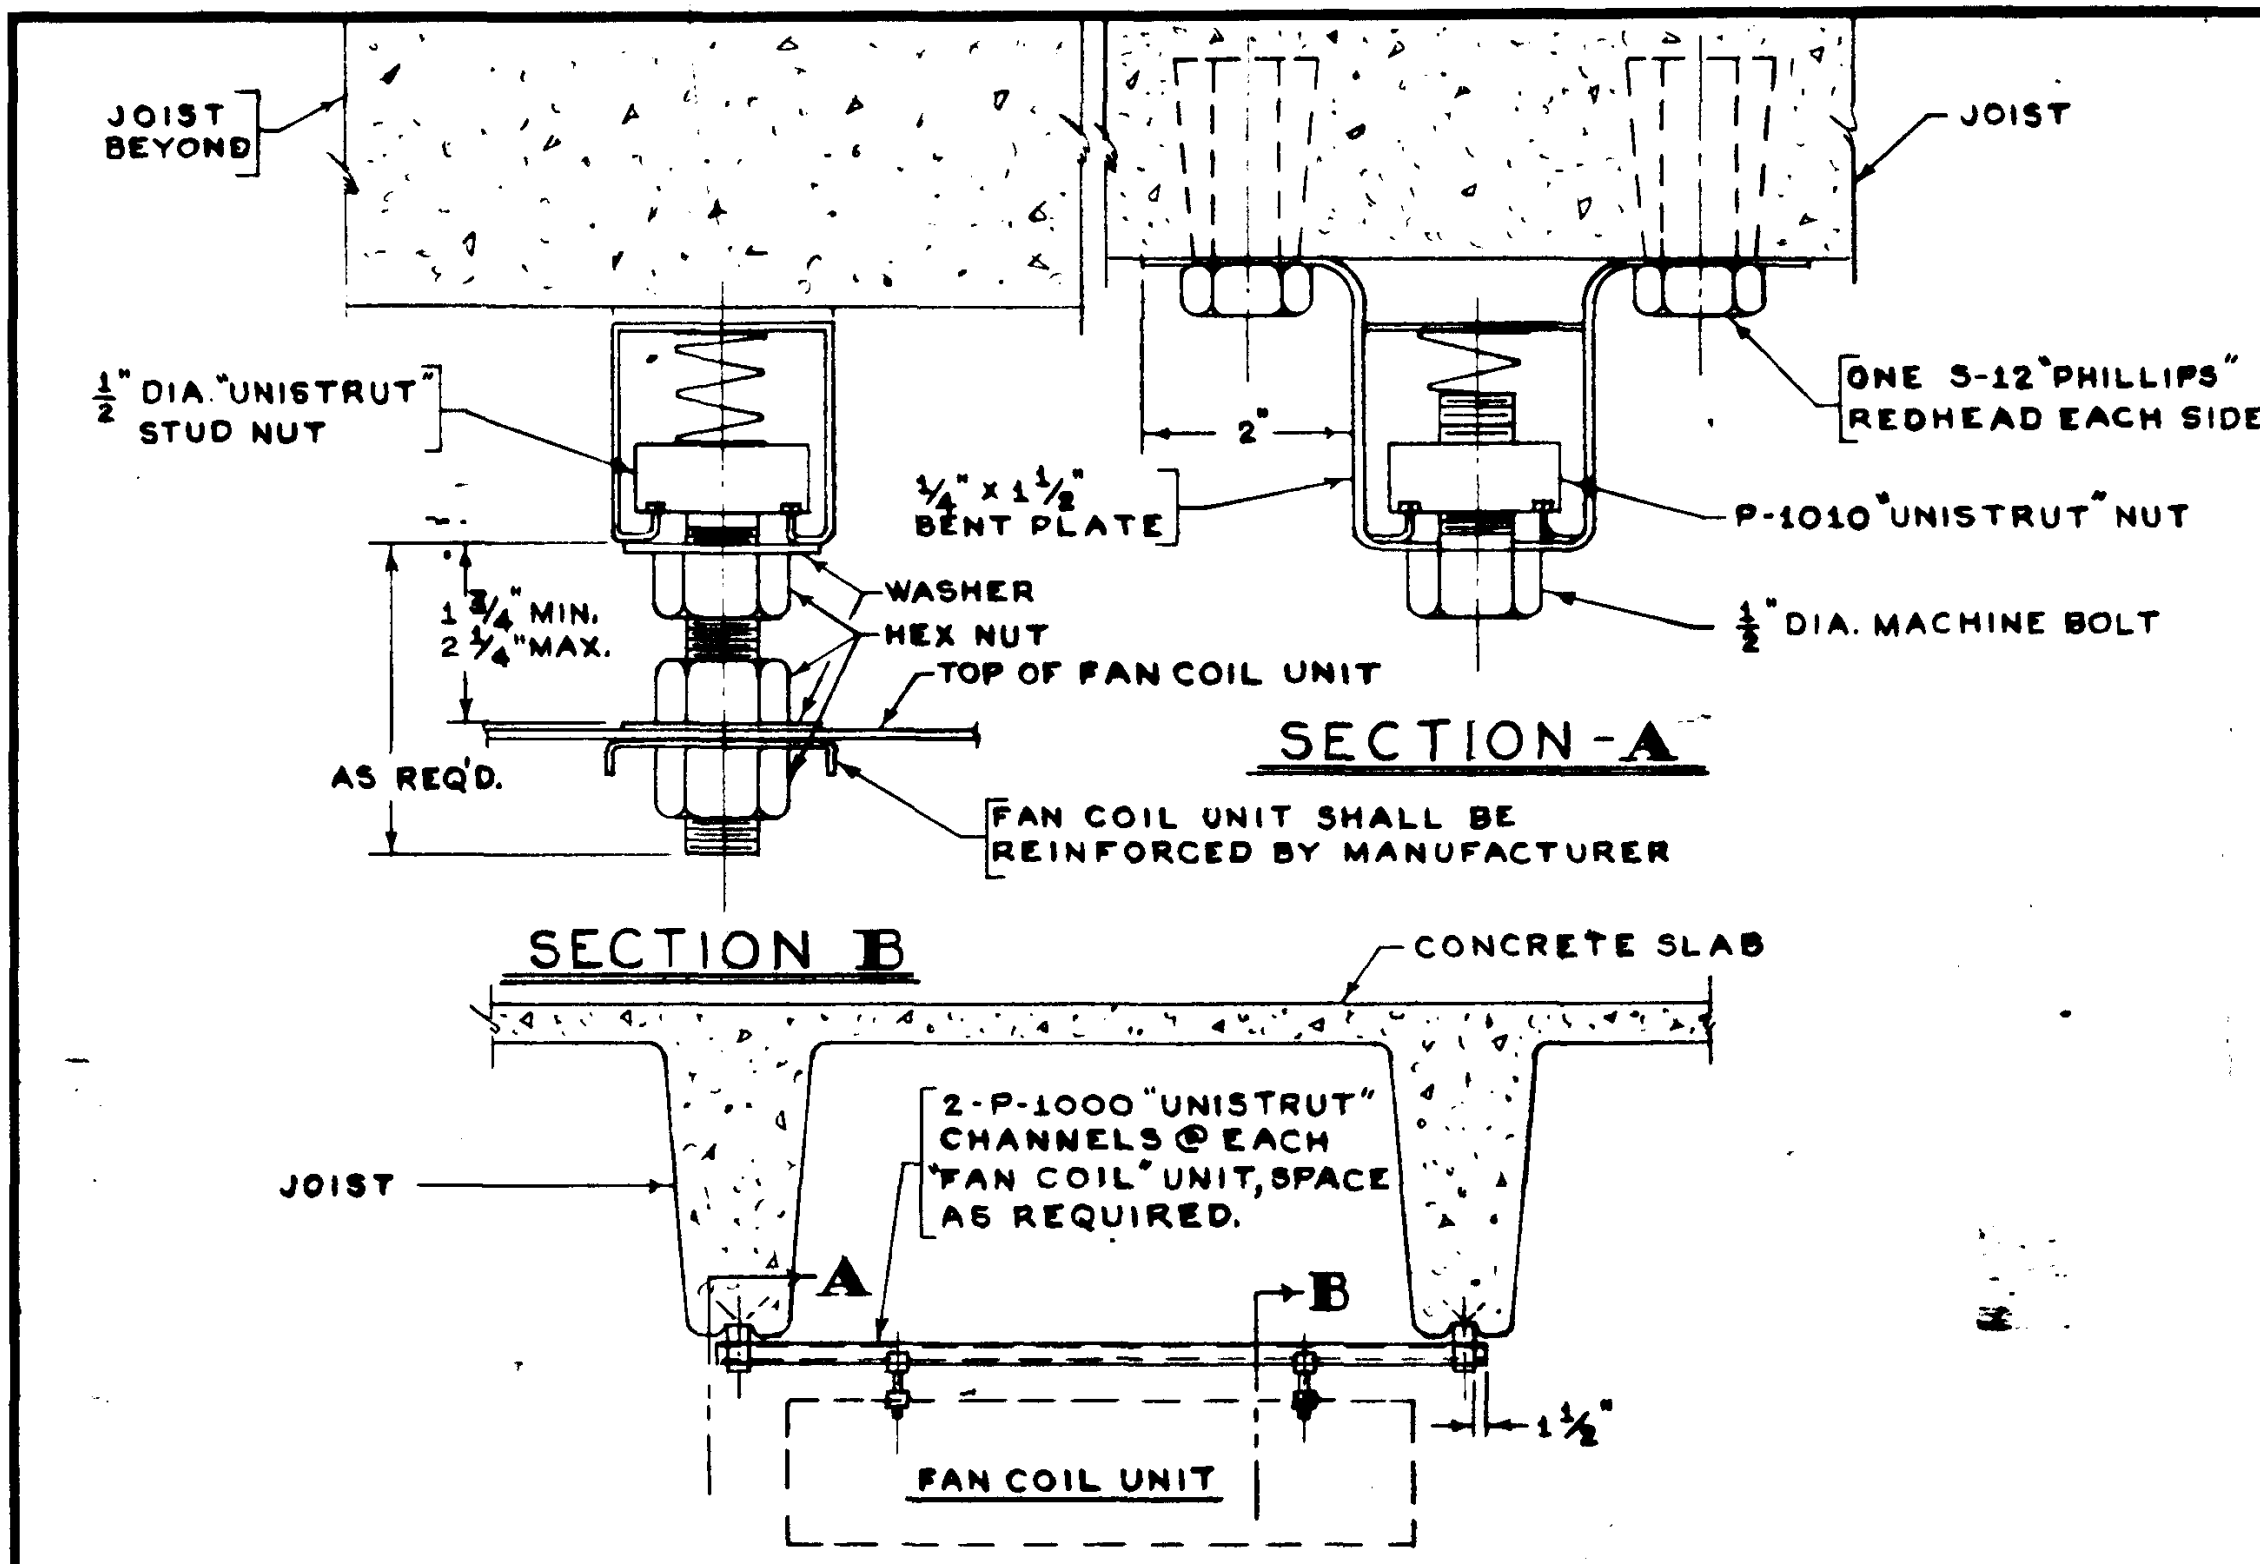

SUSPENDED FAN COIL UNIT SUPPORT SCALE NONE 1 PIPING THRU SLAB ON GRADE SCALE NONE 2 PIPE SLEEVE THRU WALL SCALE NONE 3 REFRIG. RELIEF PIPING SCALE NONE 4



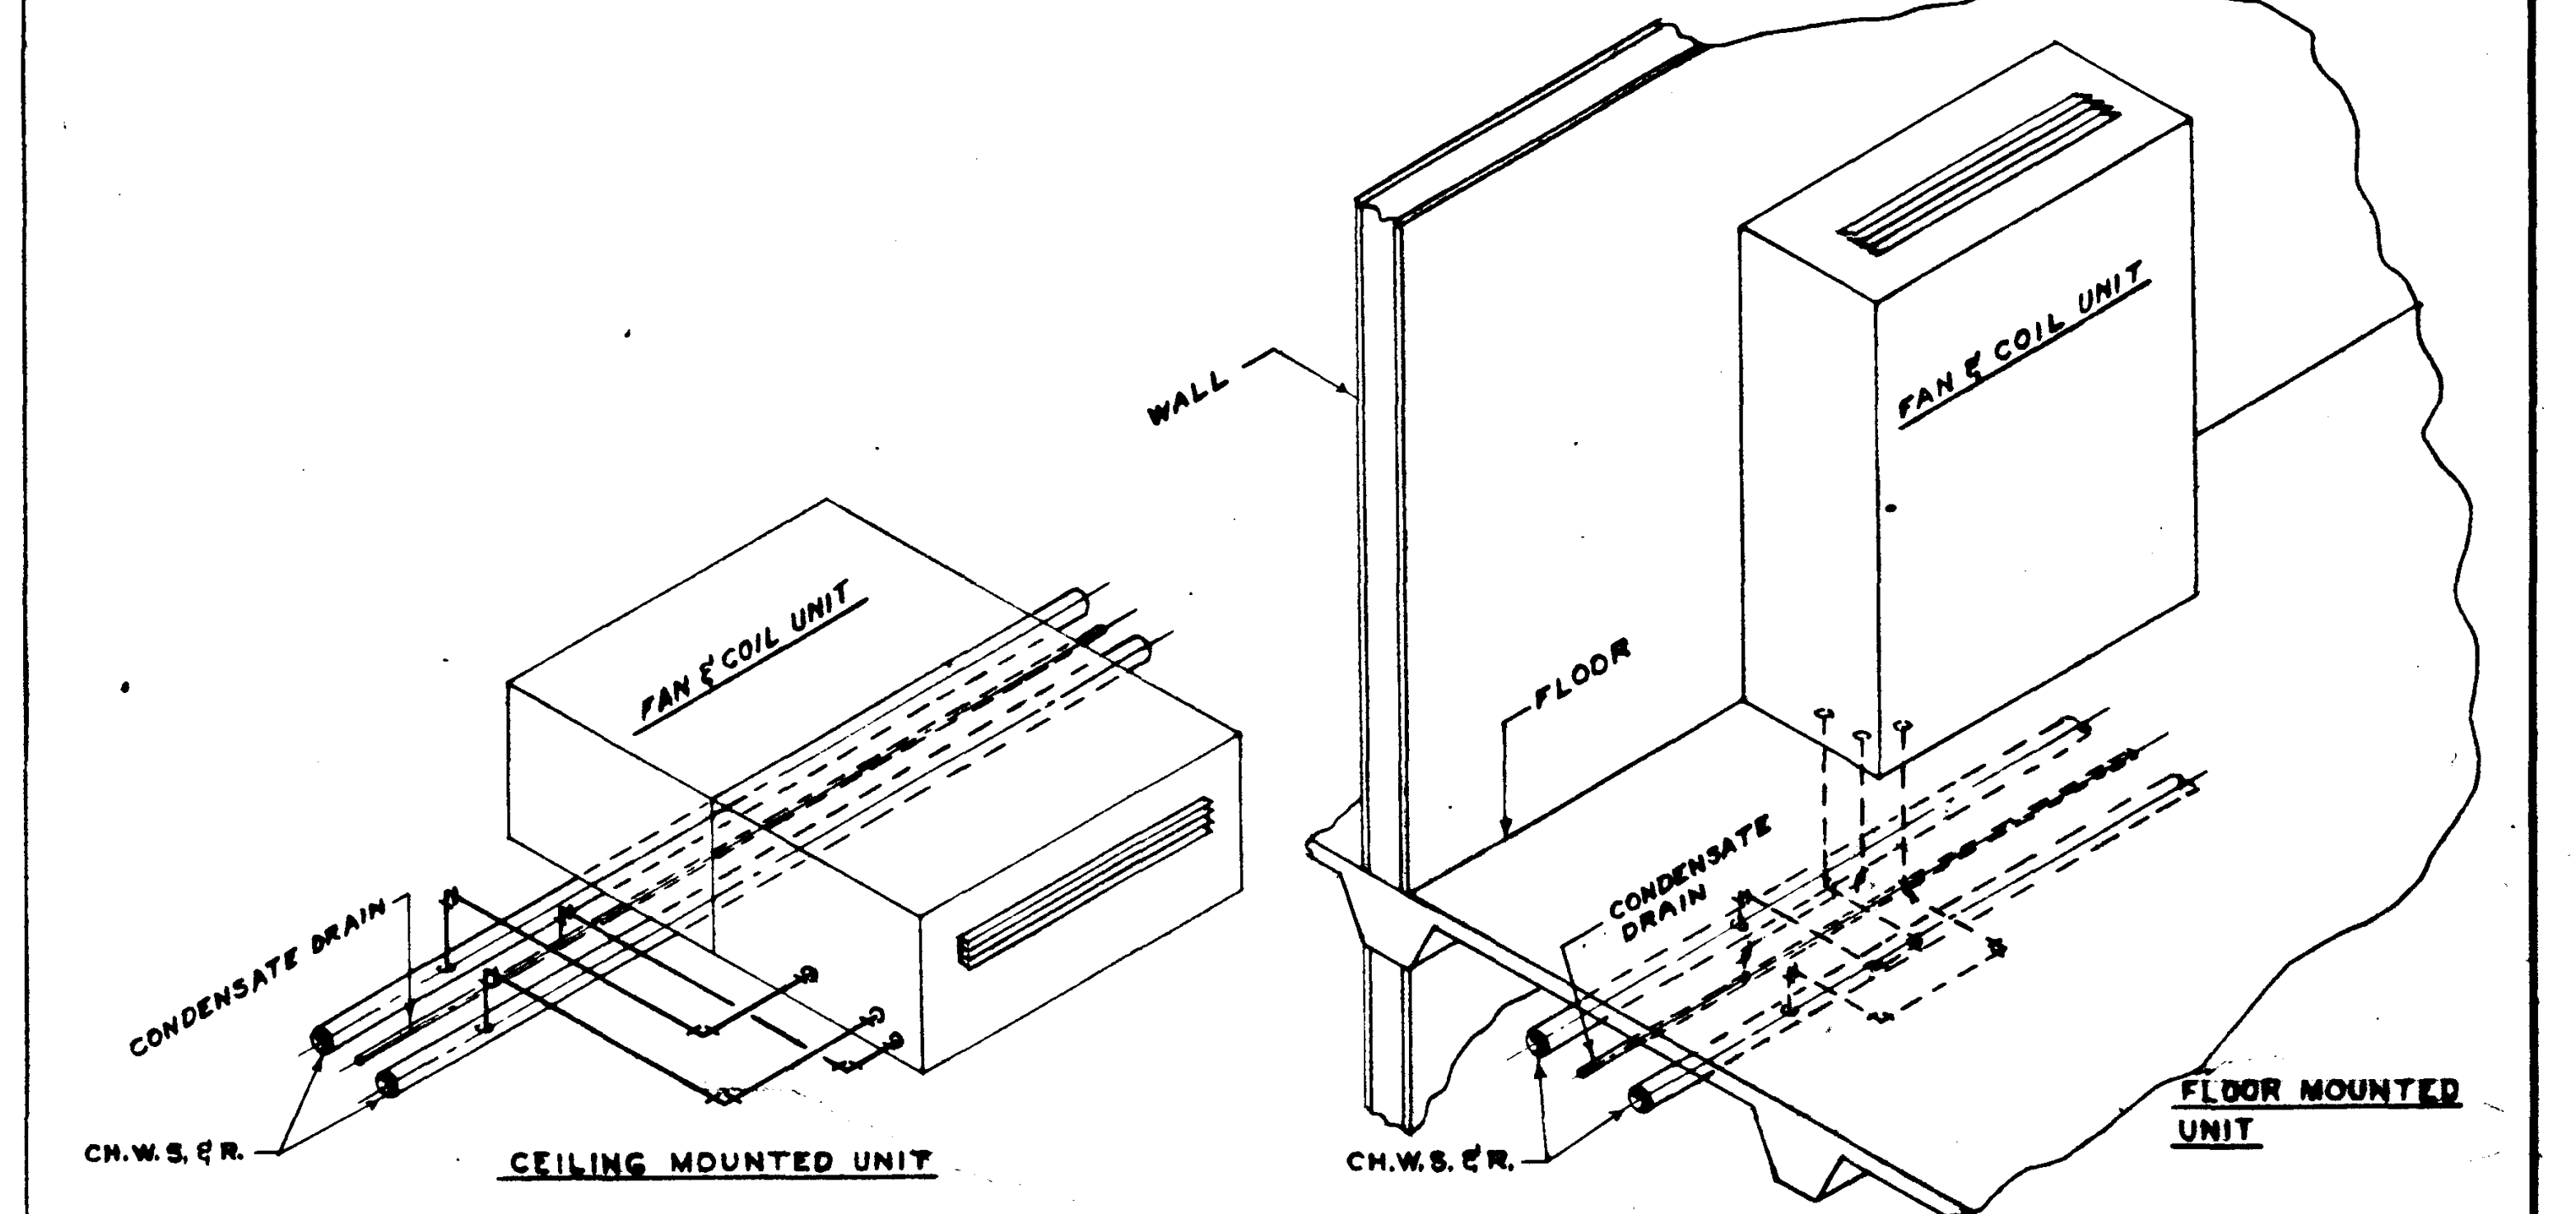
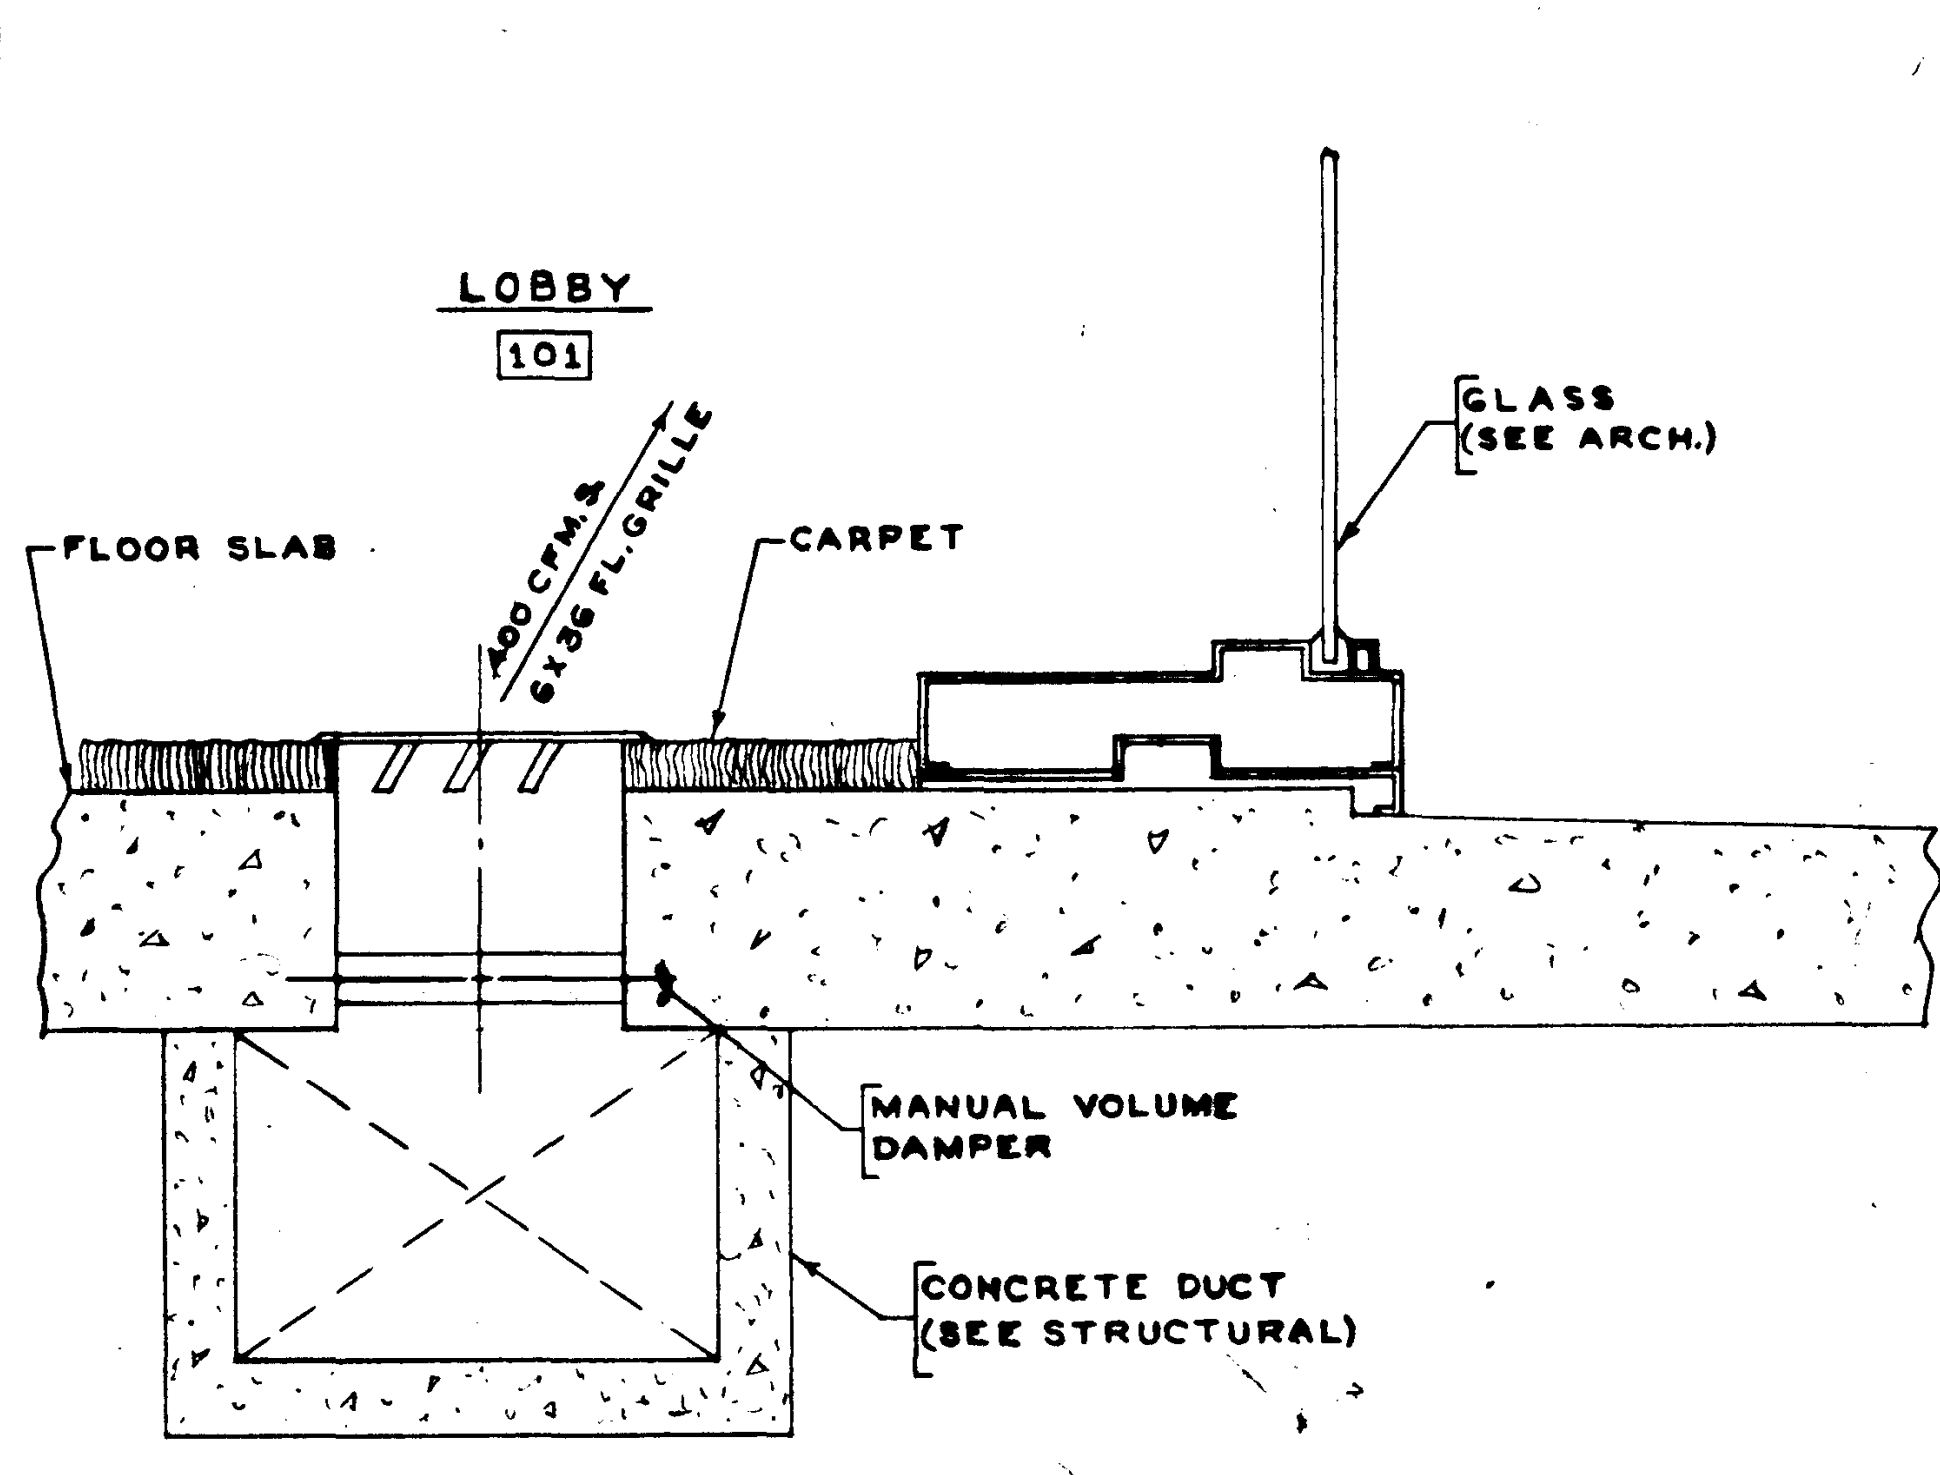
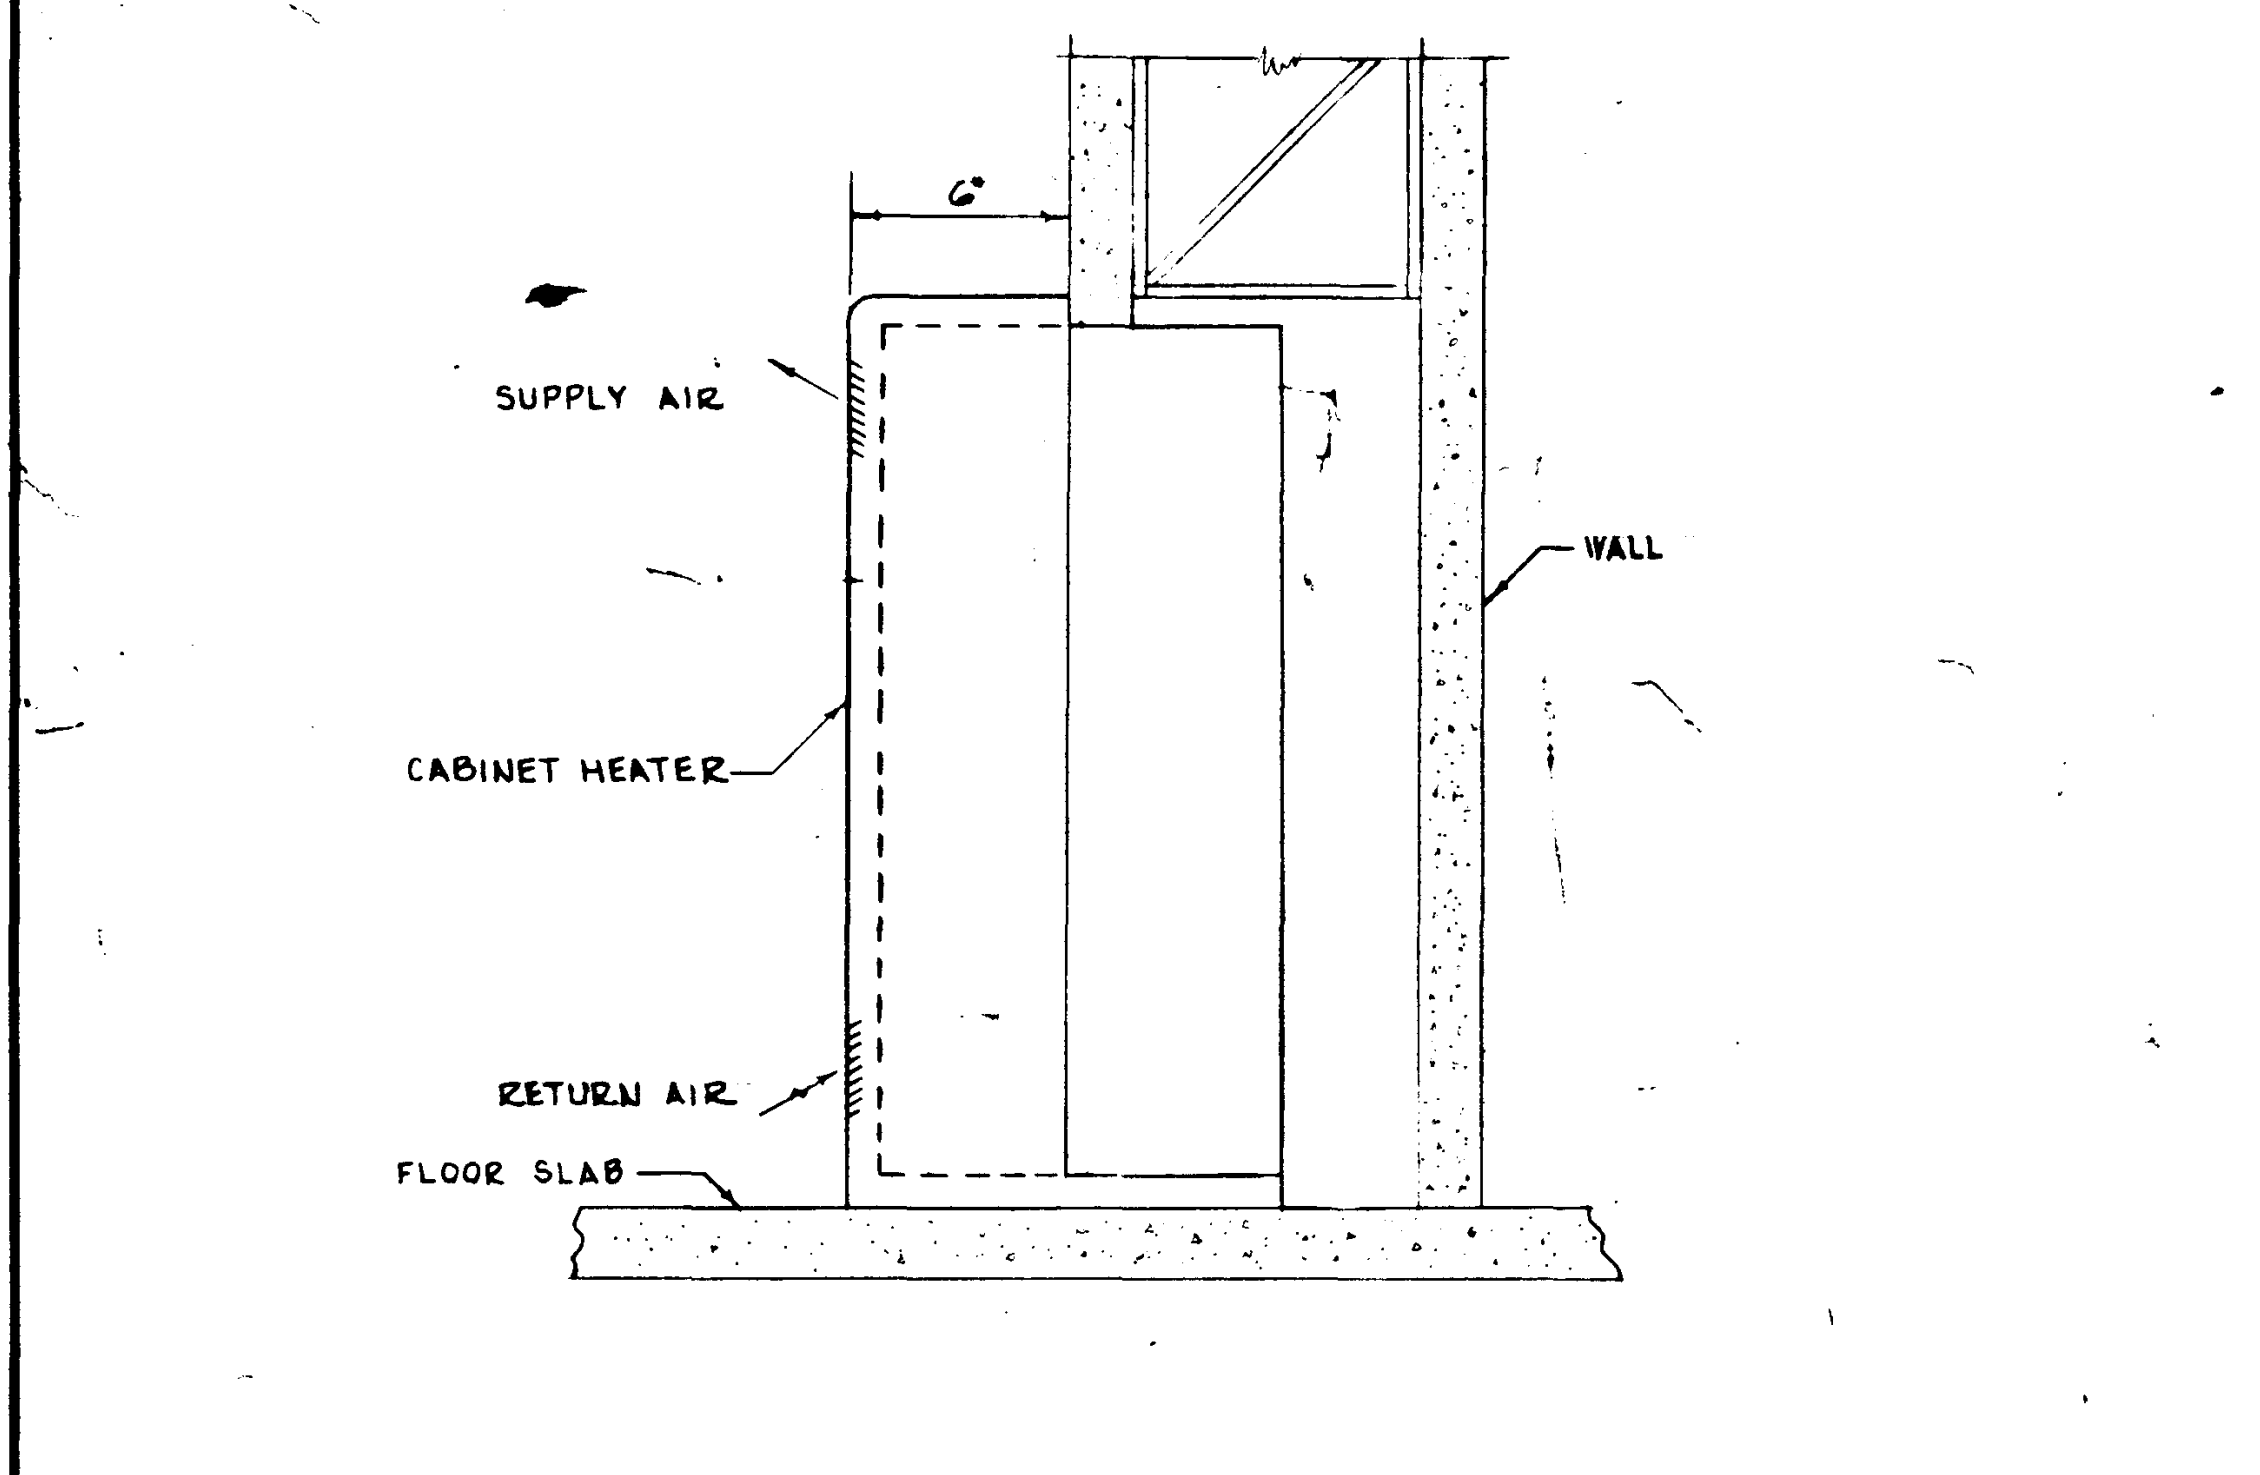


SEMI-RECESSED WALL HEATER SCALE NONE 5 FLOOR GRILLE DETAIL SCALE NONE 6 FAN & COIL PIPING UNIT DETAIL SCALE NONE 7

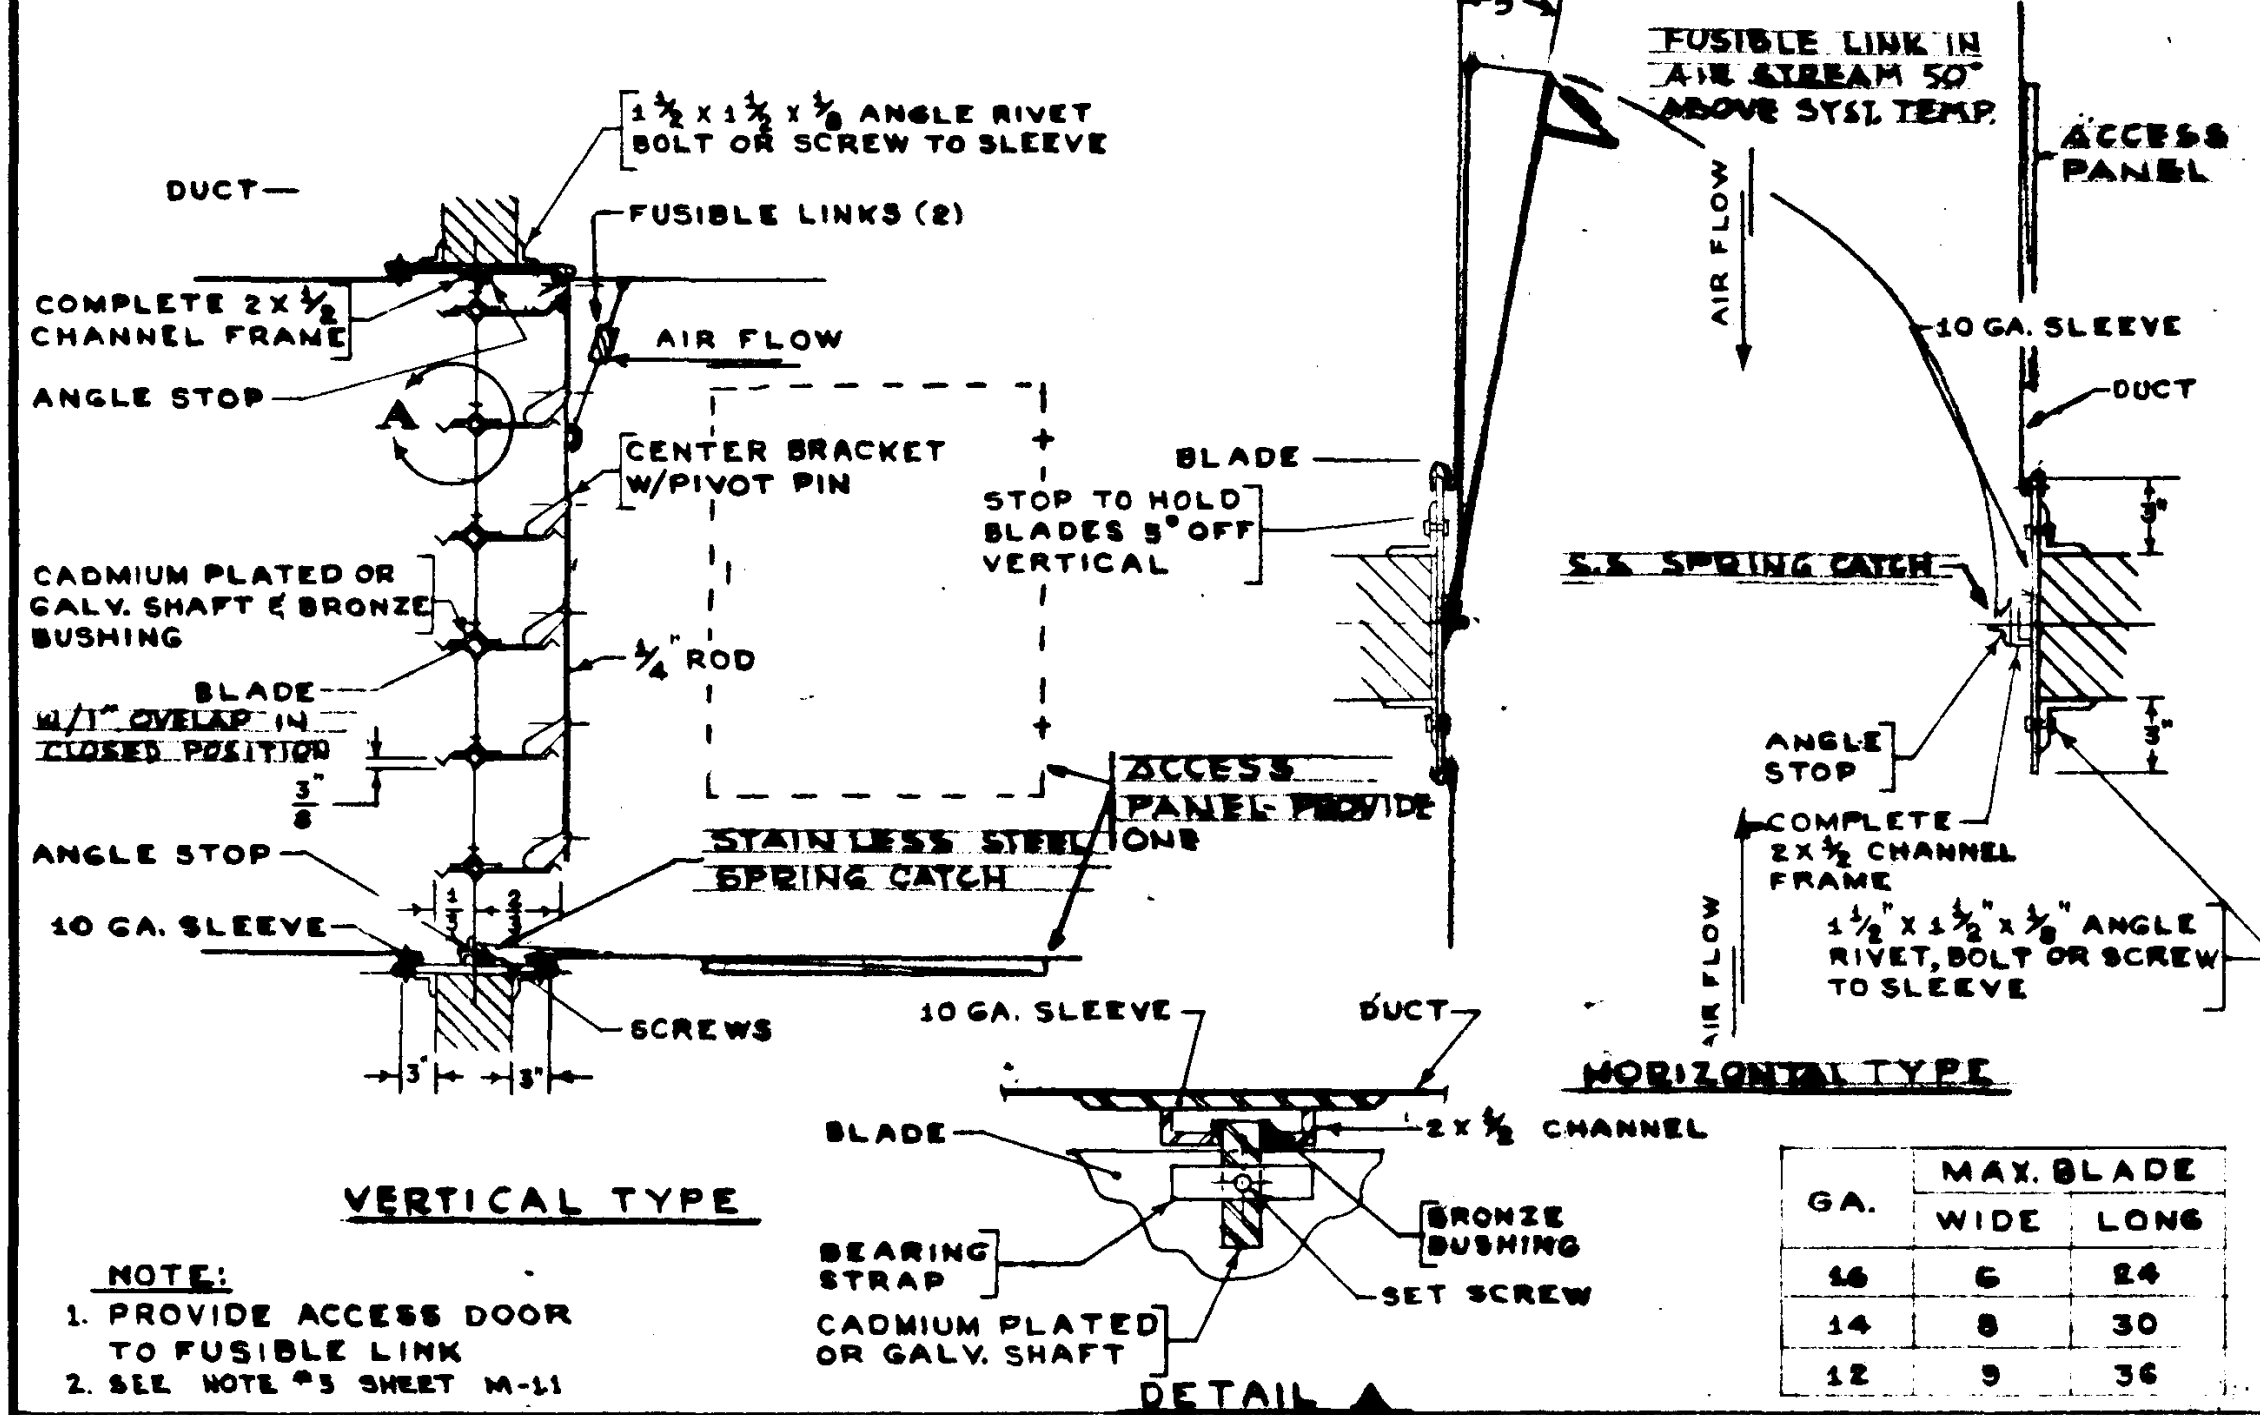

FIRE DAMPER DETAILS SCALE NONE 8

<p>STRUCTURAL ENGINEERS BRANDOW & JOHNSTON J.A. MARTIN & ASSOCIATES</p> <p>MECHANICAL ENGINEERS RALPH E. PHILLIPS, INC.</p> <p>ELECTRICAL ENGINEERS RALPH E. PHILLIPS, INC.</p> <p>CIVIL ENGINEERS O. SHURMAN & ASSOCIATES MOFFATT & NICOL</p>	<p>DESIGNED BY ALICE</p> <p>CHECKED BY W.C.L.</p>	<p>ARCHITECT WILLIAM L. FERREIRA & ASSOCIATES</p> <p>APPROVED JUN 21 1965</p> <p>STATE FIRE MARSHAL STATE OF CALIFORNIA JUN 23 1965</p>	<p>ASSOCIATED ARCHITECTS: WILLIAM L. FERREIRA & ASSOCIATES A. QUINCY JONES-FREDERICK E. EMMONS & ASSOCIATES BLUROCK ELLERBROEK & ASSOCIATES</p> <p>URBANUS SQUARE • MACARTHUR BOULEVARD AT FORD ROAD TELEPHONE 714/675-2640 • CORONA DEL MAR, CALIFORNIA</p>	<p>GOLDEN WEST COLLEGE HUNTINGTON BEACH, CALIFORNIA ORANGE COAST JUNIOR COLLEGE DISTRICT</p>	<p>DD DETAILS</p>	<p>JOB NO. RD-1</p> <p>DATE 6-15-65</p> <p>SHEET NO. M 2.2</p>
--	---	---	--	---	-------------------	--

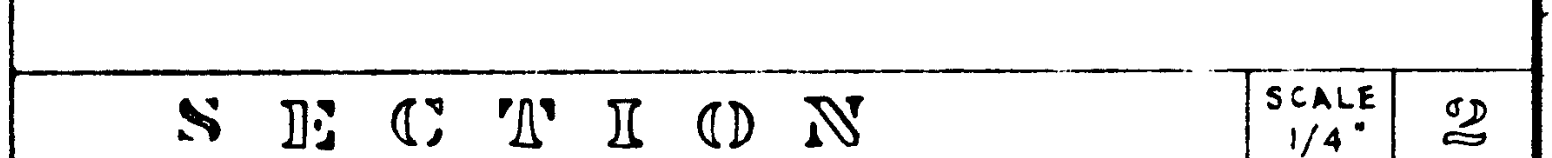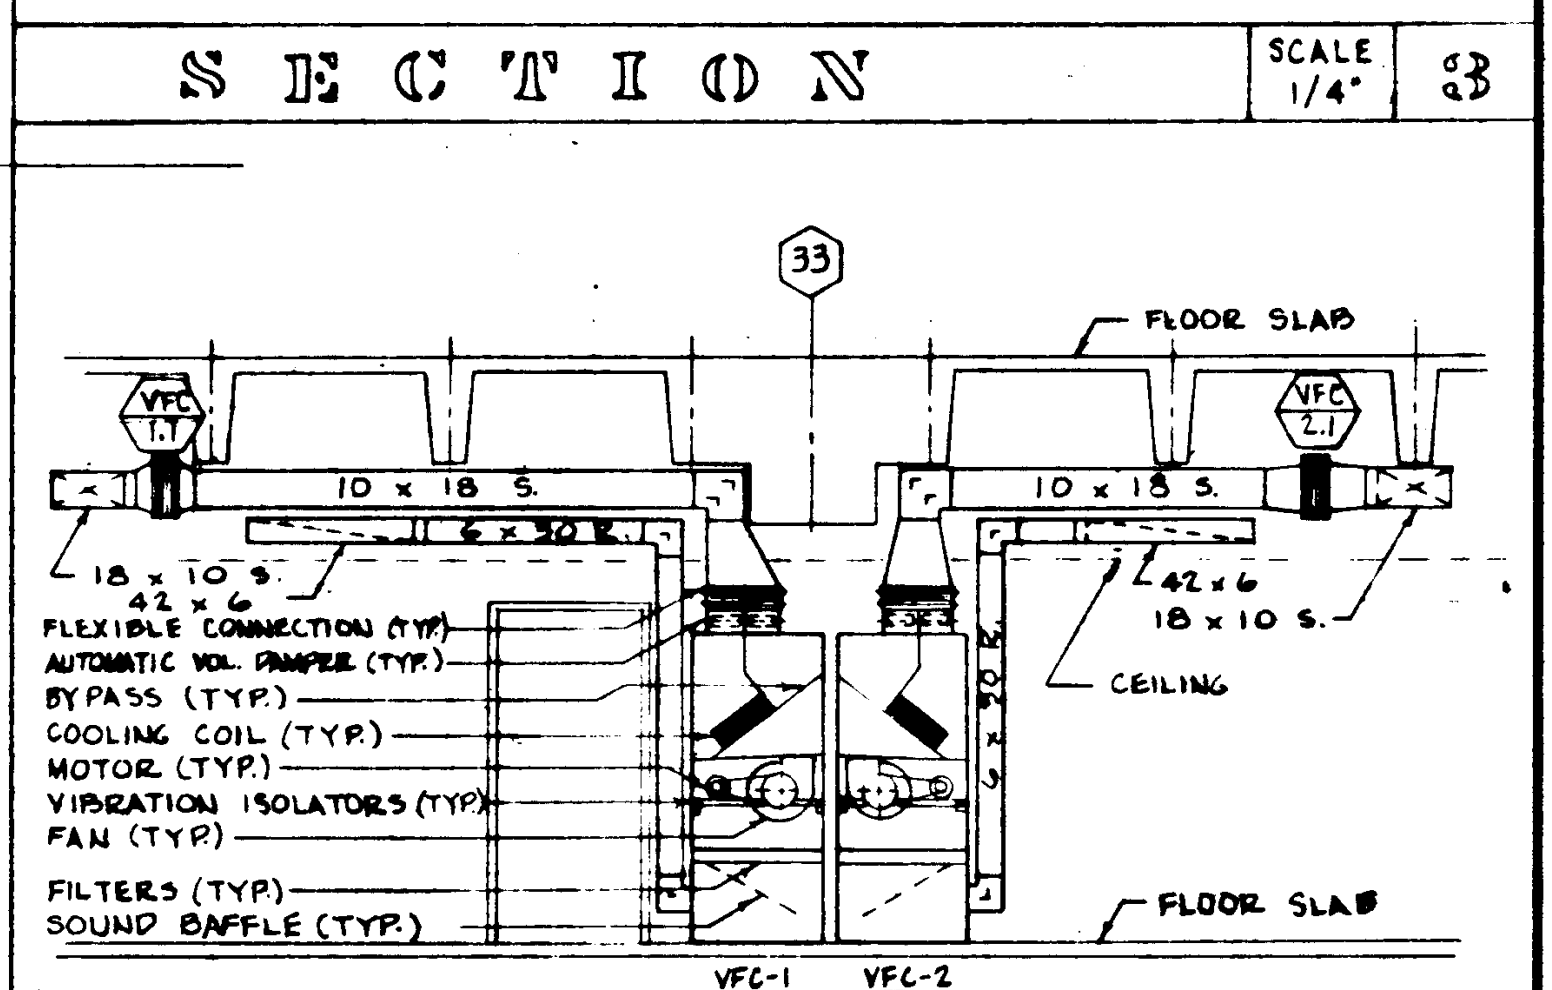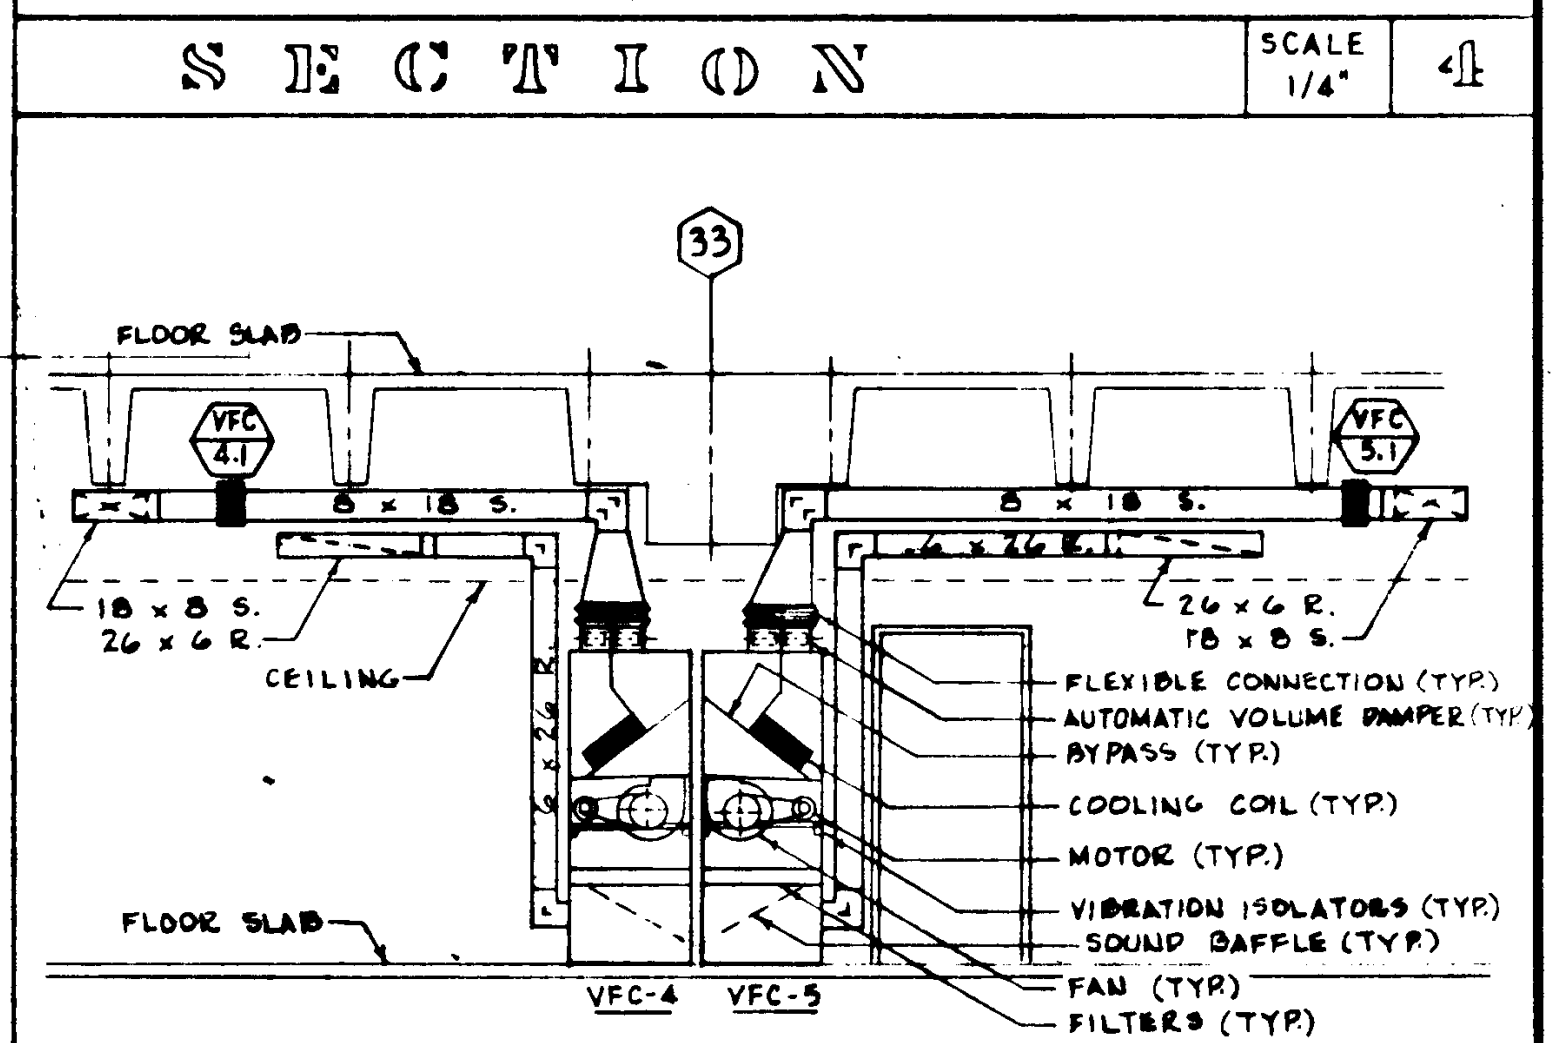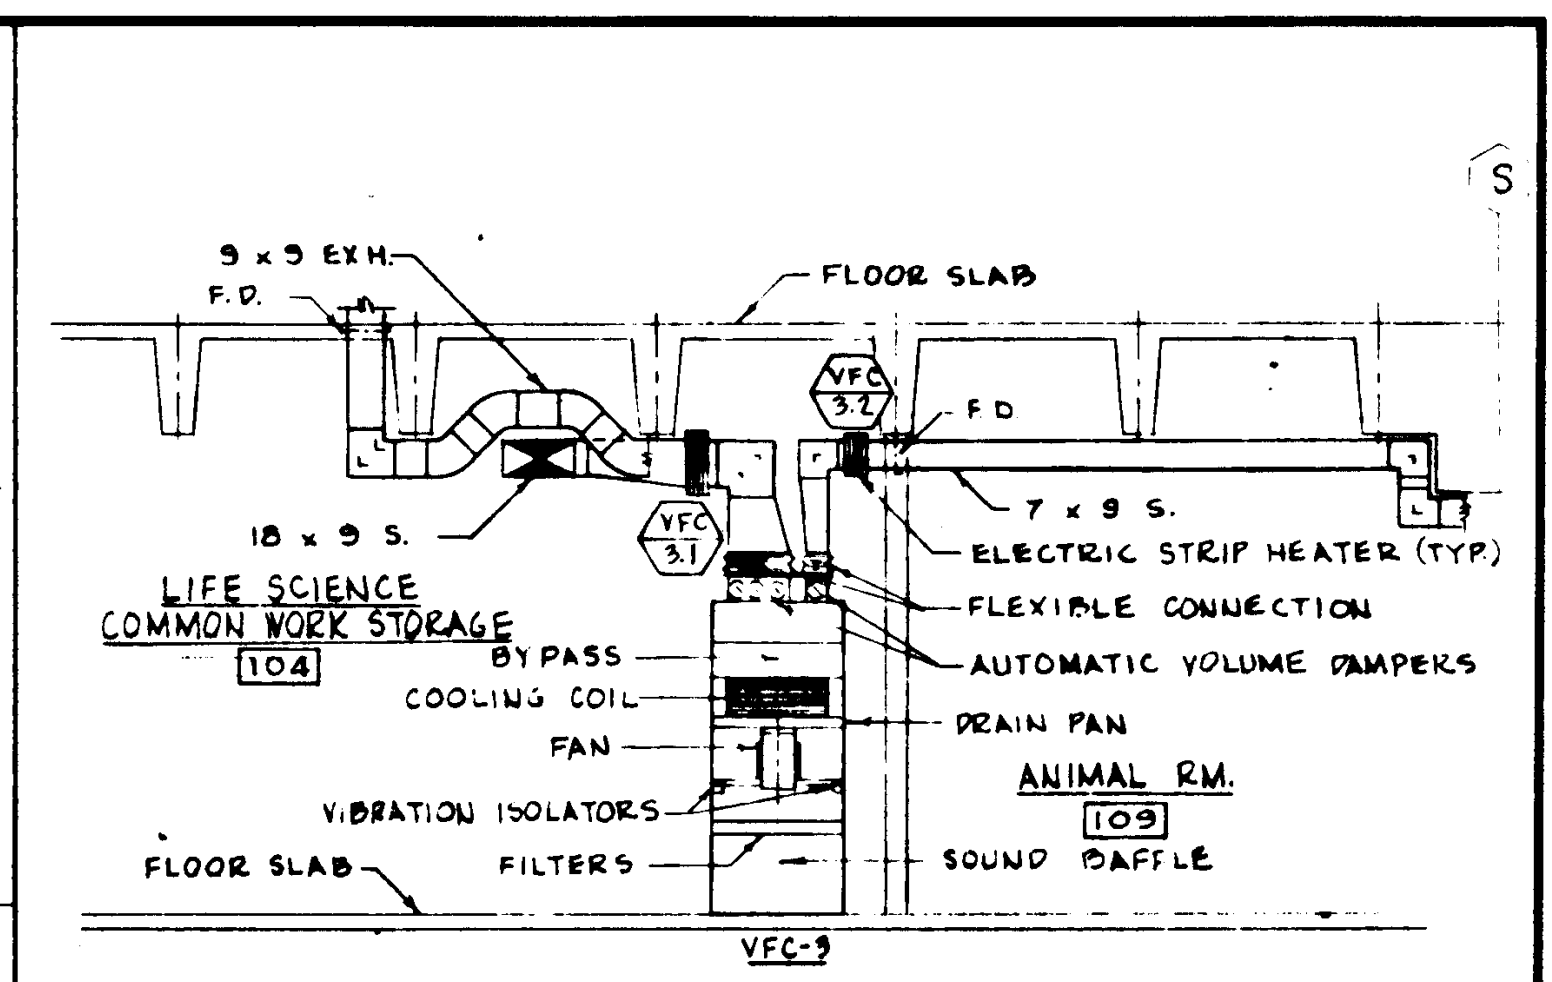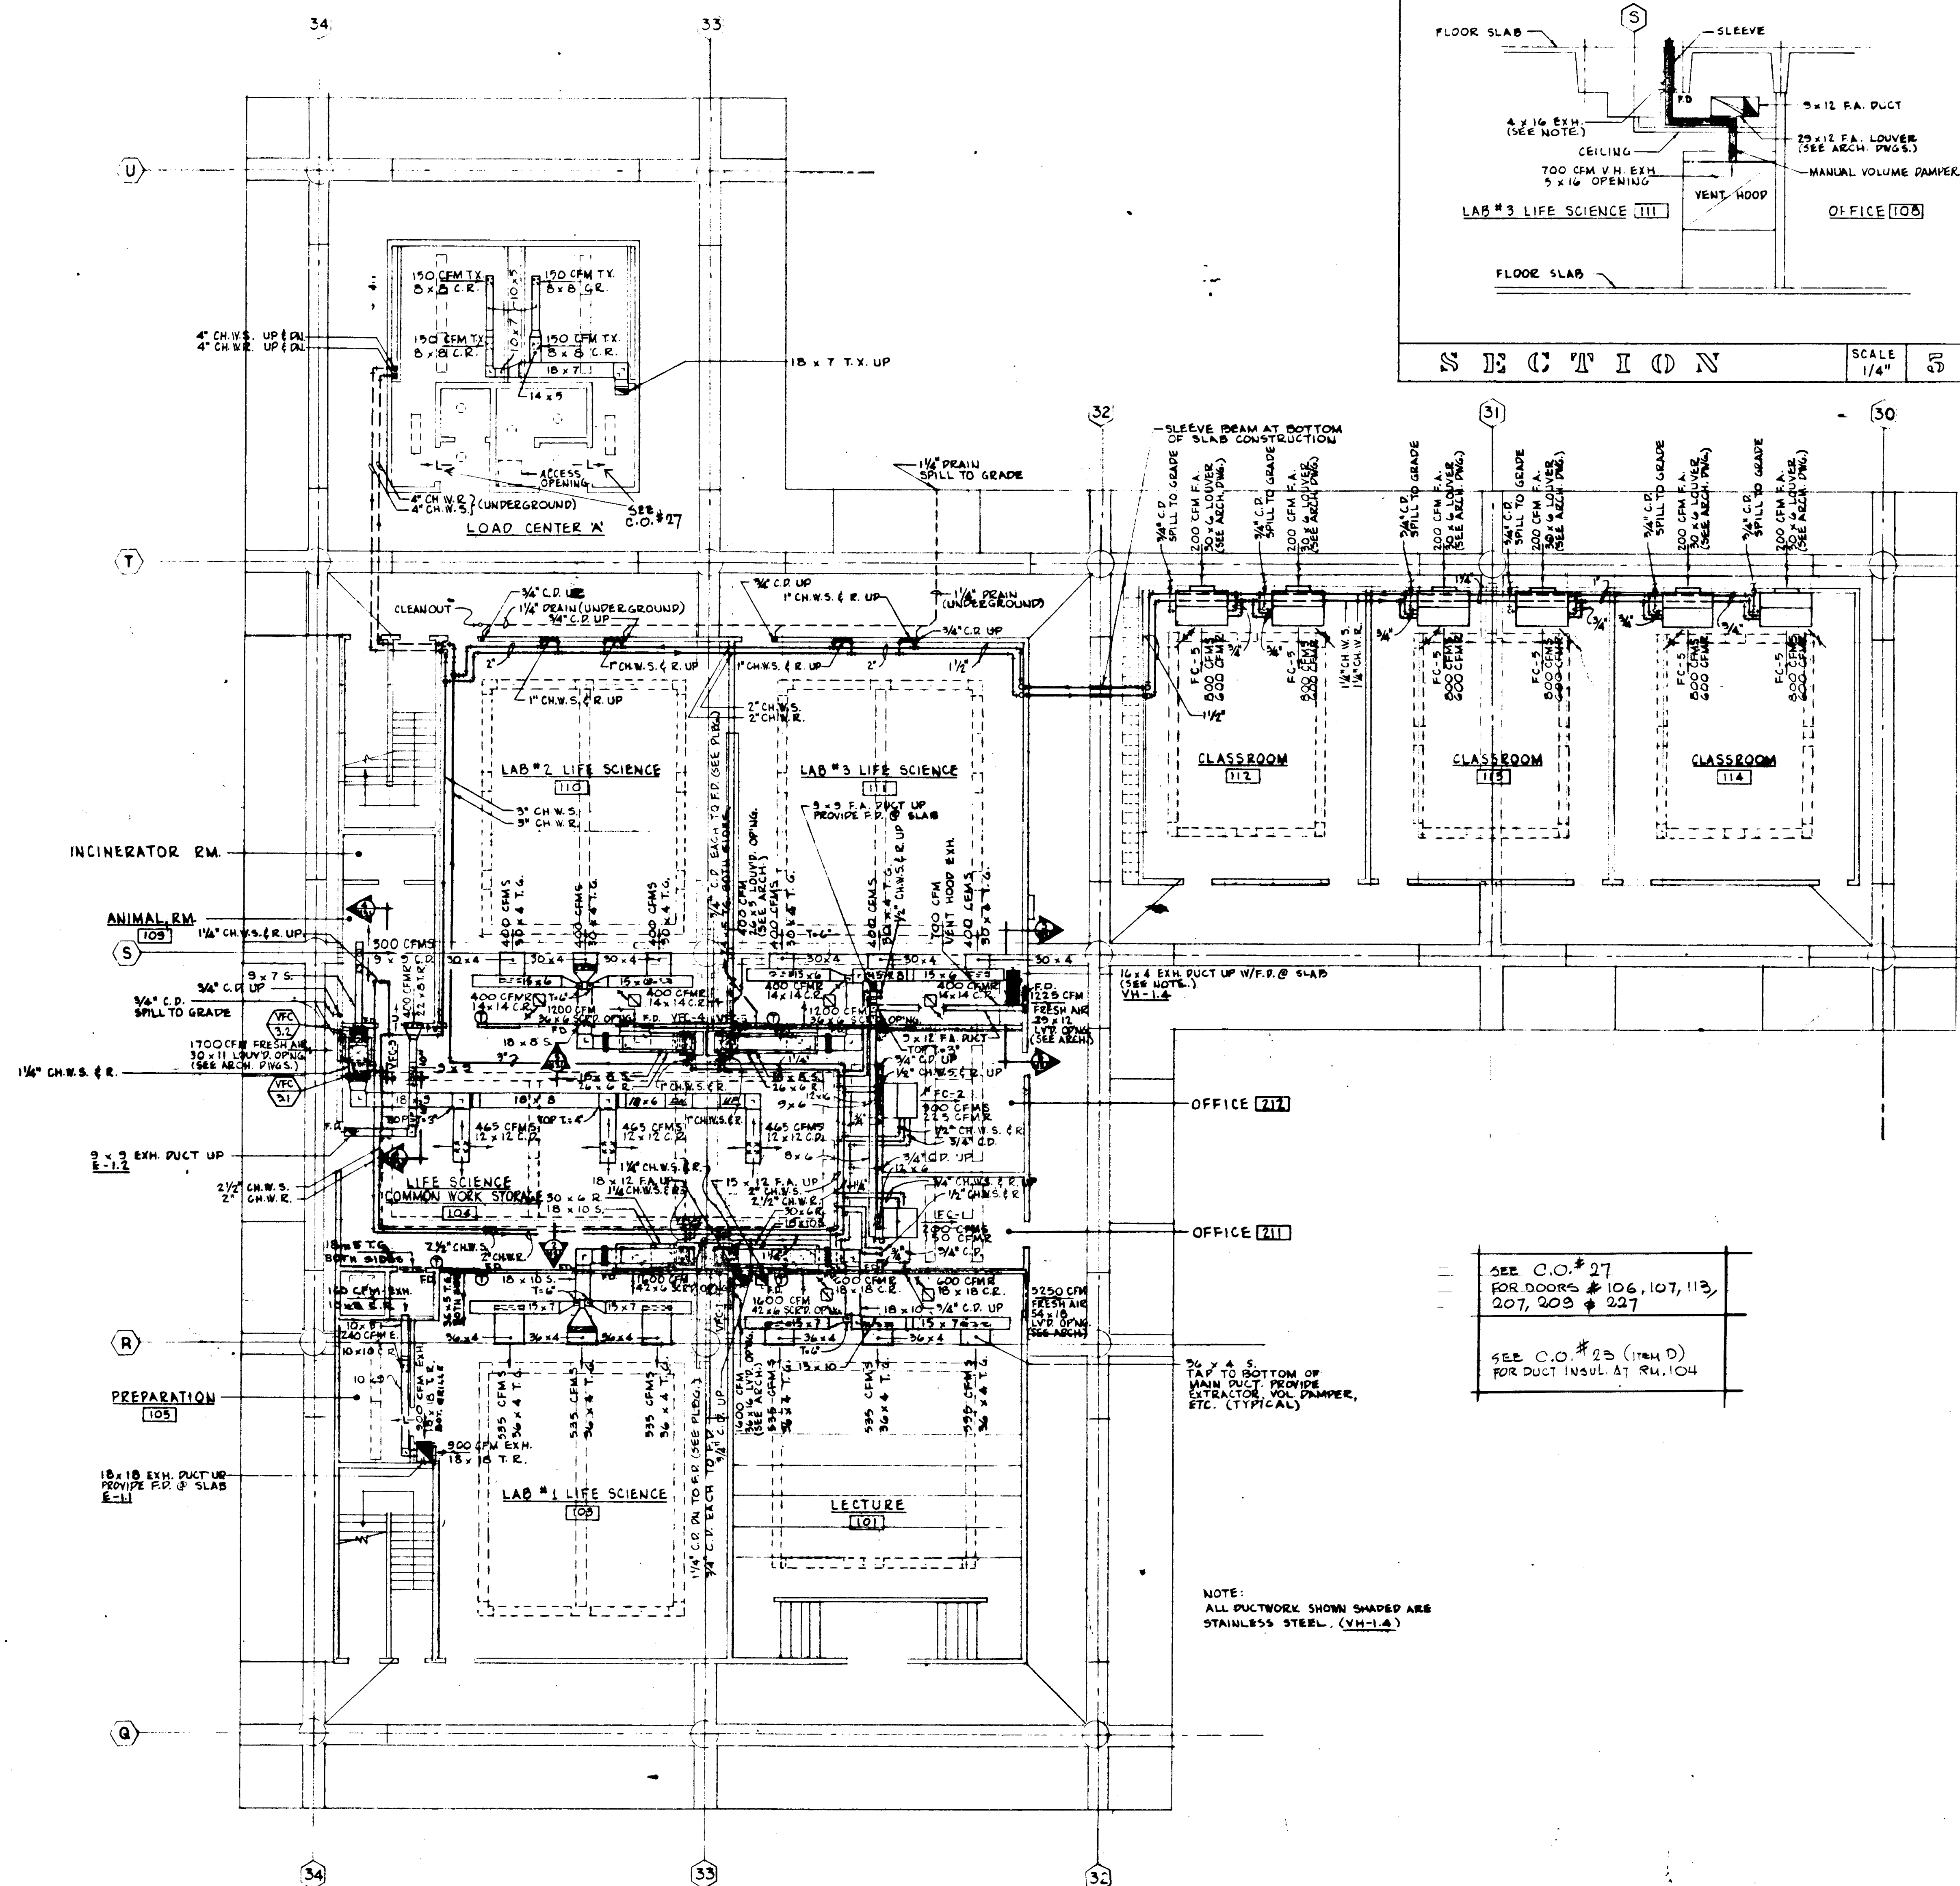

SEE C.O. # 27
FOR DOORS # 106, 107, 113,
207, 209 & 227

SEE C.O. # 23 (ITEM D)
FOR DUCT INSUL. AT RM. 104

NOTE:
ALL DUCTWORK SHOWN SHADED ARE
STAINLESS STEEL. (VH-1.4)

I I R S 'T I L O O R

SCALE 1/2" = 1'

UNIT I

JOB NO.
100-1

F L C C R


SHEET NO.

1^o L A N




MI 3.1

GOLDEN WEST COLLEGE
HUNTINGTON BEACH, CALIFORNIA
ORANGE COAST JUNIOR COLLEGE DISTRICT

			STRUCTURAL ENGINEERS BRANDOW & JOHNSTON J.A. MARTIN & ASSOCIATES	DESIGNED L.H.W.	ARCHITECT <i>William L. Pereira</i>	APPROVED STATE OF CALIFORNIA DATE JUN 21 1965	ASSOCIATED ARCHITECTS: WILLIAM L. PEREIRA & ASSOCIATES A. QUINCY JONES-FREDERICK E. EMMONS & ASSOCIATES BLURNOCK ELLERBROEK & ASSOCIATES
			MECHANICAL ENGINEERS RALPHE E. PHILLIPS, INC.	DRAWN BY A.B.B.	ENGINEER <i>Ralph E. Phillips</i>	APPROVED STATE FIRE MARSHAL STATE OF CALIFORNIA DATE JUN 21 1965	
			ELECTRICAL ENGINEERS RALPHE E. PHILLIPS, INC.	CHECKED BY W.C.L.	COLLEGE		
			CIVIL ENGINEERS O. SHUEMAN & ASSOCIATES MOFFATT & NICOL				URBANUS SQUARE - MACARTHUR BOULEVARD AT FORD ROAD TELEPHONE 714-675-2640 CORONA DEL MAR, CALIFORNIA
			REVISIONS				

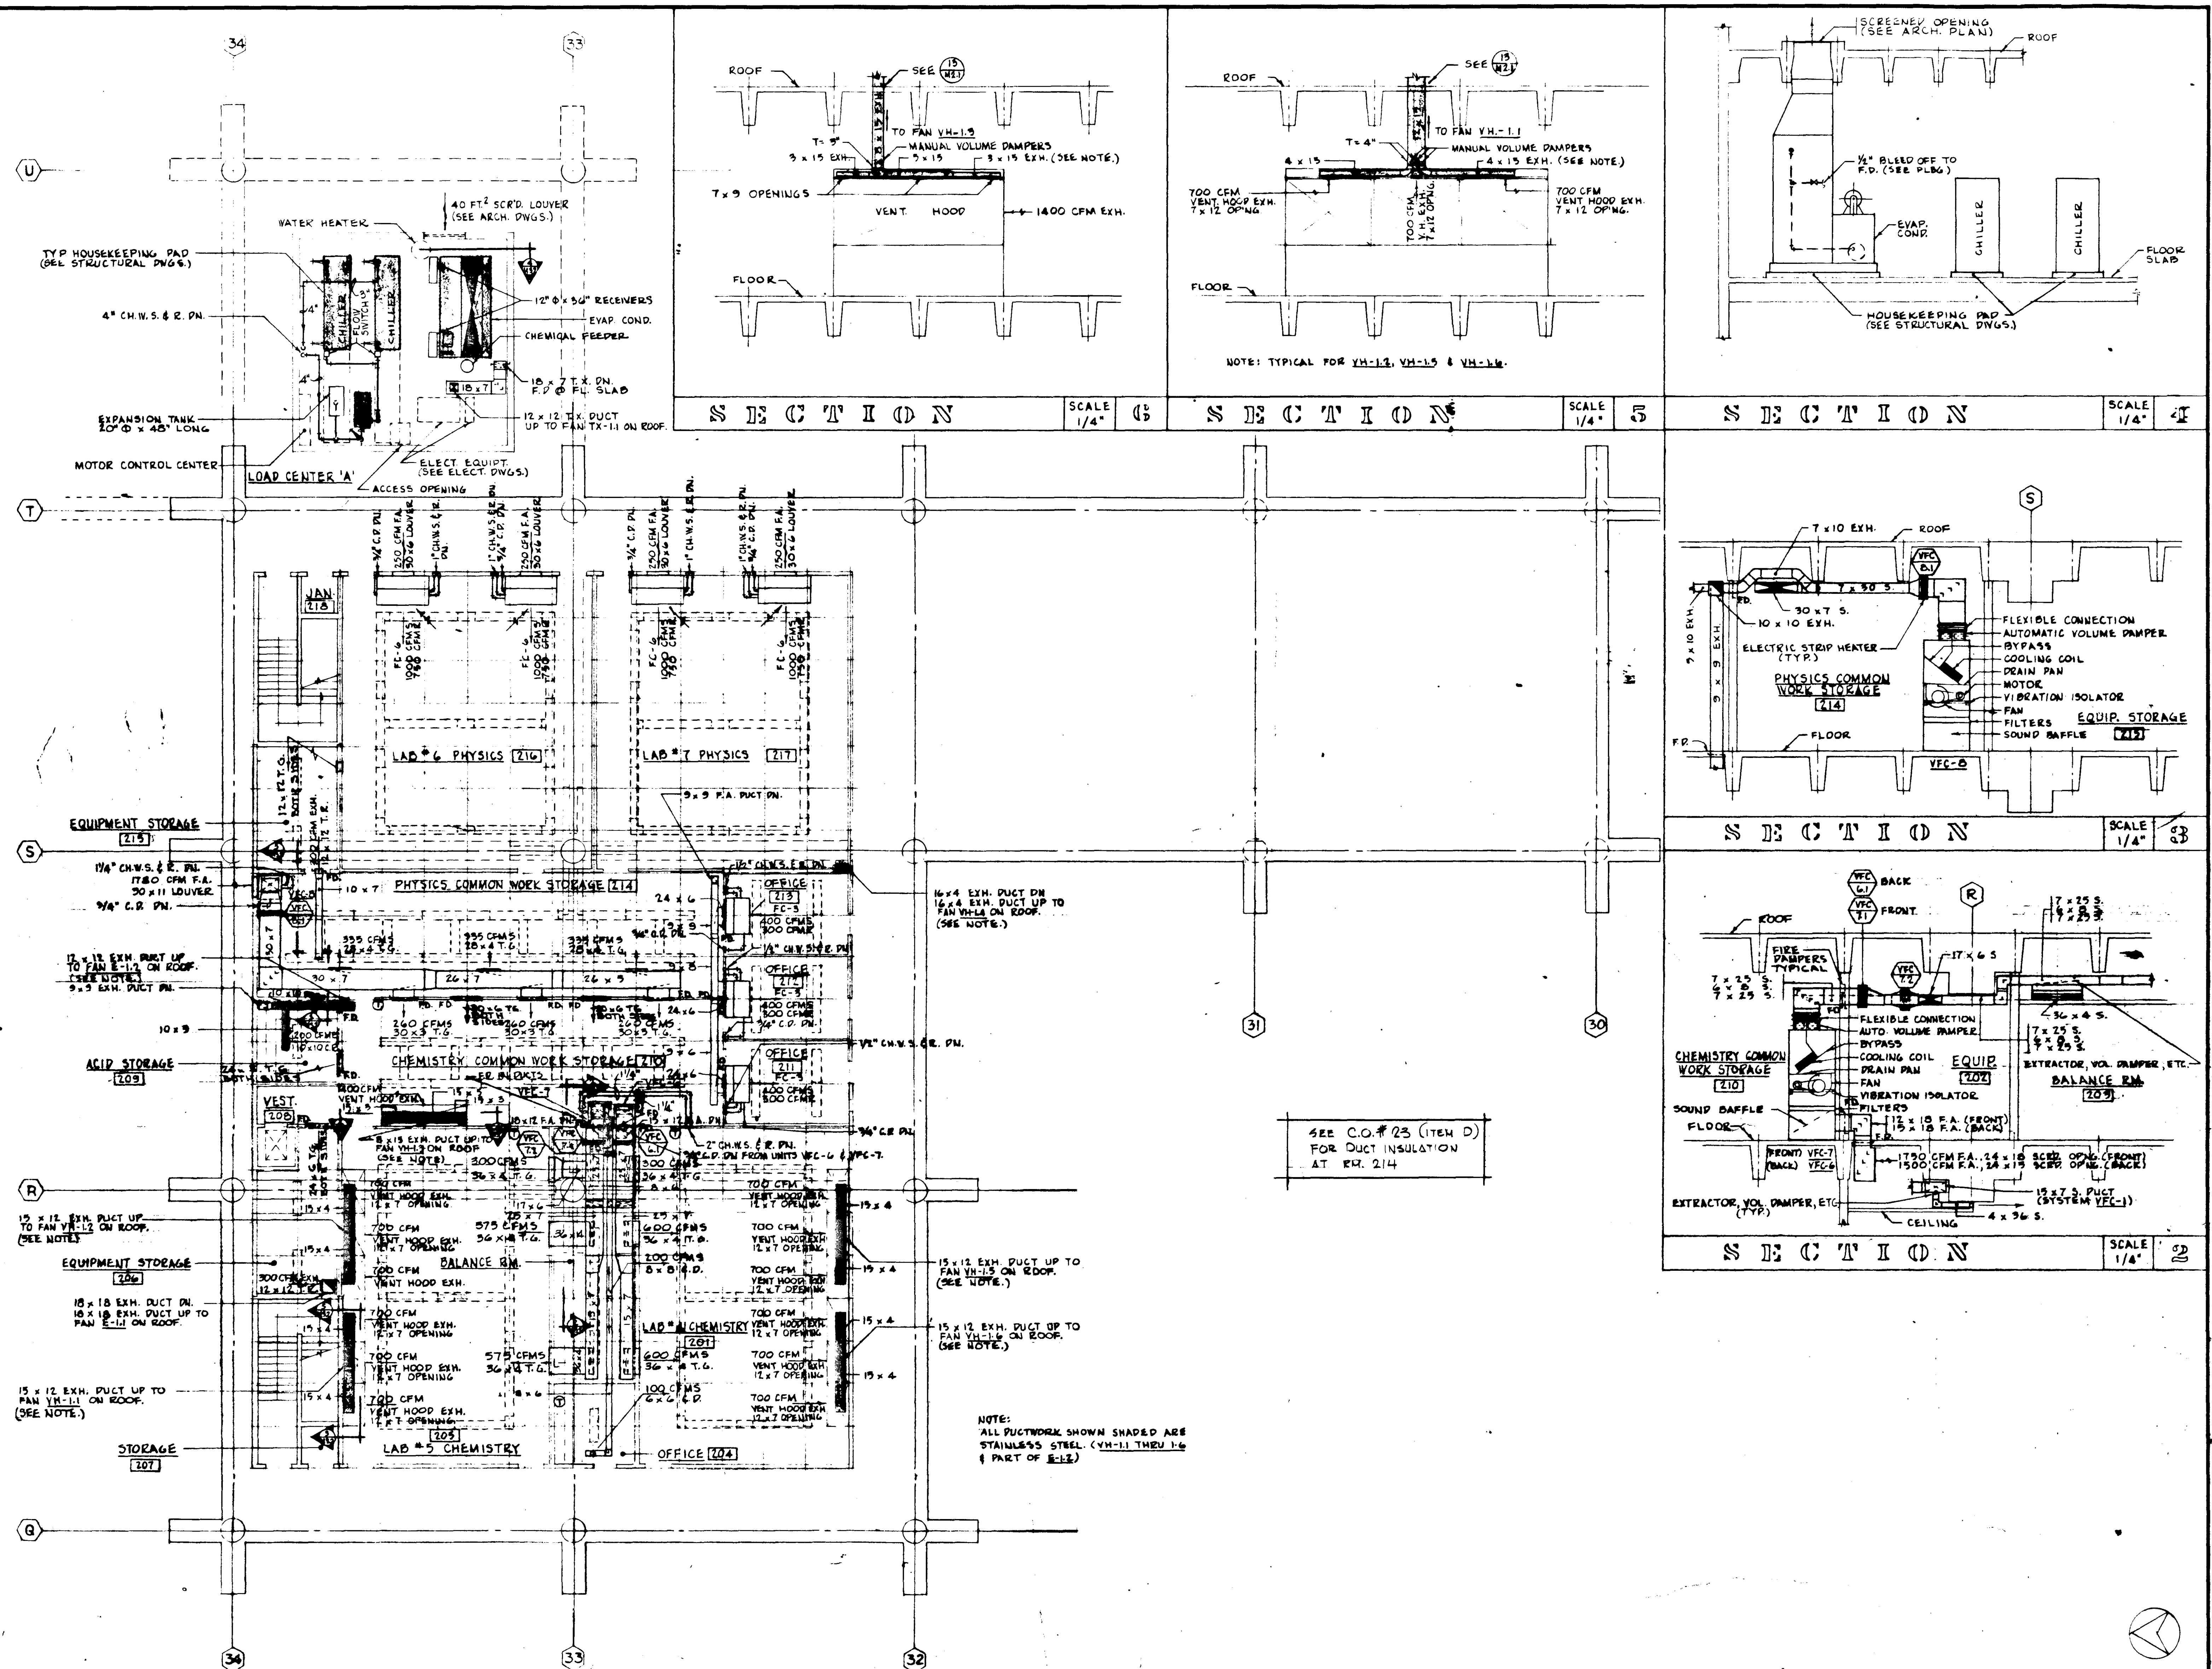

										S E C O N D F L O O R										SCALE	1/4"	1
REVISIONS		DATE		STRUCTURAL ENGINEERS BRANDOW & JOHNSTON J.A. MARTIN & ASSOCIATES		DESIGNED L. H. W.		ARCHITECT William L. Pereira		APPROVED \$5874 APPROVED JUN 21 1965		ASSOCIATED ARCHITECTS: WILLIAM L. PEREIRA & ASSOCIATES A. GUINOT JONES-FREDERICK E. HEMMONS & ASSOCIATES BLUROCK ELLERBROOK & ASSOCIATES		GOLDEN WEST COLLEGE HUNTINGTON BEACH, CALIFORNIA ORANGE COAST JUNIOR COLLEGE DISTRICT		UNIT 1 FLOOR PLAN		JOB NO. 1004 DATE 6-16-65 SHEET NO. M32				
				MECHANICAL ENGINEERS RALPH E. PHILLIPS, INC.		DRAWN BY A. E. O.		STATE FIRE MARSHAL STATE OF CALIFORNIA DATE JUL 2 1965														
				ELECTRICAL ENGINEERS RALPH E. PHILLIPS, INC.		CHECKED BY W. C. L.		COLLEGE														
				CIVIL ENGINEERS O. SHURMAN & ASSOCIATES MOFFATT & NISBET																		

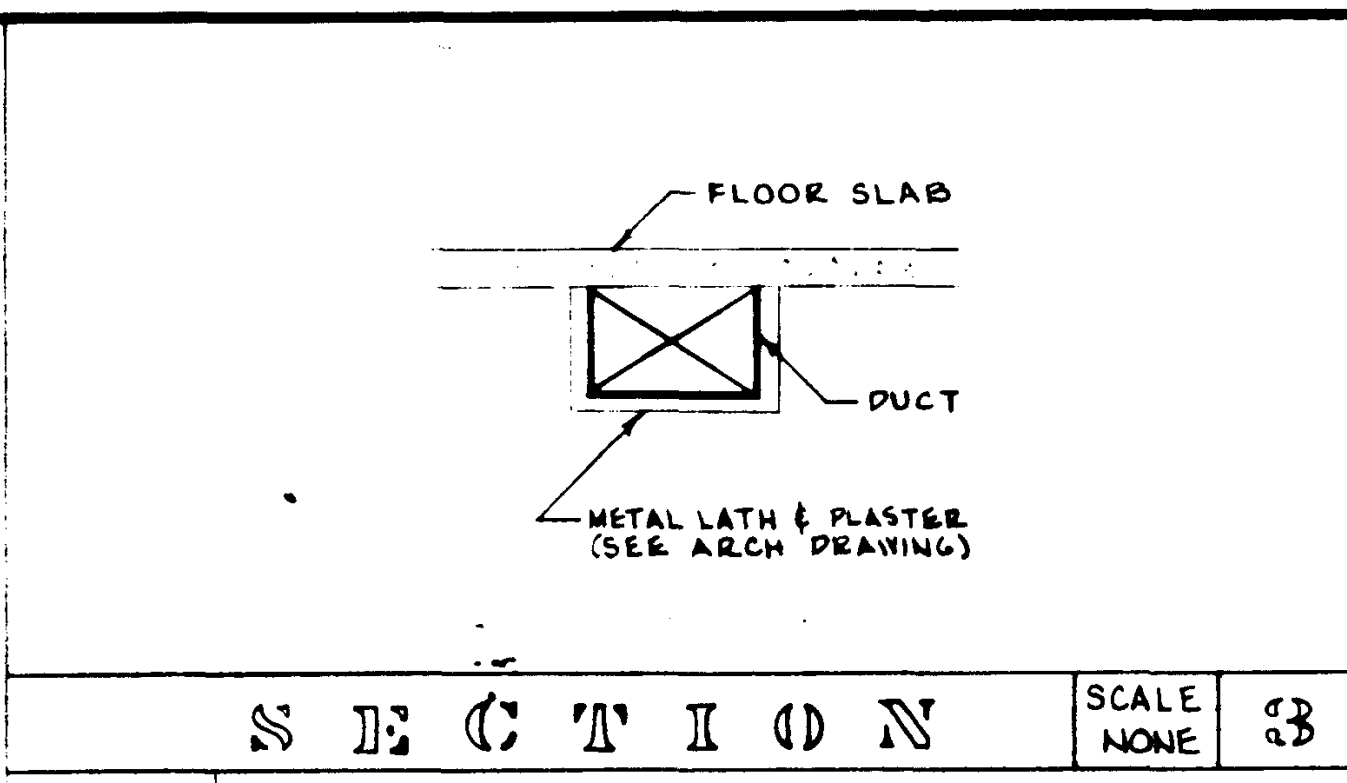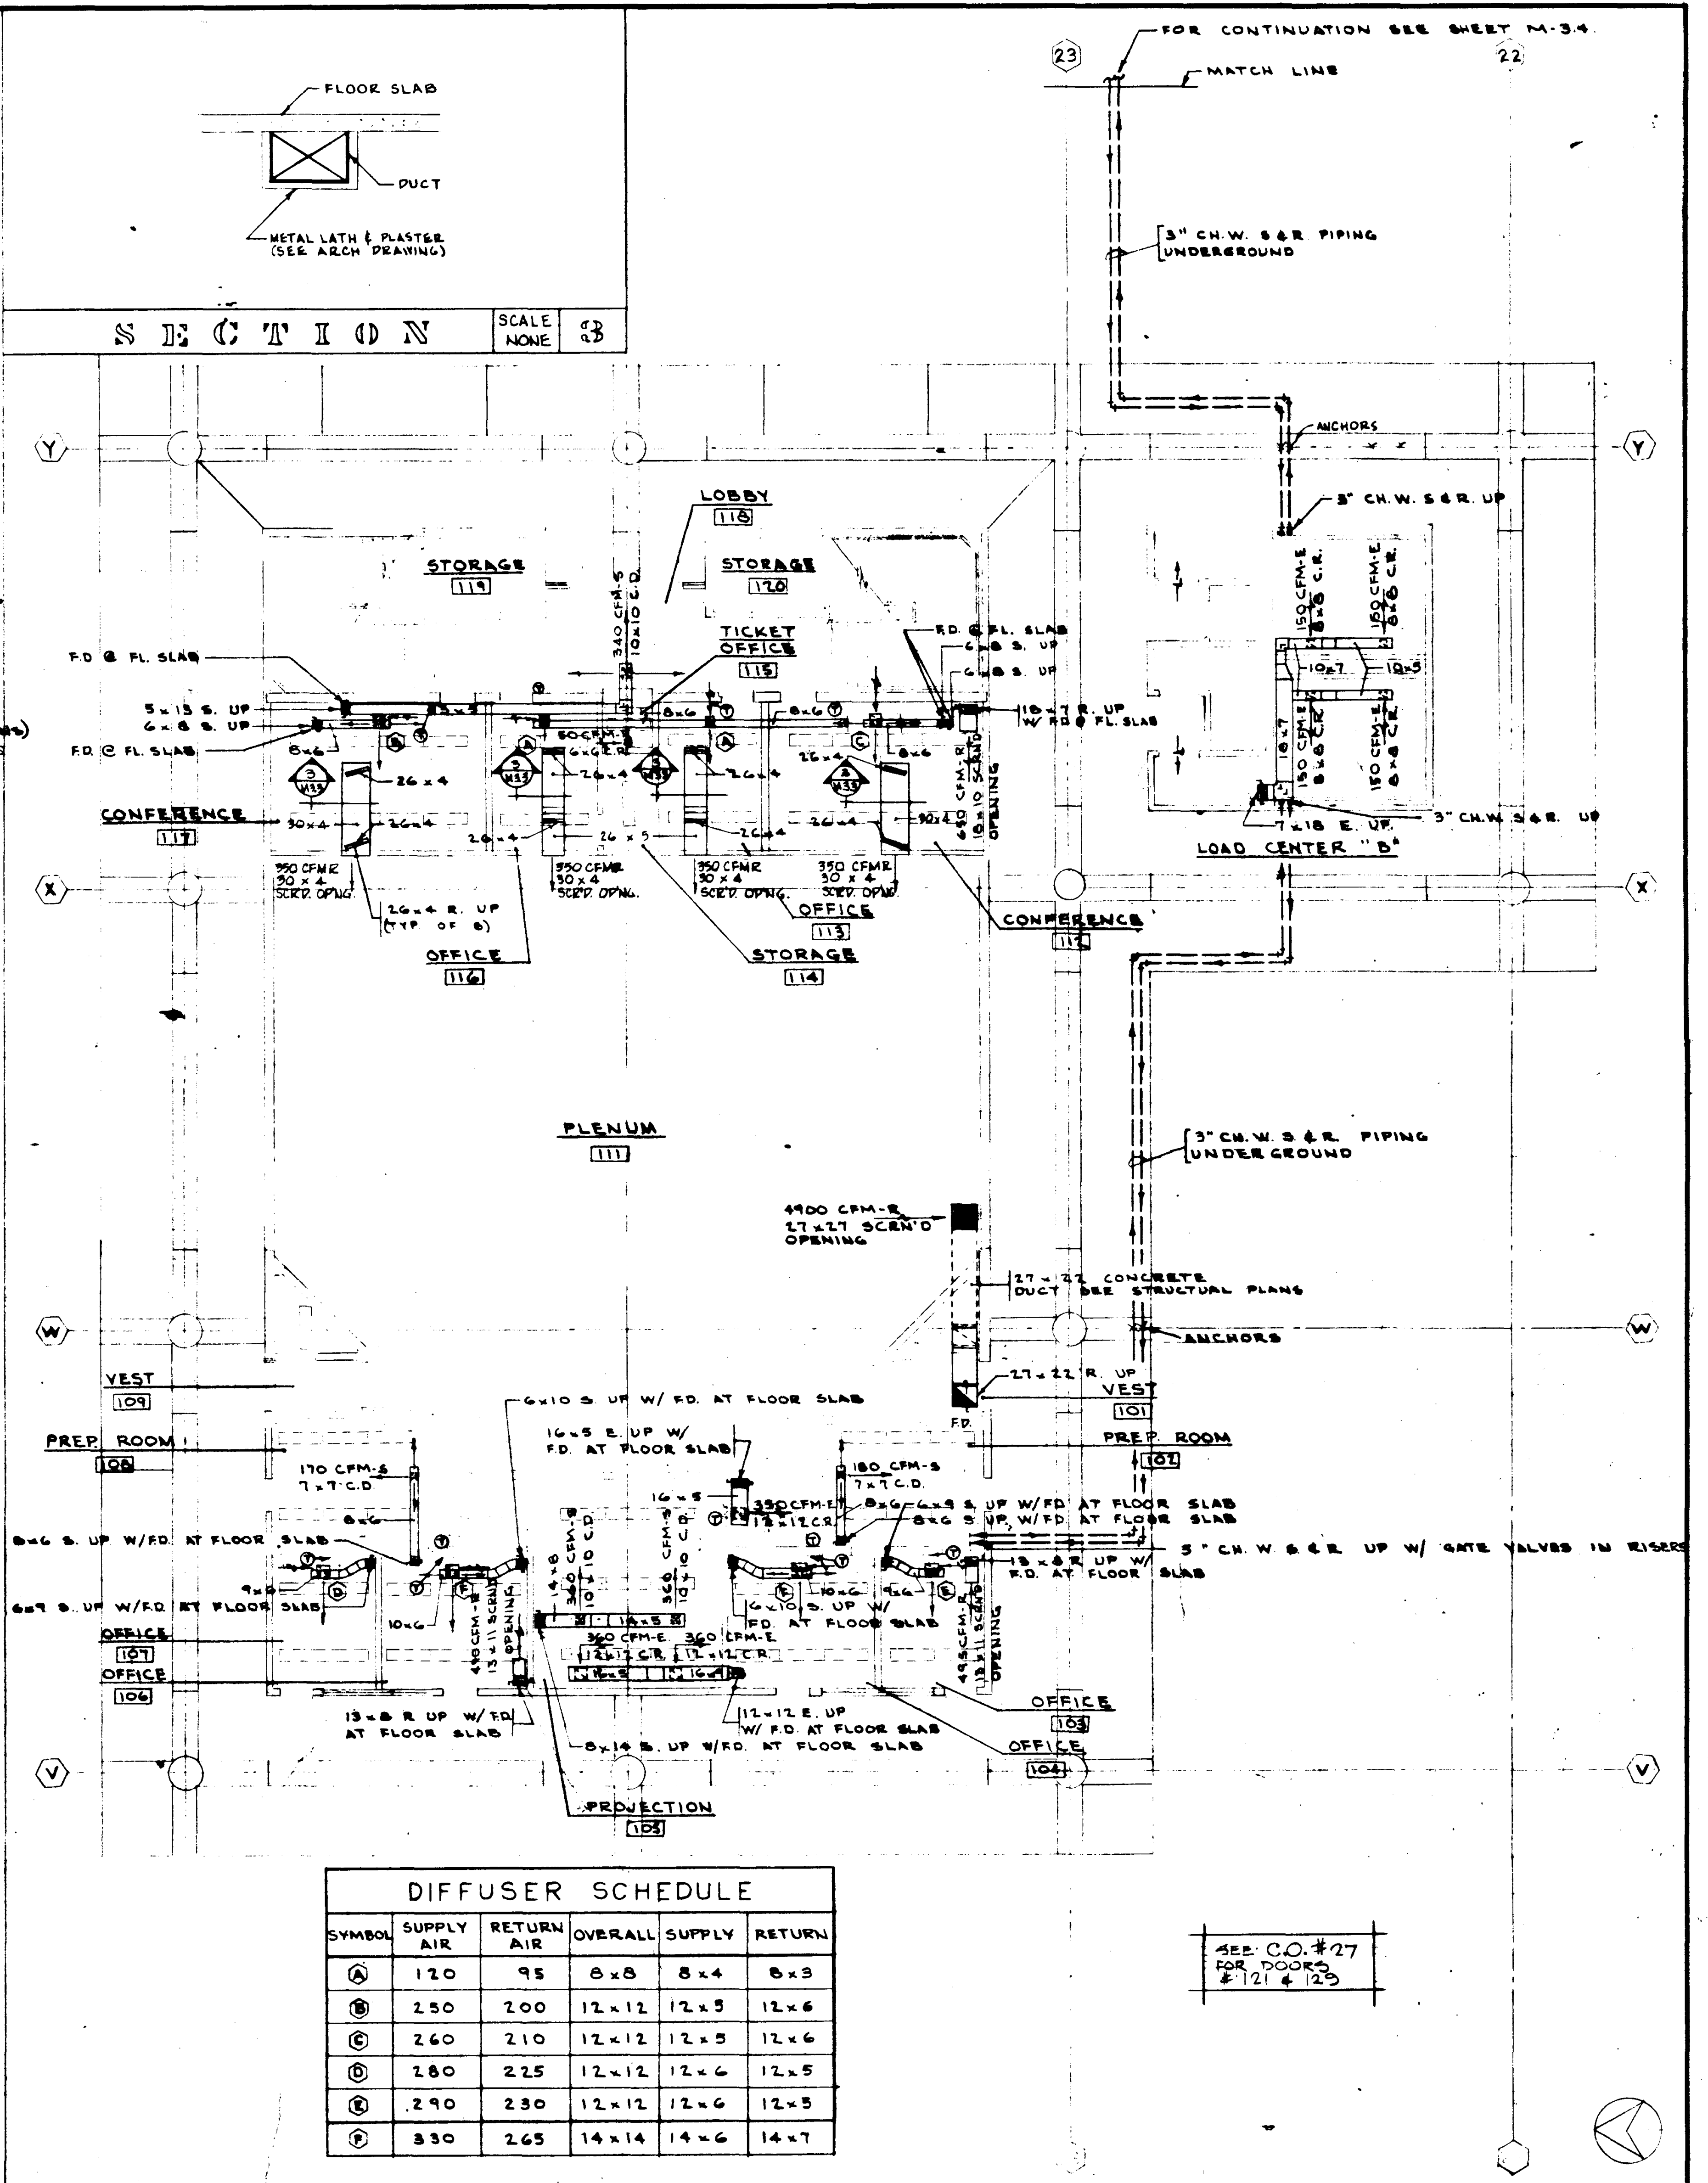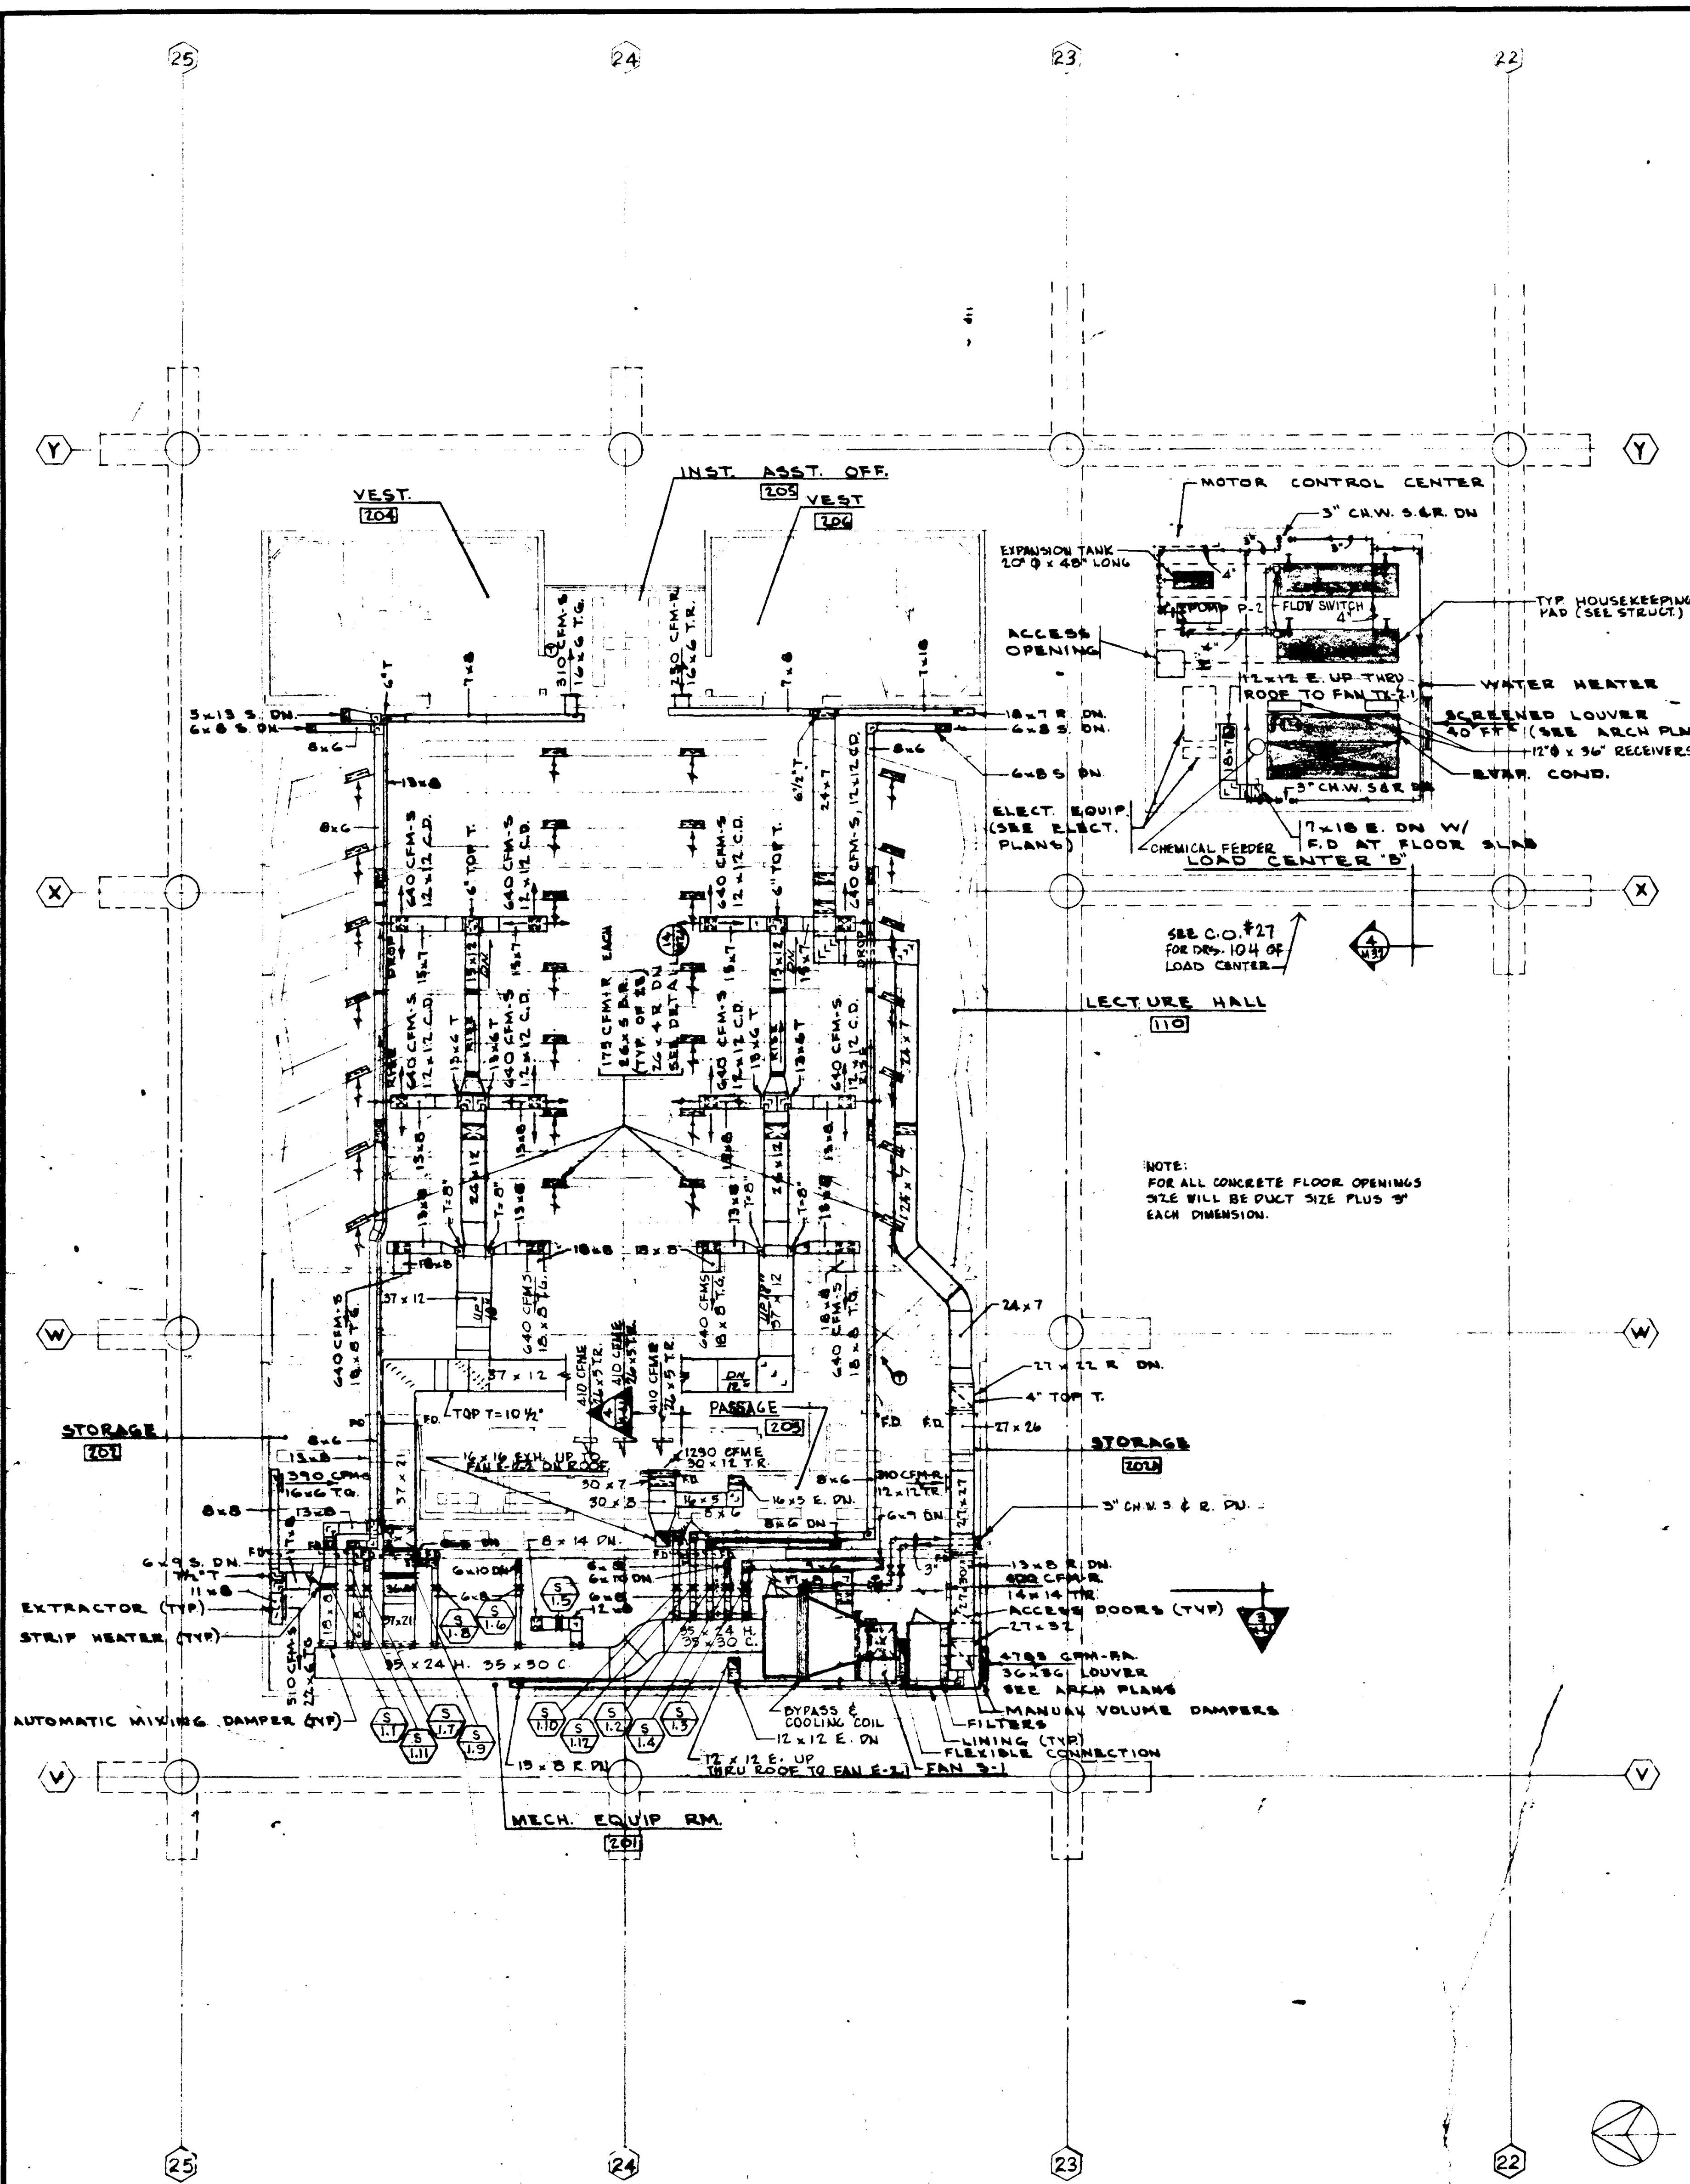

DIFFUSER SCHEDULE					
SYMBOL	SUPPLY AIR	RETURN AIR	OVERALL	SUPPLY	RETURN
A	120	95	8x8	8x4	8x3
B	230	200	12x12	12x5	12x6
C	260	210	12x12	12x5	12x6
D	280	225	12x12	12x6	12x5
E	290	230	12x12	12x6	12x5
F	330	265	14x14	14x6	14x7

SECOND FLOOR

SCALE 1/8" = 1'-0"

FIRST FLOOR

SCALE 1/8" = 1'-0"

UNIT 2

FLOOR PLANS

ORANGE COAST JUNIOR COLLEGE DISTRICT

STRUCTURAL ENGINEERS
BRANDOW & JOHNSON
14 MARTIN & ASSOCIATES

Mechanical Engineers
RALPH E. PHILLIPS, INC.

Electrical Engineers
RALPH E. PHILLIPS, INC.

Civil Engineers
G. SHURMAN & ASSOCIATES
MOFFATT & MICROL

DESIGNED
L.H.W.



DRAWN BY
R.W.

CHECKED BY
V.C.L.

APPROVED
STATE FIRE MARSHAL
STATE OF CALIFORNIA
JUN 21 1965

ASSOCIATED ARCHITECTS:
WILLIAM L. PEREIRA & ASSOCIATES
A. QUINCY JONES-FREDERICK & EMMONS & ASSOCIATES
BLUROCK ELLERBROCK & ASSOCIATES

URBANUS SQUARE MACARTHUR BOULEVARD AT FORD ROAD
TELEPHONE 714/875-2540 CORONA DEL MAR, CALIFORNIA

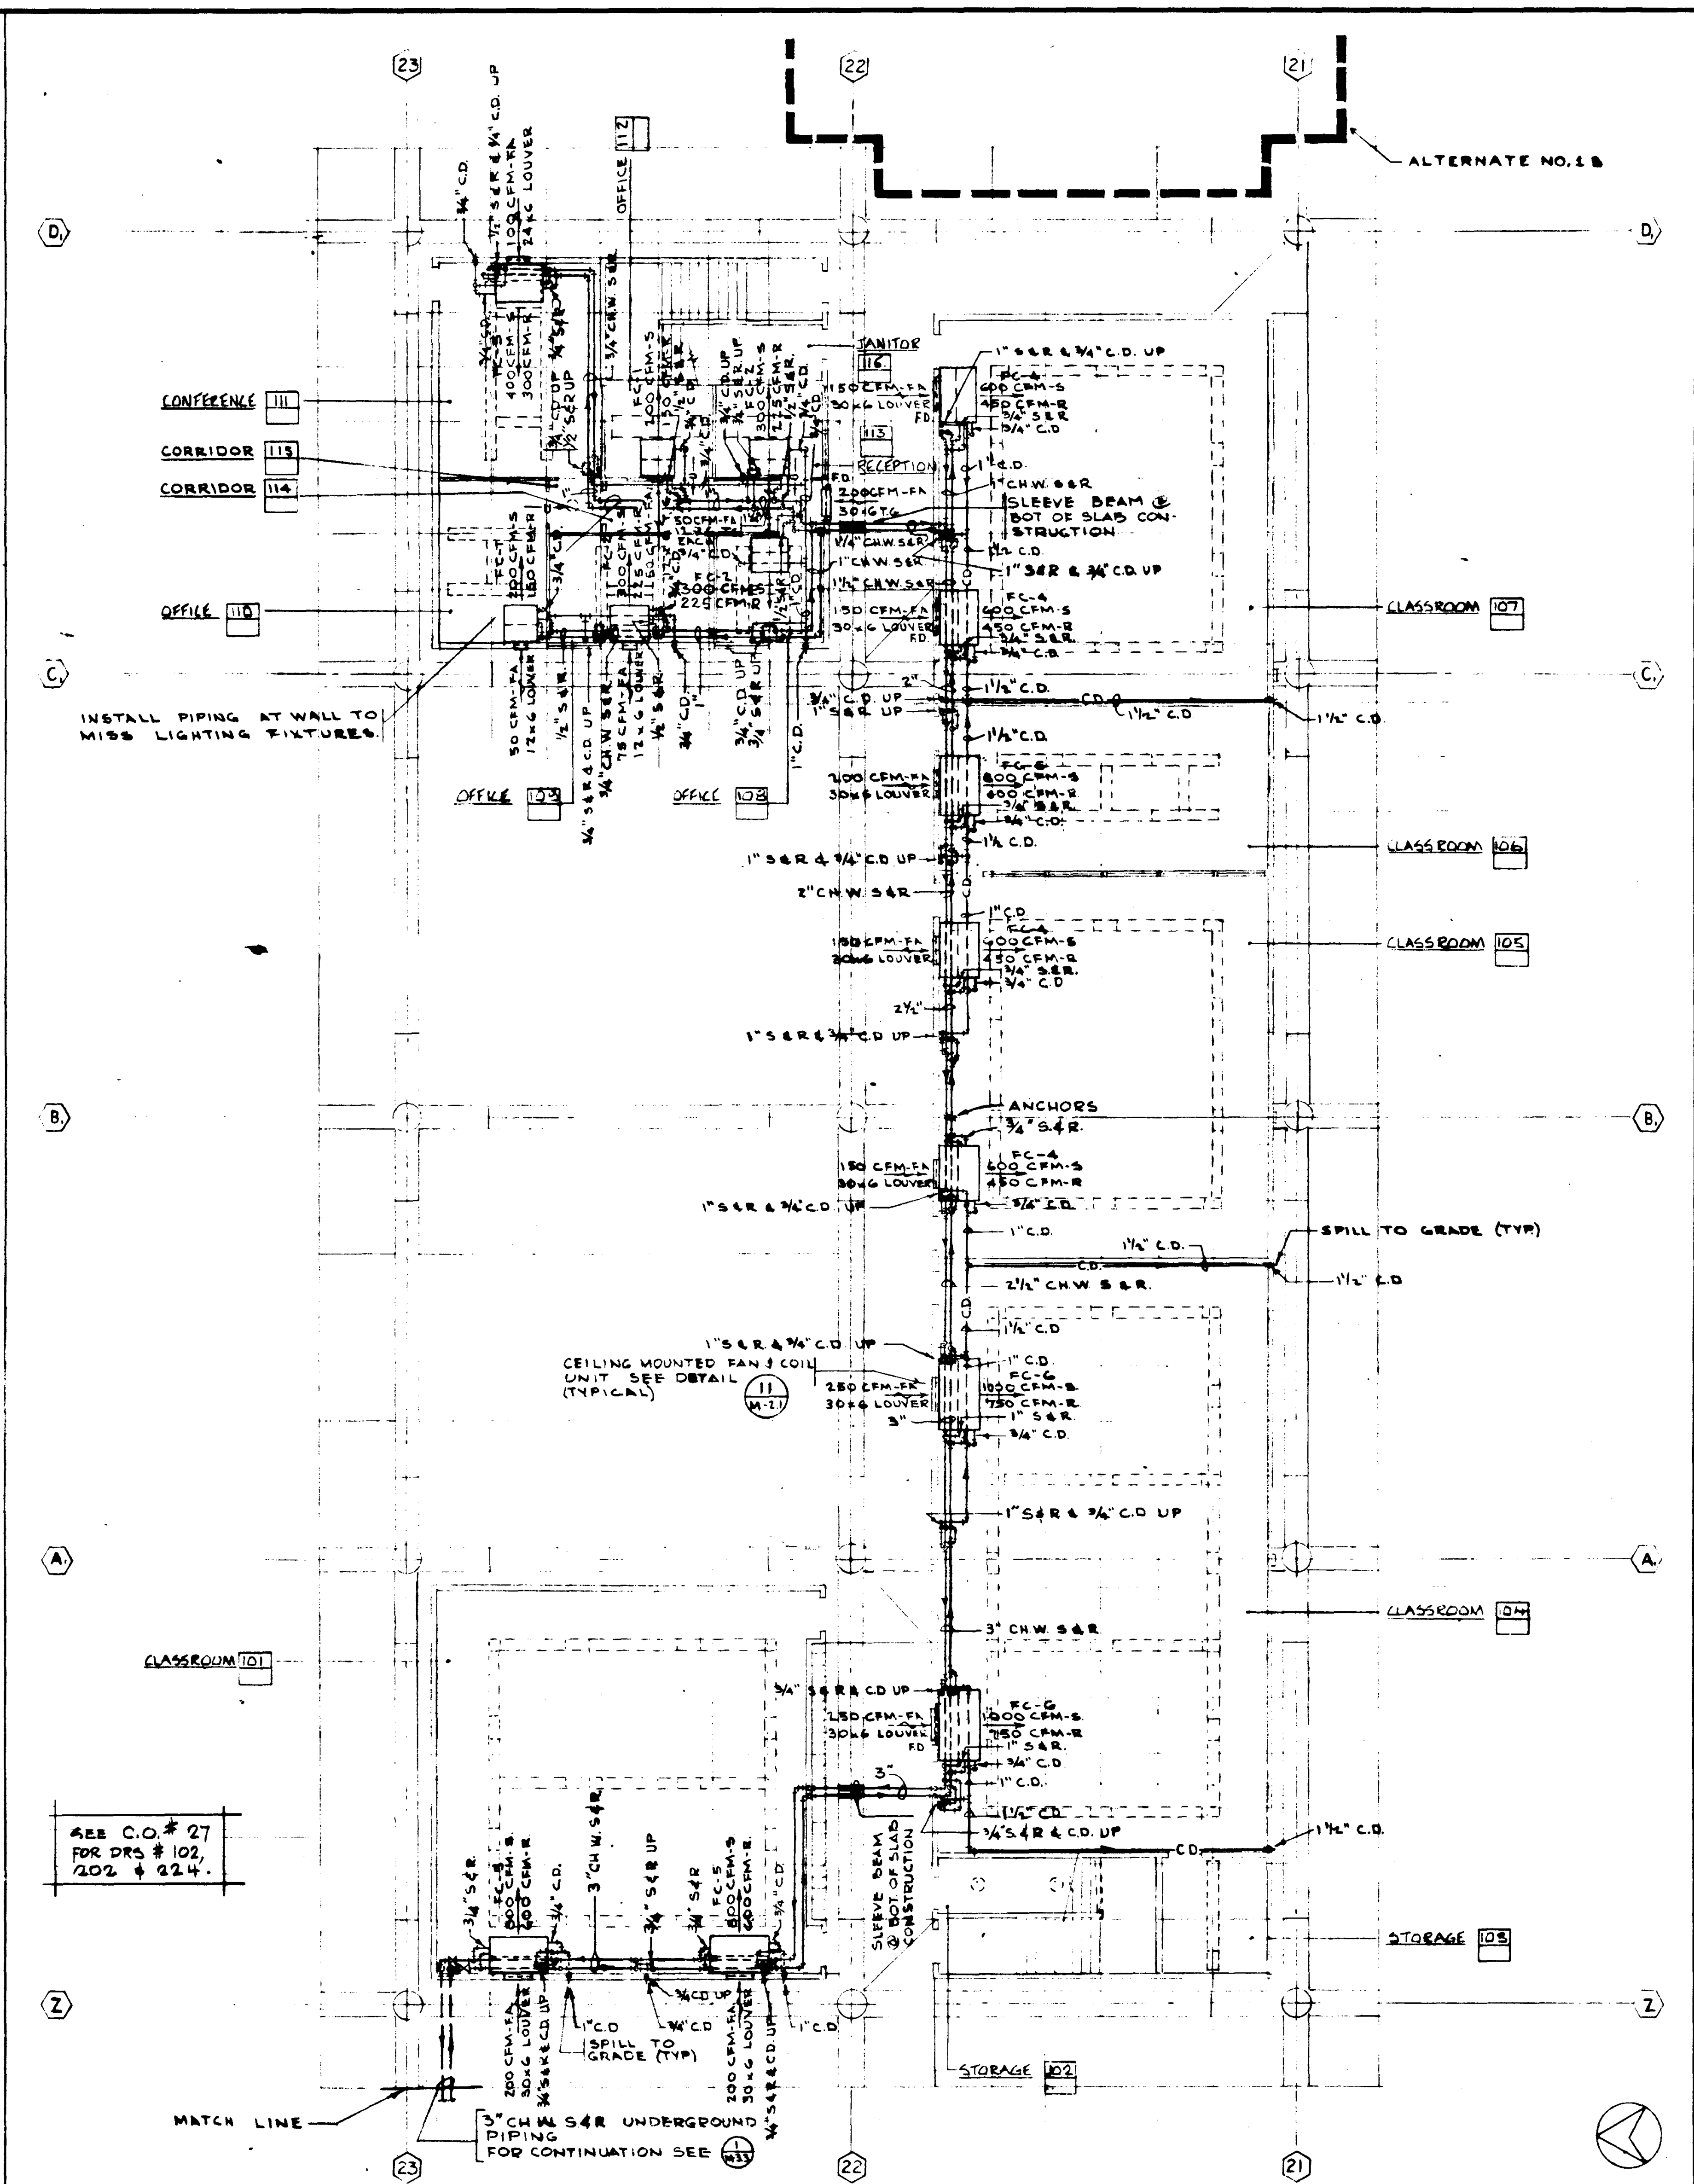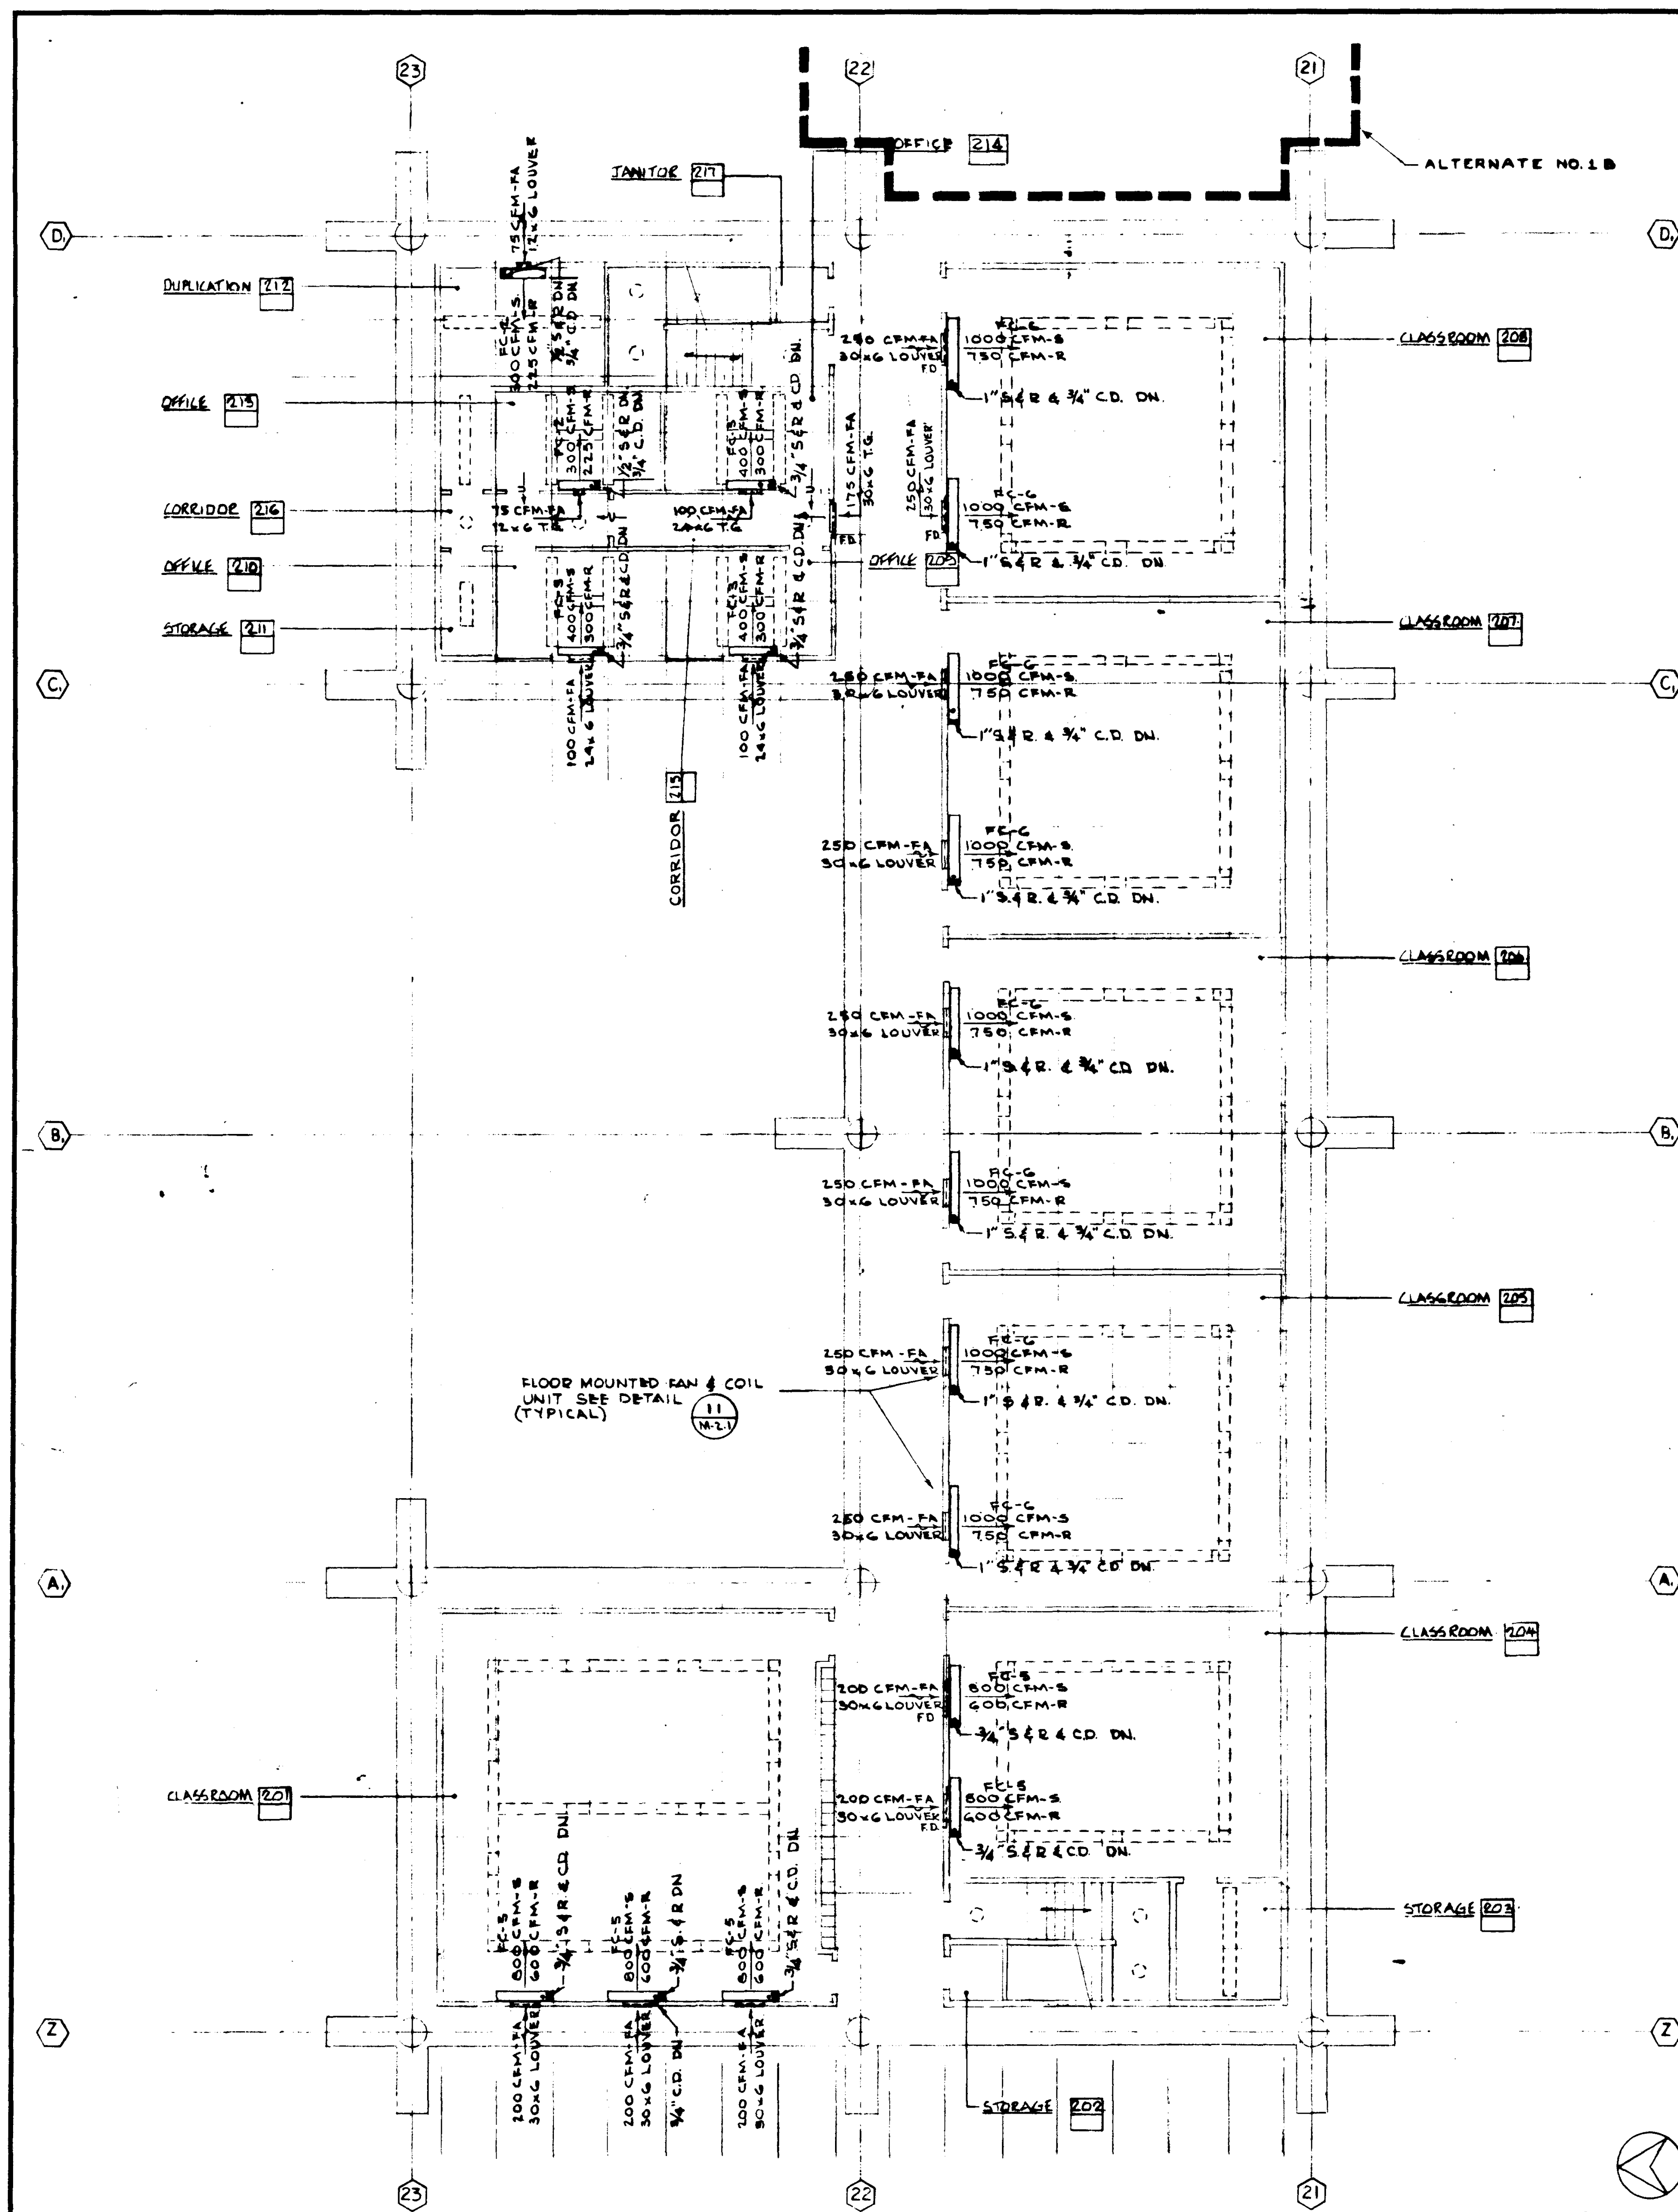

SECOND FLOOR

SCALE 1/8" = 1'-0"

FIRST FLOOR

SCALE 1/8" = 1'-0"


STRUCTURAL ENGINEERS BRADDOCK & JOHNSON J.A. MARTIN & ASSOCIATES	DESIGNED L.H.W.	ARCHITECT WILLIAM L. PEREIRA & ASSOCIATES	APPROVED JUN 21 1965
MECHANICAL ENGINEERS RALPH E. PHILLIPS, INC.	DRAWN BY R.V.	ENGINEER WILLIAM L. PEREIRA	APPROVED JUN 21 1965
ELECTRICAL ENGINEERS RALPH E. PHILLIPS, INC.	CHECKED BY W.C.L.	STATE OF CALIFORNIA JULY 1965	
CIVIL ENGINEERS G. SHURMAN & ASSOCIATES MOFFATT & NICHOL			

ASSOCIATED ARCHITECTS:
WILLIAM L. PEREIRA & ASSOCIATES
A. QUINCY JONES-FREDERICK E. EMMONS & ASSOCIATES
BLUROCK ELLERBROEK & ASSOCIATES


URBANUS SQUARE • MACARTHUR BOULEVARD AT FORD ROAD
TELEPHONE 714/675-2640 • CORONA DEL MAR, CALIFORNIA

GOLDEN WEST COLLEGE
HUNTINGTON BEACH, CALIFORNIA
ORANGE COAST JUNIOR COLLEGE DISTRICT

UNIT 3	SHEET NO. 104
FLOOR	DATE 6-15-65
PLAN	SHEET NO. M 13-6

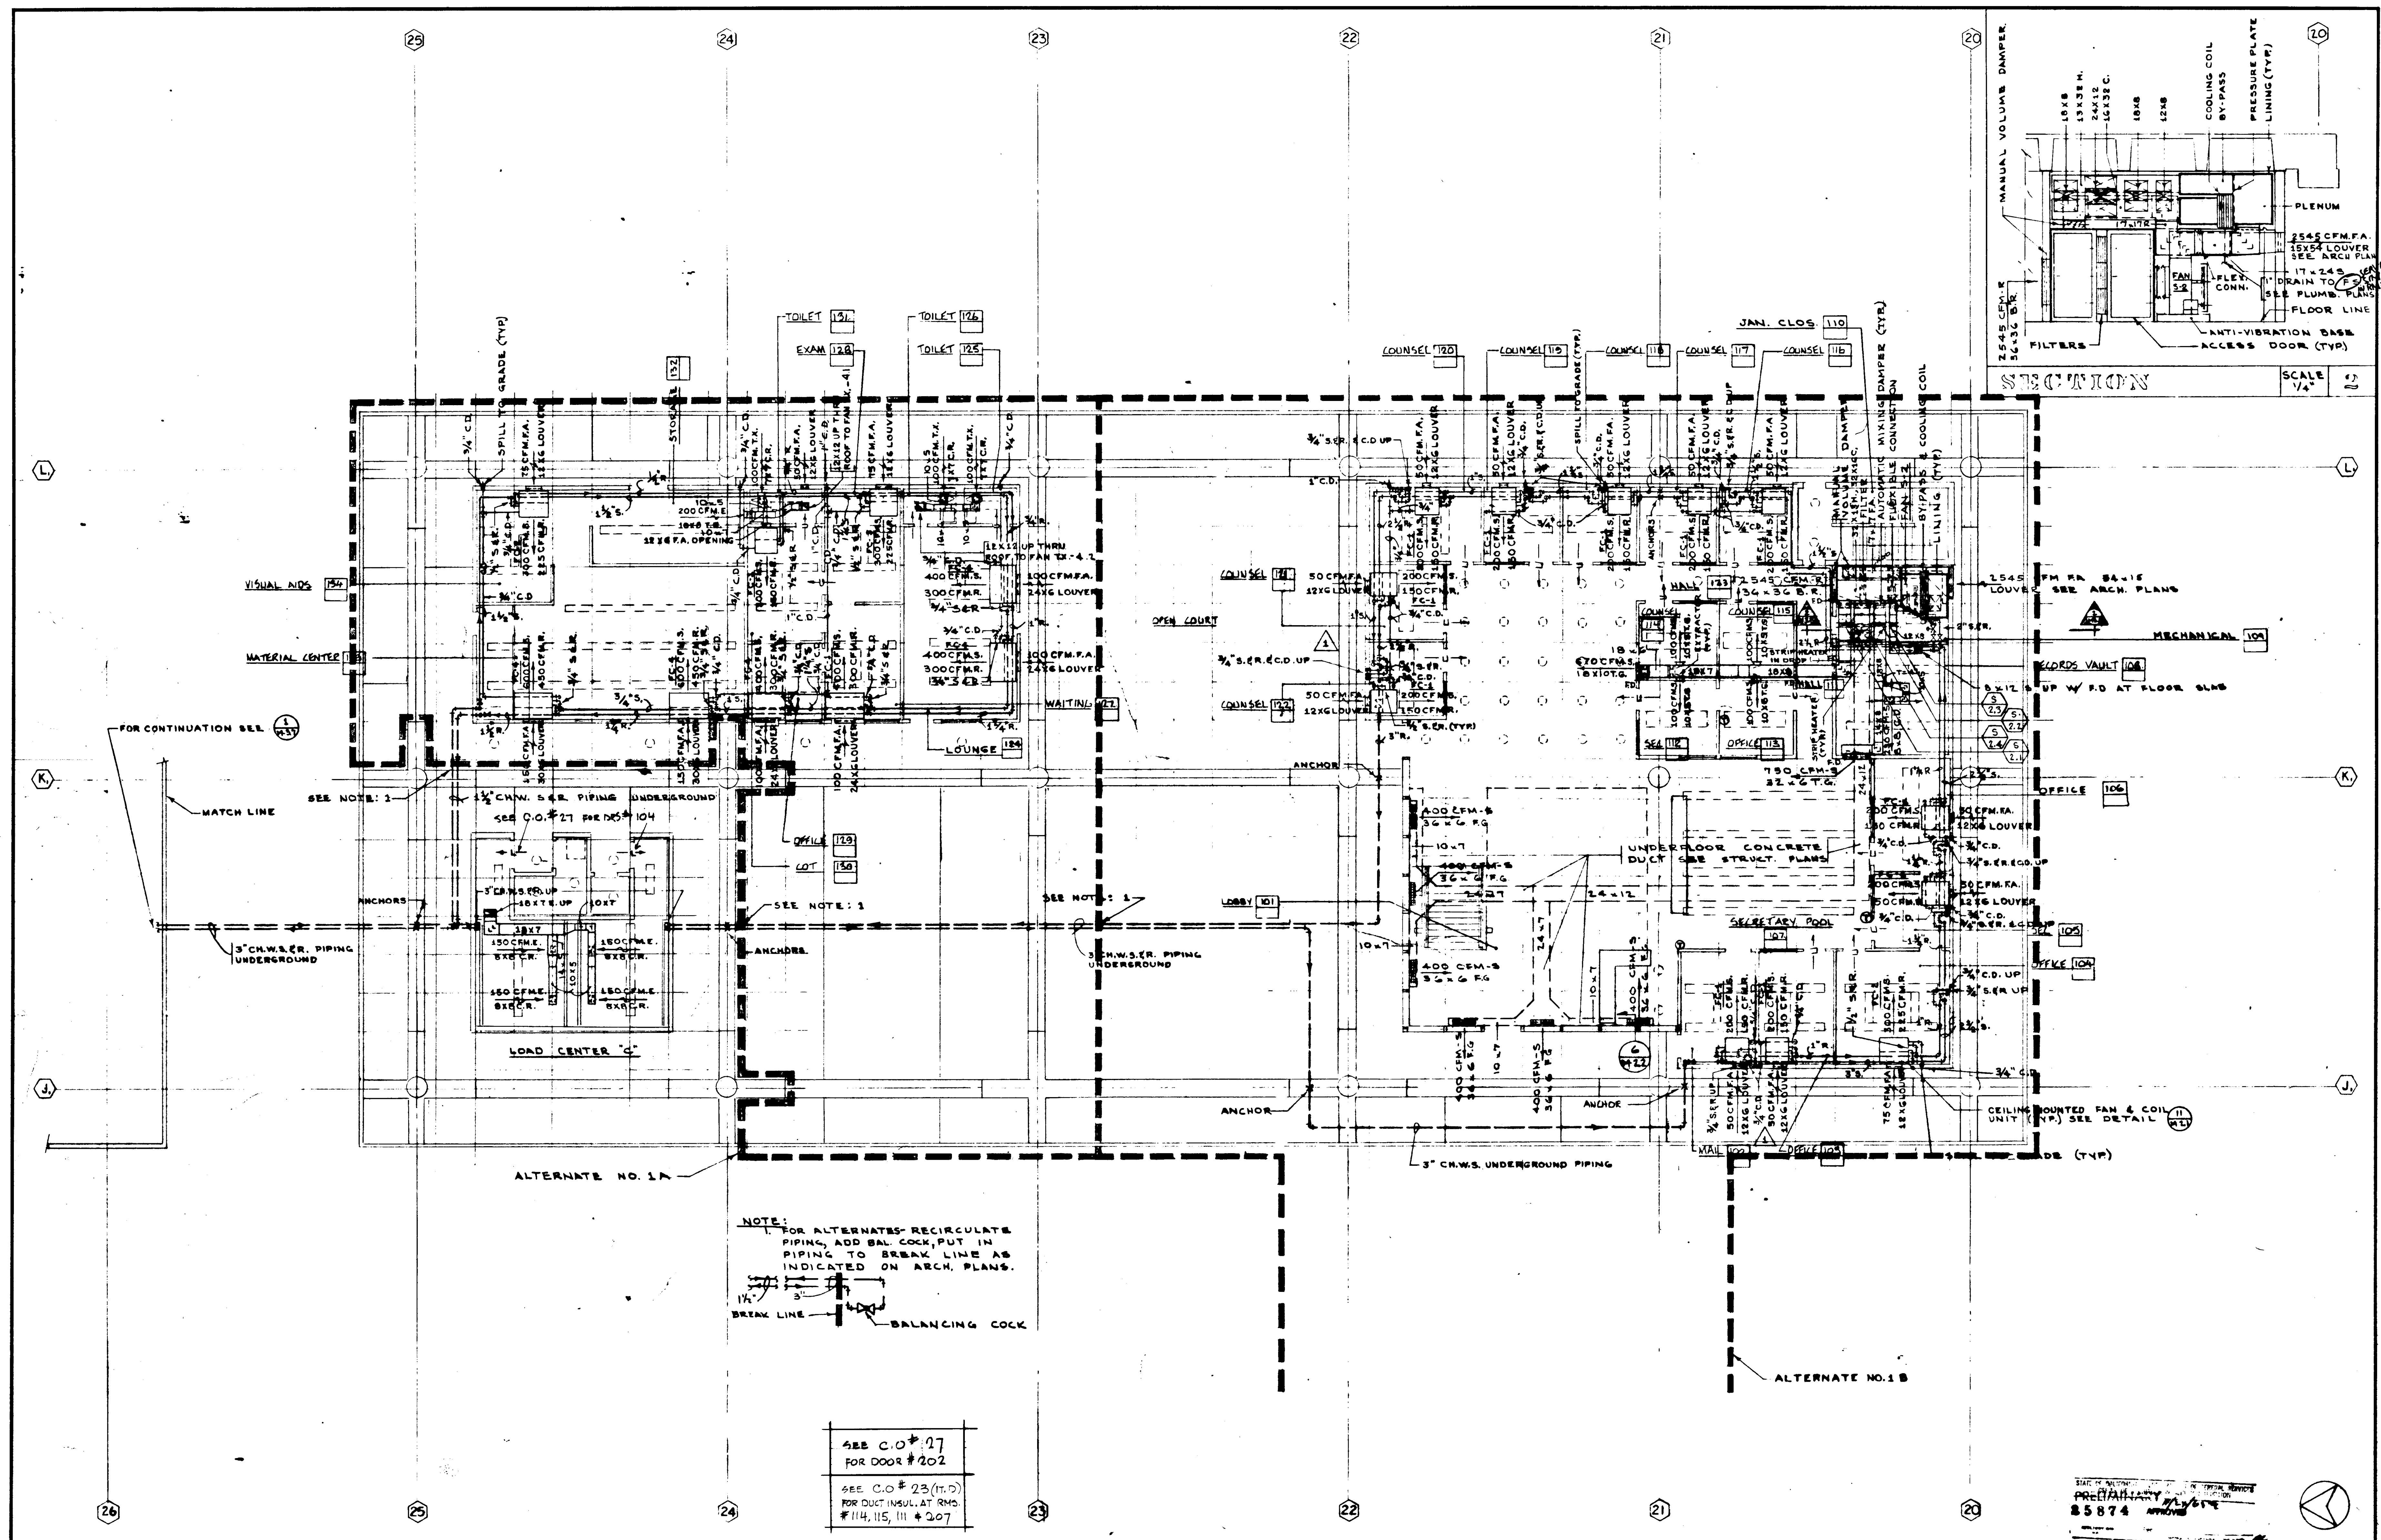



STATE OF CALIFORNIA DEPARTMENT OF GENERAL SERVICES OFFICE OF ARCHITECTURE AND CONSTRUCTION										SCALE 1/8" = 1'	
APPROVED JUN 21 1968 STATE OF CALIFORNIA DATE JUN 21 1968										UNIT 4	
ASSOCIATED ARCHITECTS: WILLIAM L. PEREIRA & ASSOCIATES A. QUINCY JONES-FREDERICK E. EMMONS & ASSOCIATES BLUROCK ELLERBROCK & ASSOCIATES										FLOOR	
URBANUS SQUARE MACARTHUR BOULEVARD AT FORD ROAD TELEPHONE 714/675-2640 CORONA DEL MAR, CALIFORNIA										PLAN	
GOLDEN WEST COLLEGE HUNTINGTON BEACH, CALIFORNIA ORANGE COAST JUNIOR COLLEGE DISTRICT										104 6-15-65 NR3.5	

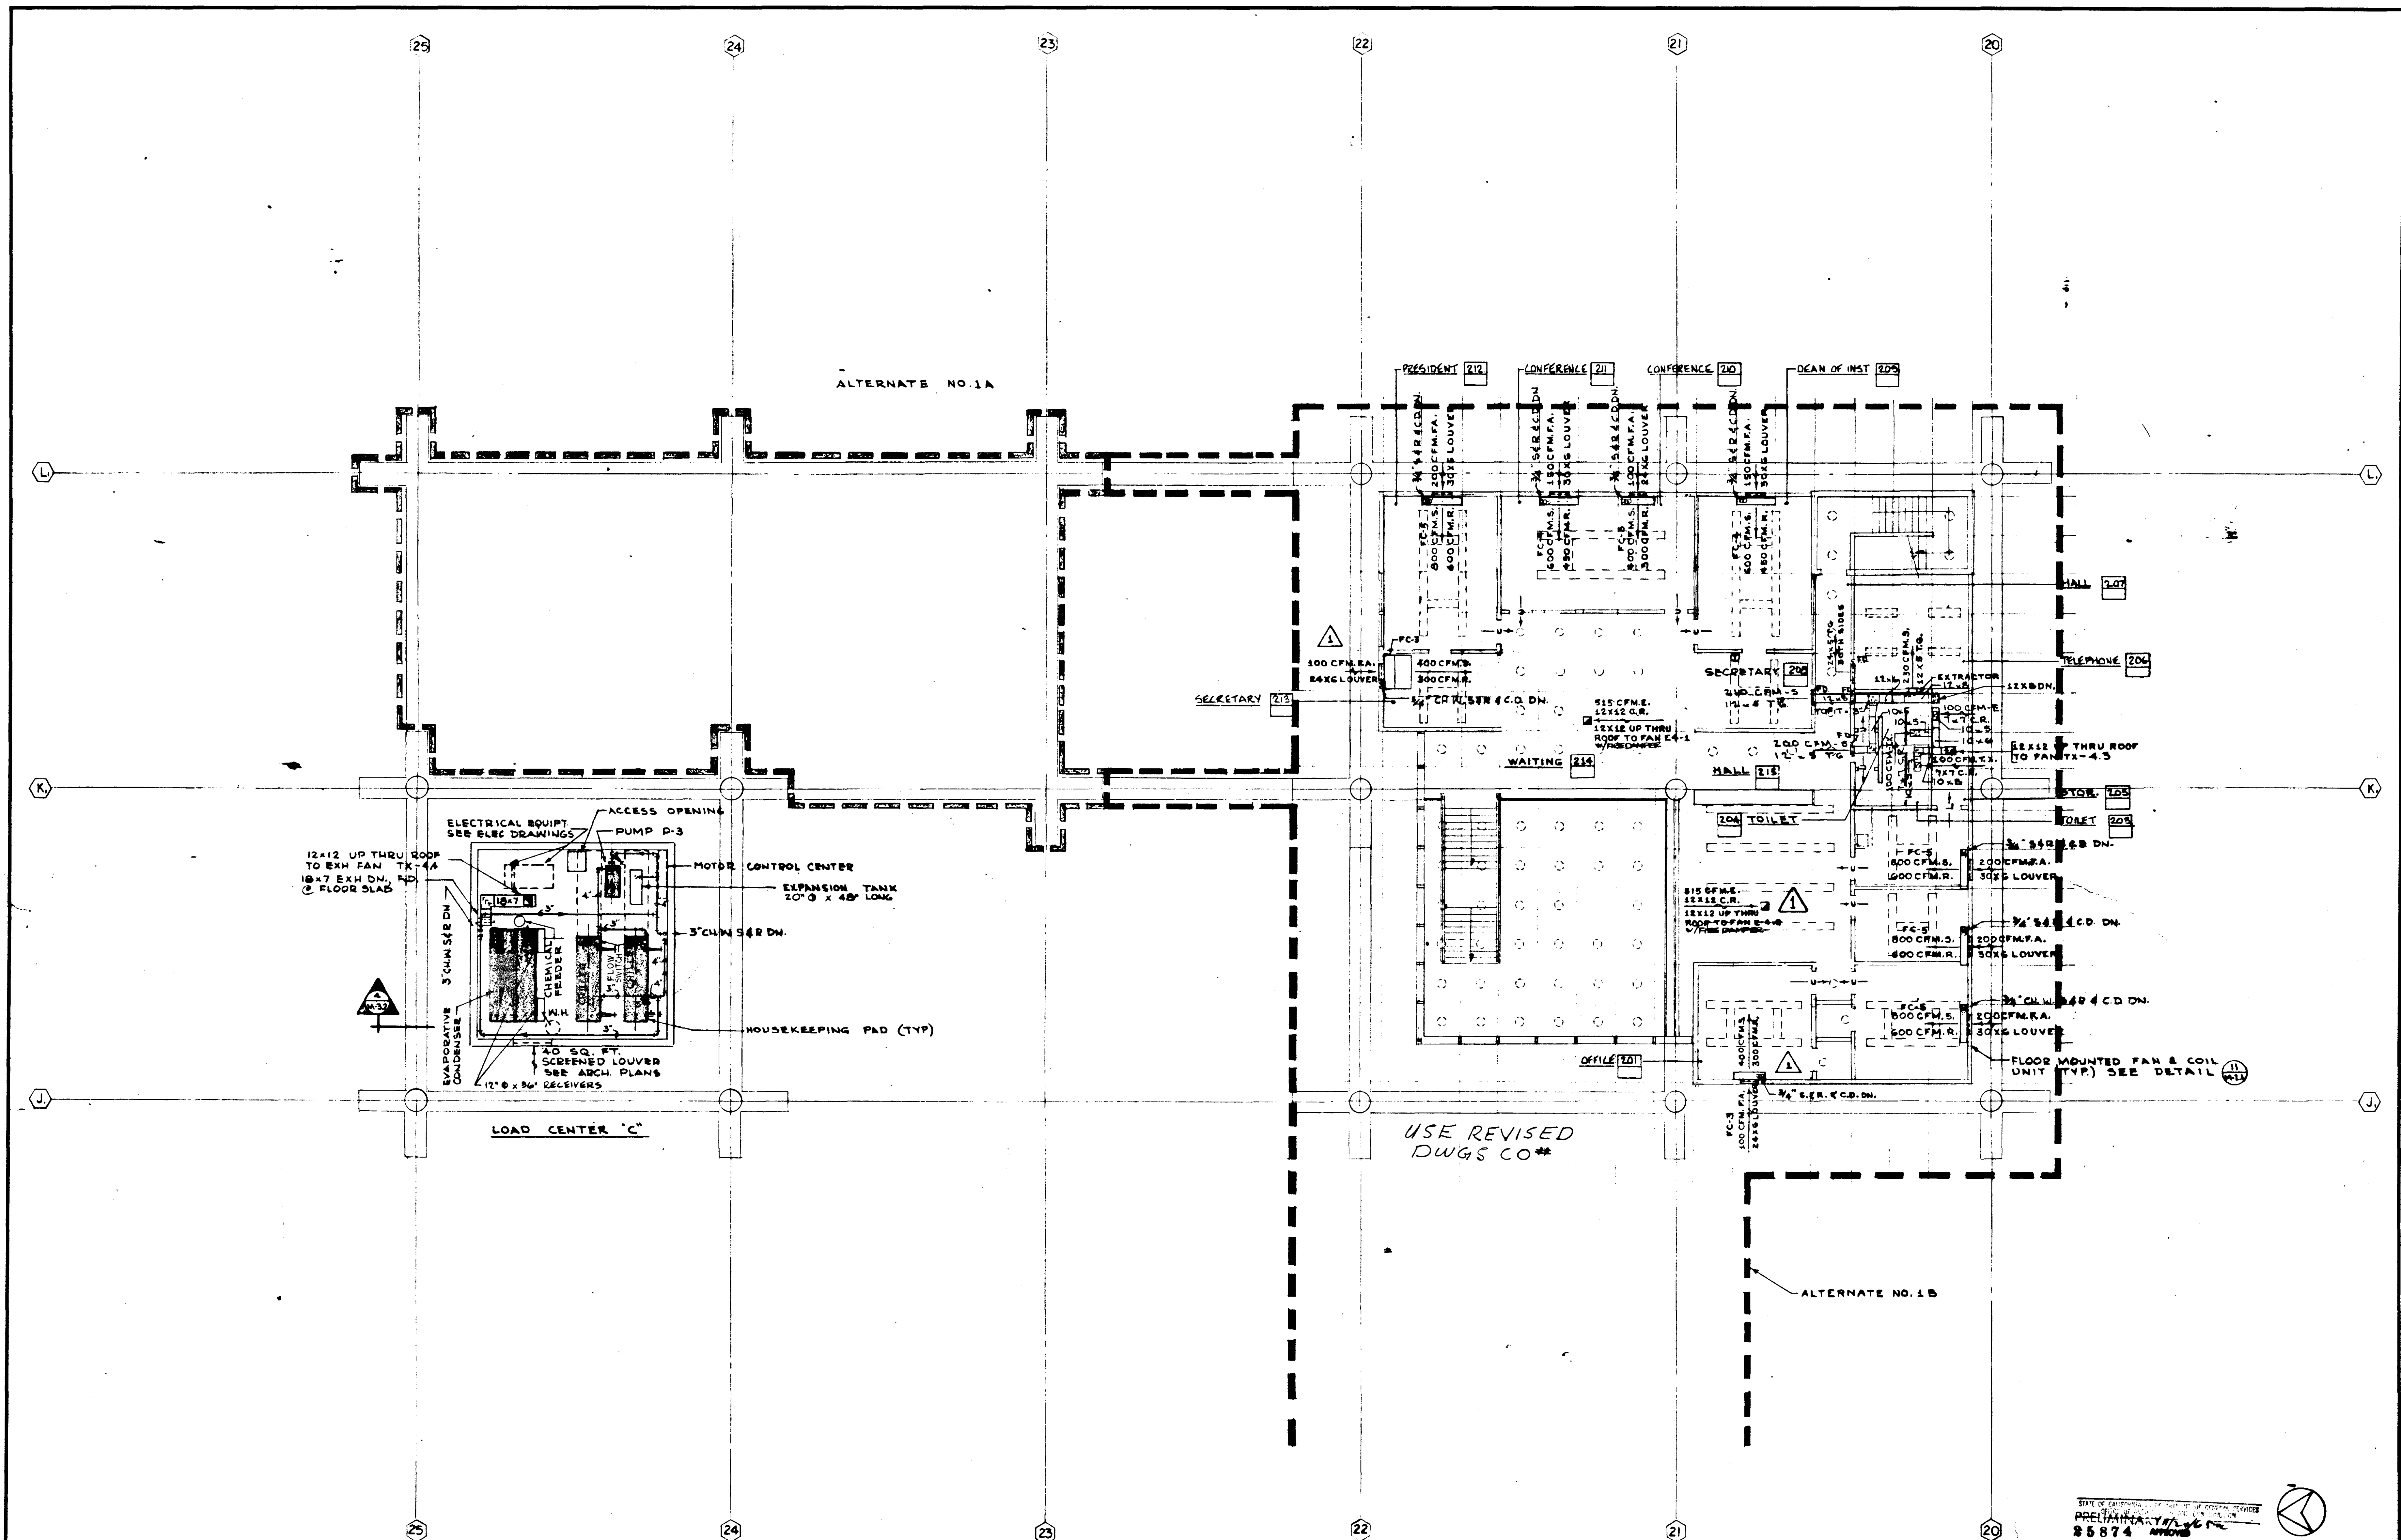

STATE OF CALIFORNIA
 PRELIMINARY
 25874

SECOND FLOOR

		STRUCTURAL ENGINEERS BRANDOW & JOHNSTON J. A. MARTIN & ASSOCIATES		DESIGNED L. H. W.		ARCHITECT WILLIAM L. PEREIRA & ASSOCIATES		APPROVED JUN 21 1965			
		MECHANICAL ENGINEERS RALPH E. PHILLIPS, INC.		DRAWN BY R. W.		APPROVED STATE FIRE MARSHAL STATE OF CALIFORNIA JUN 11 1965		ASSOCIATED ARCHITECTS: WILLIAM L. PEREIRA & ASSOCIATES A. QUINCY JONES-FREDERICK E. EMMONS & ASSOCIATES BLUROCK ELLERBROEK & ASSOCIATES			
		ELECTRICAL ENGINEERS RALPH E. PHILLIPS, INC.		CHECKED BY W. C. L.		COLLEGE		URBANUS SQUARE MACARTHUR BOULEVARD AT FORD ROAD TELEPHONE 714/675-2640 CORONA DEL MAR, CALIFORNIA			
		CIVIL ENGINEERS G. SHUVERMAN & ASSOCIATES MOFFATT & NISBOL						GOLDEN WEST COLLEGE HUNTINGTON BEACH, CALIFORNIA ORANGE COAST JUNIOR COLLEGE DISTRICT			
		REVISIONS								UNIT 4	
										FLOOR	
										PLAN	
										JOB NO. 1494	
										DATE 6-15-65	
										SHEET NO. N13.6	

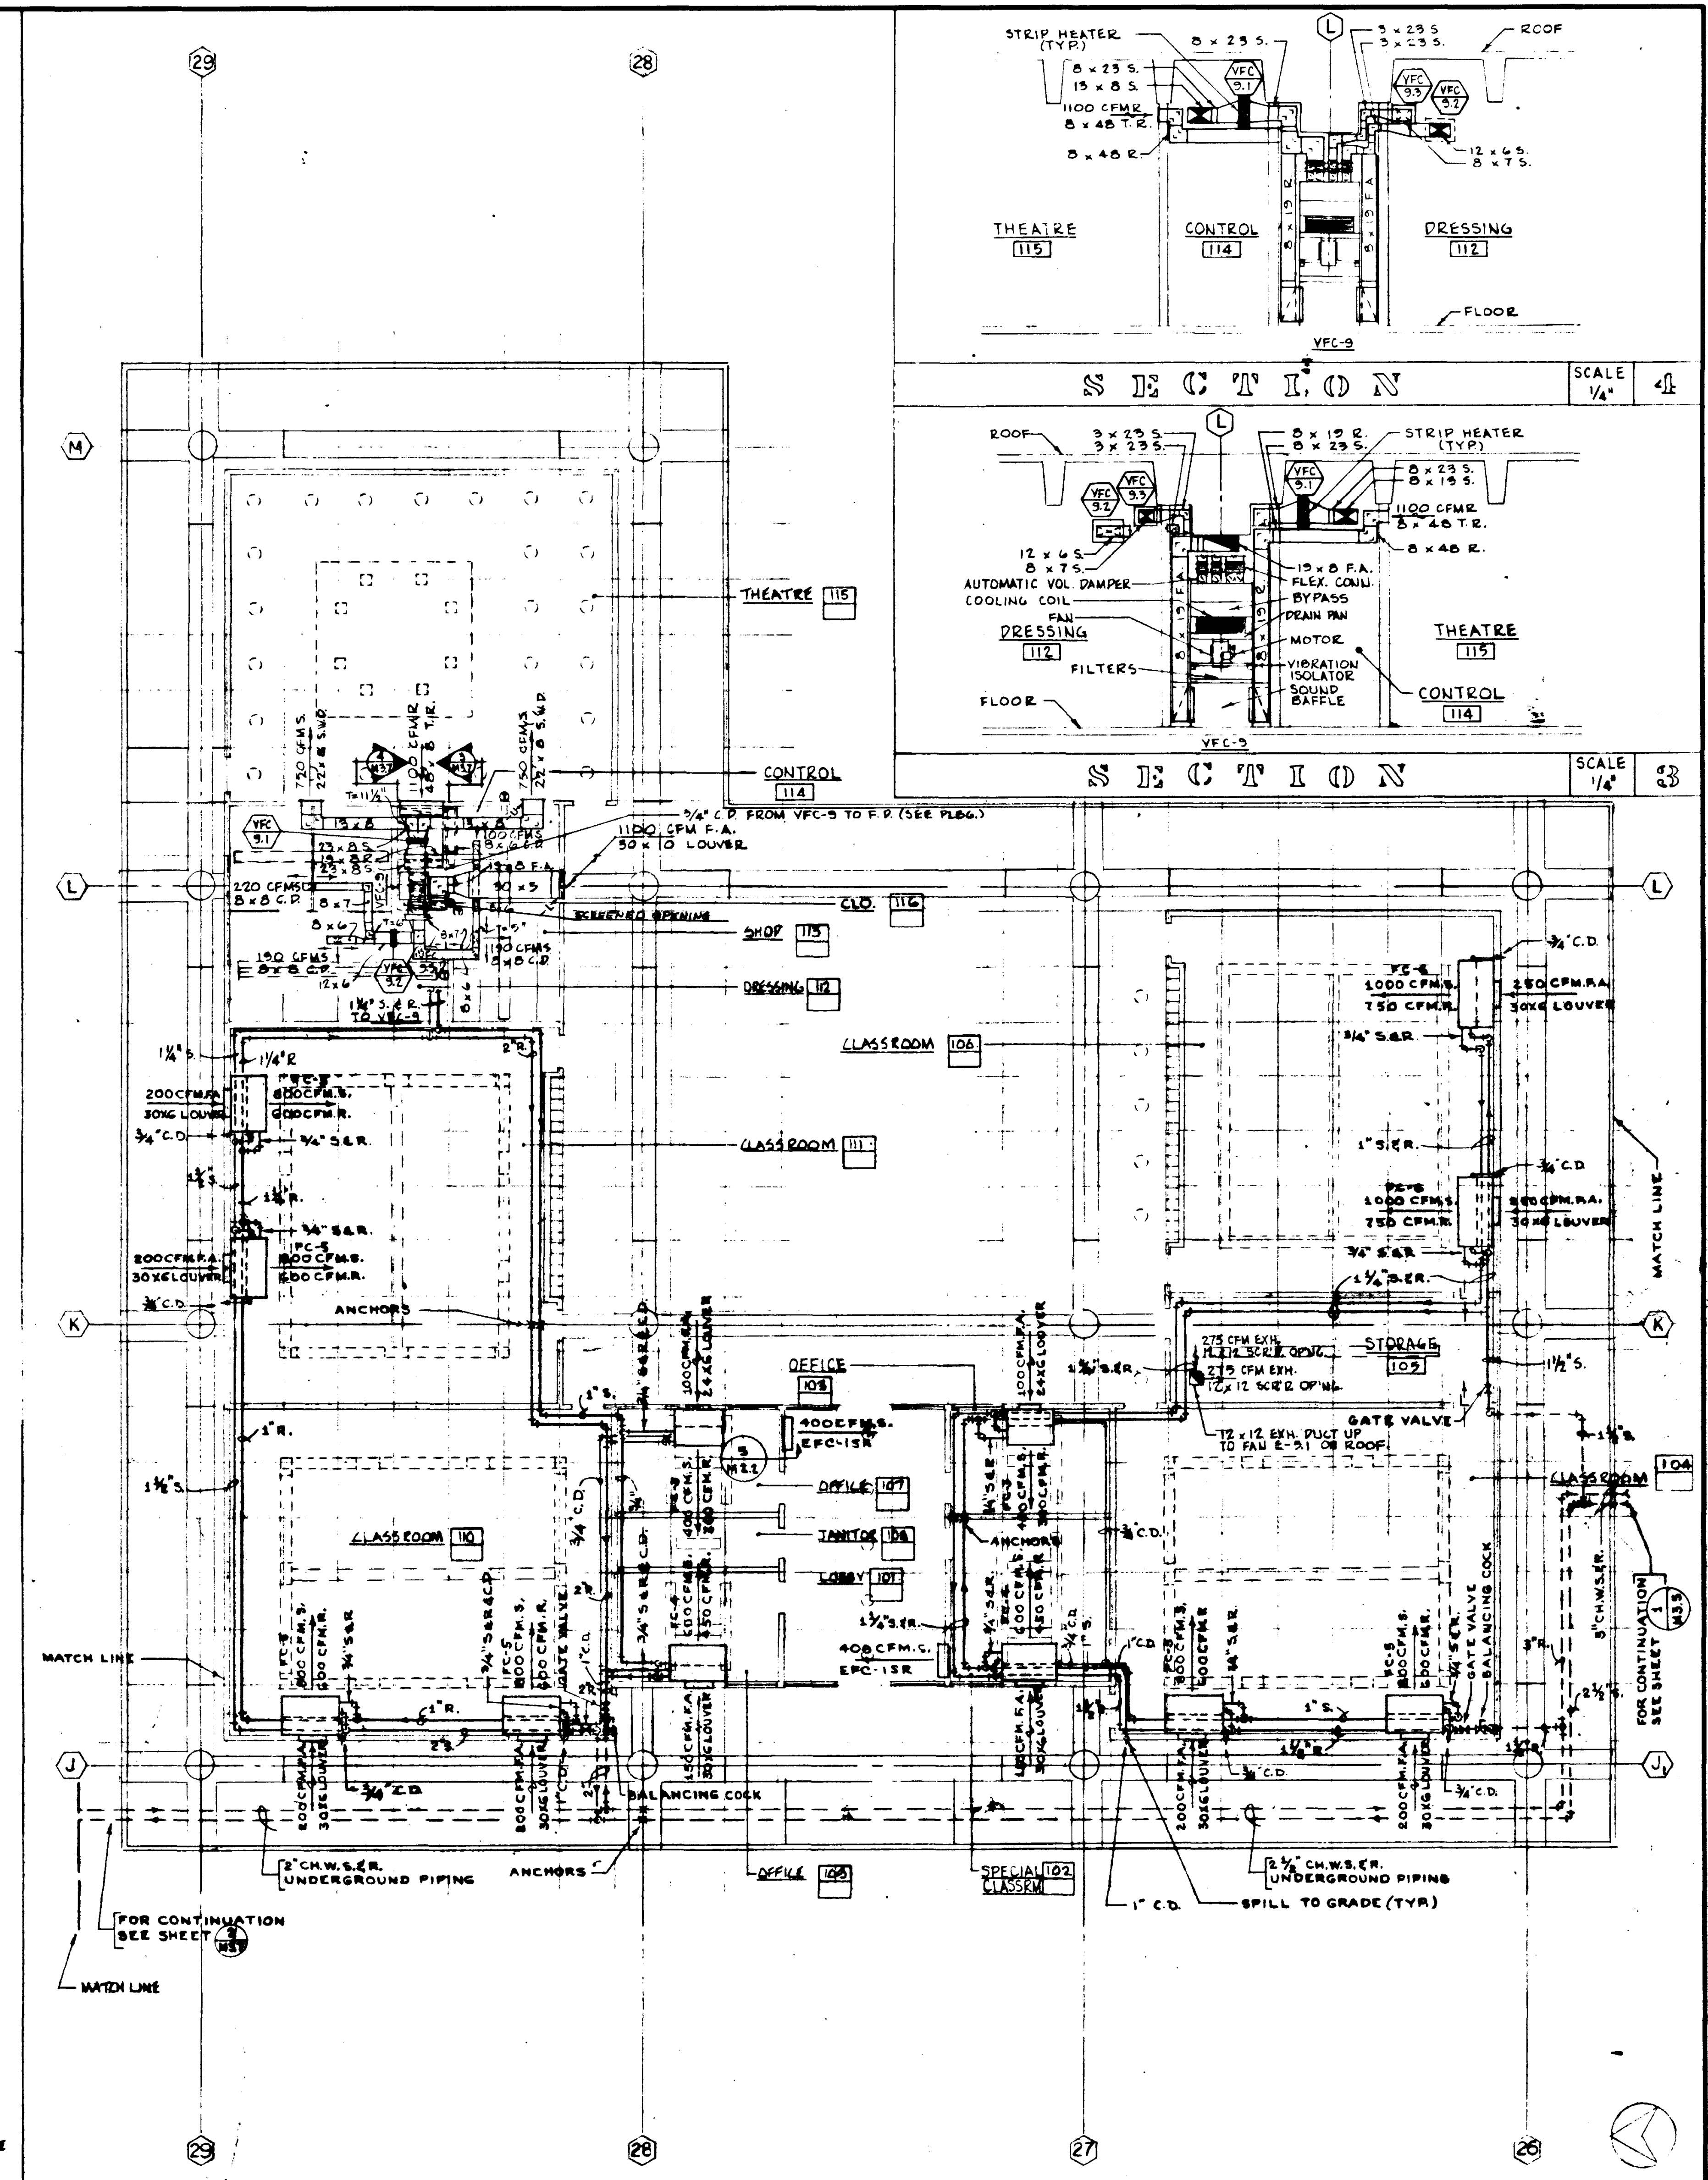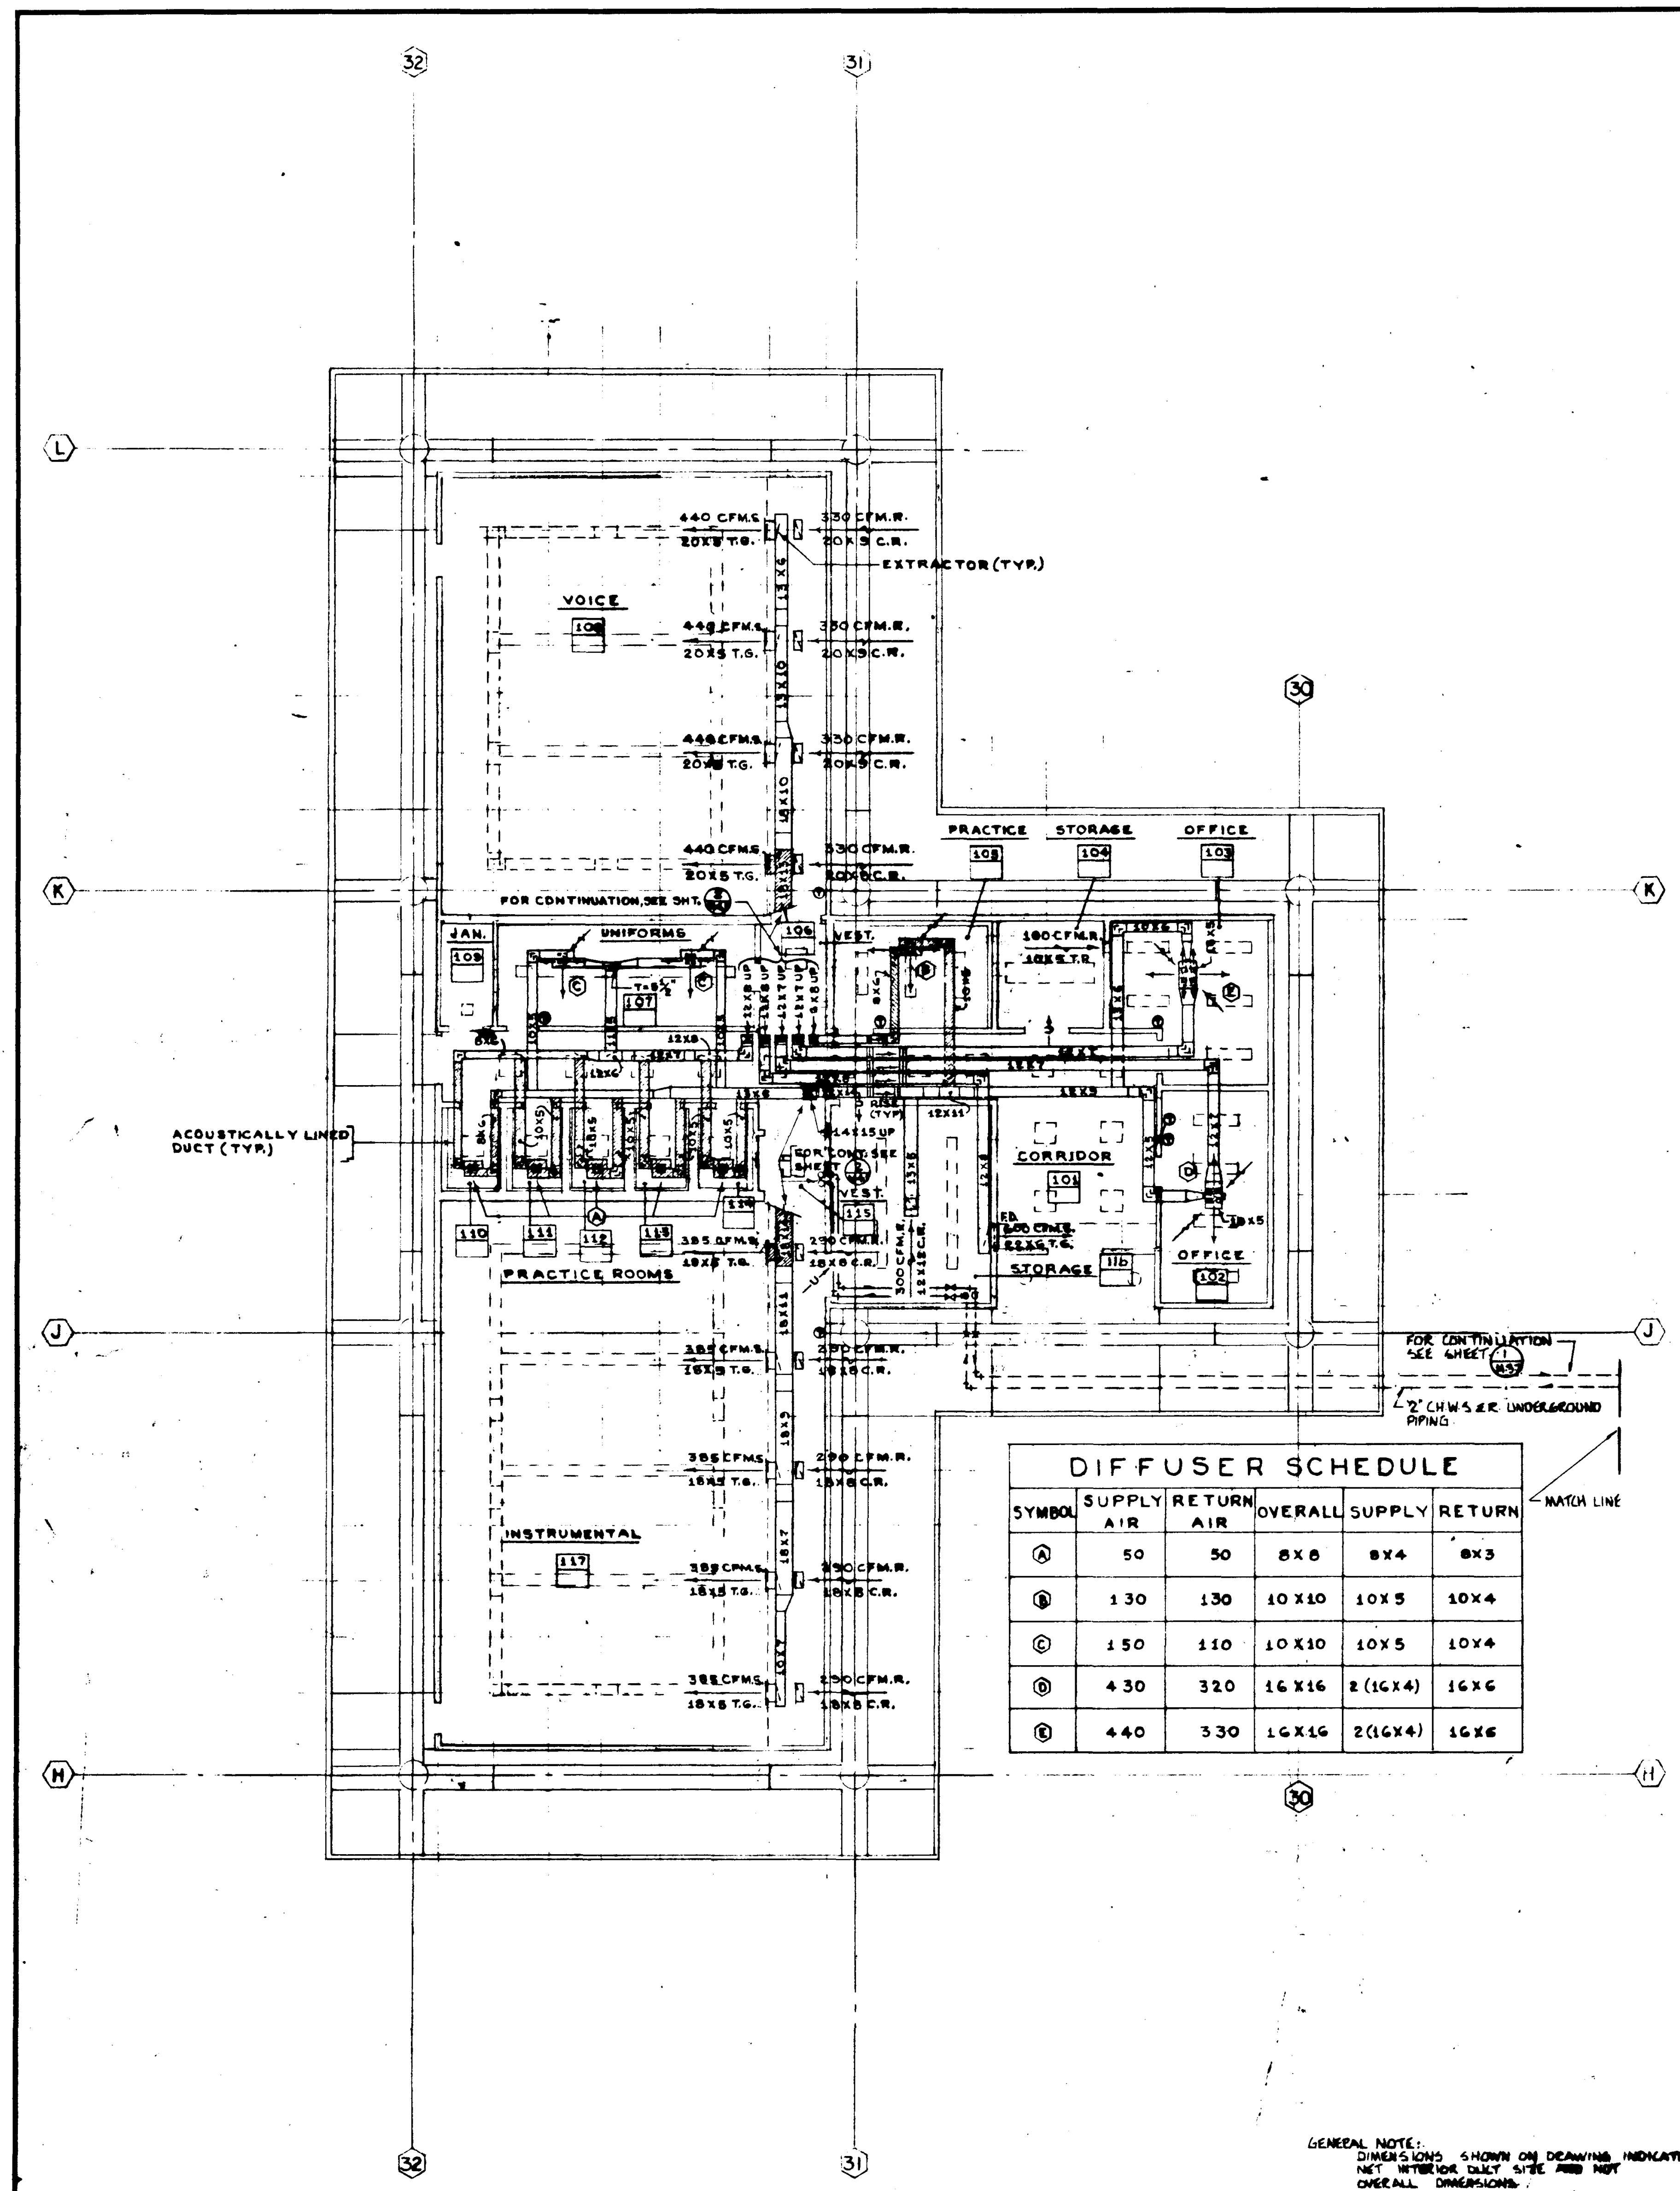

UNIT 4 FIRST FLOOR SCALE 1/8" = 1'-0"

UNIT 5 FIRST FLOOR SCALE 1/8" = 1'-0"

UNIT 5 & 6 FIRST FLOOR SCALE 1/8" = 1'-0"

STRUCTURAL ENGINEERS
BRADSHAW & JOHNSON
J.A. MARTIN & ASSOCIATES

MECHANICAL ENGINEERS
RALPH E. PHILLIPS, INC.

ELECTRICAL ENGINEERS
RALPH E. PHILLIPS, INC.

CIVIL ENGINEERS
O. SHURMAN & ASSOCIATES
MOFFATT & NICHOL

DESIGNED
L.H.W.

DRAWN BY
A.D. & A.E.B.

CHECKED BY
N.C.L.

APPROVED
STATE FIRE MARSHAL
JUN 21 1965

ASSOCIATED ARCHITECTS:
WILLIAM L. PEREIRA & ASSOCIATES
A. QUINCY JONES-FREDERICK E. EMMONS & ASSOCIATES
BLUROCK ELLERBROCK & ASSOCIATES

URBANUS SQUARE • MACARTHUR BOULEVARD AT FORD ROAD
TELEPHONE 714/675-2640 • CORONA DEL MAR, CALIFORNIA

GOLDEN WEST COLLEGE
HUNTINGTON BEACH, CALIFORNIA
ORANGE COAST JUNIOR COLLEGE DISTRICT



REVISIONS

NO.	DATE	REVISION


DATE
6-15-65

SHEET NO.
N 3.7

FOR CONTINUATION SEE SHEET

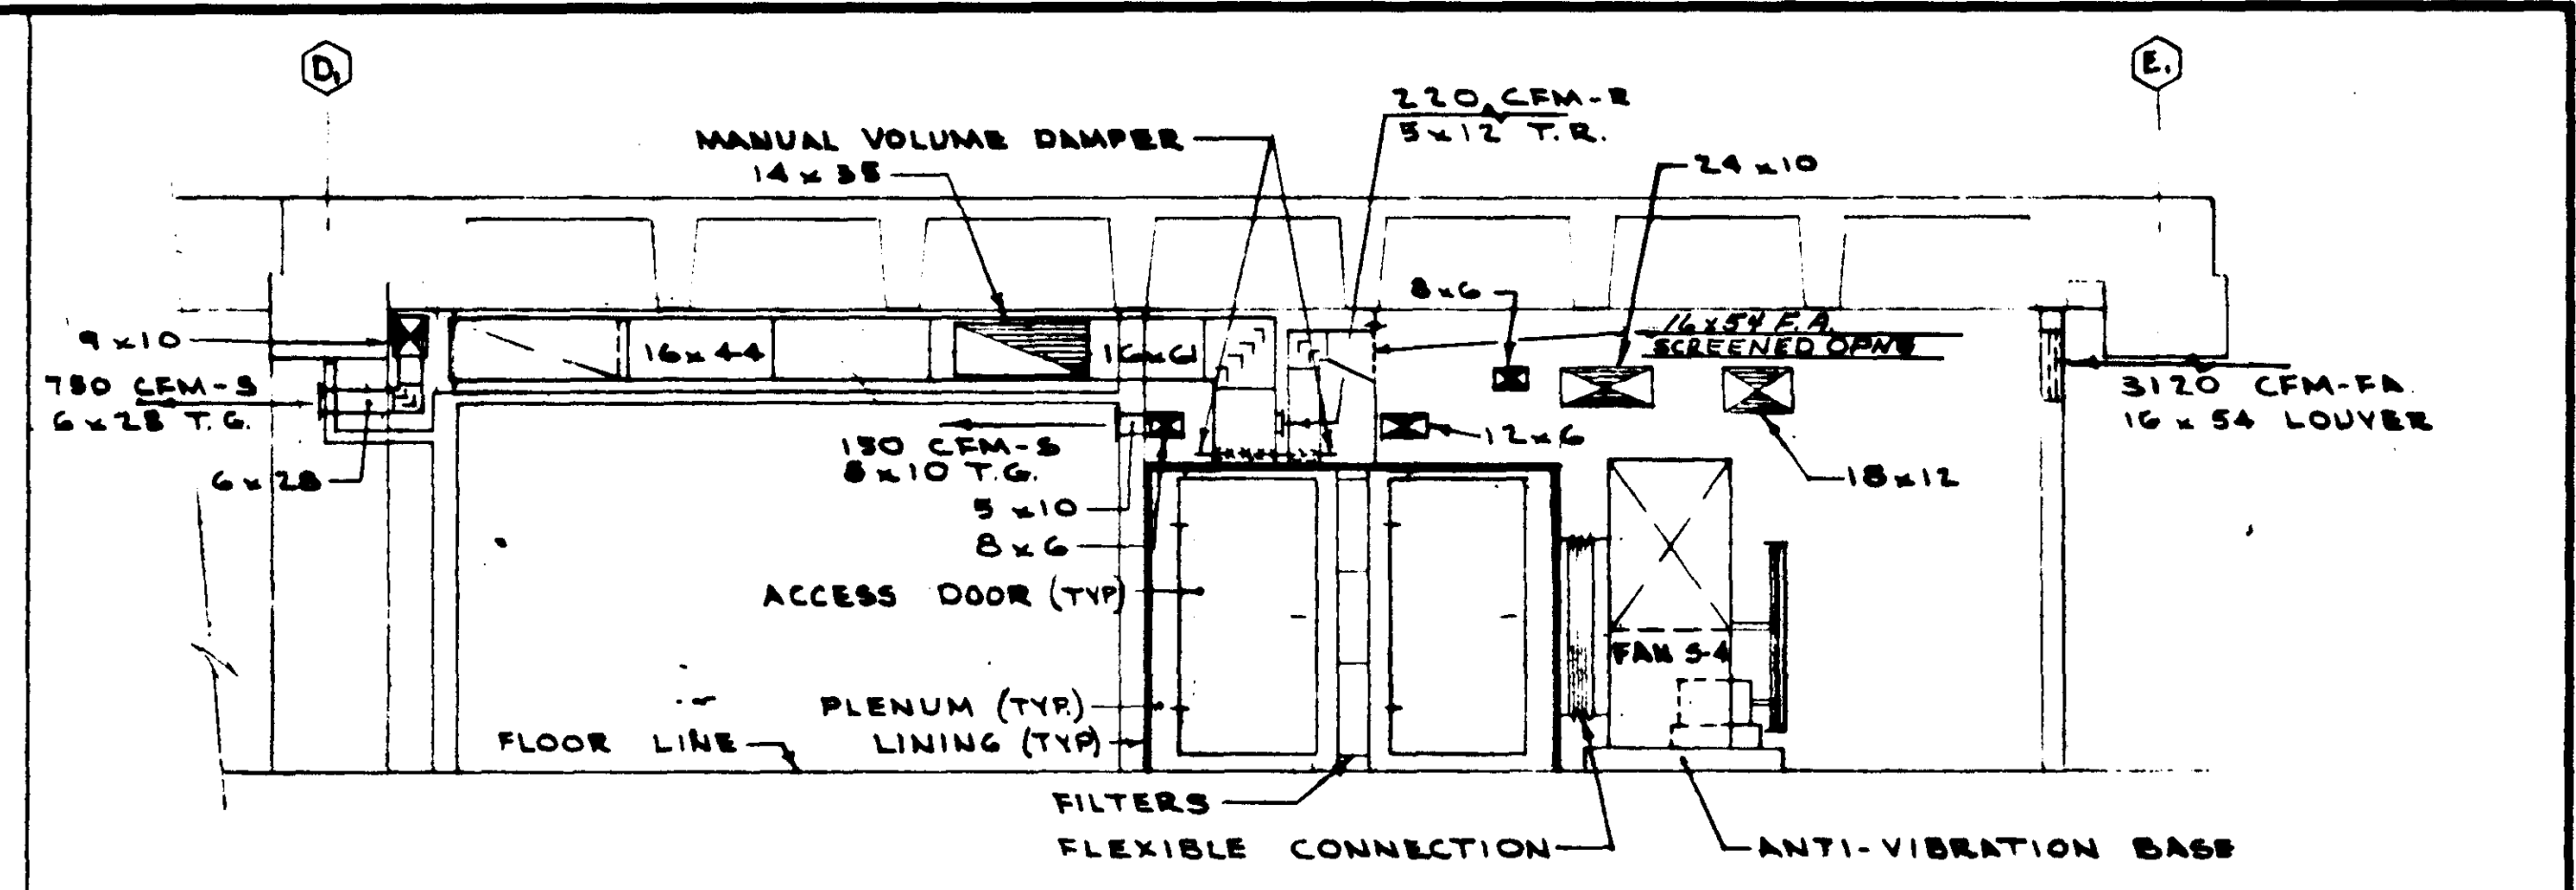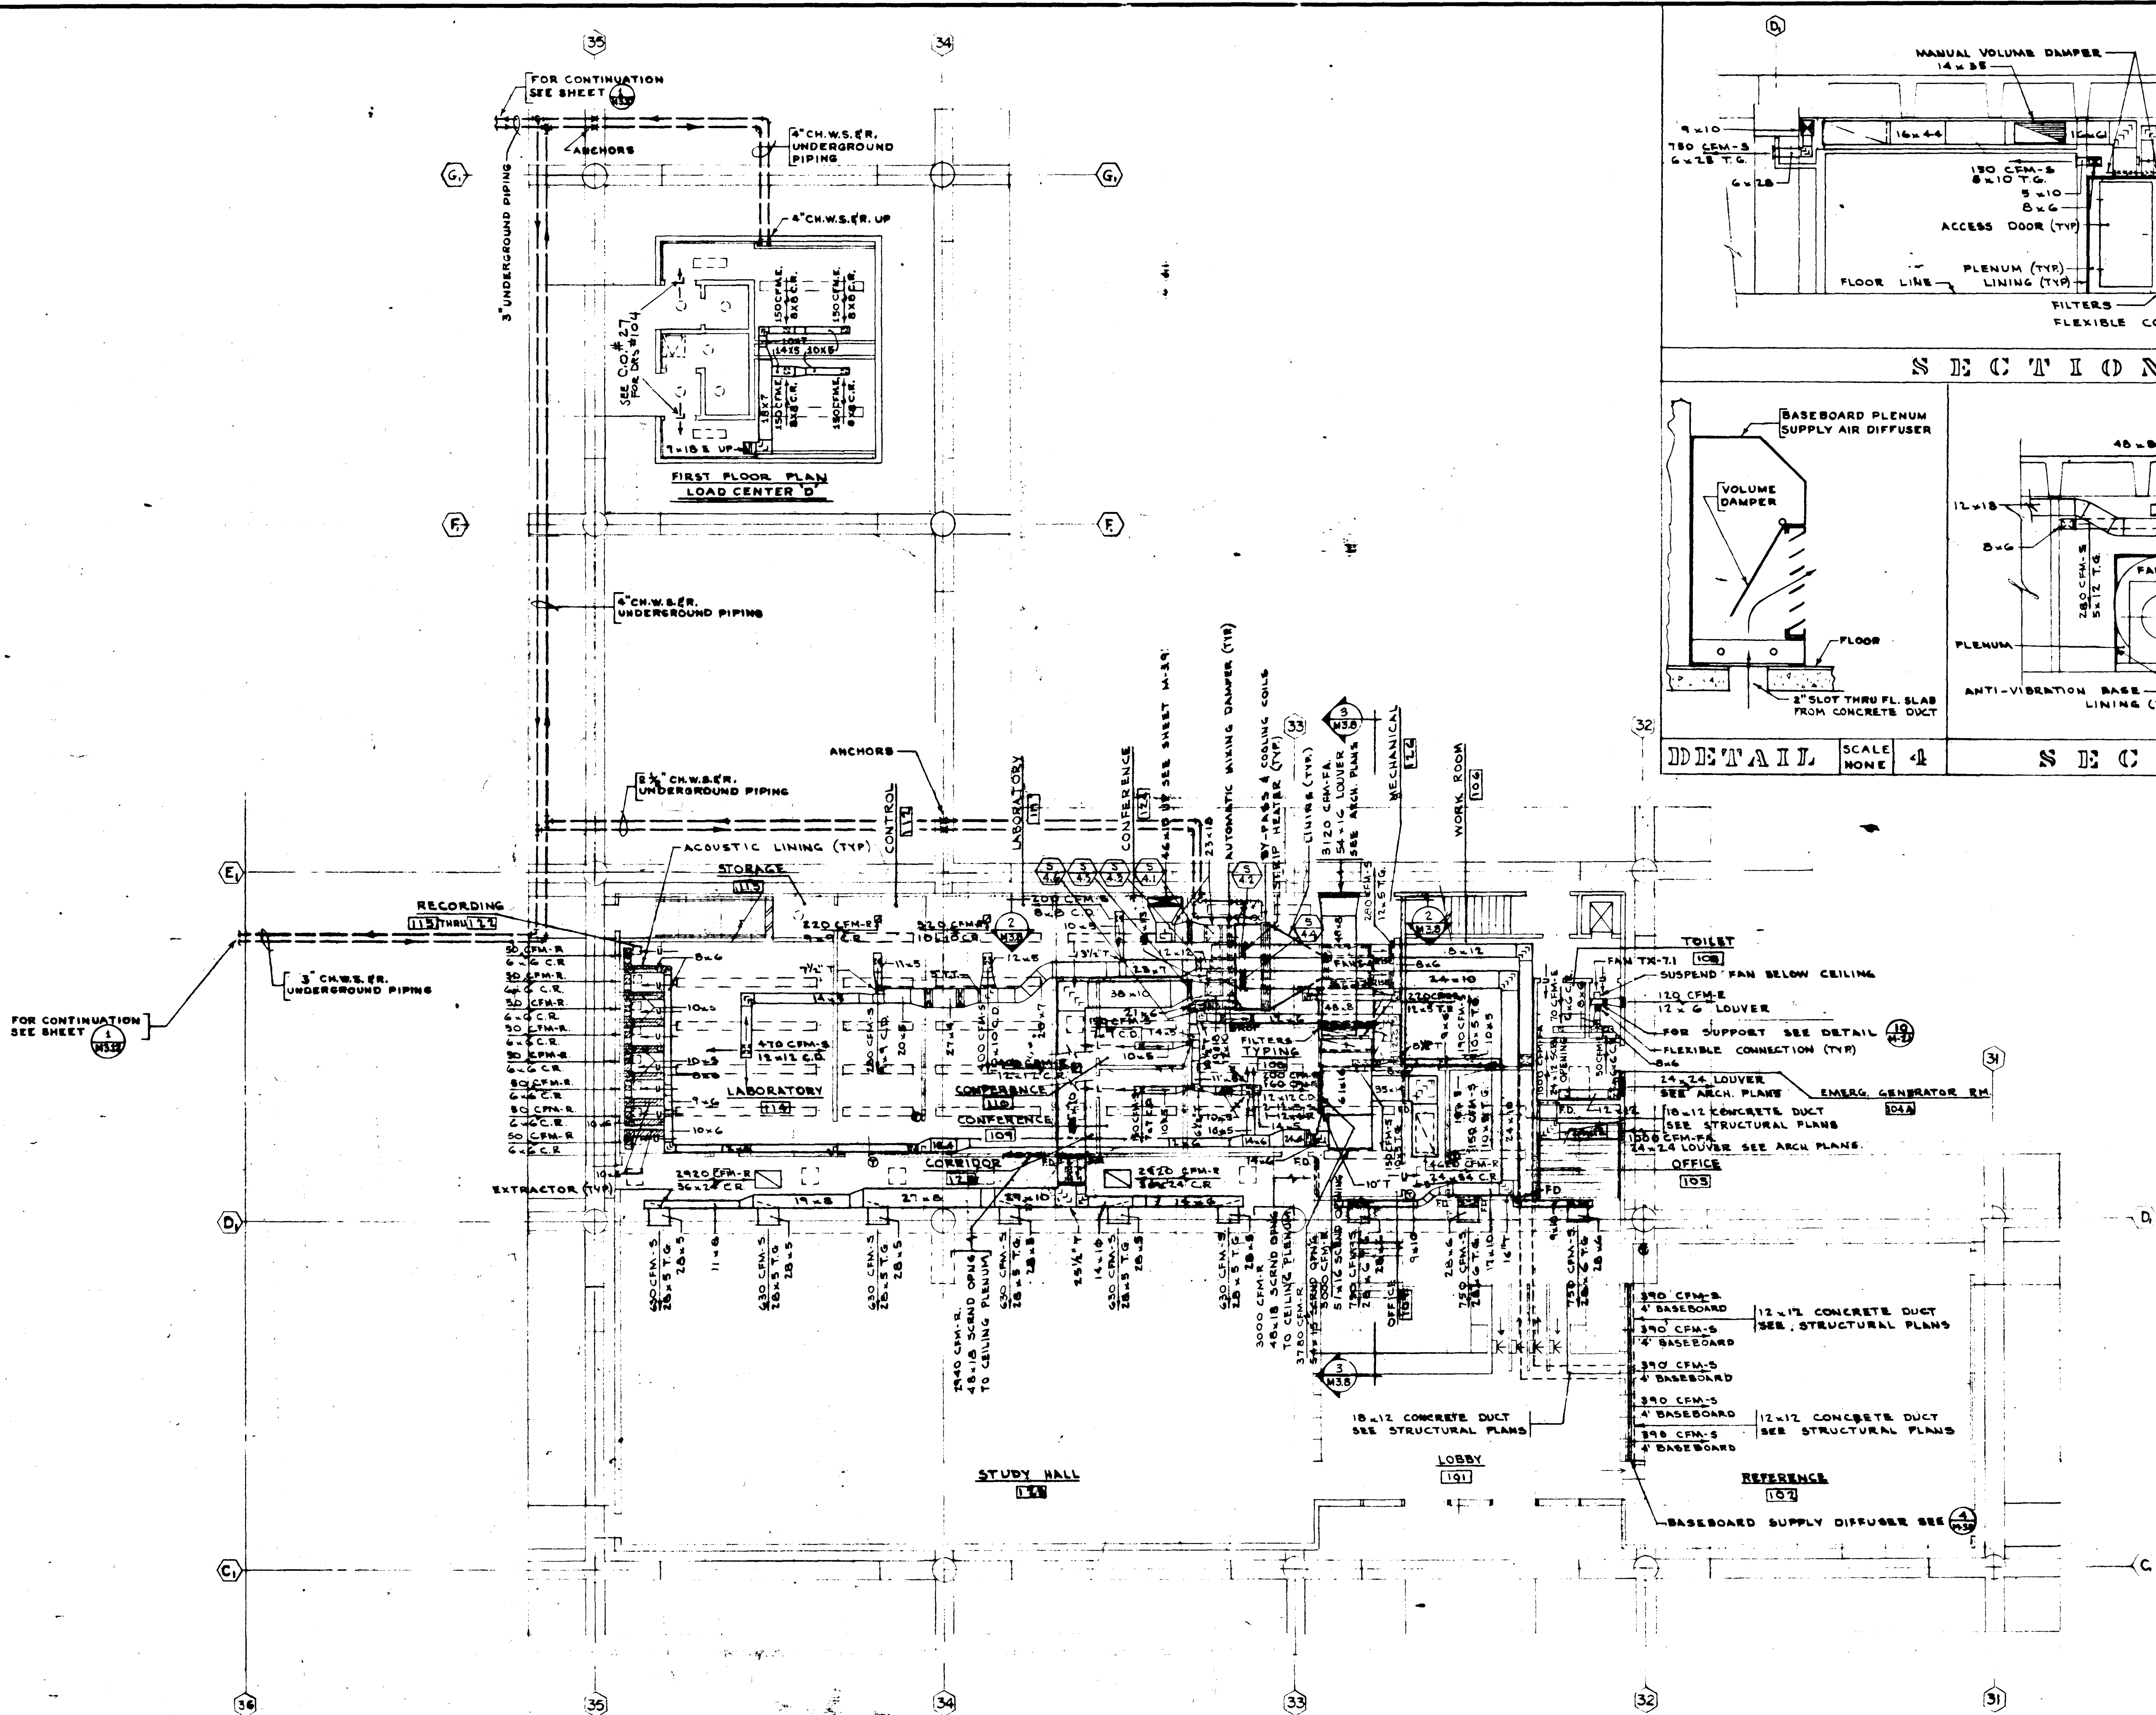

SECTION SCALE 1/4" 3

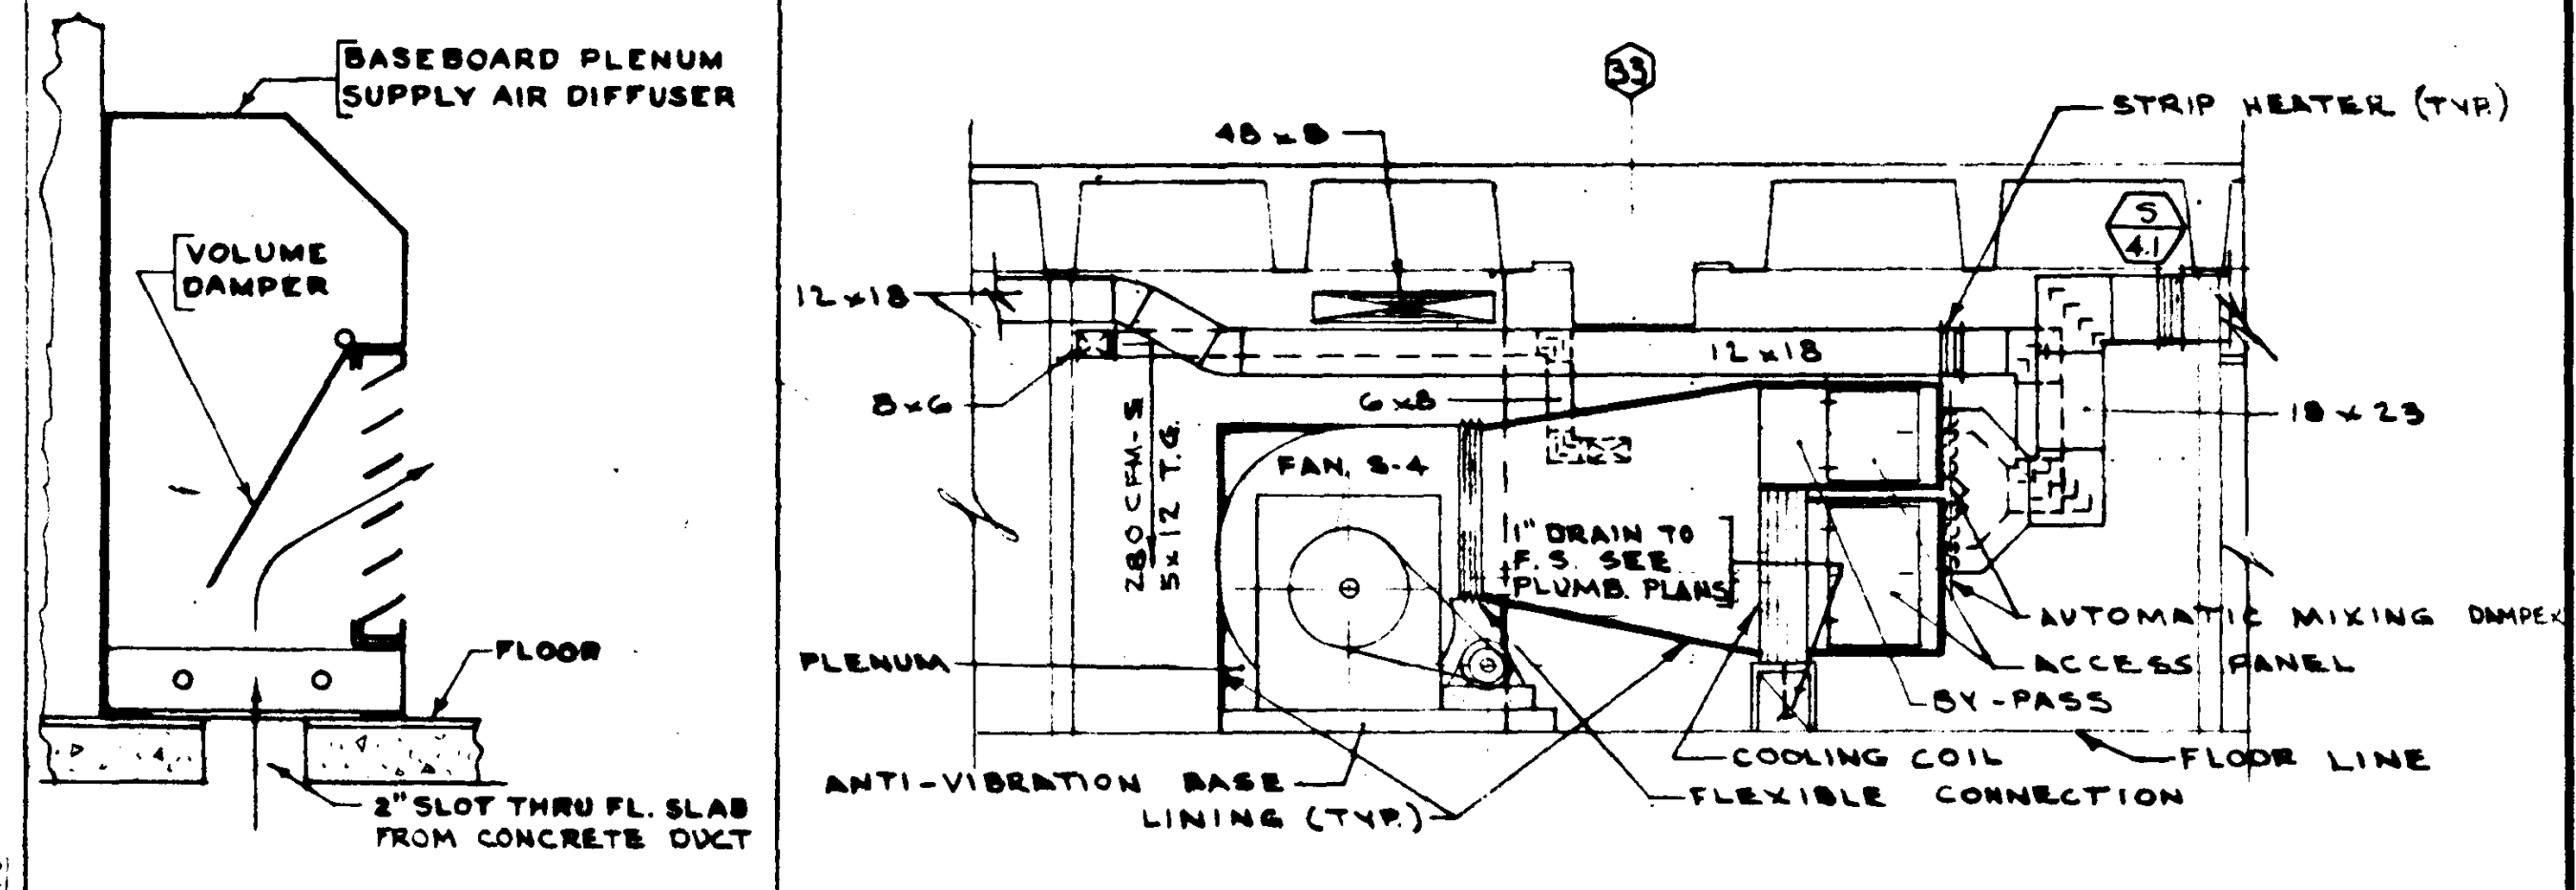


DETAIL SCALE NONE 4 SECTION SCALE 1/4" 2

SEE C.O. #27 FOR DOOR # 115

FIRST FLOOR SCALE 1/8" 1

<div>REVISIONS</div>	<div>STRUCTURAL ENGINEERS BRADY & JOHNSTON J.A. MARTIN & ASSOCIATES</div> <div>MECHANICAL ENGINEERS RALPH E. PHILLIPS, INC.</div> <div>ELECTRICAL ENGINEERS RALPH E. PHILLIPS, INC.</div> <div>CIVIL ENGINEERS G. SHURMAN & ASSOCIATES MOFFATT & MICOL</div>	<div>DESIGNED L.H.N.</div> <div>DRAWN BY R.W.</div> <div>CHECKED BY W.C.L.</div>	<div>ARCHITECT WILLIAM L. PEREIRA & ASSOCIATES</div> <div>APPROVED STATE FIRE MARSHAL STATE OF CALIFORNIA DATE: 6-15-66</div>	<div>ASSOCIATED ARCHITECTS: WILLIAM L. PEREIRA & ASSOCIATES A. QUINCY JONES-FREDERICK E. EMMONS & ASSOCIATES BLUROCK ELLERBROCK & ASSOCIATES</div> <div>URBANUS SQUARE • MACARTHUR BOULEVARD AT FORD ROAD TELEPHONE 714/675-2640 • CORONA DEL MAR, CALIFORNIA</div>	<div>GOLDEN WEST COLLEGE HUNTINGTON BEACH, CALIFORNIA ORANGE COAST JUNIOR COLLEGE DISTRICT</div>	<div>UNIT 7 FLOOR PLAN</div> <div>DATE 6-15-66 SHEET NO. N1 363</div>
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SECOND FLOOR										SCALE 1/8" = 1'	1
UNIT 7										DATE 6-15-65	100-A
FLOOR										SHEET NO.	134
PLAN											

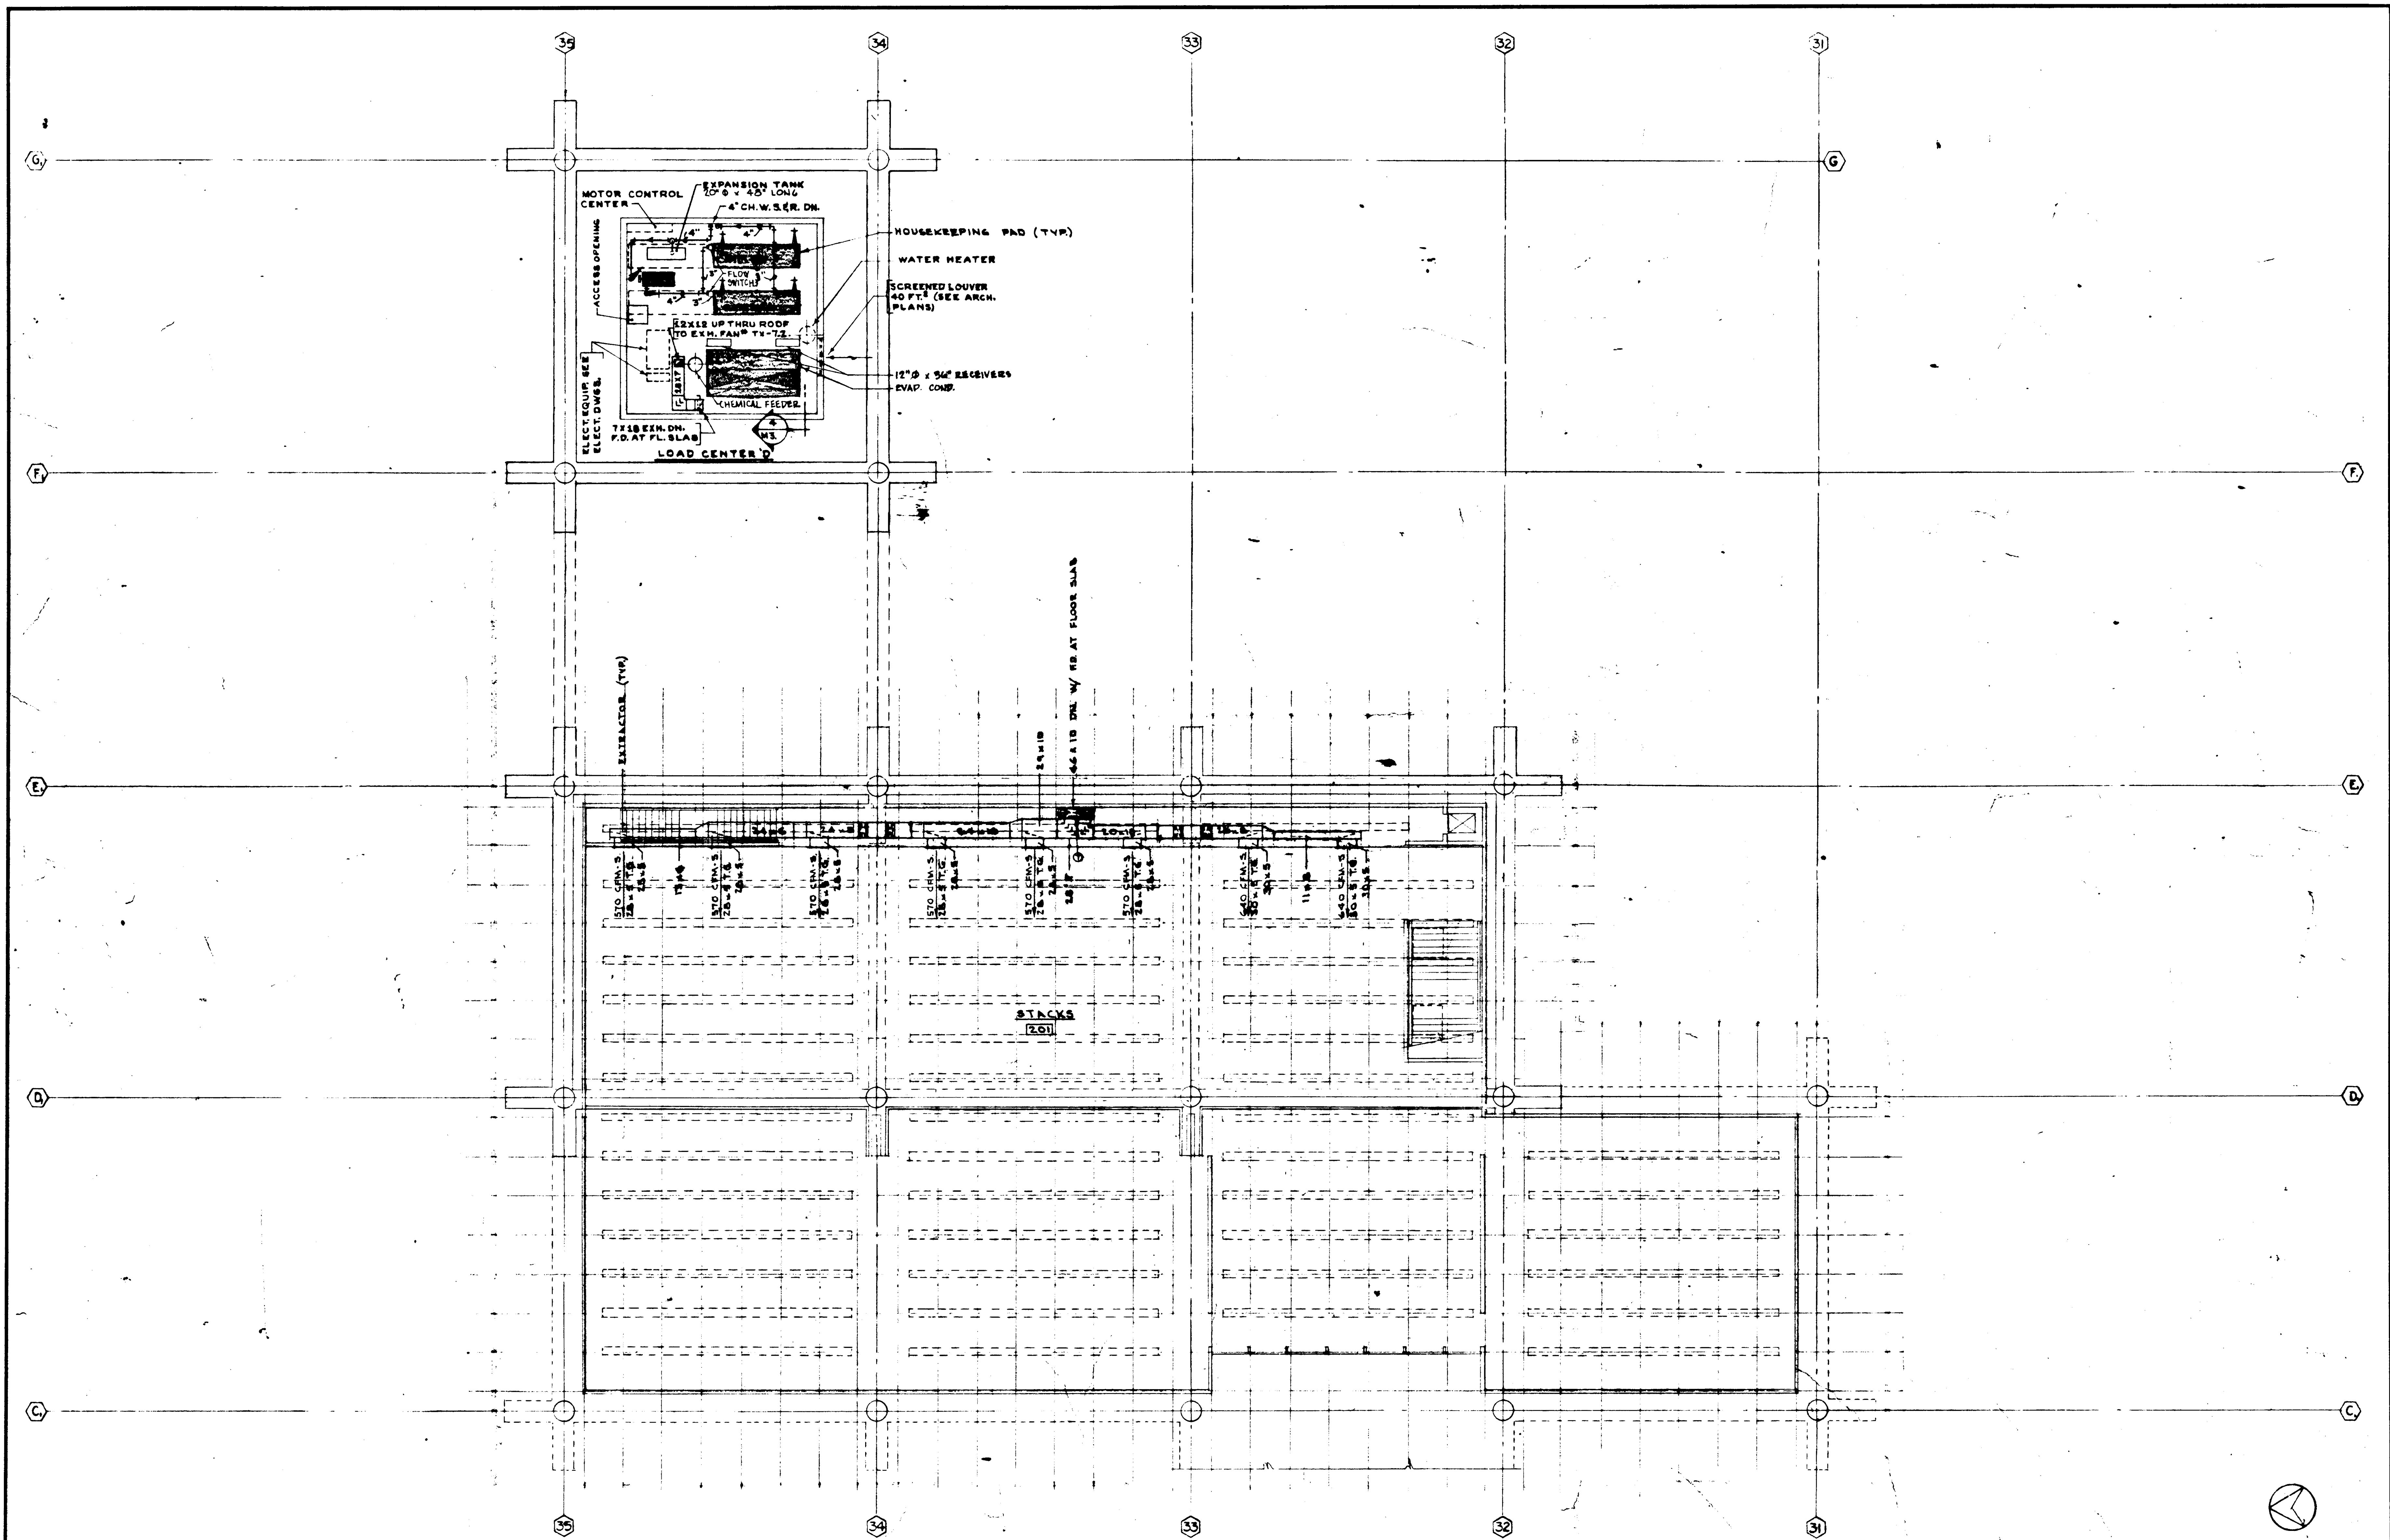
STRUCTURAL ENGINEERS BLANDOW & JOHNSTON J.A. MARTIN & ASSOCIATES	DESIGNED L.H.W.	ARCHITECT WILLIAM L. PEREIRA	APPROVED STATE OF CALIFORNIA - DEPARTMENT OF GENERAL SERVICES OFFICE OF ARCHITECTURE AND CONSTRUCTION
MECHANICAL ENGINEERS RALPH E. PHILLIPS, INC.	DRAWN BY R.W.	CHECKED BY W.C.L.	APPROVED JUN 21 1965
ELECTRICAL ENGINEERS RALPH E. PHILLIPS, INC.			
CIVIL ENGINEERS G. SHUIMAN & ASSOCIATES MOFFATT & WICKOL			

APPROVED STATE OF CALIFORNIA - DEPARTMENT OF GENERAL SERVICES OFFICE OF ARCHITECTURE AND CONSTRUCTION	APPROVED JUN 21 1965
APPROVED STATE OF CALIFORNIA - DEPARTMENT OF GENERAL SERVICES OFFICE OF ARCHITECTURE AND CONSTRUCTION	


ASSOCIATED ARCHITECTS: WILLIAM L. PEREIRA & ASSOCIATES A. QUINCY JONES - FREDERICK E. EMMONS & ASSOCIATES BLUROCK ELLERBROCK & ASSOCIATES	URBANUS SQUARE • MACARTHUR BOULEVARD AT FORD ROAD TELEPHONE 714/675-2640 • CORONA DEL MAR, CALIFORNIA
--	--

GOLDEN WEST COLLEGE HUNTINGTON BEACH, CALIFORNIA ORANGE COAST JUNIOR COLLEGE DISTRICT
--

UNIT 7	SCALE 1/8" = 1'
FLOOR	DATE 6-15-65
PLAN	SHEET NO. 134

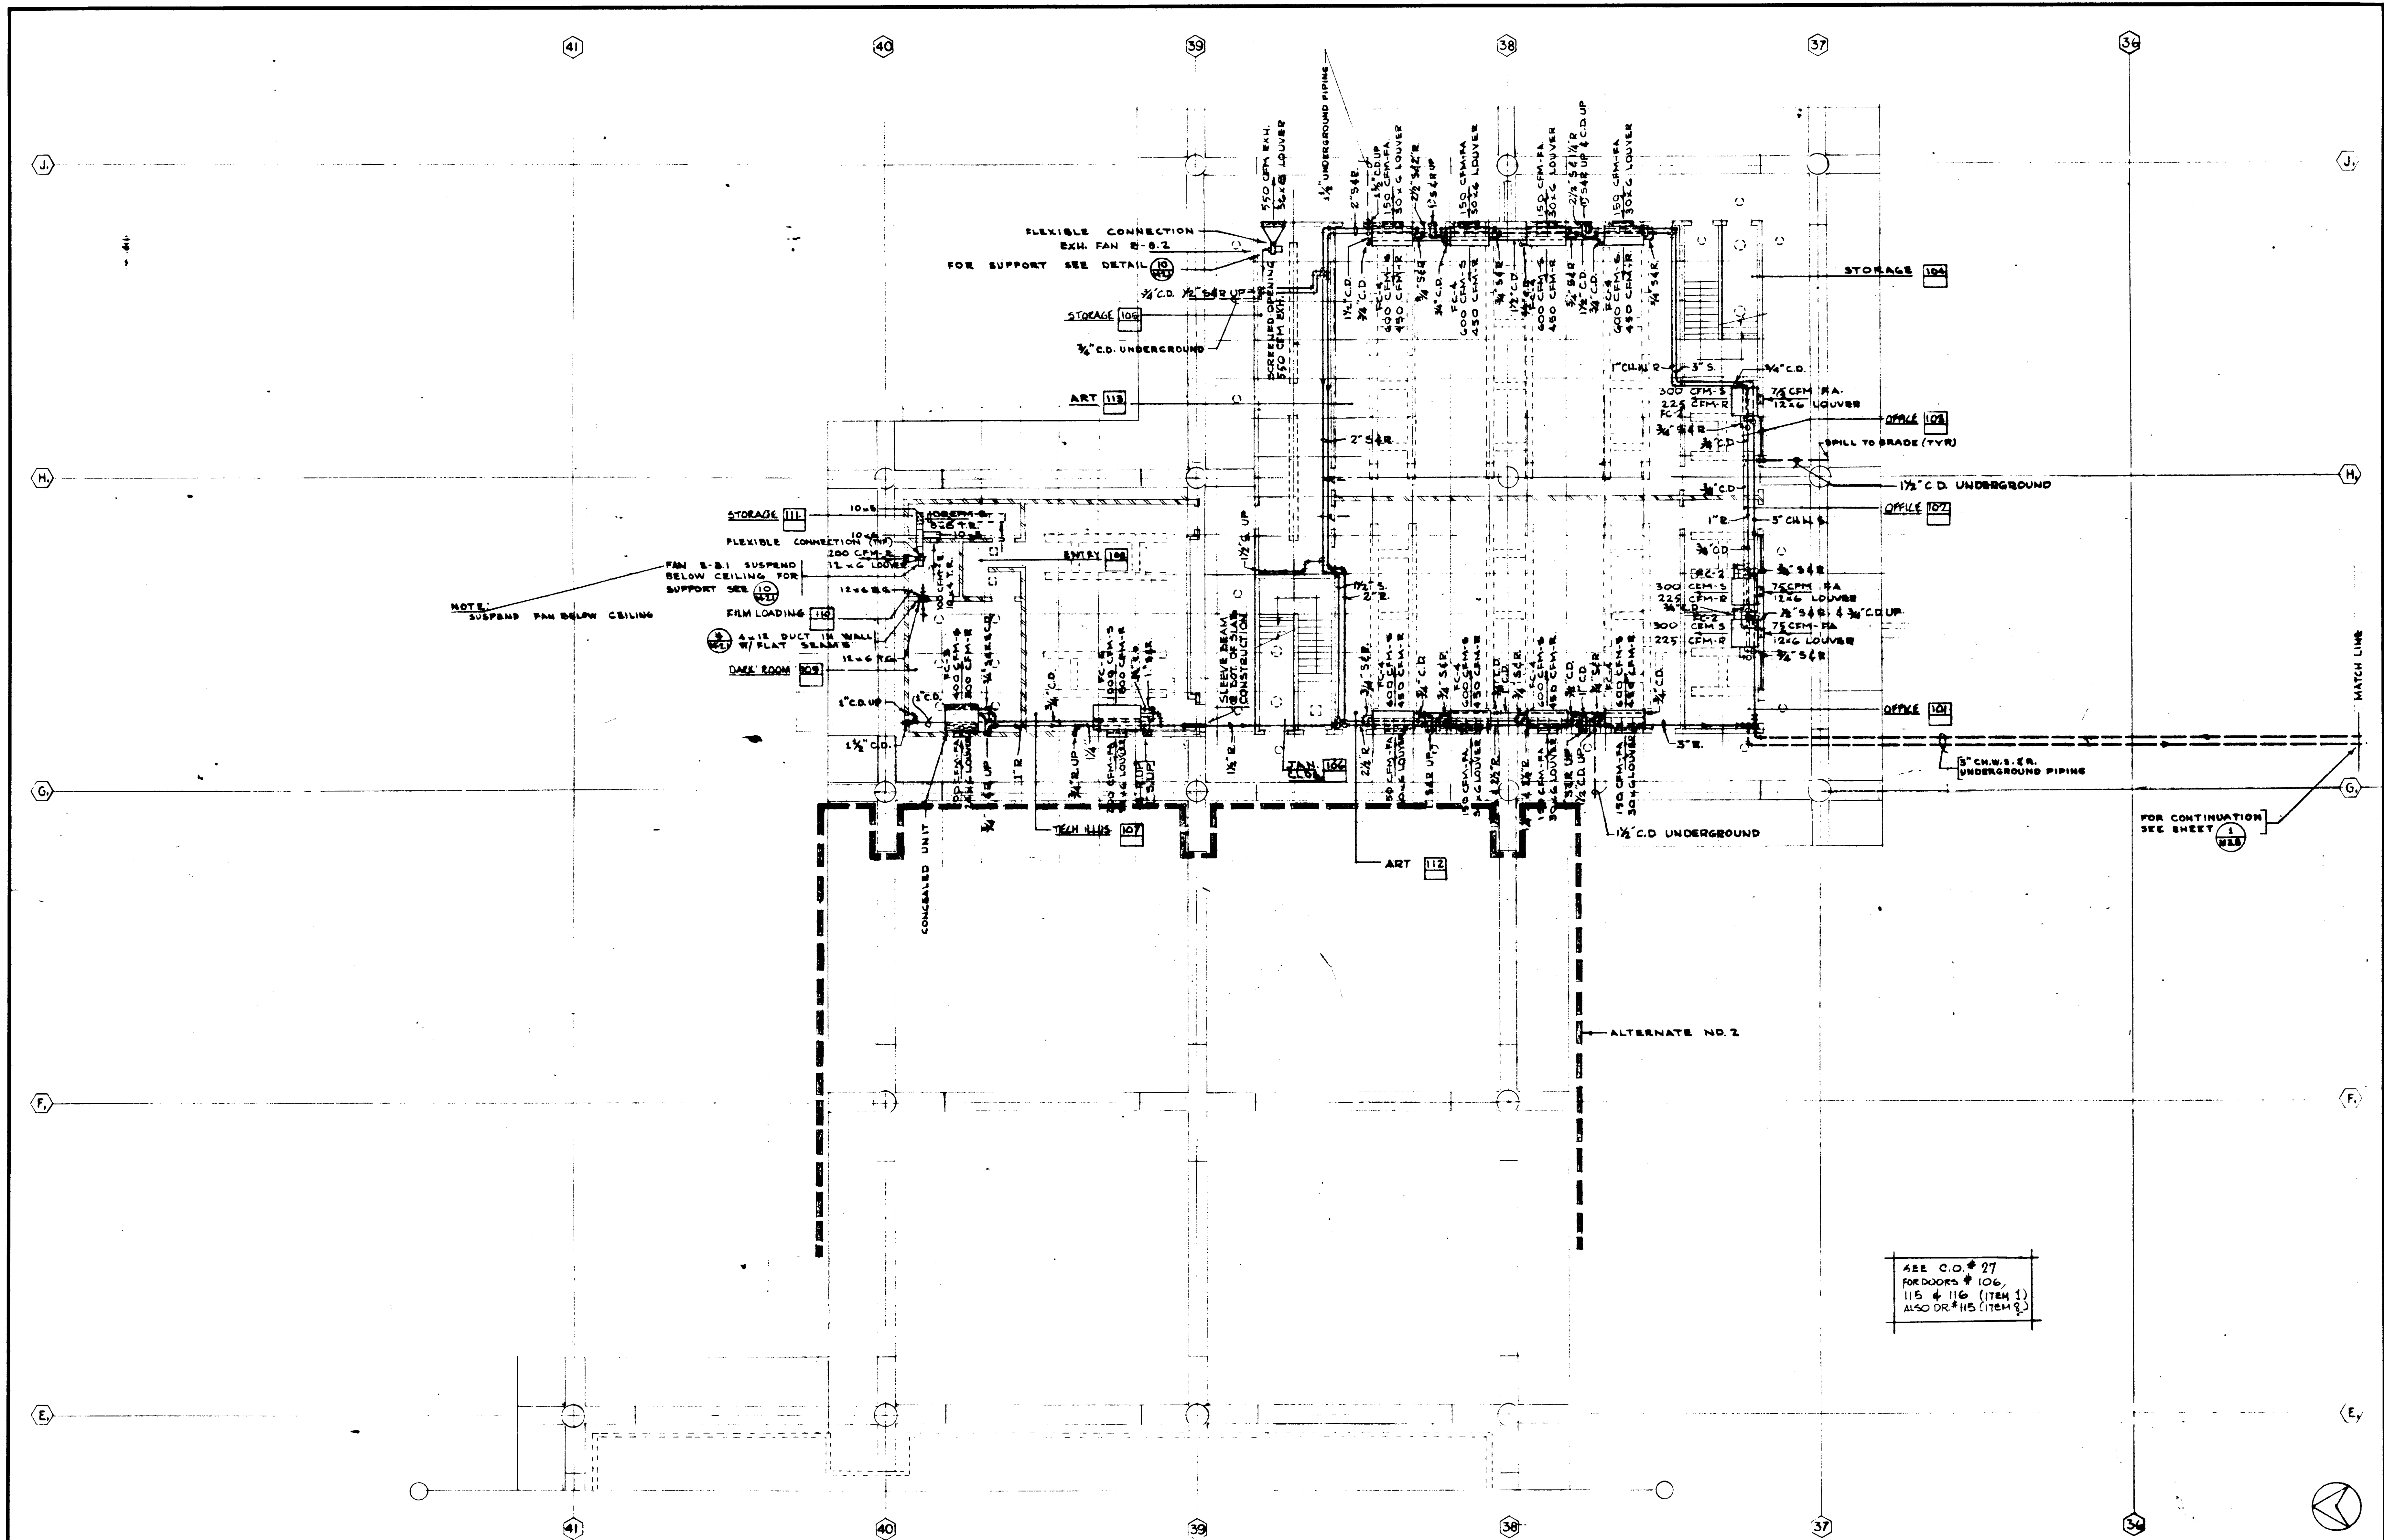

STRUCTURAL ENGINEERS BRANTON & JOHNSON J.A. MARTIN & ASSOCIATES MEDICAL ENGINEERS RALPH E. PHILLIPS, INC. ELECTRICAL ENGINEERS RALPH E. PHILLIPS, INC. CIVIL ENGINEERS G. SHURMAN & ASSOCIATES BOYFATT & NICHOL		DESIGNED L.H.W. DRAWN BY R.W. CHECKED BY W.C.L.	ARCHITECT WILLIAM L. PEREIRA COLLEGE	APPROVED STATE FIRE MARSHAL STATE OF CALIFORNIA DATE: JUN 21 1965	ASSOCIATED ARCHITECTS: WILLIAM L. PEREIRA & ASSOCIATES A. QUINCY JONES-FREDERICK & EMMONS & ASSOCIATES BLUMROCK HILSBROOK & ASSOCIATES URBANUS SQUARE • MACARTHUR BOULEVARD AT FORD ROAD TELEPHONE 714/875-2640 • CORONA DEL MAR, CALIFORNIA	GOLDEN WEST COLLEGE HUNTINGTON BEACH, CALIFORNIA ORANGE COAST JUNIOR COLLEGE DISTRICT	FIRST FLOOR UNIT 3a FLOOR PLAN	SCALE 1/8" = 1' JOB NO. RD-1 DATE 6-16-65 SHEET NO. N 3.11
--	--	--	--	--	---	--	---	---

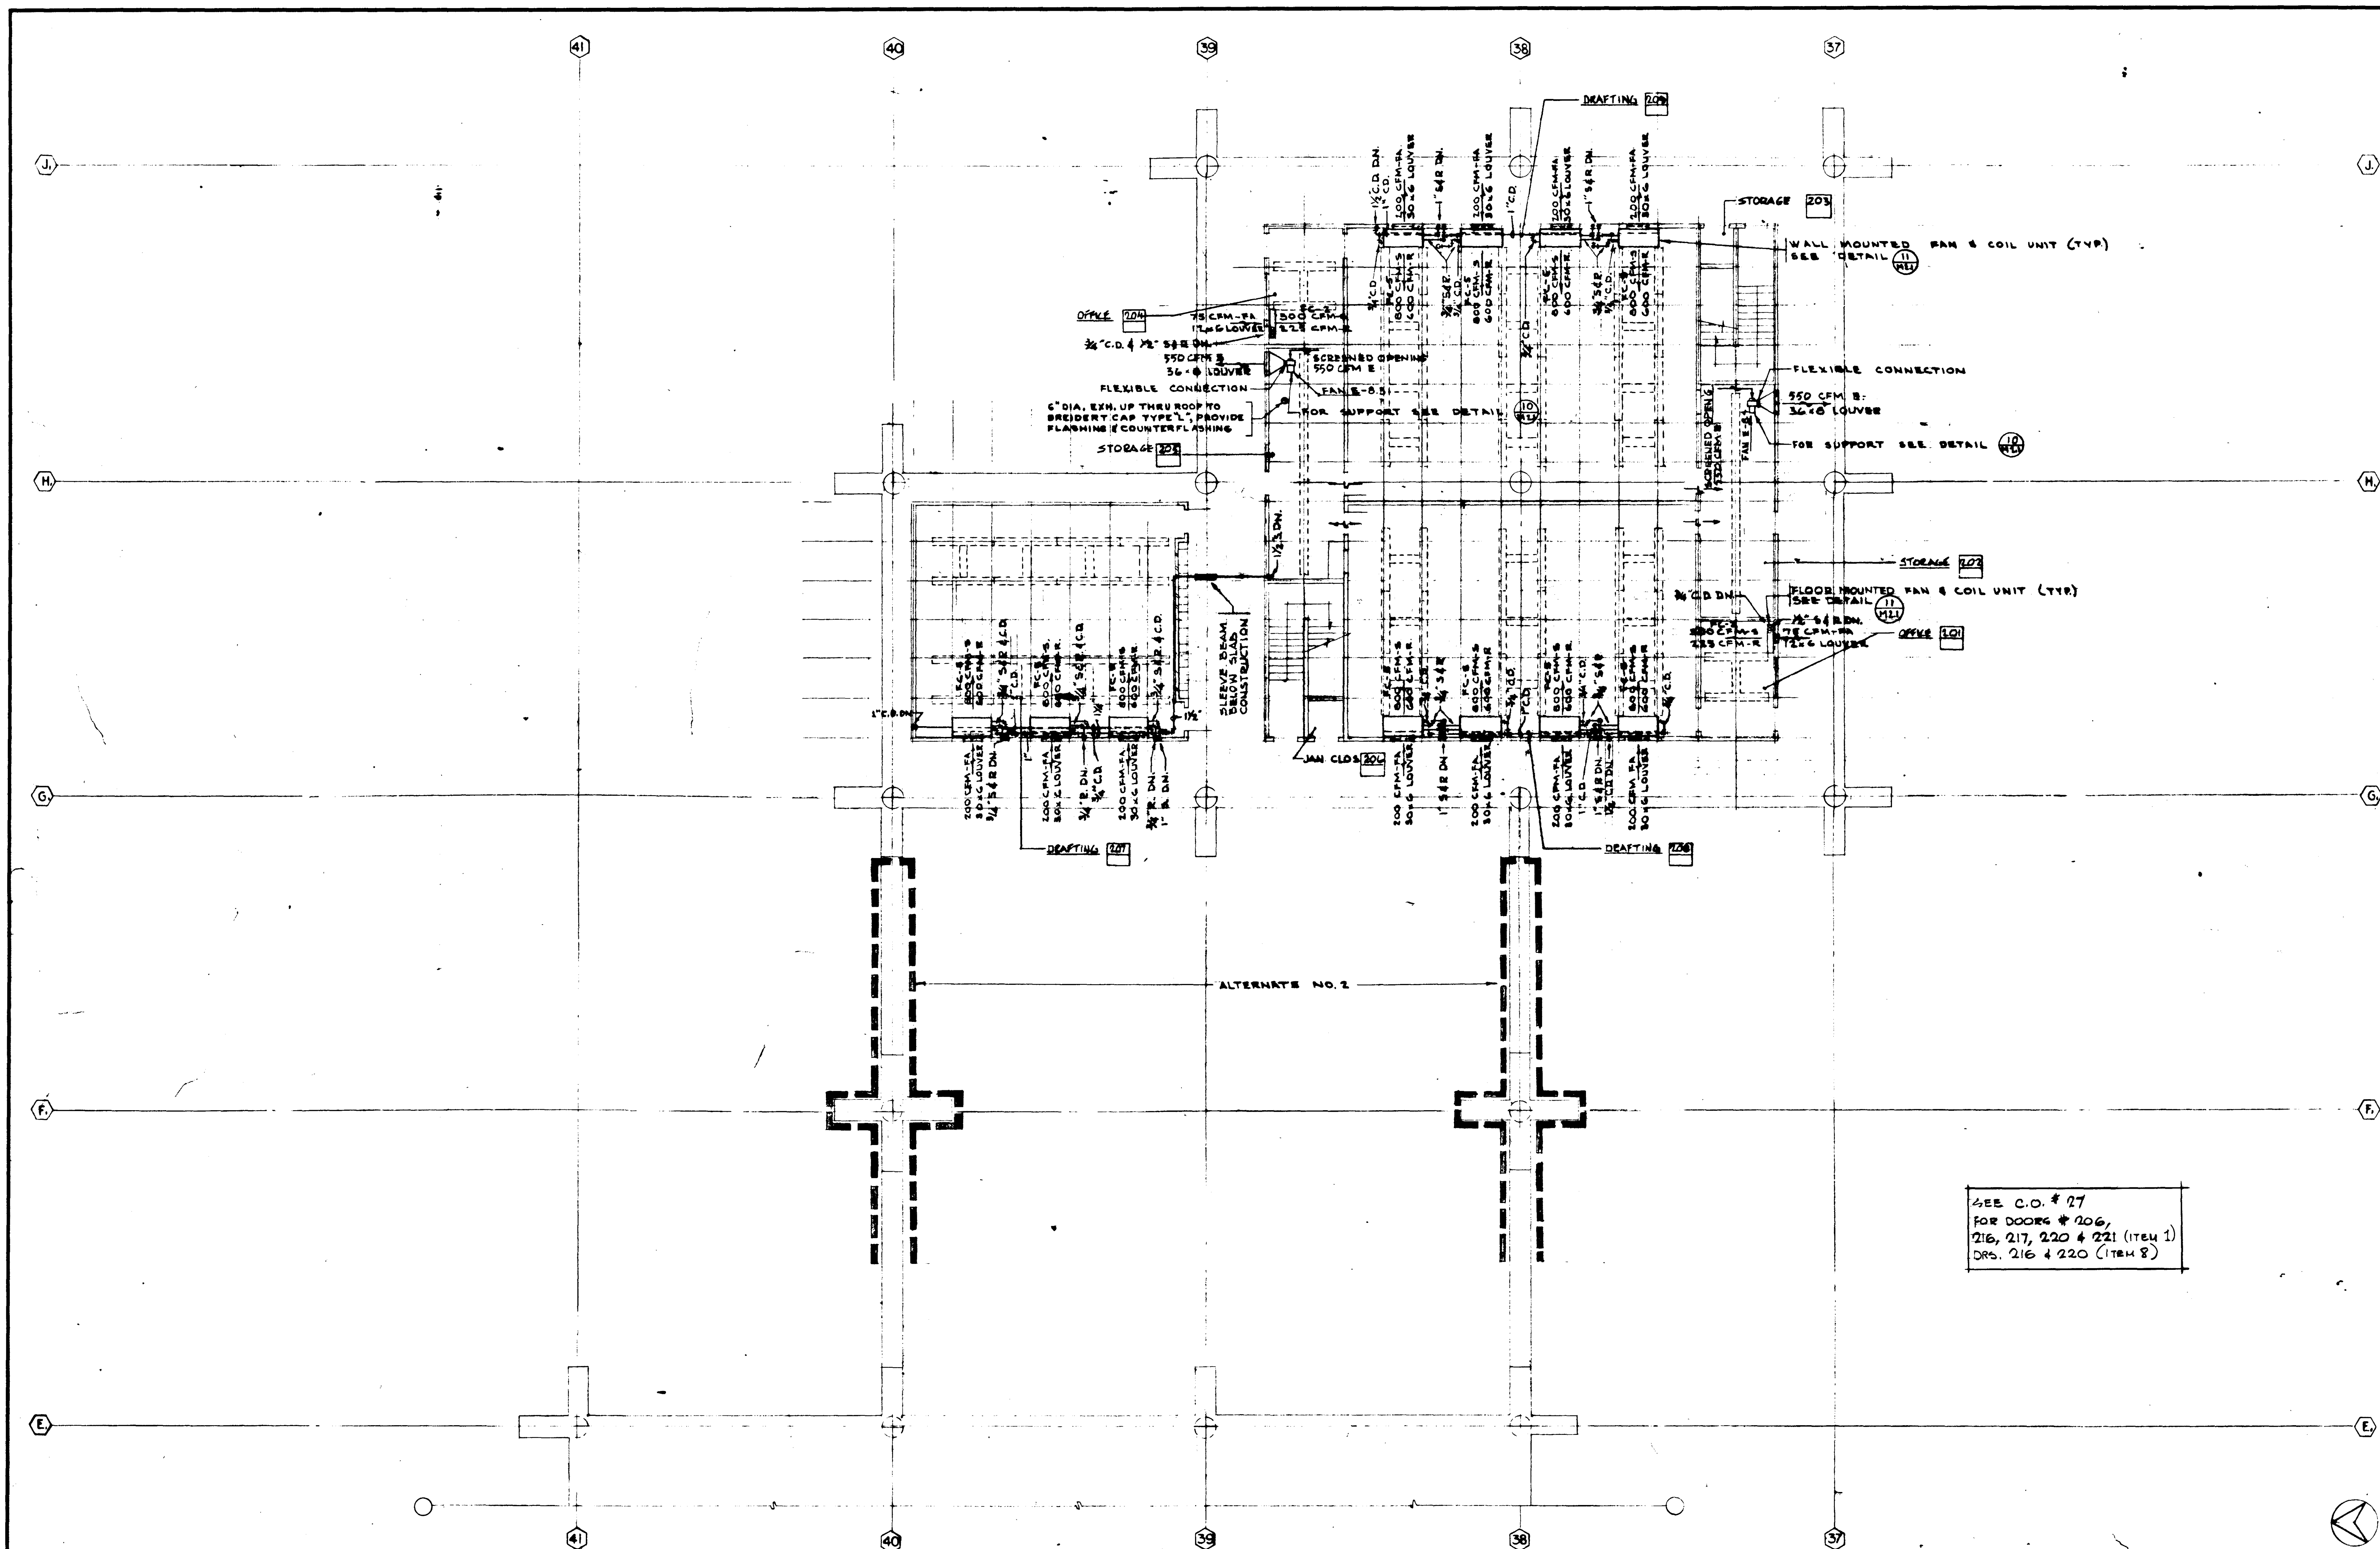

SEE C.O. # 27
FOR DOORS # 206,
216, 217, 220 & 221 (ITEM 1)
DRS. 216 & 220 (ITEM 8)

S E C O N D F L O O R										SCALE 1/8" = 1'	1
UNIT 8a										JOB NO. 104	
F L O O R										DATE 6-16-65	
P L A N										SHEET NO. 311	
<div>STRUCTURAL ENGINEERS BLANDOW & JOHNSON J.A. MARTIN & ASSOCIATES</div> <div>DESIGNED L.H.W.</div> <div>MECHANICAL ENGINEERS RALPH E. PHILLIPS, INC.</div> <div>ELECTRICAL ENGINEERS RALPH E. PHILLIPS, INC.</div> <div>CIVIL ENGINEERS O. STUTTMAN & ASSOCIATES MOFFATT & HIGDON</div> <div>ARCHITECT WILLIAM L. PEREIRA & ASSOCIATES SKR 74 APPROVED JUN 21 1965</div> <div>APPROVED STATE FIRE MARSHAL STATE OF CALIFORNIA JUN 21 1965</div> <div>ASSOCIATED ARCHITECTS: WILLIAM L. PEREIRA & ASSOCIATES A. QUINCY JONES, FREDERICK E. EDMONDS & ASSOCIATES BLUROCK ELLERBROCK & ASSOCIATES URBANE'S SQUARE • MACARTHUR BOULEVARD AT FORD ROAD TELEPHONE 714/678-2640 • CORONA DEL MAR, CALIFORNIA</div> <div>GOLDEN WEST COLLEGE HUNTINGTON BEACH, CALIFORNIA ORANGE COAST JUNIOR COLLEGE DISTRICT</div>											

ELECTRICAL ENGINEER

RALPH E. PHILLIPS, INC.

CHECKED BY

W.C.L.

ARCHITECT

WILLIAM L. PEREIRA & ASSOCIATES

APPROVED

SKR 74

APPROVED JUN 21 1965

CIVIL ENGINEER

G. SHUTMAN & ASSOCIATES

CHECKED BY

MOFFATT & HIGGINS


ARCHITECT

WILLIAM L. PEREIRA & ASSOCIATES

APPROVED

SKR 74



APPROVED JUN 21 1965

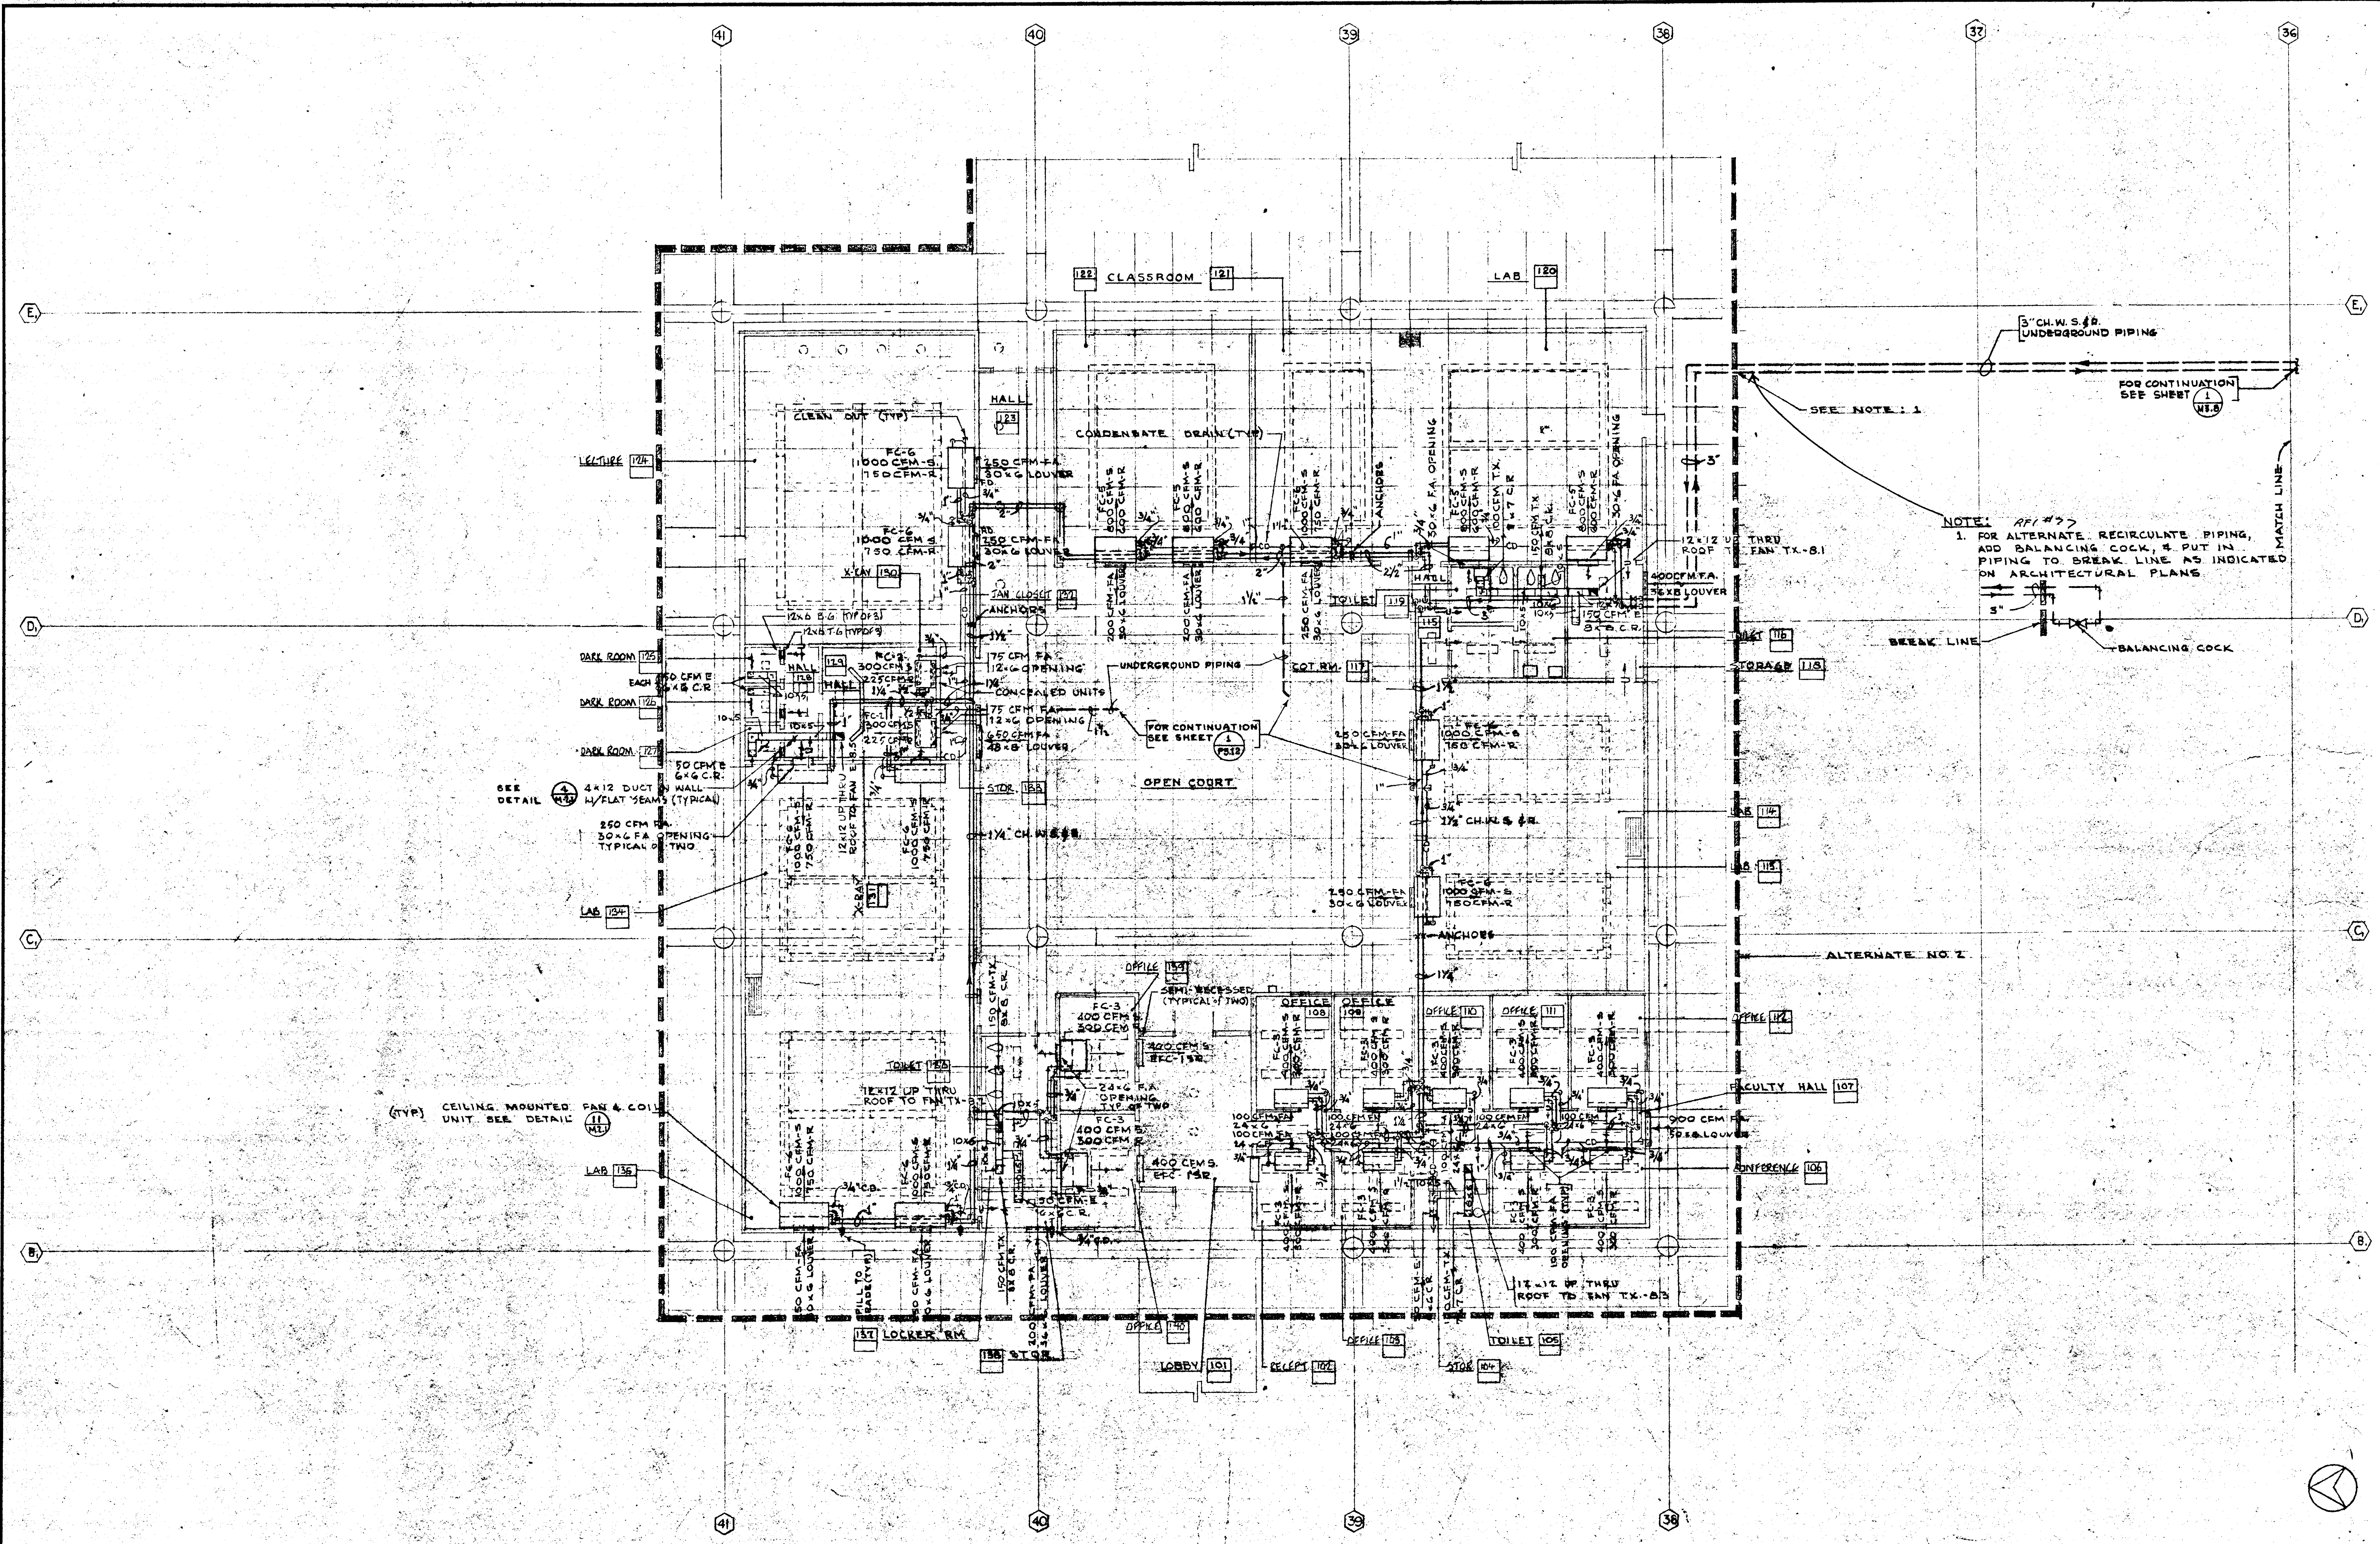

FIRST FLOOR

SCALE 1/8" = 1'

		STRUCTURAL ENGINEERS BRANDOW & JOHNSON J.A. MARTIN & ASSOCIATES		DESIGNED L.H.V.		ARCHITECT WILLIAM L. PEREIRA		APPROVED JUN 21 1965		ASSOCIATED ARCHITECTS: WILLIAM L. PEREIRA & ASSOCIATES A. QUINCY JONES-FREDERICK E. EMMONS & ASSOCIATES BLUROCK ELLERBROEK & ASSOCIATES		GOLDEN WEST COLLEGE HUNTINGTON BEACH, CALIFORNIA ORANGE COAST JUNIOR COLLEGE DISTRICT		UNIT 8b		JOB NO. 104	
		MECHANICAL ENGINEERS RALPH E. PHILLIPS, INC.		DRAWN BY R.W.		ENGINEER A. QUINCY JONES		APPROVED JUN 21 1965						DATE 6-15-65		SHEET NO.	
		ELECTRICAL ENGINEERS RALPH E. PHILLIPS, INC.		CHECKED BY W.C.L.		COLLEGE		TE PHILIP CARROLL TE OF CALIFORNIA JUN 21 1965		URBANUS SQUARE • MACARTHUR BOULEVARD AT FORD ROAD TELEPHONE 714/675-2640 • CORONA DEL MAR, CALIFORNIA				FLOOR PLAN		NE 314	
		CIVIL ENGINEERS G. SHURMAN & ASSOCIATES MOFFATT & NICOL															
DATE DRAWN		REVISIONS															

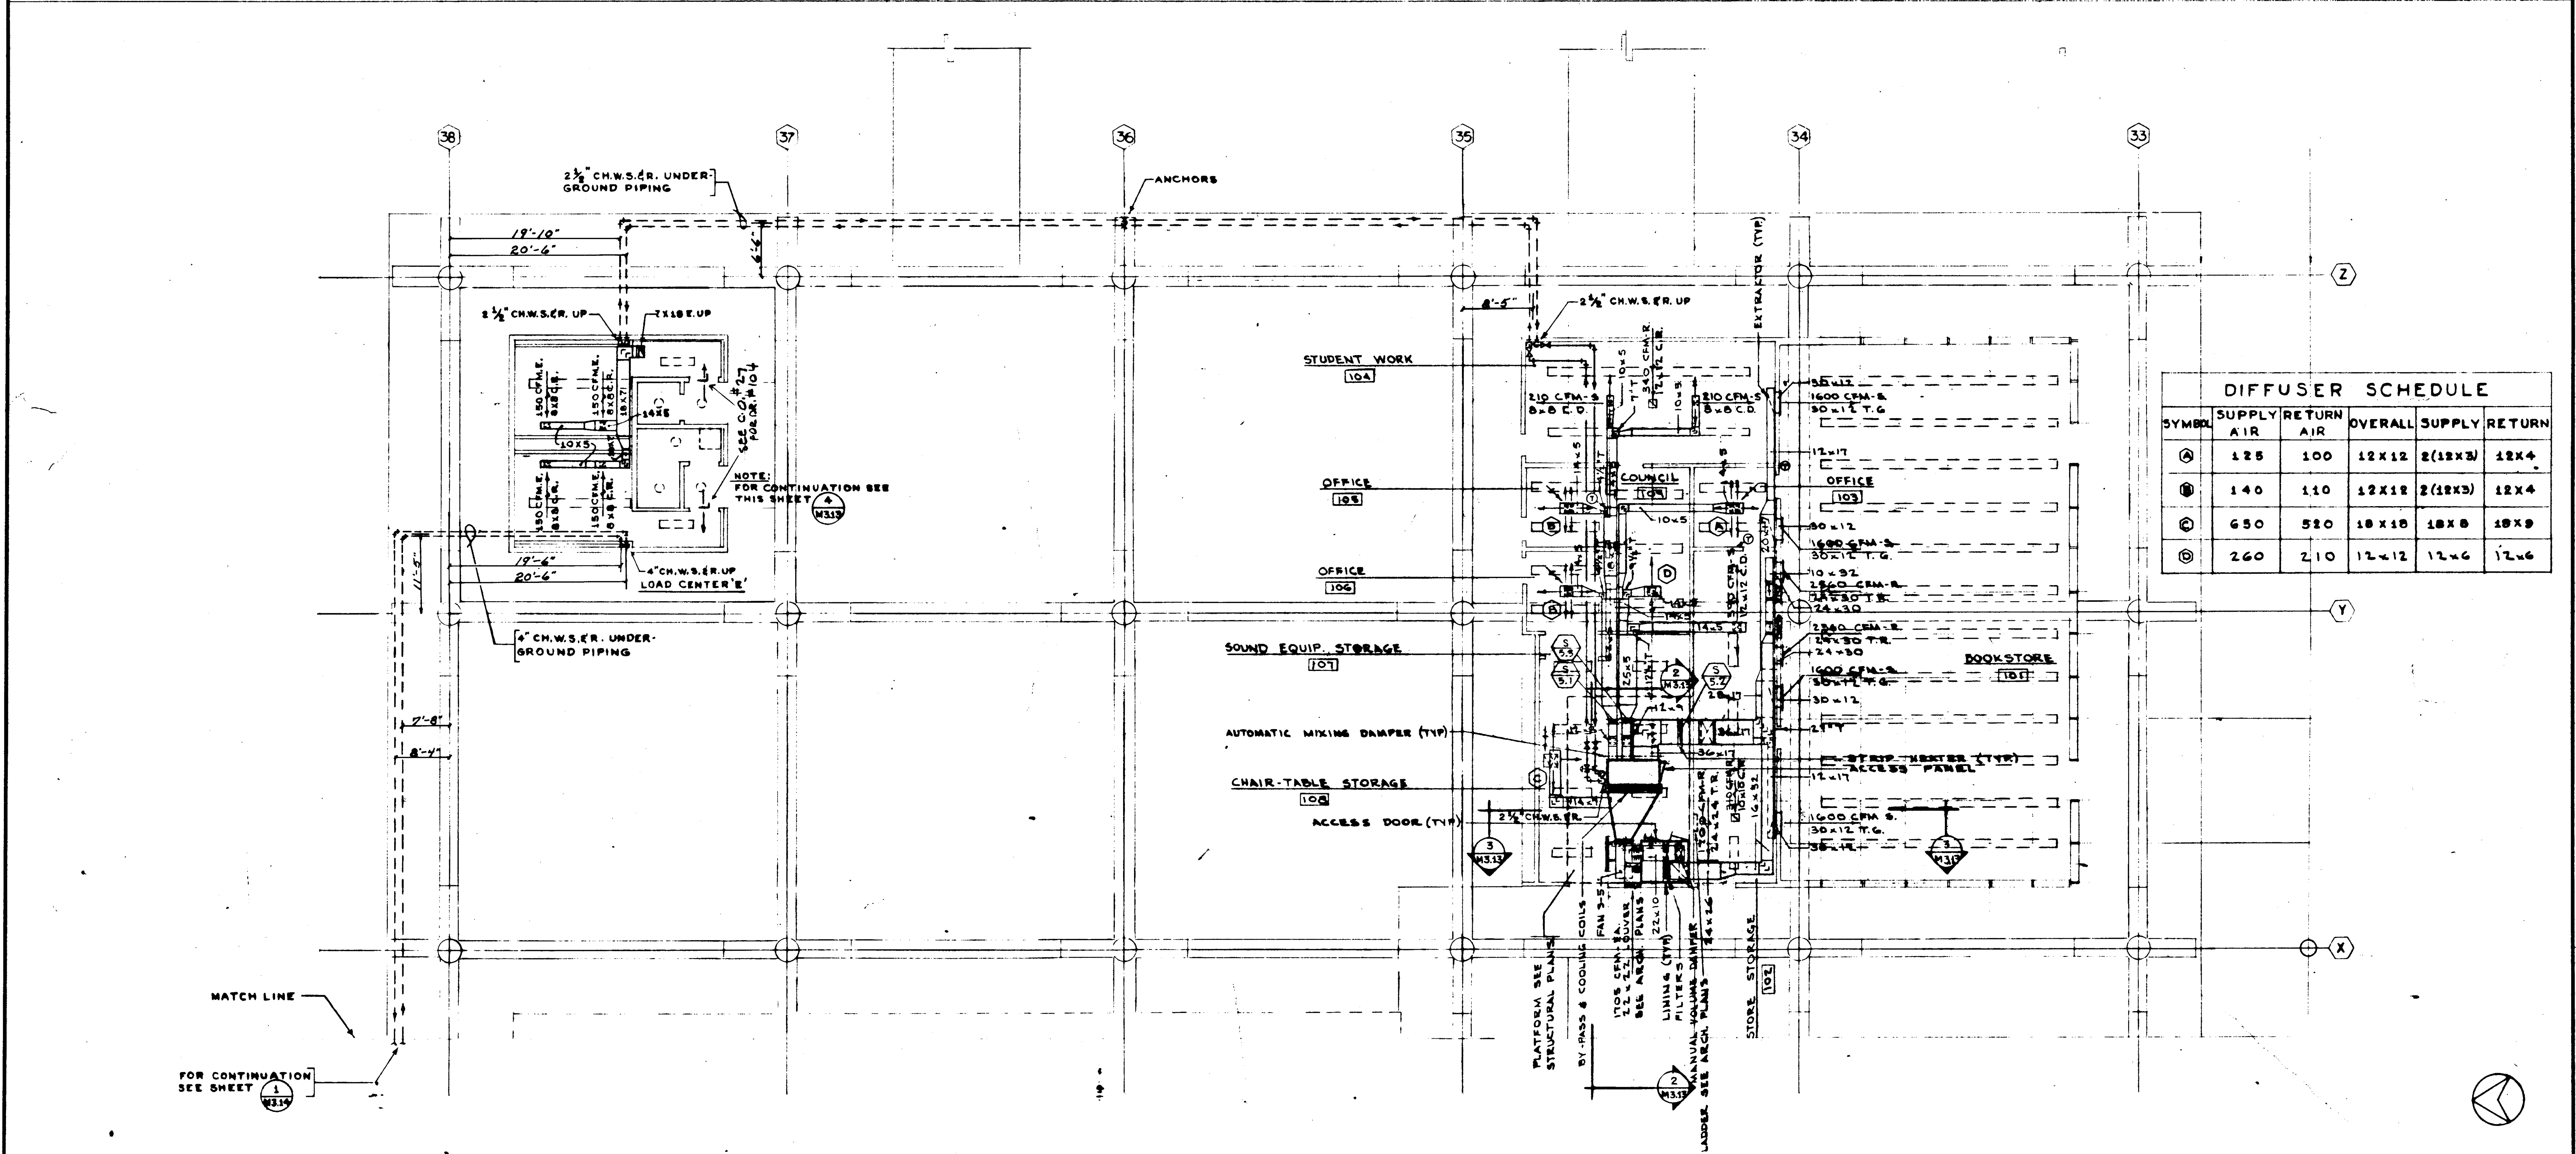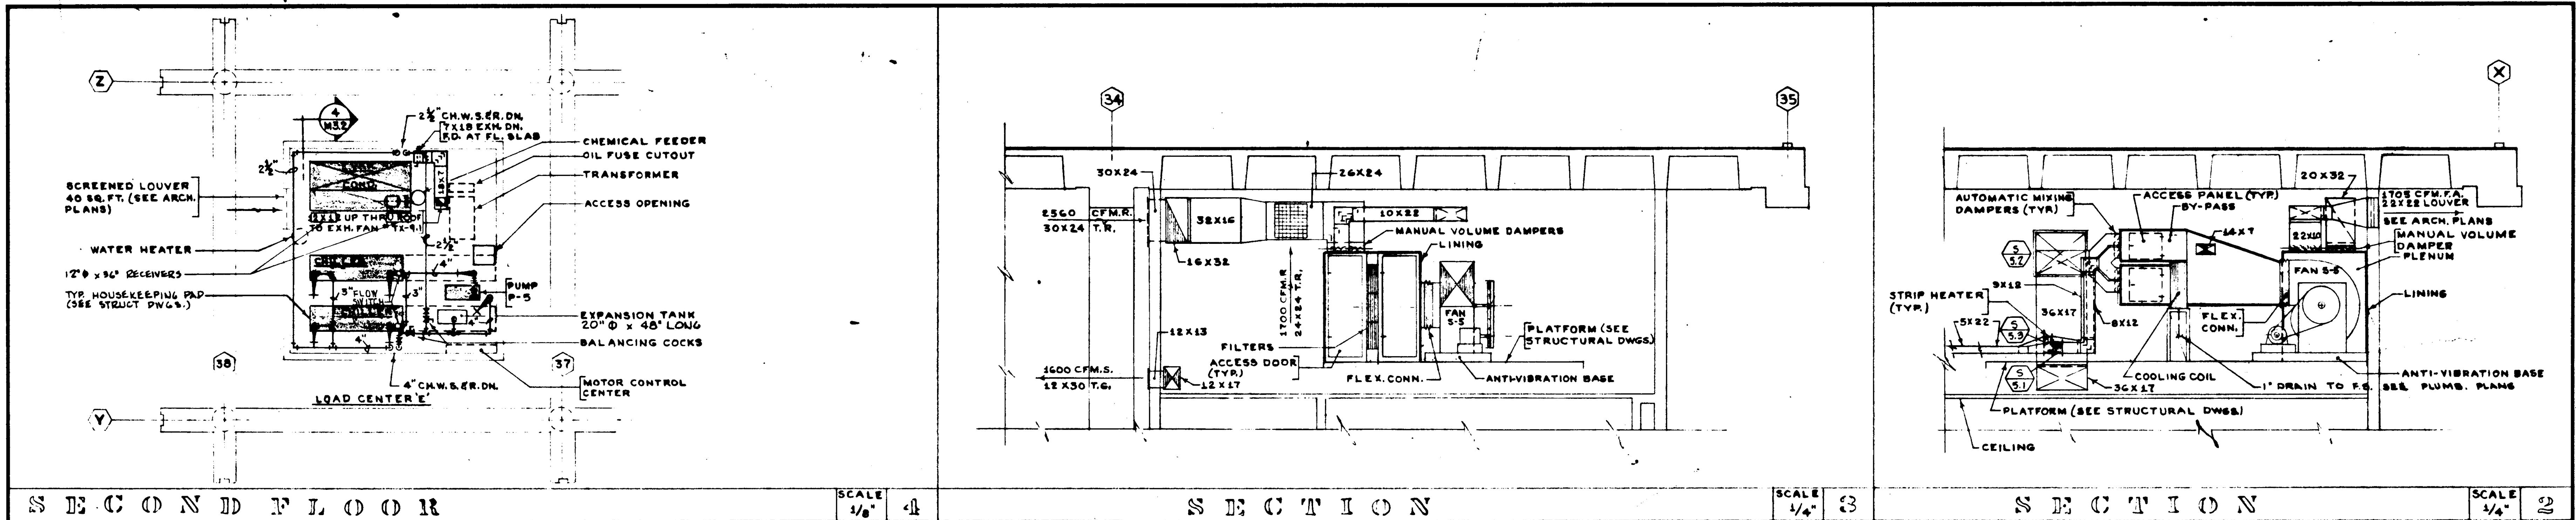

DIFFUSER SCHEDULE					
SYMBOL	SUPPLY AIR	RETURN AIR	OVERALL	SUPPLY	RETURN
①	128	100	12X12	2(12X3)	12X4
②	140	110	12X12	2(12X3)	12X4
③	650	520	18X18	18X8	18X8
④	260	210	12X12	12X6	12X6

STRUCTURAL ENGINEERS
BRANDOW & JOHNSON
J.A. MARTIN & ASSOCIATES

MECHANICAL ENGINEERS
RALPH S. PHILLIPS, INC.

ELECTRICAL ENGINEERS
RALPH S. PHILLIPS, INC.

CIVIL ENGINEERS
G. SHURMAN & ASSOCIATES
MOFFATT & NICOL

DESIGNED
L.H.W.

DRAWN BY
R.W.

CHECKED BY
W.C.L.

APPROVED
JUN 21 1966

ASSOCIATED ARCHITECTS:
WILLIAM L. FERRERA & ASSOCIATES
A. QUINCY JONES-FREDERICK E. EMMONS & ASSOCIATES
BLUROCK ELLERBROEK & ASSOCIATES

URBANUS SQUARE • MACARTHUR BOULEVARD AT FORD ROAD
TELEPHONE 714/675-2640 • CORONA DEL MAR, CALIFORNIA

GOLDEN WEST COLLEGE

HUNTINGTON BEACH, CALIFORNIA

ORANGE COAST JUNIOR COLLEGE DISTRICT

UNIT 3a

FLOOR PLAN

SCALE
1/8" = 1'

JOB NO.
104

DATE
6-15-65

SHEET NO.
M3.13

FOR CONTINUATION, SEE SHEET 1 M313


4" CH.W.S. R PIPING UNDERGROUND

MATCH LINE

NOTE: FOR DUCTS IN LOWER PART OF THIS AREA SEE SECTION 37


NOTE: FOR DUCT LAYOUT THIS AREA - REFER TO SUBMITTED SHOP DRAWING AC-1

DIFFUSER SCHEDULE					
SYMBOL	SUPPLY AIR	RETURN AIR	OVERALL	SUPPLY	RETURN
A	860	775	20X20	20X10	20X9
B	625	500	20X20	20X8	20X11
C	510	405	20X20	20X7	20X12

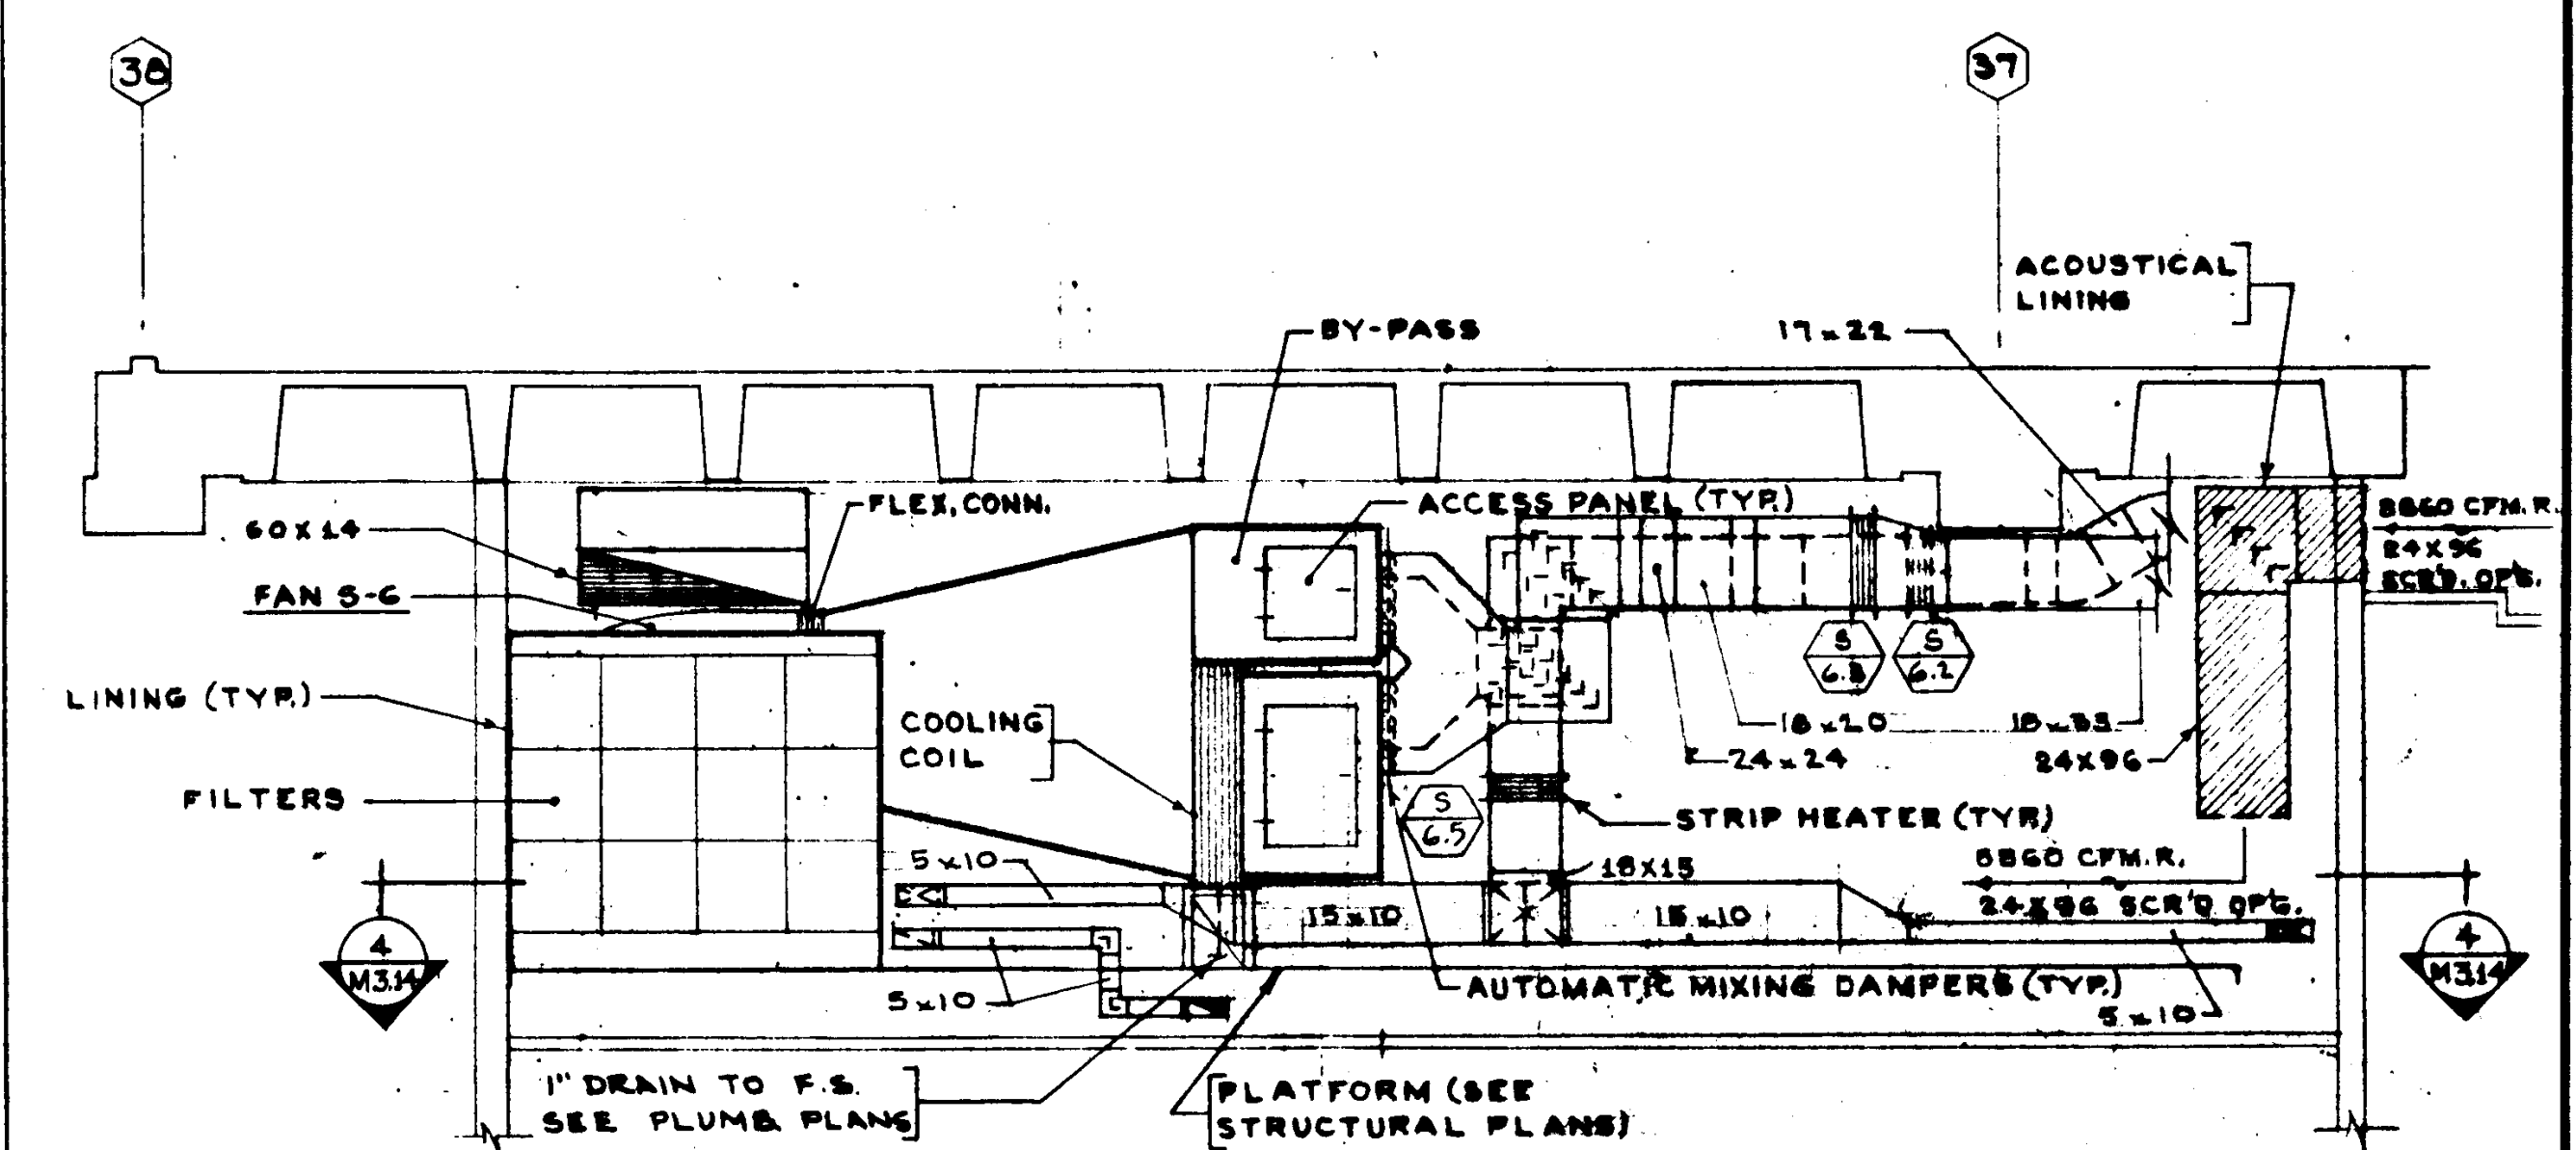


SECTION

SCALE 1/4" = 1'

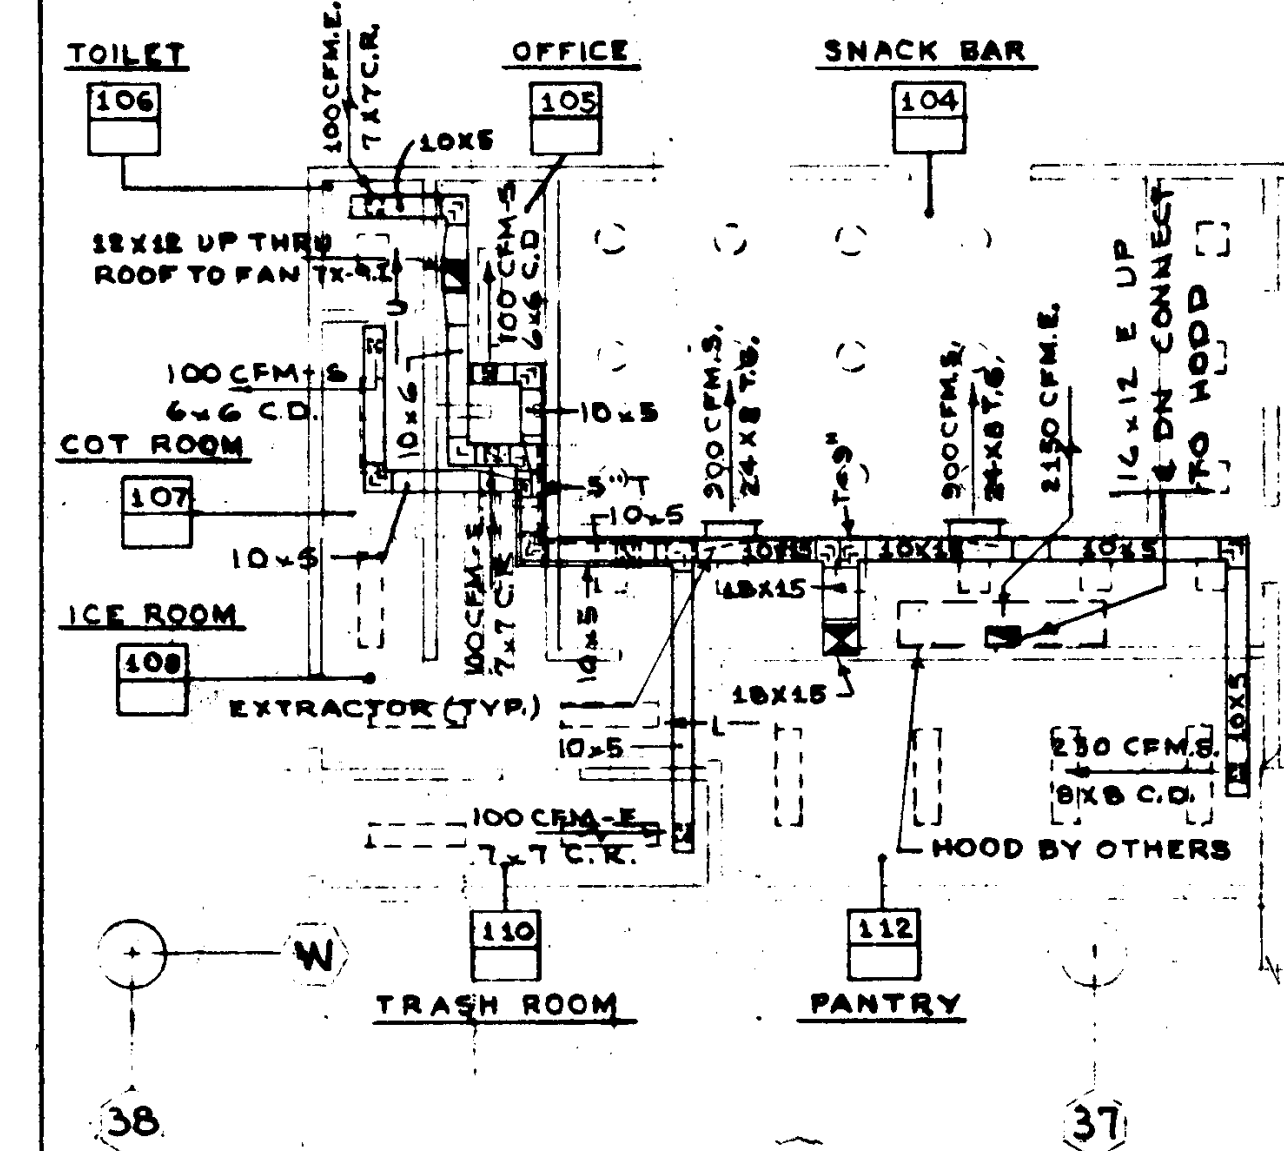

SECTION

SCALE 1/4" = 1'

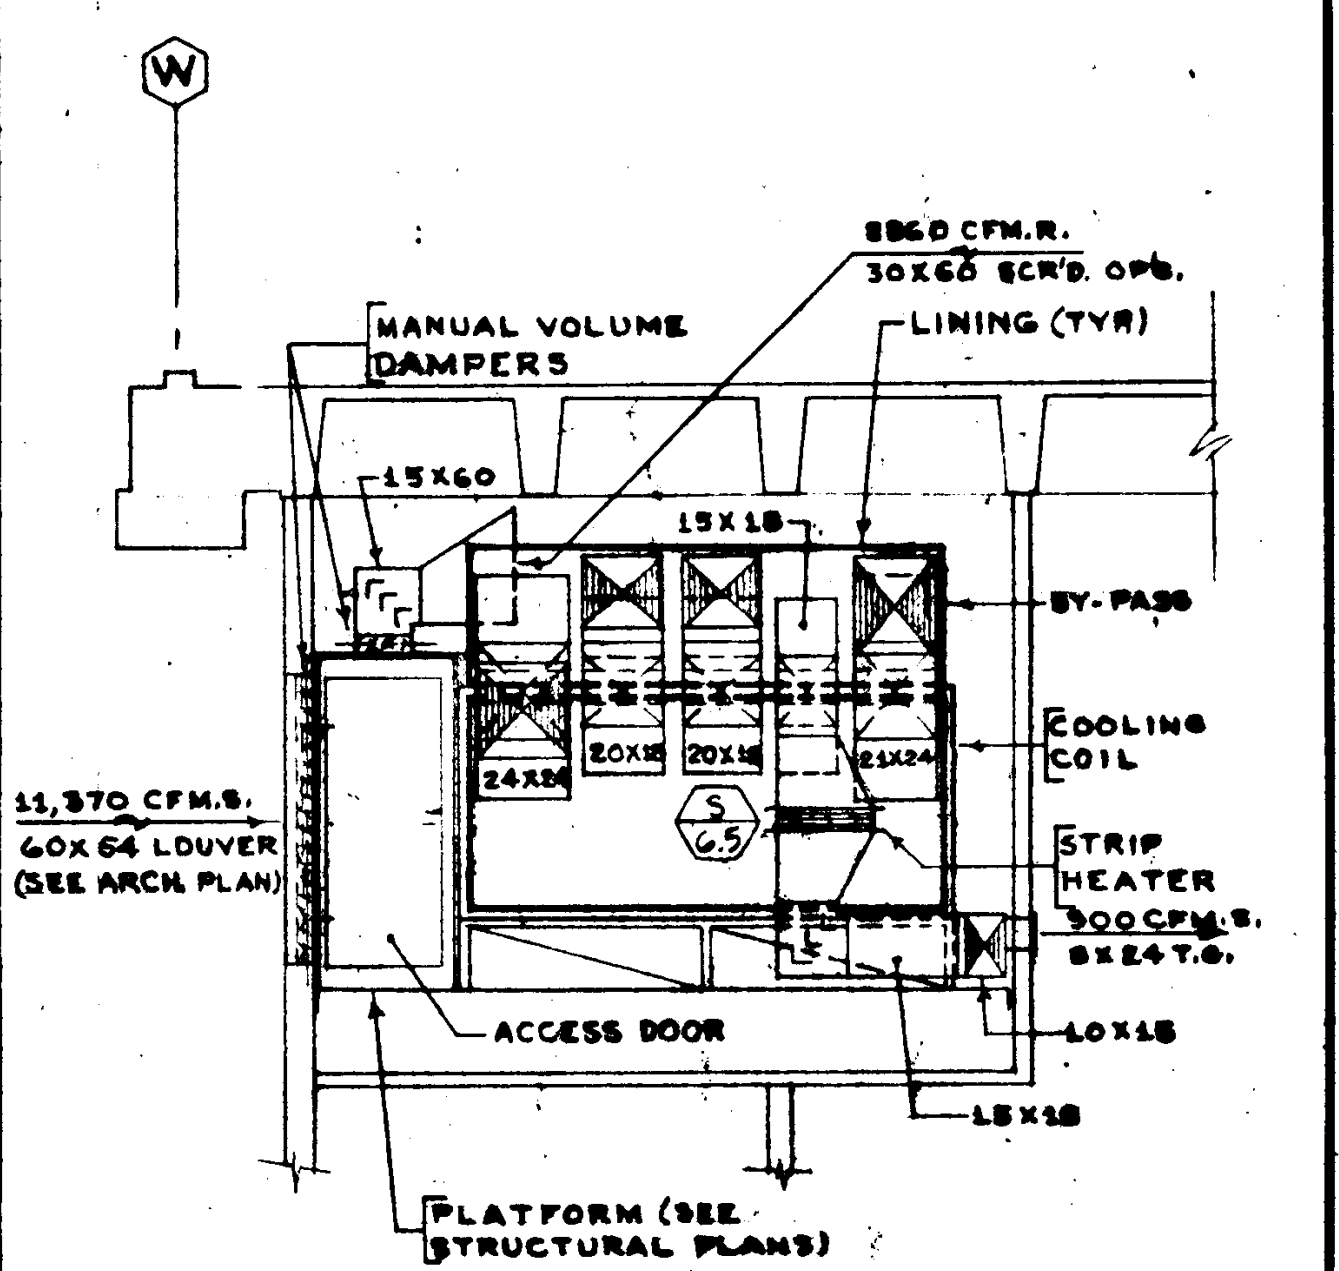

SECTION

SCALE 1/4" = 1'

FIRST FLOOR



SCALE 1/8" = 1'

STRUCTURAL ENGINEERS BRANDOW & JOHNSTON J. A. MARTIN & ASSOCIATES MECHANICAL ENGINEERS RALPH E. PHILLIPS, INC. ELECTRICAL ENGINEERS RALPH E. PHILLIPS, INC. CIVIL ENGINEERS G. SHURMAN & ASSOCIATES MOFFATT & NICHOL		DESIGNED L.H.W. DRAWN BY R.W. & A.B. CHECKED BY W.C.L.	ARCHITECT WILLIAM L. FERREIRA ASSOCIATED ARCHITECTS: WILLIAM L. FERREIRA & ASSOCIATES A. QUINCY JONES-FREDERICK E. EMMONS & ASSOCIATES BLUROCK ELLERBROEK & ASSOCIATES URBANUS SQUARE • MACARTHUR BOULEVARD AT FORD ROAD TELEPHONE 714/675-2640 • CORONA DEL MAR, CALIFORNIA	APPROVED JUN 21 1965 STATE OF CALIFORNIA DATE JUN 21 1965	GOLDEN WEST COLLEGE HUNTINGTON BEACH, CALIFORNIA ORANGE COAST JUNIOR COLLEGE DISTRICT	UNIT #6 FLOOR PLAN	JOB NO. 104 DATE 6-15-65 SHEET NO. M3.14
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RM. NAMES & NO'S



AC-17

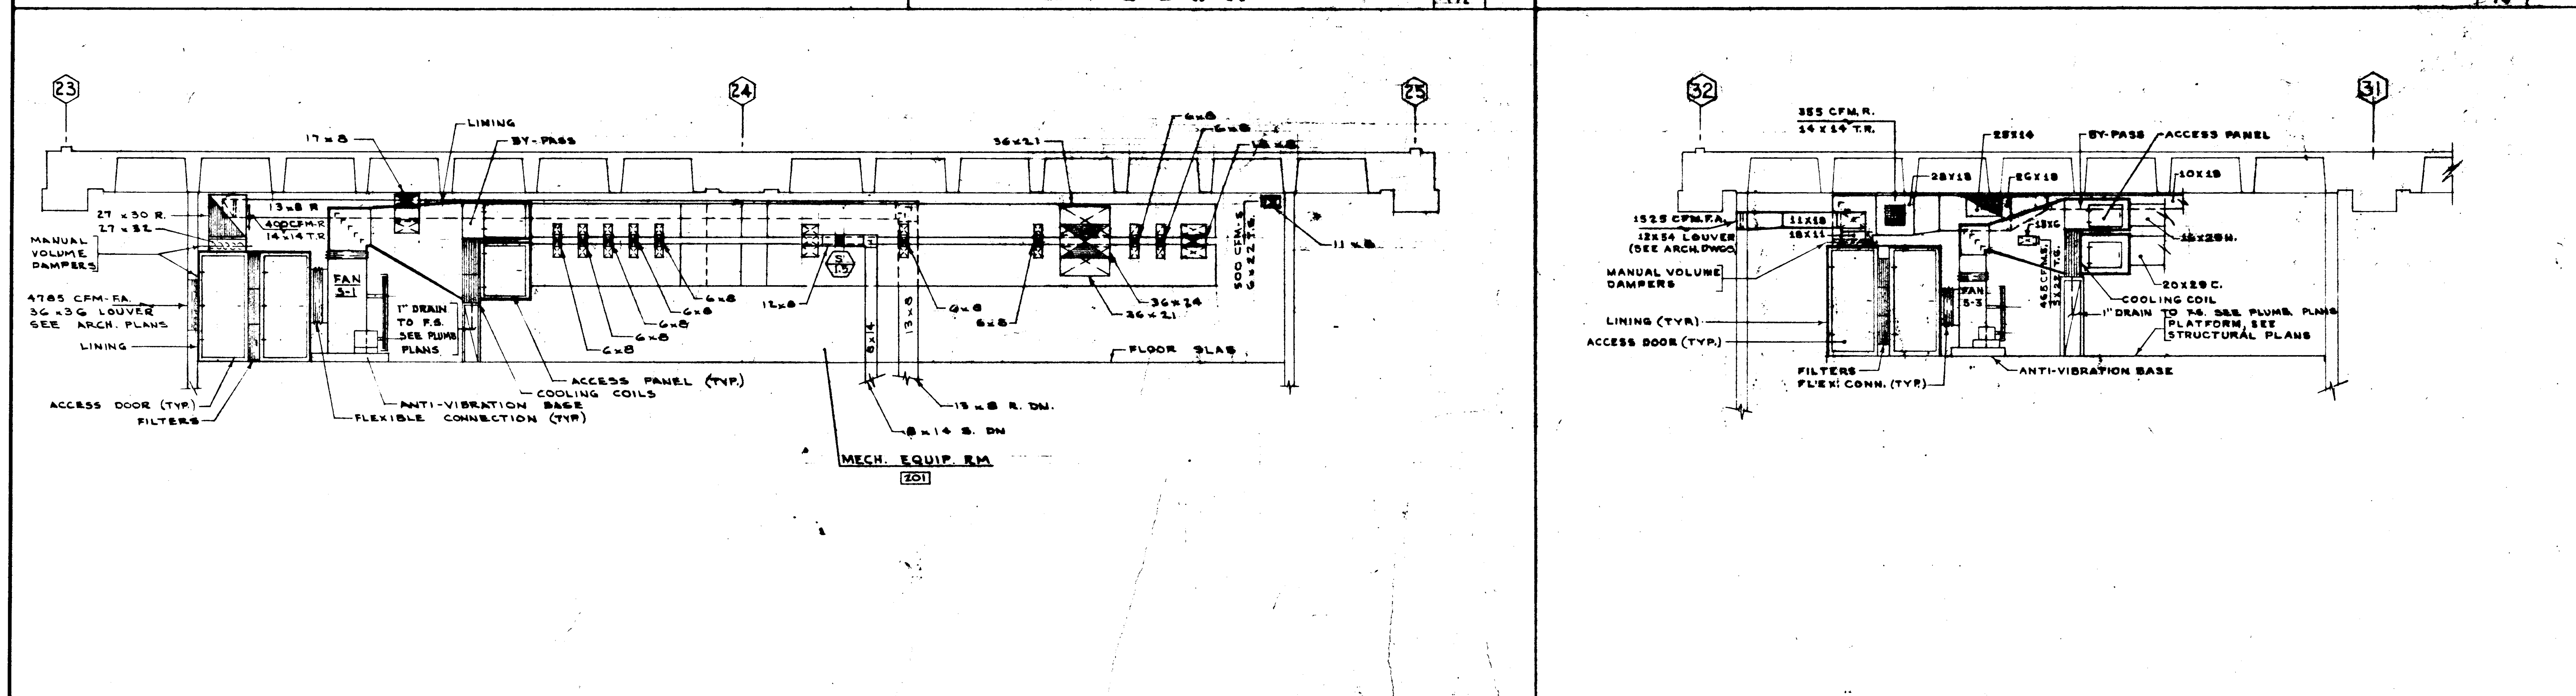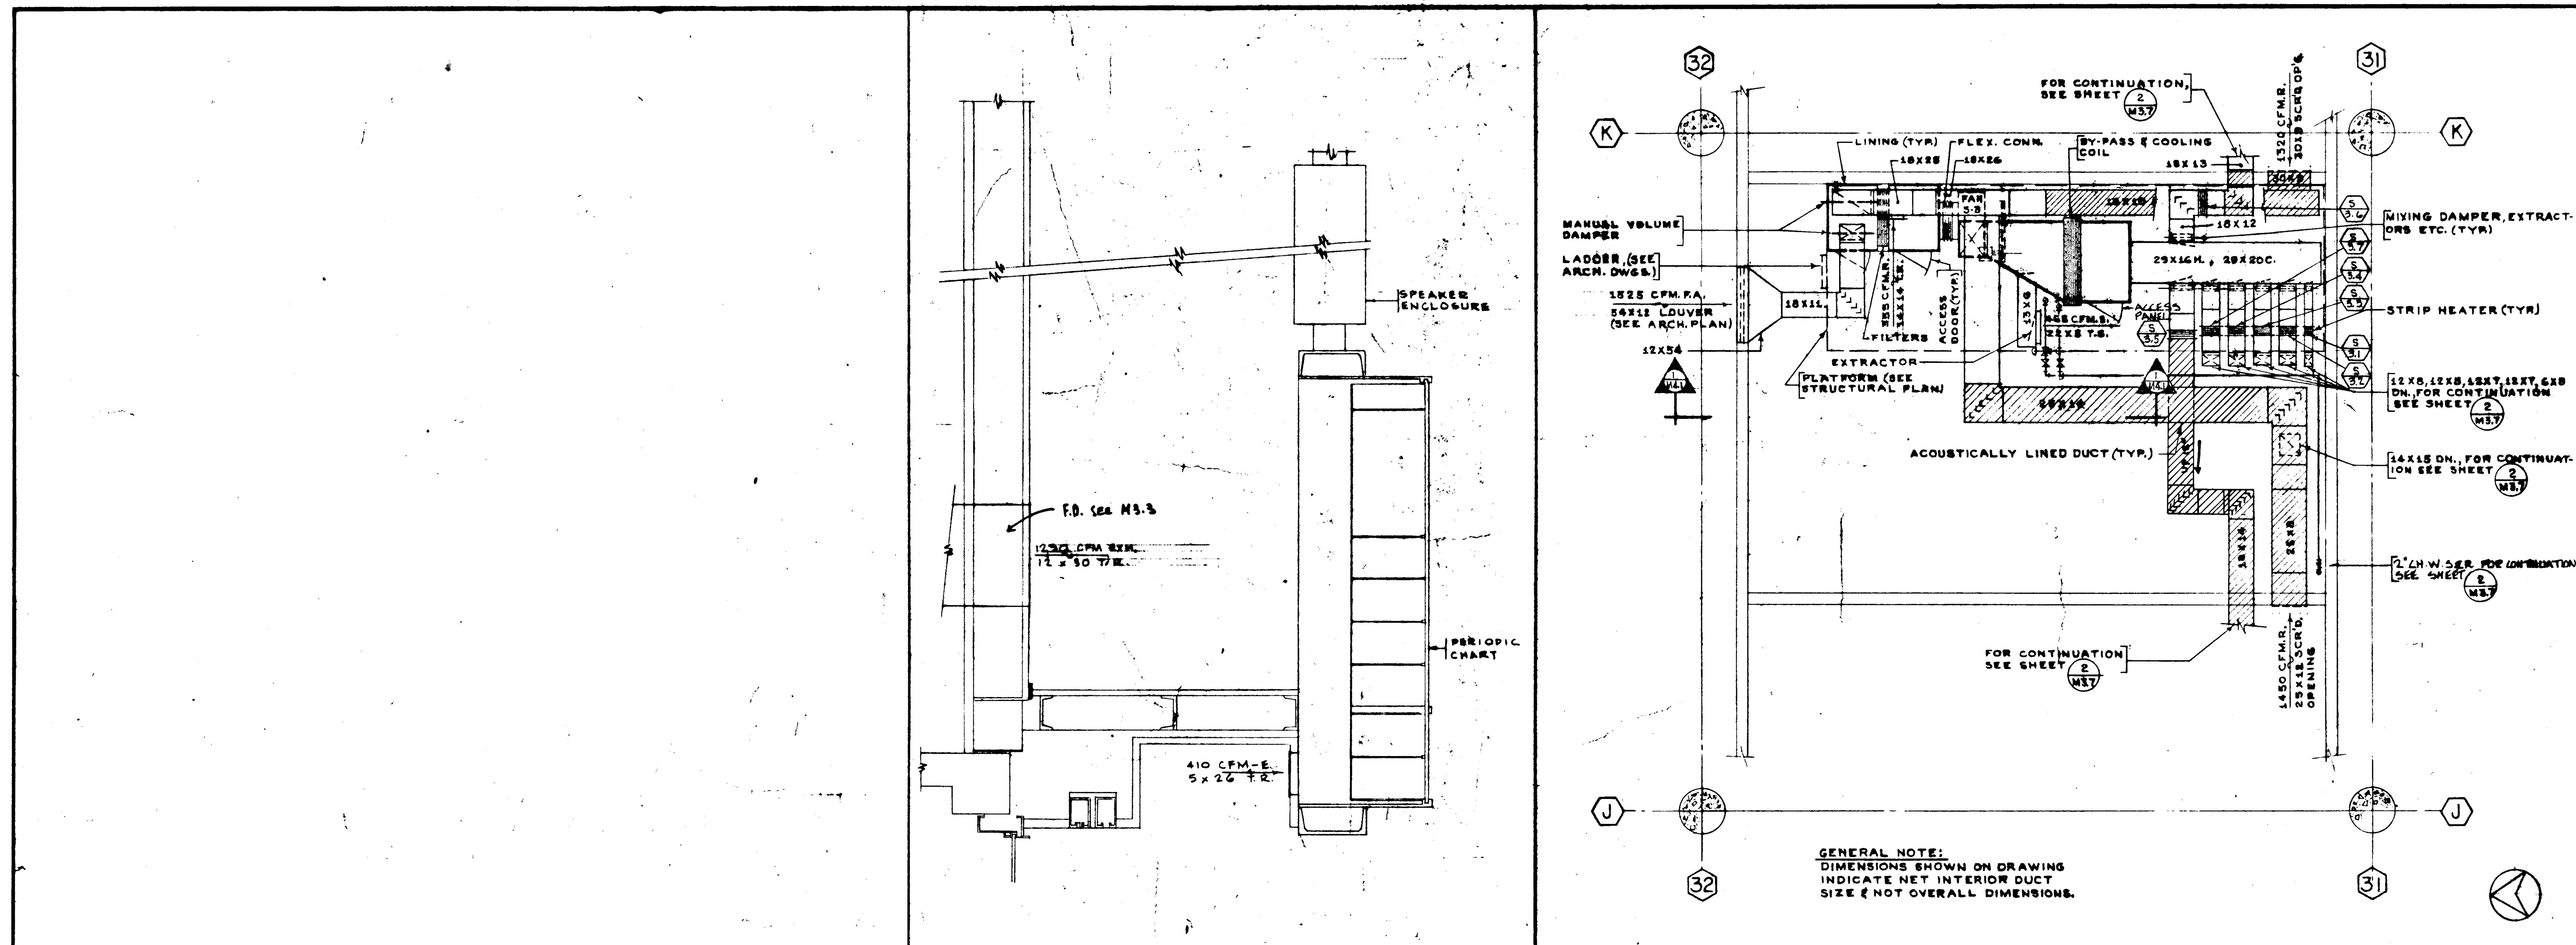

SECTION										SCALE 1/4" = 1'		SECTION										SCALE 1/4" = 1'					
STRUCTURAL ENGINEERS BRANDOW & JOHNSON S. A. MARTIN & ASSOCIATES										DESIGNED L. H. W.		ARCHITECT W. L. P.		APPROVED 25874		ASSOCIATED ARCHITECTS: WILLIAM L. PEREIRA & ASSOCIATES A. QUINCY JONES-FREDERICK E. EMMONS & ASSOCIATES BLUROCK ELLERBROOK & ASSOCIATES										JOB NO. 1004	
MECHANICAL ENGINEERS RALPH E. PHILLIPS, INC.										DRAWN BY A. S. E. W.		ENGINEER A. S. E. W.		APPROVED JUN 21 1965		GOLDEN WEST COLLEGE HUNTINGTON BEACH, CALIFORNIA ORANGE COAST JUNIOR COLLEGE DISTRICT										DATE 6-15-65	
ELECTRICAL ENGINEERS RALPH E. PHILLIPS, INC.										CHECKED BY W. C. L.		COLLOR		STATE FIRE MARSHAL STATE OF CALIFORNIA JUN 21 1965												SHEET NO. M 4.1	
CIVIL ENGINEERS O. SHURMAN & ASSOCIATES MOFFATT & NICHOL																											
REVISIONS																											

SUPPLY SYSTEMS S-1 THRU S-6.
VFC-1 THRU VFC-9 SIMILAR NO SCALE.



S U B P L Y S Y S T E M S S - 1 T H I R U S - 6 . (VFL-1 THRU VFL-9 SIMILAR)

SUPPLY SYSTEMS S-7 & HV-1.
NO SCALE.



S U P P L Y S Y S T E M S S - 7 & H V - 1

FAN & COIL UNITS FC-1 THRU FG-6.
NO SCALE.

F A N & C O I L U N I T S F C - 1 T H I R D F C - 3 (EFC UNITS TO HAVE HEATING CONTROL ONLY)										SCALE NONE	33	EVAPORATIVE COND. AUTO. DRAIN COND.		SCALE NONE	4				
STRUCTURAL ENGINEERS BRAWLEY & JOHNSTON J. A. MARTIN & ASSOCIATES		DESIGNED L. H. W.		ARCHITECT W. J. R. H.		APPROVED J. E. H. 74 APPROVED JUN 21 1965 J. E. H.		ASSOCIATED ARCHITECTS: WILLIAM L. PEREIRA & ASSOCIATES A. QUINCY JONES-FREDERICK E. EMMONS & ASSOCIATES BLUROCK ELLERBROEK & ASSOCIATES				GOLDEN WEST COLLEGE HUNTINGTON BEACH, CALIFORNIA ORANGE COAST JUNIOR COLLEGE DISTRICT				ALL UNITS		JOB NO. 104	
MECHANICAL ENGINEERS RALPH E. PHILLIPS, INC.		DRAWN BY P. L.		ENGINEER J. E. H.		APPROVED STATE FIRE MARSHAL STATE OF CALIFORNIA DATE JUN 21 1965		URBANUS SQUARE • MACARTHUR BOULEVARD AT FORD ROAD TELEPHONE 714/675-2640 • CORONA DEL MAR, CALIFORNIA				CONTROL DIAGRAMS				DATE 6-15-65		SHEET NO. M 4.2	
ELECTRICAL ENGINEERS RALPH E. PHILLIPS, INC.		CHECKED BY W. C. L.		COLLECTOR J. E. H.															
CIVIL ENGINEERS O. SHURMAN & ASSOCIATES MOFFATT & NICOL																			
DATE DRAWN		REVISIONS																	

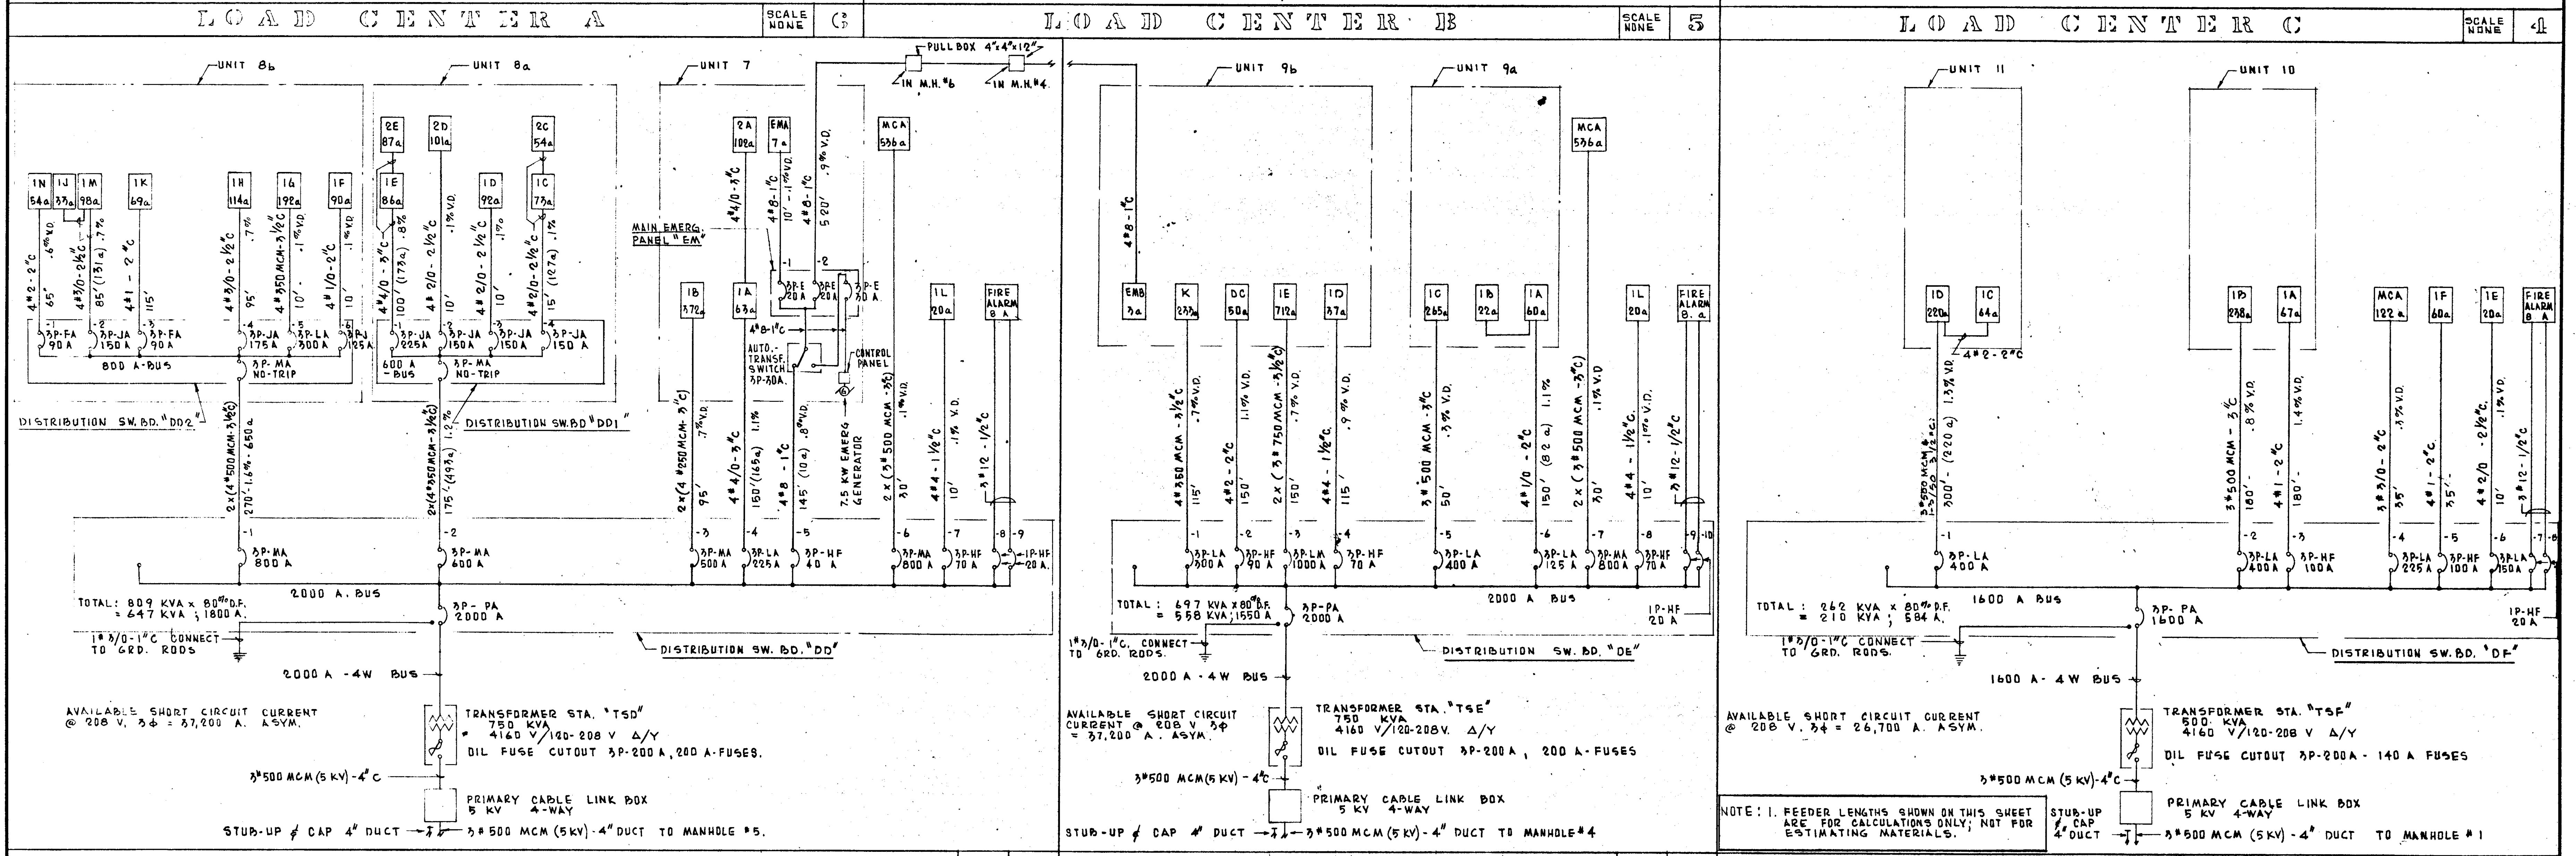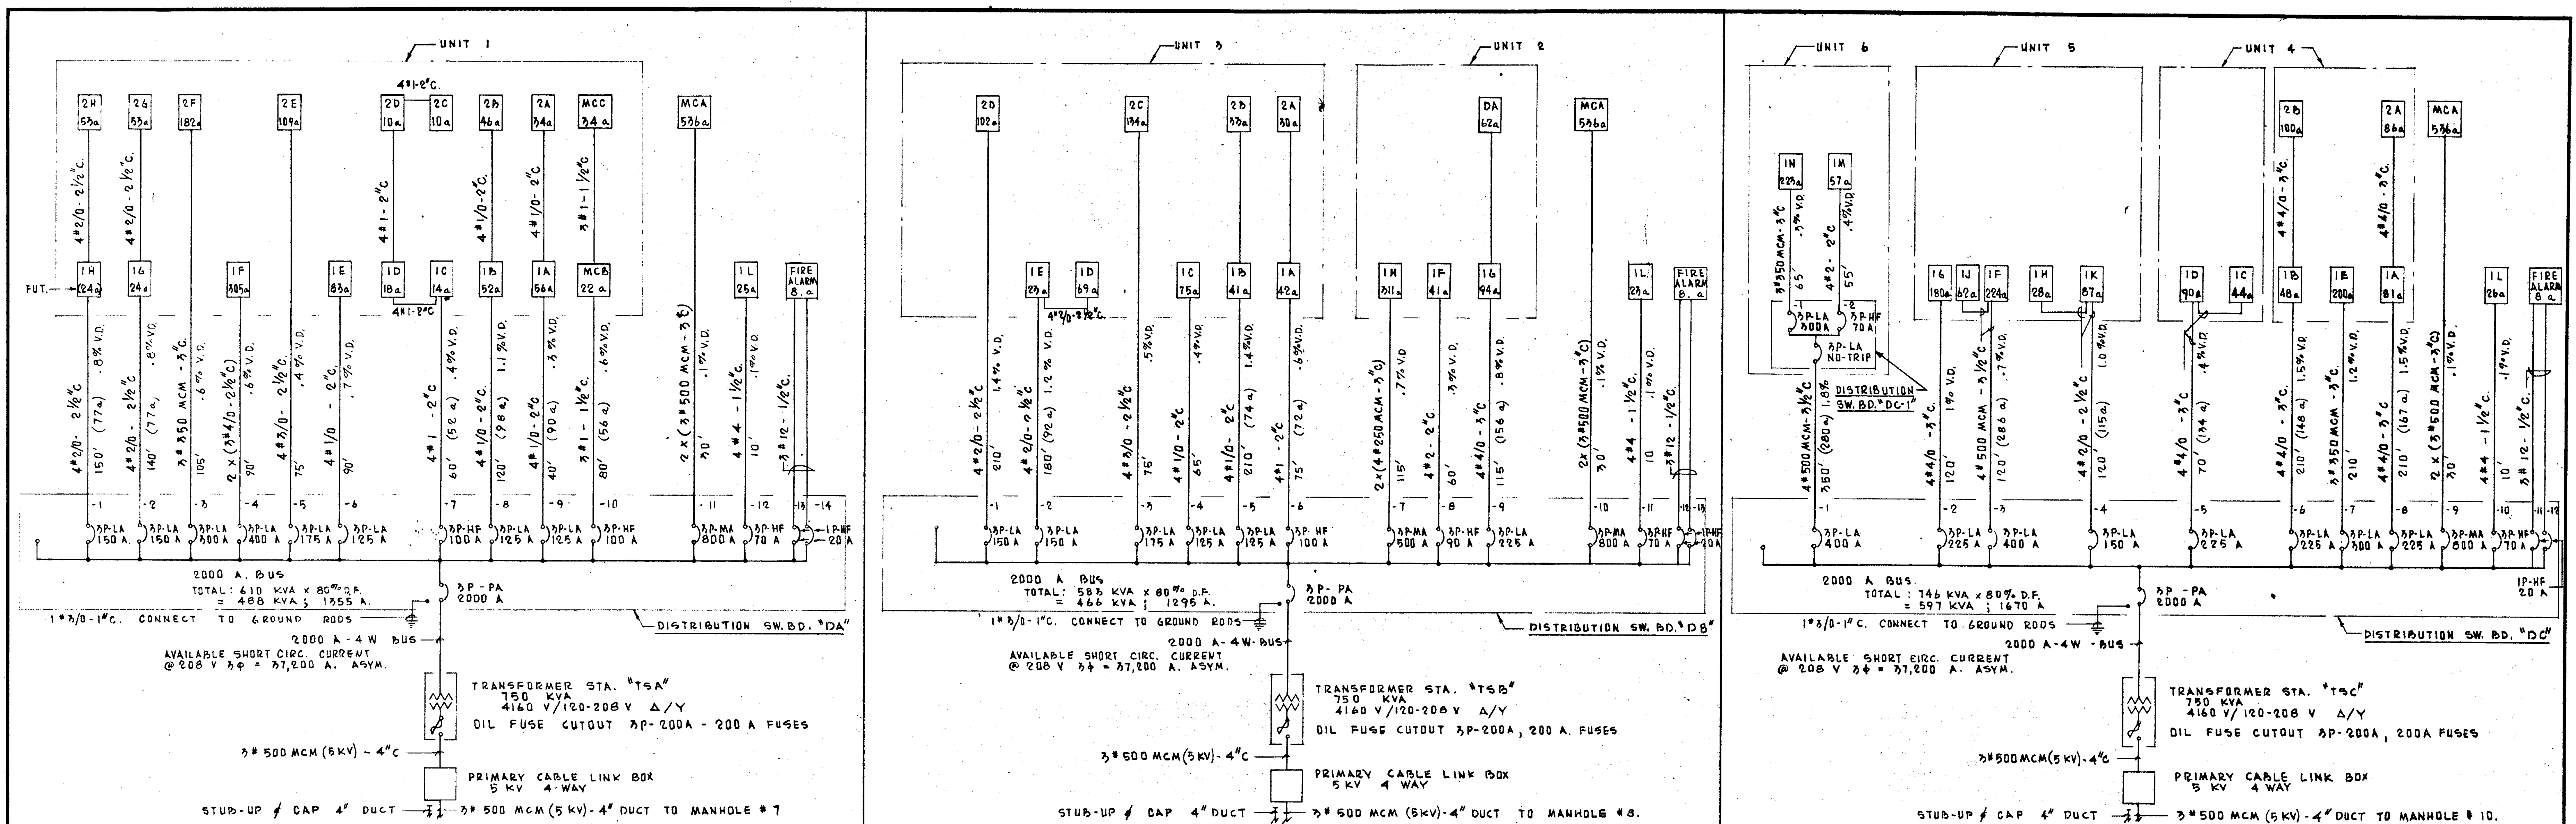


STRUCTURAL ENGINEERS BRANDOW & JOHNSTON J.A. MARTIN & ASSOCIATES MECHANICAL ENGINEERS RALPH E. PHILLIPS, INC. ELECTRICAL ENGINEERS RALPH E. PHILLIPS, INC. CIVIL ENGINEERS G. SHURMAN & ASSOCIATES MOFFATT & NICHOL		DESIGNED DRAWN BY CHECKED BY	ARCHITECT APPROVED STATE FIRE MARSHAL DATE JUN 11 1955 25874 APPROVED JUN 21 1955	ASSOCIATED ARCHITECTS: WILLIAM L. PEREIRA & ASSOCIATES A. QUINCY JONES-FREDERICK E. EMMONS & ASSOCIATES BLUROCK ELLERBROCK & ASSOCIATES URBANUS SQUARE • MACARTHUR BOULEVARD AT FORD ROAD TELEPHONE 714/675-2640 • CORONA DEL MAR, CALIFORNIA	GOLDEN WEST COLLEGE HUNTINGTON BEACH, CALIFORNIA ORANGE COAST JUNIOR COLLEGE DISTRICT	ALL UNITS ONE LINE DIAGRAMS JOB NO. 104 DATE 6-16-55 SHEET NO. 12.1
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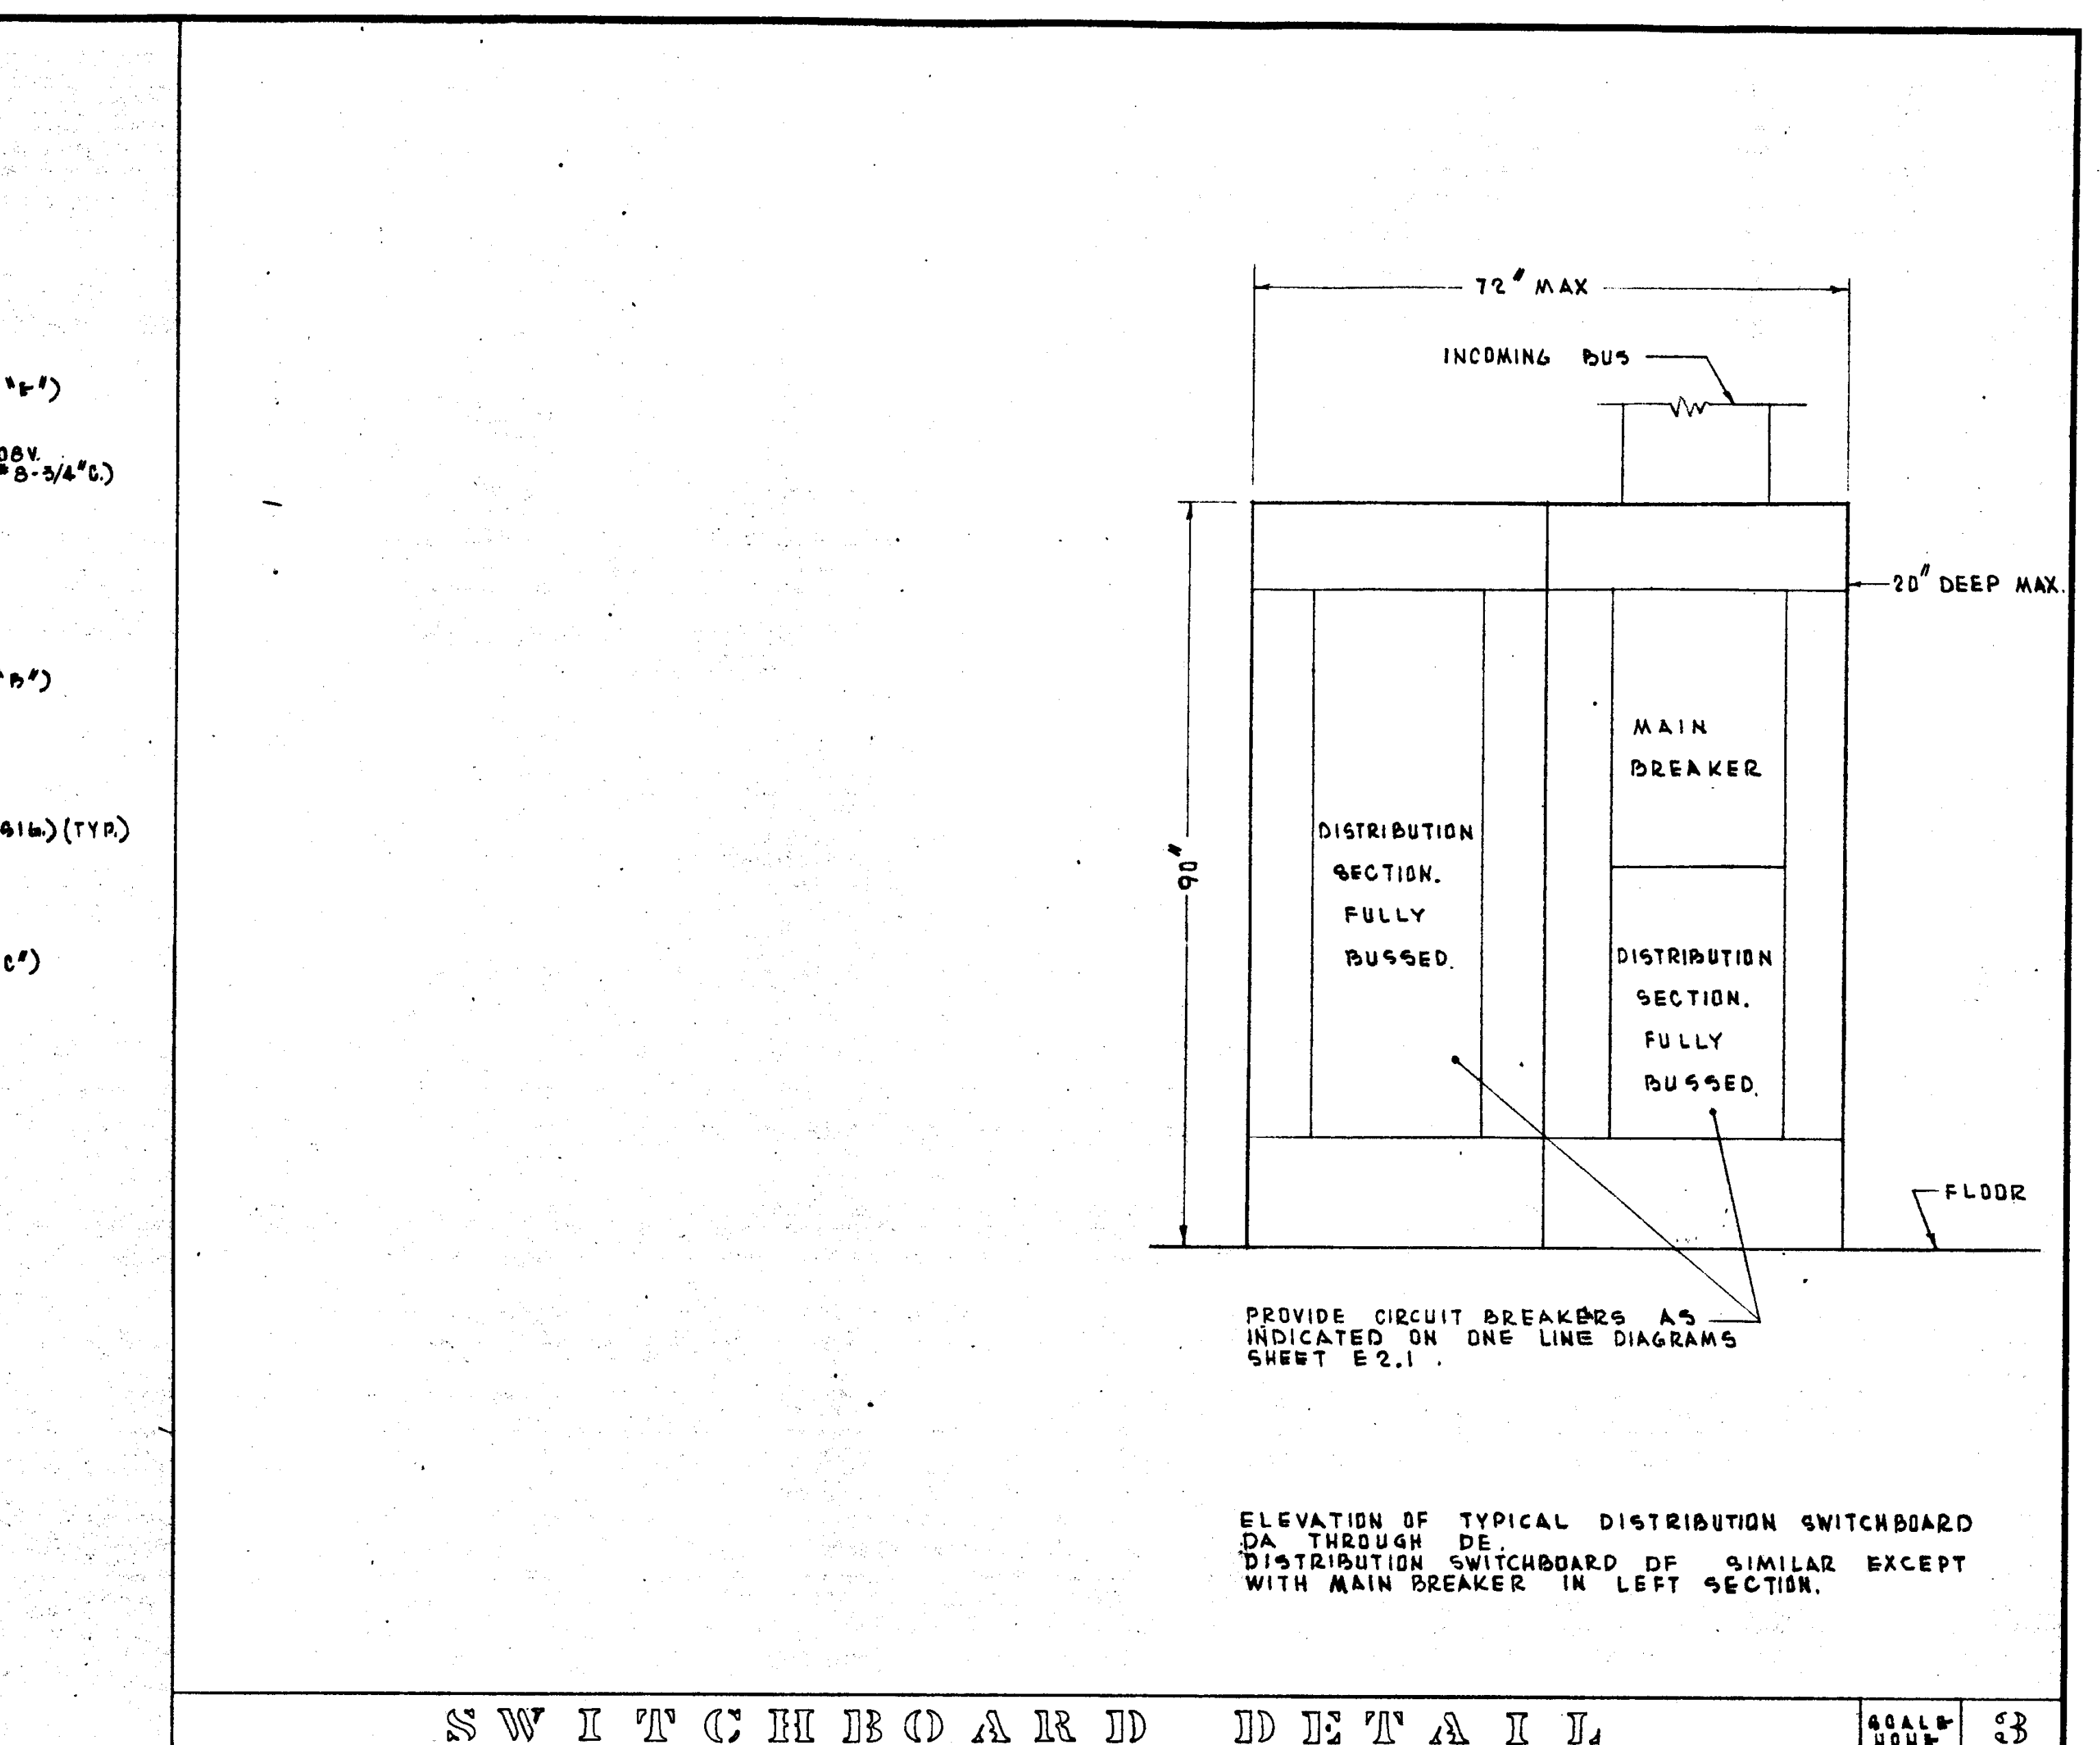


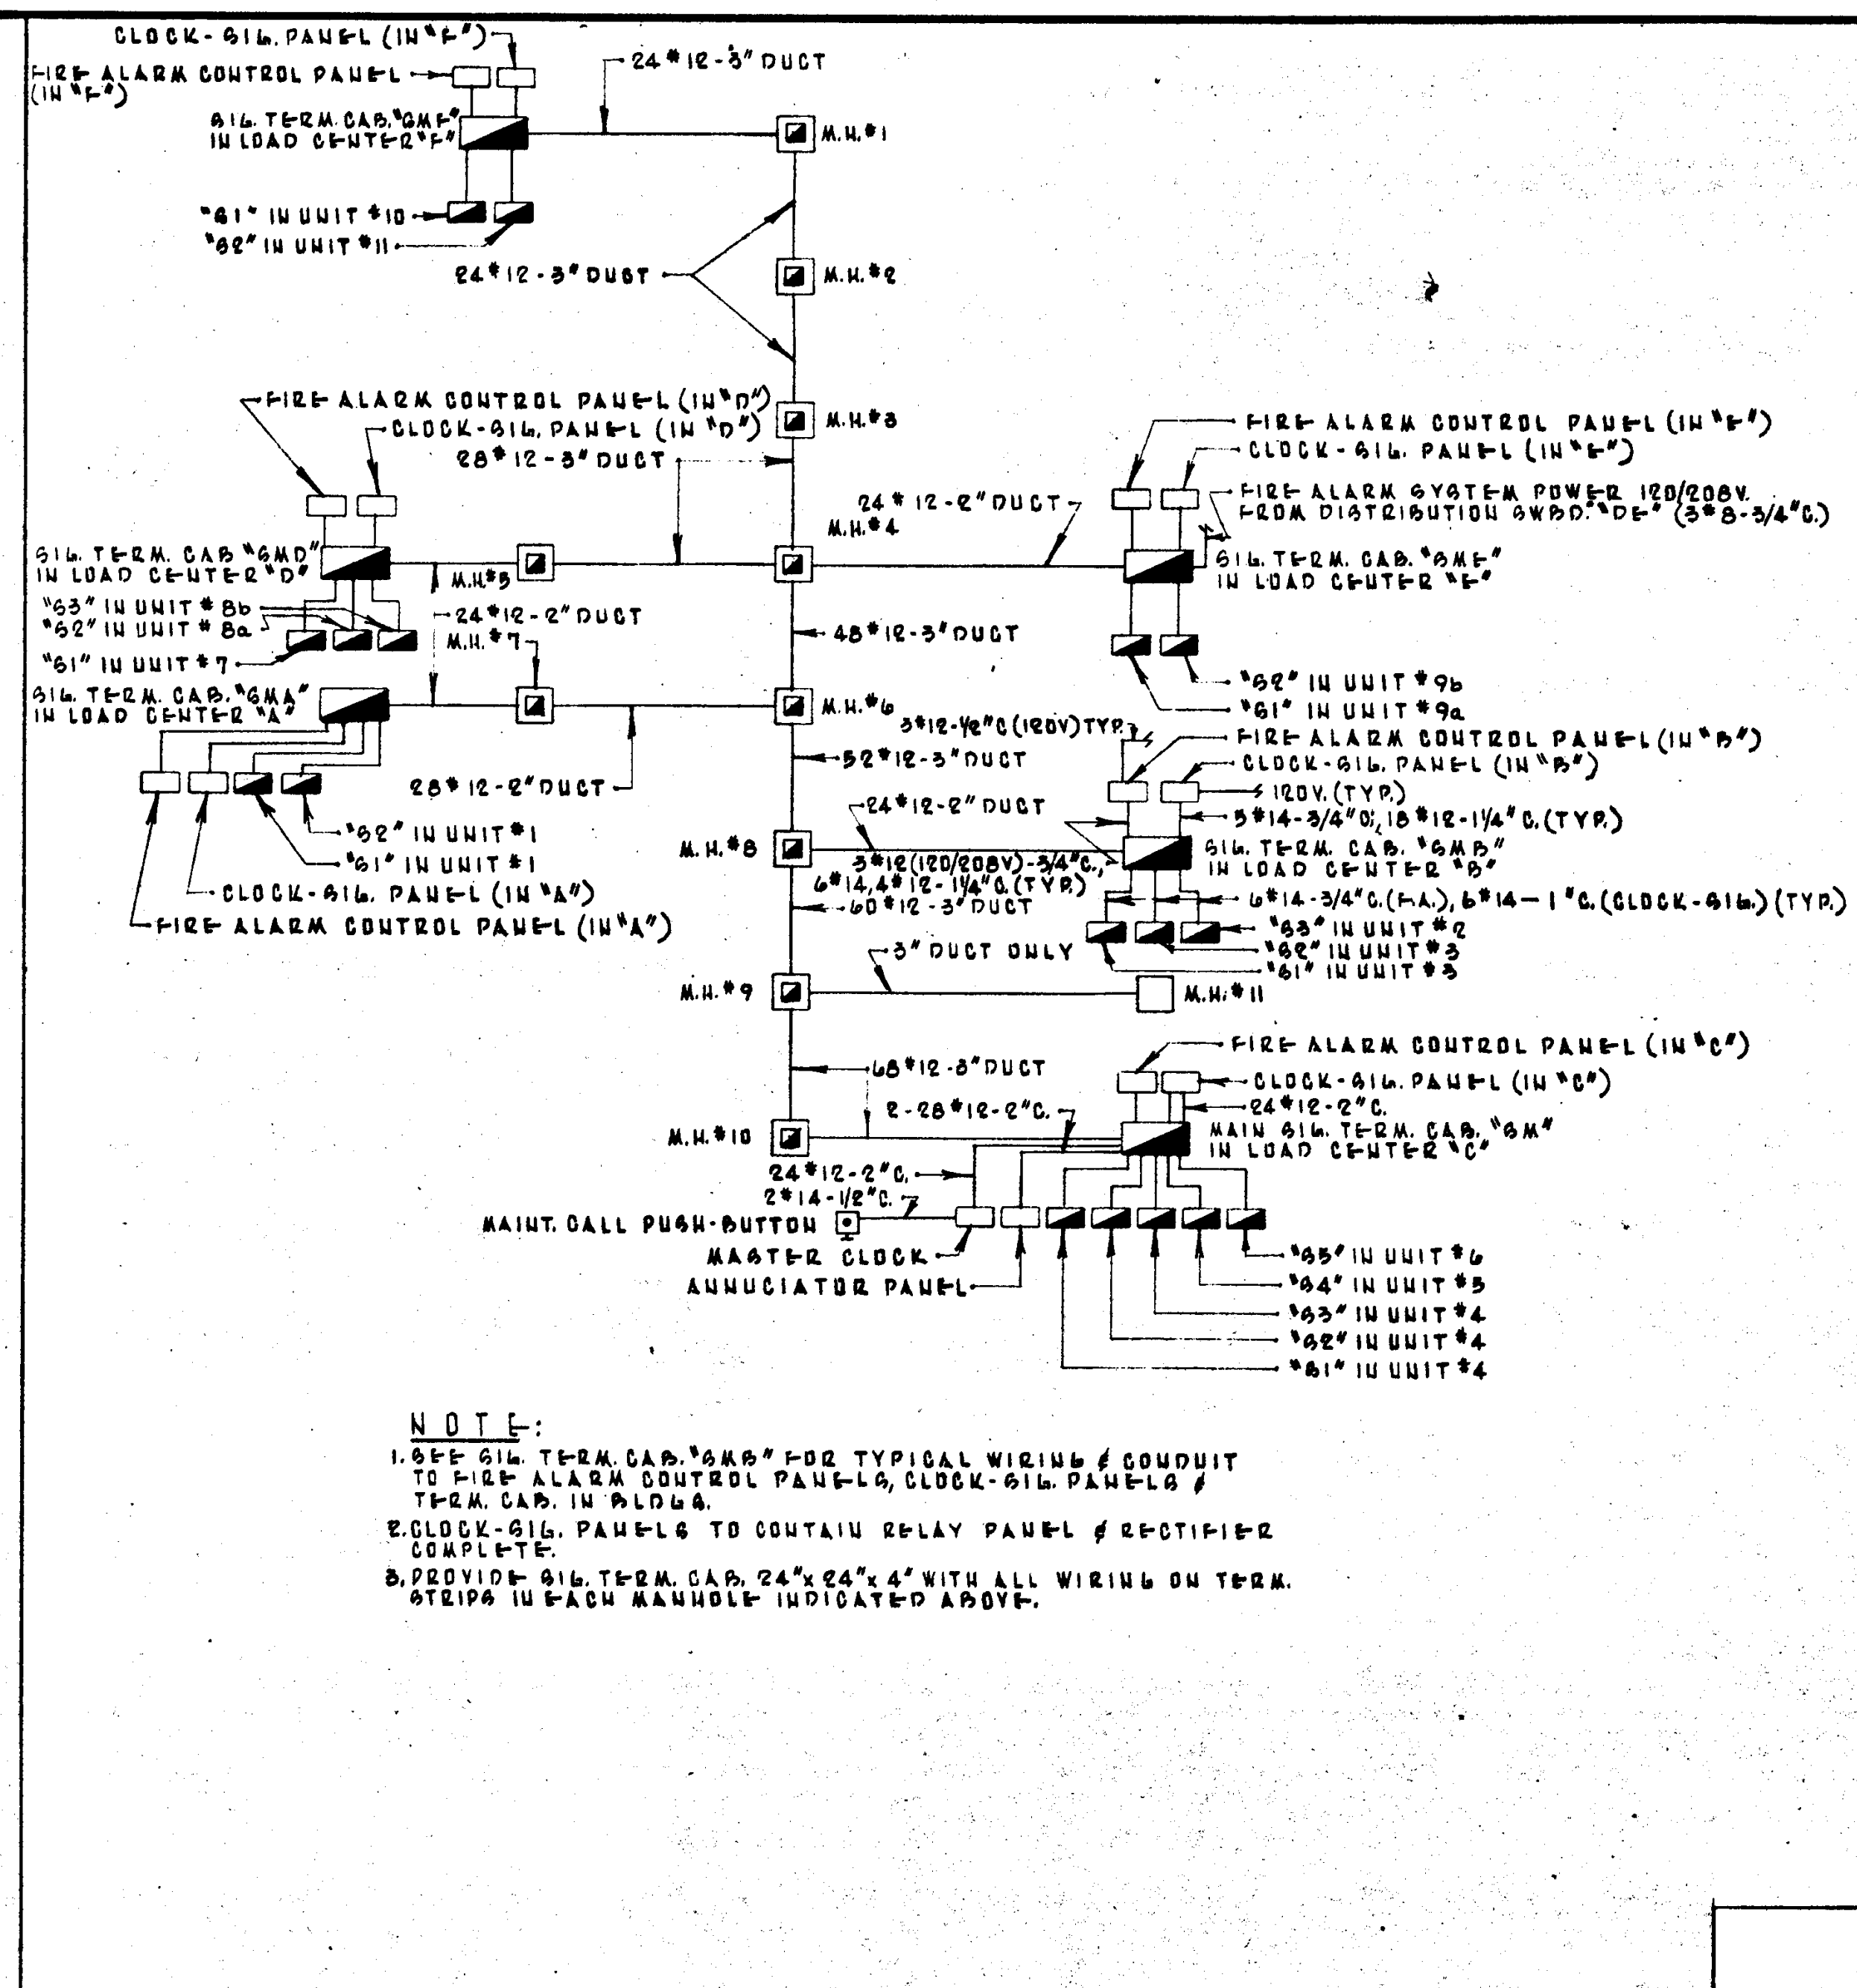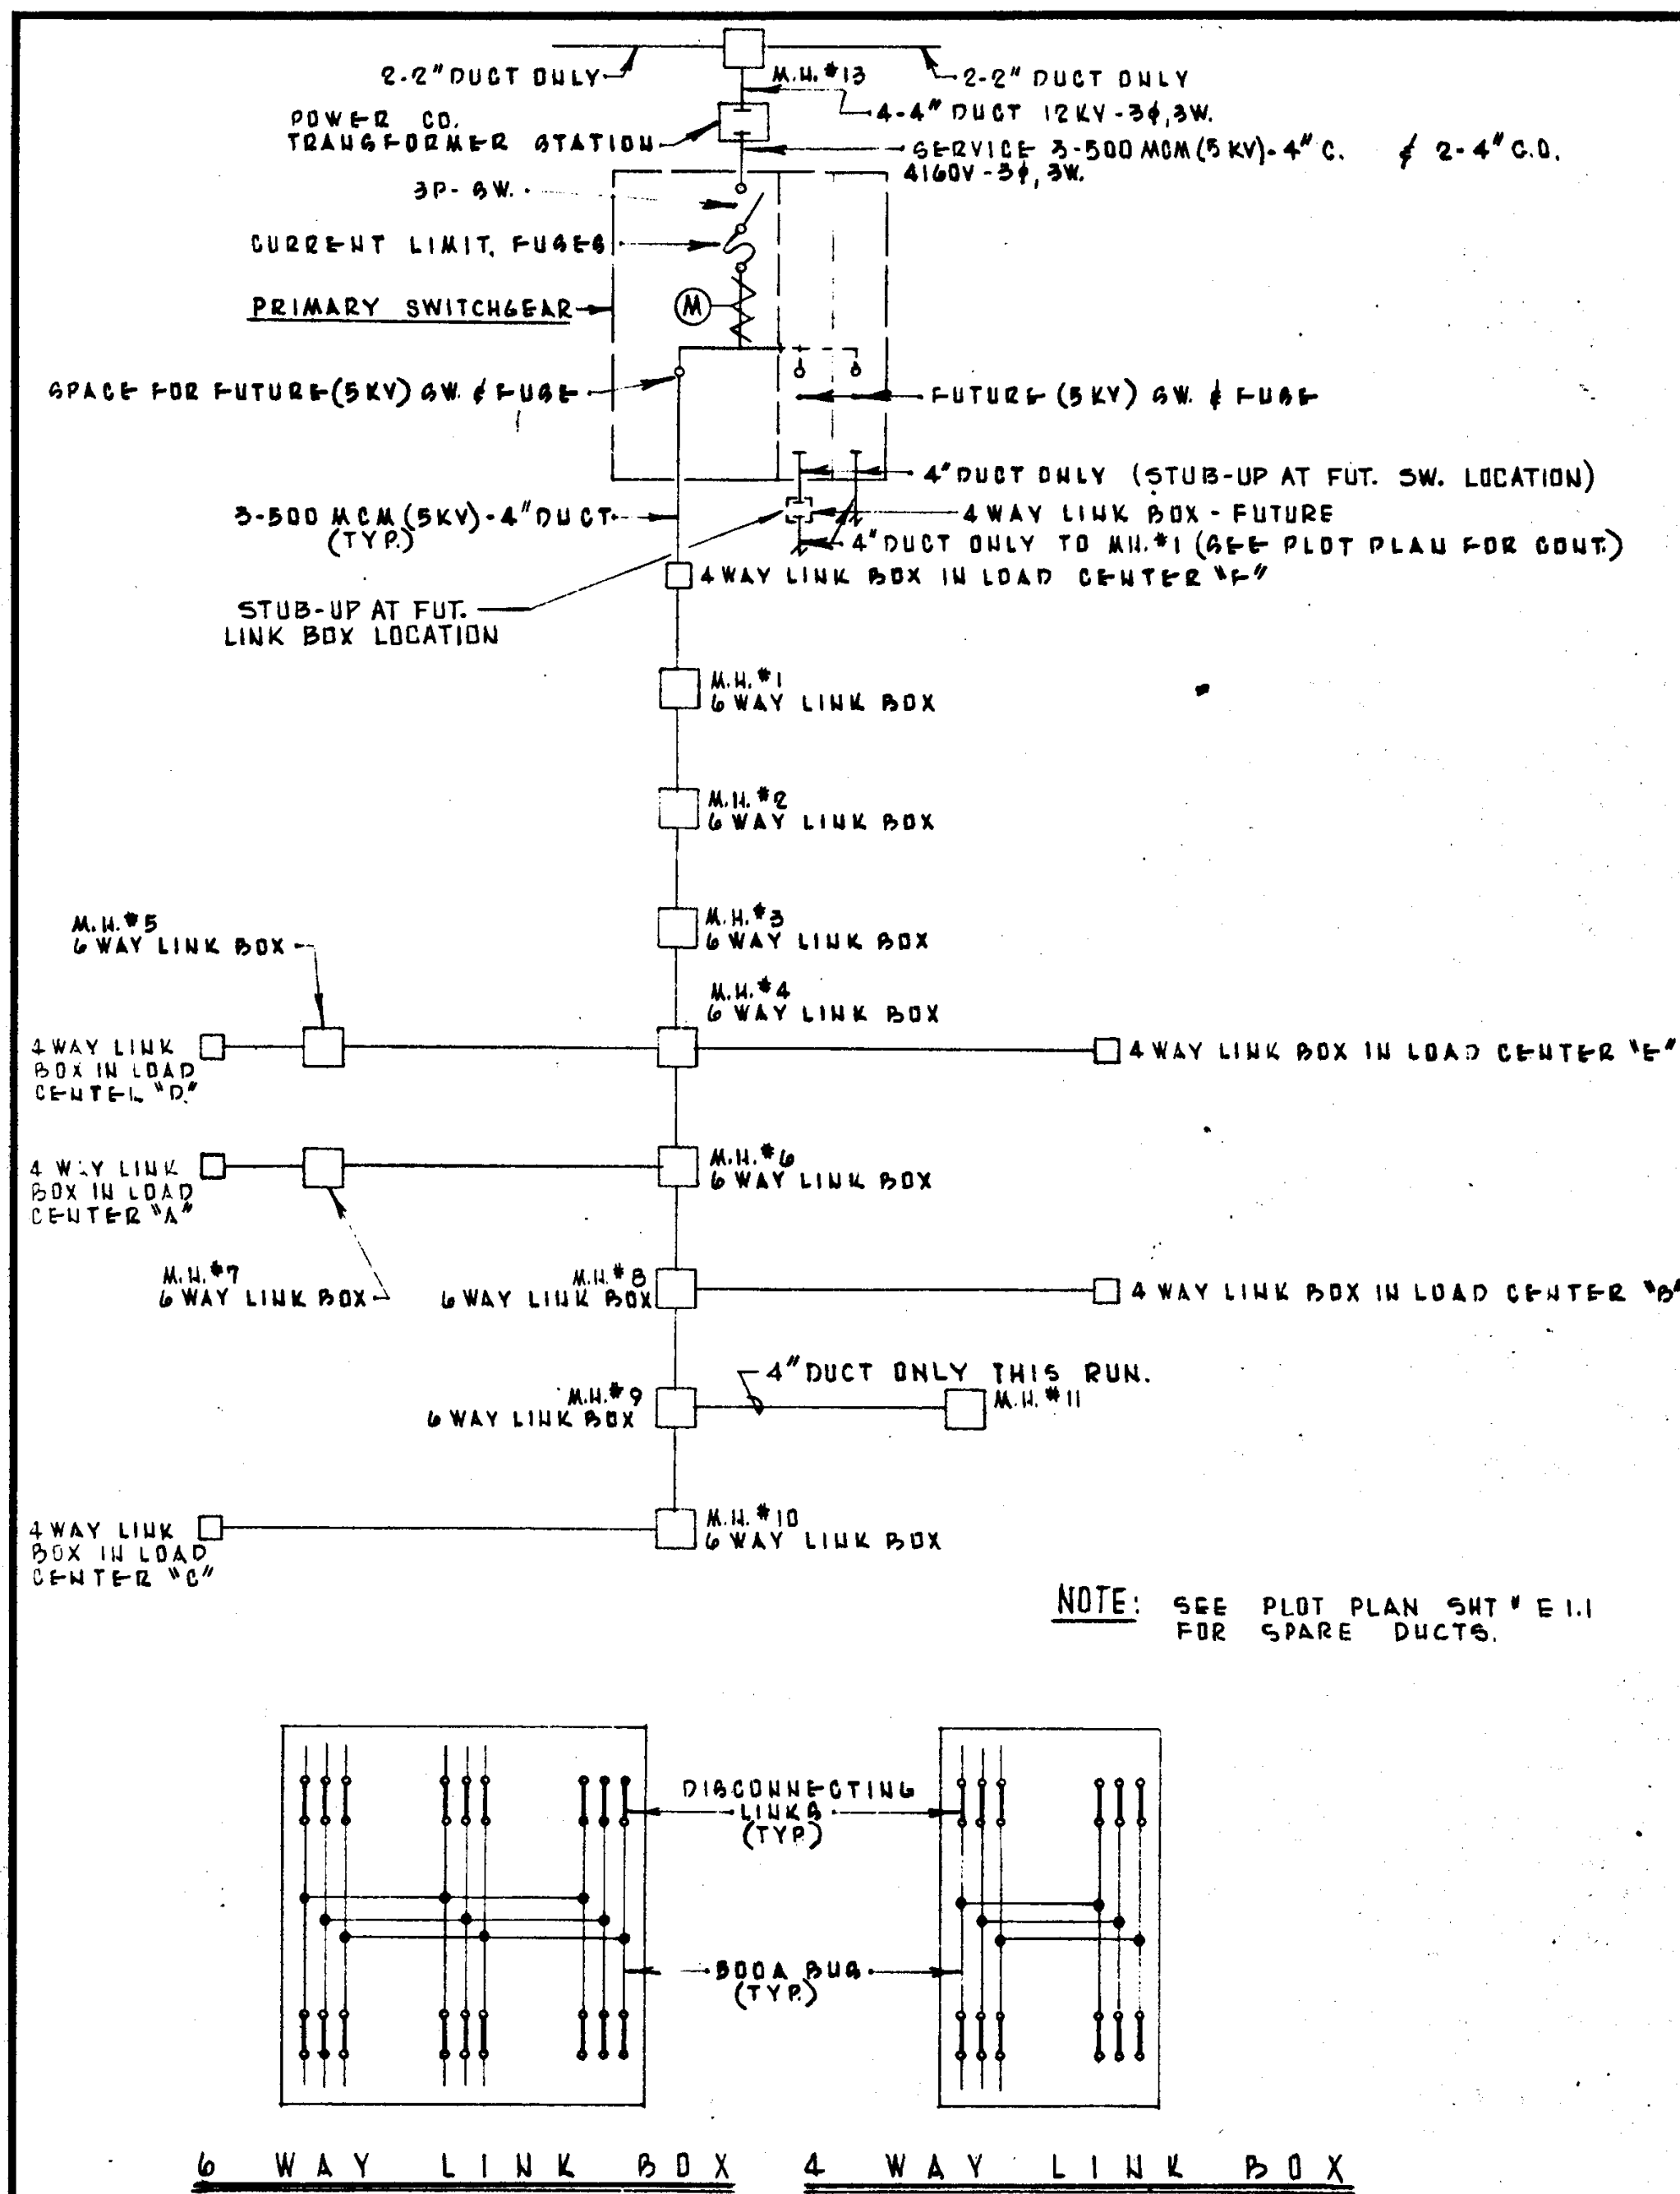PRIMARY SYSTEM DIAGRAM SCALE 1/8\"/>


SIGNAL SYSTEM DIAGRAM SCALE 1/8\"/>

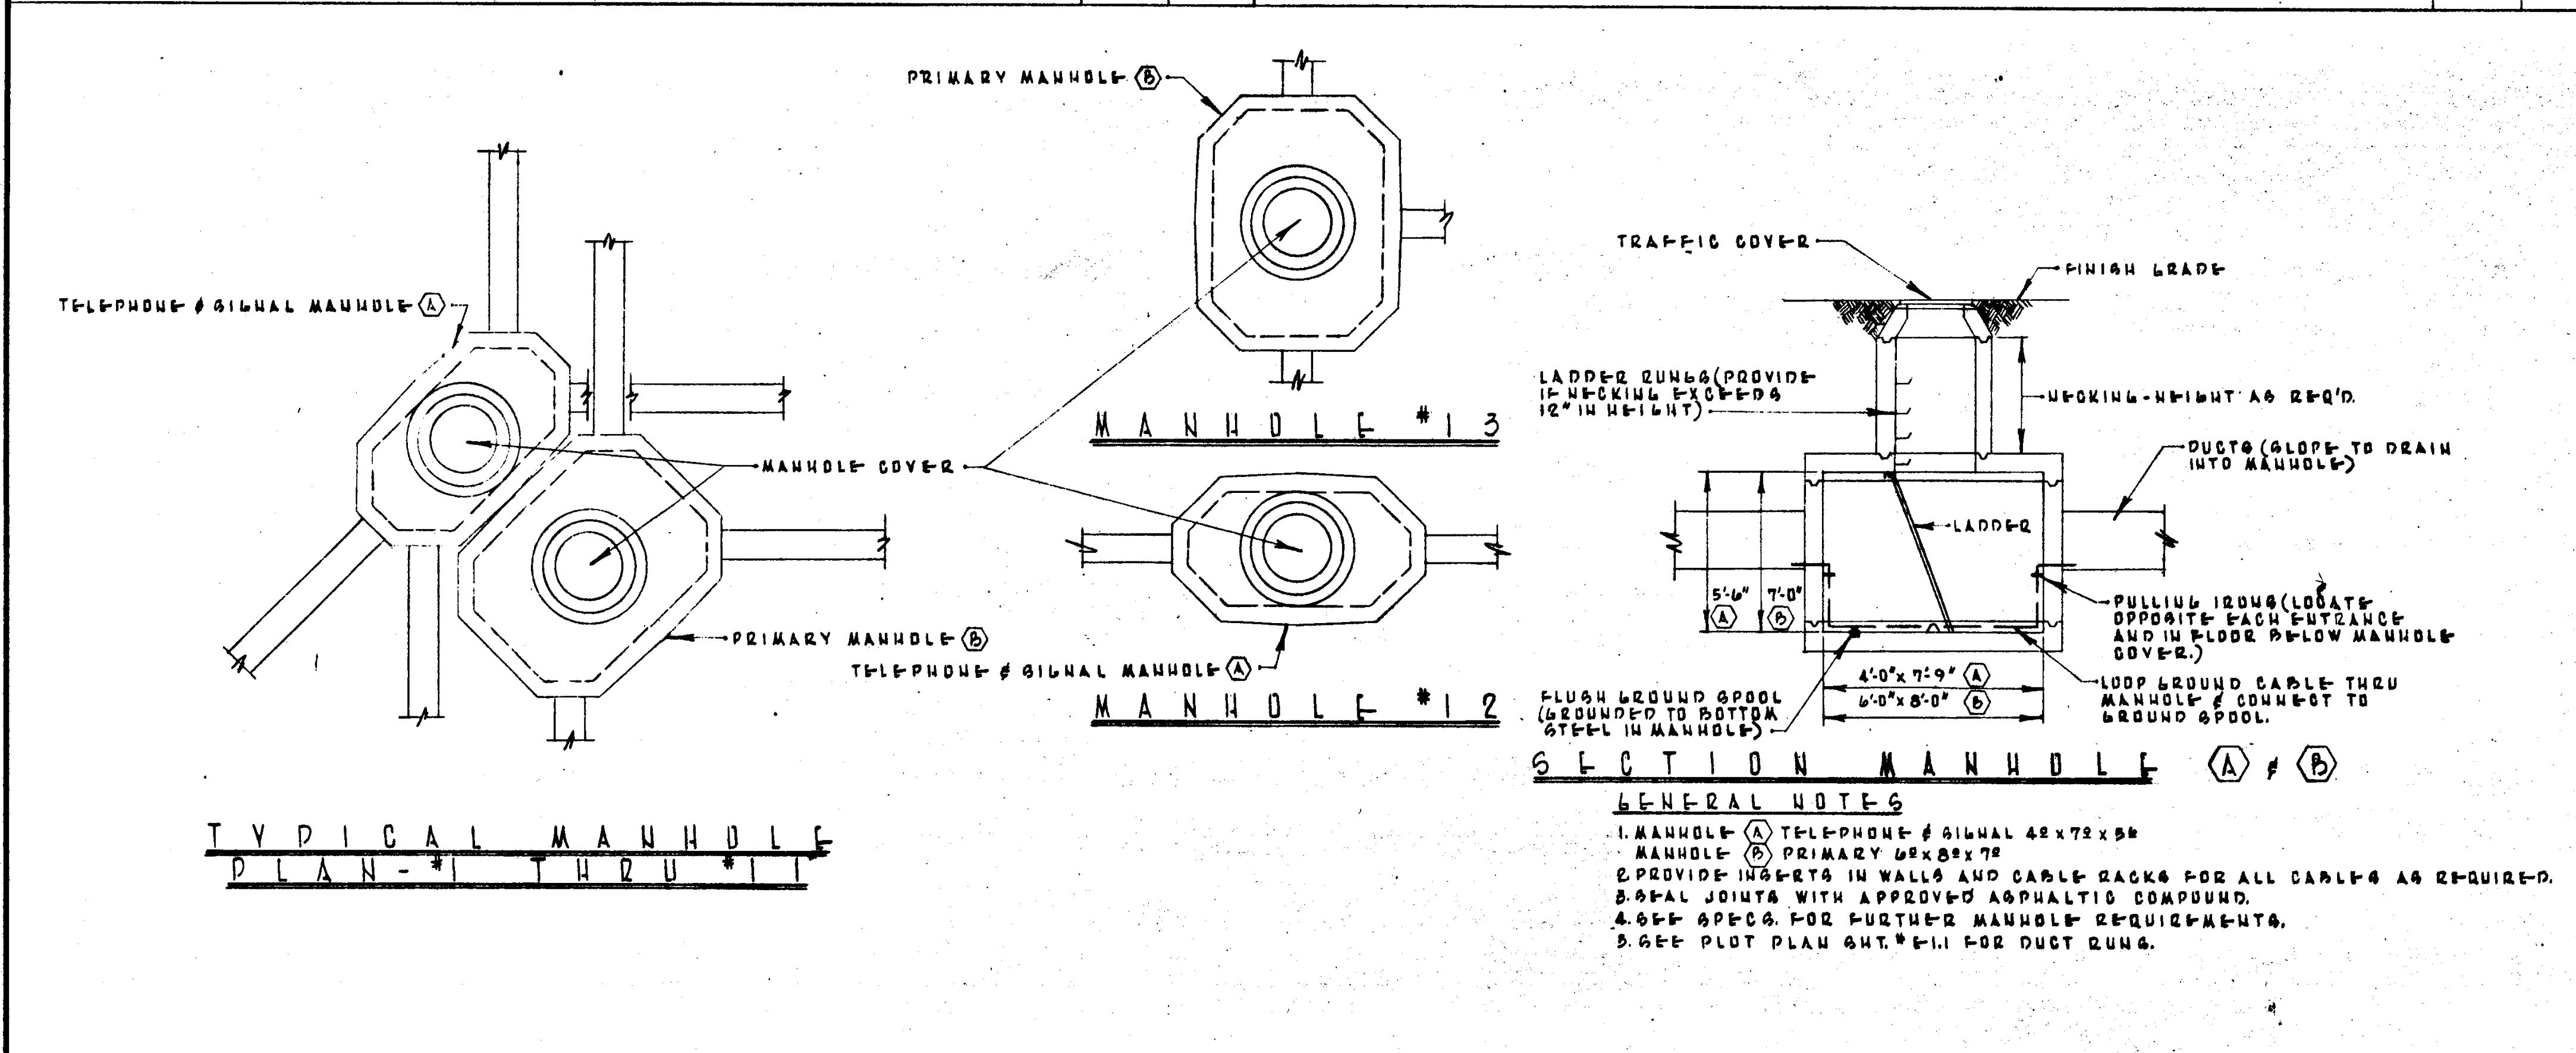

MANHOLE DETAILS SCALE 1/8\"/>



SWITCHBOARD DETAILS SCALE 1/8\"/>

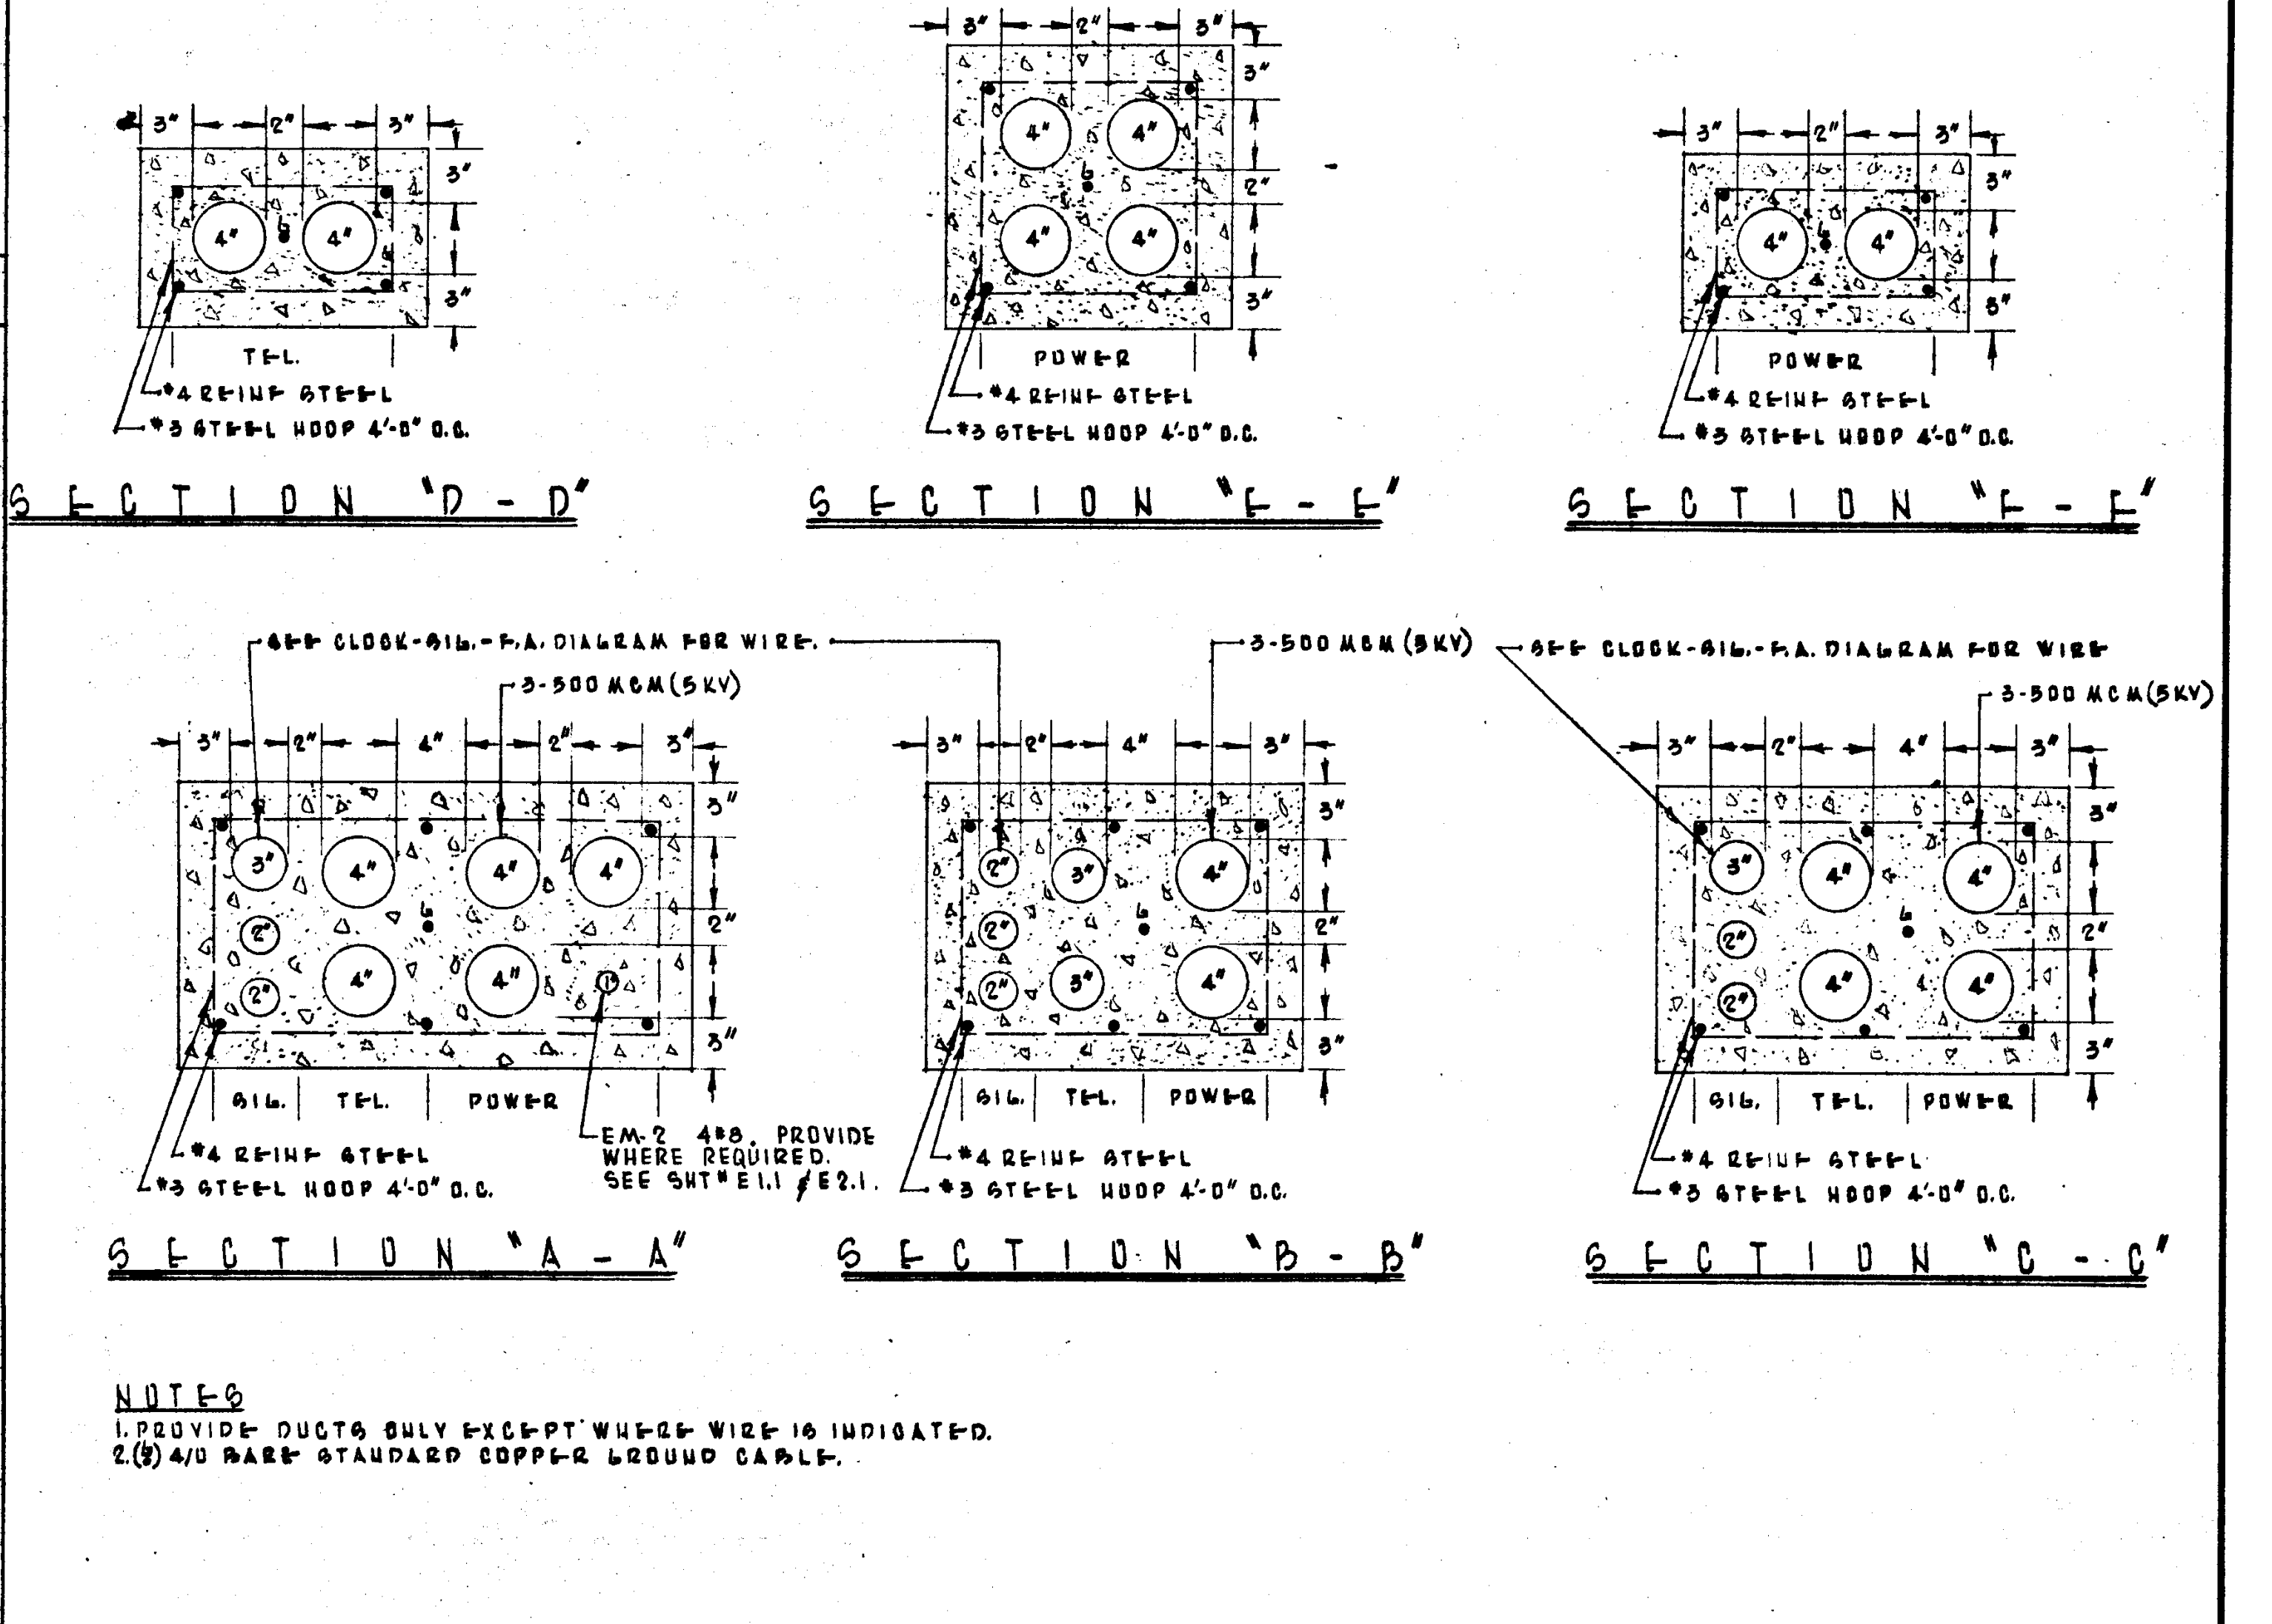


DUCT DETAILS SCALE 1/8\"/>


DATE	REVISIONS	DESIGNED	DRAWN BY	CHECKED BY	APPROVED	ASSOCIATED ARCHITECTS:
		BRANDOW & JOHNSON J.A. MARTIN & ASSOCIATES				WILLIAM L. PEREIRA & ASSOCIATES A. QUINCY JONES-FREDERICK E. EMMONS & ASSOCIATES BLUROCK ELLERBROEK & ASSOCIATES
		RAULPH E. PHILLIPS, INC.				URBANUS SQUARE • MACARTHUR BOULEVARD AT FORD ROAD TELEPHONE 714/675-2640 • CORONA DEL MAR, CALIFORNIA
		RAULPH E. PHILLIPS, INC.				
		G. SHURMAN & ASSOCIATES MOFFATT & NICHOL				

ALL UNITS	DATE	SHEET NO.
DIAGRAMS & DETAILS	6-15-65	E2.2

GOLDEN WEST COLLEGE
HUNTINGTON BEACH, CALIFORNIA
ORANGE COAST JUNIOR COLLEGE DISTRICT

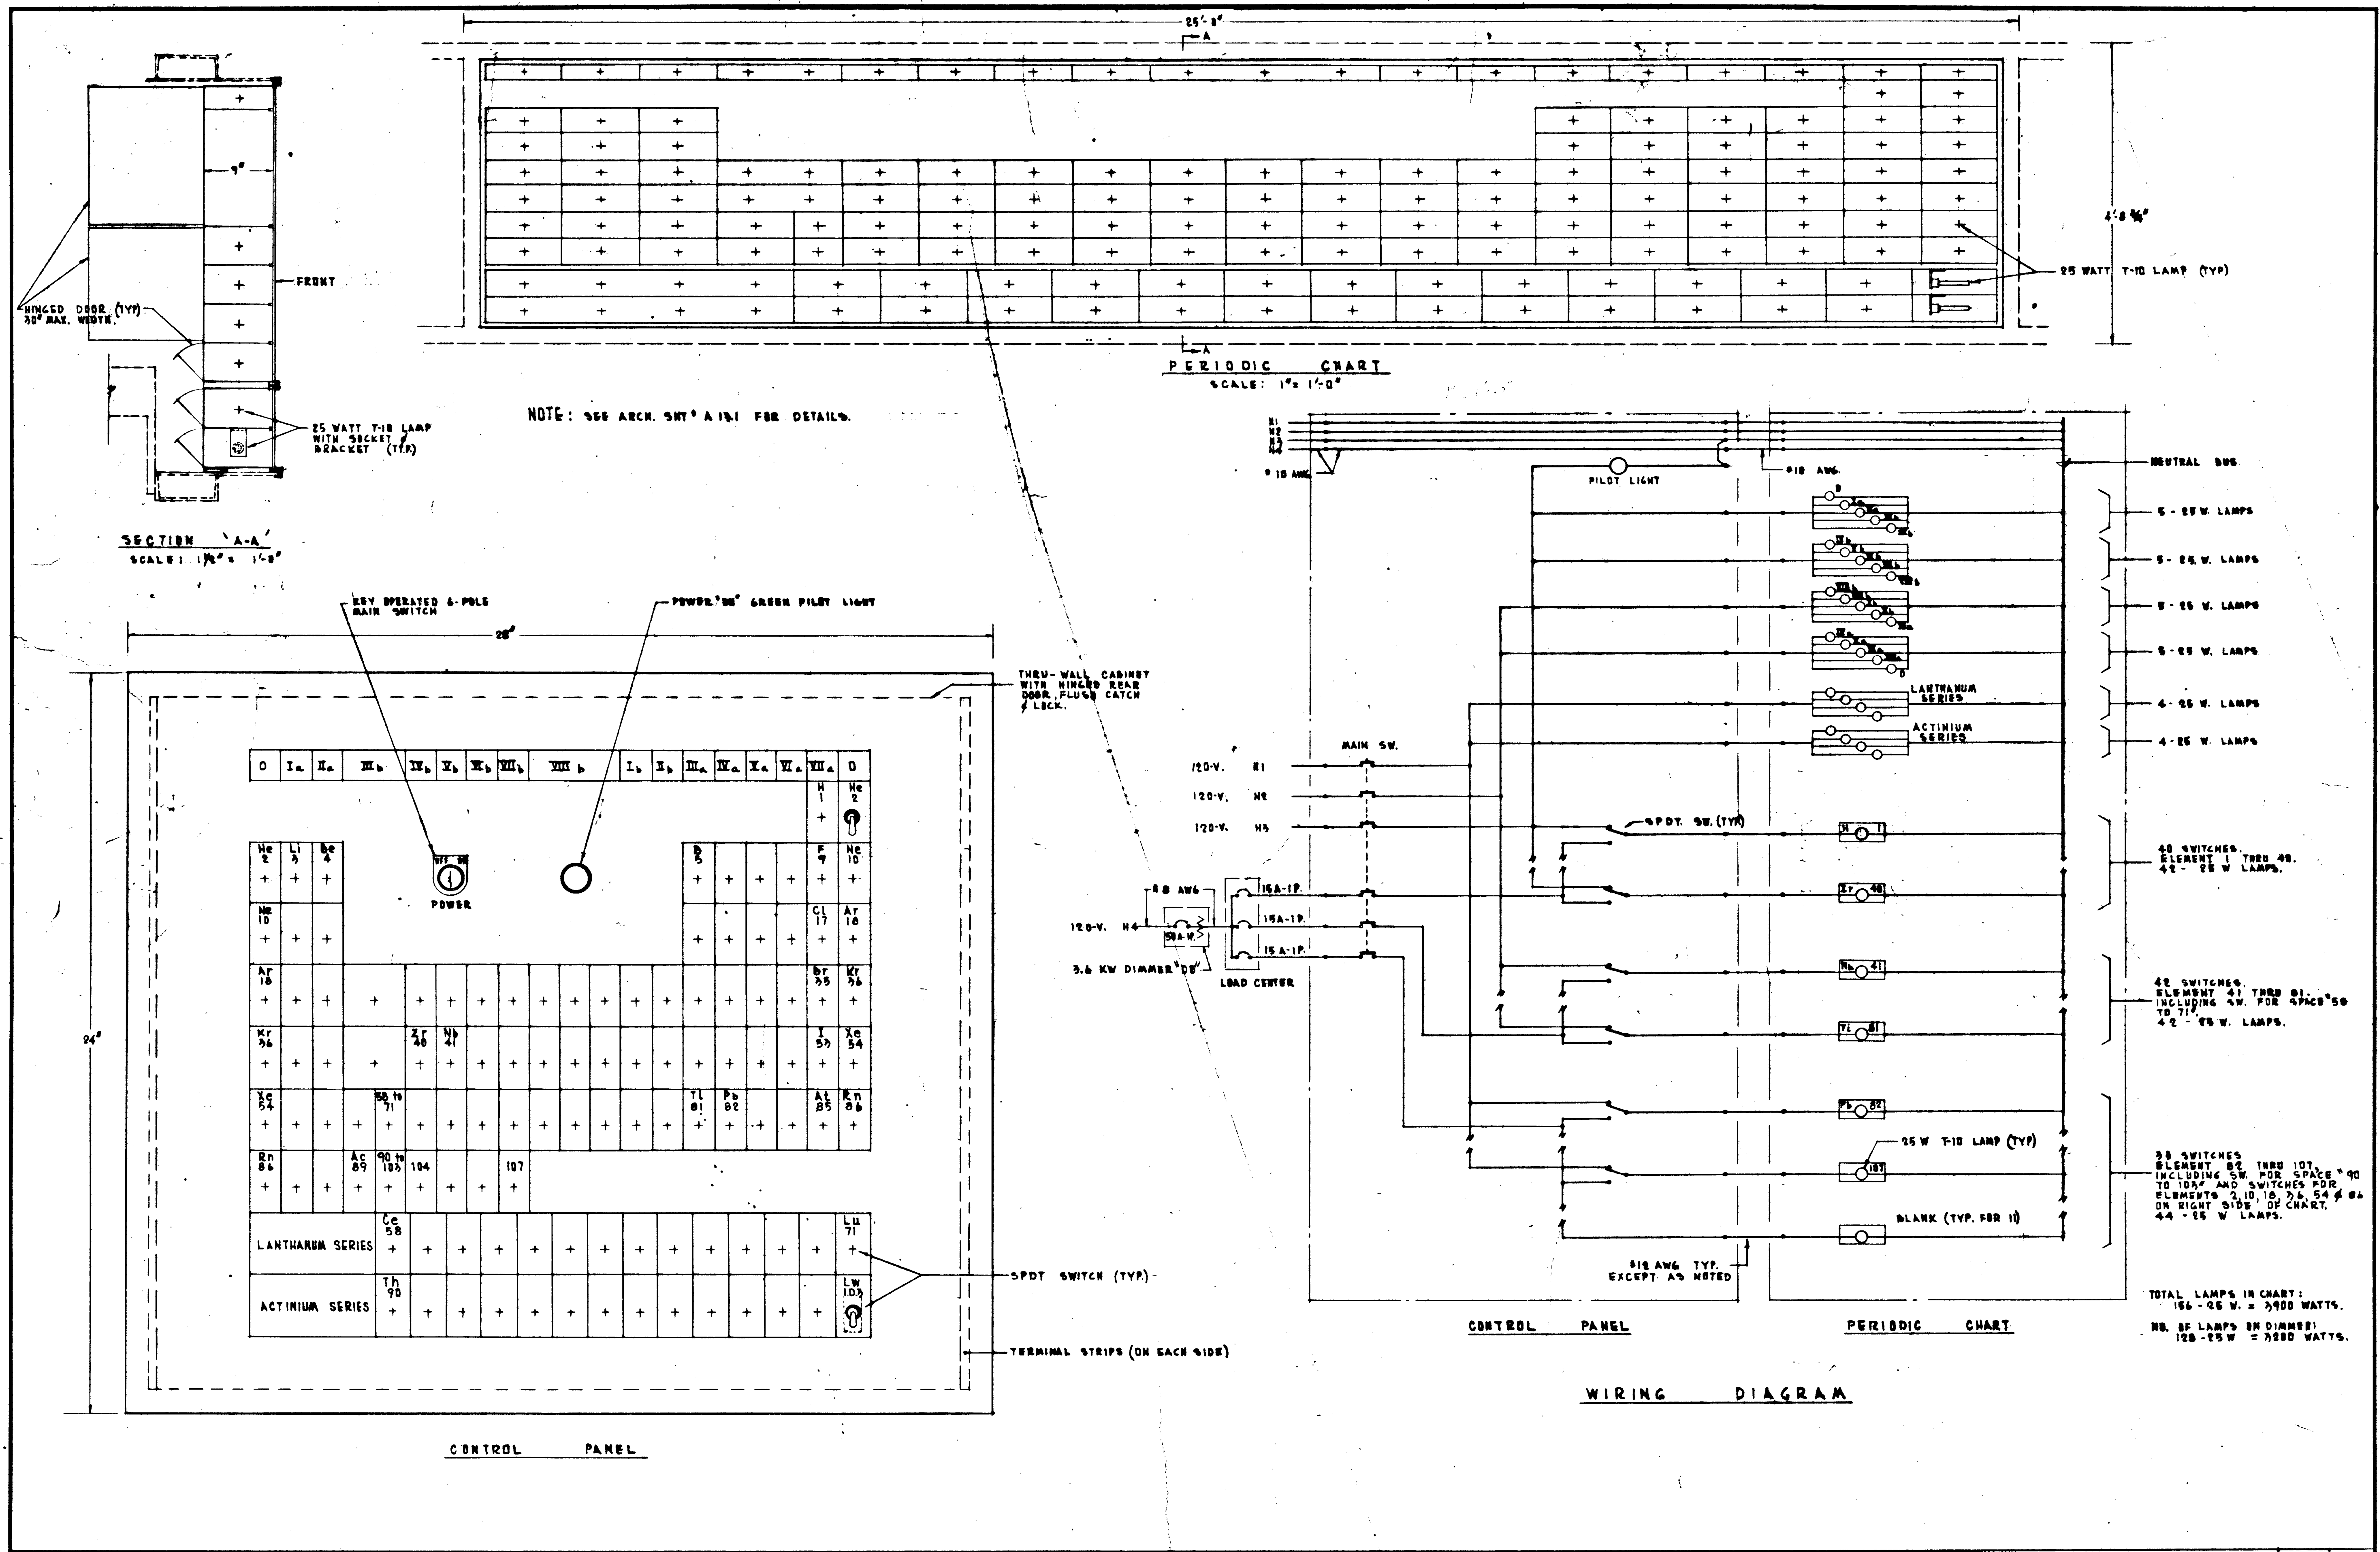


PERIODIC CHART DIAGRAM & DETAILS				SCALE	1
STRUCTURAL ENGINEERS BRADDOCK & JOHNSON J.A. MARTIN & ASSOCIATES MECHANICAL ENGINEERS RALPH E. PHILLIPS, INC. ELECTRICAL ENGINEERS RALPH E. PHILLIPS, INC. CIVIL ENGINEERS O. SHUTMAN & ASSOCIATES MOFFATT & NISBOL	DESIGNED DRAWN BY CHECKED BY DATE JUN 21 1965	ARCHITECT WILLIAM L. PEREIRA ASSOCIATED ARCHITECTS: WILLIAM L. PEREIRA & ASSOCIATES A. QUINCY JONES-FREDERICK E. EMMONS & ASSOCIATES BLUROCK ELLERBROCK & ASSOCIATES URBANUS SQUARE • MACARTHUR BOULEVARD AT FORD ROAD TELEPHONE 714/675-2640 • CORONA DEL MAR, CALIFORNIA	APPROVED STATE FIRE MARSHAL DATE JUN 21 1965 25874 APPROVED JUN 21 1965	UNIT 2 DIAGRAMS & DETAILS SHEET NO. E 2.4	JOB NO. 104 DATE 6-15-65


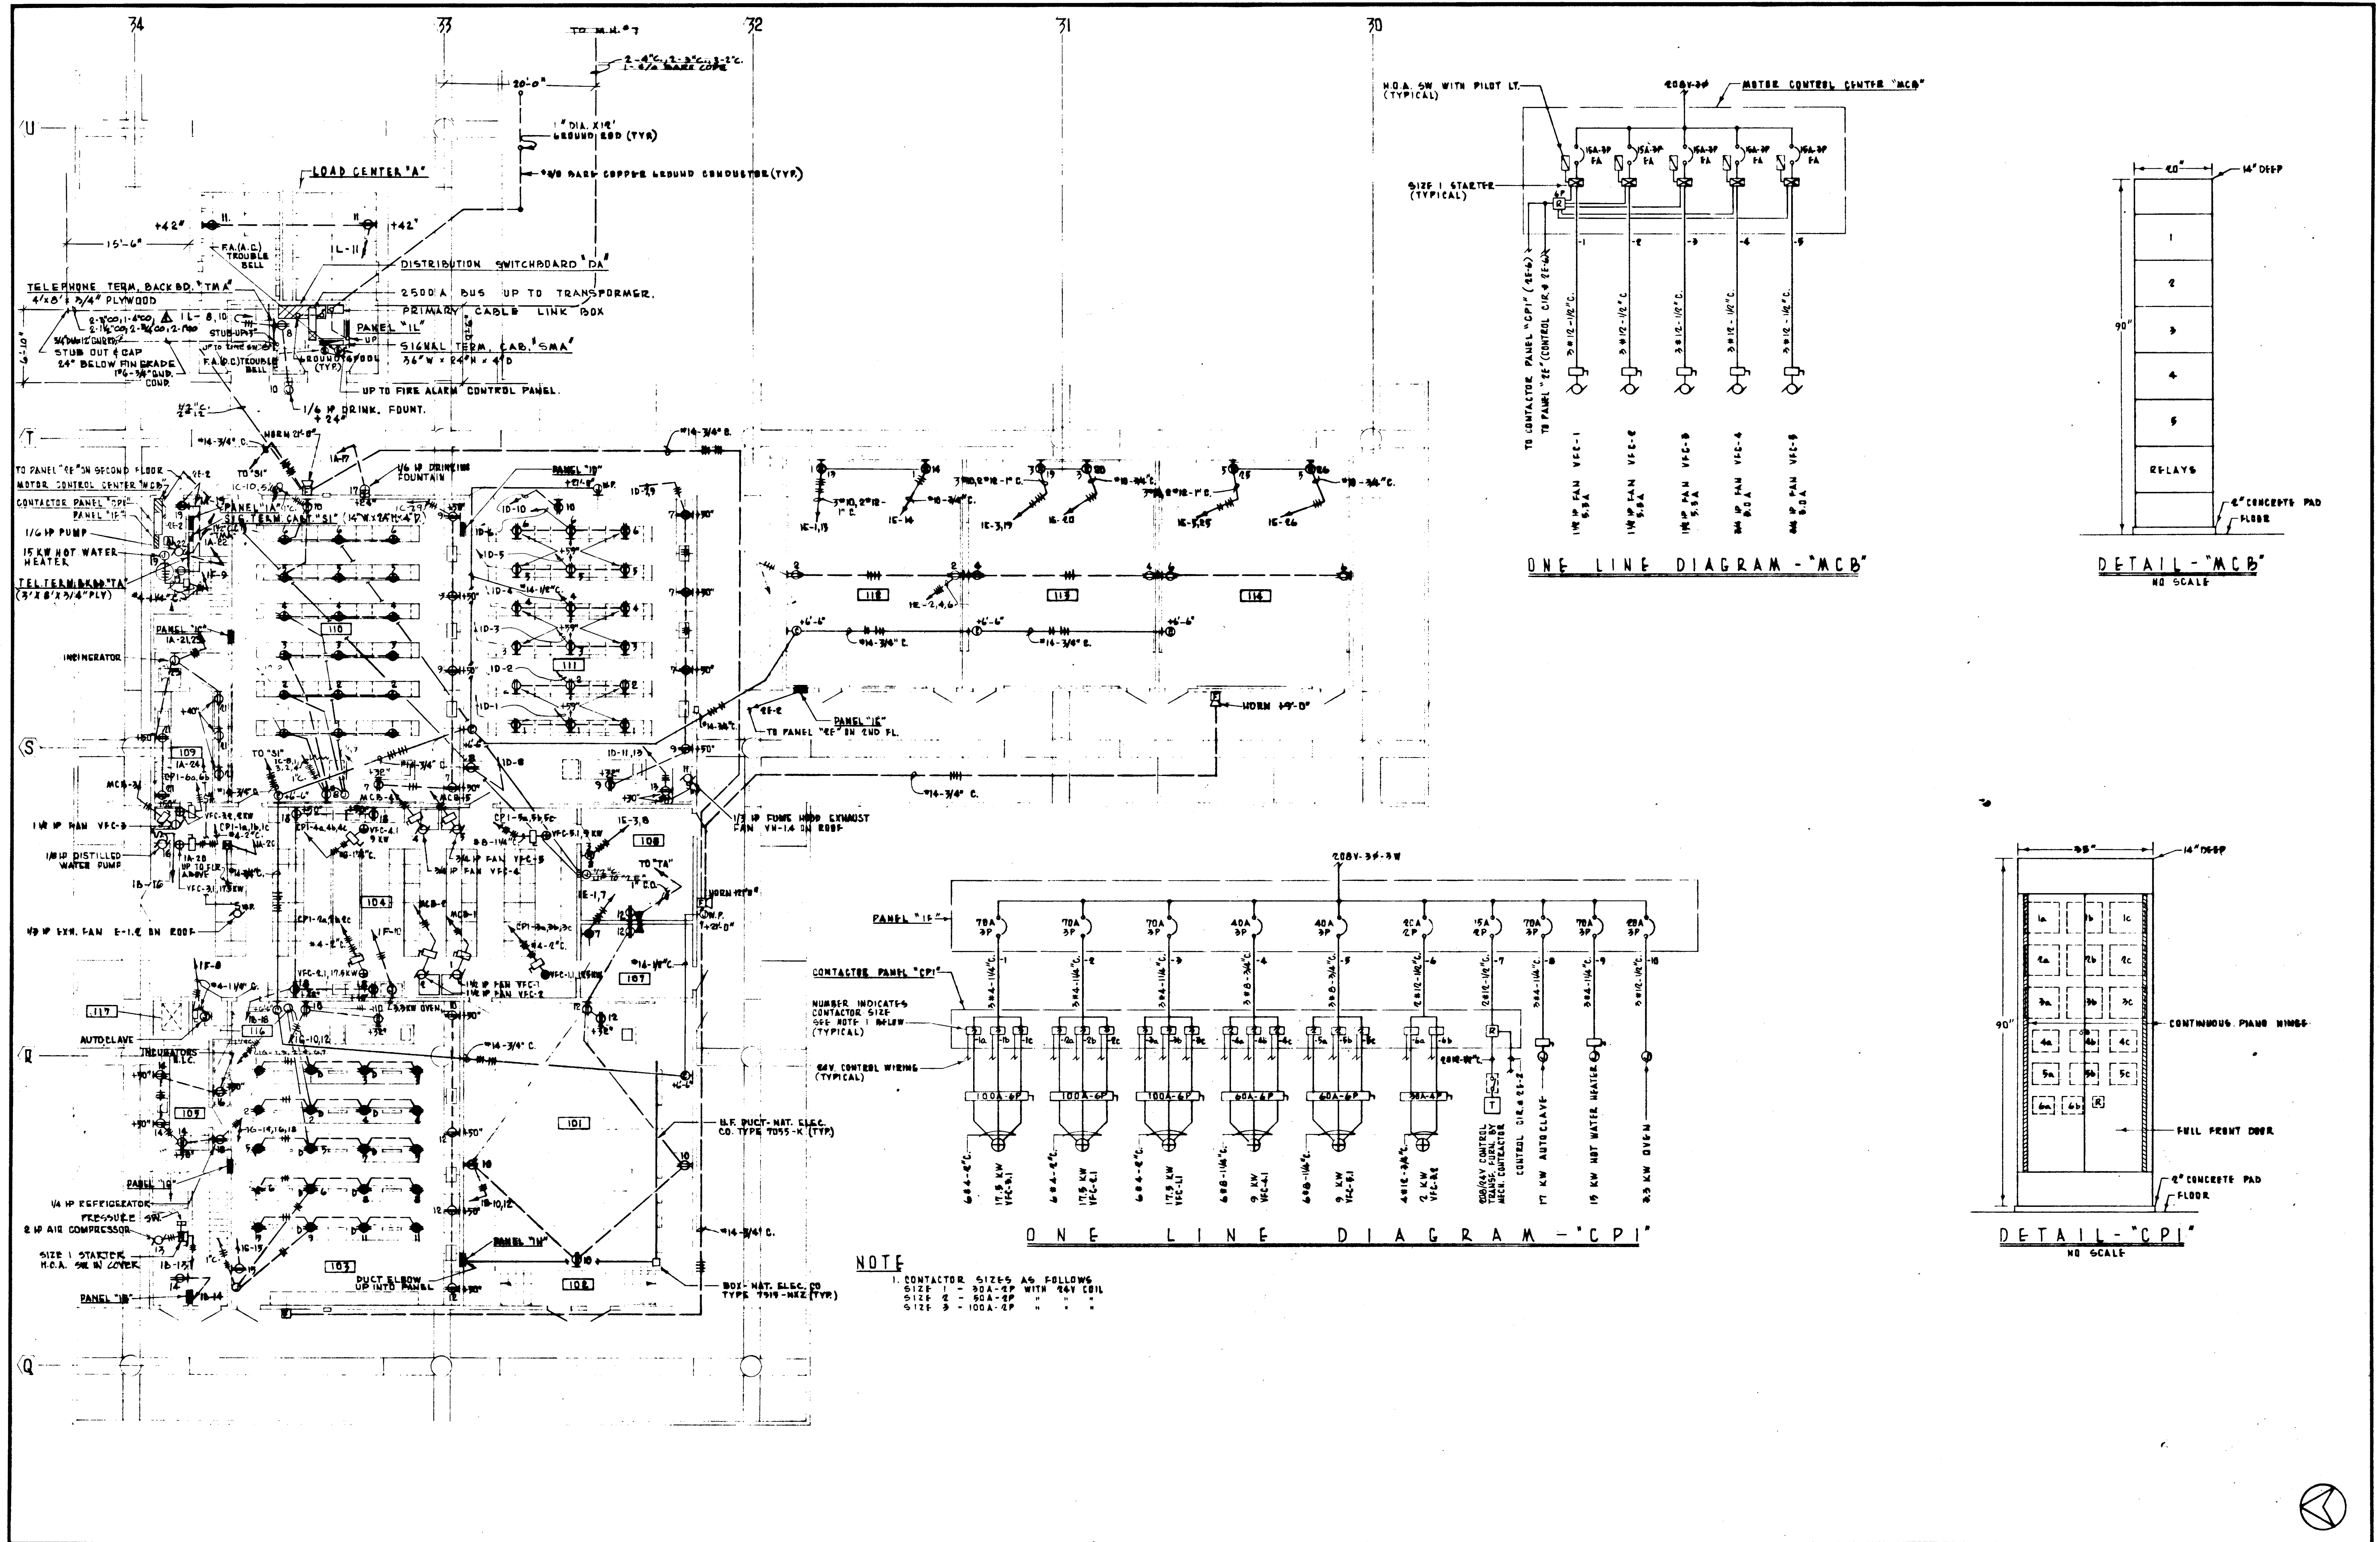


FIRST FLOOR POWER & SIGNAL

<p>REVISIONS</p>	<p>STRUCTURAL ENGINEERS BRADY & JOHNSON J.A. MARTIN & ASSOCIATES</p> <p>MECHANICAL ENGINEERS RALPH E. PHILLIPS, INC.</p> <p>ELECTRICAL ENGINEERS RALPH E. PHILLIPS, INC.</p> <p>CIVIL ENGINEERS O. SHURMAN & ASSOCIATES MOFFATT & RICHOL</p>	<p>DESIGNED DRAWN BY CHECKED BY</p> <p>APPROVED STATE FIRE MARSHAL STATE OF CALIFORNIA DATE JUN 14 1965</p> <p>35874-A-7000 JUN 14 1965</p>	<p>ASSOCIATED ARCHITECTS: WILLIAM L. PEREIRA & ASSOCIATES QUINCY JONES-FREDERICK E. EMMONS & ASSOCIATES BLUROCK ELLERBROCK & ASSOCIATES</p> <p>URBANUS SQUARE • MACARTHUR BOULEVARD AT FORD ROAD TELEPHONE 714/678-2640 • CORONA DEL MAR, CALIFORNIA</p>	<p>GOLDEN WEST COLLEGE HUNTINGTON BEACH, CALIFORNIA ORANGE COAST JUNIOR COLLEGE DISTRICT</p>	<p>UNIT 1 FLOOR PLAN</p> <p>SCALE 1/8"=1'-0" JOB NO. 104 DATE 6-15-65 SHEET NO. 123.2</p>
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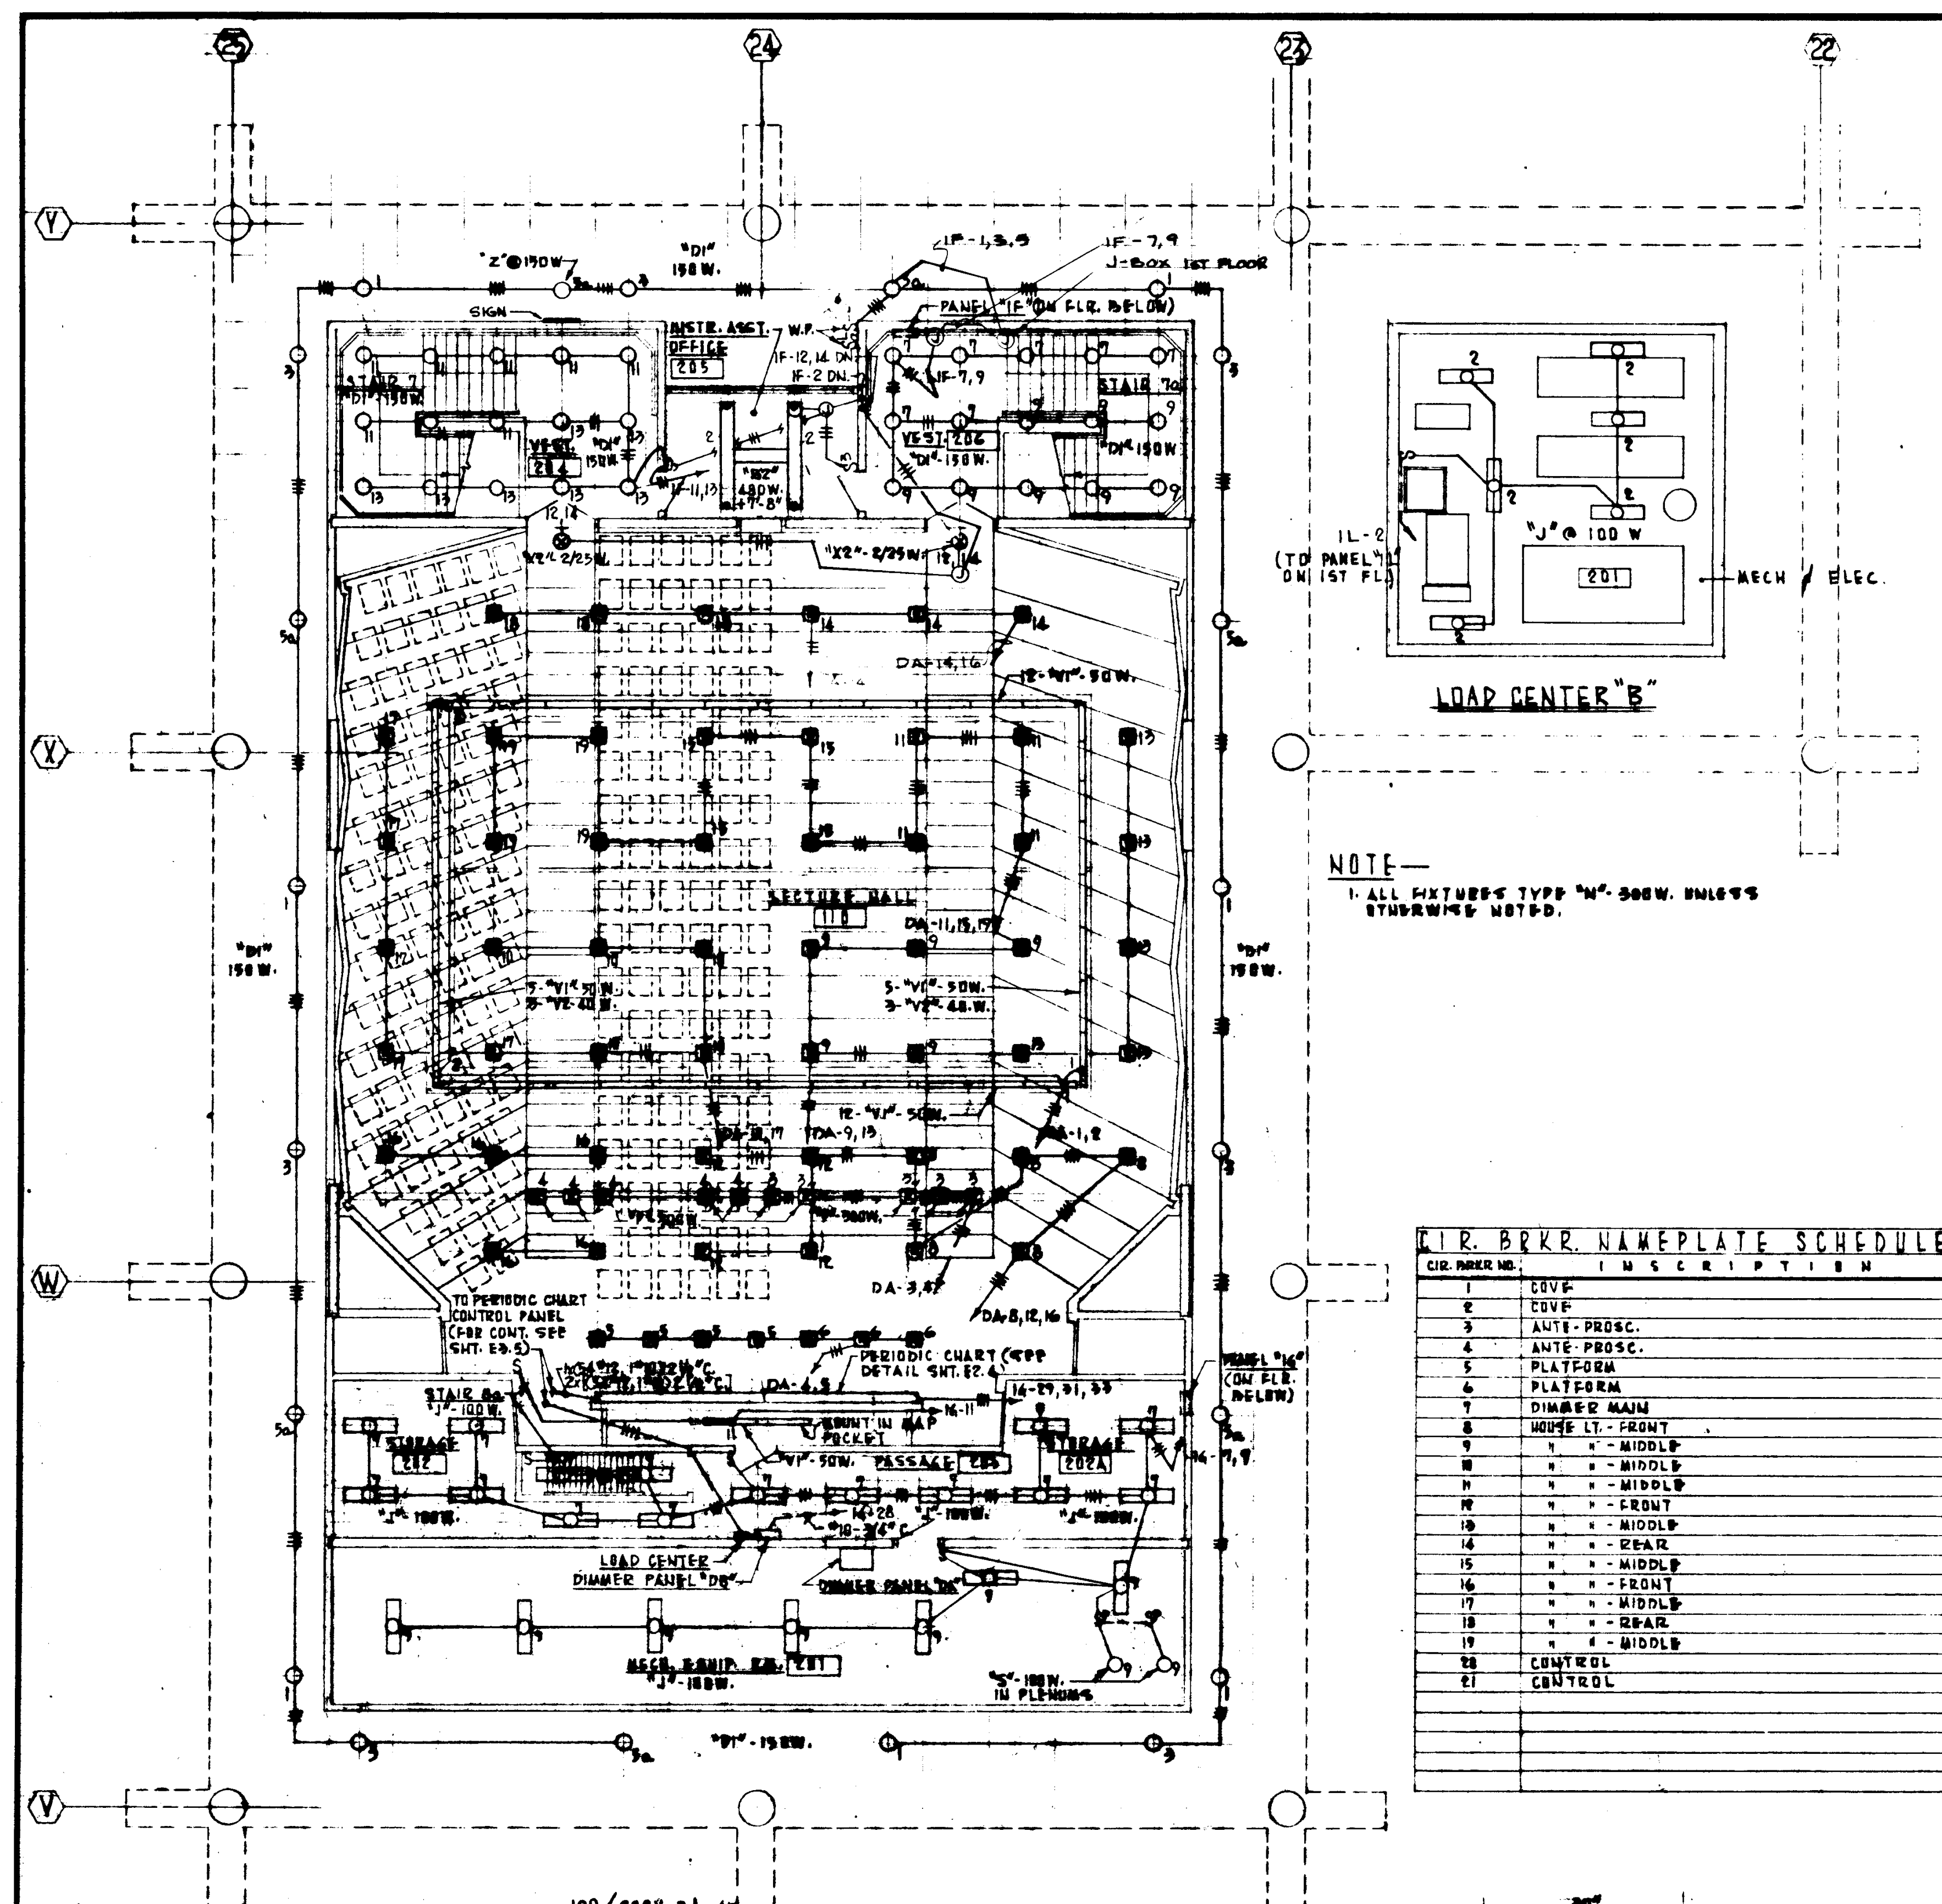


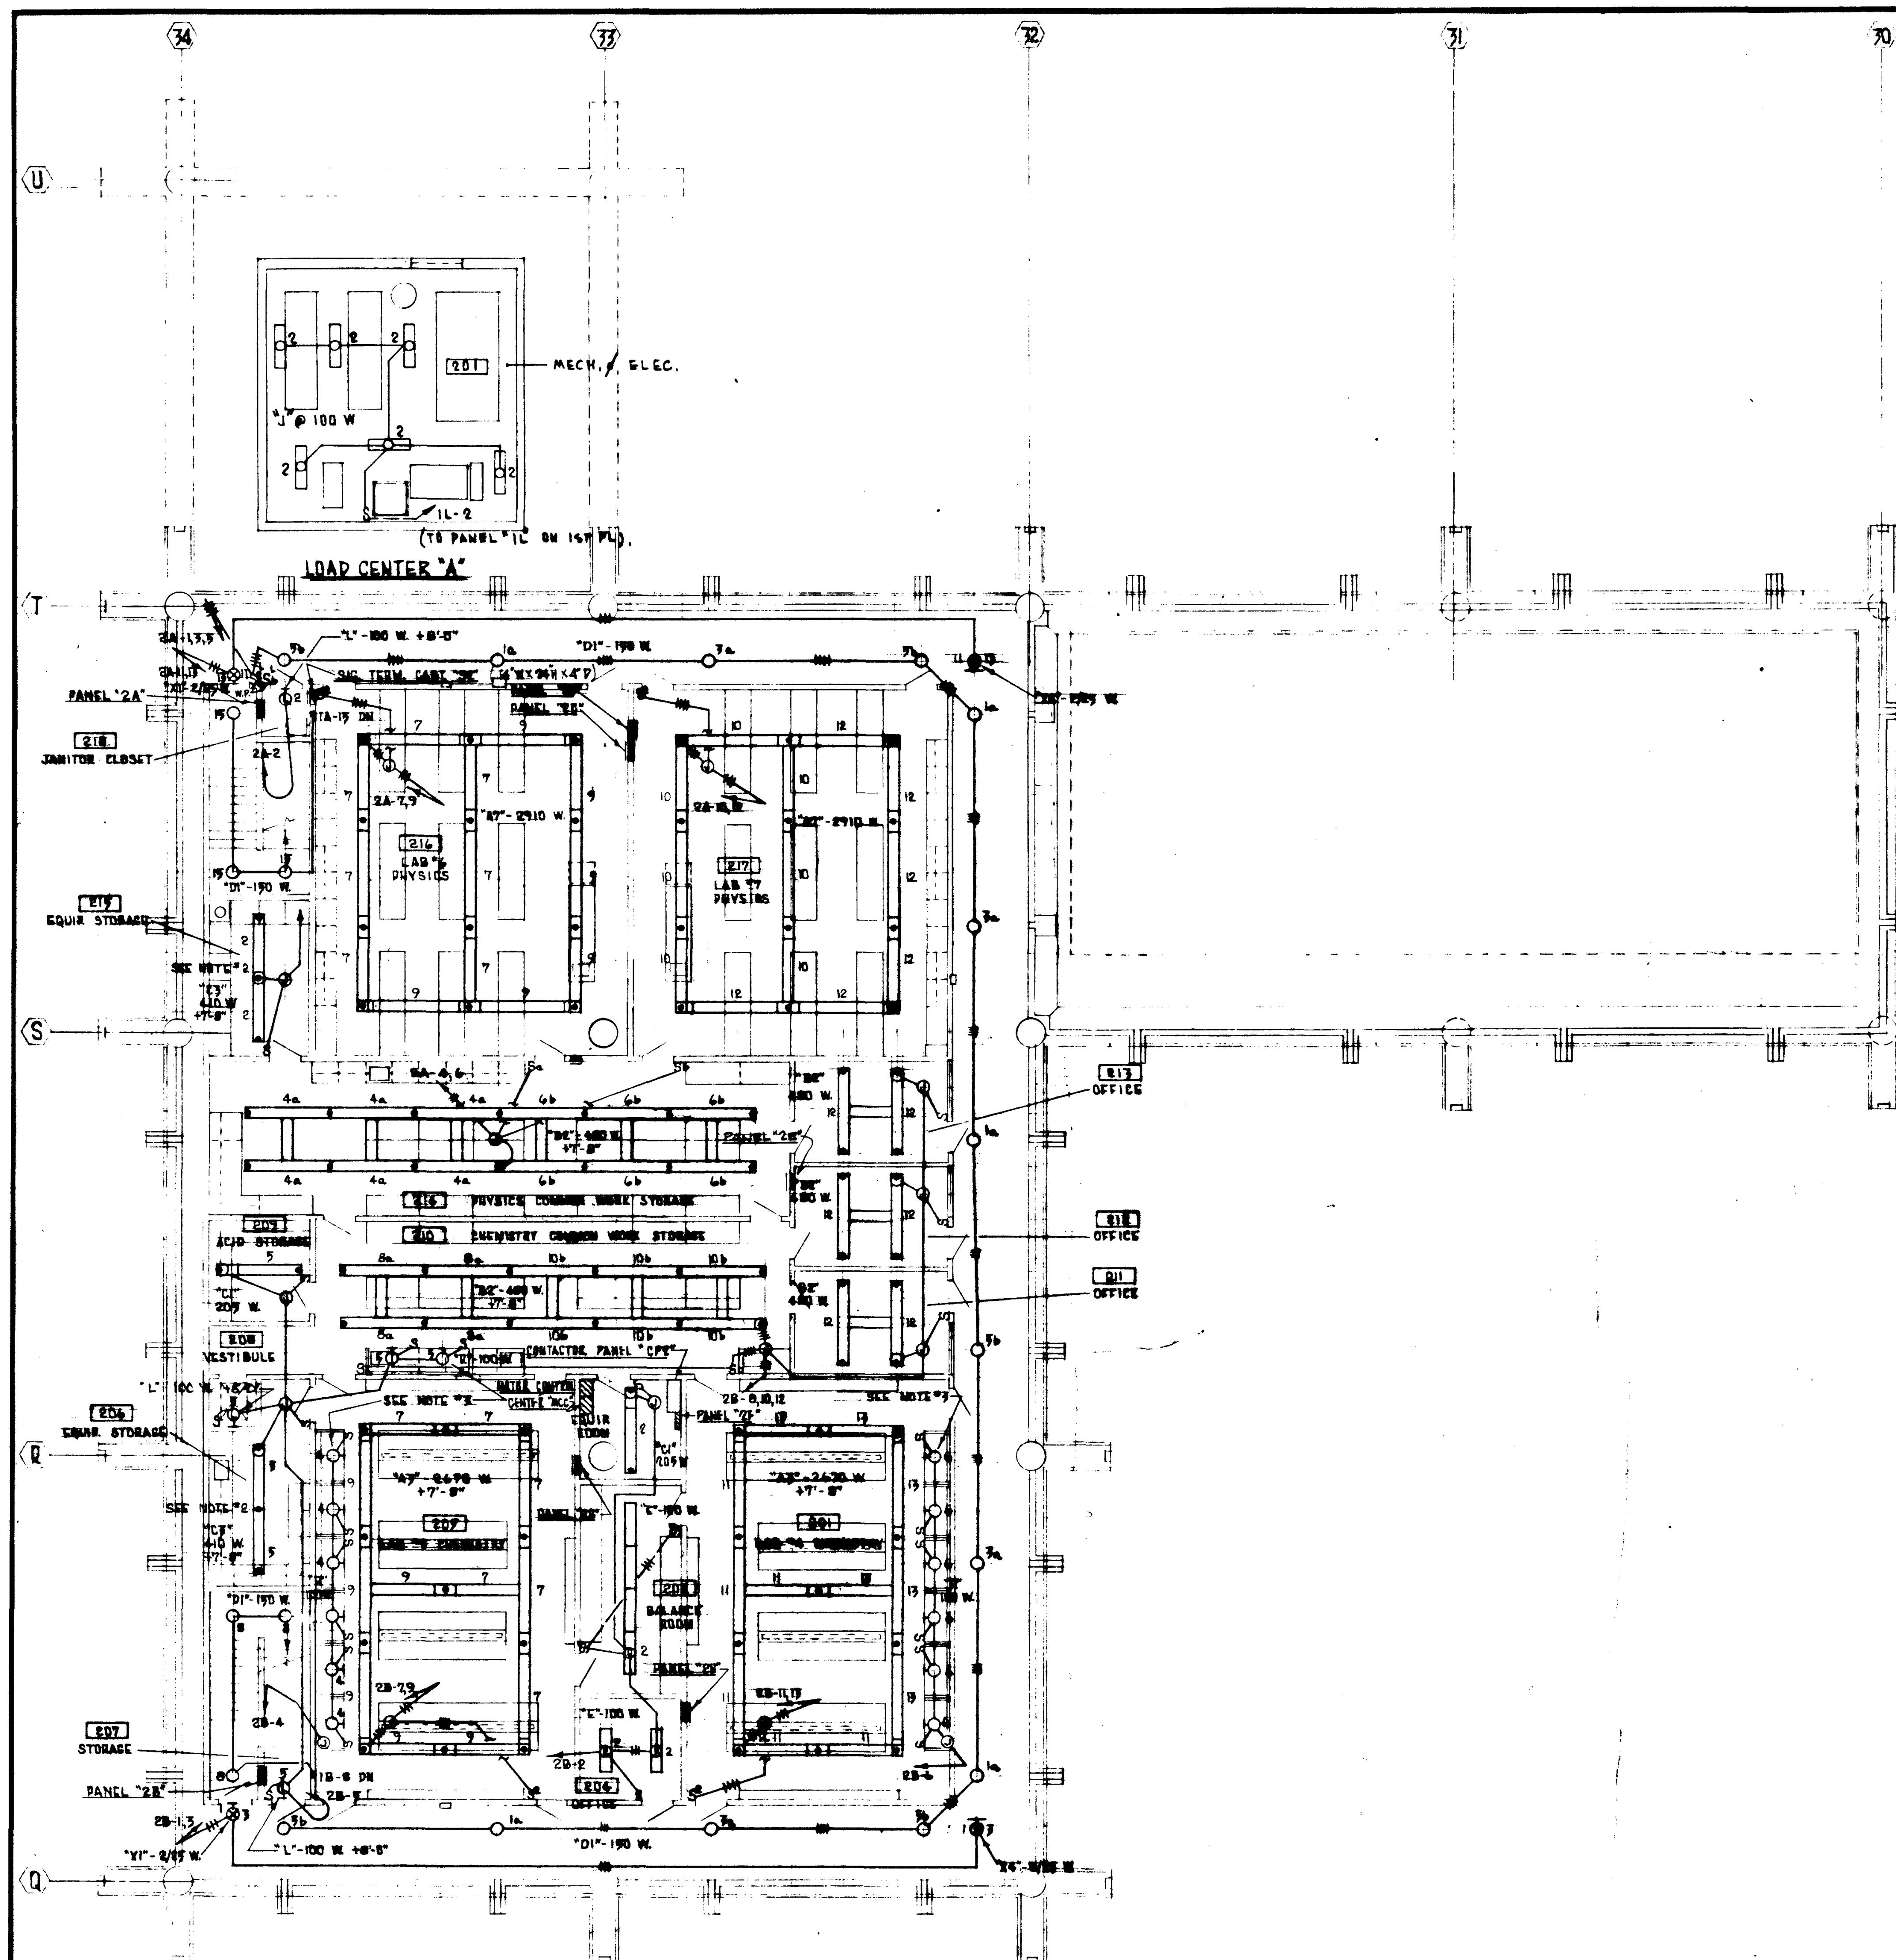PANEL '2D' SCHEDULE									
NO.	OUTLETS	WATTS	AMPS	NO.	OUTLETS	WATTS	AMPS	NO.	OUTLETS
1	2	3	4	5	6	7	8	9	10
1	1	100	0.45	1	1	100	0.45	1	1
2	1	100	0.45	2	1	100	0.45	2	1
3	1	100	0.45	3	1	100	0.45	3	1
4	1	100	0.45	4	1	100	0.45	4	1
5	1	100	0.45	5	1	100	0.45	5	1
6	1	100	0.45	6	1	100	0.45	6	1
7	1	100	0.45	7	1	100	0.45	7	1
8	1	100	0.45	8	1	100	0.45	8	1
9	1	100	0.45	9	1	100	0.45	9	1
10	1	100	0.45	10	1	100	0.45	10	1
11	1	100	0.45	11	1	100	0.45	11	1
12	1	100	0.45	12	1	100	0.45	12	1
13	1	100	0.45	13	1	100	0.45	13	1
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99	1	100	0.45	99	1	100	0.45	99	1
100	1	100	0.45	100	1	100	0.45	100	1
101	1	100	0.45	101	1	100	0.45	101	1
102	1	100	0.45	102	1	100	0.45	102	1
103	1	100	0.45	103	1	100	0.45	103	1
104	1	100	0.45	104	1	100	0.45	104	1
105	1	100	0.45	105	1	100	0.45	105	1
106	1	100	0.45	106	1	100	0.45	106	1
107	1	100	0.45	107	1	100	0.45	107	1
108	1	100	0.45	108	1	100	0.45	108	1
109	1	100	0.45	109	1	100	0.45	109	1
110	1	100	0.45	110	1	100	0.45	110	1
111	1	100	0.45	111	1	100	0.45	111	1
112	1	100	0.45	112	1	100	0.45	112	1
113	1	100	0.45	113	1	100	0.45	113	1
114	1	100	0.45	114	1	100	0.45	114	1
115	1	100	0.45	115	1	100	0.45	115	1
116	1	100	0.45	116	1	100	0.45	116	1
117	1	100	0.45	117	1	100	0.45	117	1
118	1	100	0.45	118	1	100	0.45	118	1
119	1	100	0.45	119	1	100	0.45	119	1
120	1	100	0.45	120	1	100	0.45	120	1
121	1	100	0.45	121	1	100	0.45	121	1
122	1	100	0.45	122	1	100	0.45	122	1
123	1	100	0.45	123	1	100	0.45	123	1
124	1	100	0.45	124	1	100	0.45	124	1
125	1	100	0.45	125	1	100	0.45	125	1
126	1	100	0.45	126	1	100	0.45	126	1
127	1	100	0.45	127	1	100	0.45	127	1
128	1	100	0.45	128	1	100	0.45	128	1
129	1	100	0.45	129	1	100	0.45	129	1
130	1	100	0.45	130	1	100	0.45	130	1
131	1	100	0.45	131	1	100	0.45	131	1
132	1	100	0.45	132	1	100	0.45	132	1
133	1	100	0.45	133	1	100	0.45	133	1
134	1	100	0.45	134	1	100	0.45	134	1
135	1	100	0.45	135	1	100	0.45	135	1
136	1	100	0.45	136	1	100	0.45	136	1
137	1	100	0.45	137	1	100	0.45	137	1
138	1	100	0.45	138	1	100	0.45	138	1
139	1	100	0.45	139	1	100	0.45	139	1
140	1	100	0.45	140	1	100	0.45	140	1
141	1	100	0.45	141	1	100	0.45	141	1
142	1	100	0.45	142	1	100	0.45	142	1
143	1	100	0.45	143	1	100	0.45	143	1
144	1	100	0.45	144	1	100	0.45	144	1
145	1	100	0.45	145	1	100	0.45	145	1
146	1	100	0.45	146	1	100	0.45	146	1
147	1	100	0.45	147	1	100	0.45	147	1
148	1	100	0.45	148	1	100	0.45	148	1
149	1	100	0.45	149	1	100	0.45	149	1
150	1	100	0.45	150	1	100			

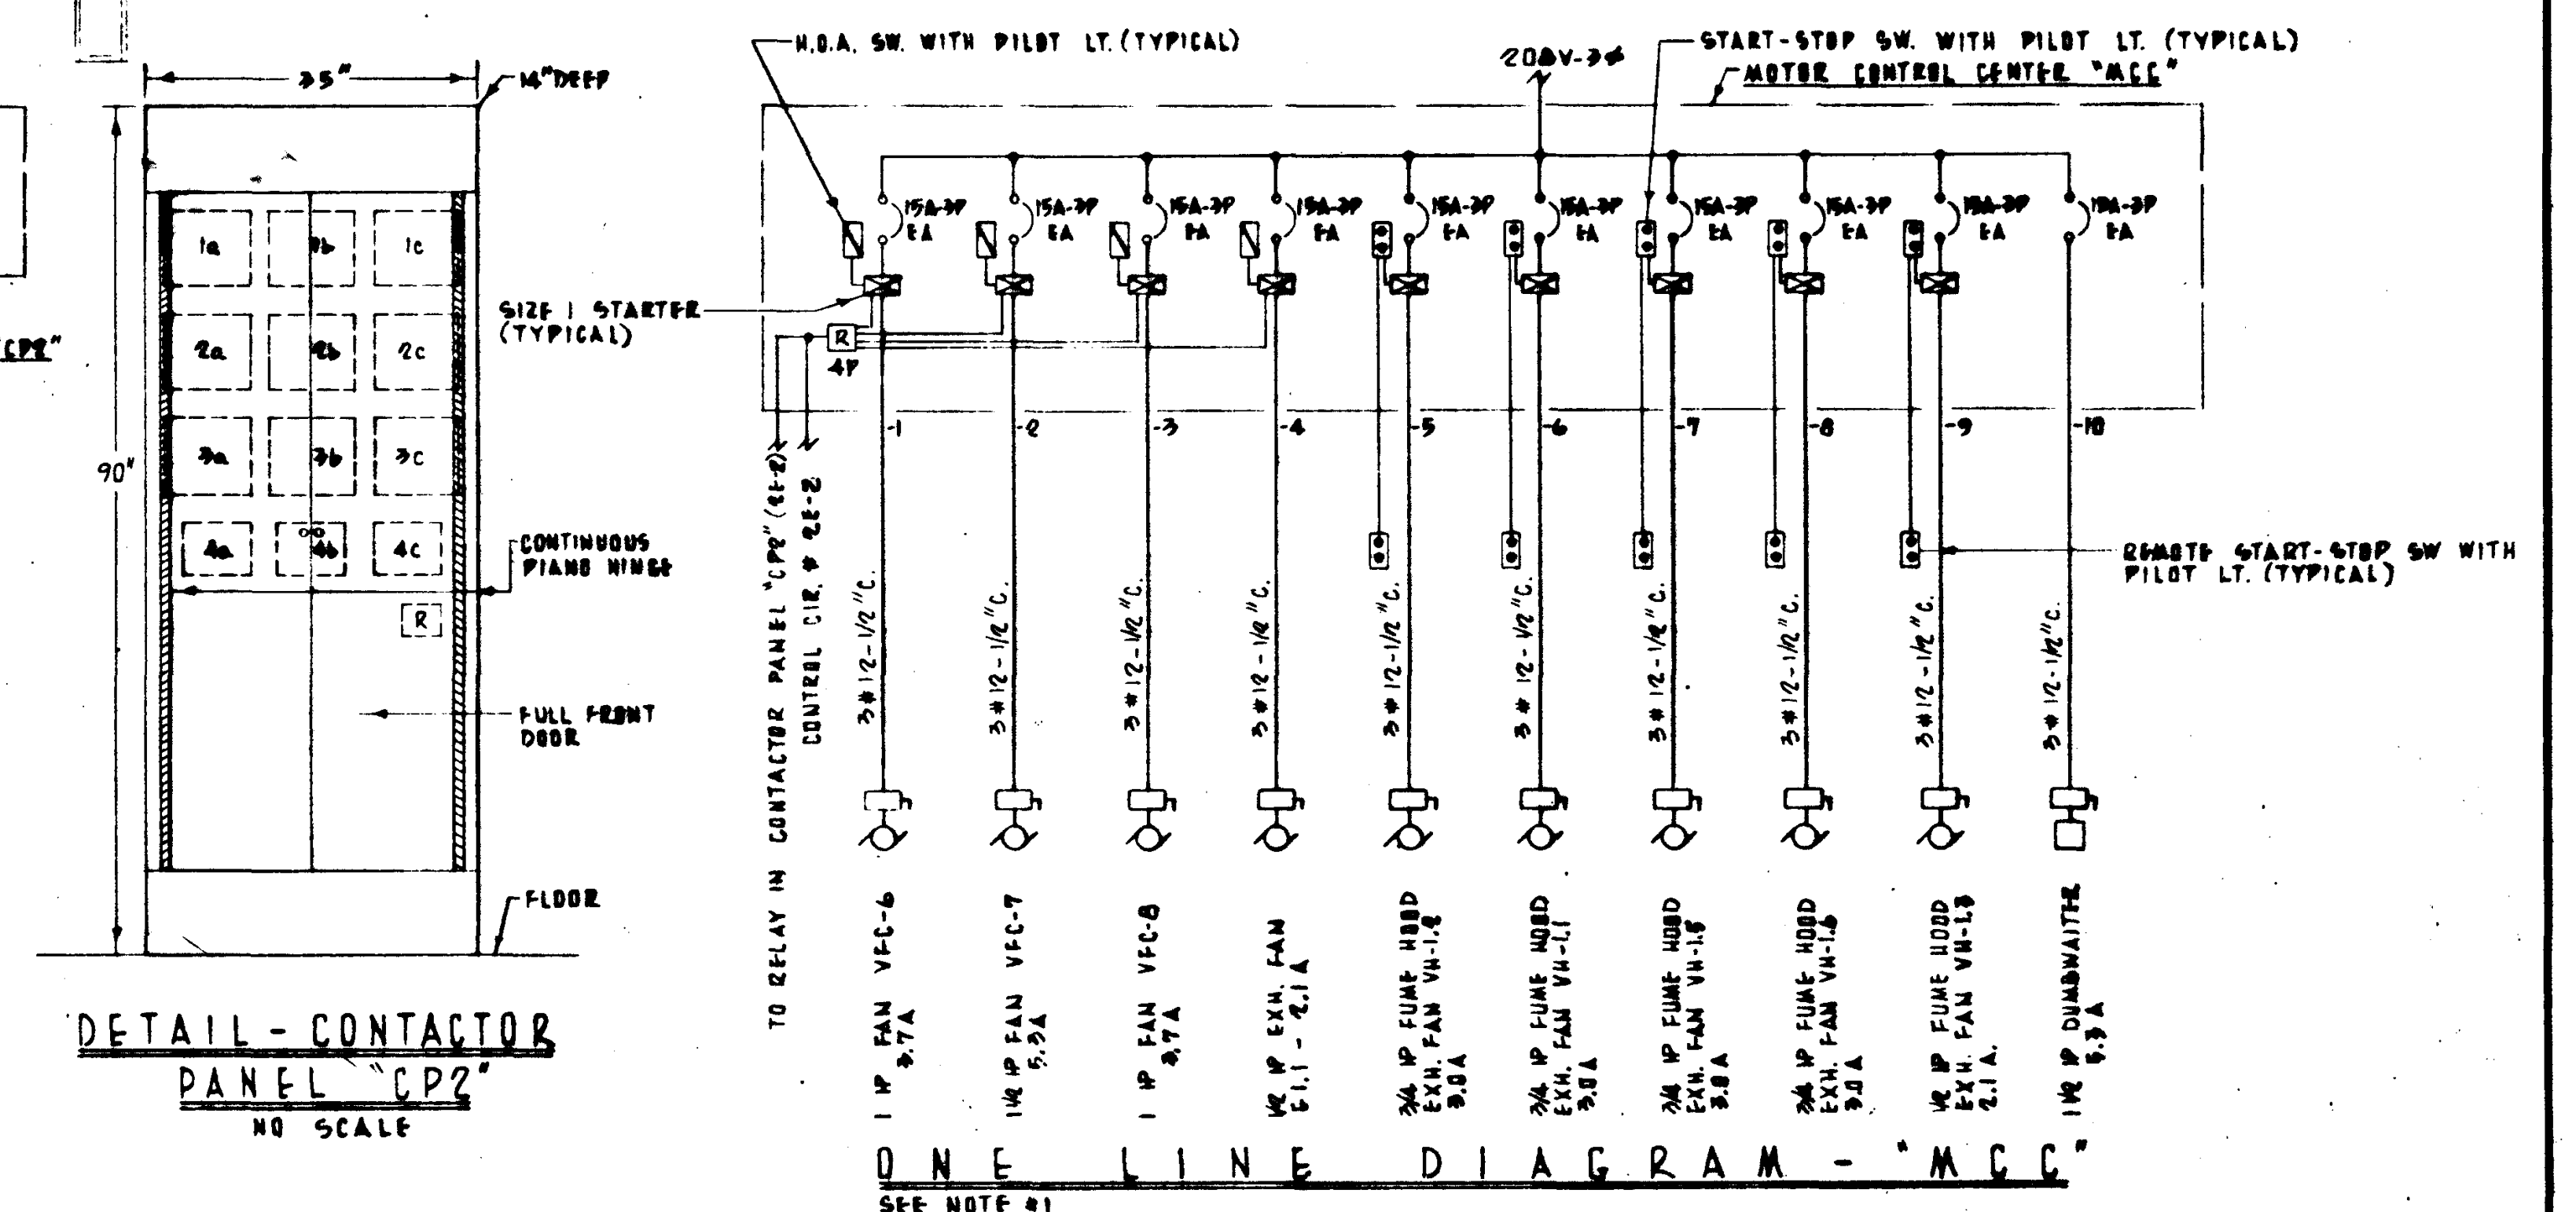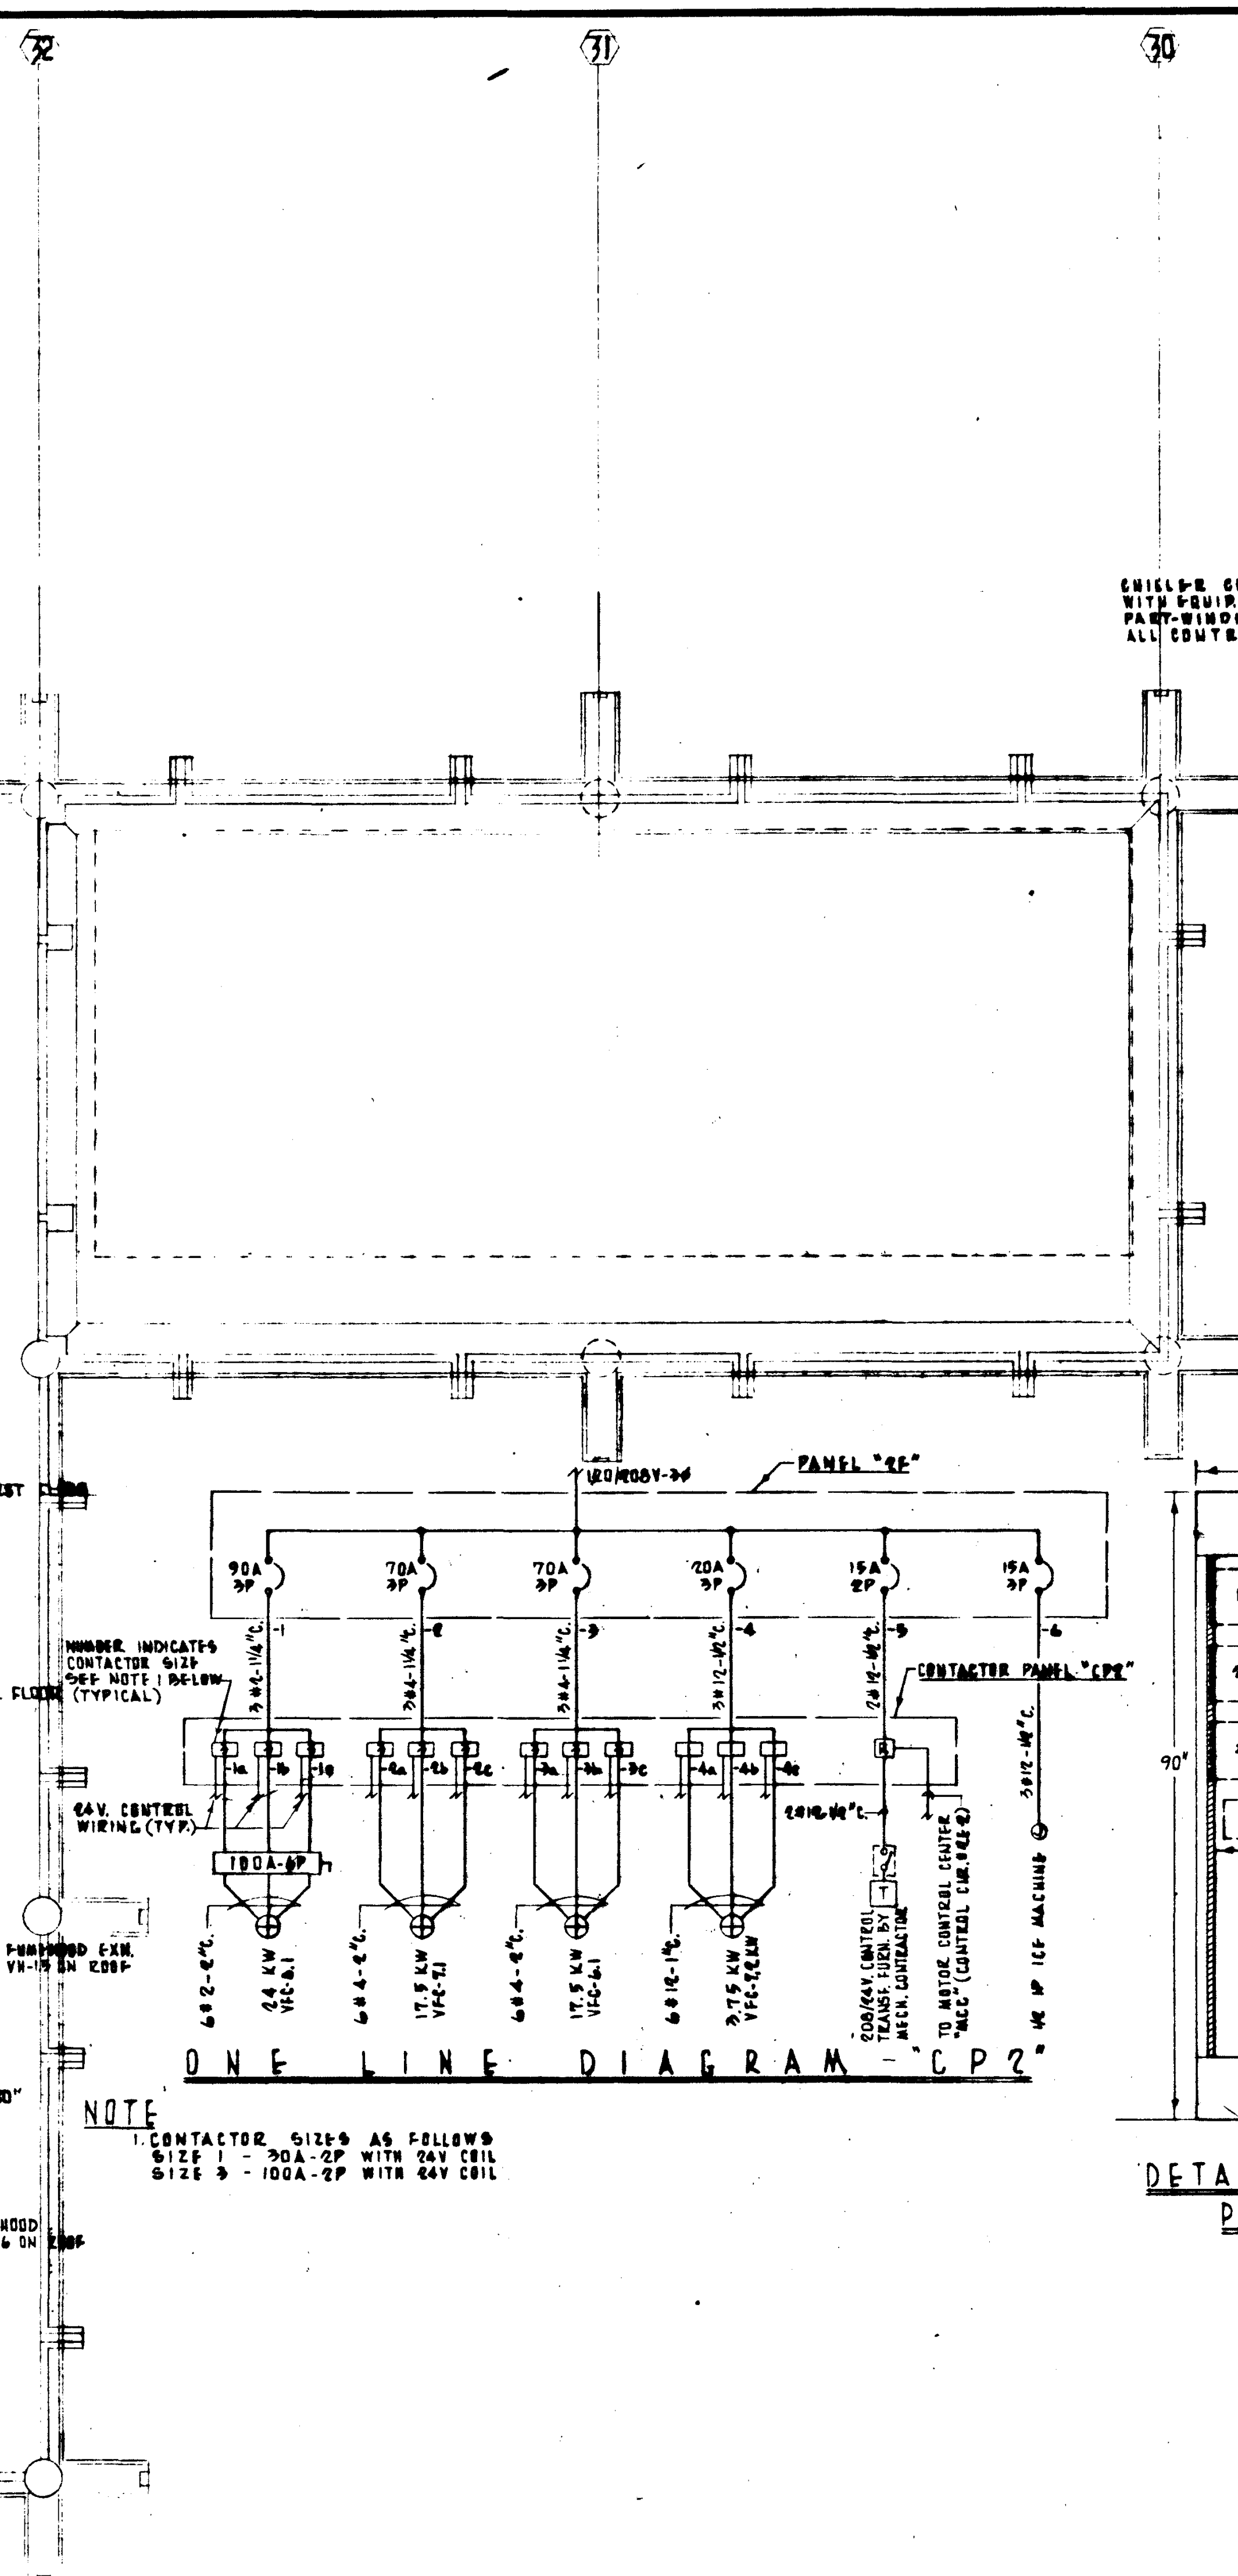




SECOND FLOOR POWER & SIGNAL

[illegible]



1. P. BRKR. NAMEPLATE SCHEDULE


CIR. BRKR. NO.	DESCRIPTION
1	COVE.
2	COVE.
3	AUTO. PROSC.
4	ANTI. PROSC.
5	PLATFORM
6	PLATFORM
7	DIMMER MAIN
8	HOUSE LT. FRONT
9	" " MIDDLE
10	" " MIDDLE
11	" " MIDDLE
12	" " MIDDLE
13	" " MIDDLE
14	" " MIDDLE
15	" " MIDDLE
16	" " MIDDLE
17	" " MIDDLE
18	" " MIDDLE
19	" " MIDDLE
20	" " MIDDLE
21	CONTROL

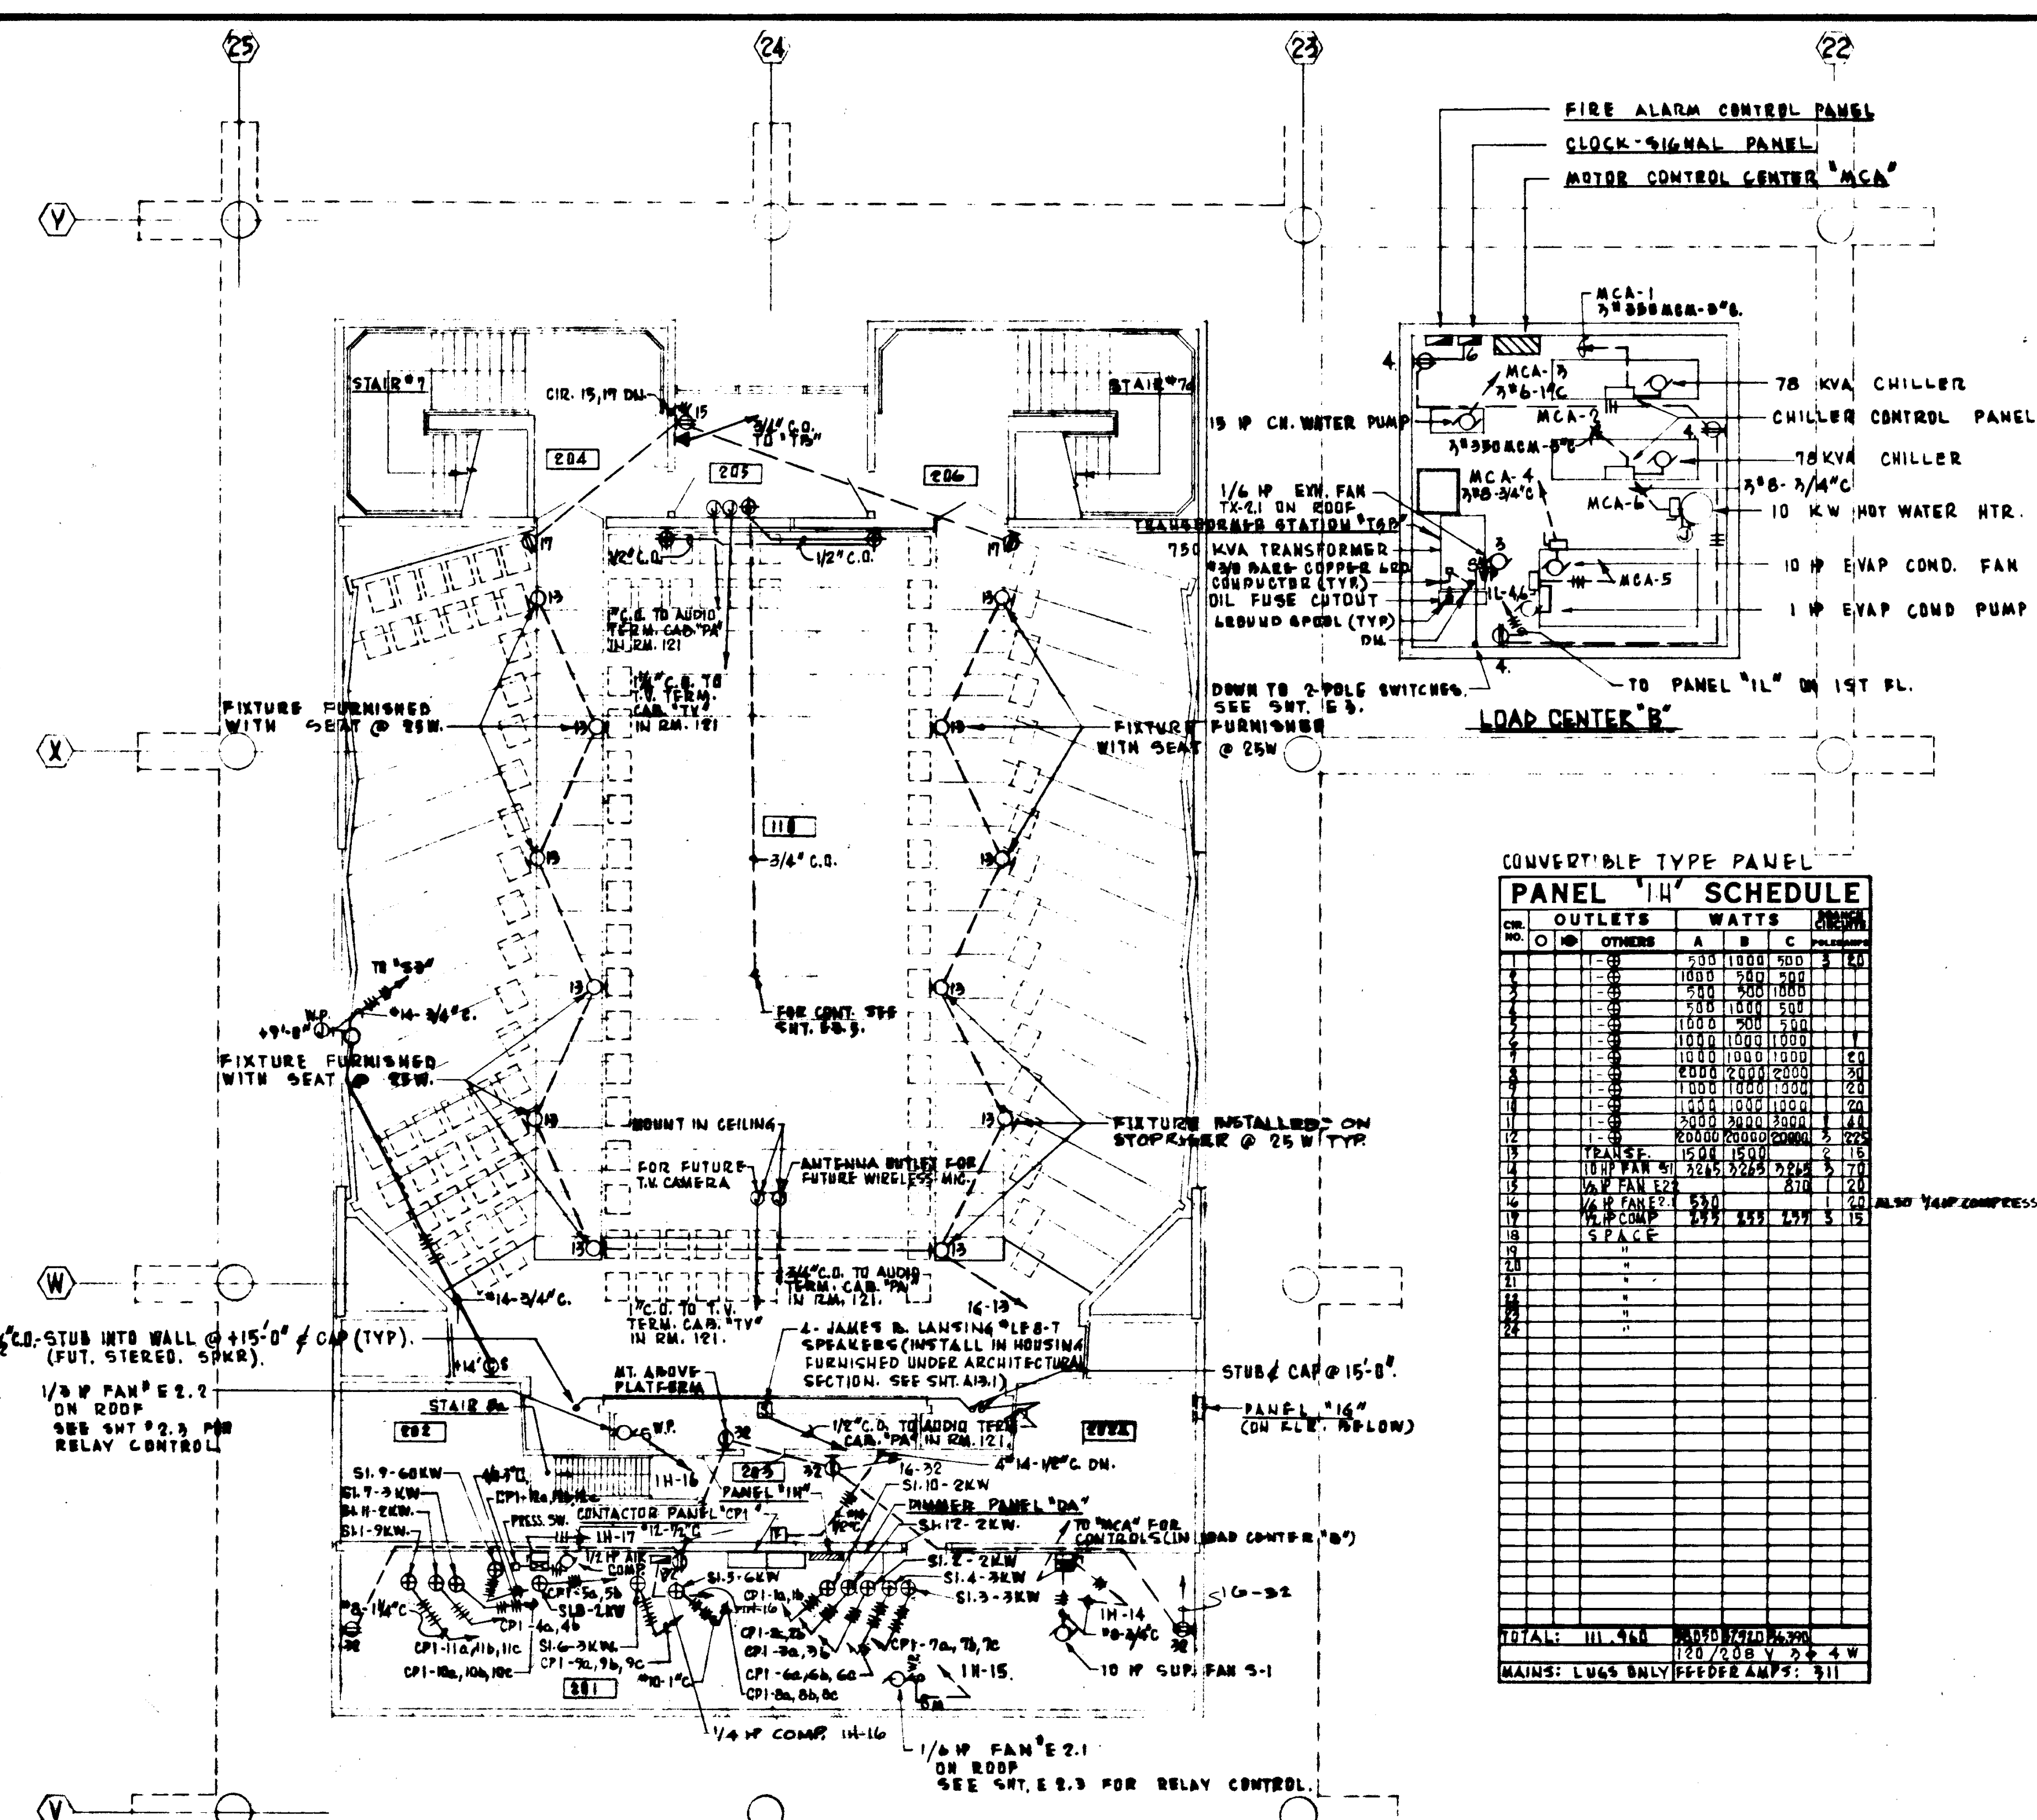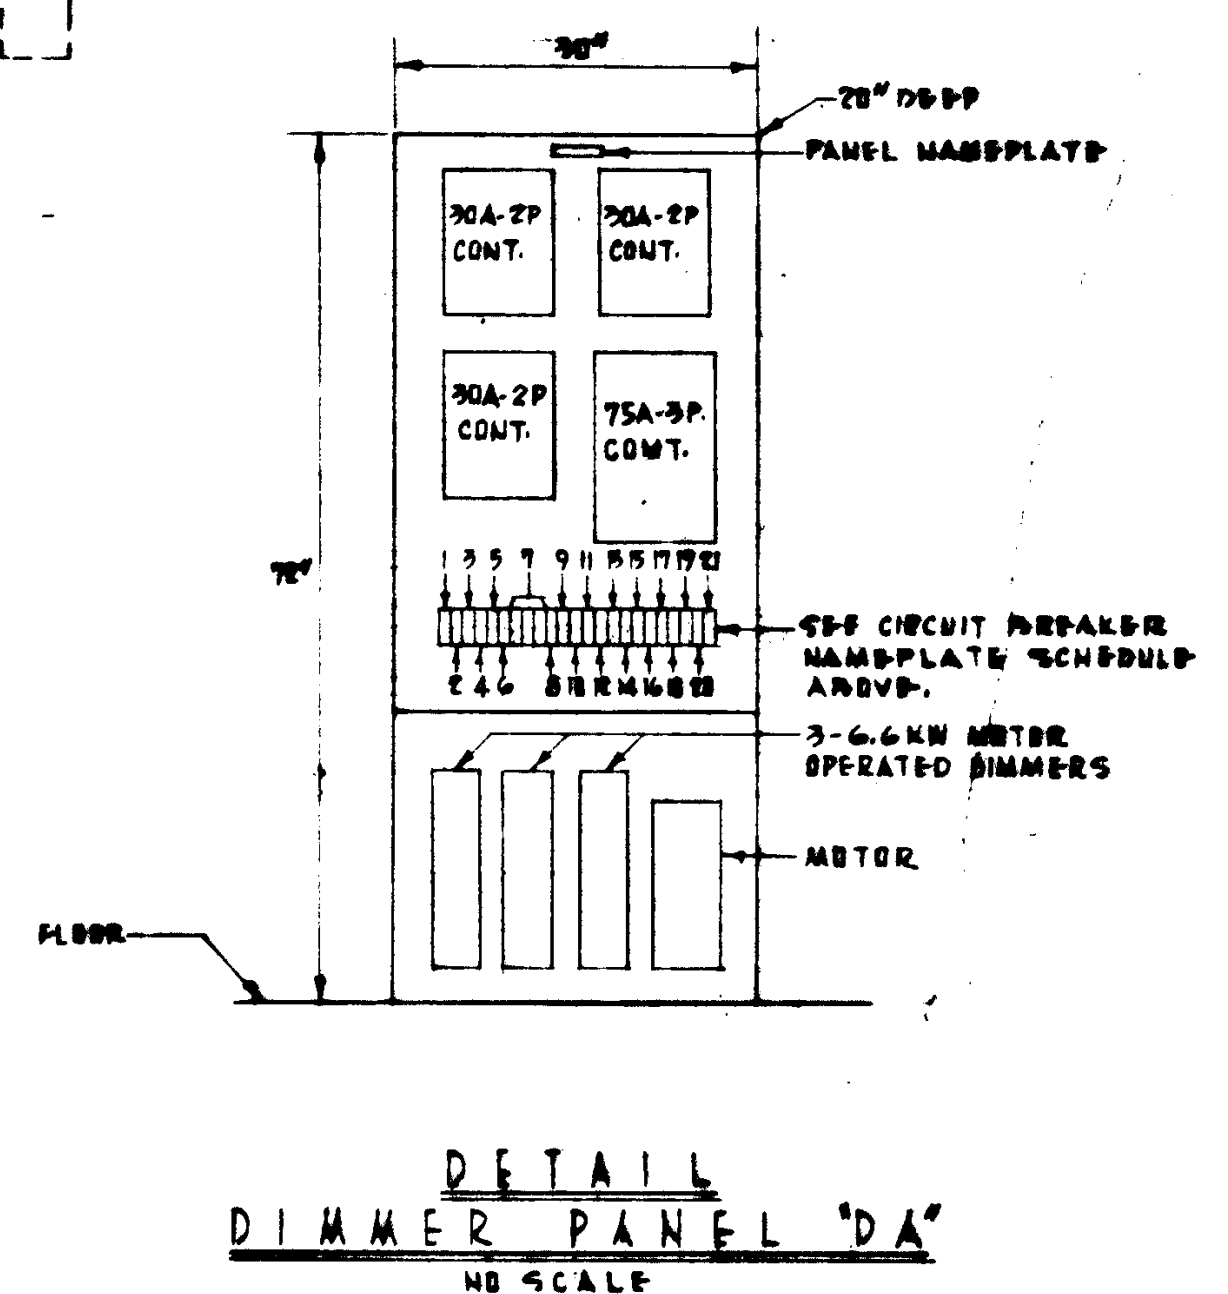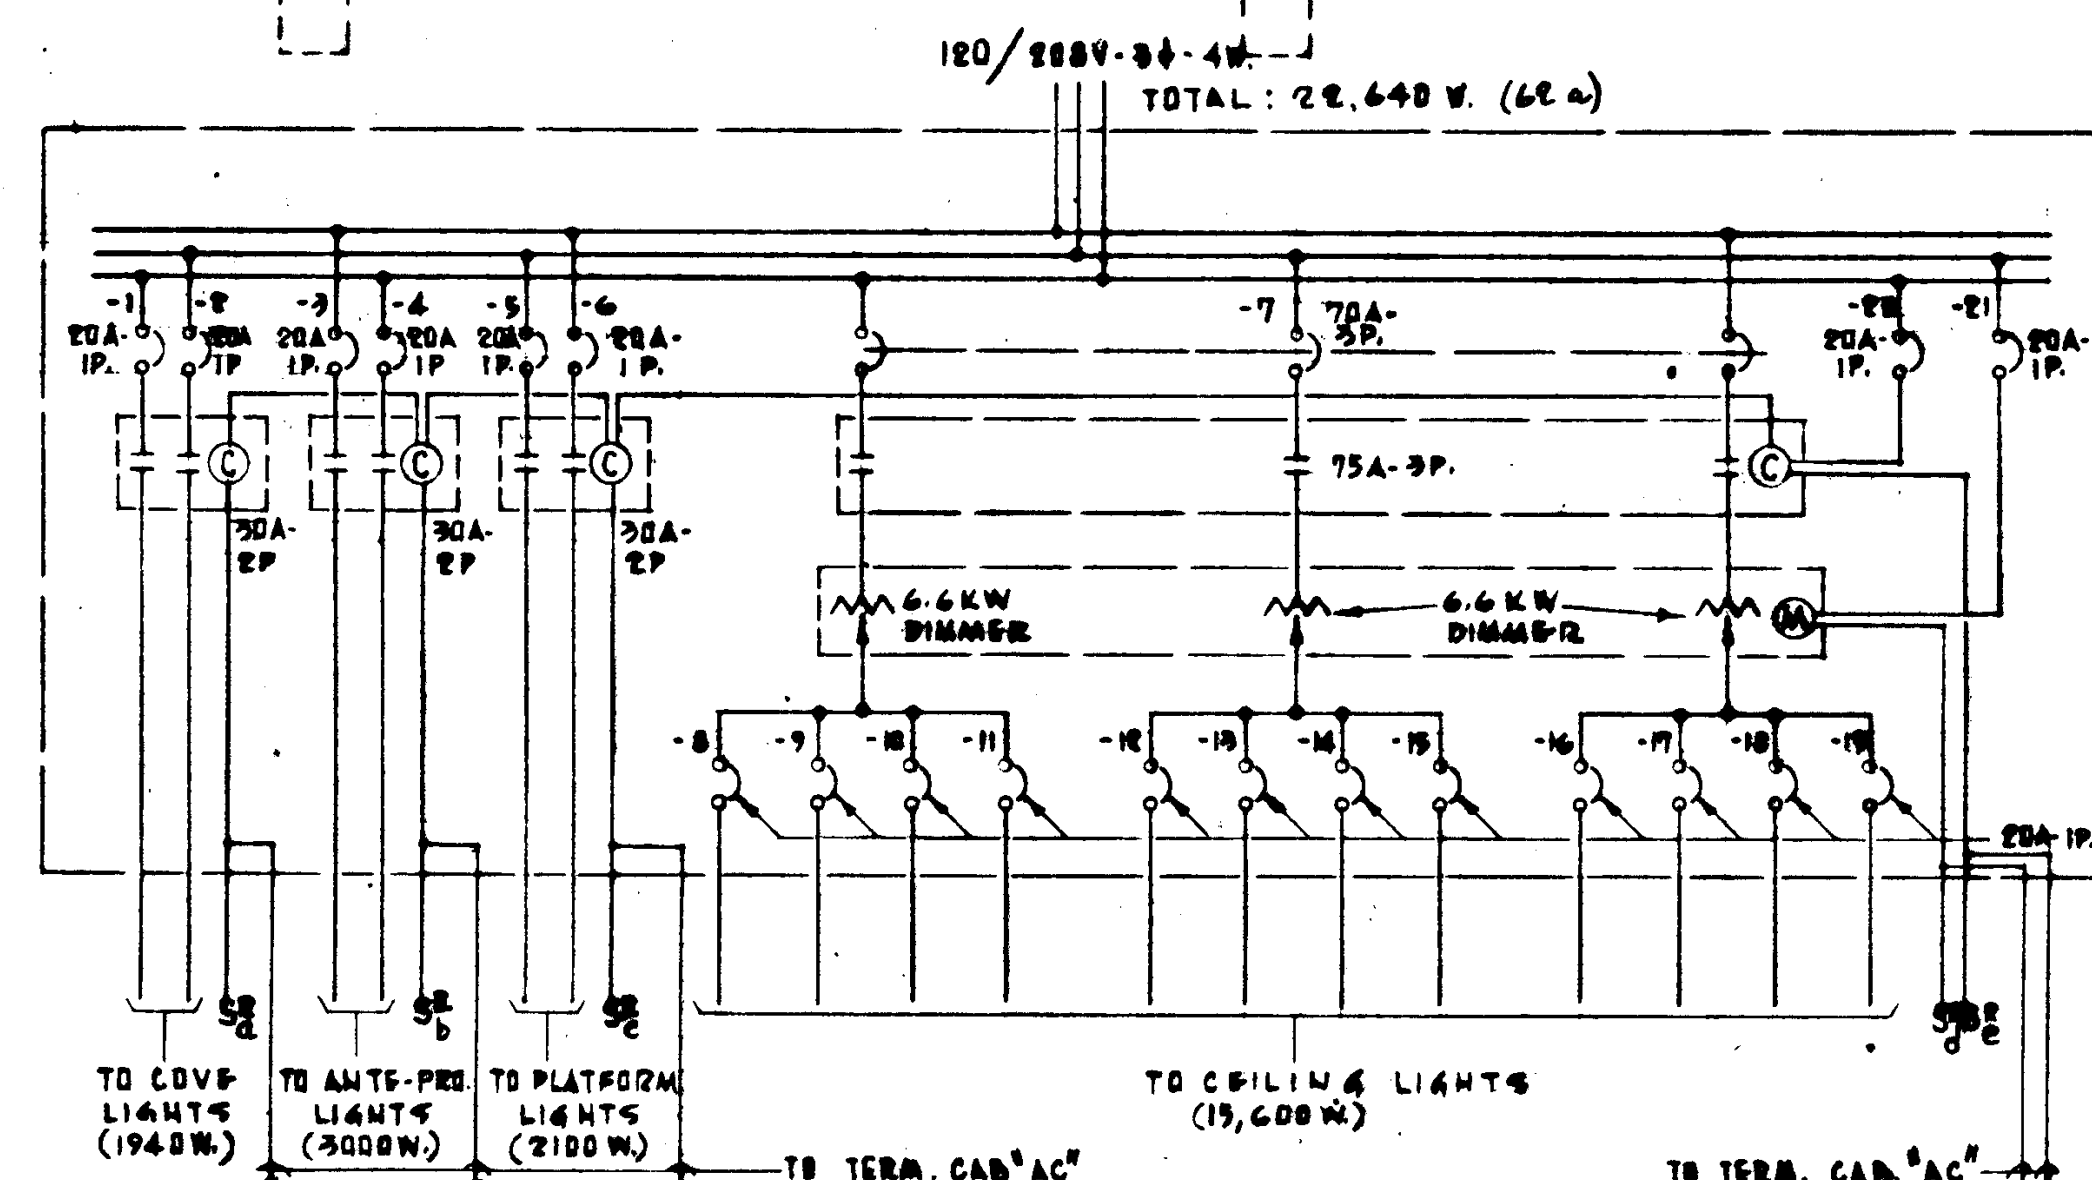


CONVERTIBLE TYPE PANEL

PANEL "H" SCHEDULE

CIR. NO.	OUTLETS	WATTS	AMPS
1	1000	1000	4.5
2	1000	1000	4.5
3	1000	1000	4.5
100	1000	1000	4.5

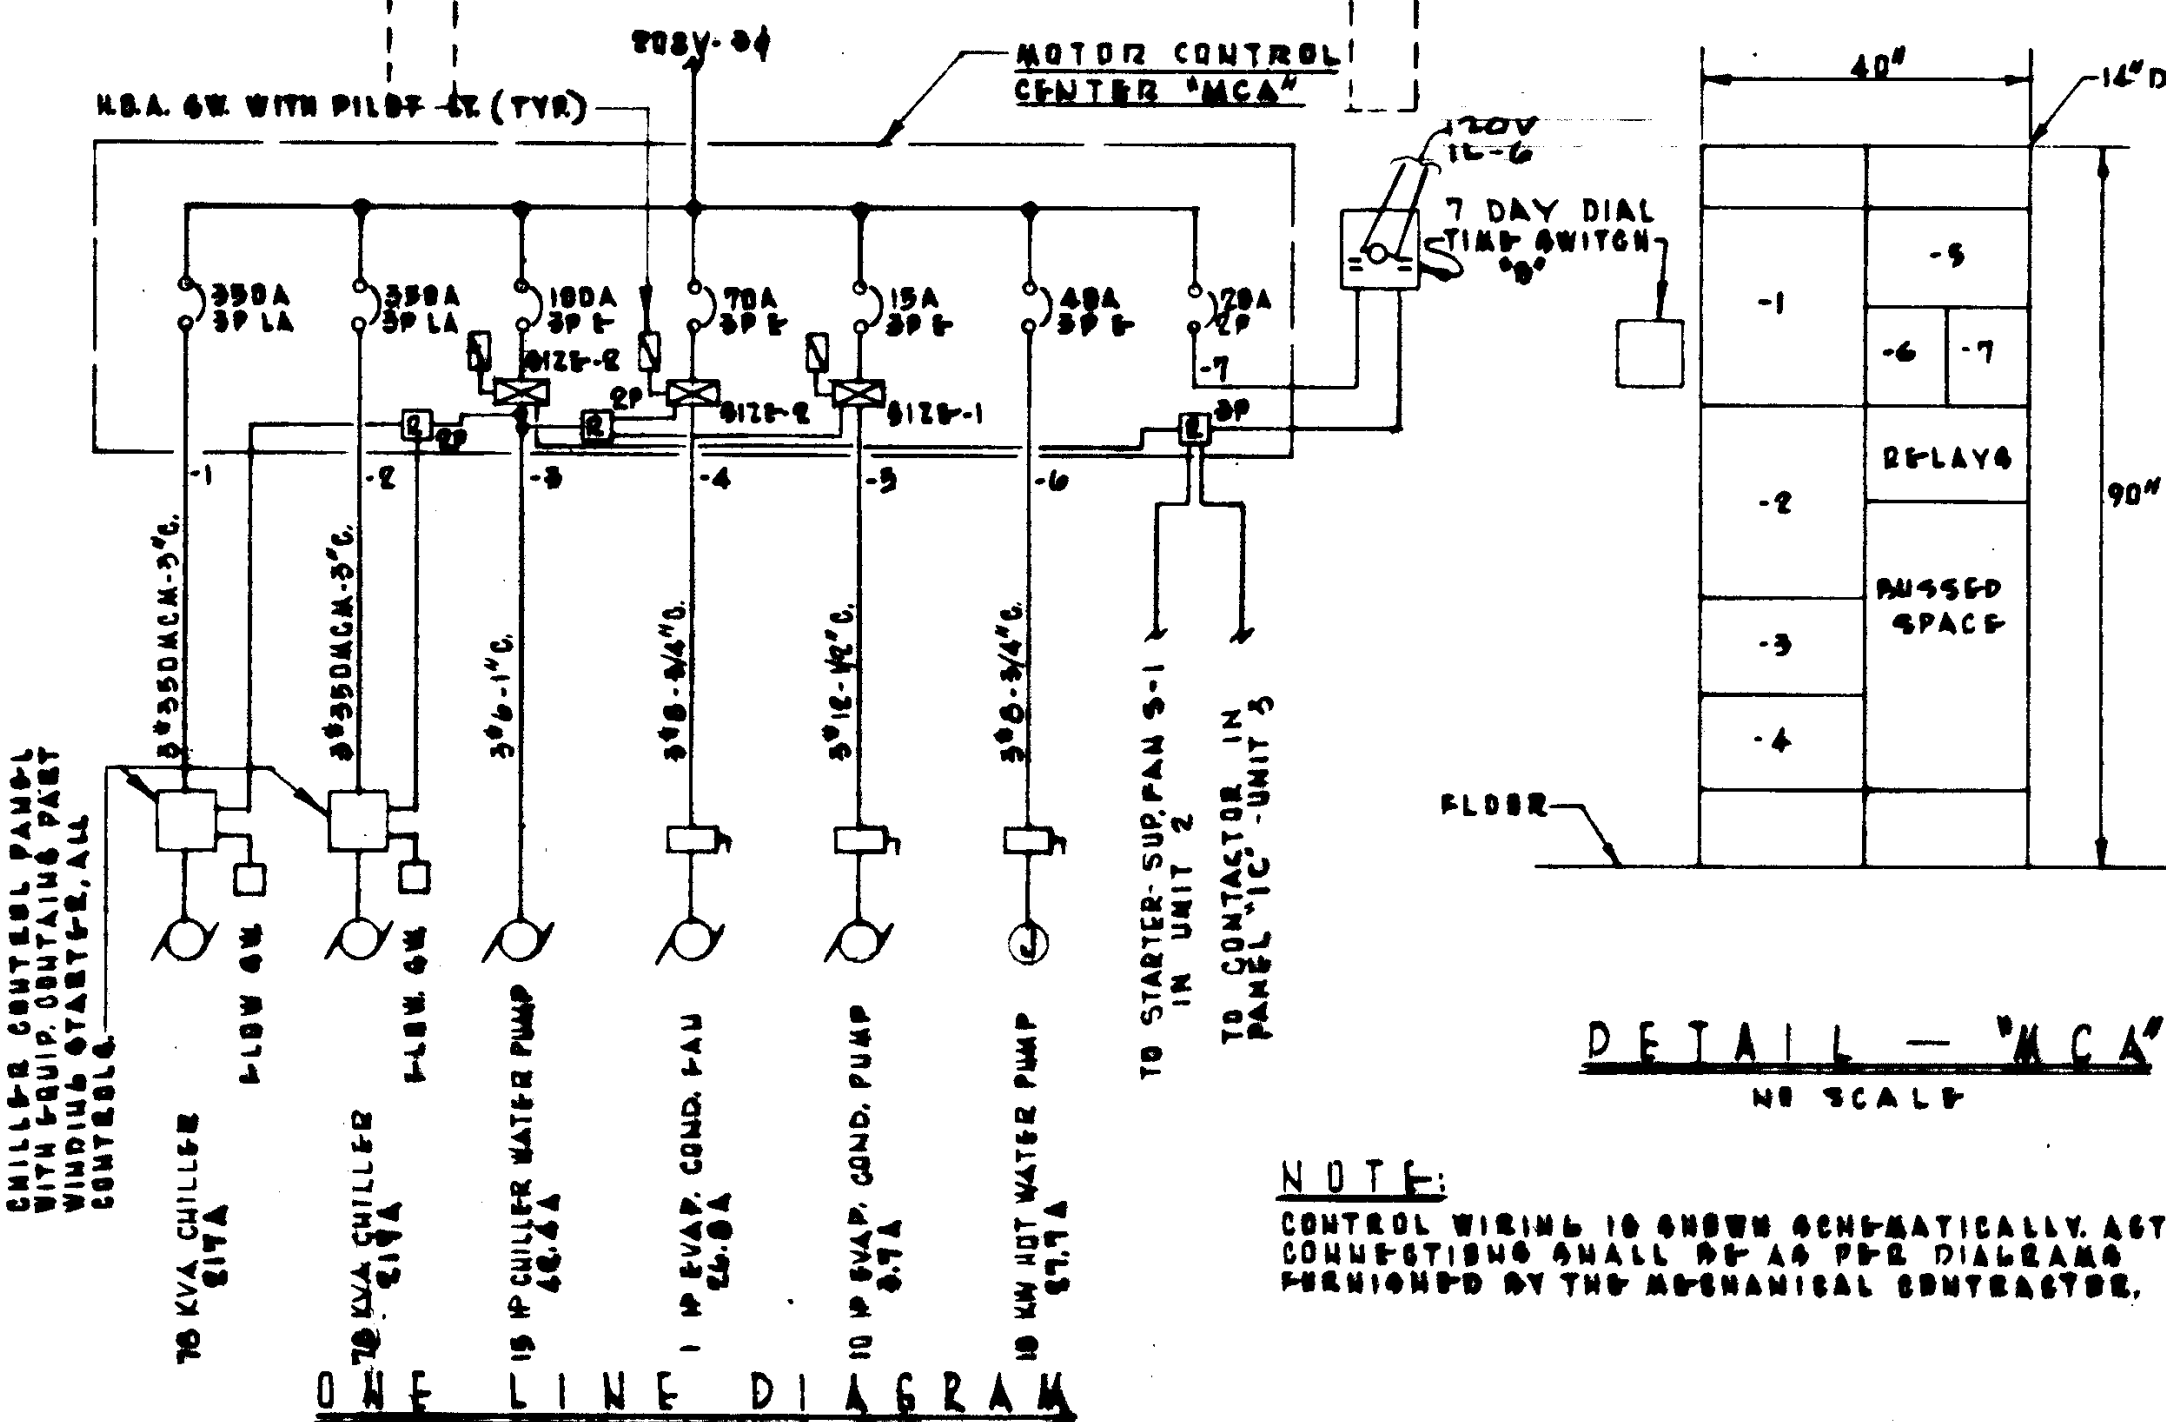

SECOND FLOOR LIGHTING				SECOND FLOOR POWER & SIGNAL			
STRUCTURAL ENGINEERS BRANDT & JOHNSON J.A. MARTIN & ASSOCIATES	DESIGNED RALPH E. PHILLIPS, INC.	CHECKED BY RALPH E. PHILLIPS, INC.	APPROVED STATE FIRE MARSHAL STATE OF CALIFORNIA DATE: 1965	STRUCTURAL ENGINEERS BRANDT & JOHNSON J.A. MARTIN & ASSOCIATES	DESIGNED RALPH E. PHILLIPS, INC.	CHECKED BY RALPH E. PHILLIPS, INC.	APPROVED STATE FIRE MARSHAL STATE OF CALIFORNIA DATE: 1965
ASSOCIATED ARCHITECTS: WILLIAM L. PEREIRA & ASSOCIATES A. QUINCY JONES, FREDERICK E. HEMMONS & ASSOCIATES BLURCK ELLERBROCK & ASSOCIATES URBANUS SQUARE • MACARTHUR BOULEVARD AT FORD ROAD TELEPHONE 714-675-2640 • CORONA DEL MAR, CALIFORNIA				GOLDEN WEST COLLEGE HUNTINGTON BEACH, CALIFORNIA ORANGE COAST JUNIOR COLLEGE DISTRICT			
REVISIONS 1. 10/1/65 2. 10/1/65 3. 10/1/65 4. 10/1/65 5. 10/1/65 6. 10/1/65 7. 10/1/65 8. 10/1/65 9. 10/1/65 10. 10/1/65				UNIT 2 FLOOR PLAN SCALE: 1/8" = 1'-0" JOB NO. 104 DATE 6/5/65 SHEET NO. 233.05			

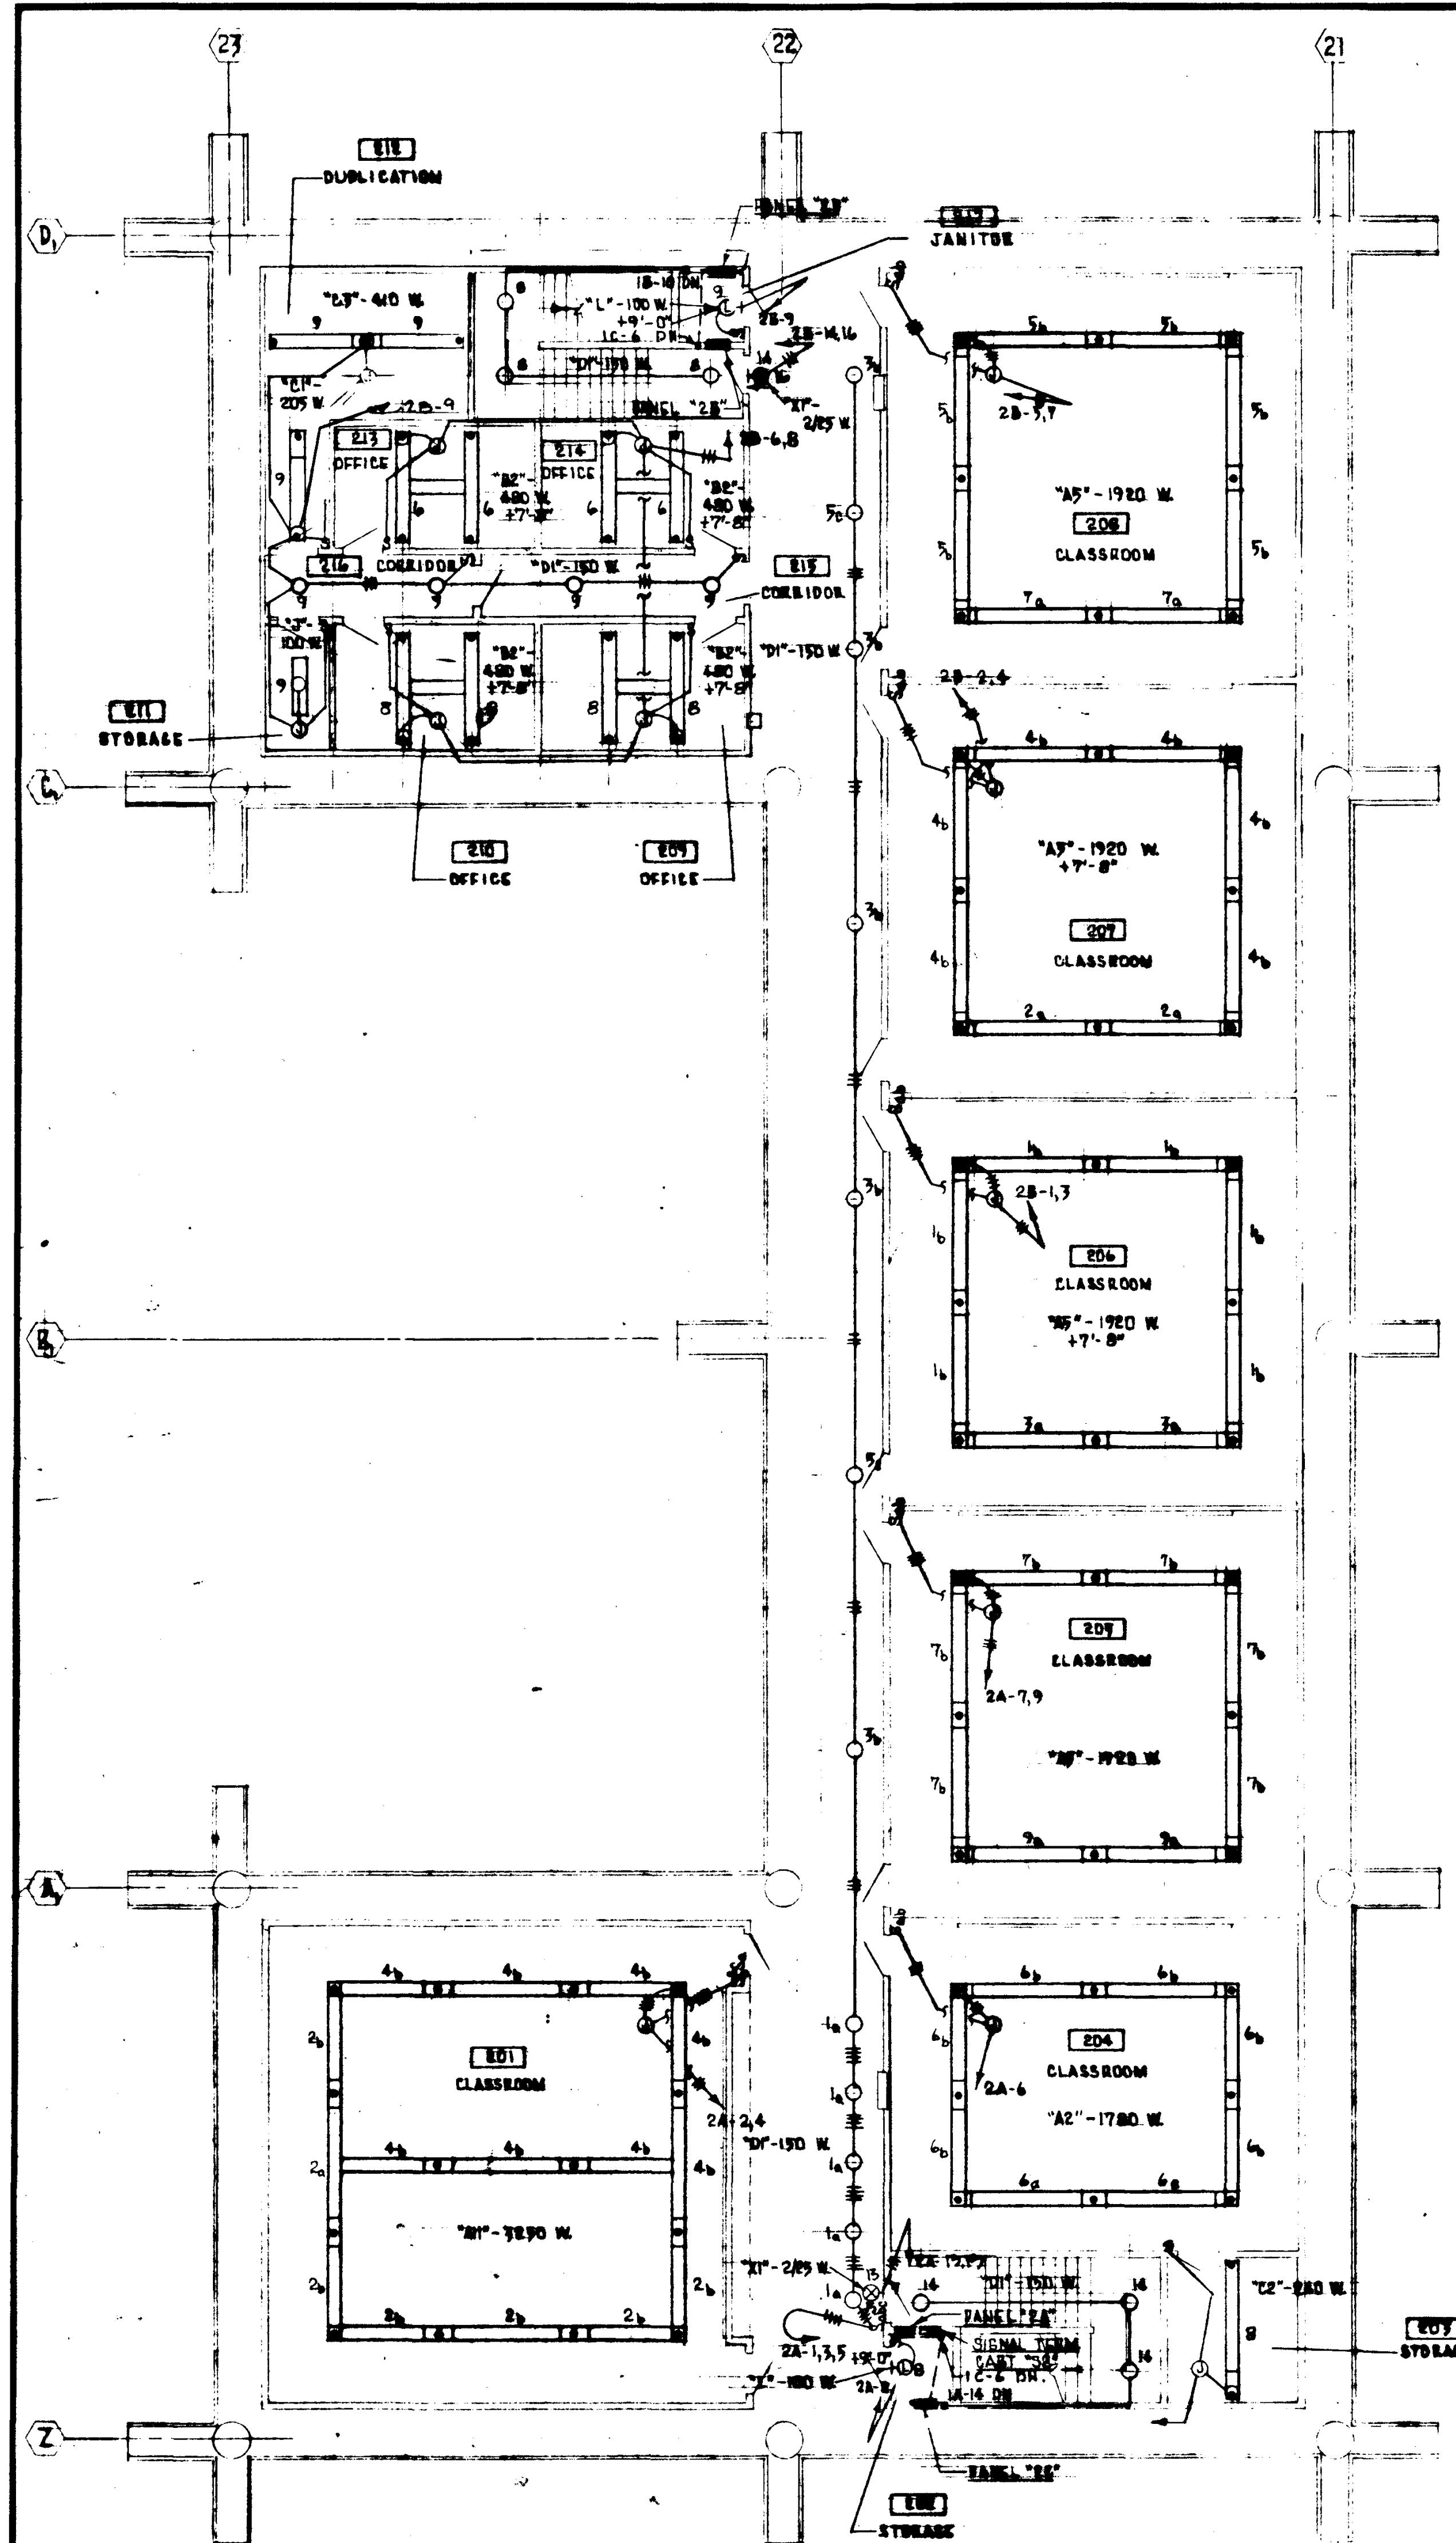


PANEL '2 C' SCHEDULE				
NO.	OUTLETS	WATTS	AMPS	REMARKS
	O	A	B	C
1	2'x4' R	100		
2	2'x4' R	100		
3	2'x4' R	100		
100	2'x4' R	100		
TOTAL	47,400	2,150	14.50	420
MAIN: LUGS ONLY FEEDER AMPS: 15.4				


* 30A-3P CONTACTOR IN PANEL TO CONTROL SPLIT BUS-1-2 CONTROLLED BY CIR. 1C-6 IN PANEL '1C'.

PANEL '2 D' SCHEDULE				
NO.	OUTLETS	WATTS	AMPS	REMARKS
	O	A	B	C
1	2'x4' R	100		
2	2'x4' R	100		
3	2'x4' R	100		
100	2'x4' R	100		
TOTAL	26,400	1,200	8.50	100
MAIN: LUGS ONLY FEEDER AMPS: 10.8				

* 30A-3P CONTACTOR IN PANEL TO CONTROL SPLIT BUS-1-2 CONTROLLED BY CIR. 1C-6 IN PANEL '1C'.

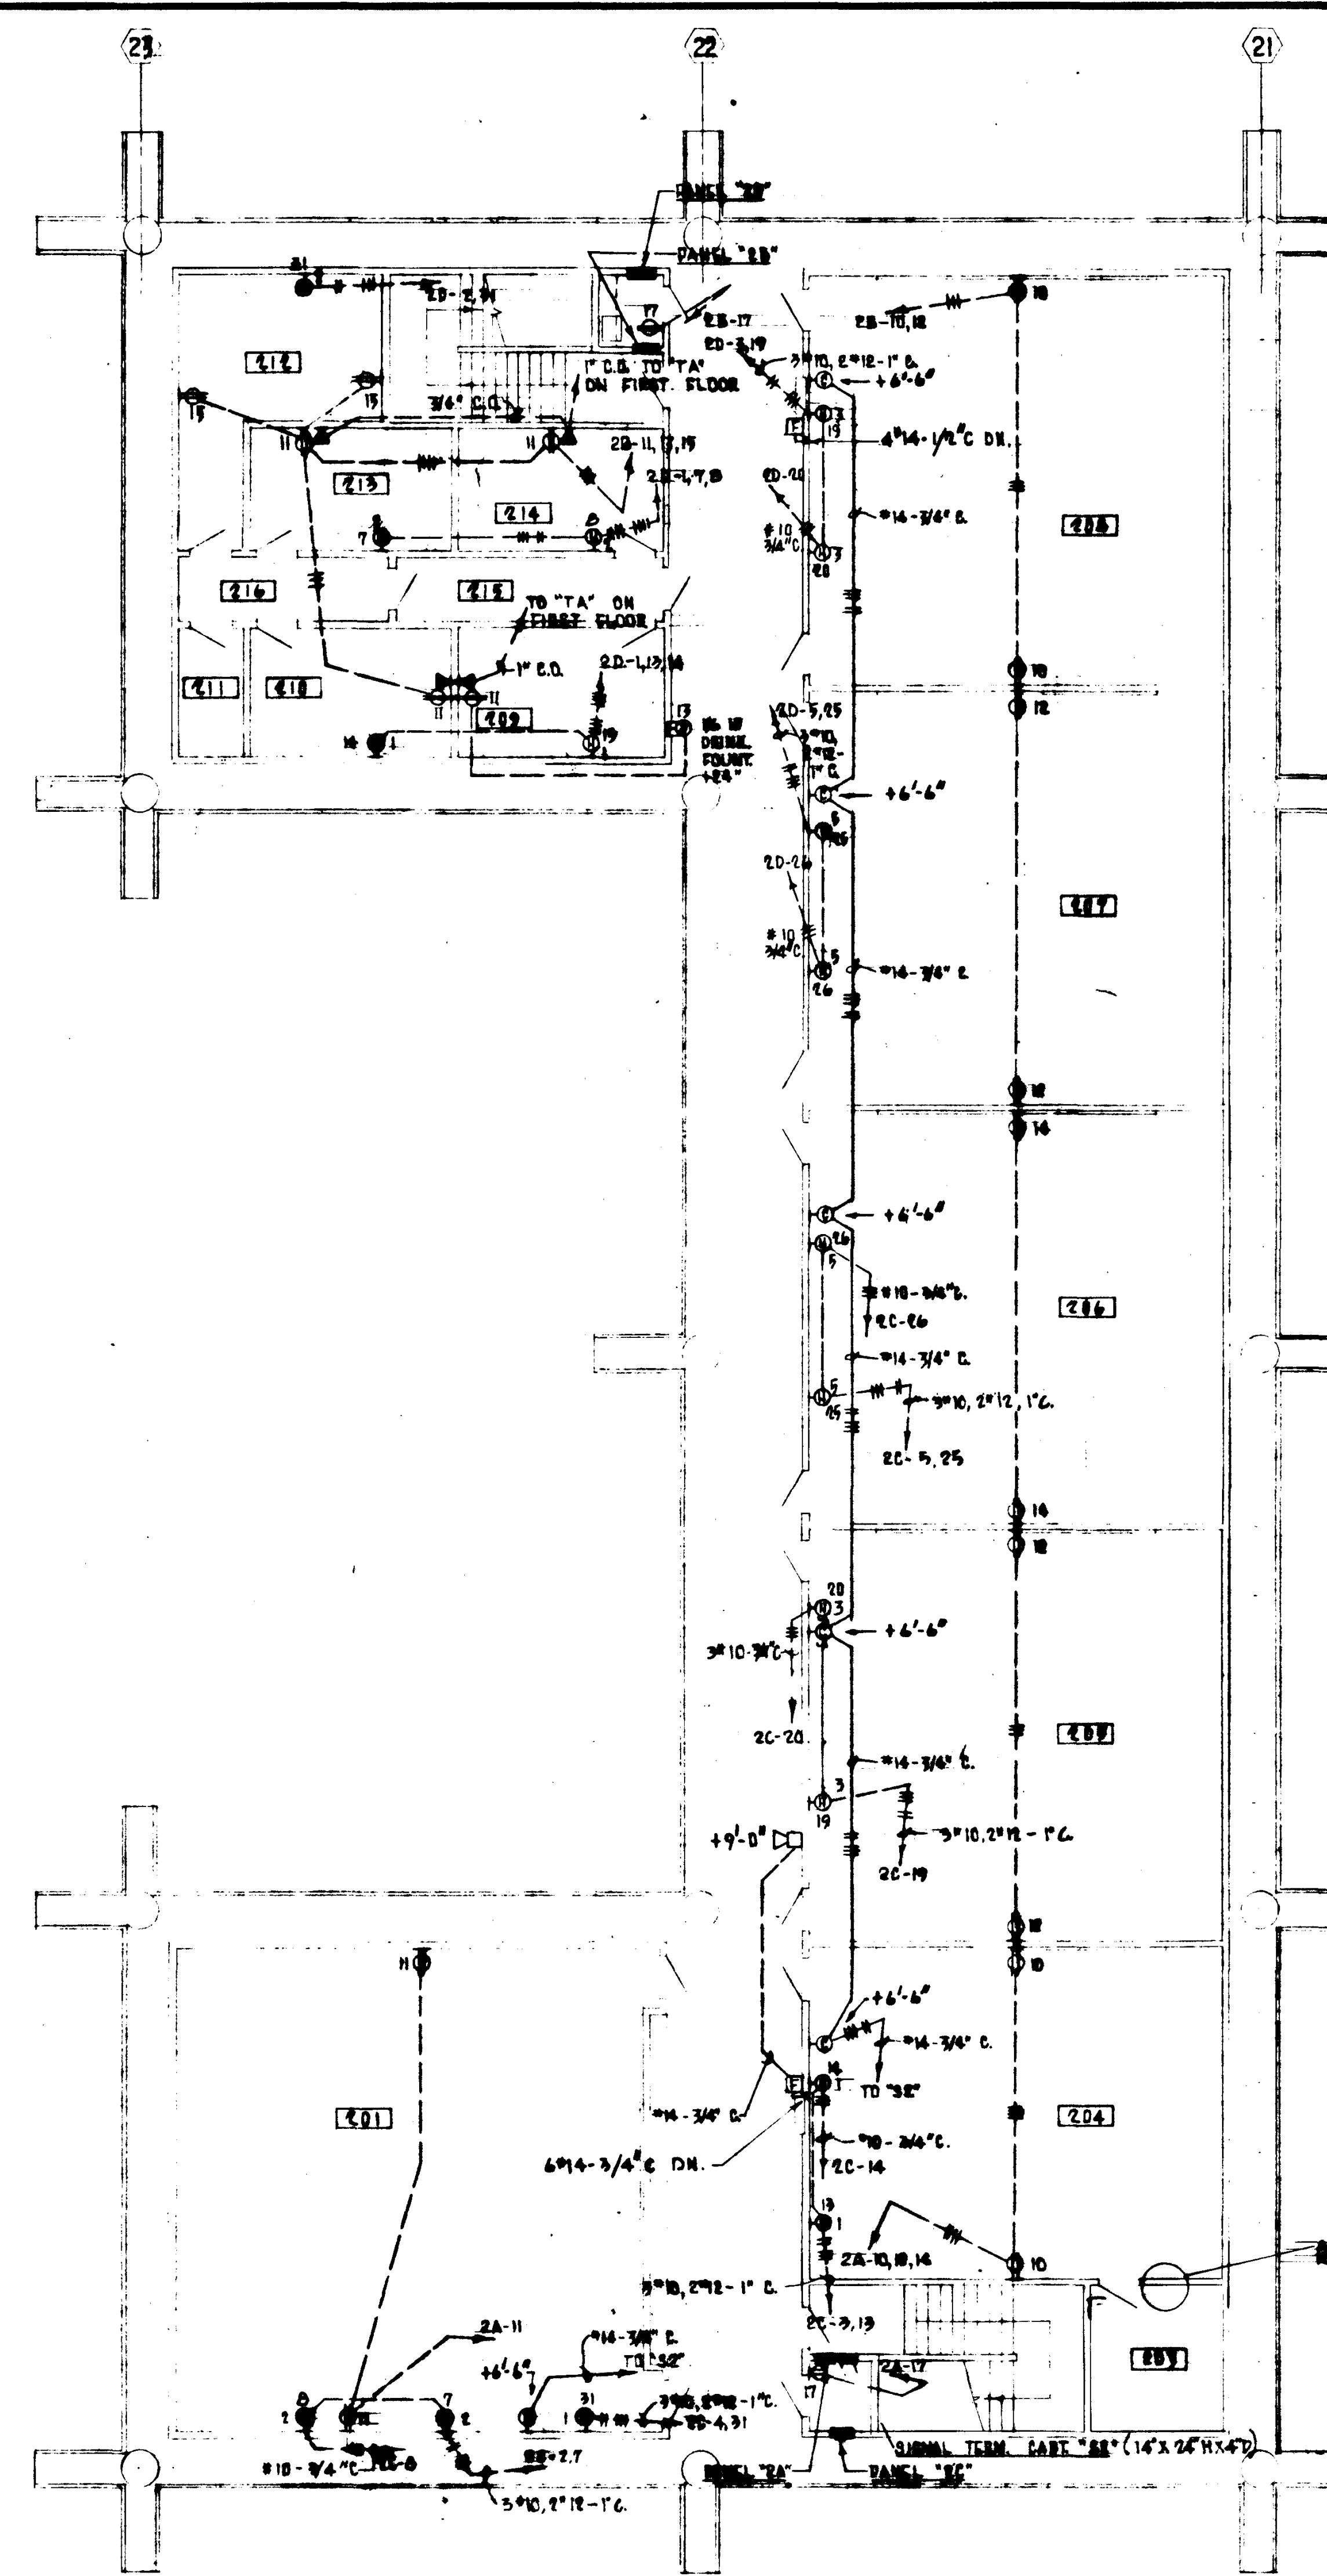

PANEL '2 A' SCHEDULE					
NO.	OUTLETS		WATTS		REMARKS
	O	OTHERS	A	B	
1	1		750		
2	1		750		
3	1		750		
100	1		750		
TOTAL: 100 AMP, 24.4 W					
MAINS: LUGS ONLY, FEED: AMP, 30					

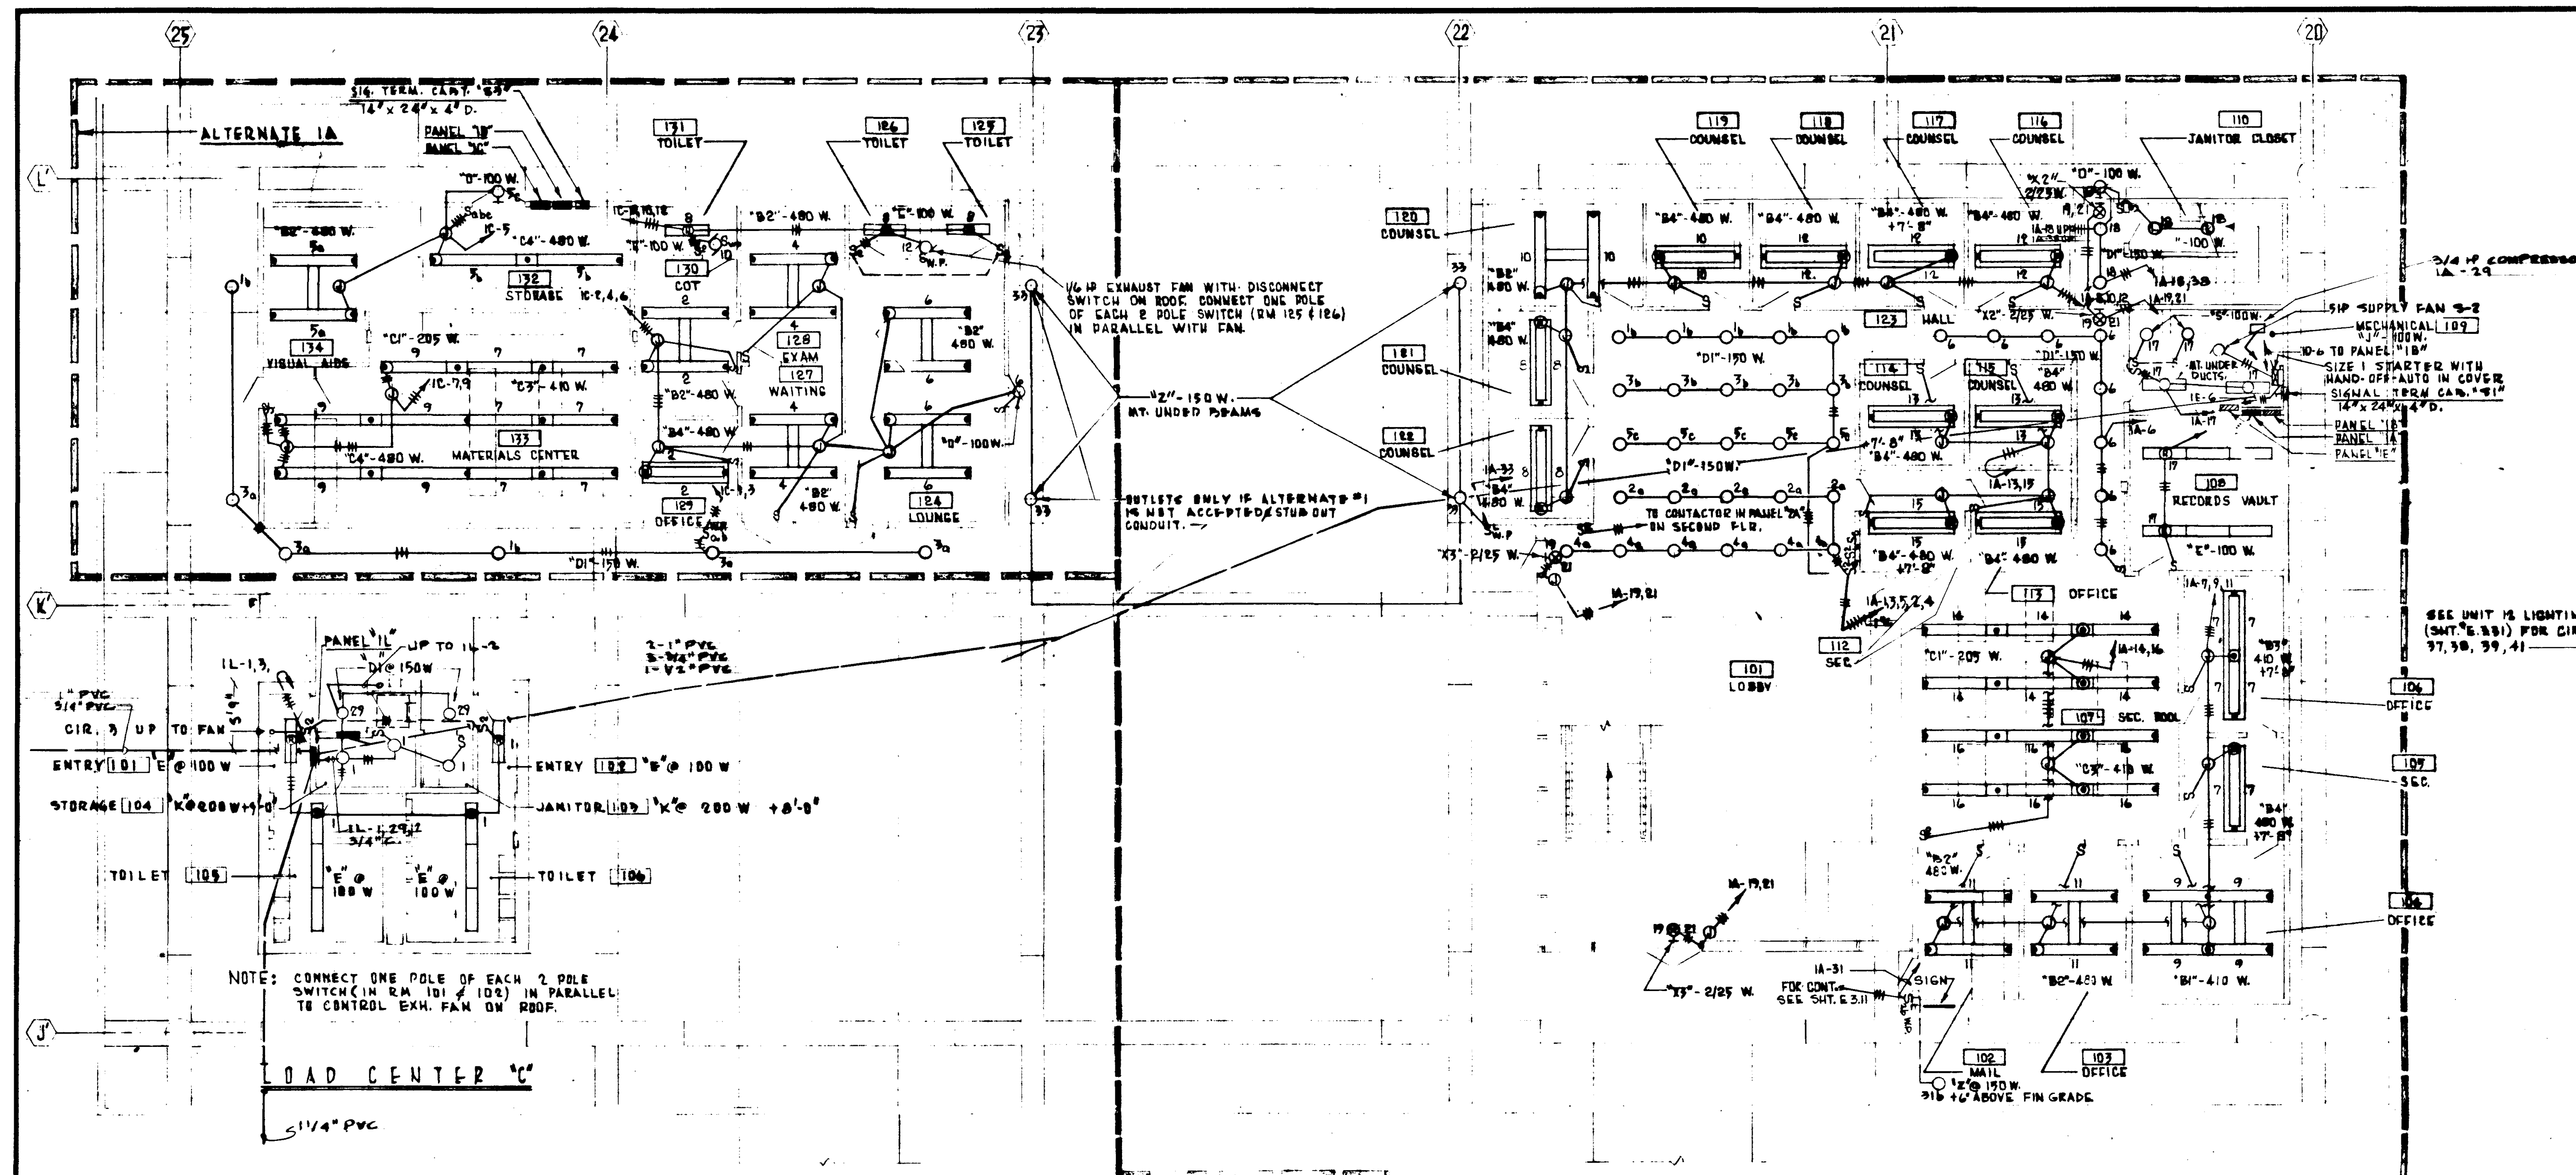


PANEL "A" SCHEDULE

CIR. NO.	OUTLETS	WATTS	REMARKS		
O	OTHERS	A	B	C	PERCENTAGE
1					70
2		750			
3			750		
4			400		
5				750	
6				1200	
7		750			
8		900			
9			820		
10			950		
11				900	
12				1440	
13		900			
14		1200			
15			850		
16			1000		
17				1000	
18					
19	A-100	100			
20		900			
21			144		
22	A-100		720		
23			720		
24			180		
25				180	
26				540	
27					720
28					
29					
30		900			
31	SPARE		600		
32					
33	SPARE				
34					
35					
36					
37		1050			
38		750			
39			1050		
40	SPARE				
41				900	70
42	SPARE				

*30A, 3P, CONTACTOR IN PANEL FOR
 SPLIT BUS CONTROLLED BY TIME SWITCH

PANEL "A" (CONTACTOR TO
 MECH. HELD TYPE)

MAINS: 1440 ONLY PEPPER LUMPS: 81

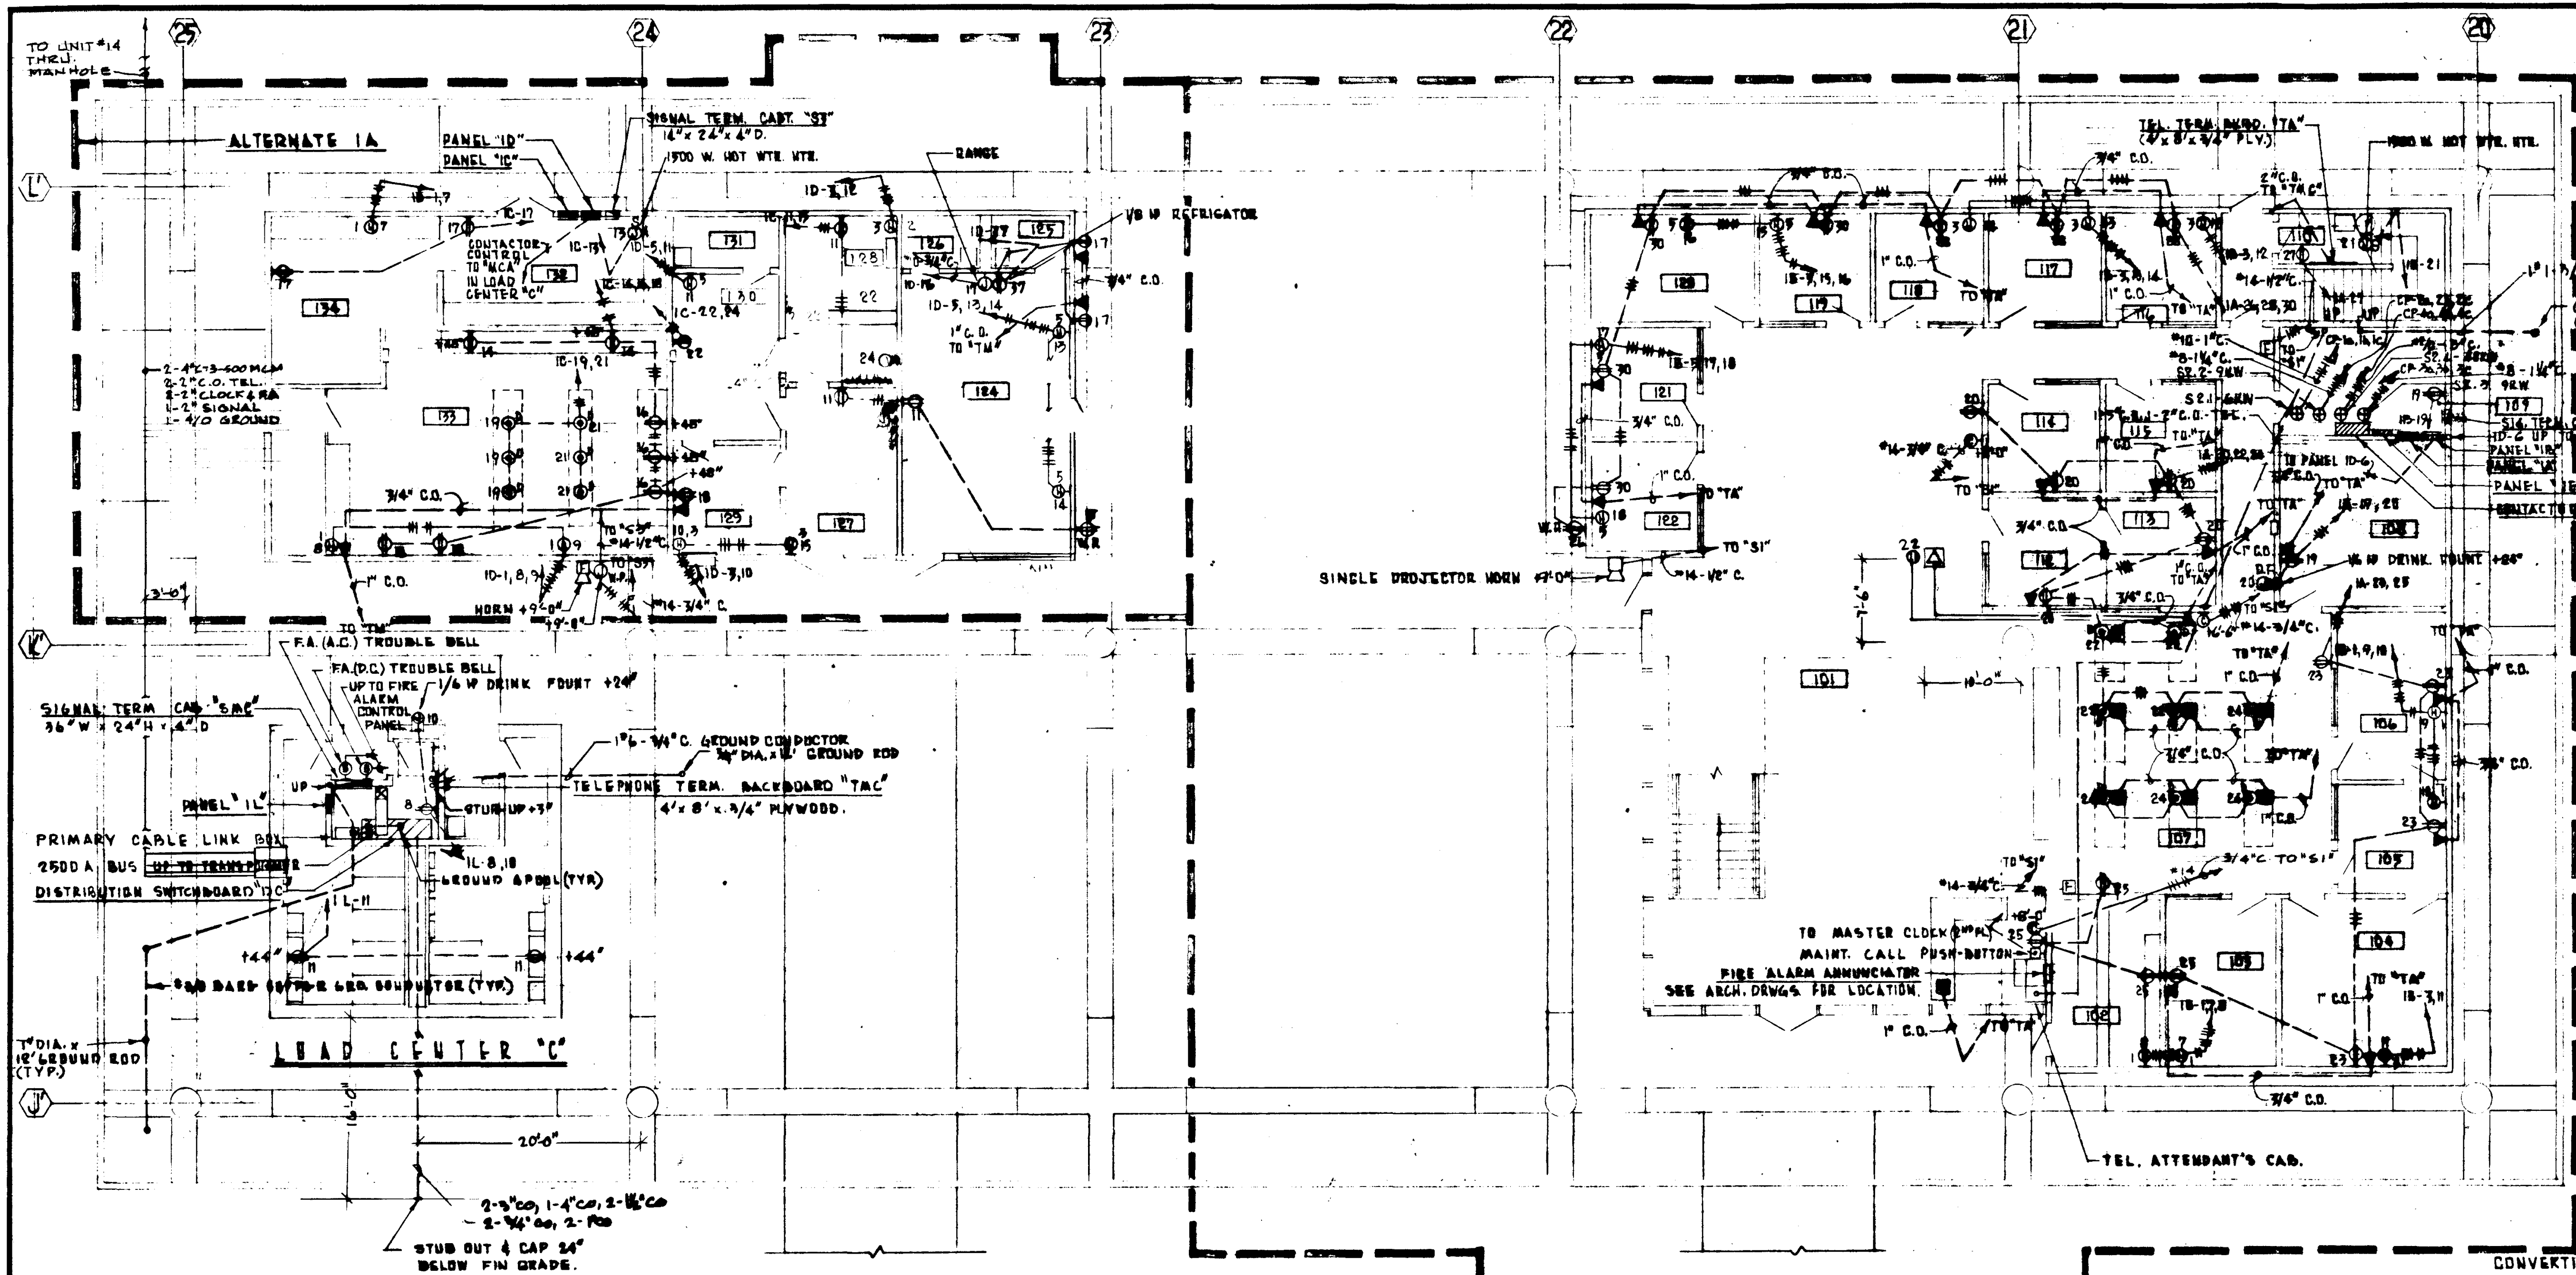

CONVERTIBLE TYPE PANEL




PANEL '1B' SCHEDULE

OUTLET	WATTS	WATTS	WATTS
A	B	C	D
1	SPACE	750	100
2	SPACE	750	100
3	SPACE	750	100
4	SPACE	750	100
5	SPACE	750	100
6	SPACE	750	100
7	SPACE	750	100
8	SPACE	750	100
9	SPACE	750	100
10	SPACE	750	100
11	SPACE	750	100
12	SPACE	750	100
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17	SPACE	750	100
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92	SPACE	750	100
93	SPACE	750	100
94	SPACE	750	100
95	SPACE	750	100
96	SPACE	750	100
97	SPACE	750	100
98	SPACE	750	100
99	SPACE	750	100
100	SPACE	750	100

CONVERTIBLE TYPE PANEL

PANEL '1D' SCHEDULE

OUTLET	WATTS	WATTS	WATTS
A	B	C	D
1	SPACE	750	100
2	SPACE	750	100
3	SPACE	750	100
4	SPACE	750	100
5	SPACE	750	100
6	SPACE	750	100
7	SPACE	750	100
8	SPACE	750	100
9	SPACE	750	100
10	SPACE	750	100
11	SPACE	750	100
12	SPACE	750	100
13	SPACE	750	100
14	SPACE	750	100
15	SPACE	750	100
16	SPACE	750	100
17	SPACE	750	100
18	SPACE	750	100
19	SPACE	750	100
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21	SPACE	750	100
22	SPACE	750	100
23	SPACE	750	100
24	SPACE	750	100
25	SPACE	750	100
26	SPACE	750	100
27	SPACE	750	100
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29	SPACE	750	100
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31	SPACE	750	100
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33	SPACE	750	100
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36	SPACE	750	100
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41	SPACE	750	100
42	SPACE	750	100
43	SPACE	750	100
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94	SPACE	750	100
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99	SPACE	750	100
100	SPACE	750	100

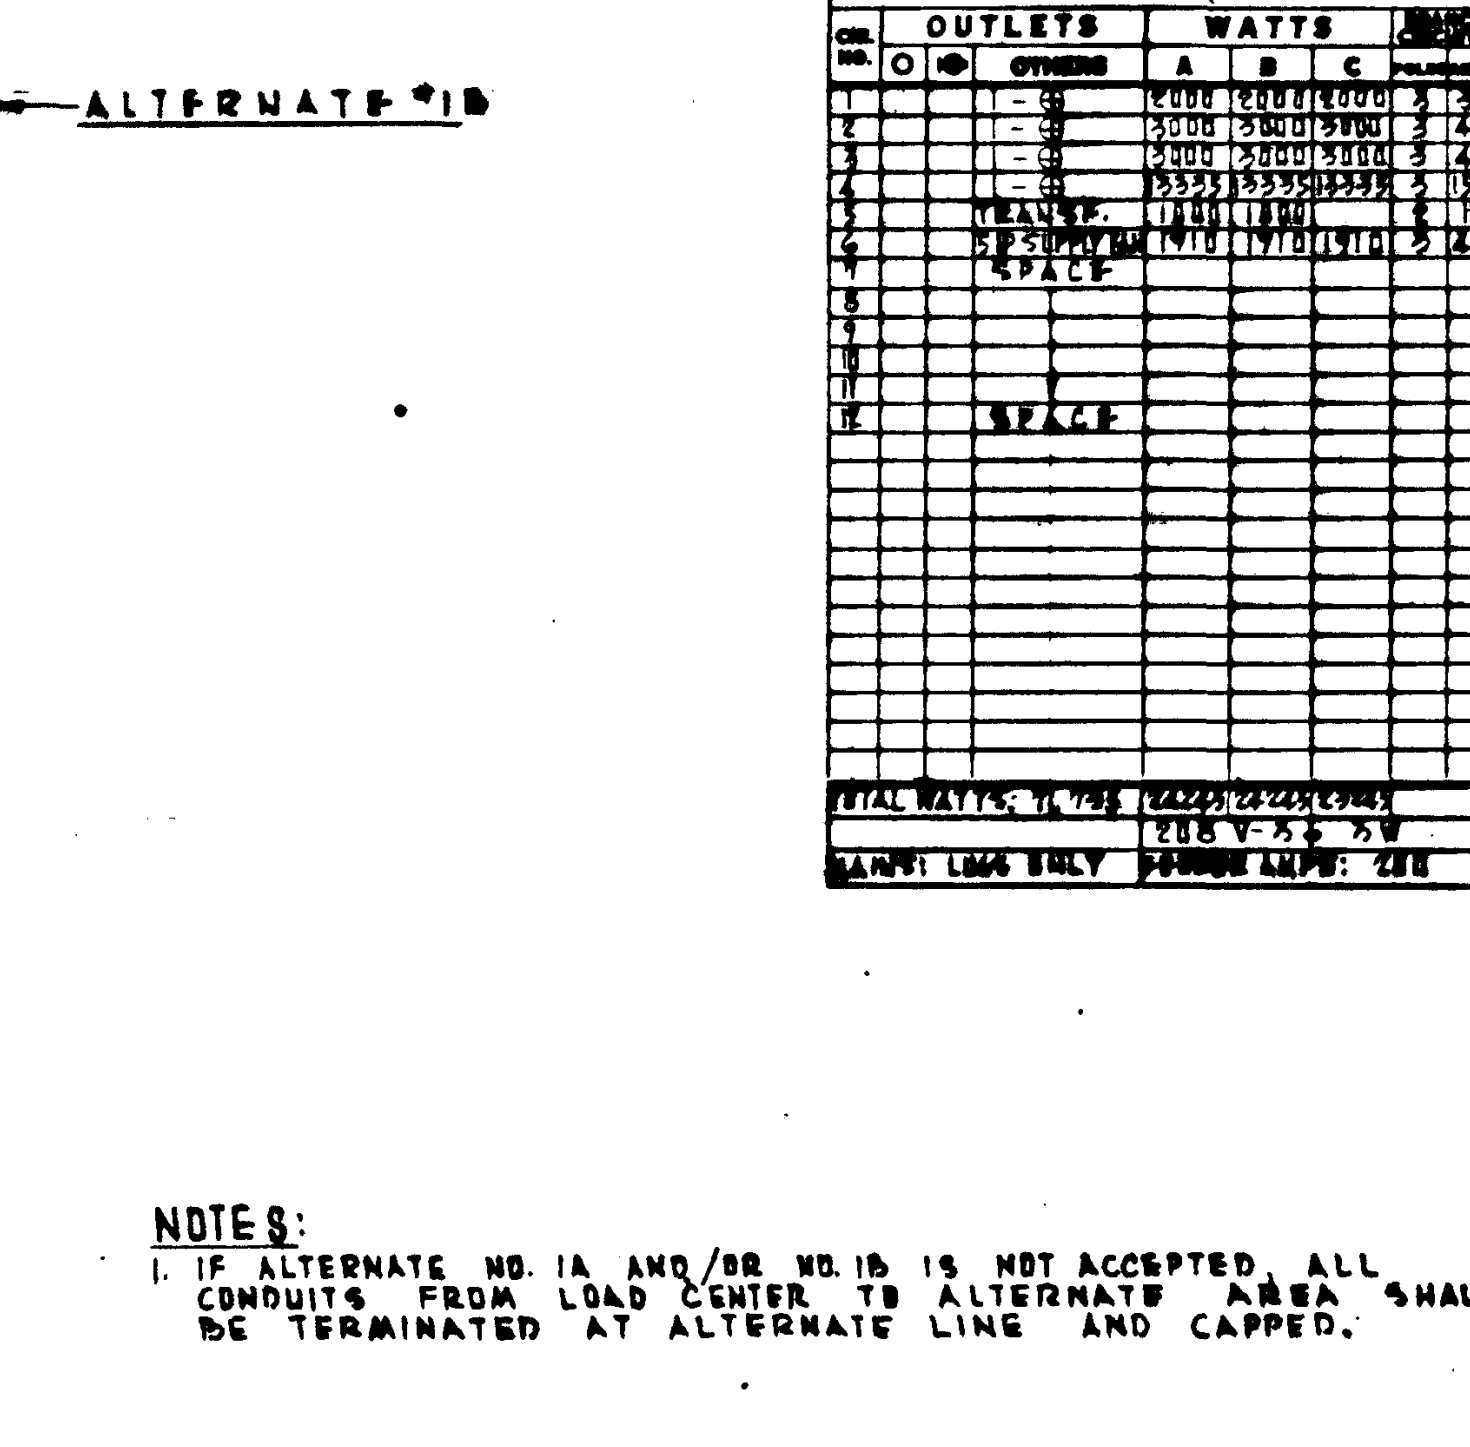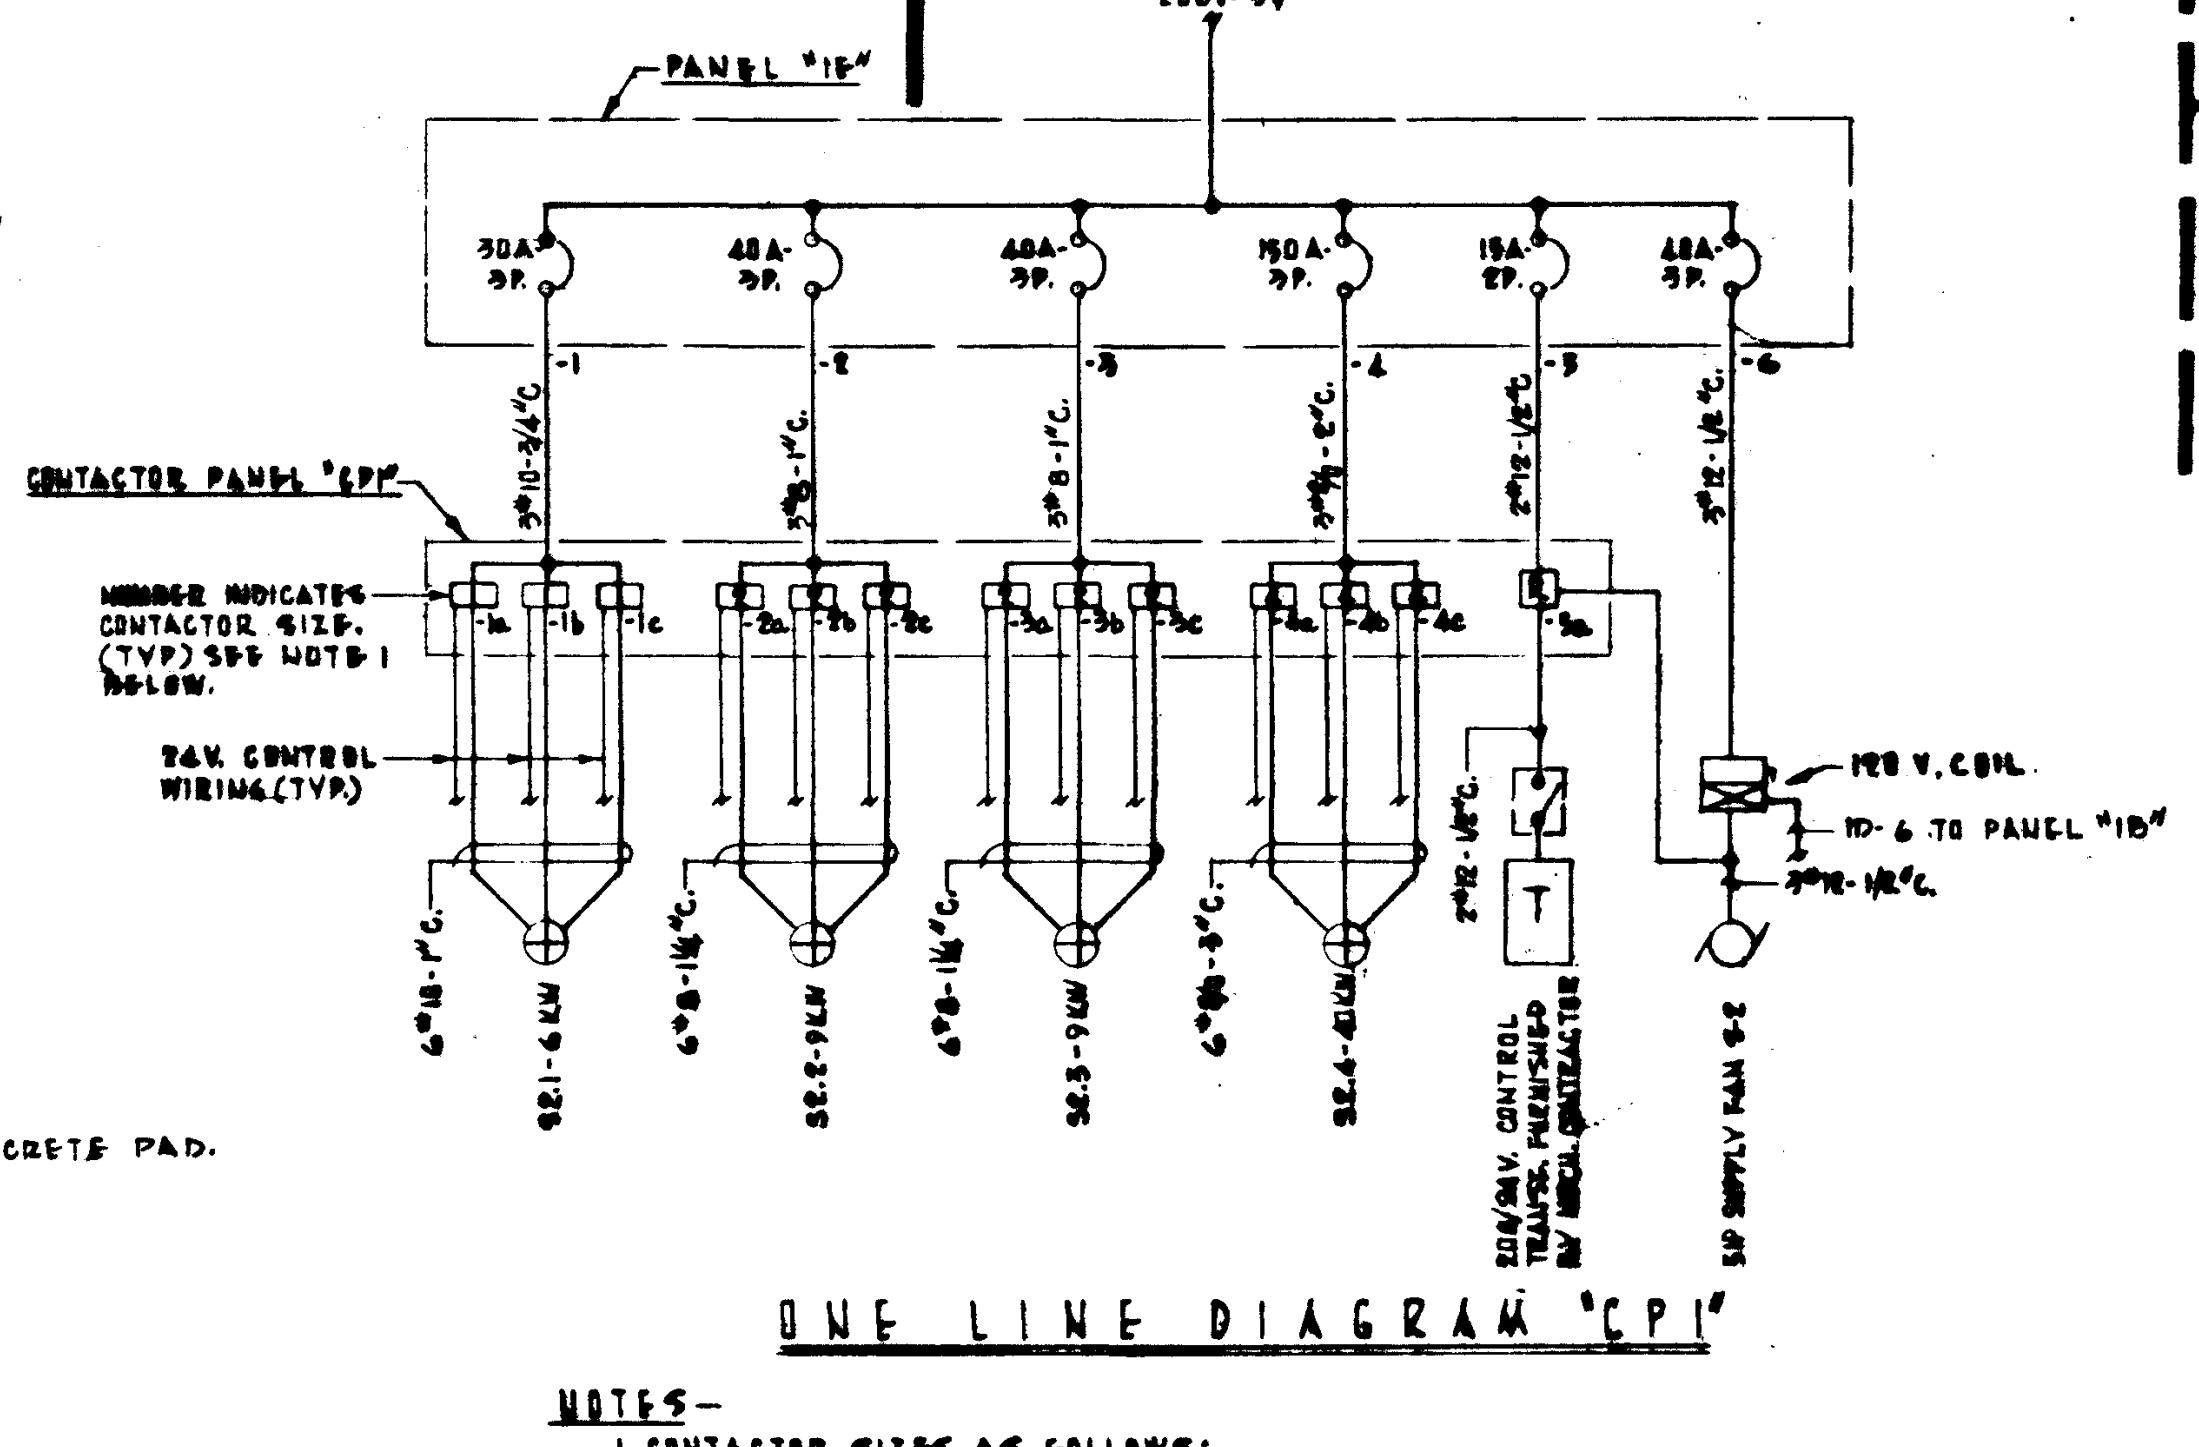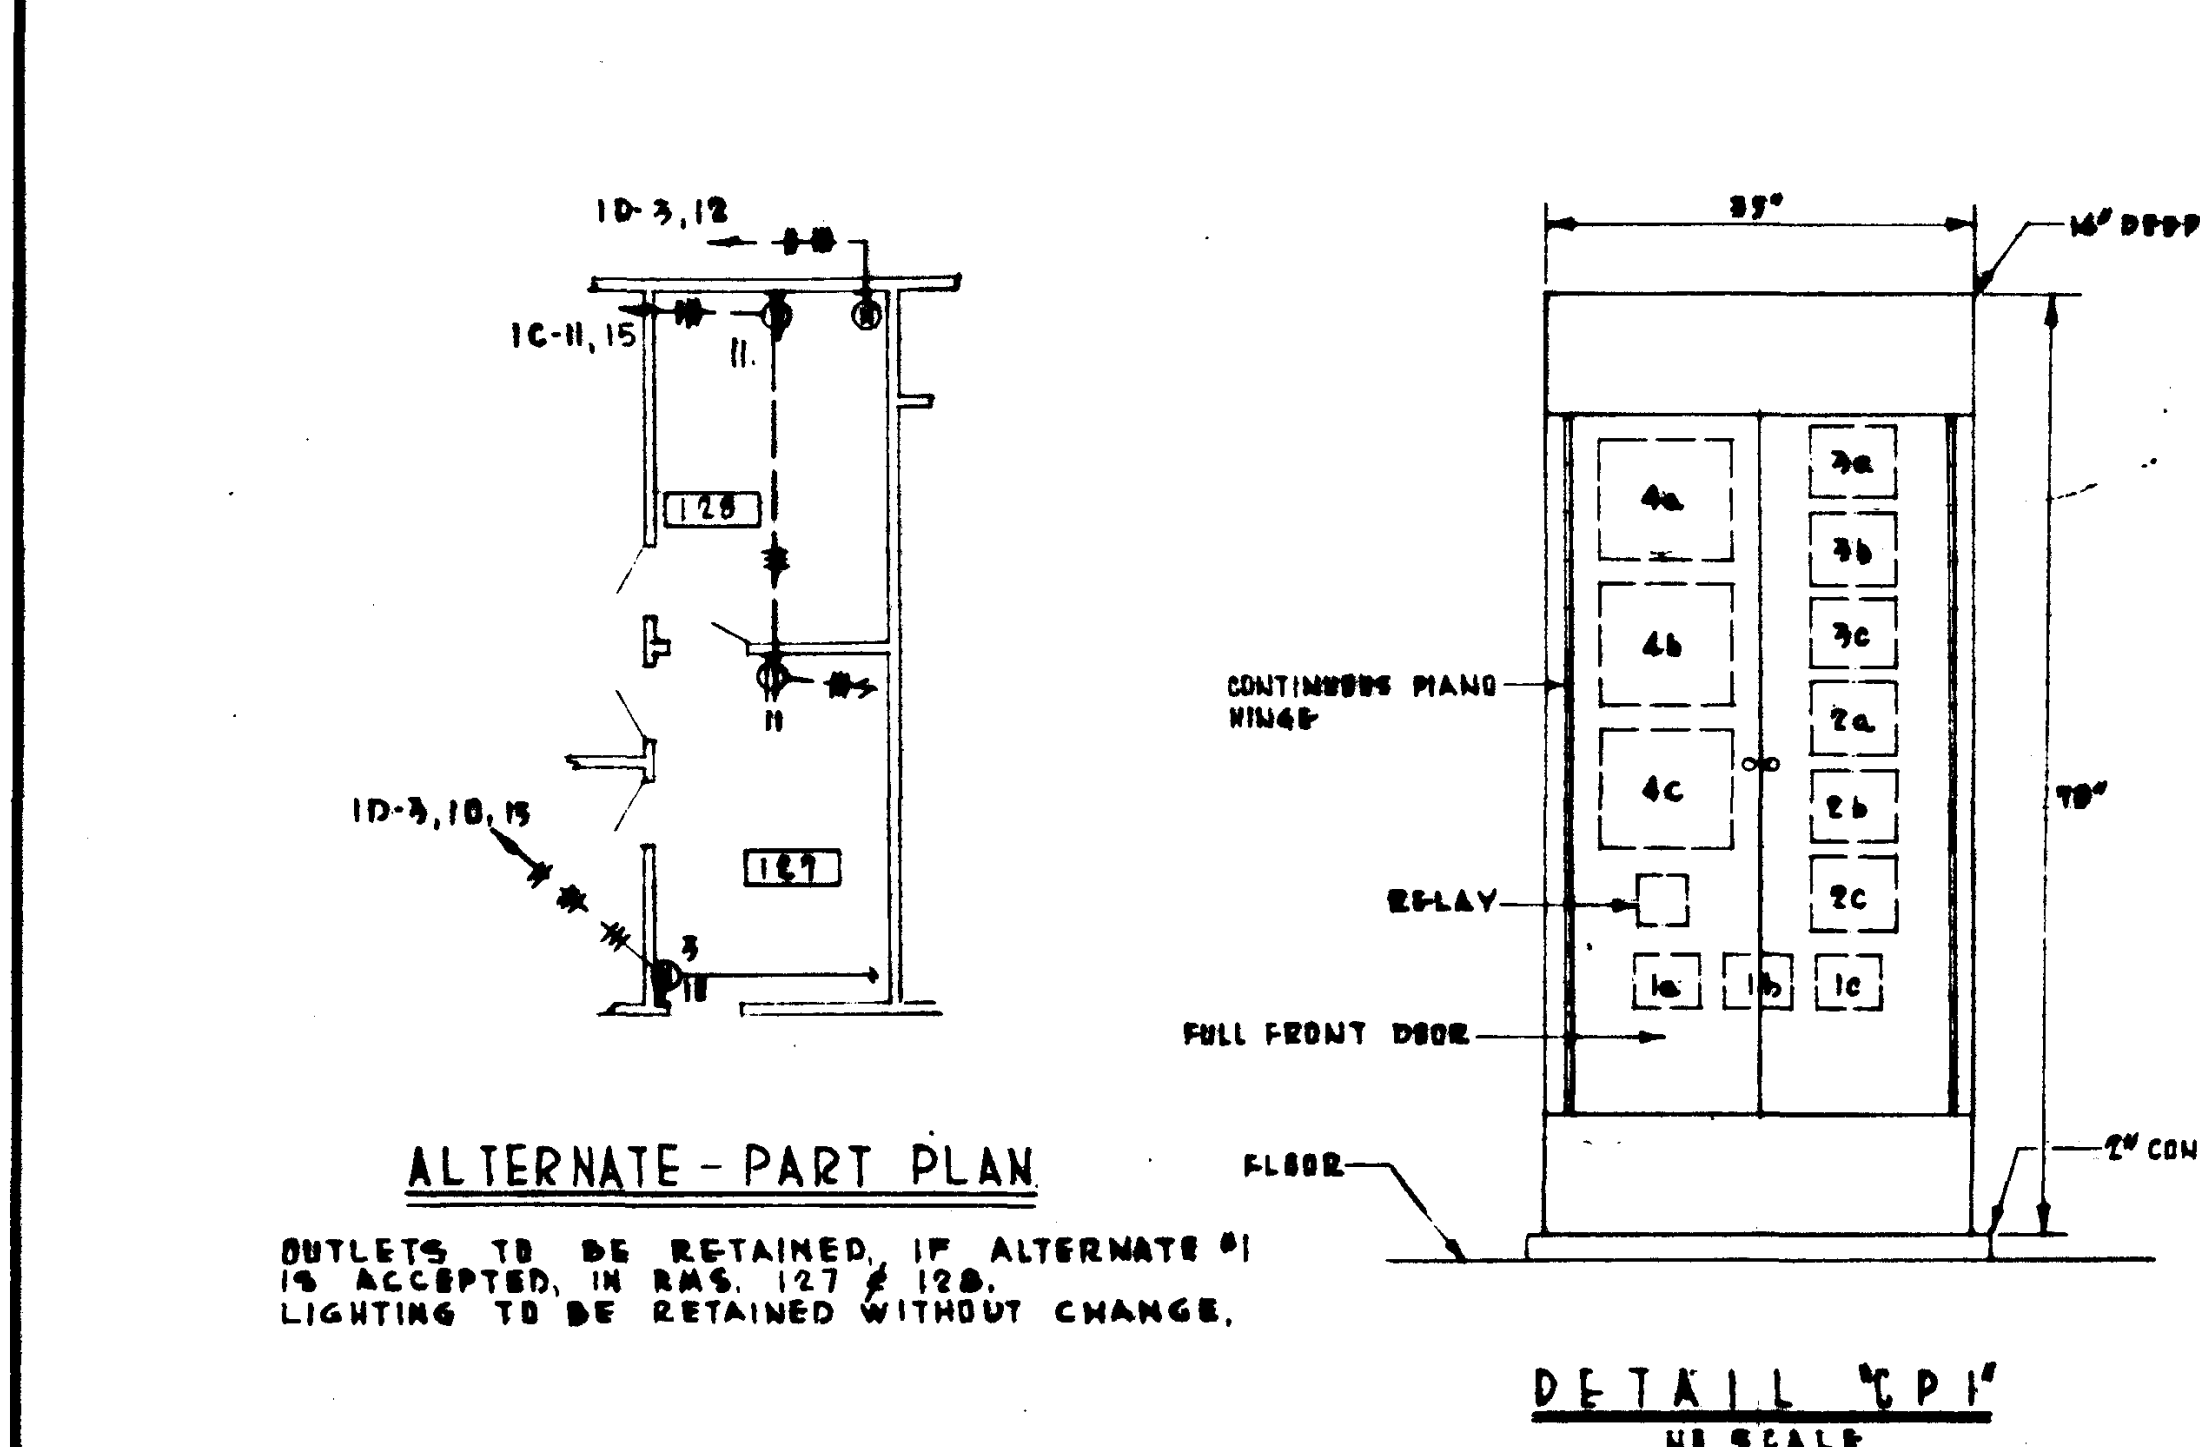


NOTES:

- IF ALTERNATE NO. 1A AND/OR NO. 1B IS NOT ACCEPTED, ALL CONDUITS FROM LOAD CENTER TO ALTERNATE AREA SHALL BE TERMINATED AT ALTERNATE LINE AND CAPPED.

REVISIONS:



NO.	DATE	DESCRIPTION
1	6-15-65	ISSUED FOR PERMIT

STRUCTURAL ENGINEERS H. J. MARTIN & ASSOCIATES 1000 N. GARDEN ST. ANAHEIM, CALIF. 92805		DESIGNED BY H. J. MARTIN		APPROVED H. J. MARTIN		ASSOCIATED ARCHITECTS: WILLIAM L. PEREIRA & ASSOCIATES A. QUINCY JONES, FREDERICK E. EMMONS & ASSOCIATES BLURLOCK HILLERBROOK & ASSOCIATES 1000 N. GARDEN ST. ANAHEIM, CALIF. 92805		GOLDEN WEST COLLEGE HUNTINGTON BEACH, CALIFORNIA ORANGE COAST JUNIOR COLLEGE DISTRICT		UNIT 4 FLOOR PLAN		SCALE 1/4" = 1'-0"	
MECHANICAL ENGINEERS RALPH E. PHILLIPS, INC. 1000 N. GARDEN ST. ANAHEIM, CALIF. 92805		DRAWN BY RALPH E. PHILLIPS		CHECKED BY RALPH E. PHILLIPS		APPROVED RALPH E. PHILLIPS		DATE 6-15-65		SHEET NO. 123.100		DATE 6-15-65	
ELECTRICAL ENGINEERS RALPH E. PHILLIPS, INC. 1000 N. GARDEN ST. ANAHEIM, CALIF. 92805		DATE 6-15-65		REVISIONS		DATE 6-15-65		REVISIONS		DATE 6-15-65		REVISIONS	

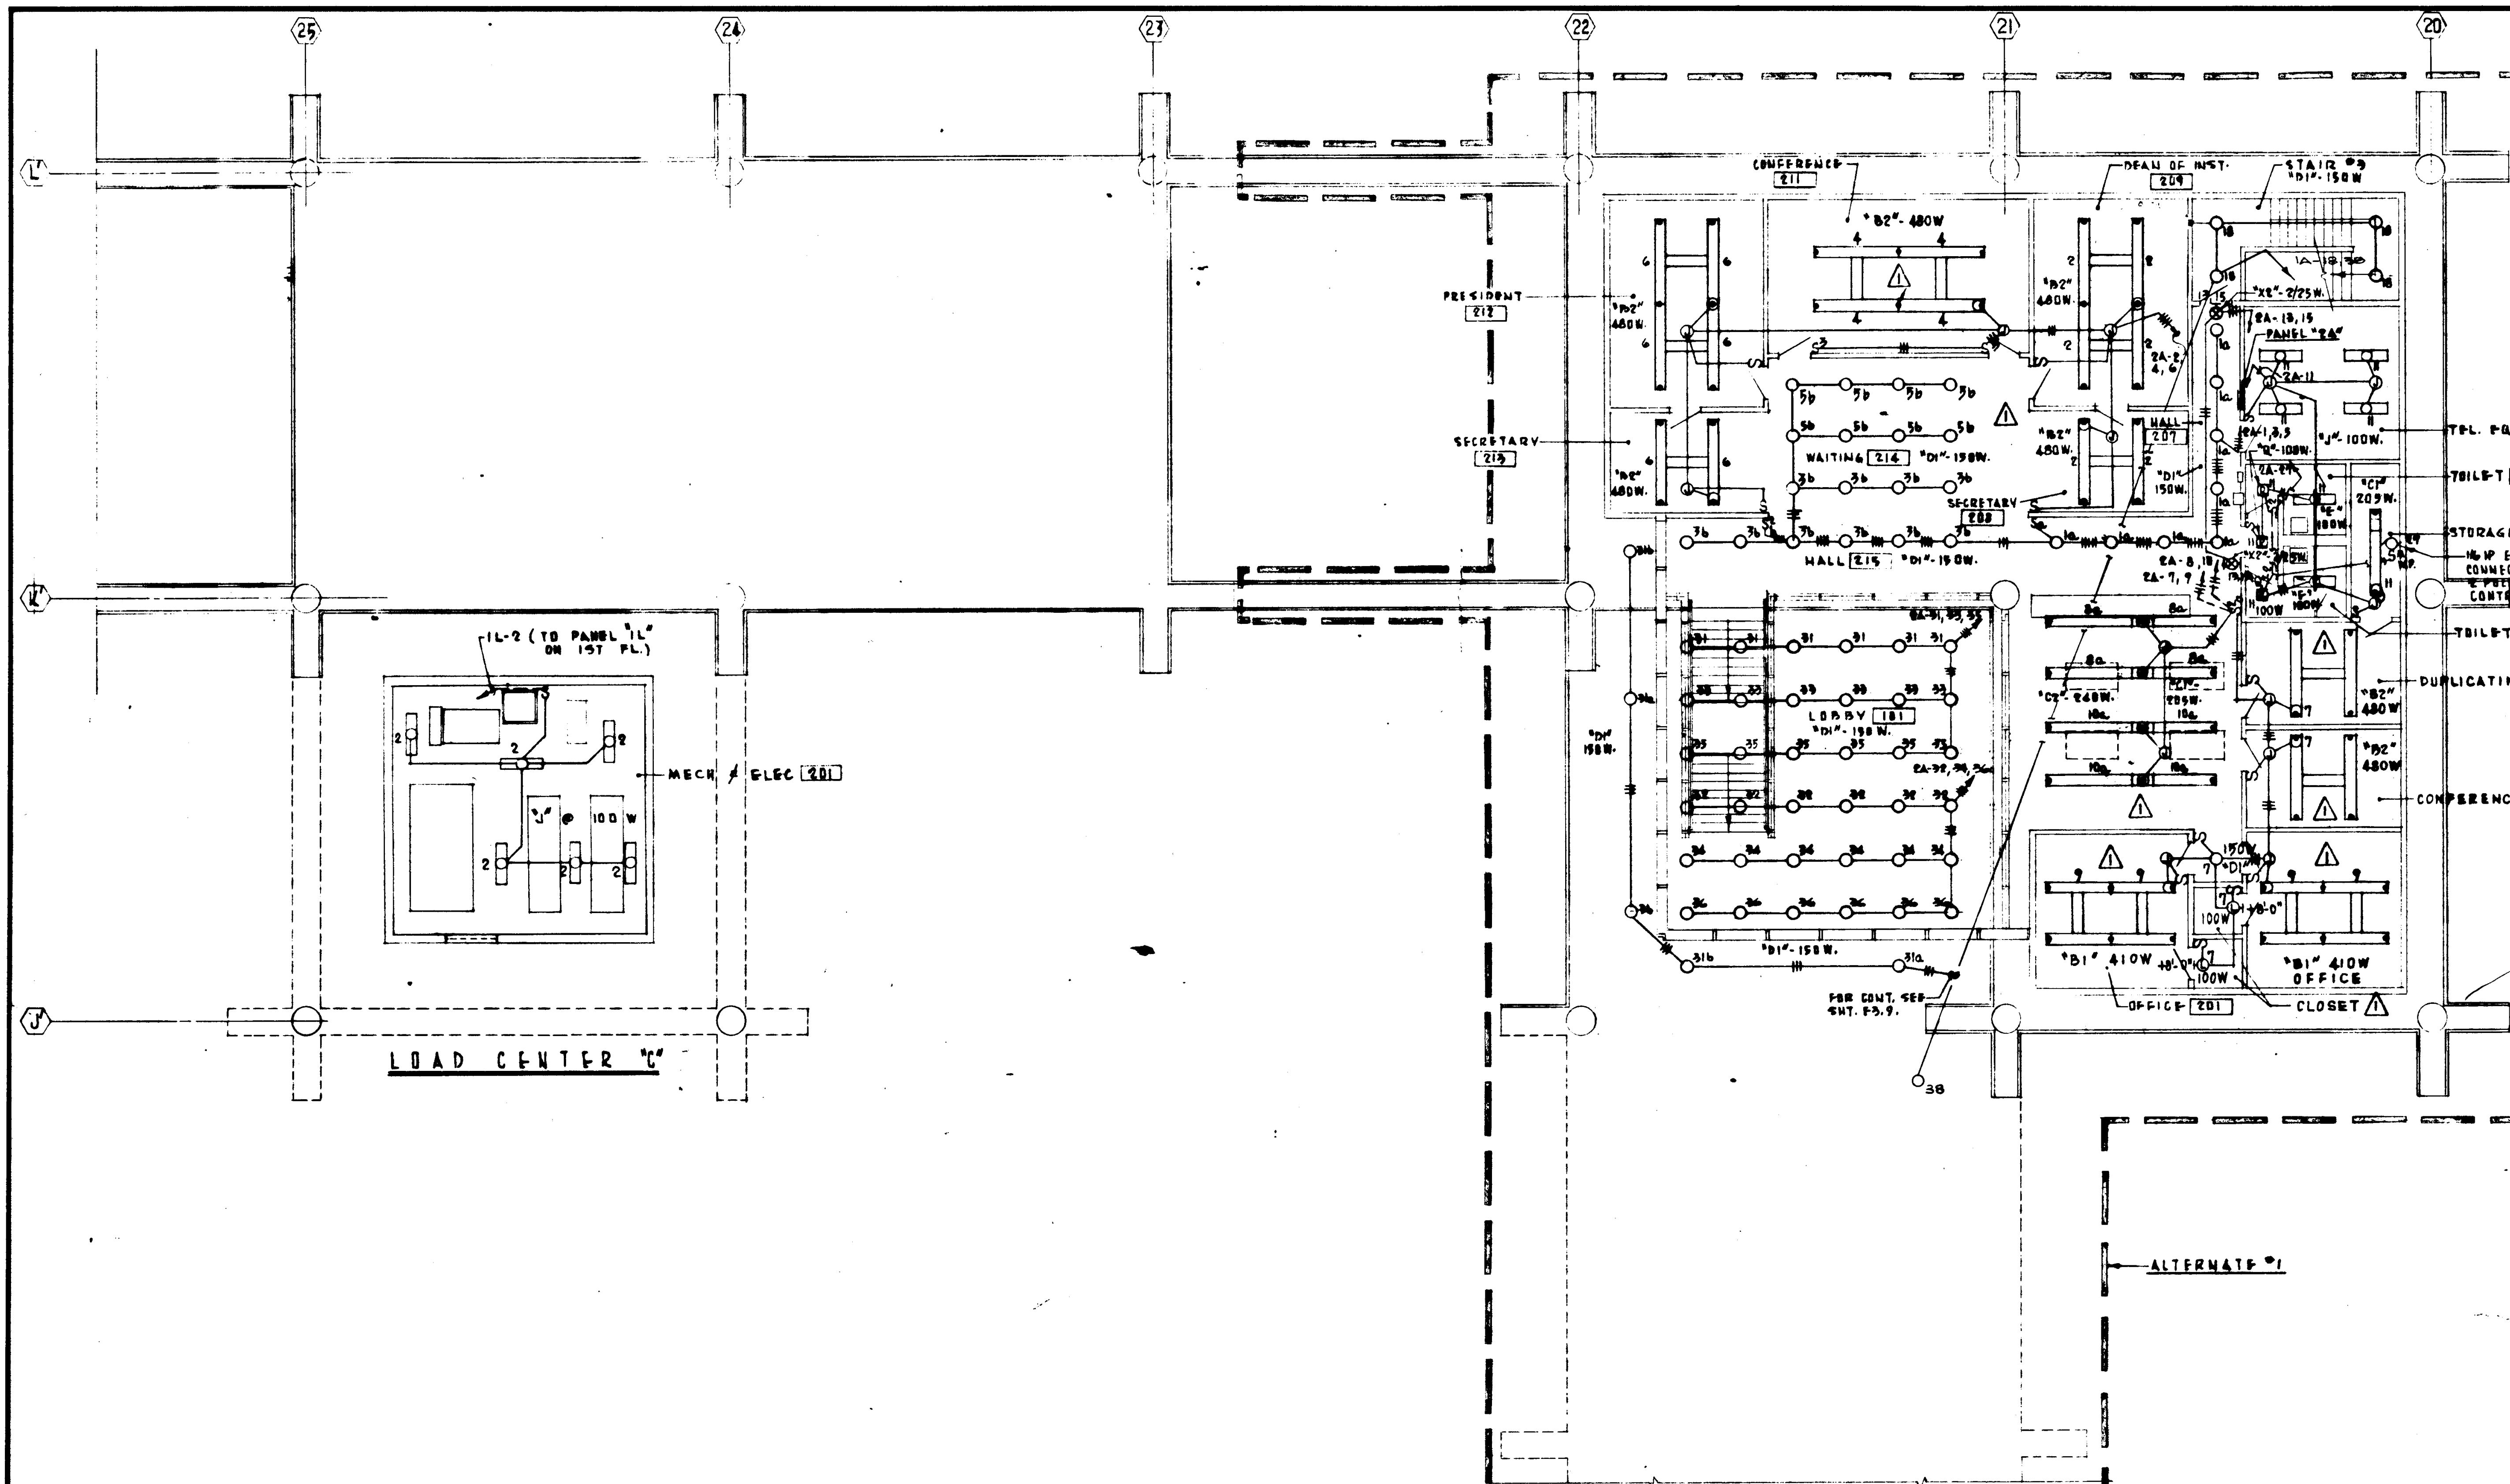

PANEL 2A SCHEDULE									
NO.	OUTLETS	WATTS	AMPS	TYPE	LOCATION	REMARKS	DATE	BY	CHKD.
1	1	1000	4.5	1000	CONFERENCE				
2	1	1200	5.4	1200	DEAN OF MEN'S				
3	1	1000	4.5	1000	STAIRS				
4	1	1000	4.5	1000	STAIRS				
5	1	1000	4.5	1000	STAIRS				
6	1	1000	4.5	1000	STAIRS				
7	1	1000	4.5	1000	STAIRS				
8	1	1000	4.5	1000	STAIRS				
9	1	1000	4.5	1000	STAIRS				
10	1	1000	4.5	1000	STAIRS				
11	1	1000	4.5	1000	STAIRS				
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13	1	1000	4.5	1000	STAIRS				
14	1	1000	4.5	1000	STAIRS				
15	1	1000	4.5	1000	STAIRS				
16	1	1000	4.5	1000	STAIRS				
17	1	1000	4.5	1000	STAIRS				
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25	1	1000	4.5	1000	STAIRS				
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98	1	1000	4.5	1000	STAIRS				
99	1	1000	4.5	1000	STAIRS				
100	1	1000	4.5	1000	STAIRS				

STRUCTURAL ENGINEERS BRANDOW & JOHNSON J. A. MARTIN & ASSOCIATES MECHANICAL ENGINEERS RALPH E. PHILLIPS, INC. ELECTRICAL ENGINEERS RALPH E. PHILLIPS, INC.				DESIGNED DRAWN BY CHECKED BY	ARCHITECT WILLIAM L. FERREIRA & ASSOCIATES A. QUINCY JONES-FREDERICK E. HENRONS & ASSOCIATES BLUMOCK ELLERBROOK & ASSOCIATES	APPROVED STATE FIRE MARSHAL STATE OF CALIFORNIA DATE: JUN 24 1965 25874	ASSOCIATED ARCHITECTS: WILLIAM L. FERREIRA & ASSOCIATES A. QUINCY JONES-FREDERICK E. HENRONS & ASSOCIATES BLUMOCK ELLERBROOK & ASSOCIATES URBANUS SQUARE • MACARTHUR BOULEVARD AT FORD ROAD TELEPHONE 714/678-2640 • CORONA DEL MAR, CALIFORNIA	GOLDEN WEST COLLEGE HUNTINGTON BEACH, CALIFORNIA ORANGE COAST JUNIOR COLLEGE DISTRICT	UNIT FLOOR PLAN	SCALE 1/8" = 1'-0" DATE 6-15-65 SHEET NO. E3.1 I
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FIXTURE MOUNTING DETAIL
NO. SCALE

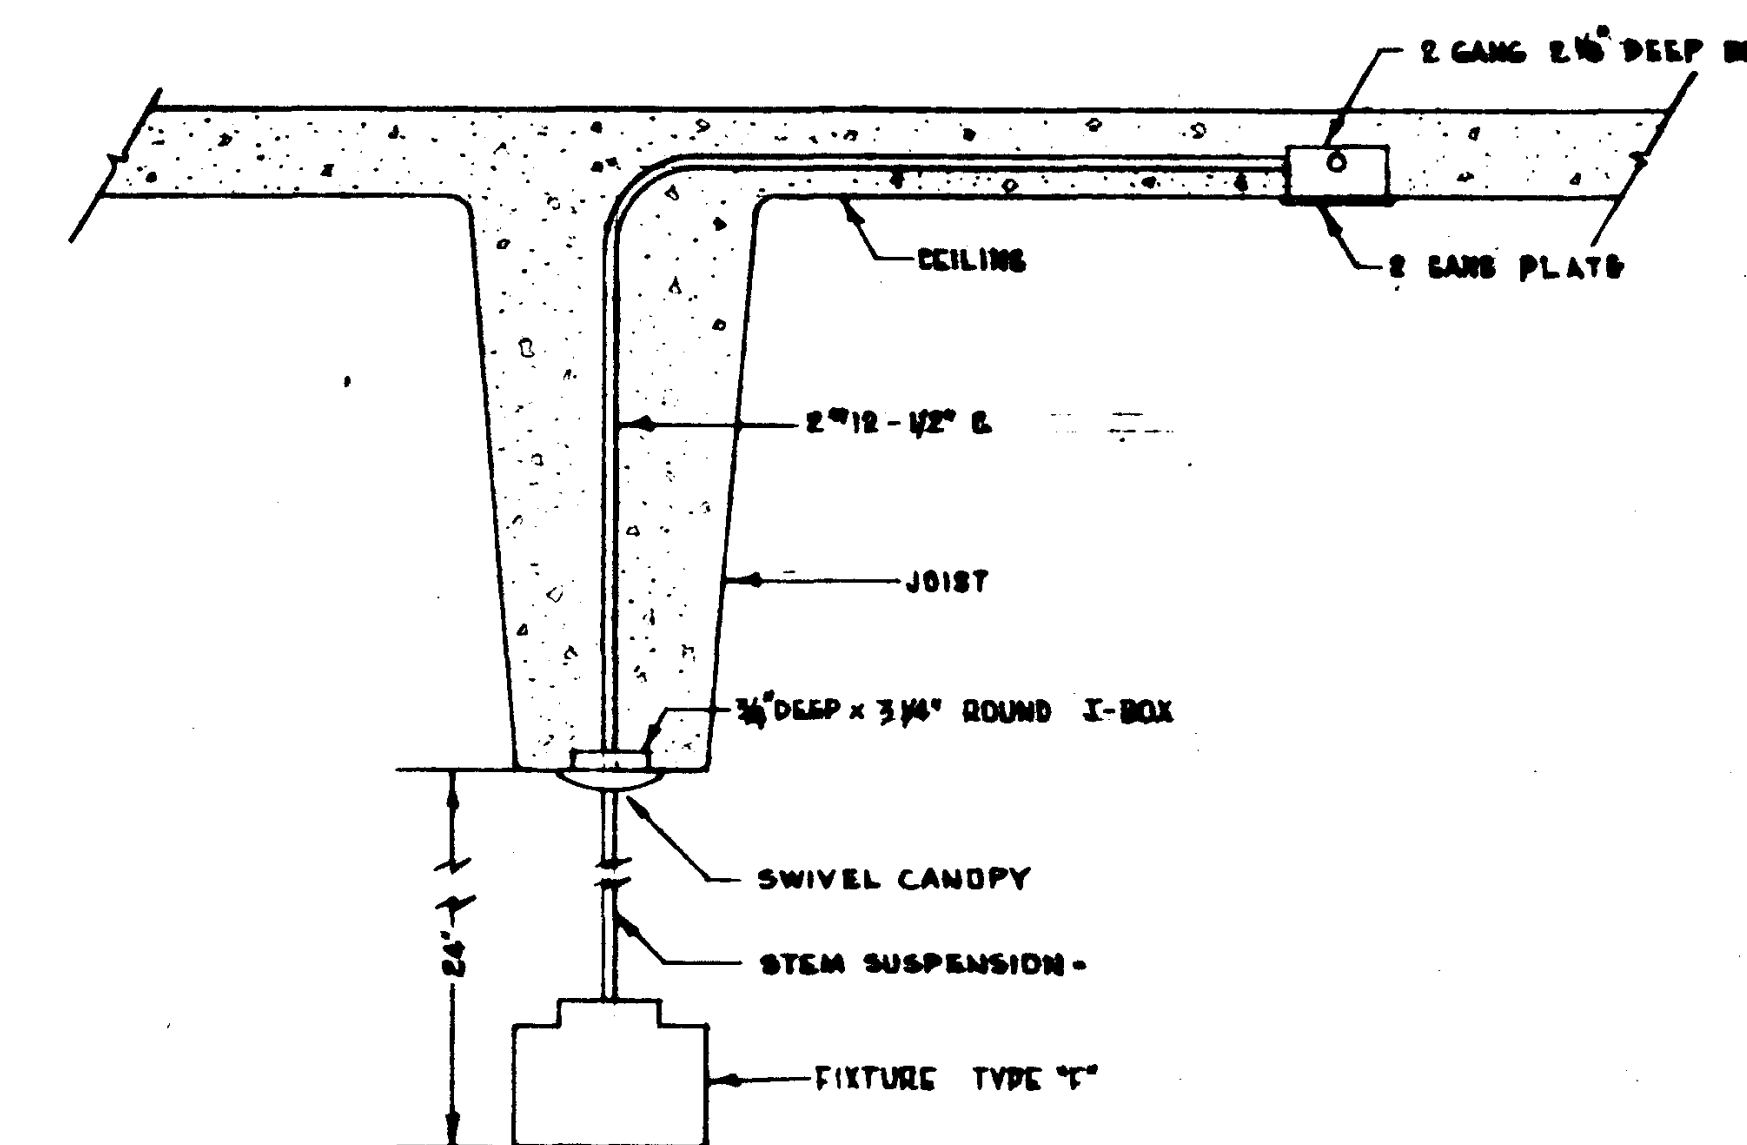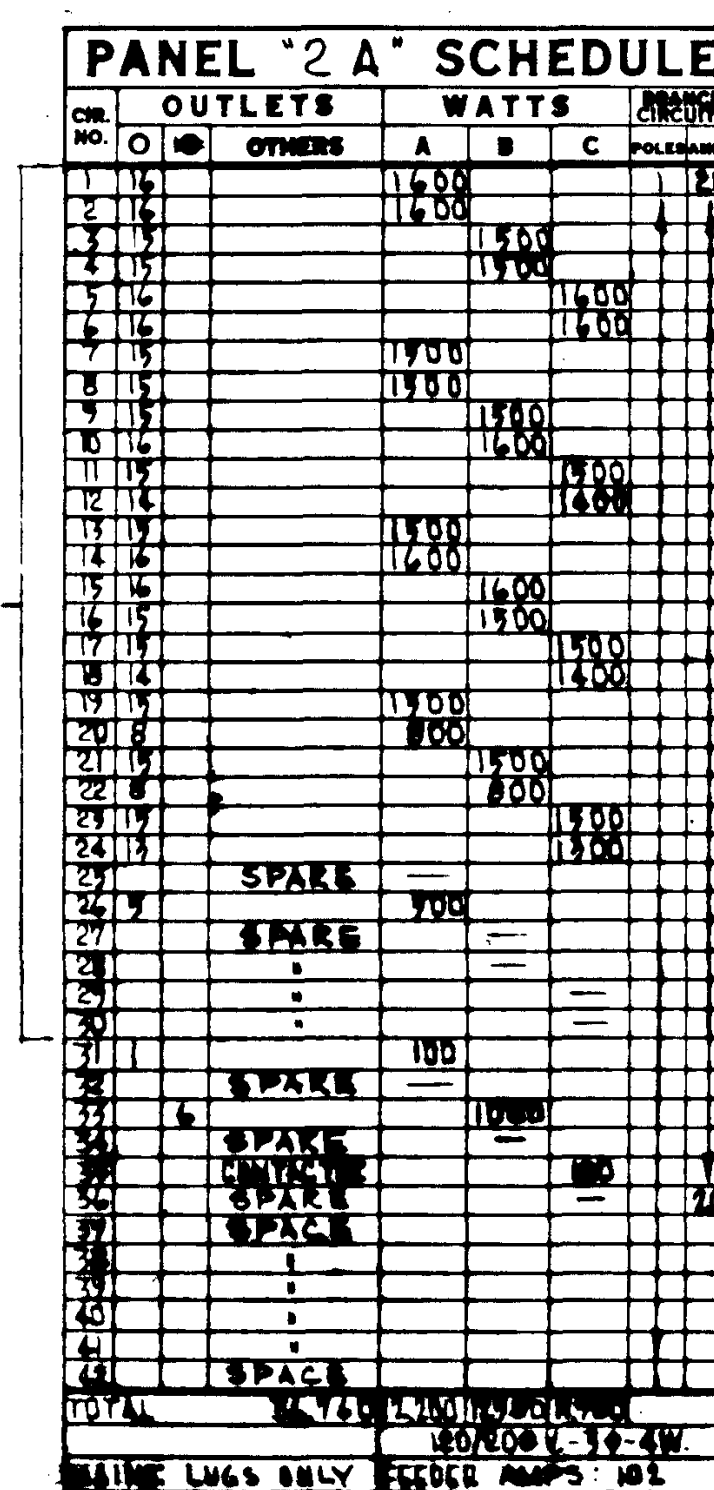NOTES

1. ALL FIXTURES ARE TYPE "F" 100 W SUSPENDED EXCEPT AS NOTED
(SEE FIXTURE MOUNTING DETAIL - ABOVE.)



SECOND FLOOR LIGHTING

GOLDEN WEST COLLEGE
HUNTINGTON BEACH, CALIFORNIA
ORANGE COAST JUNIOR COLLEGE DISTRICT

U	N	I	T
F	L	C	C
P	L	A	N

SCALE 1/4" = 1'-0"	11
JOB NO.	1100-1
DATE	6-15-65
SHEET NO.	1100-1

<div><div>REVISIONS</div><div>DATE</div><div>BY</div></div>	STRUCTURAL ENGINEER BRANDOW & JOHNSON J.A. MARTIN & ASSOCIATES	DESIGNED	ARCHITECT WILLIAMS & PEREIRA	APPROVED	<div><div>APPROVED</div><div>STATE OF CALIFORNIA</div><div>DATE JUN 21 1965</div><div>25874 APPROVED JUN 21 1965</div></div>	ASSOCIATED ARCHITECTS: WILLIAM L. PEREIRA & ASSOCIATES & QUINCY JORCKE BERNICK & ASSOCIATES BLURCK ELLERBROCK & ASSOCIATES	
	MECHANICAL ENGINEER RALPH S. PEREIRA, INC.	DRAWN BY	COLLEGE			URBANUS SQUARE	MACARTHUR BOULEVARD AT FORS ROAD
	ELECTRICAL ENGINEER RALPH S. PEREIRA, INC.	CHECKED BY				TELEPHONE 714/675-2640	CORONA DEL MAR, CALIFORNIA
	CIVIL ENGINEER G. WILHELMAN & ASSOCIATES						

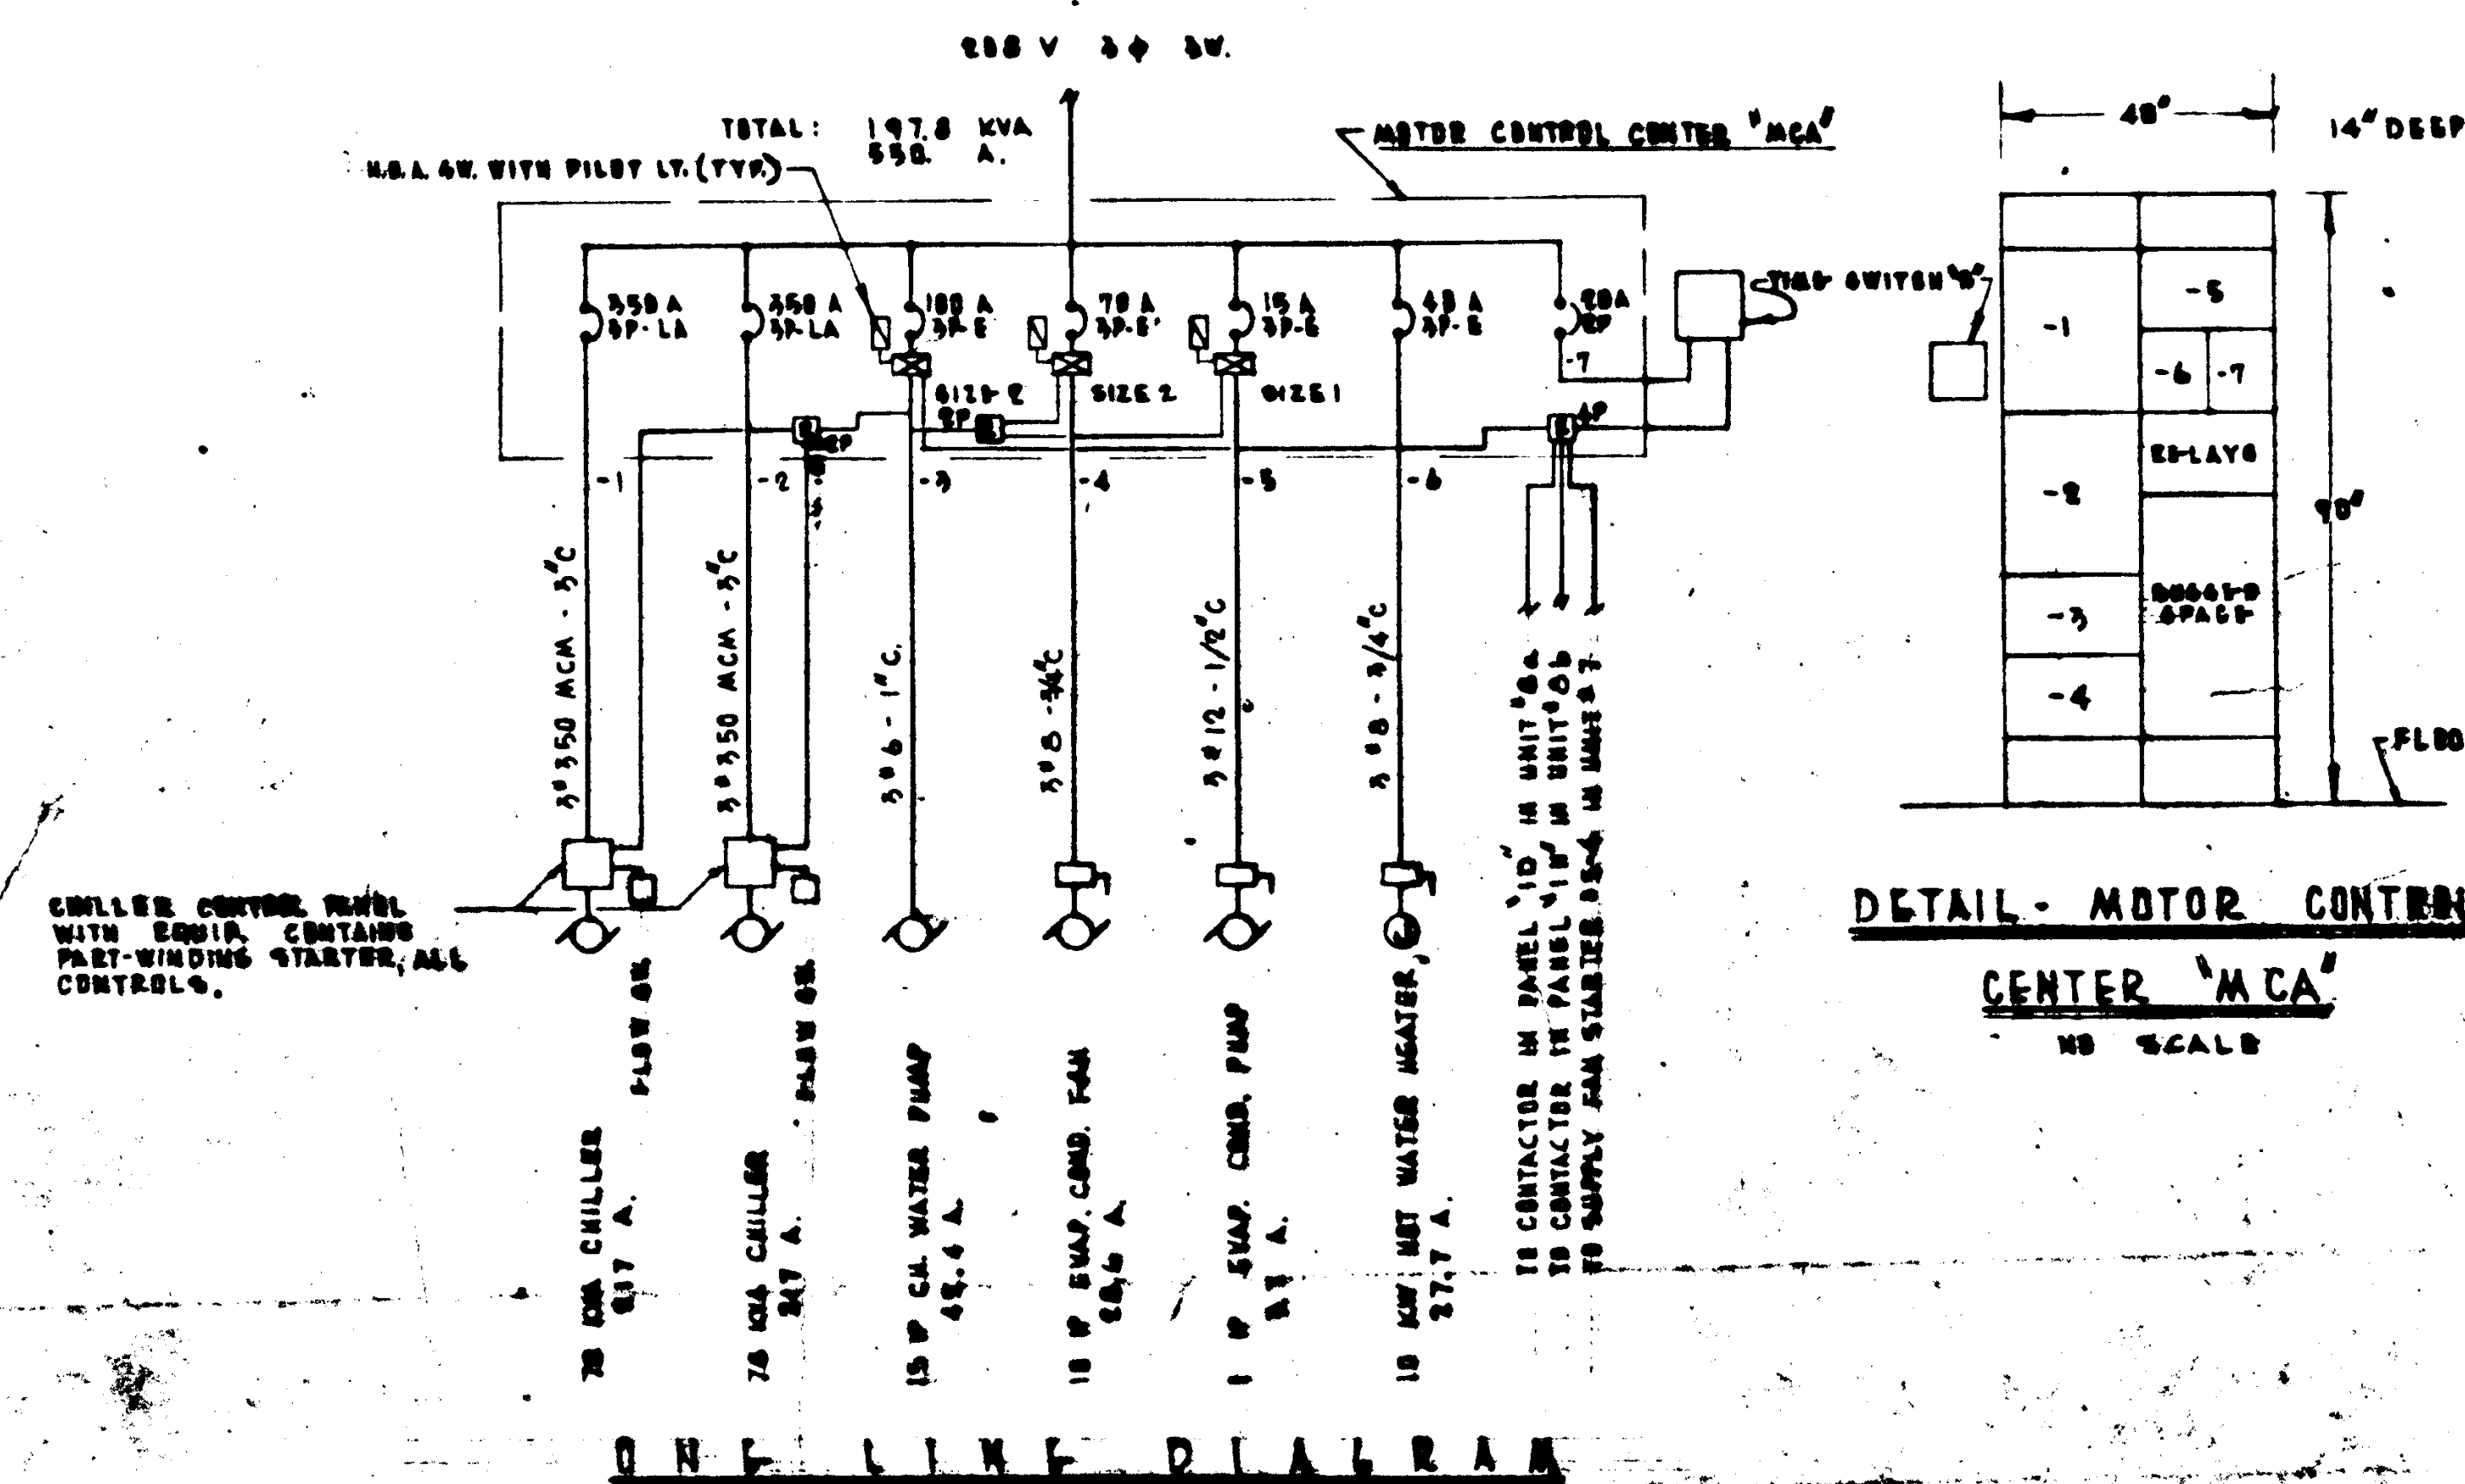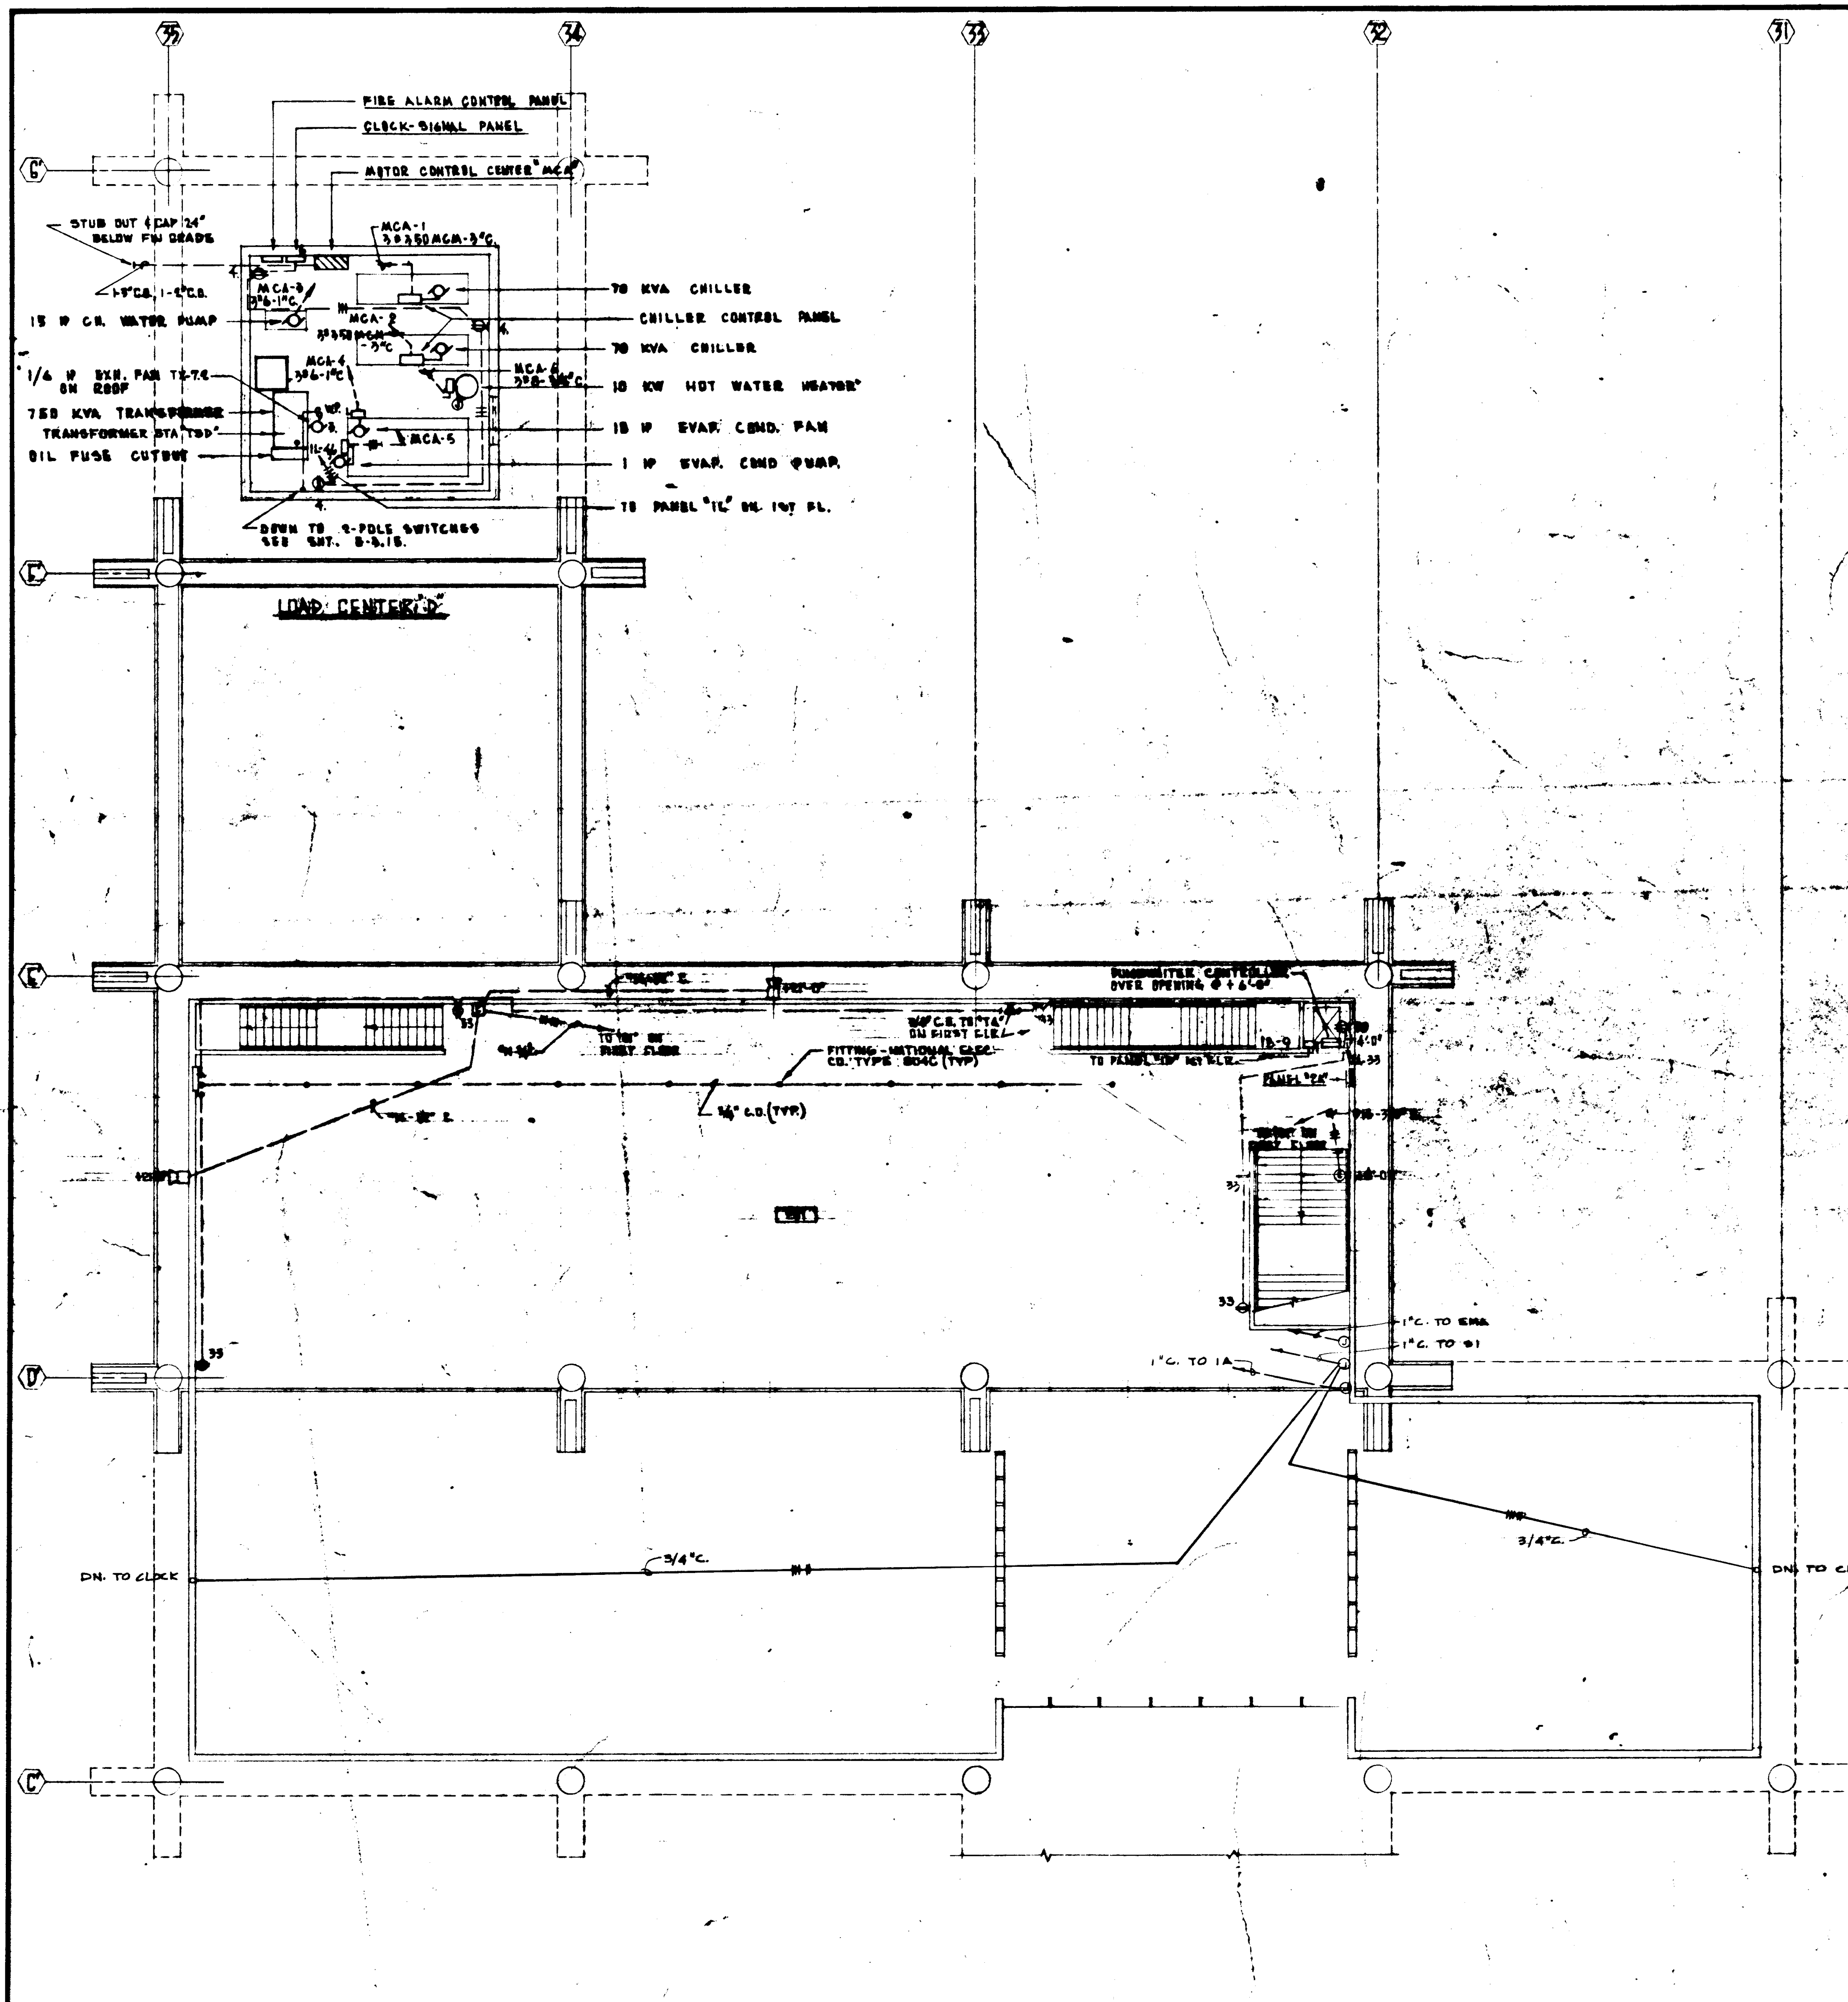

NOTE:
EQUIPMENT SHOWN IS SHOWN REPRESENTATIVELY. ACTUAL
EQUIPMENT SHALL BE AS PER MANUFACTURER'S
DESIGN AND TYPE SPECIFICATIONS.

DETAIL - MOTOR CONTROL
CENTER 'MCA'
NO SCALE

SECOND FLOOR POWER & SIGNALS

NO.	REVISIONS
1	
2	
3	
4	
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8	
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10	


STRUCTURAL ENGINEER BRADY & JOHNSON 1 A. MARTIN & ASSOCIATES	MECHANICAL ENGINEER RALPH E. PHILLIPS, INC.	ELECTRICAL ENGINEER RALPH E. PHILLIPS, INC.	CIVIL ENGINEER O. BEUBERMAN & ASSOCIATES MOFFATT & STUBBS
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APPROVED STATE FIRE MARSHAL STATE OF CALIFORNIA DATE: JUN 21 1965	APPROVED JUN 21 1965
--	----------------------


ASSOCIATED ARCHITECTS:
WILLIAM L. PEREIRA & ASSOCIATES
A. GUNCEY JONES-FREDERICK E. HENSON & ASSOCIATES
BLURROCK ELLERBROOK & ASSOCIATES
URBANUS SQUARE • MACARTHUR BOULEVARD AT FORD ROAD
TELEPHONE 714/678-3800 • CORONA DEL MAR, CALIFORNIA

GOLDEN WEST COLLEGE
HUNTINGTON BEACH, CALIFORNIA
ORANGE COAST JUNIOR COLLEGE DISTRICT

UNIT 7	SCALE: 1/8" = 1'-0"
FLOOR PLAN	DATE: 6-15-65
	DRAWN BY: DSC-188

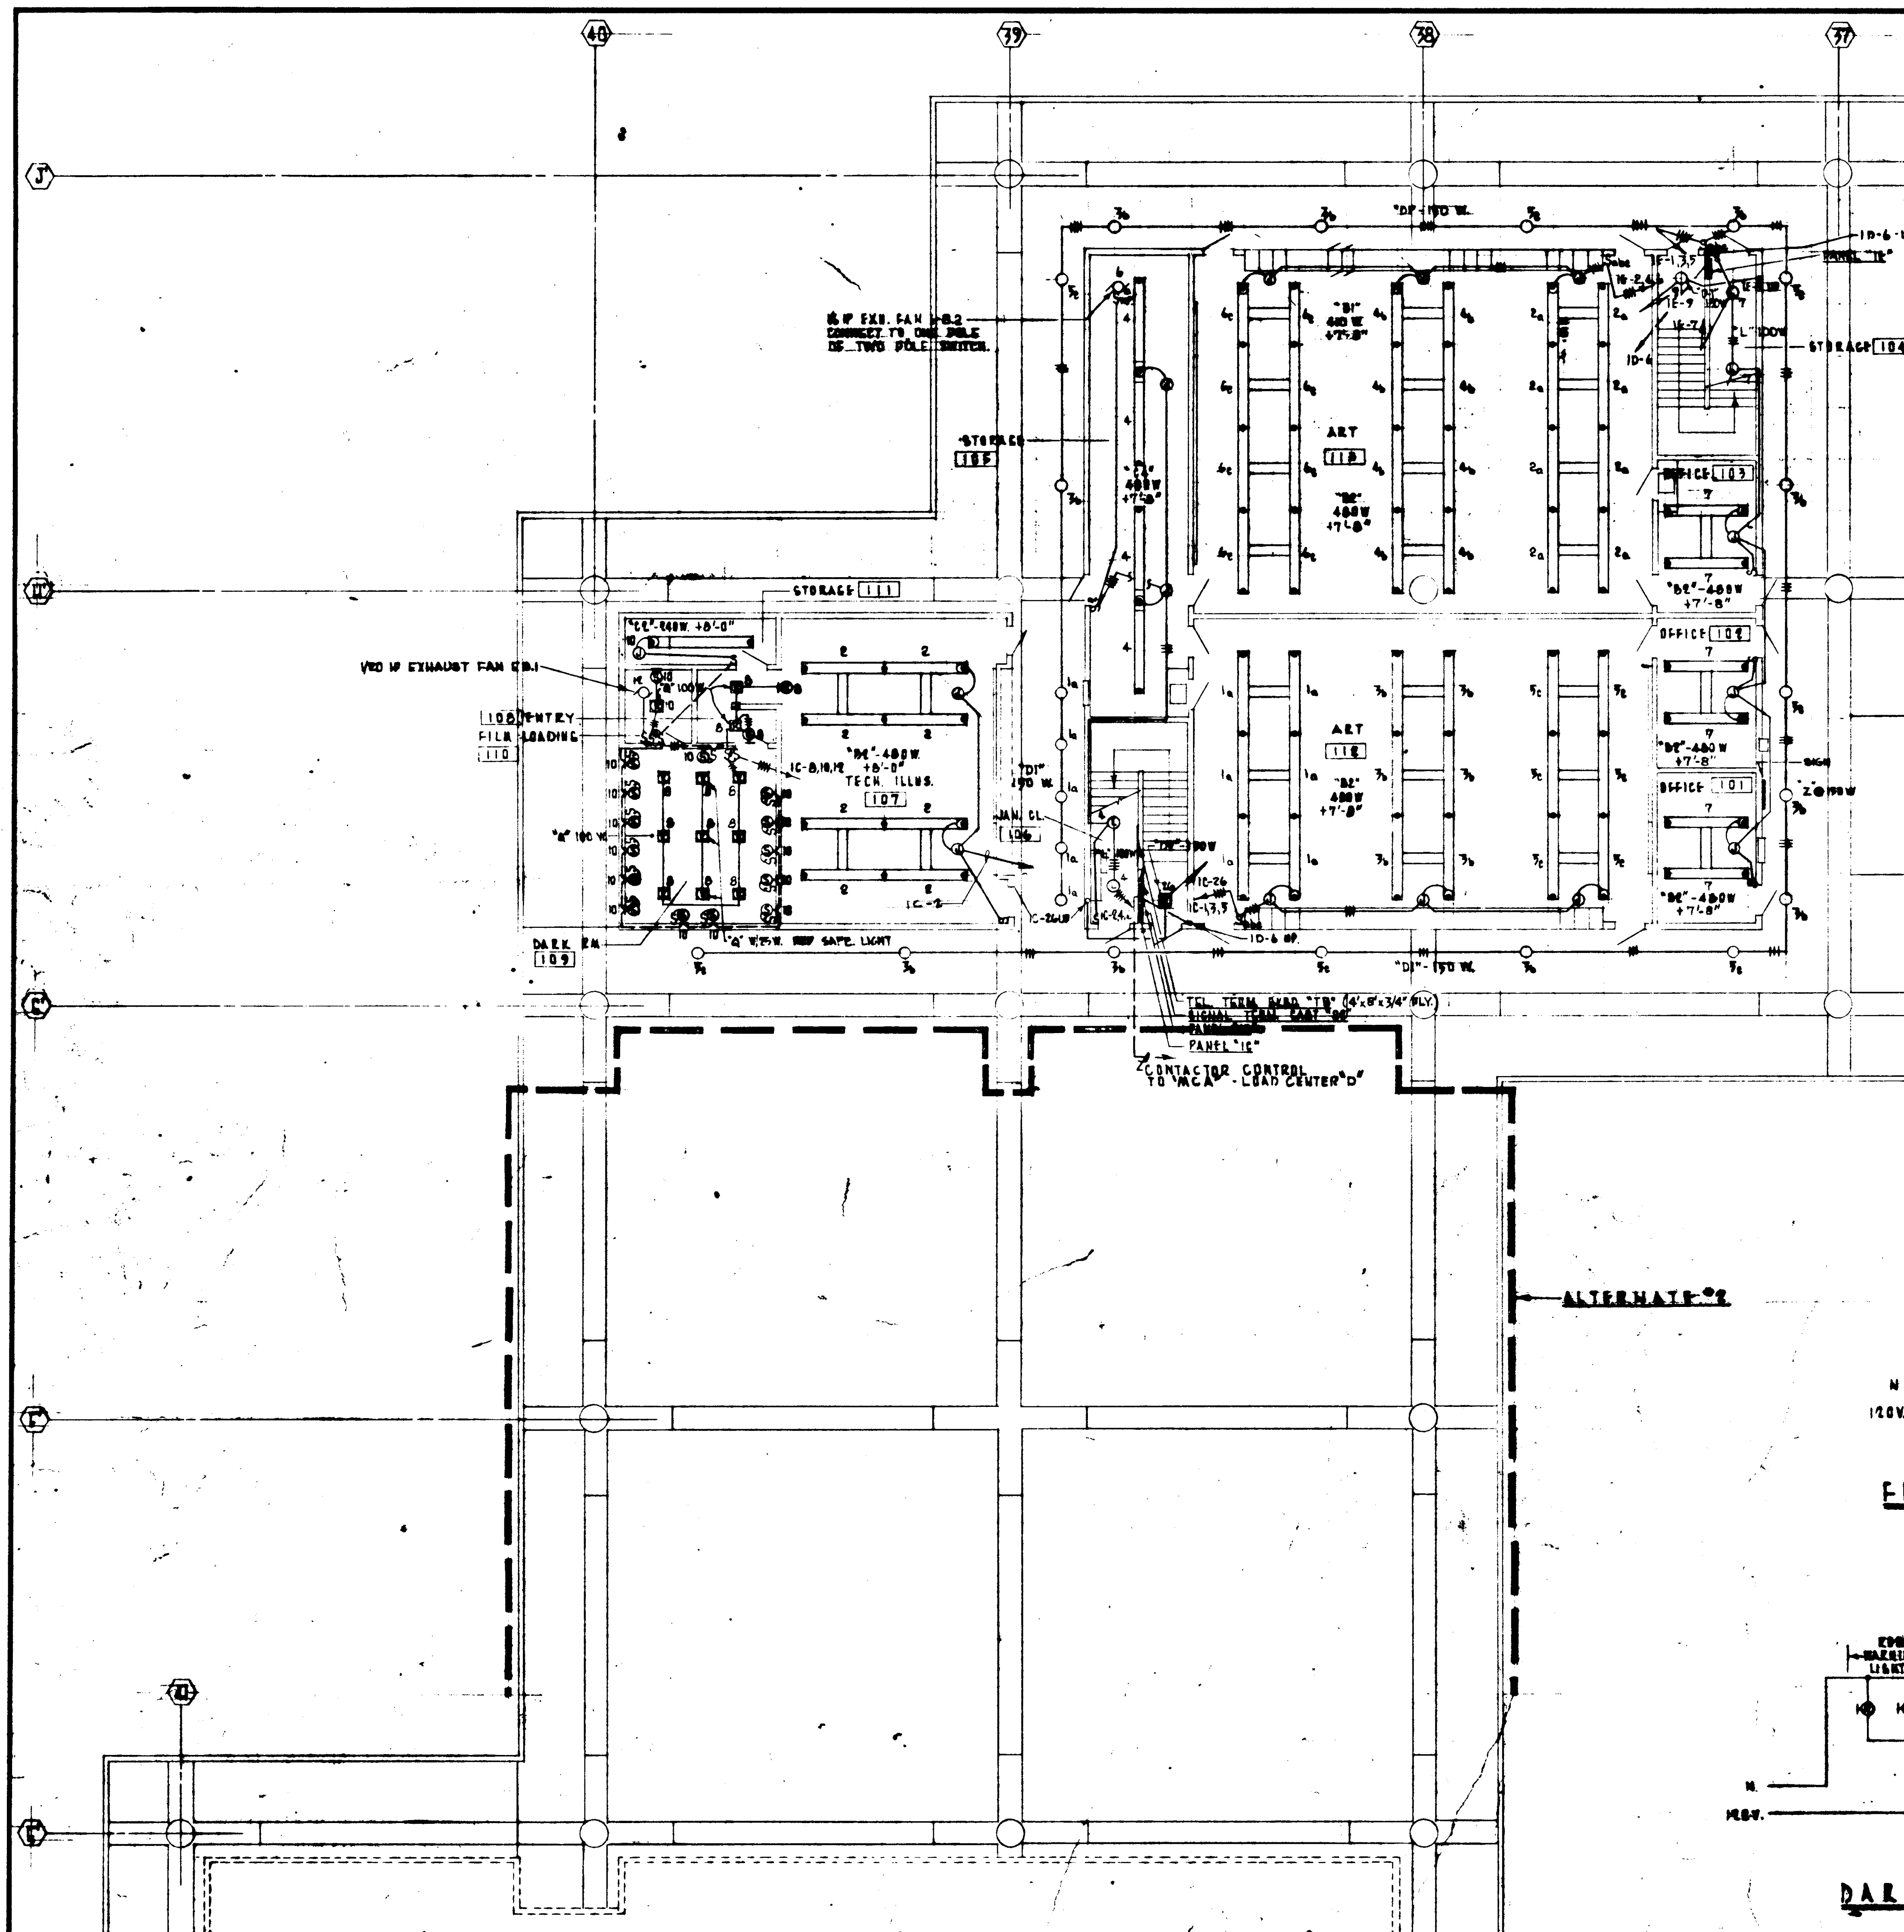

PANEL "IC" SCHEDULE									
NO.	OUTLETS	WATTS	AMPS	NO.	OUTLETS	WATTS	AMPS	NO.	OUTLETS
1	10-0	440	2.0	11	10-0	440	2.0	21	10-0
2	10-0	440	2.0	12	10-0	440	2.0	22	10-0
3	10-0	440	2.0	13	10-0	440	2.0	23	10-0
4	10-0	440	2.0	14	10-0	440	2.0	24	10-0
5	10-0	440	2.0	15	10-0	440	2.0	25	10-0
6	10-0	440	2.0	16	10-0	440	2.0	26	10-0
7	10-0	440	2.0	17	10-0	440	2.0	27	10-0
8	10-0	440	2.0	18	10-0	440	2.0	28	10-0
9	10-0	440	2.0	19	10-0	440	2.0	29	10-0
10	10-0	440	2.0	20	10-0	440	2.0	30	10-0
31	10-0	440	2.0	32	10-0	440	2.0	33	10-0
34	10-0	440	2.0	35	10-0	440	2.0	36	10-0
37	10-0	440	2.0	38	10-0	440	2.0	39	10-0
253	10-0	440	2.0	254	10-0	440	2.0	255	10-0
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259	10-0	440	2.0	260	10-0	440	2.0	261	10-0
262	10-0	440	2.0	263	10-0	440	2.0	264	10-0
265	10-0	440	2.0	266	10-0	440	2.0	267	10-0
268	10-0	440	2.0	269	10-0	440	2.0	270	10-0
271	10-0	440	2.0	272	10-0	440	2.0	273	10-0
274	10-0	440	2.0	275	10-0	440	2.0	276	10-0
277	10-0	440	2.0	278	10-0	440	2.0	279	10-0
280	10-0	440	2.0	281	10-0	440	2.0	282	10-0
283	10-0	440	2.0	284	10-0	440	2.0	285	10-0
286	10-0	440	2.0	287	10-0	440	2.0	288	10-0
289	10-0	440	2.0	290	10-0	440	2.0	291	10-0
292	10-0	440	2.0	293	10-0	440	2.0	294	10-0
295	10-0	440	2.0	296	10-0	440	2.0	297	10-0
298	10-0	440	2.0	299	10-0	440	2.0	300	10-0
301	10-0	440	2.0	302	10-0	440	2.0	303	10-0
304	10-0	440	2.0	305	10-0	440	2.0	306	10-0
307	10-0	440	2.0	308	10-0	440	2.0	309	10-0
310	10-0	440	2.0	311	10-0	440	2.0	312	10-0
313	10-0	440	2.0	314	10-0	440	2.0	315	10-0
316	10-0	440	2.0	317	10-0	440	2.0	318	10-0
319	10-0	440	2.0	320	10-0	440	2.0	321	10-0
322	10-0	440	2.0	323	10-0	440	2.0	324	10-0
325	10-0	440	2.0	326	10-0	440	2.0	327	10-0
328	10-0	440	2.0	329	10-0	440	2.0	330	10-0
331	10-0	440	2.0	332	10-0	440	2.0	333	10-0
334	10-0	440	2.0	335	10-0	440	2.0	336	10-0
337	10-0	440	2.0	338	10-0	440	2.0	339	10-0
340	10-0	440	2.0	341	10-0	440	2.0	342	10-0
343	10-0	440	2.0	344	10-0	440	2.0	345	10-0
346	10-0	440	2.0	347	10-0	440	2.0	348	10-0
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352	10-0	440	2.0	353	10-0	440	2.0	354	10-0
355	10-0	440	2.0	356	10-0	440	2.0	357	10-0
358	10-0	440	2.0	359	10-0	440	2.0	360	10-0
361	10-0	440	2.0	362	10-0	440	2.0	363	10-0
364	10-0	440	2.0	365	10-0	440	2.0	366	10-0
367	10-0	440	2.0	368	10-0	440	2.0	369	10-0
370	10-0	440	2.0	371	10-0	440	2.0	372	10-0
373	10-0	440	2.0	374	10-0	440	2.0	375	10-0
376	10-0	440	2.0	377	10-0	440	2.0	378	10-0
379	10-0	440	2.0	380	10-0	440	2.0	381	10-0
382	10-0	440	2.0	383	10-0	440	2.0	384	10-0
385	10-0	440	2.0	386	10-0	440	2.0	387	10-0
388	10-0	440	2.0	389	10-0	440	2.0	390	10-0
391	10-0	440	2.0	392	10-0	440	2.0	393	10-0
394	10-0	440	2.0	395	10-0	440	2.0	396	10-0
397	10-0	440	2.0	398	10-0	440	2.0	399	10-0
400	10-0	440	2.0	401	10-0	440	2.0	402	10-0
403	10-0	440	2.0	404	10-0	440	2.0	405	10-0
406	10-0	440	2.0	407	10-0	440	2.0	408	10-0
409	10-0	440	2.0	410	10-0	440	2.0		

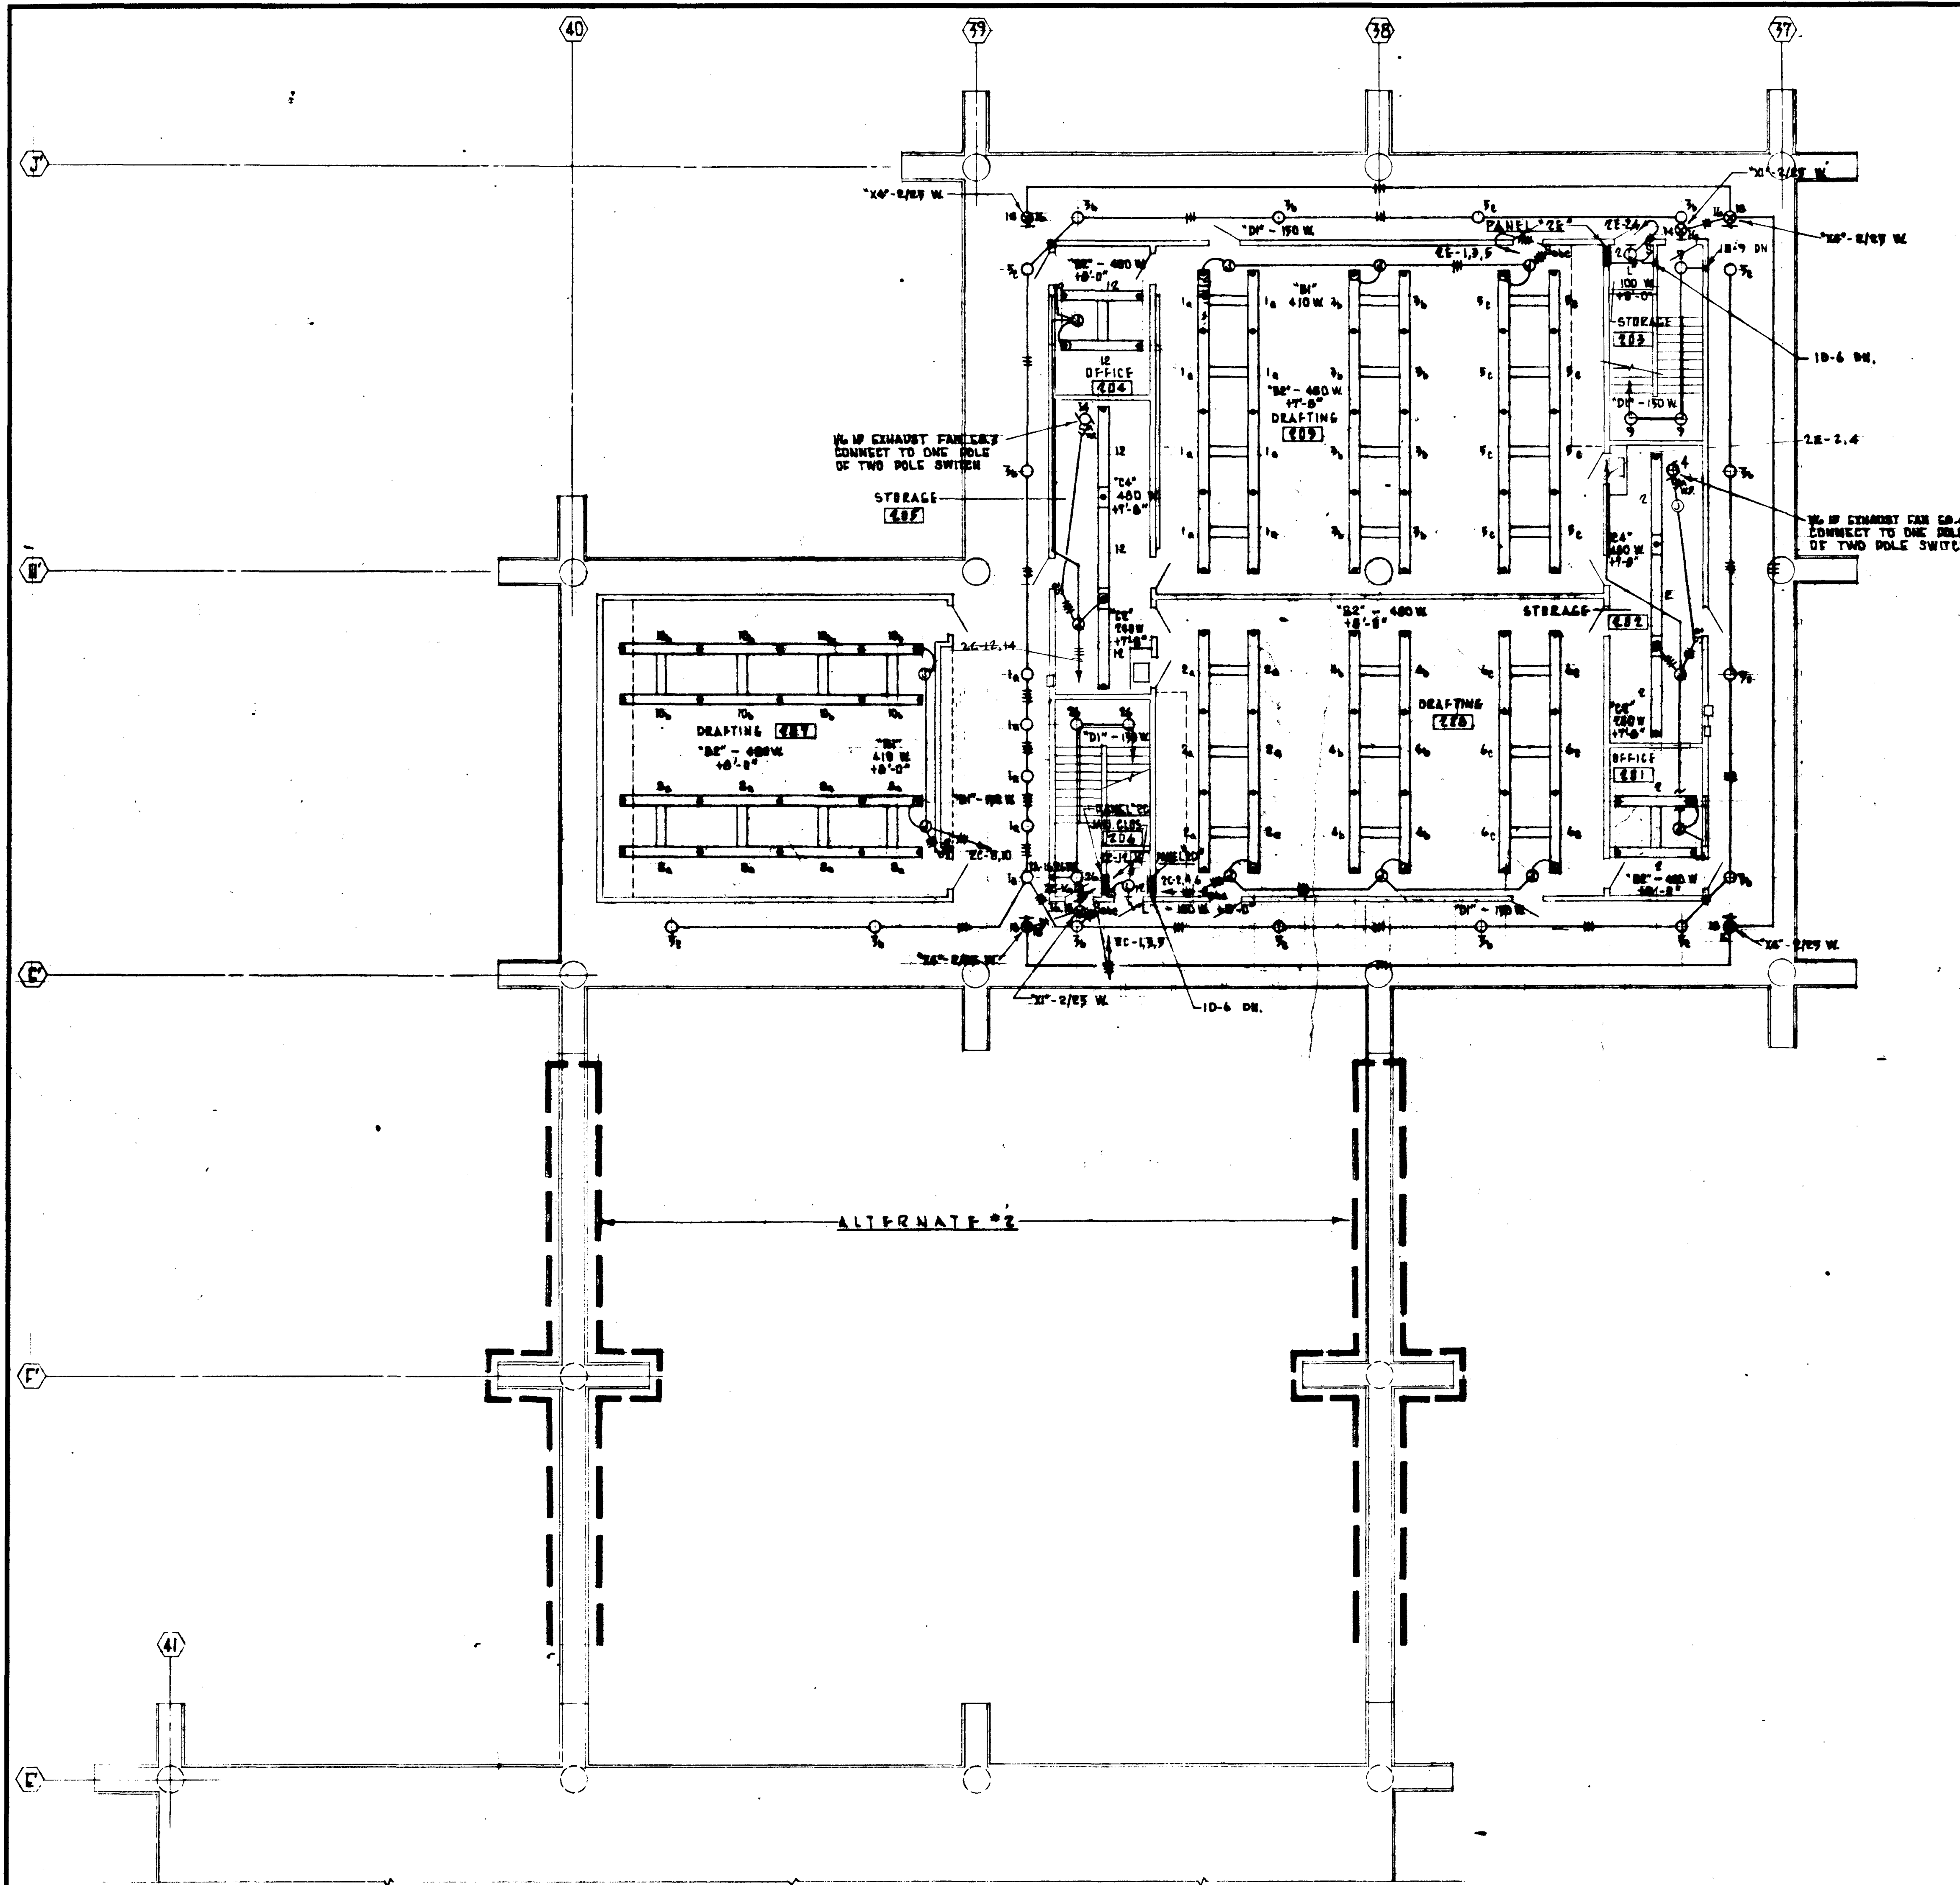

PANEL '2C' SCHEDULE

CIR.	NO.	OUTLETS		WATTS			F.F.
		O	OTHERS	A	B	C	
1	1						
2	2						
3	3						
4	4						
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7	7						
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100	100						


PANEL '2E' SCHEDULE

CIR.	NO.	OUTLETS		WATTS			F.F.
		O	OTHERS	A	B	C	
1	1						
2	2						
3	3						
4	4						
5	5						
6	6						
7	7						
8	8						
9	9						
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100	100						

*30 A-3P CONTRACTOR IN PANEL TO CONTROL CIR. 6 & 8 (1 POLE 4 WIRE) CONTROLLED BY CIR. 10-6 IN PANEL '10'.



SECOND FLOOR LIGHTING

REVISIONS 1. _____ 2. _____ 3. _____ 4. _____ 5. _____ 6. _____ 7. _____ 8. _____ 9. _____ 10. _____	STRUCTURAL ENGINEER BRANTON & JOHNSON J.A. MARTIN & ASSOCIATES	DESIGNED BY RALPH E. PHILLIPS, INC.	ARCHITECT WILLIAM L. PEREIRA & ASSOCIATES A. QUINCY JONES-FREDERICK E. EMMONS & ASSOCIATES BLUMOCK ELLERBROOK & ASSOCIATES	APPROVED STATE FIRE MARSHAL DATE: JUN 1 1965	APPROVED JUN 2 1965	GOLDEN WEST COLLEGE HUNTINGTON BEACH, CALIFORNIA ORANGE COAST JUNIOR COLLEGE DISTRICT	UNIT 88a FLOOR PLAN	SCALE 1/8" = 1'-0" DATE 6-15-65 SHEET NO. 1033-21
	ELECTRICAL ENGINEER RALPH E. PHILLIPS, INC.	CHECKED BY G. SHUTEMAN & ASSOCIATES ROYALTY & NICHOL	COLLEGE	URBANUS SQUARE • MACARTHUR BOULEVARD AT FORD ROAD TELEPHONE 714/675-2640 • CORONA DEL MAR, CALIFORNIA				

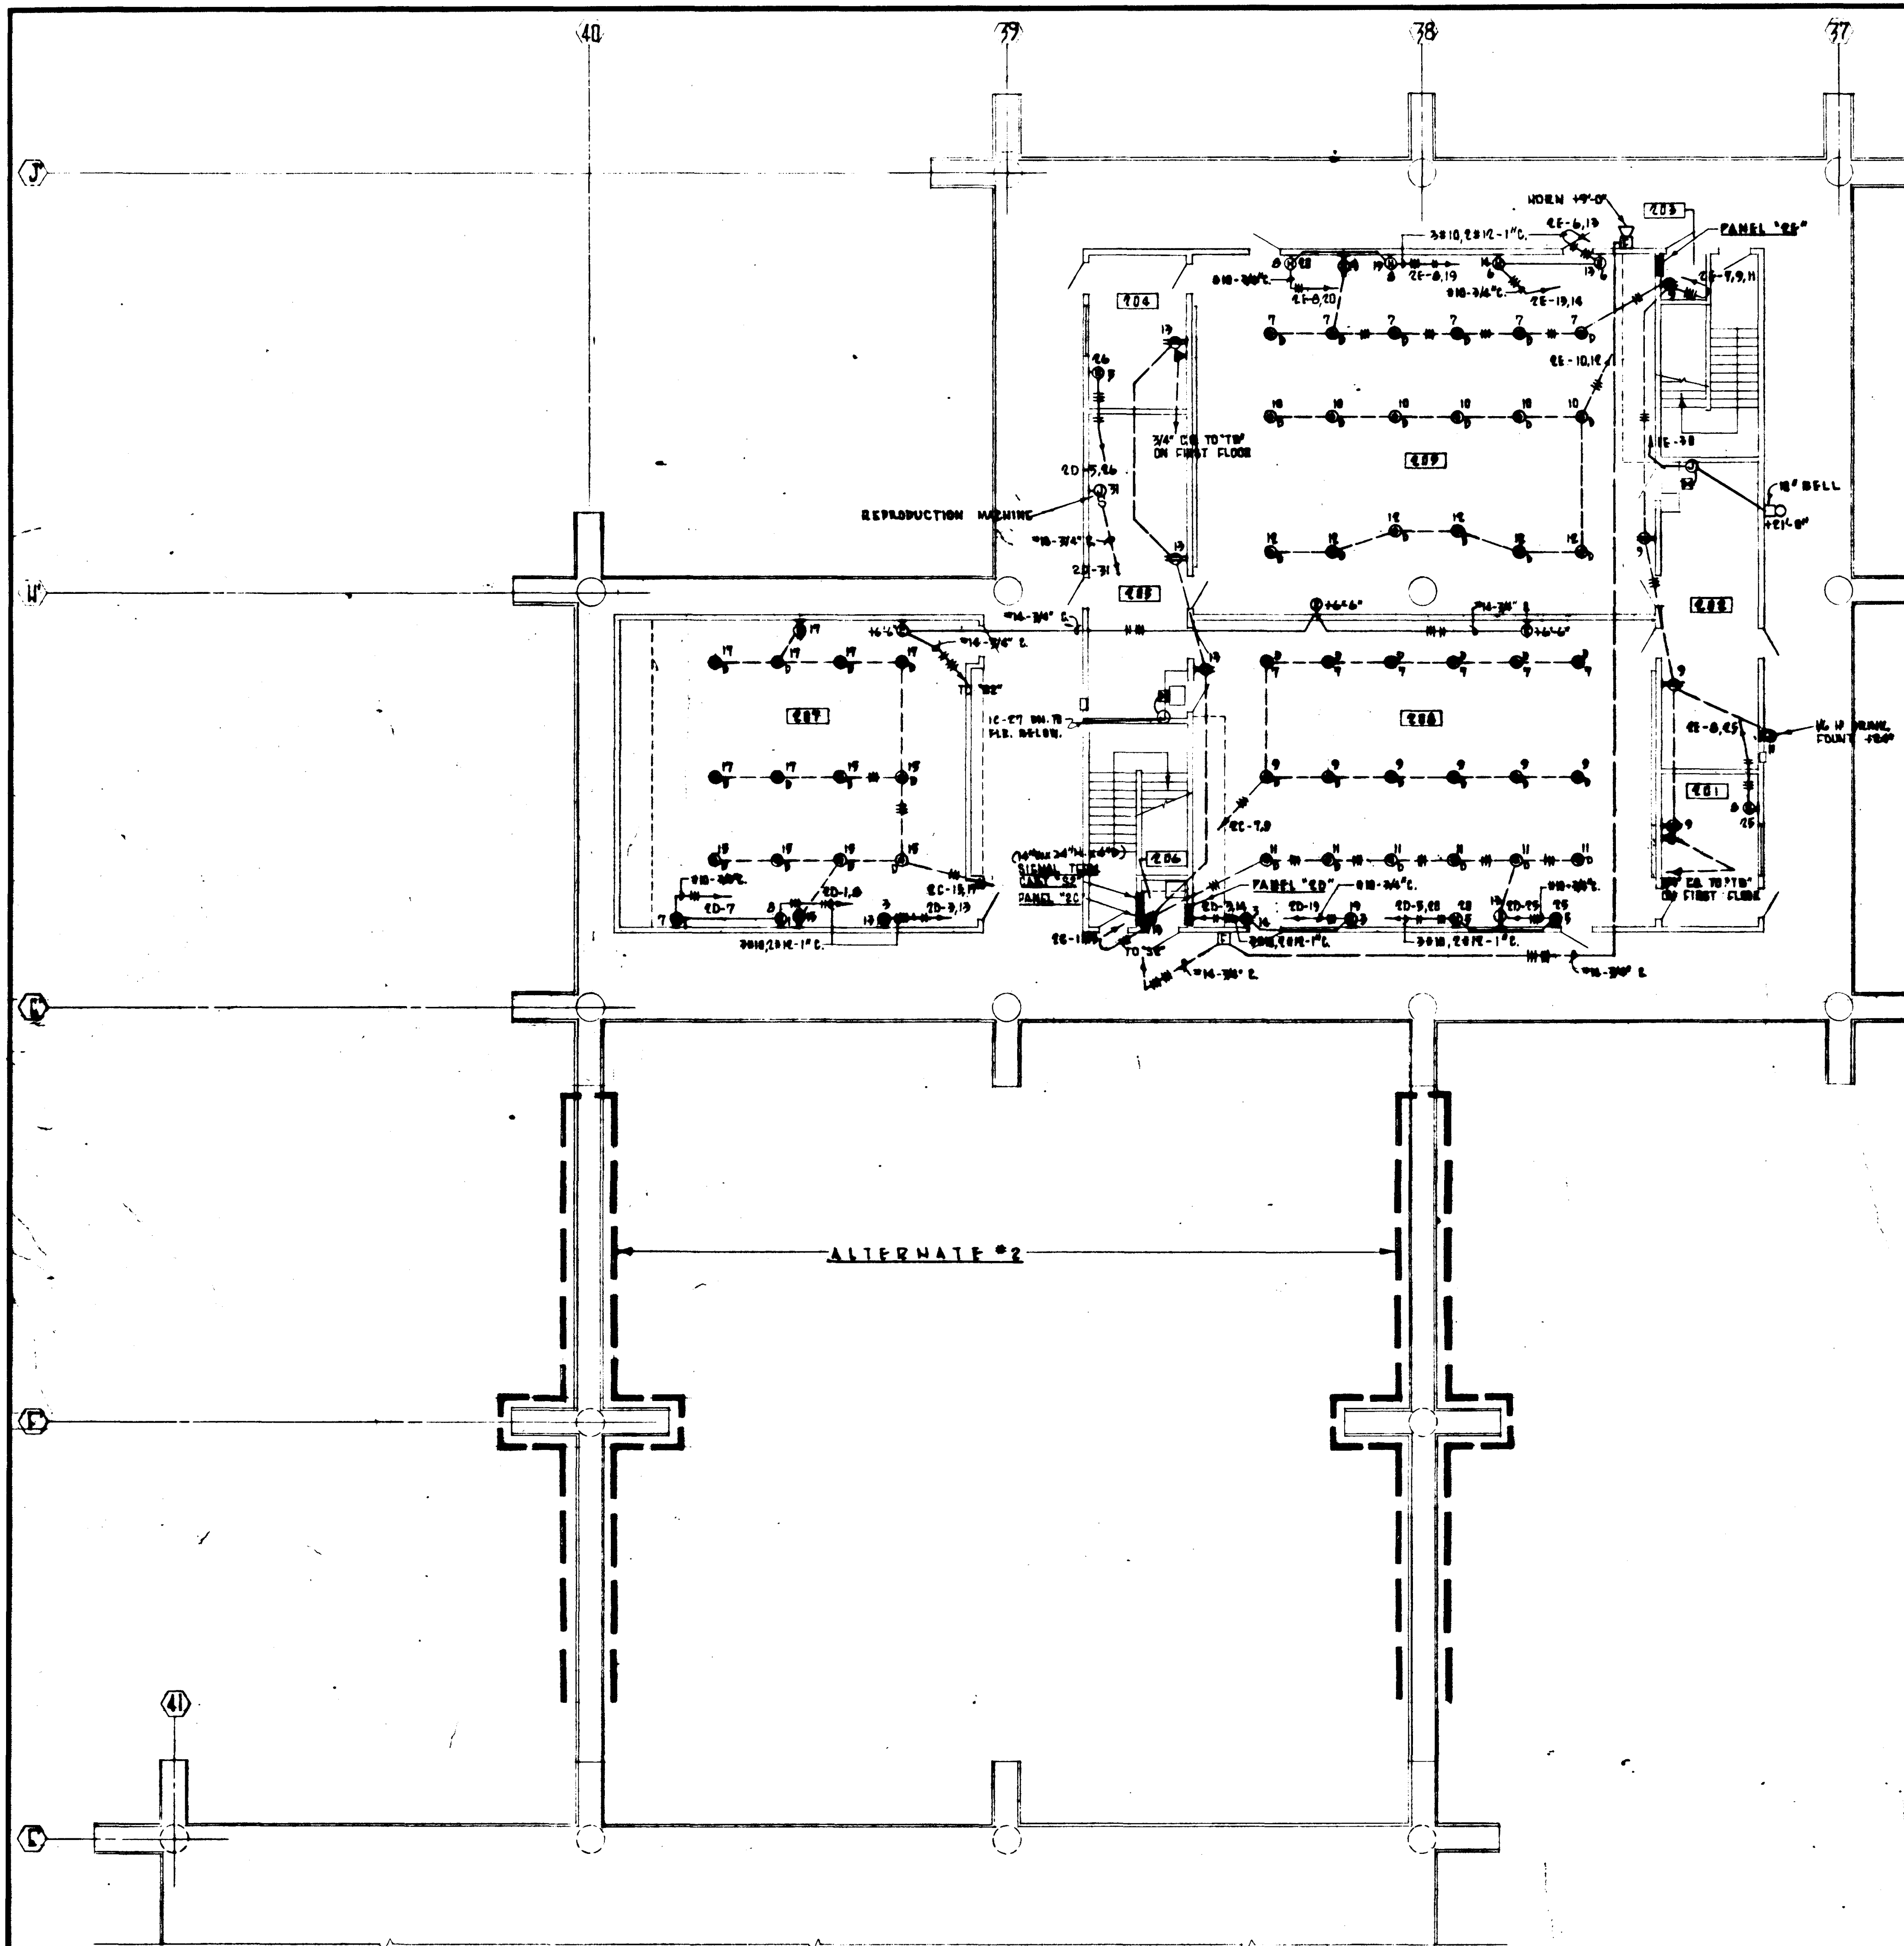



PANEL "20" SCHEDULE									
CIR. NO.	OUTLETS	WATTS			CIR. NO.	OUTLETS	WATTS		
		A	B	C			A	B	C
1	SPACE	250			1	SPACE	250		
2	SPACE	750			2	SPACE	750		
3	SPACE				3	SPACE			
4	SPACE	1000			4	SPACE	1000		
5	SPACE				5	SPACE			
6	SPACE	1000			6	SPACE	1000		
7	SPACE				7	SPACE			
8	SPACE	1000			8	SPACE	1000		
9	SPACE				9	SPACE			
10	SPACE	1000			10	SPACE	1000		
11	SPACE				11	SPACE			
12	SPACE	1000			12	SPACE	1000		
13	SPACE				13	SPACE			
14	SPACE	1000			14	SPACE	1000		
15	SPACE				15	SPACE			
16	SPACE	1000			16	SPACE	1000		
17	SPACE				17	SPACE			
18	SPACE	1000			18	SPACE	1000		
19	SPACE				19	SPACE			
20	SPACE	1000			20	SPACE	1000		
21	SPACE				21	SPACE			
22	SPACE	1000			22	SPACE	1000		
23	SPACE				23	SPACE			
24	SPACE	1000			24	SPACE	1000		
25	SPACE				25	SPACE			
26	SPACE	1000			26	SPACE	1000		
27	SPACE				27	SPACE			
28	SPACE	1000			28	SPACE	1000		
29	SPACE				29	SPACE			
30	SPACE	1000			30	SPACE	1000		
31	SPACE				31	SPACE			
32	SPACE	1000			32	SPACE	1000		
33	SPACE				33	SPACE			
34	SPACE	1000			34	SPACE	1000		
35	SPACE				35	SPACE			
36	SPACE	1000			36	SPACE	1000		
37	SPACE				37	SPACE			
38	SPACE	1000			38	SPACE	1000		
39	SPACE				39	SPACE			
40	SPACE	1000			40	SPACE	1000		
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42	SPACE	1000			42	SPACE	1000		
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48	SPACE	1000			48	SPACE	1000		
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96	SPACE	1000			96	SPACE	1000		
97	SPACE				97	SPACE			
98	SPACE	1000			98	SPACE	1000		
99	SPACE				99	SPACE			
100	SPACE	1000			100	SPACE	1000		

* 20A-20F. CONTACTOR IN PANEL 70
CONTROL CIR. 21, 22, 23, 319, 3

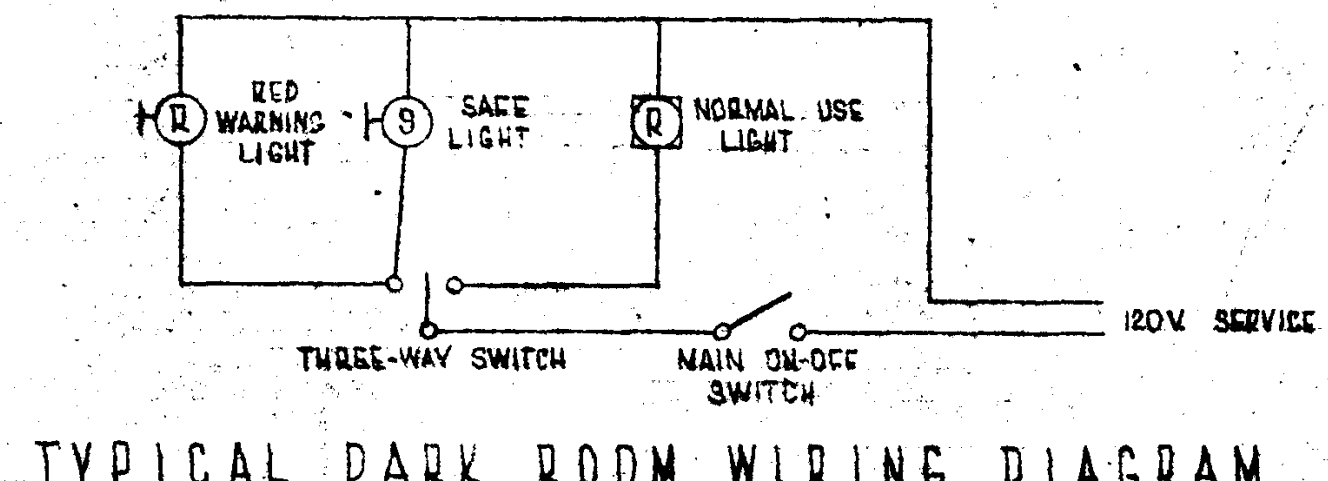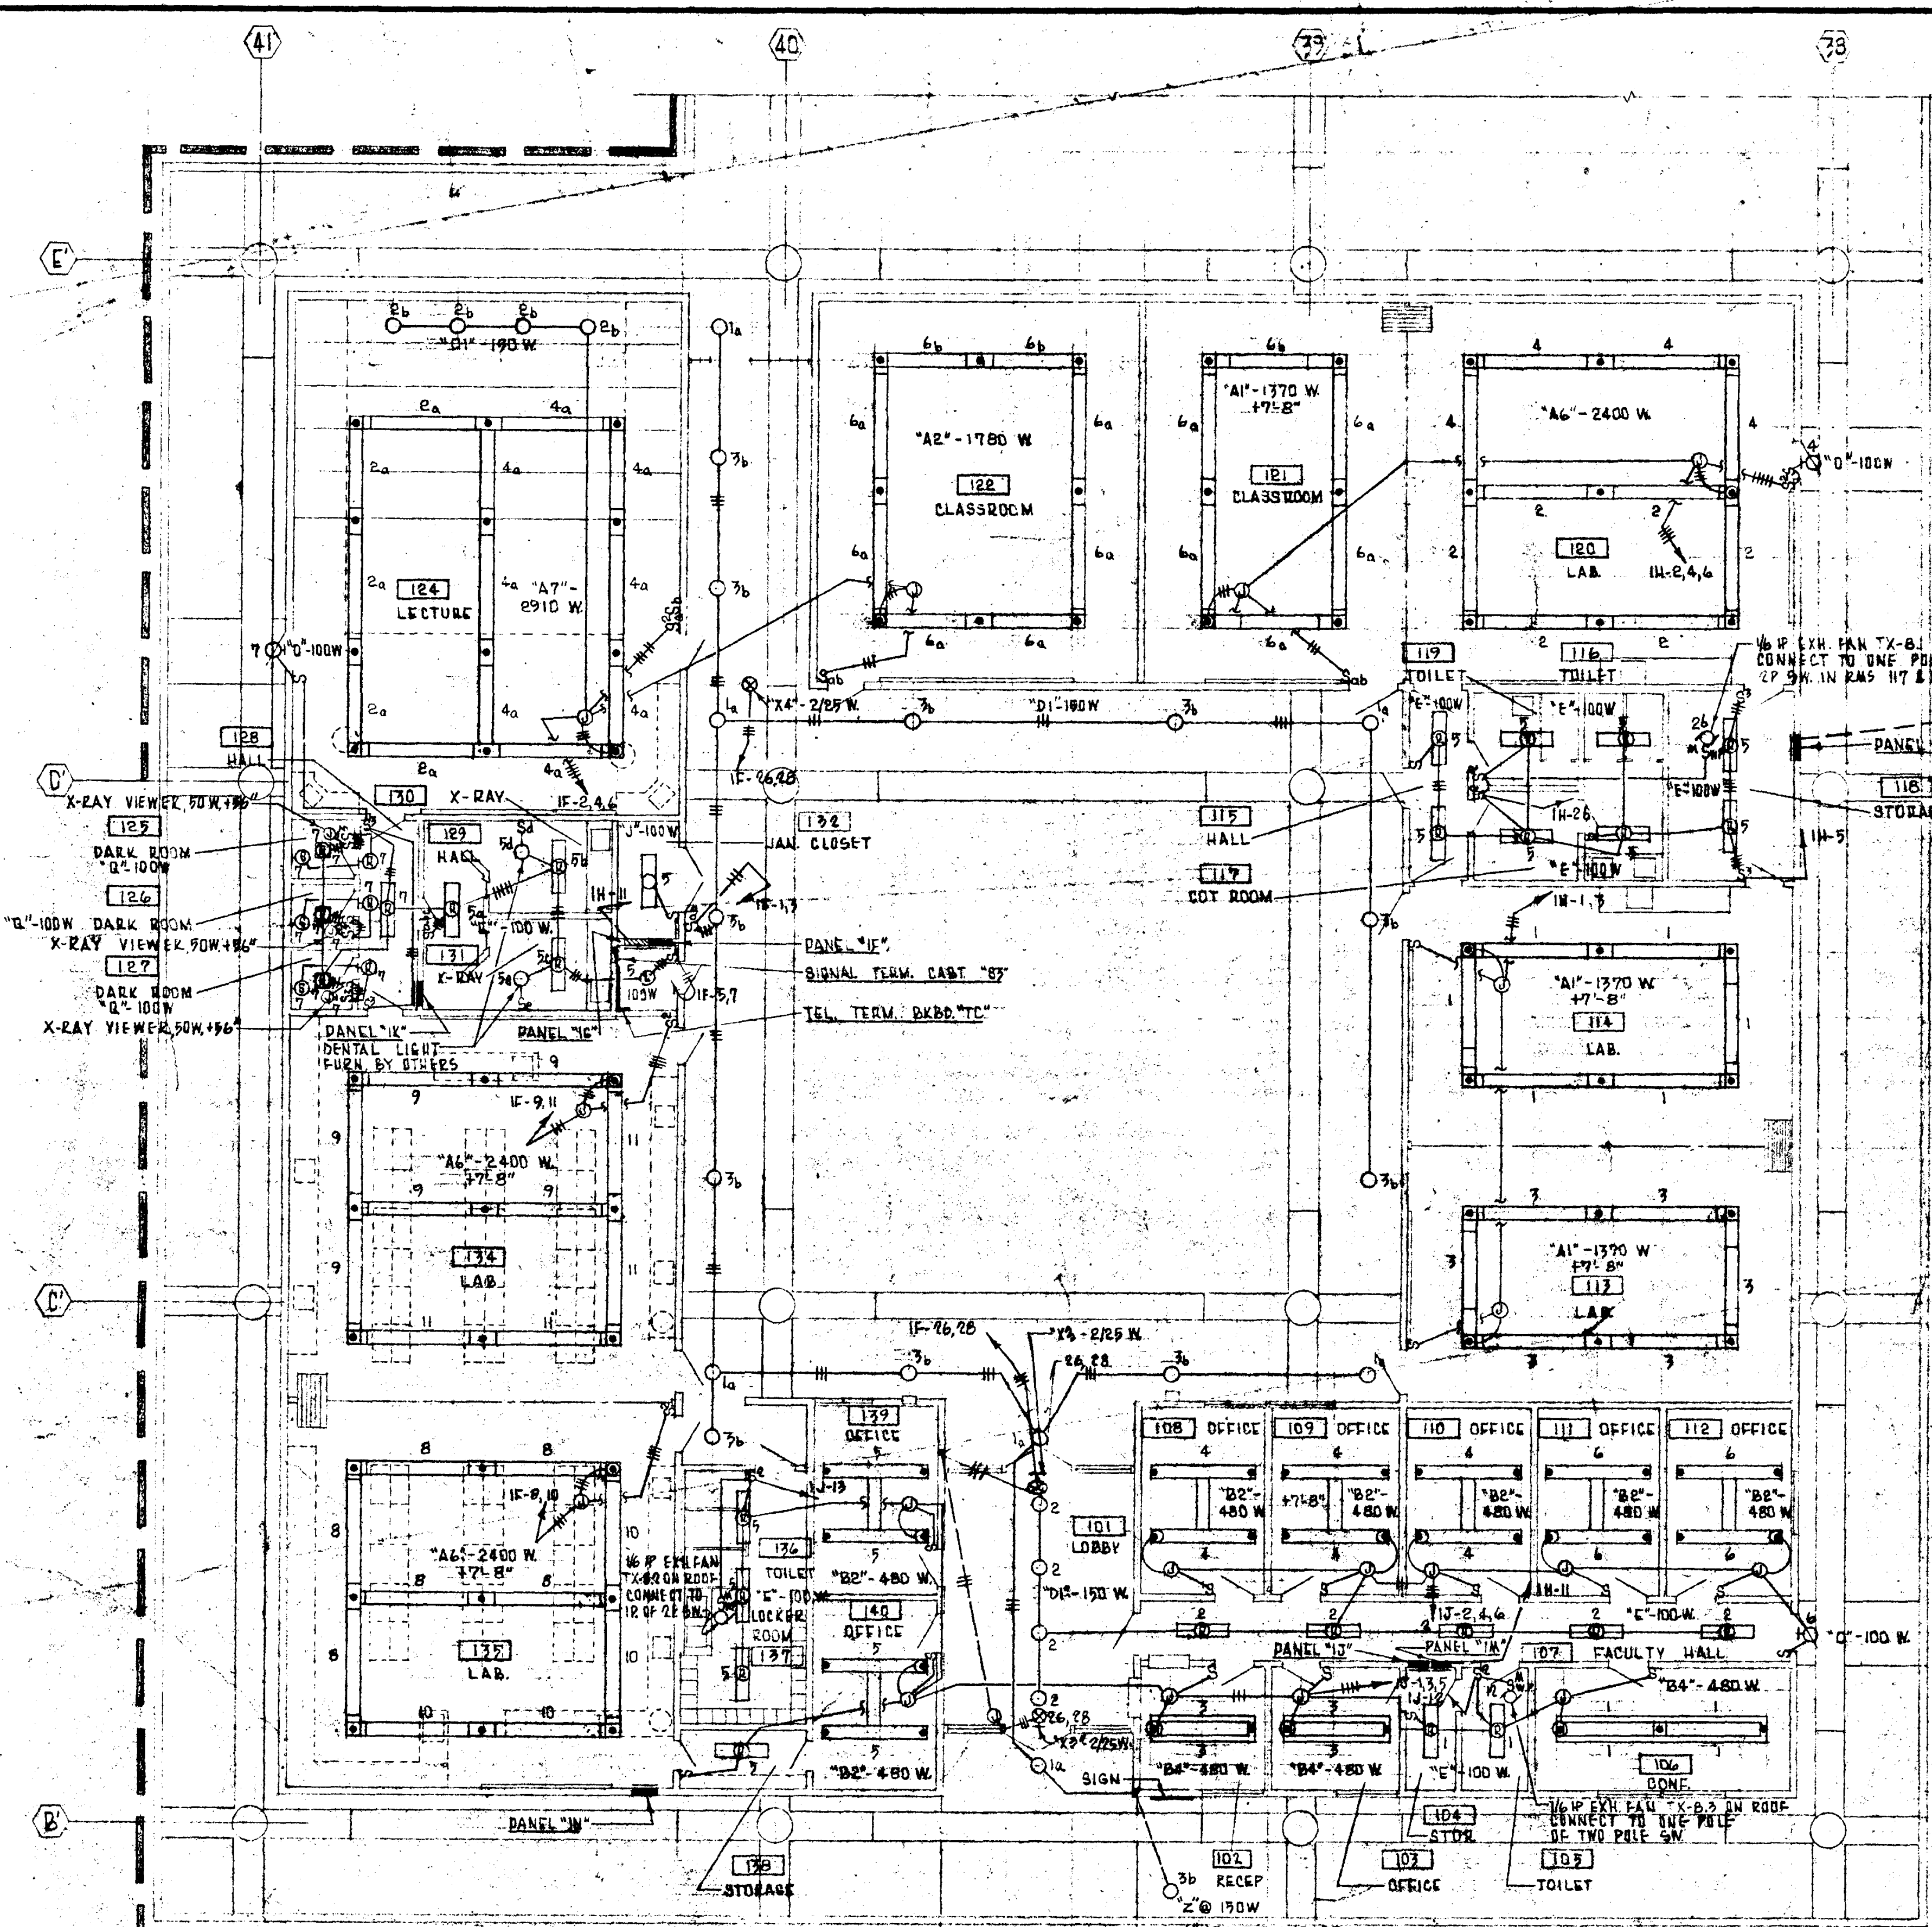

PANEL "I" SCHEDULE

CIR. NO.	OUTLETS		WATTS		AMPS
	O	OTHERS	A	B	
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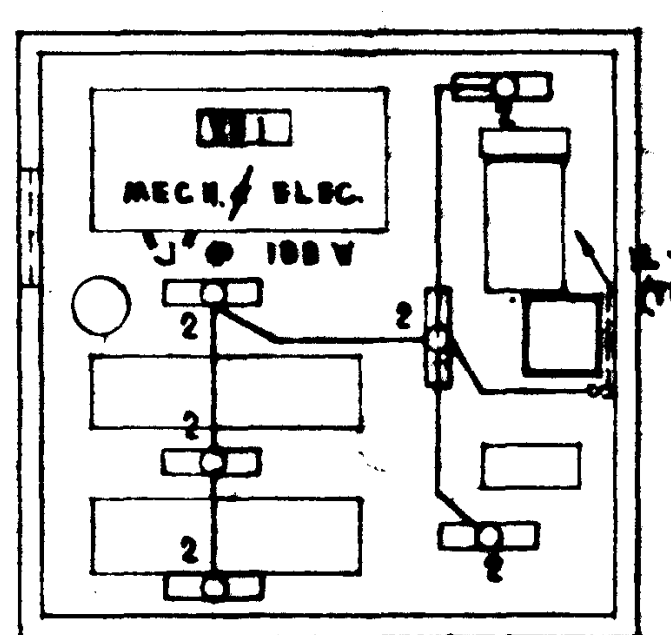
PANEL 'L' SCHEDULE

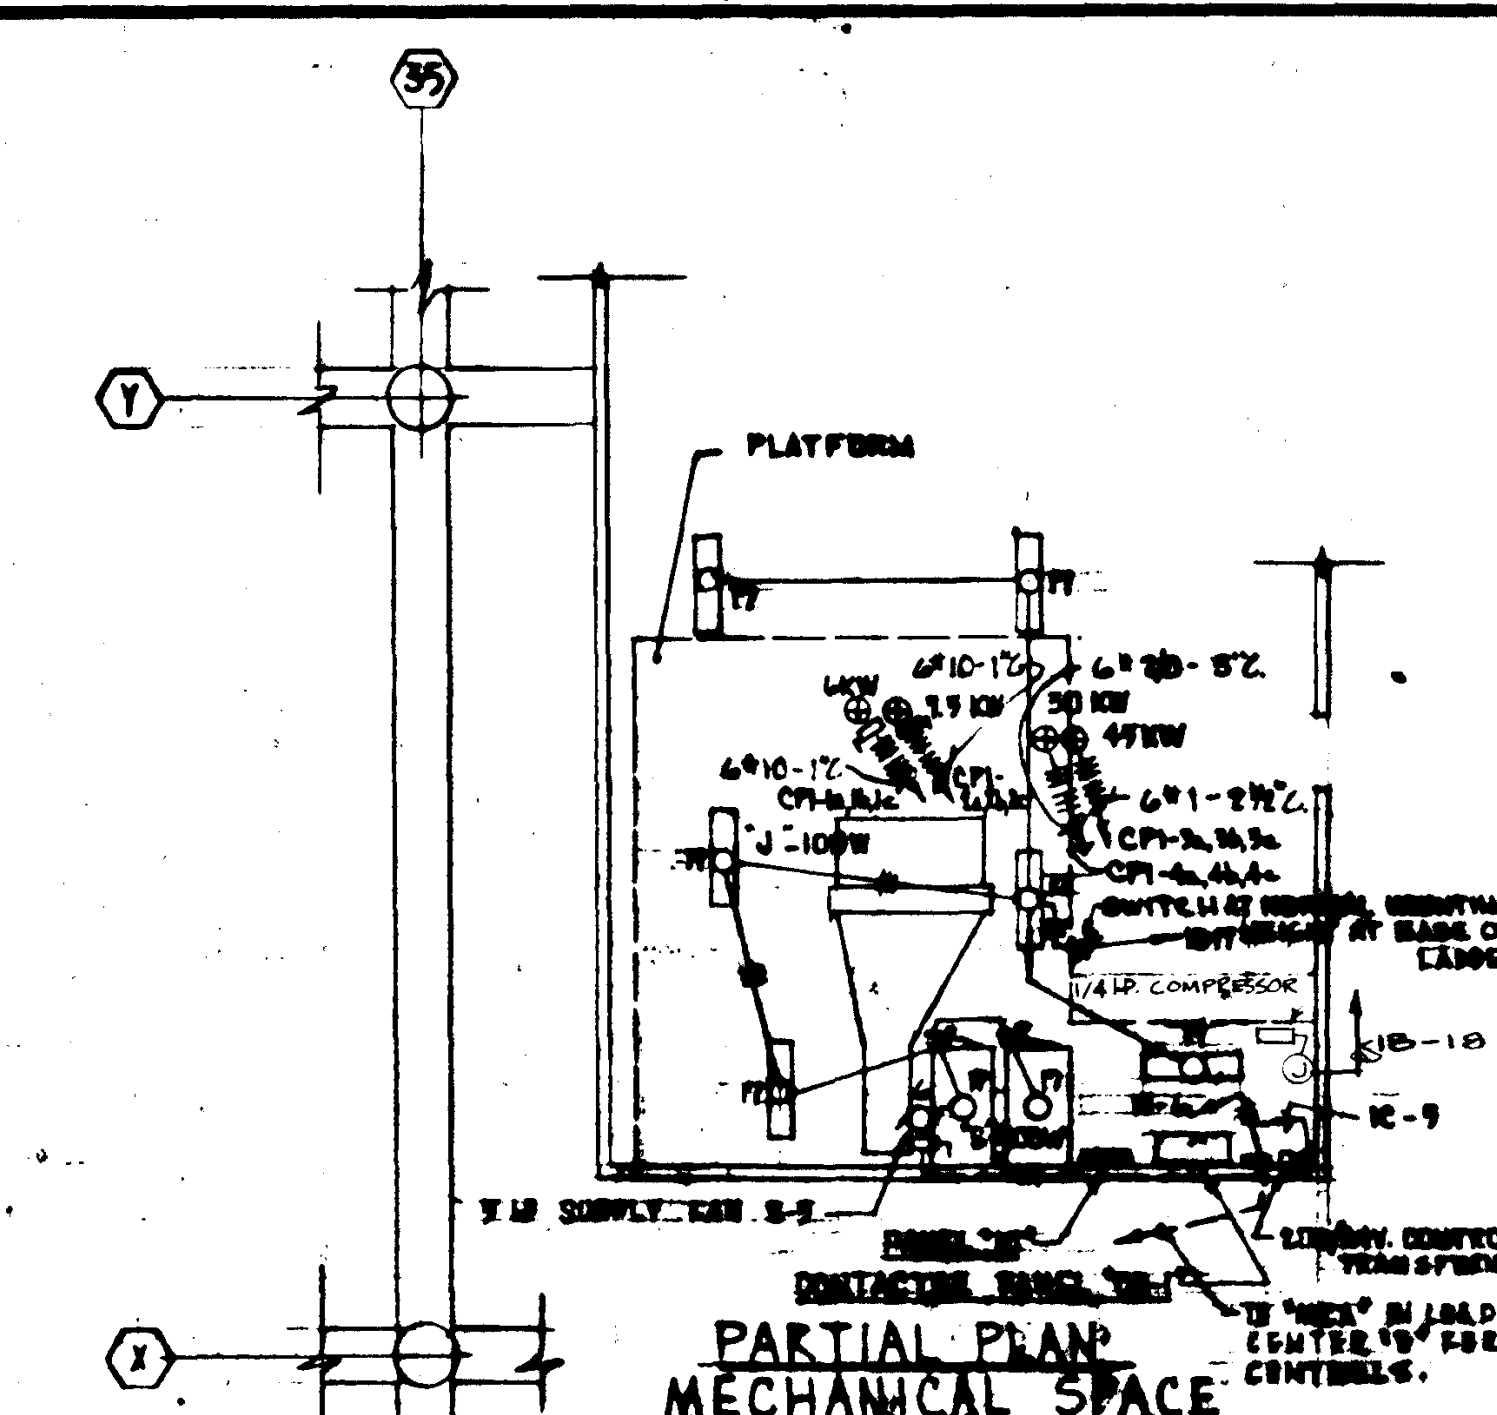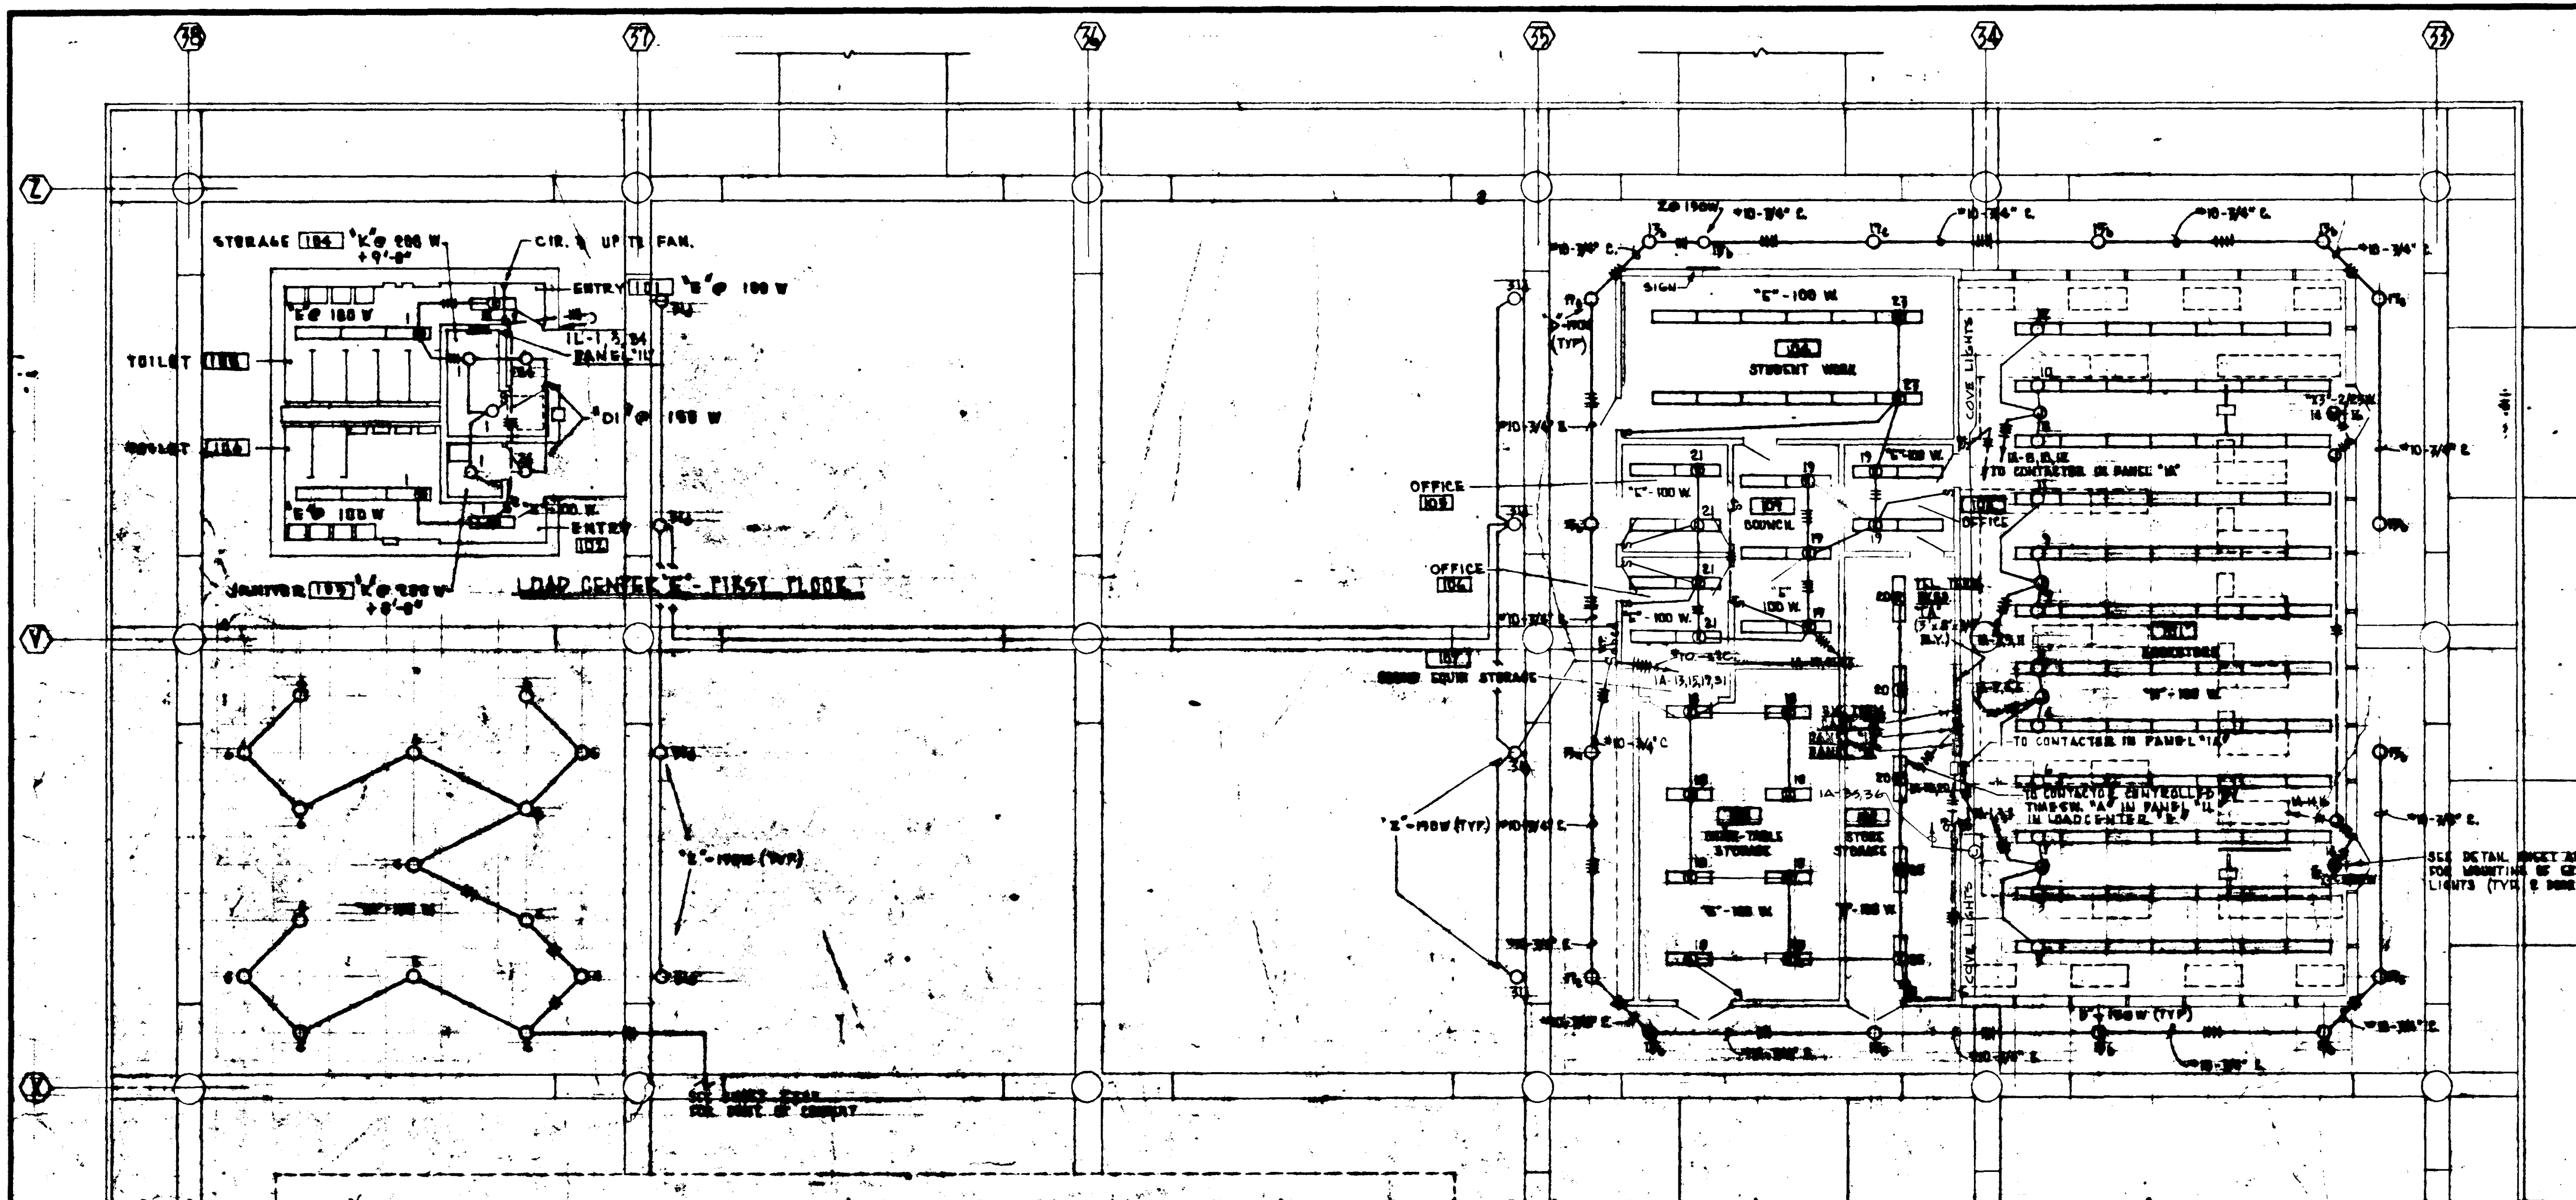NO.	OUTLETS	WATTS	REMARKS
1	100 W		
2	100 W		
3	100 W		
4	100 W		
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6	100 W		
7	100 W		
8	100 W		
9	100 W		
10	100 W		
11	100 W		
12	100 W		
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94	100 W		
95	100 W		
96	100 W		
97	100 W		
98	100 W		
99	100 W		
100	100 W		

PANEL 'M' SCHEDULE

NO.	OUTLETS	WATTS	REMARKS
1	100 W		
2	100 W		
3	100 W		
4	100 W		
5	100 W		
6	100 W		
7	100 W		
8	100 W		
9	100 W		
10	100 W		
11	100 W		
12	100 W		
13	100 W		
14	100 W		
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93	100 W		
94	100 W		
95	100 W		
96	100 W		
97	100 W		
98	100 W		
99	100 W		
100	100 W		

NOTES:
 1. ALL TYPES OF FIXTURES SHOWN ON THIS PLAN ARE TO BE INSTALLED IN ACCORDANCE WITH THE LATEST EDITION OF THE NATIONAL ELECTRICAL CODE.
 2. ALL TYPES OF FIXTURES SHOWN ON THIS PLAN ARE TO BE INSTALLED IN ACCORDANCE WITH THE LATEST EDITION OF THE NATIONAL ELECTRICAL CODE.










PANEL 'A' SCHEDULE


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3	100 W		
4	100 W		
5	100 W		
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PANEL 'B' SCHEDULE


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3	100 W		
4	100 W		
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8	100 W		
9	100 W		
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100	100 W		



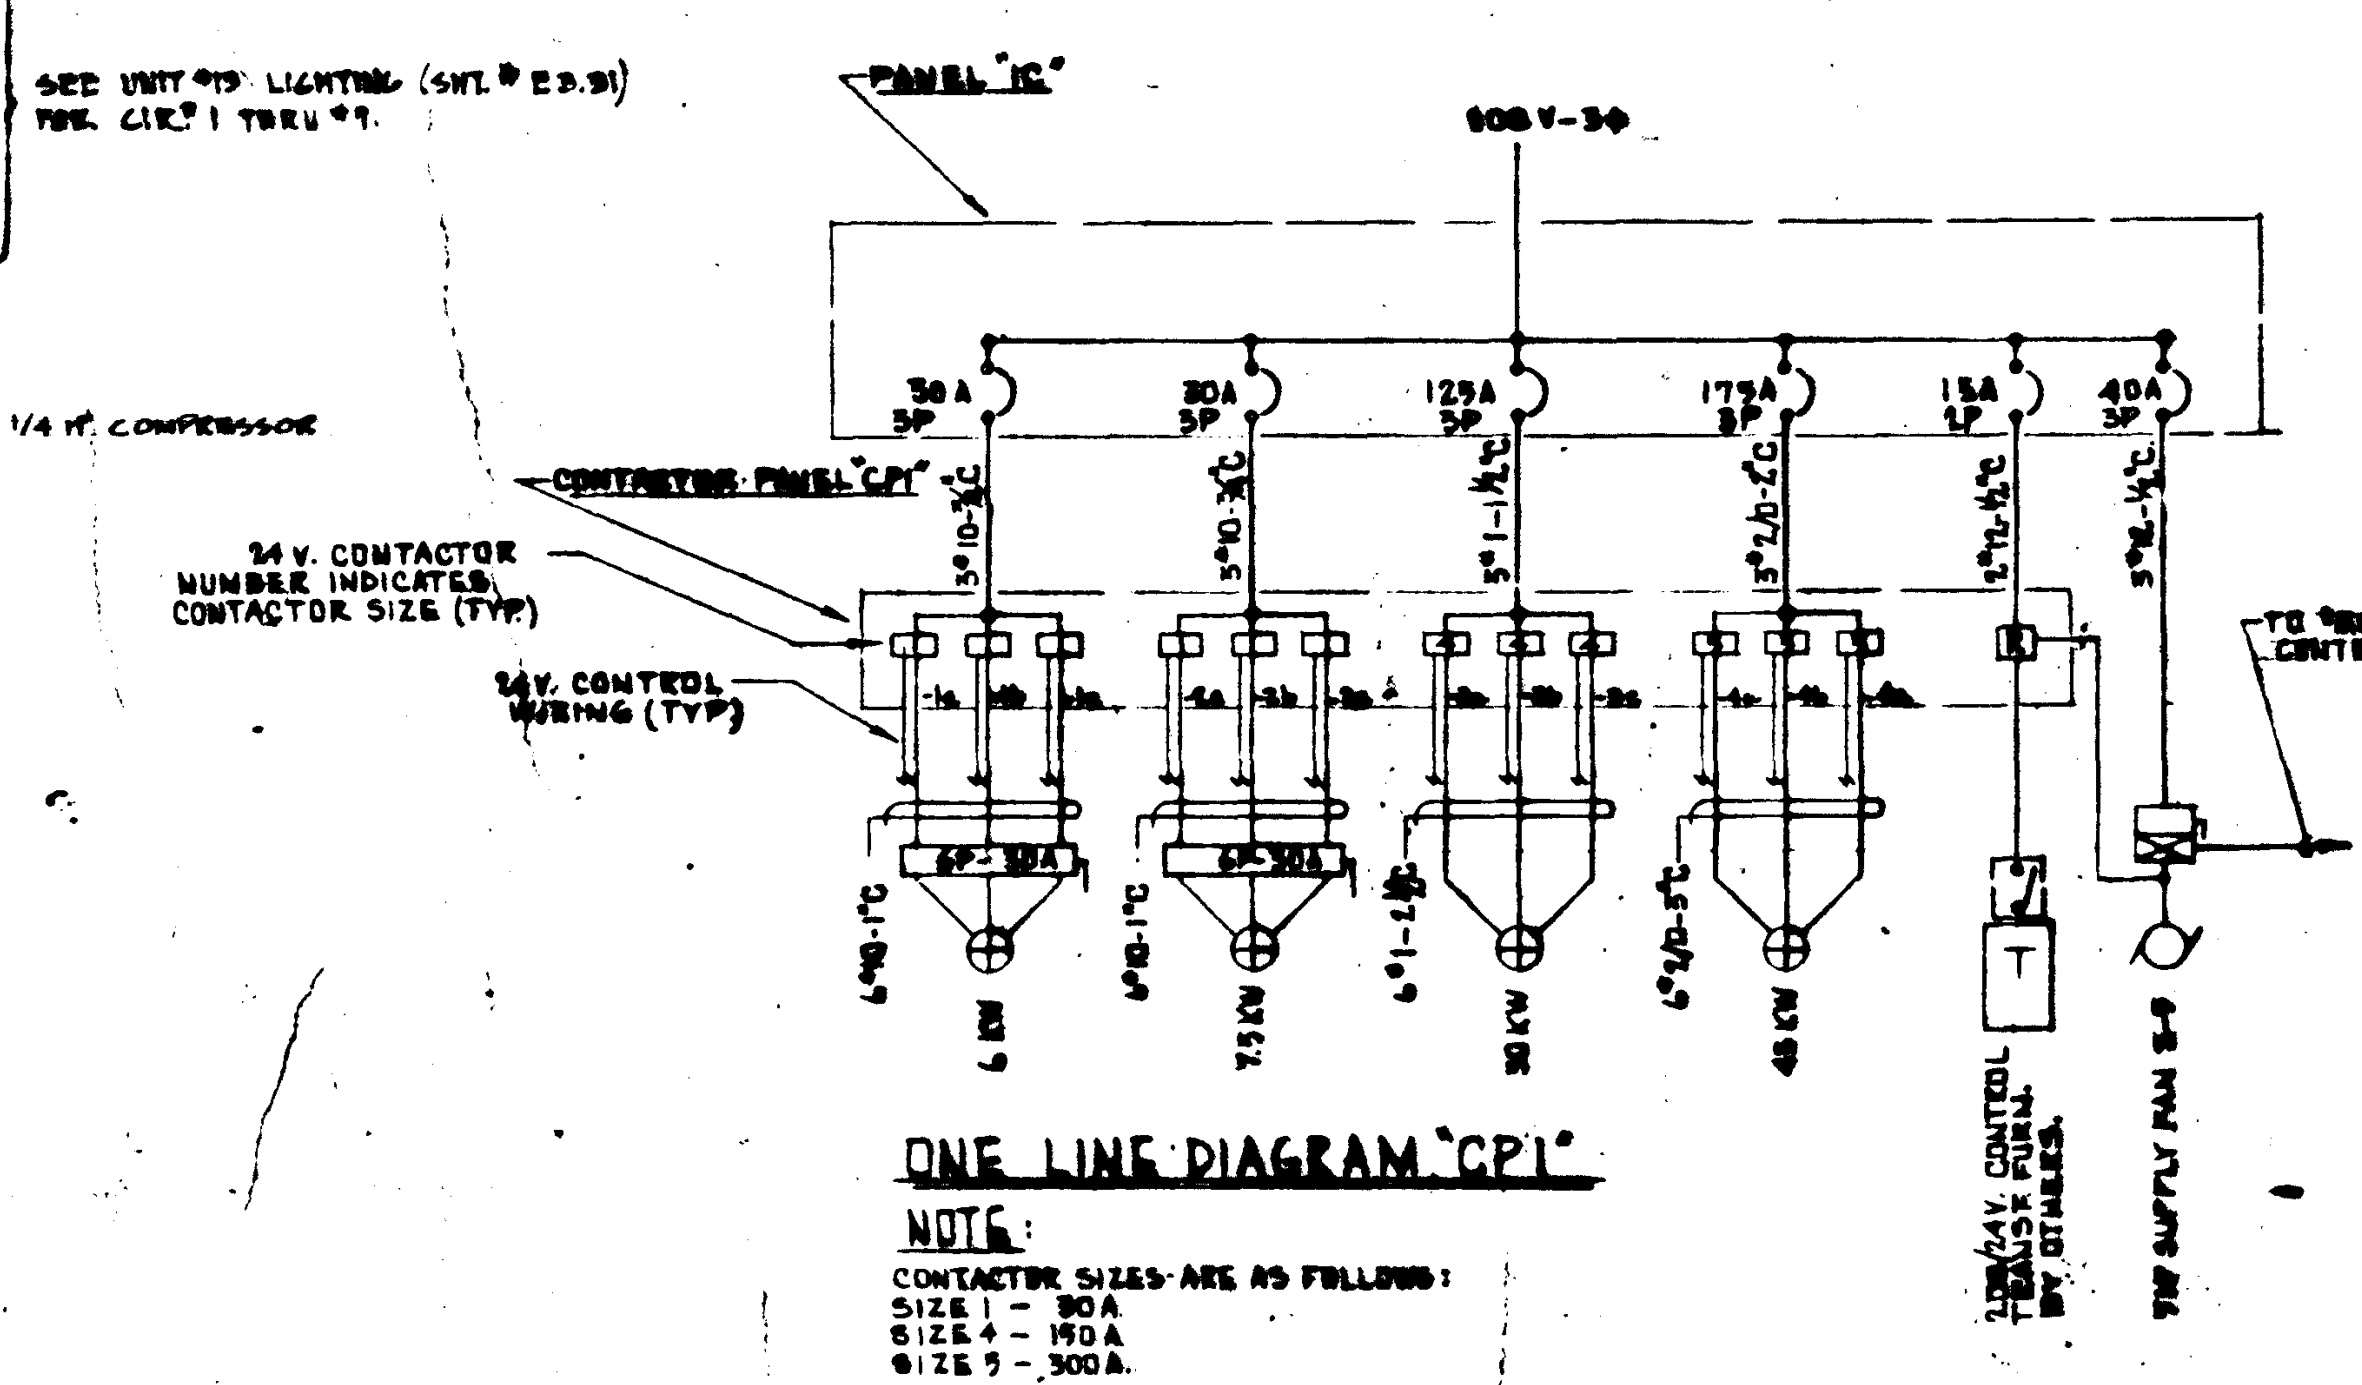

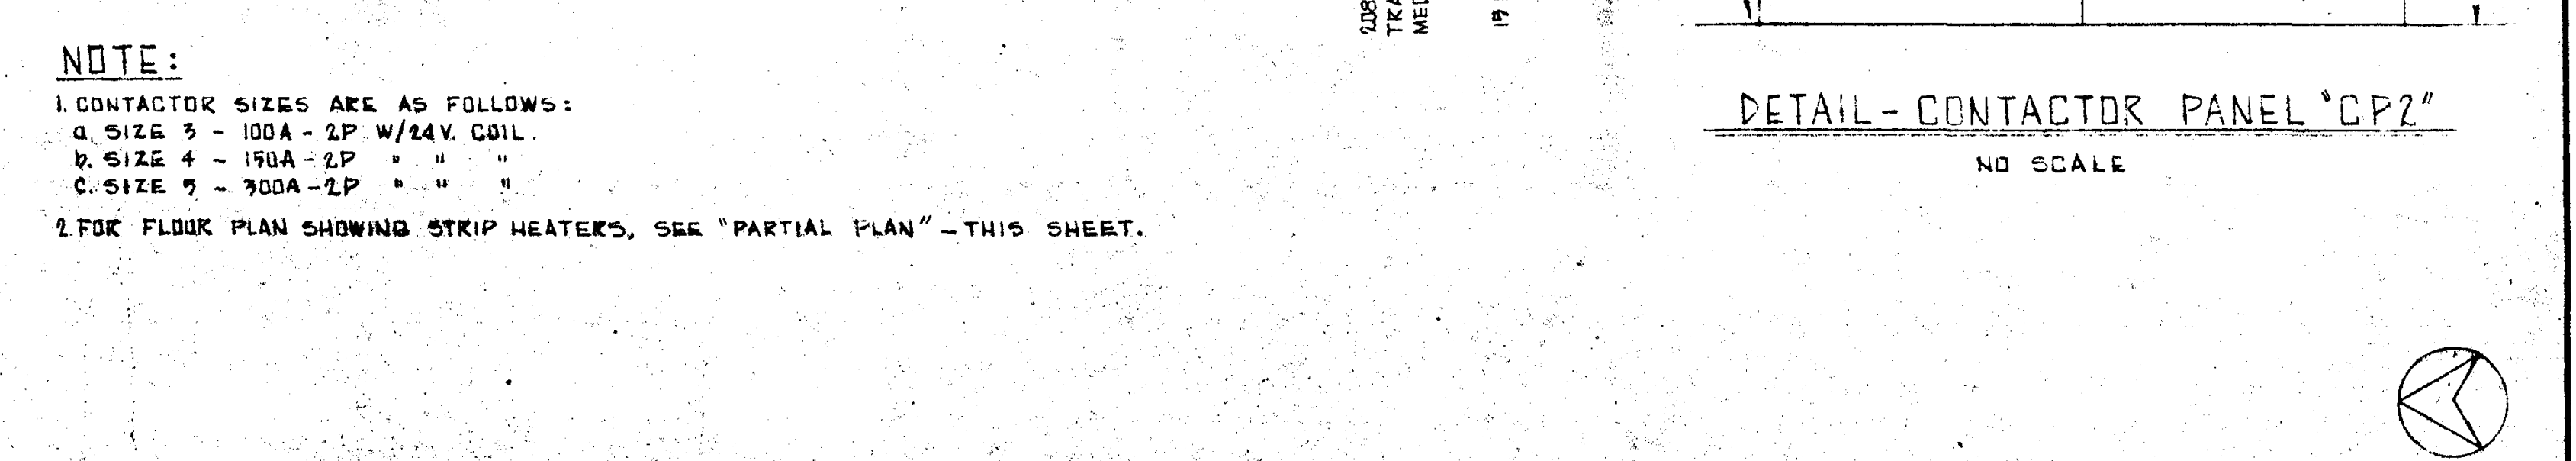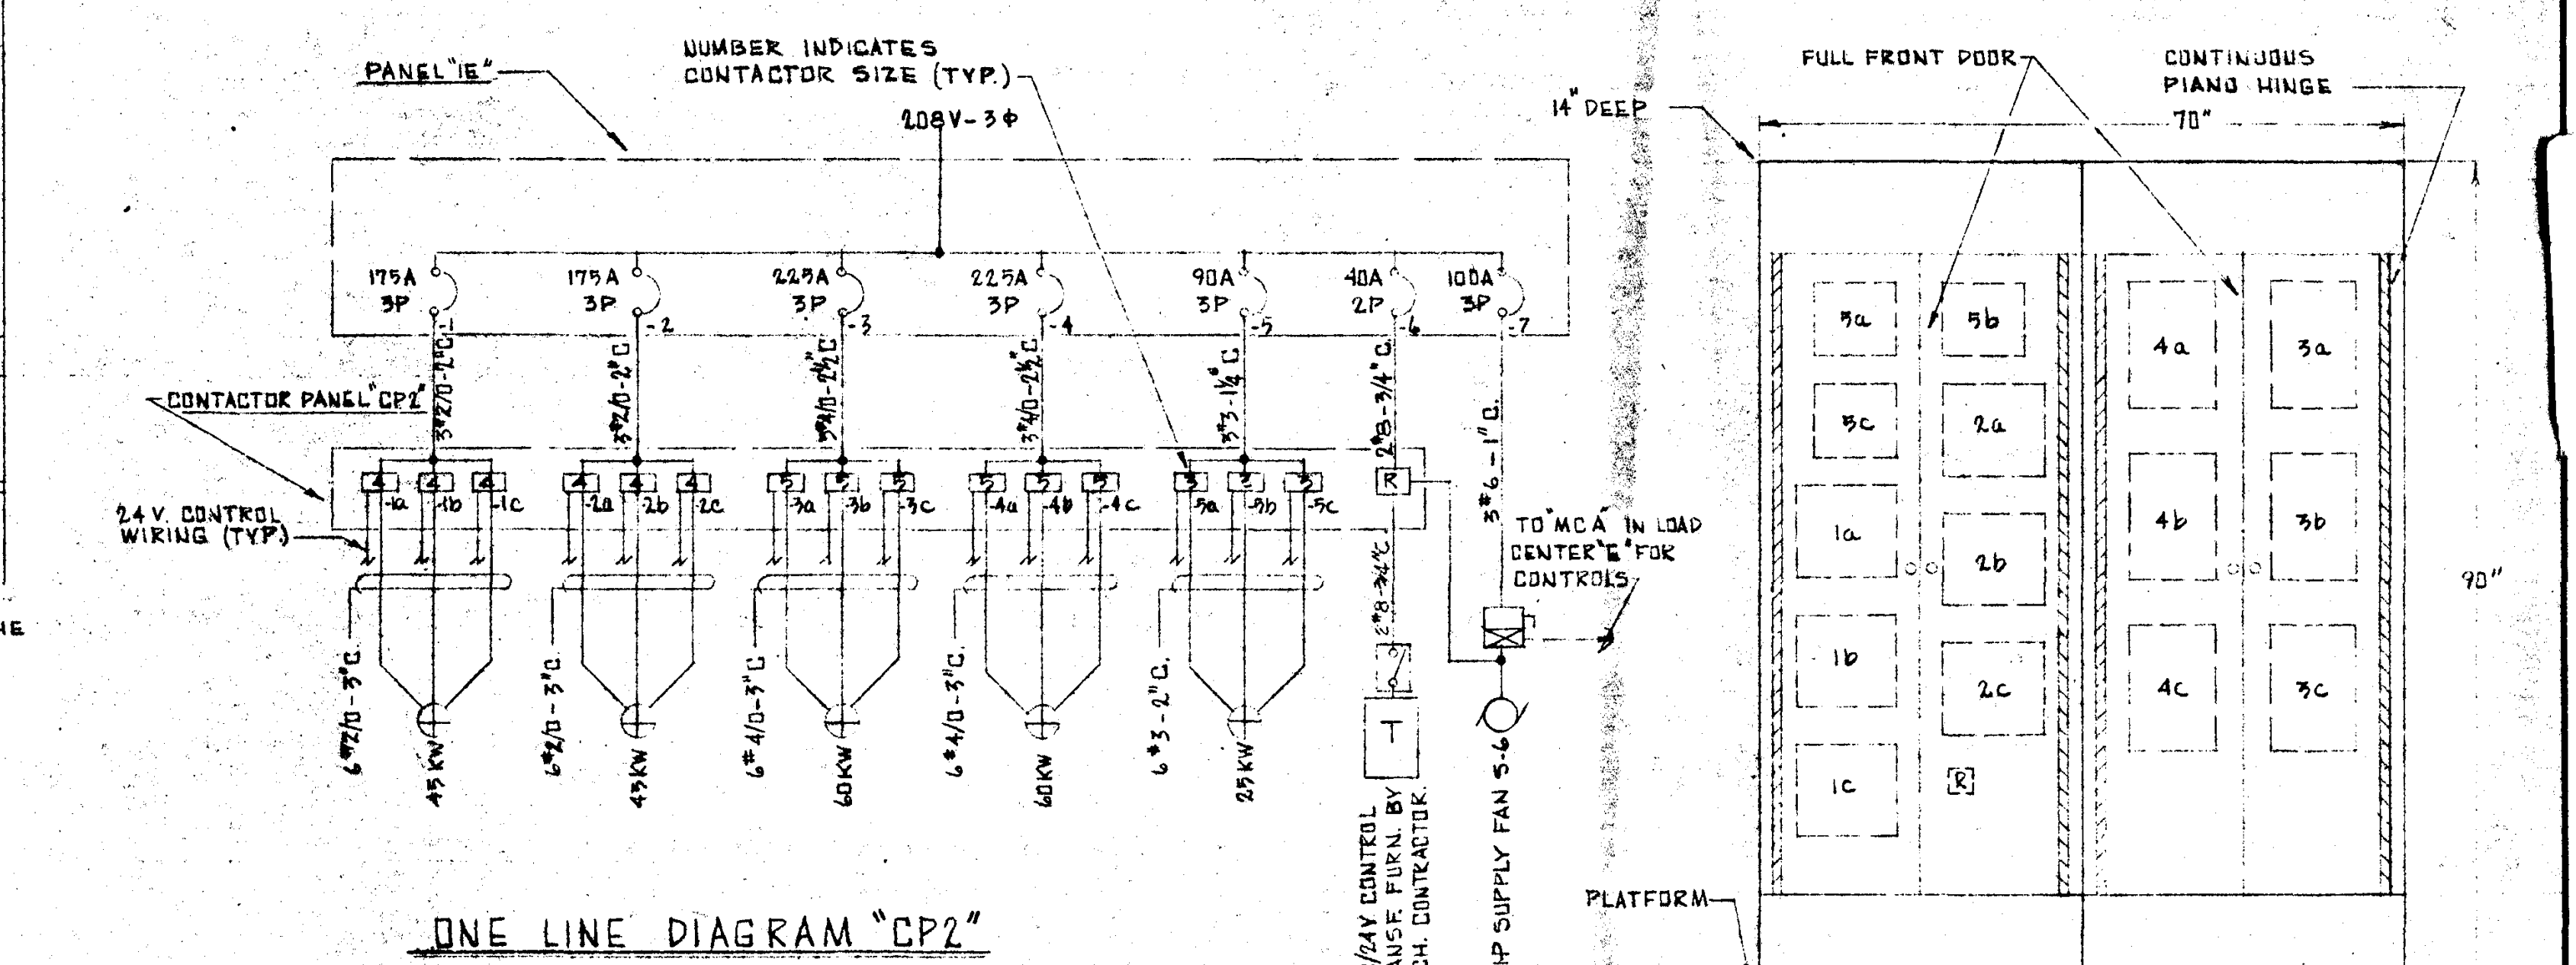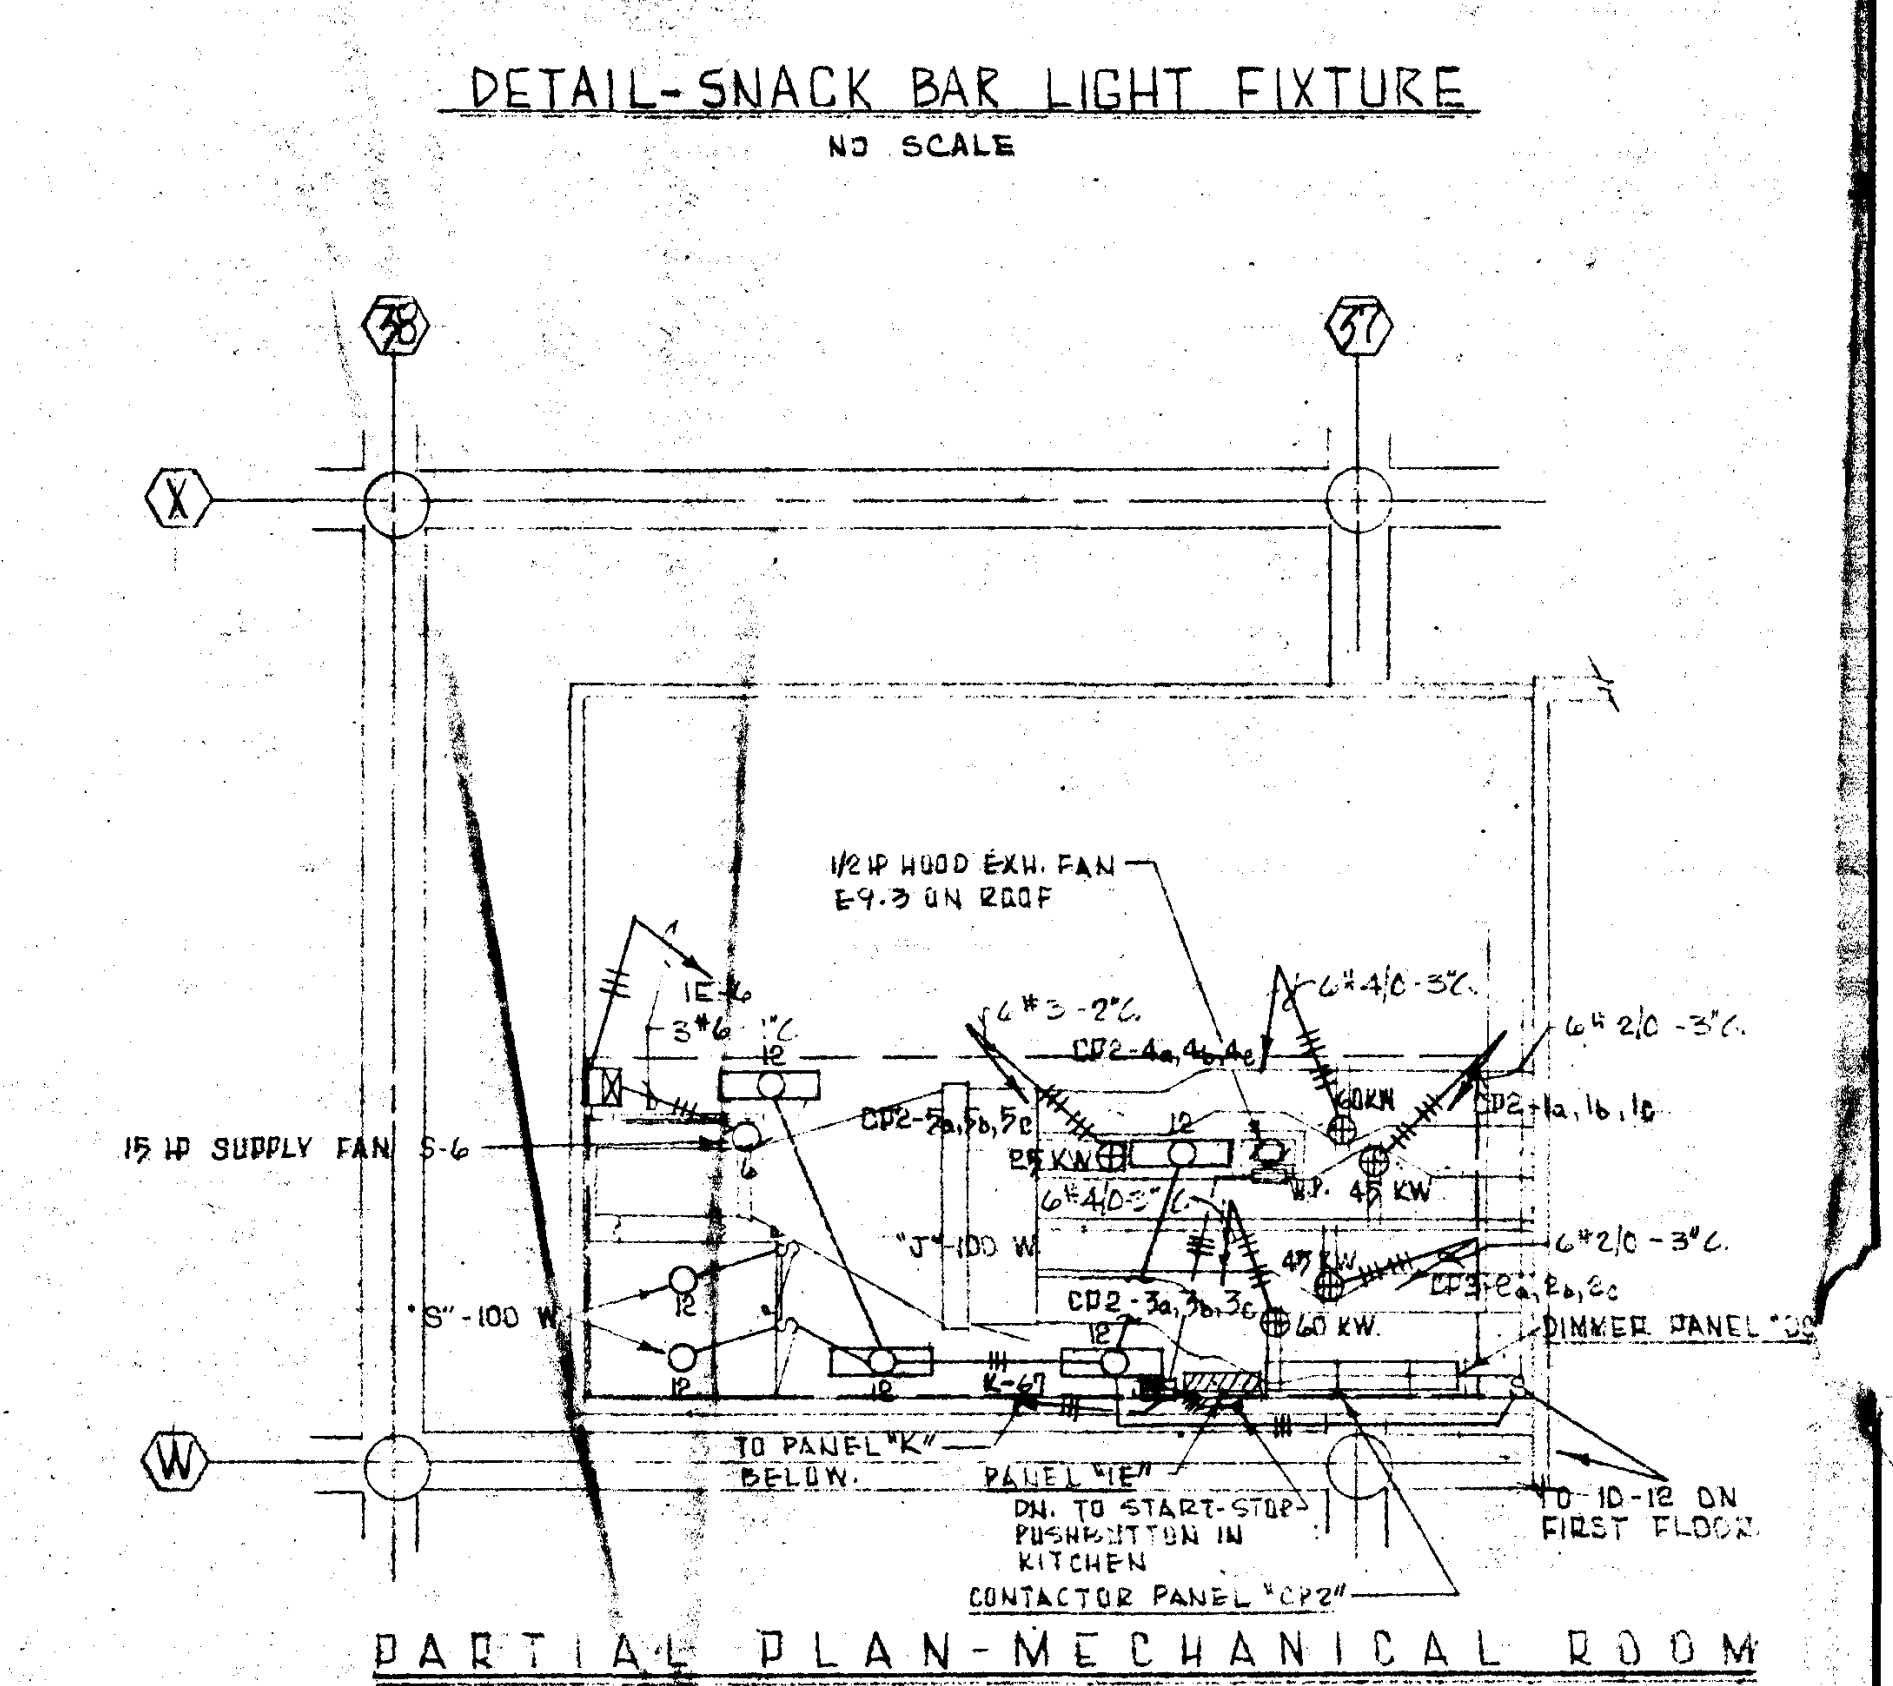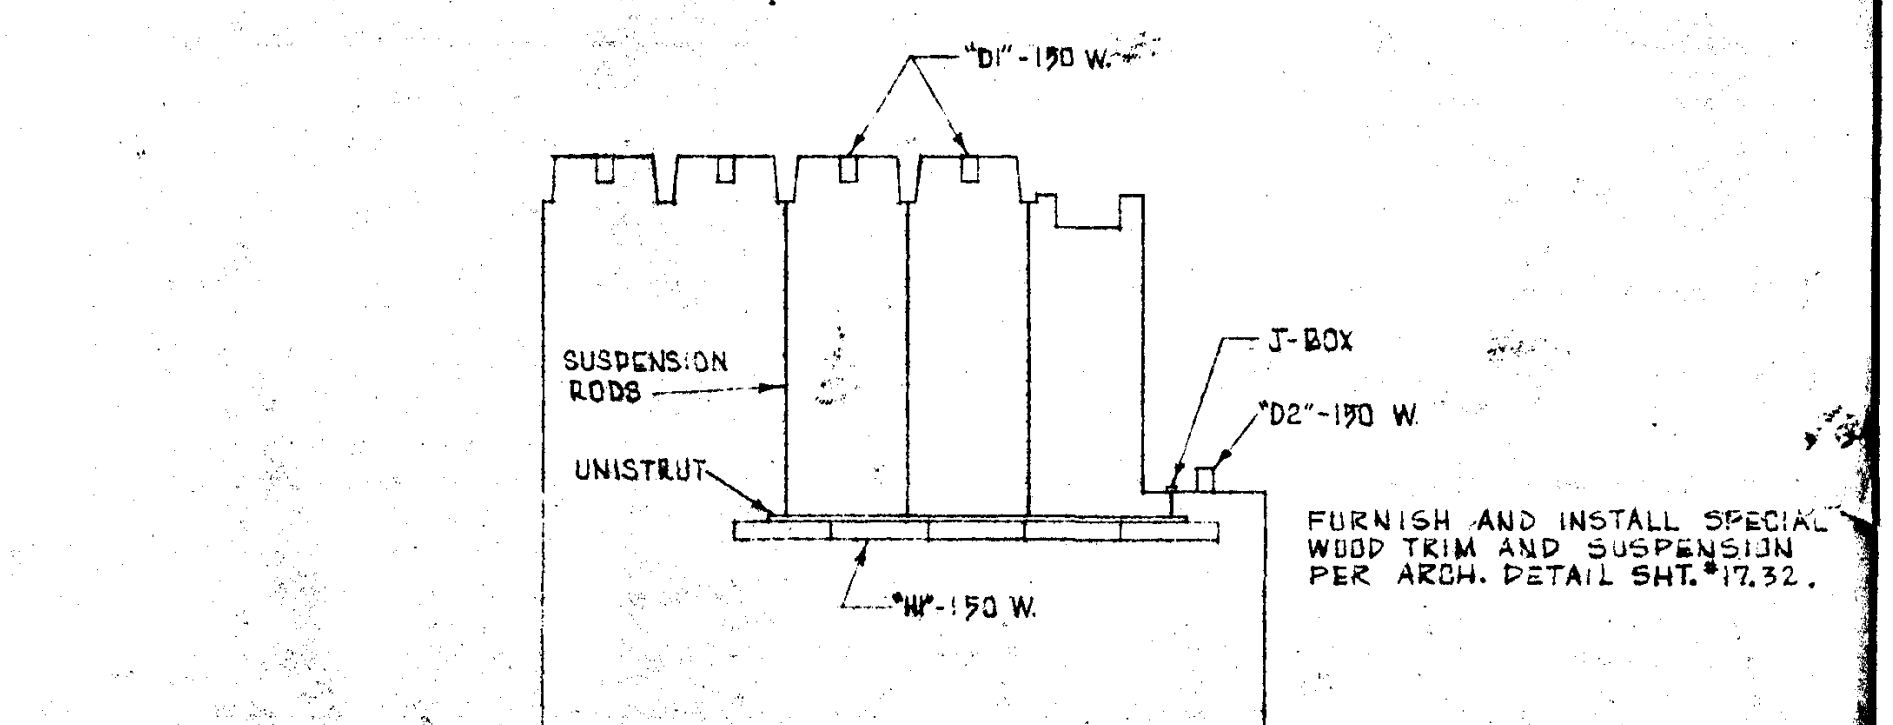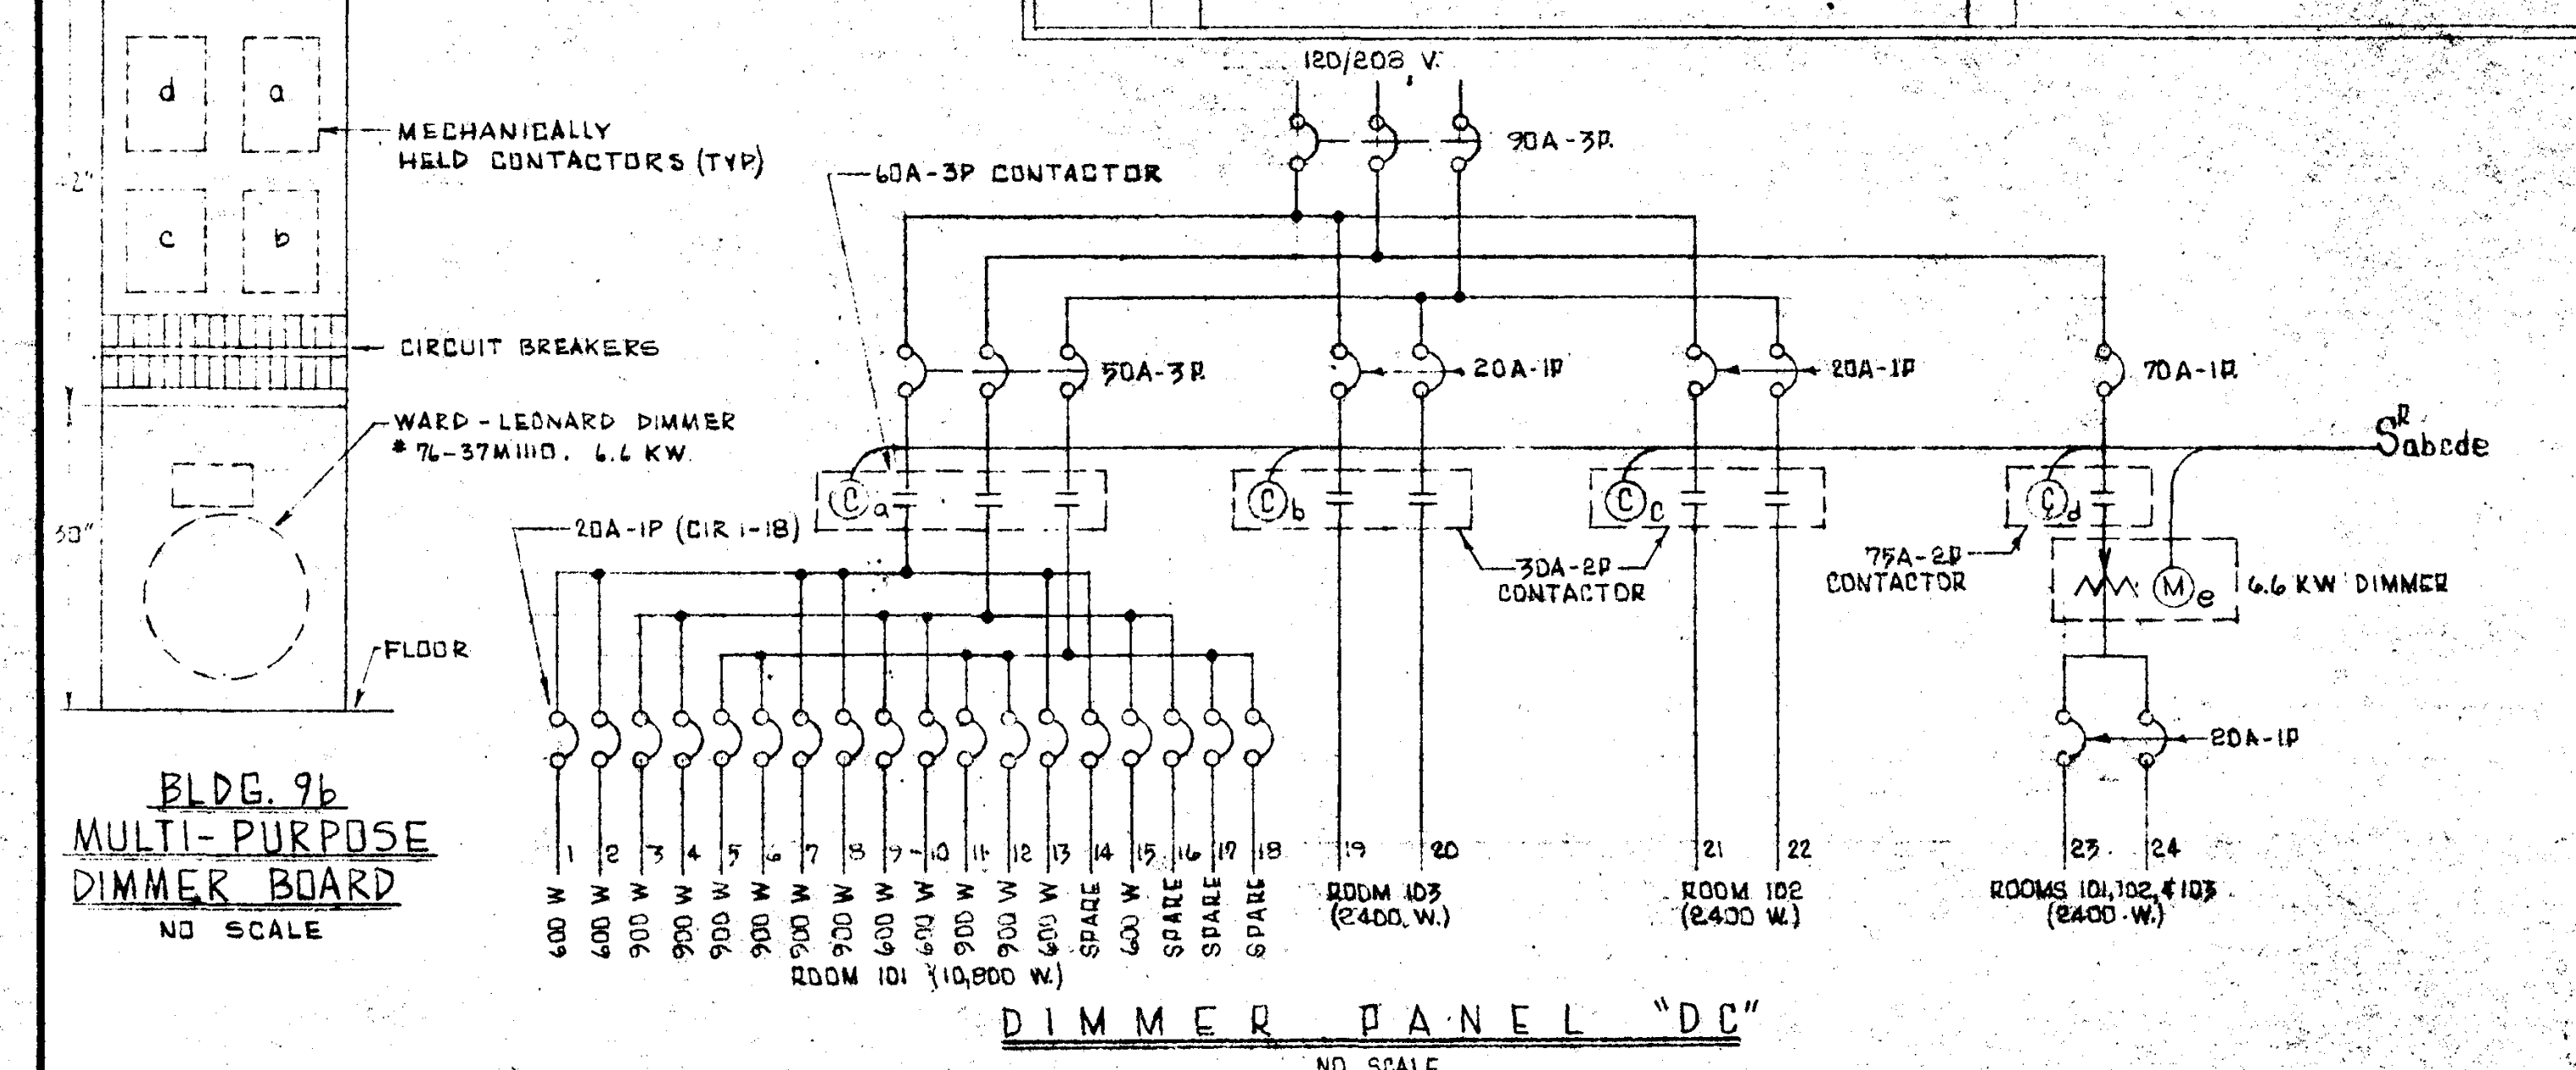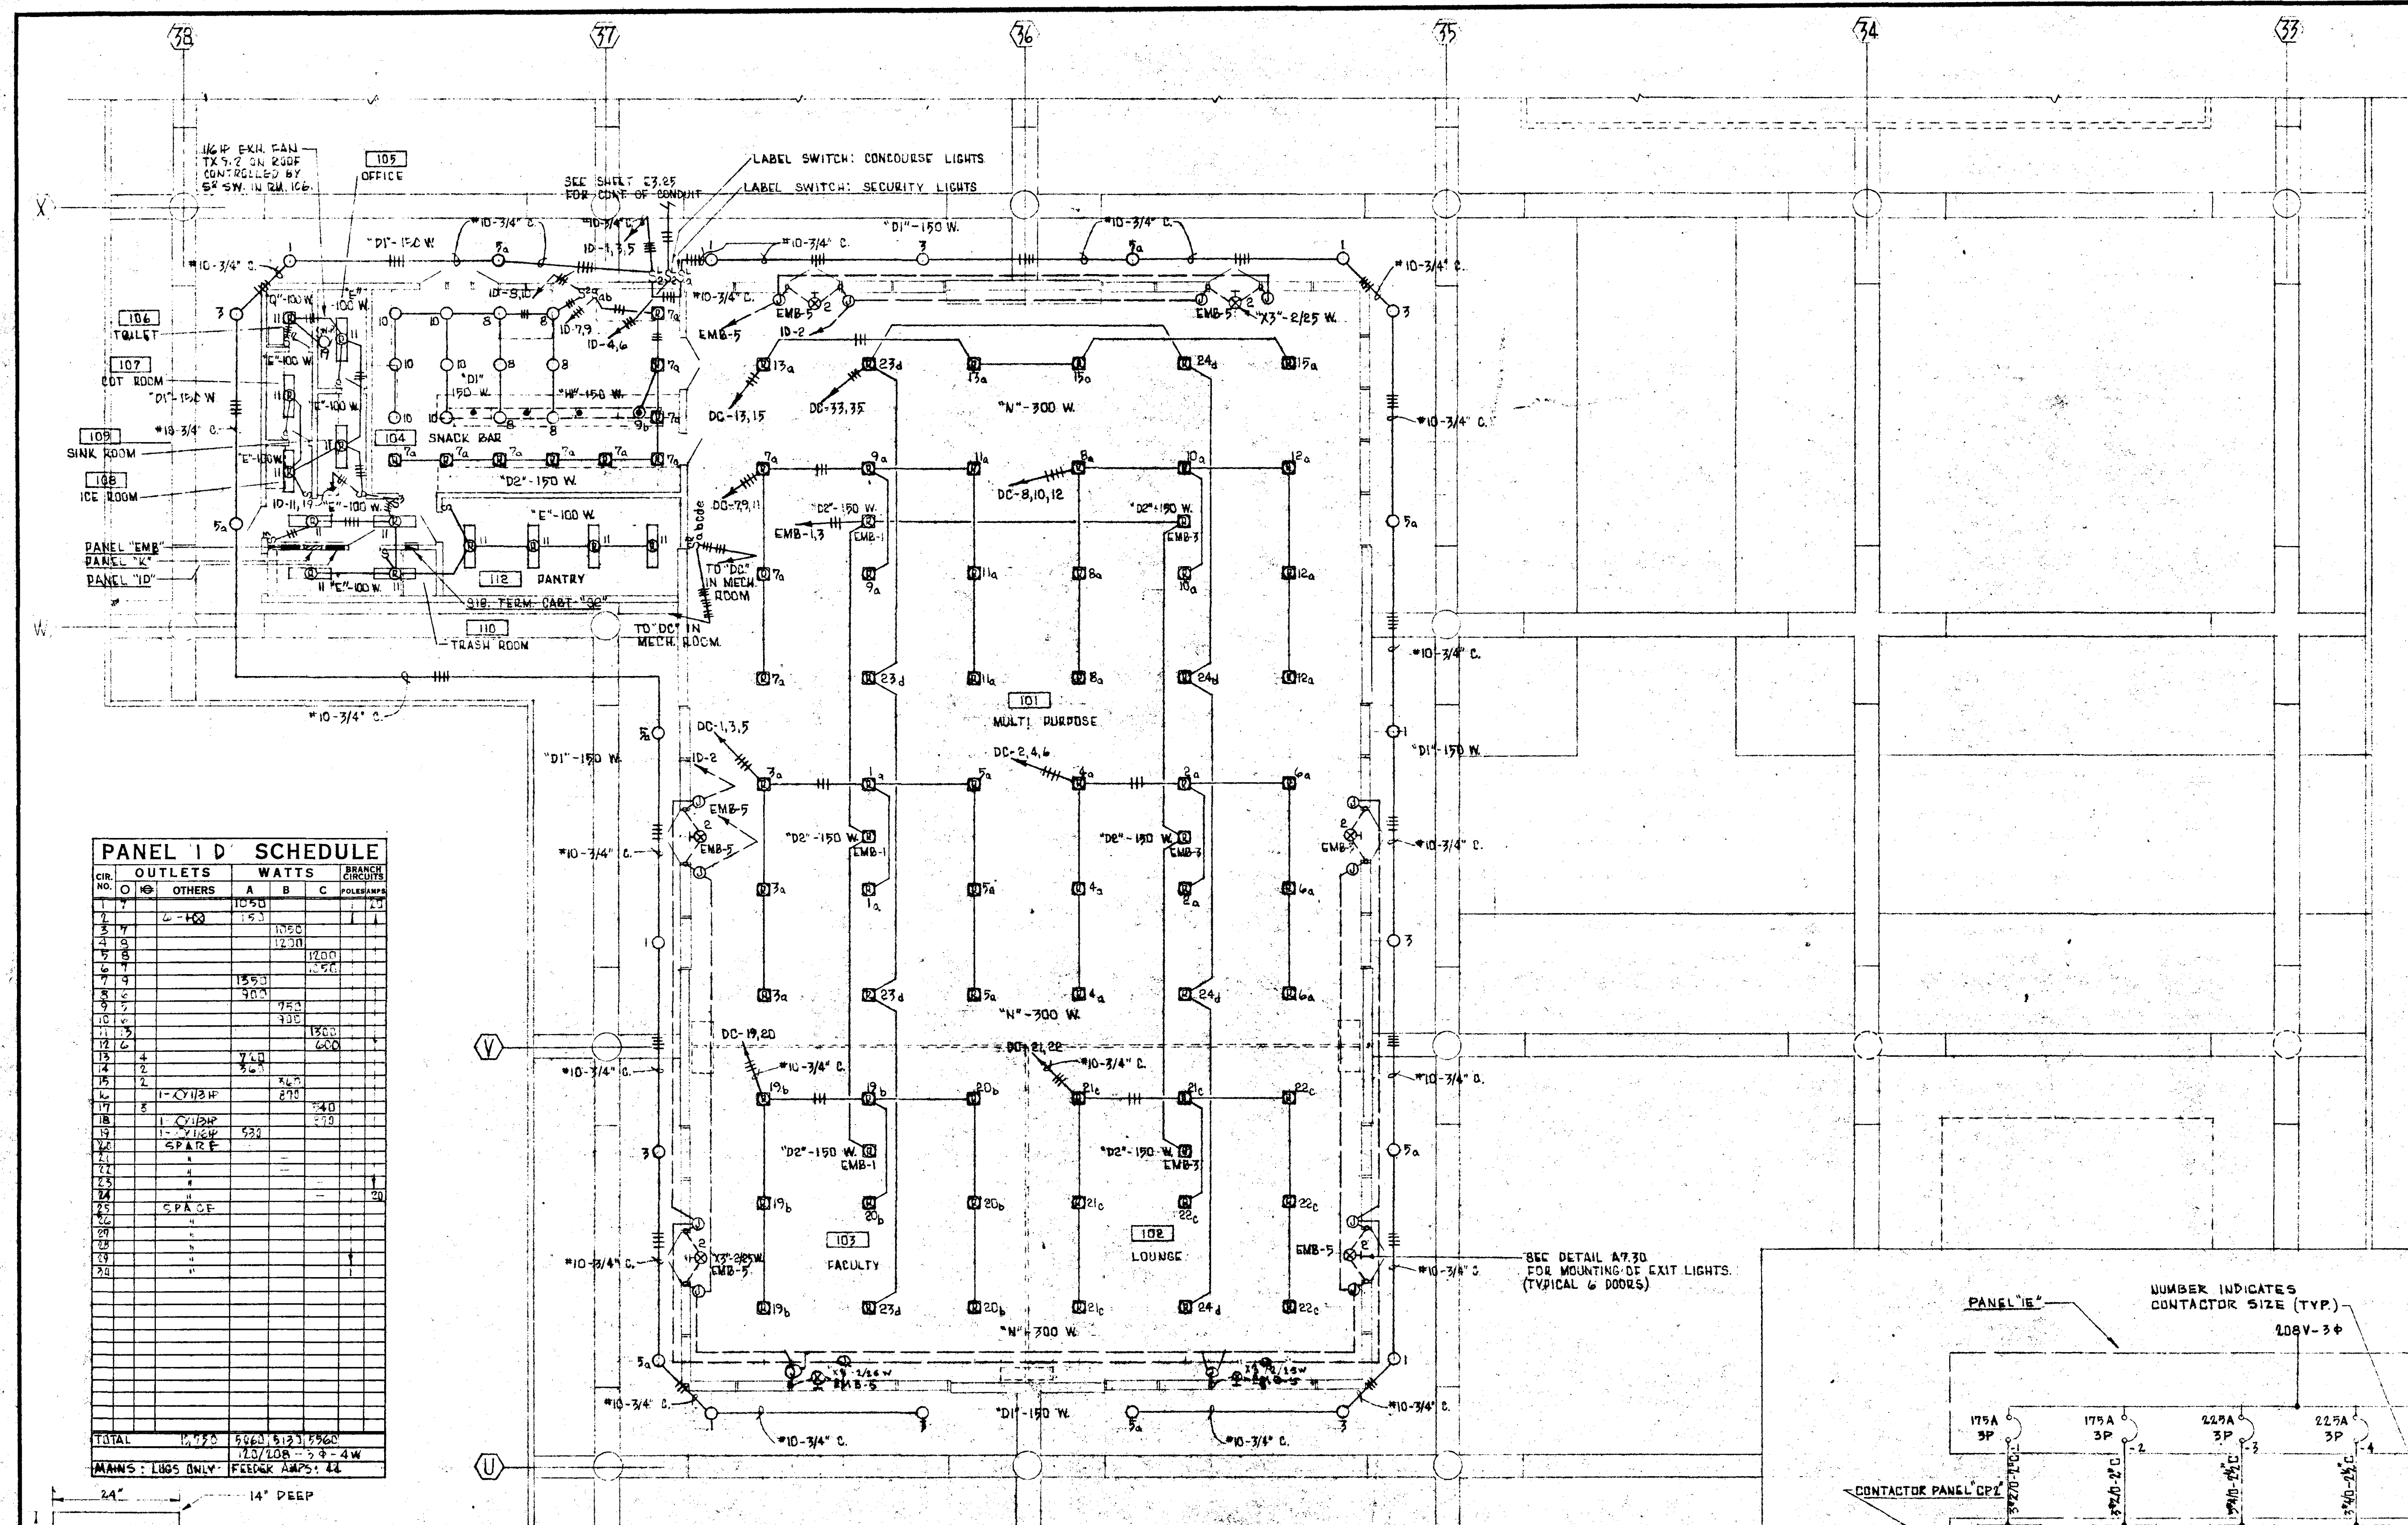

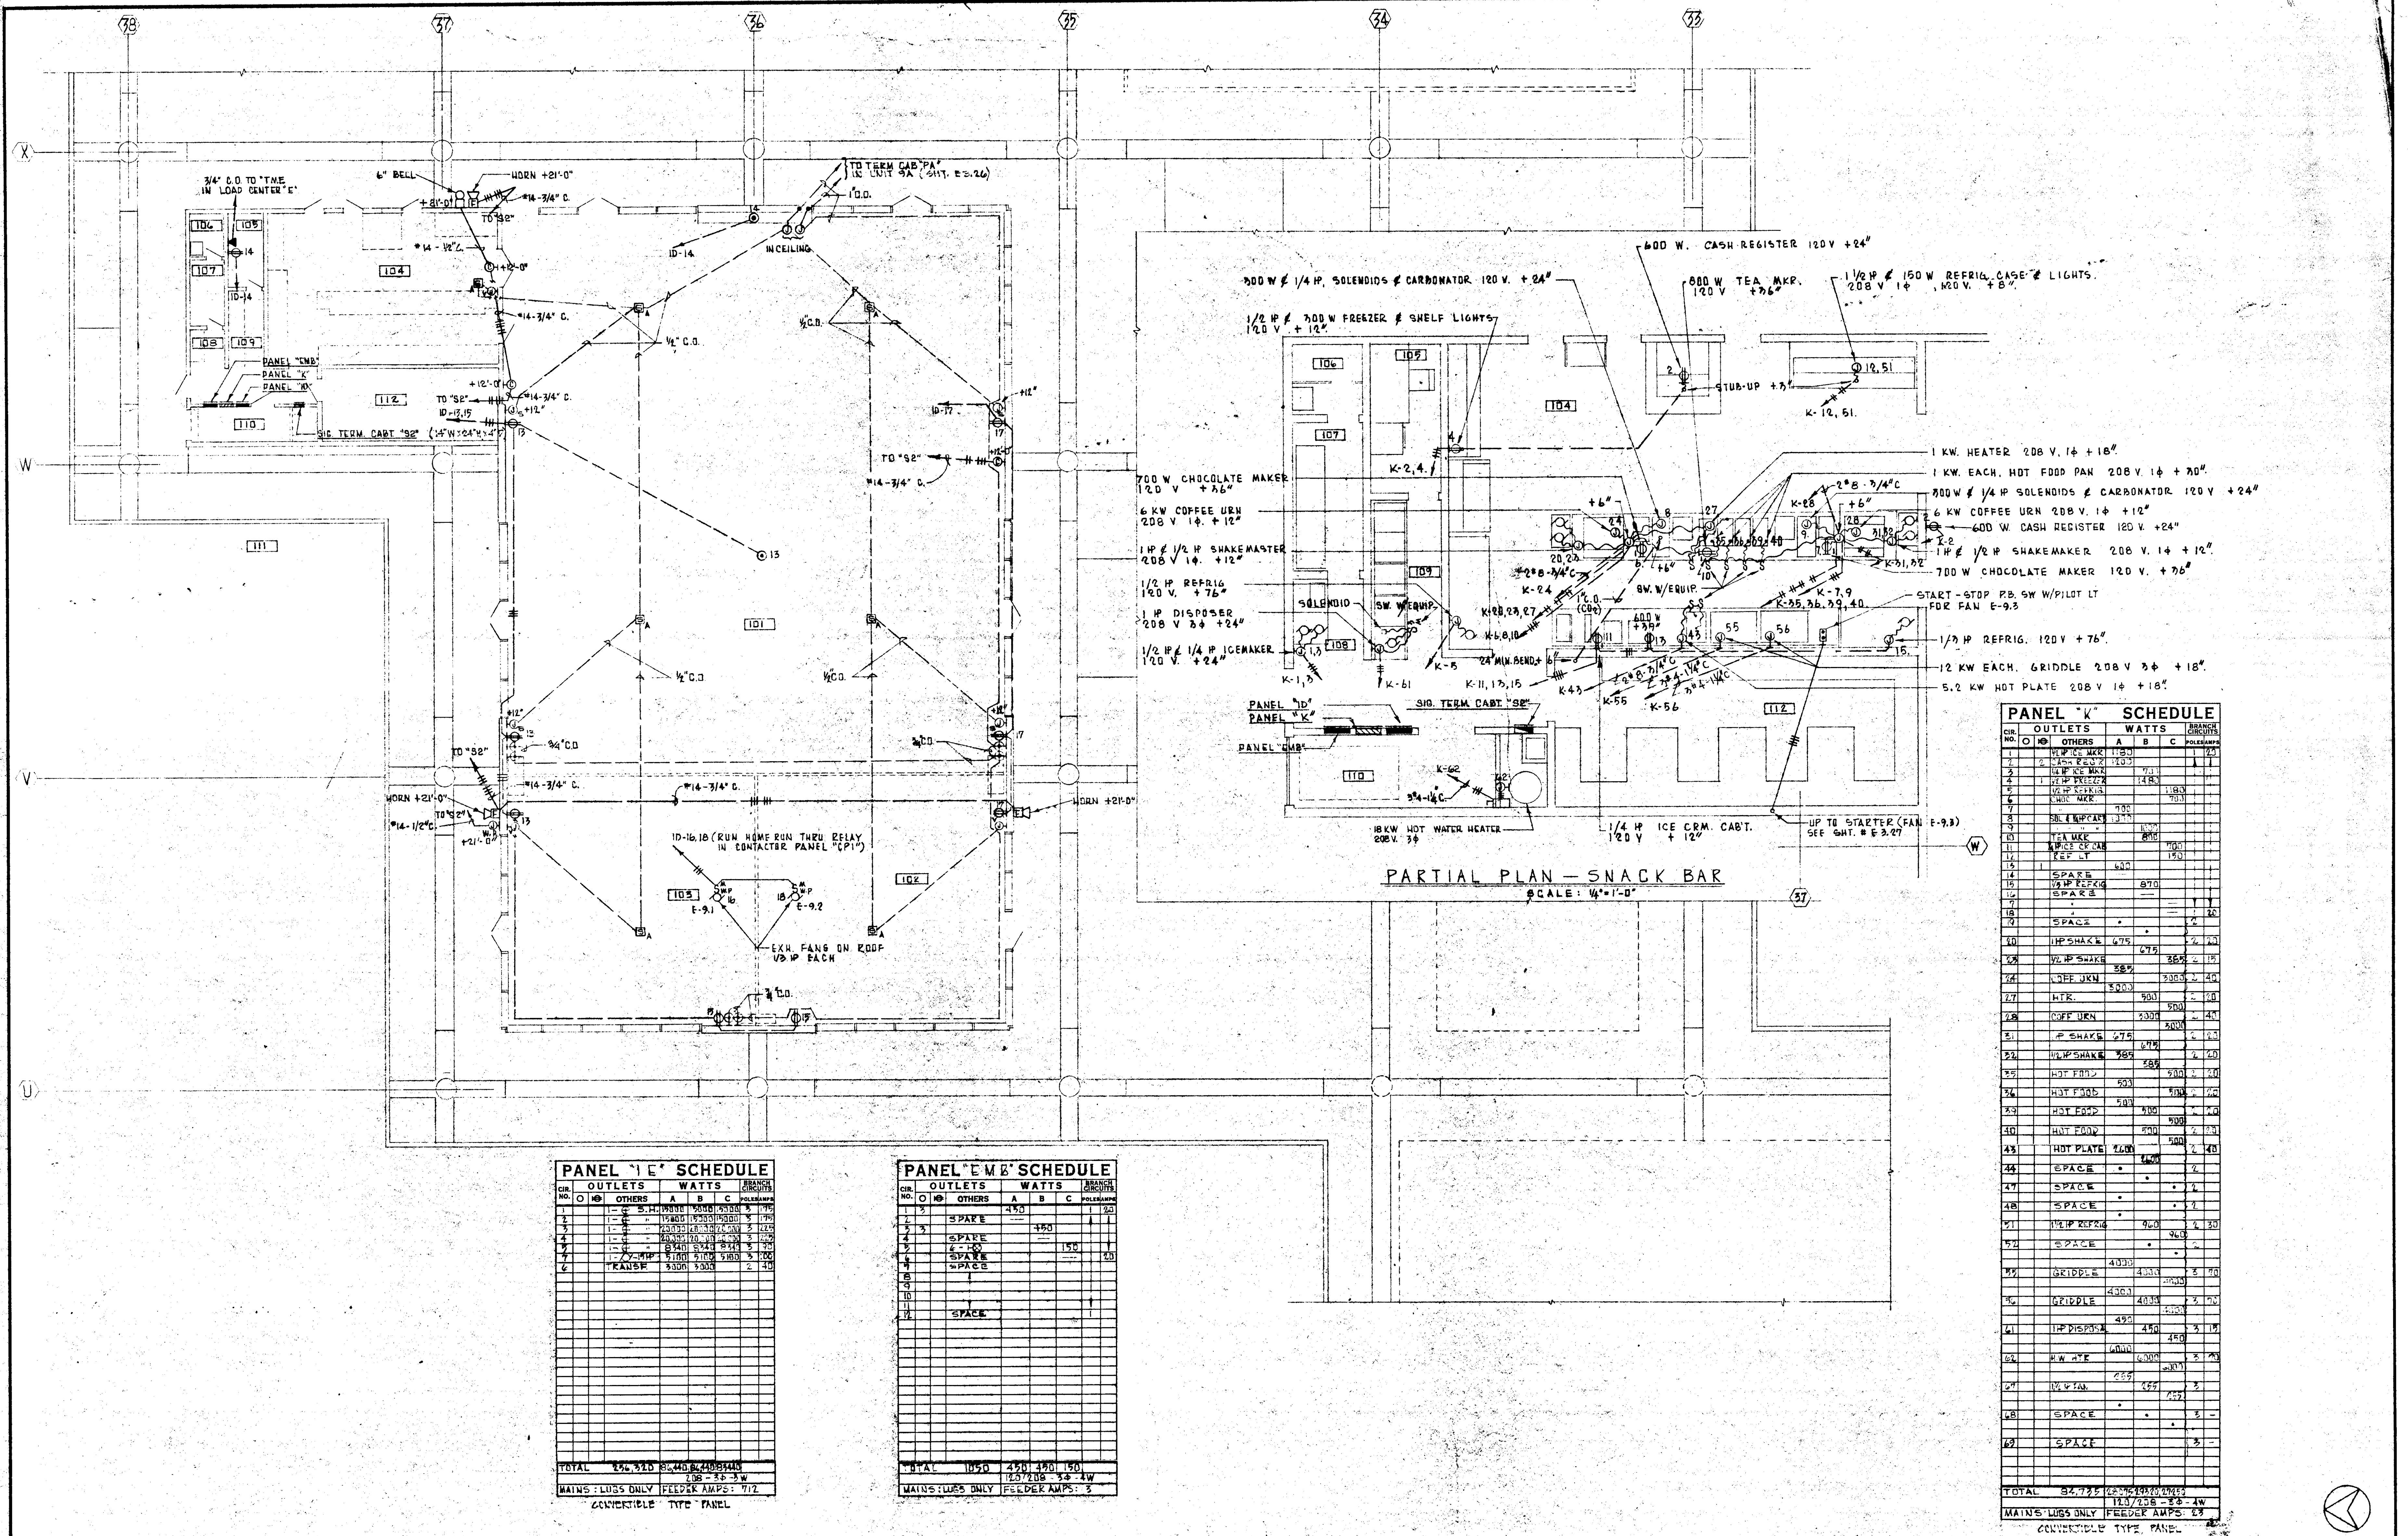POWER & SIGNAL		GOLDEN WEST COLLEGE HUNTINGTON BEACH, CALIFORNIA ORANGE COAST JUNIOR COLLEGE DISTRICT		JOB NO. 1004 DATE 6-15-65 SHEET NO. 113.28
STRUCTURAL ENGINEERS BRANDOW & JOHNSTON J. A. MARTIN & ASSOCIATES MECHANICAL ENGINEERS RALPH E. PHILLIPS, INC. ELECTRICAL ENGINEERS RALPH E. PHILLIPS, INC. CIVIL ENGINEERS G. SHURMAN & ASSOCIATES MOFFATT & NICHOL	DESIGNED DRAWN BY CHECKED BY	ARCHITECT ENGINEER COLLEGE	APPROVED APPROVED APPROVED	ASSOCIATED ARCHITECTS: WILLIAM L. PEREIRA & ASSOCIATES A. QUINCY JONES-FREDERICK E. EMMONS & ASSOCIATES BLUROCK ELLERBROEK & ASSOCIATES URBANUS SQUARE • MACARTHUR BOULEVARD AT FORD ROAD TELEPHONE 714/675-2640 • CORONA DEL MAR, CALIFORNIA

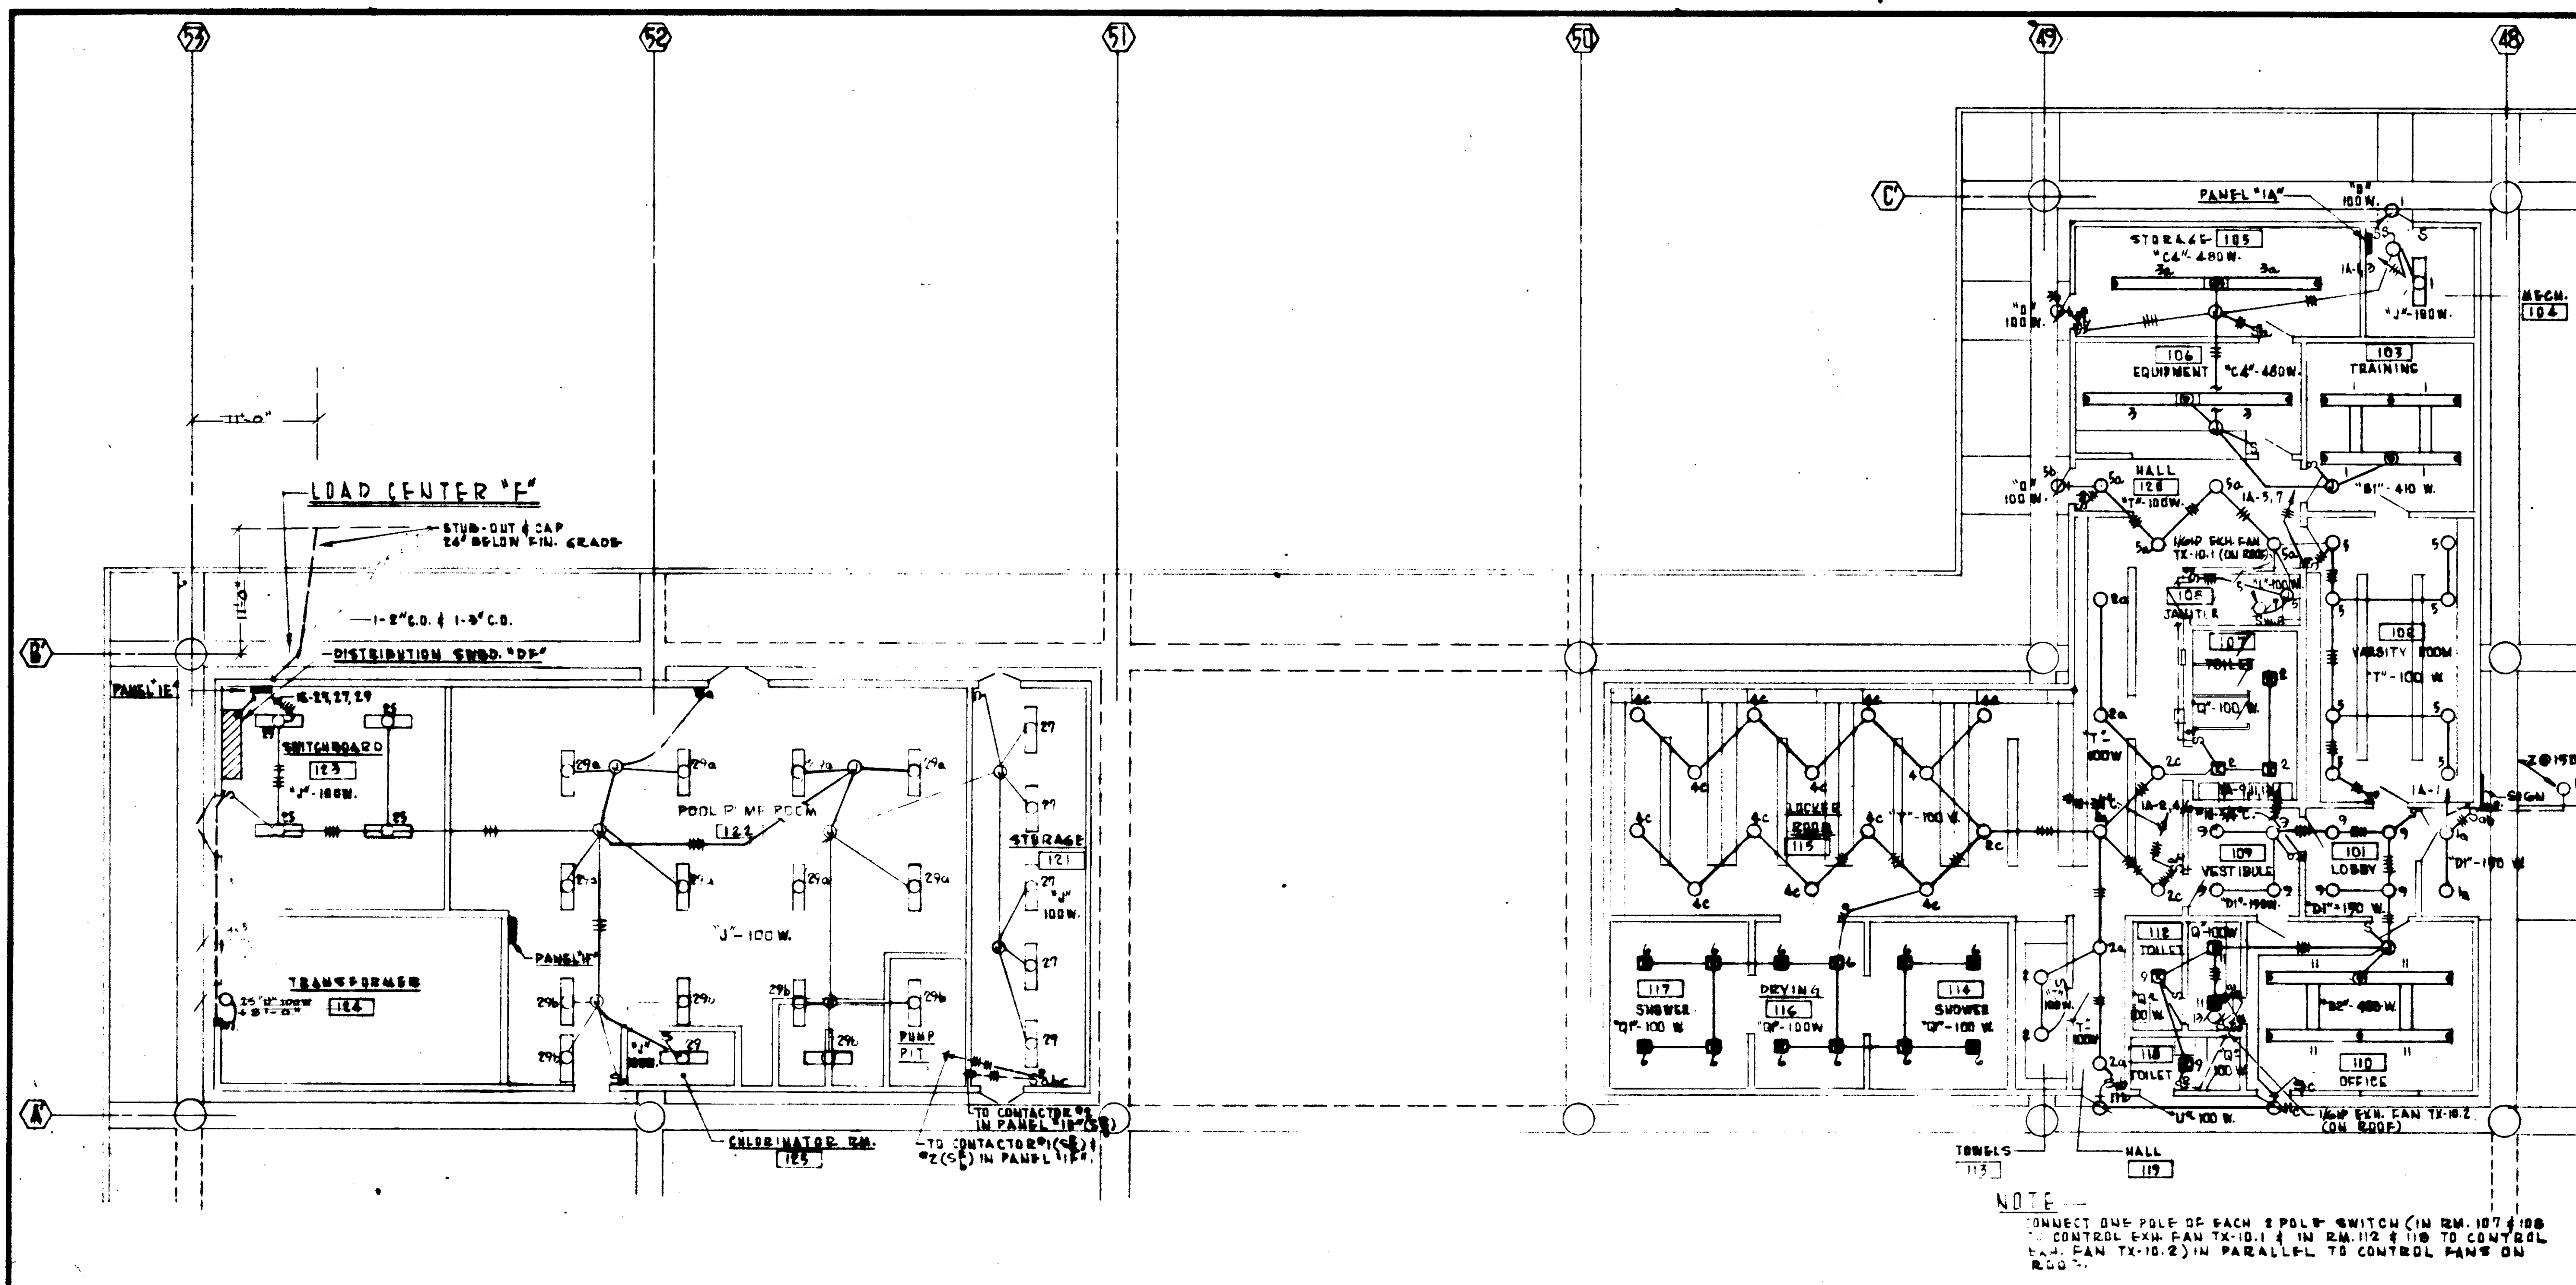

PANEL 'B' SCHEDULE



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2	100	0.45
3	100	0.45
4	100	0.45
5	100	0.45
6	100	0.45
7	100	0.45
8	100	0.45
9	100	0.45
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95	100	0.45
96	100	0.45
97	100	0.45
98	100	0.45
99	100	0.45
100	100	0.45

PANEL 'A' SCHEDULE

OUTLET	WATTS	AMPS
1	100	0.45
2	100	0.45
3	100	0.45
4	100	0.45
5	100	0.45
6	100	0.45
7	100	0.45
8	100	0.45
9	100	0.45
10	100	0.45
11	100	0.45
12	100	0.45
13	100	0.45
14	100	0.45
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19	100	0.45
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38	100	0.45
39	100	0.45
40	100	0.45
41	100	0.45
42	100	0.45
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47	100	0.45
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49	100	0.45
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95	100	0.45
96	100	0.45
97	100	0.45
98	100	0.45
99	100	0.45
100	100	0.45

PANEL 'C' SCHEDULE

OUTLET	WATTS	AMPS
1	100	0.45
2	100	0.45
3	100	0.45
4	100	0.45
5	100	0.45
6	100	0.45
7	100	0.45
8	100	0.45
9	100	0.45
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53	100	0.45
54	100	0.45
55	100	0.45
56	100	0.45
57	100	0.45
58	100	0.45
59	100	0.

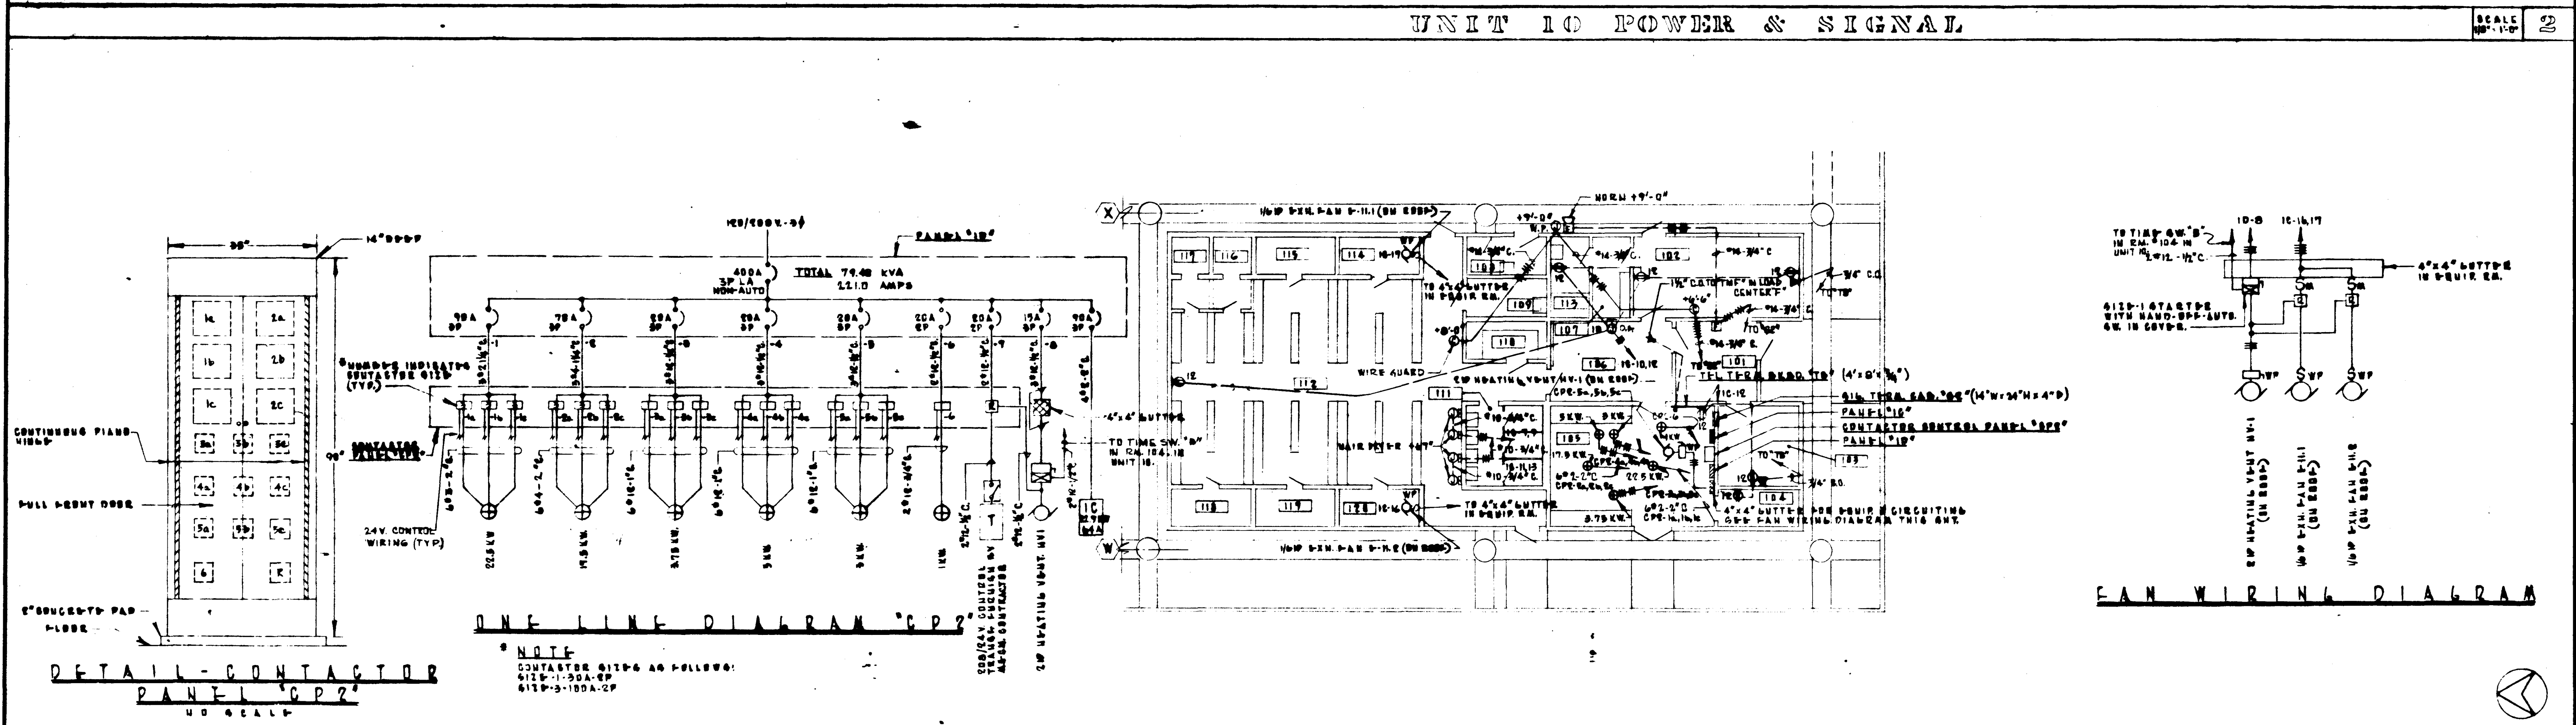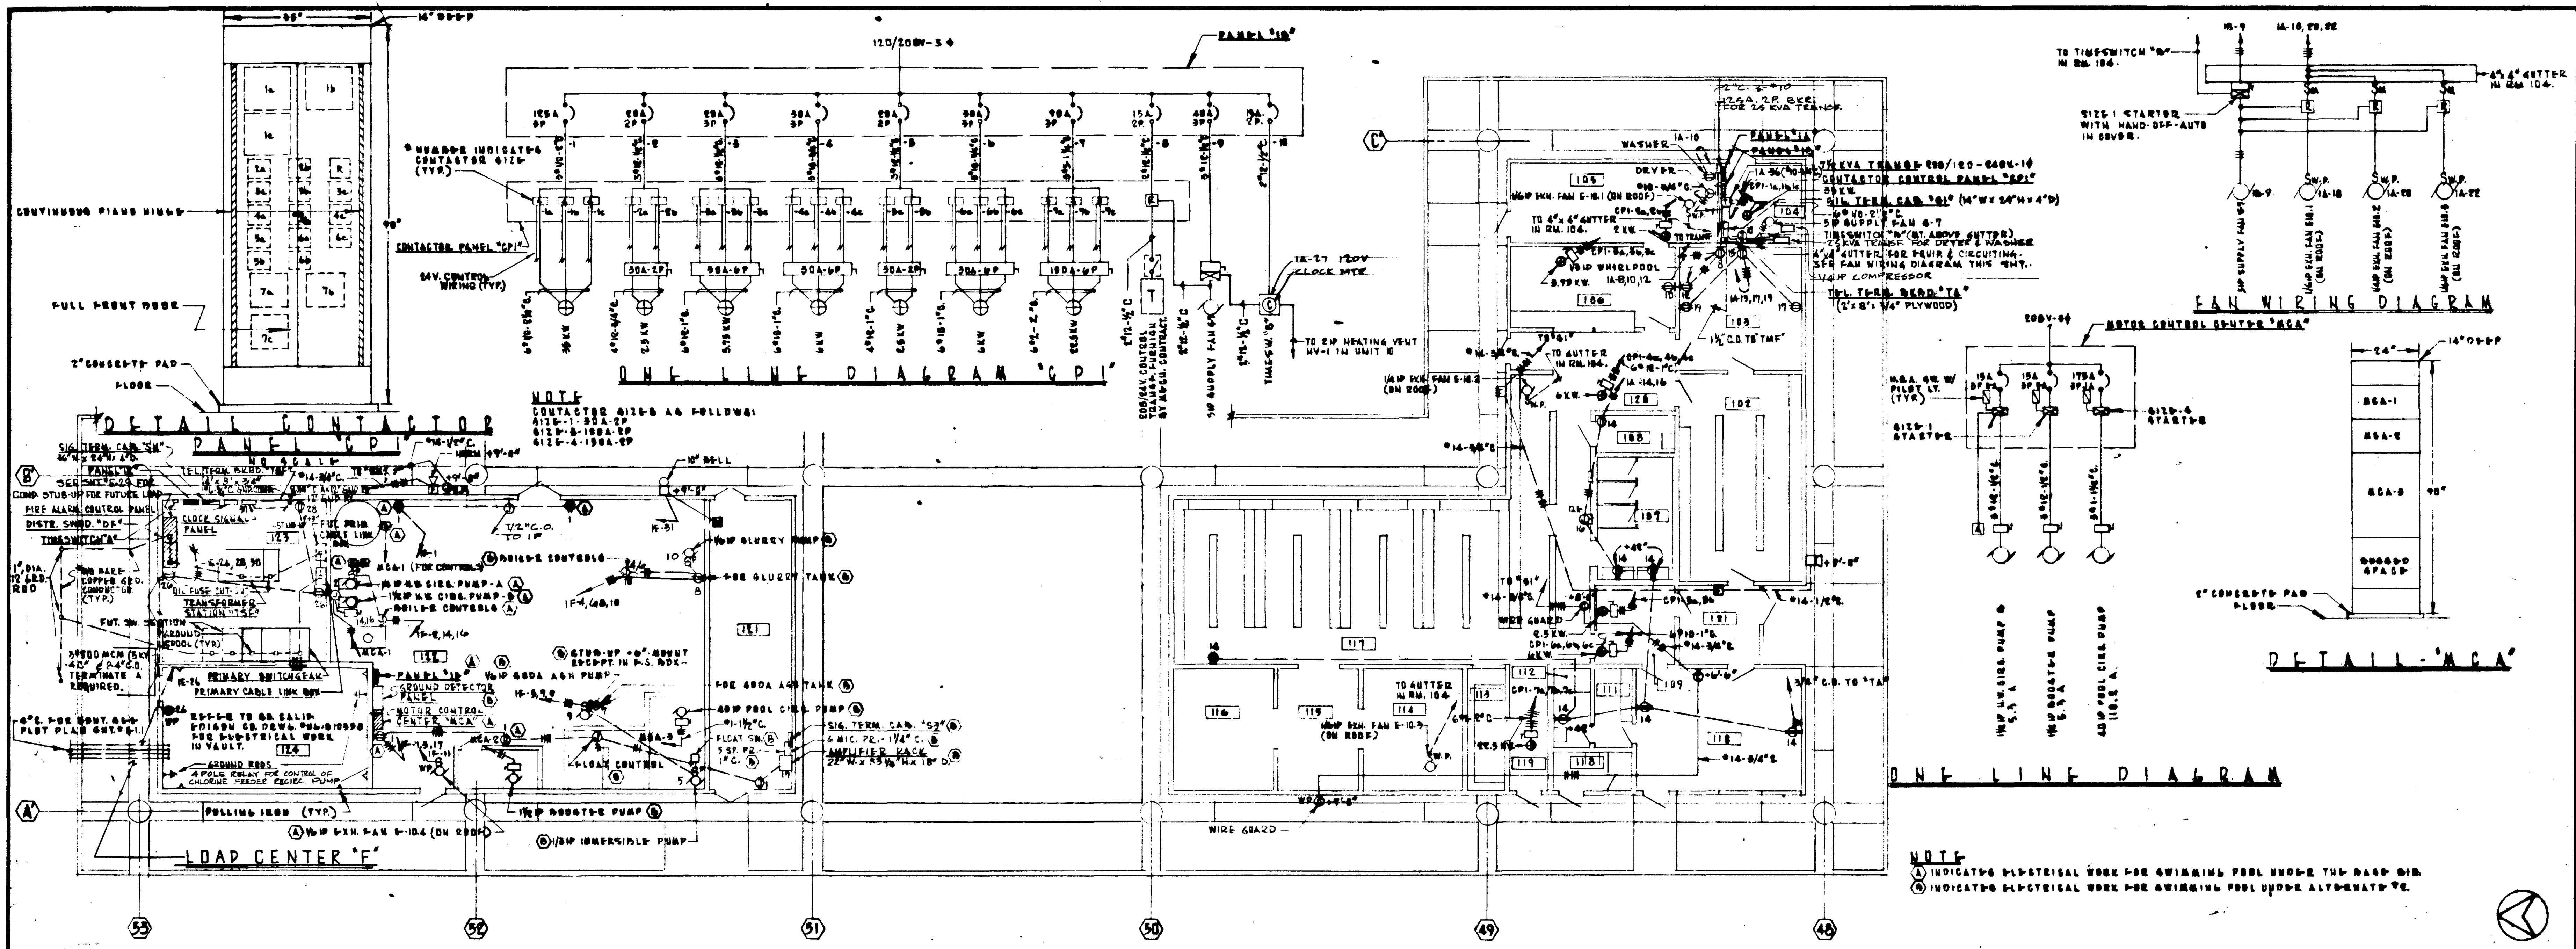

UNIT 10 POWER & SIGNAL				UNIT 11 POWER & SIGNAL			
STRUCTURAL ENGINEER J. A. MARTIN & ASSOCIATES	DESIGNED J. A. MARTIN	MECHANICAL ENGINEER RALPH E. PHILLIPS, INC.	DRAWN BY RALPH E. PHILLIPS, INC.	STRUCTURAL ENGINEER J. A. MARTIN & ASSOCIATES	DESIGNED J. A. MARTIN	MECHANICAL ENGINEER RALPH E. PHILLIPS, INC.	DRAWN BY RALPH E. PHILLIPS, INC.
ELECTRICAL ENGINEER RALPH E. PHILLIPS, INC.	CHECKED BY RALPH E. PHILLIPS, INC.	CIVIL ENGINEER G. SHIRMAN & ASSOCIATES	APPROVED G. SHIRMAN	ELECTRICAL ENGINEER RALPH E. PHILLIPS, INC.	CHECKED BY RALPH E. PHILLIPS, INC.	CIVIL ENGINEER G. SHIRMAN & ASSOCIATES	APPROVED G. SHIRMAN
REVISIONS				REVISIONS			


ASSOCIATED ARCHITECTS:
WILLIAM L. PEREIRA & ASSOCIATES
A. QUINCY JONES-FREDERICK & EMMONS & ASSOCIATES
BLUMOCK HILSBROOK & ASSOCIATES

URBANUS SQUARE • MACARTHUR BOULEVARD AT FORD ROAD
TELEPHONE 714/675-2540 • CORONA DEL MAR, CALIFORNIA

GOLDEN WEST COLLEGE
HUNTINGTON BEACH, CALIFORNIA
ORANGE COAST JUNIOR COLLEGE DISTRICT


UNIT 10 & 11
FLOOR
PLAN

DATE: 6-6-65
SHEET NO.: 123.30

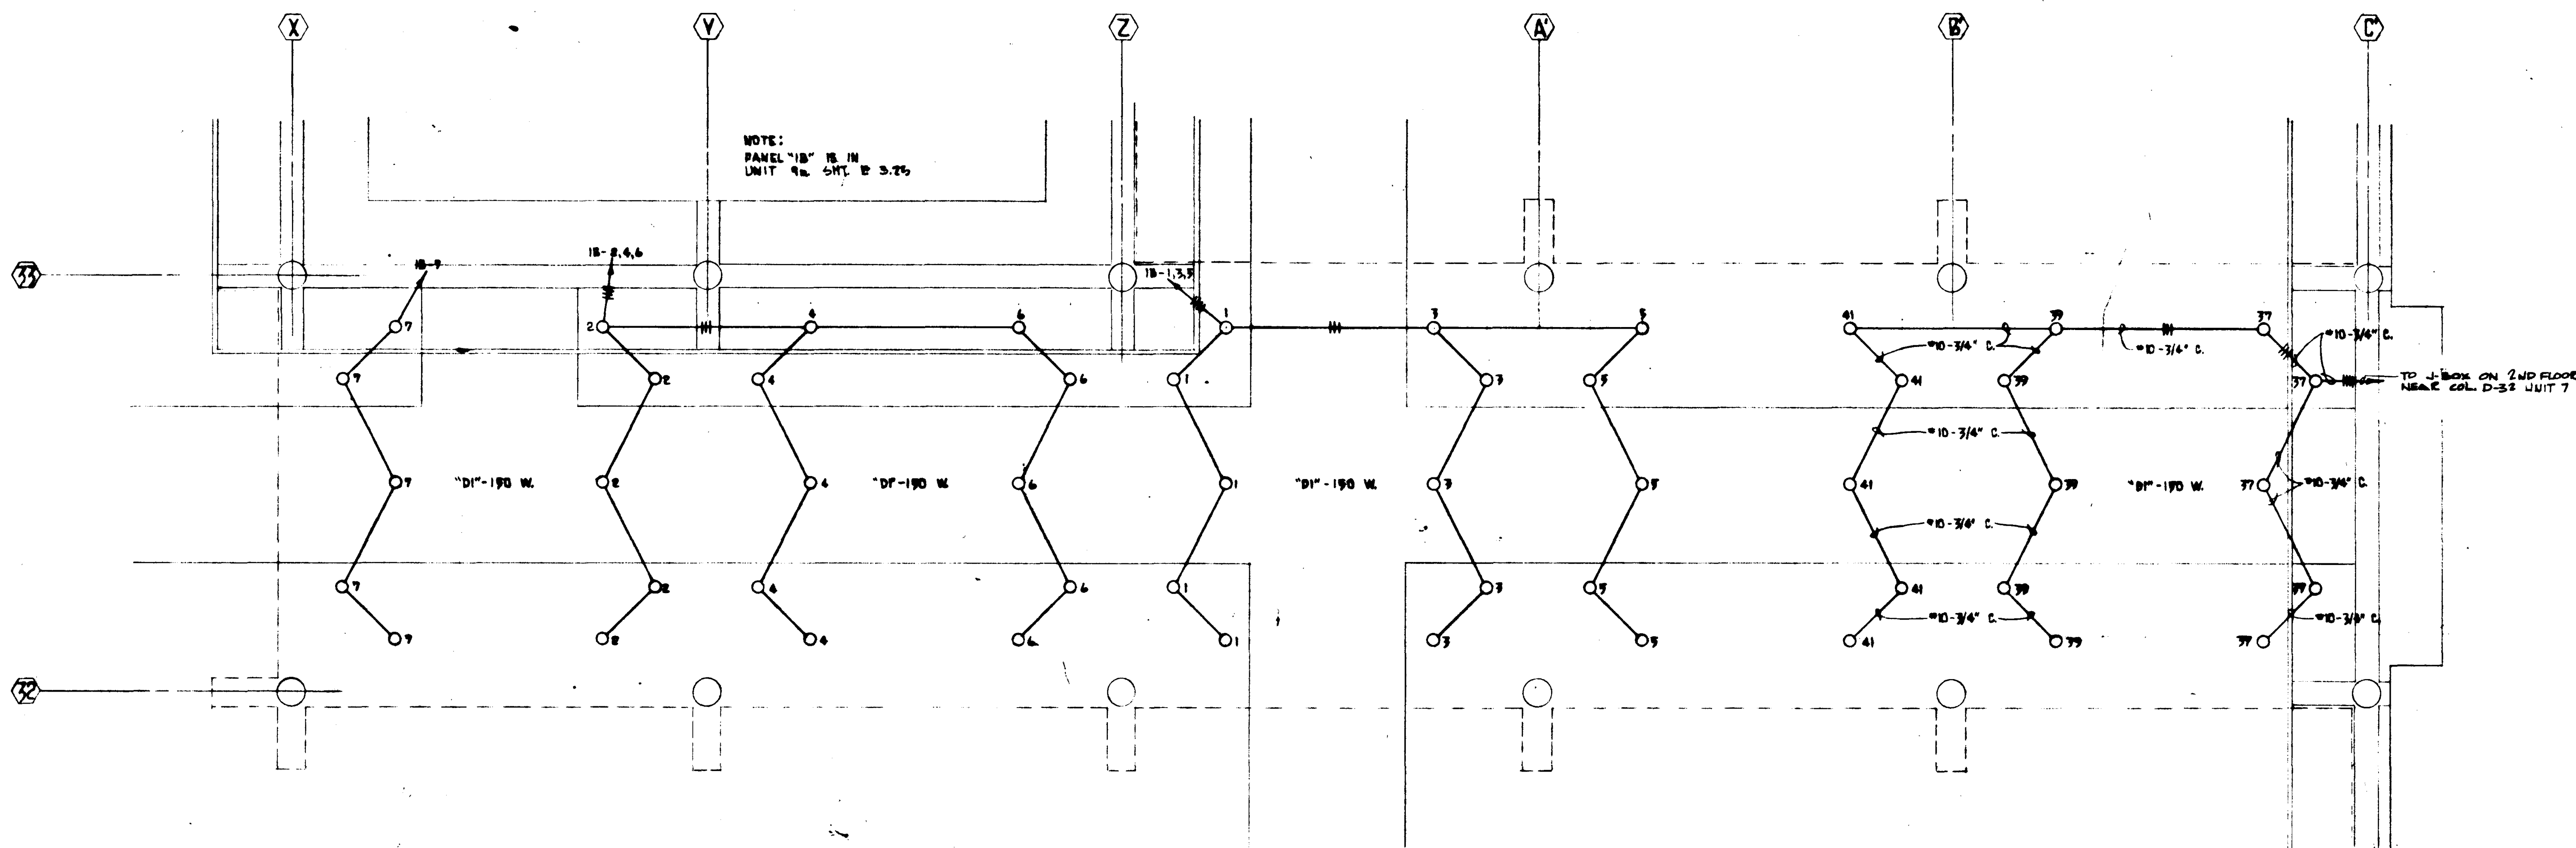

UNIT 13 LIGHTING

SCALE 1/8"=1'-0" 2




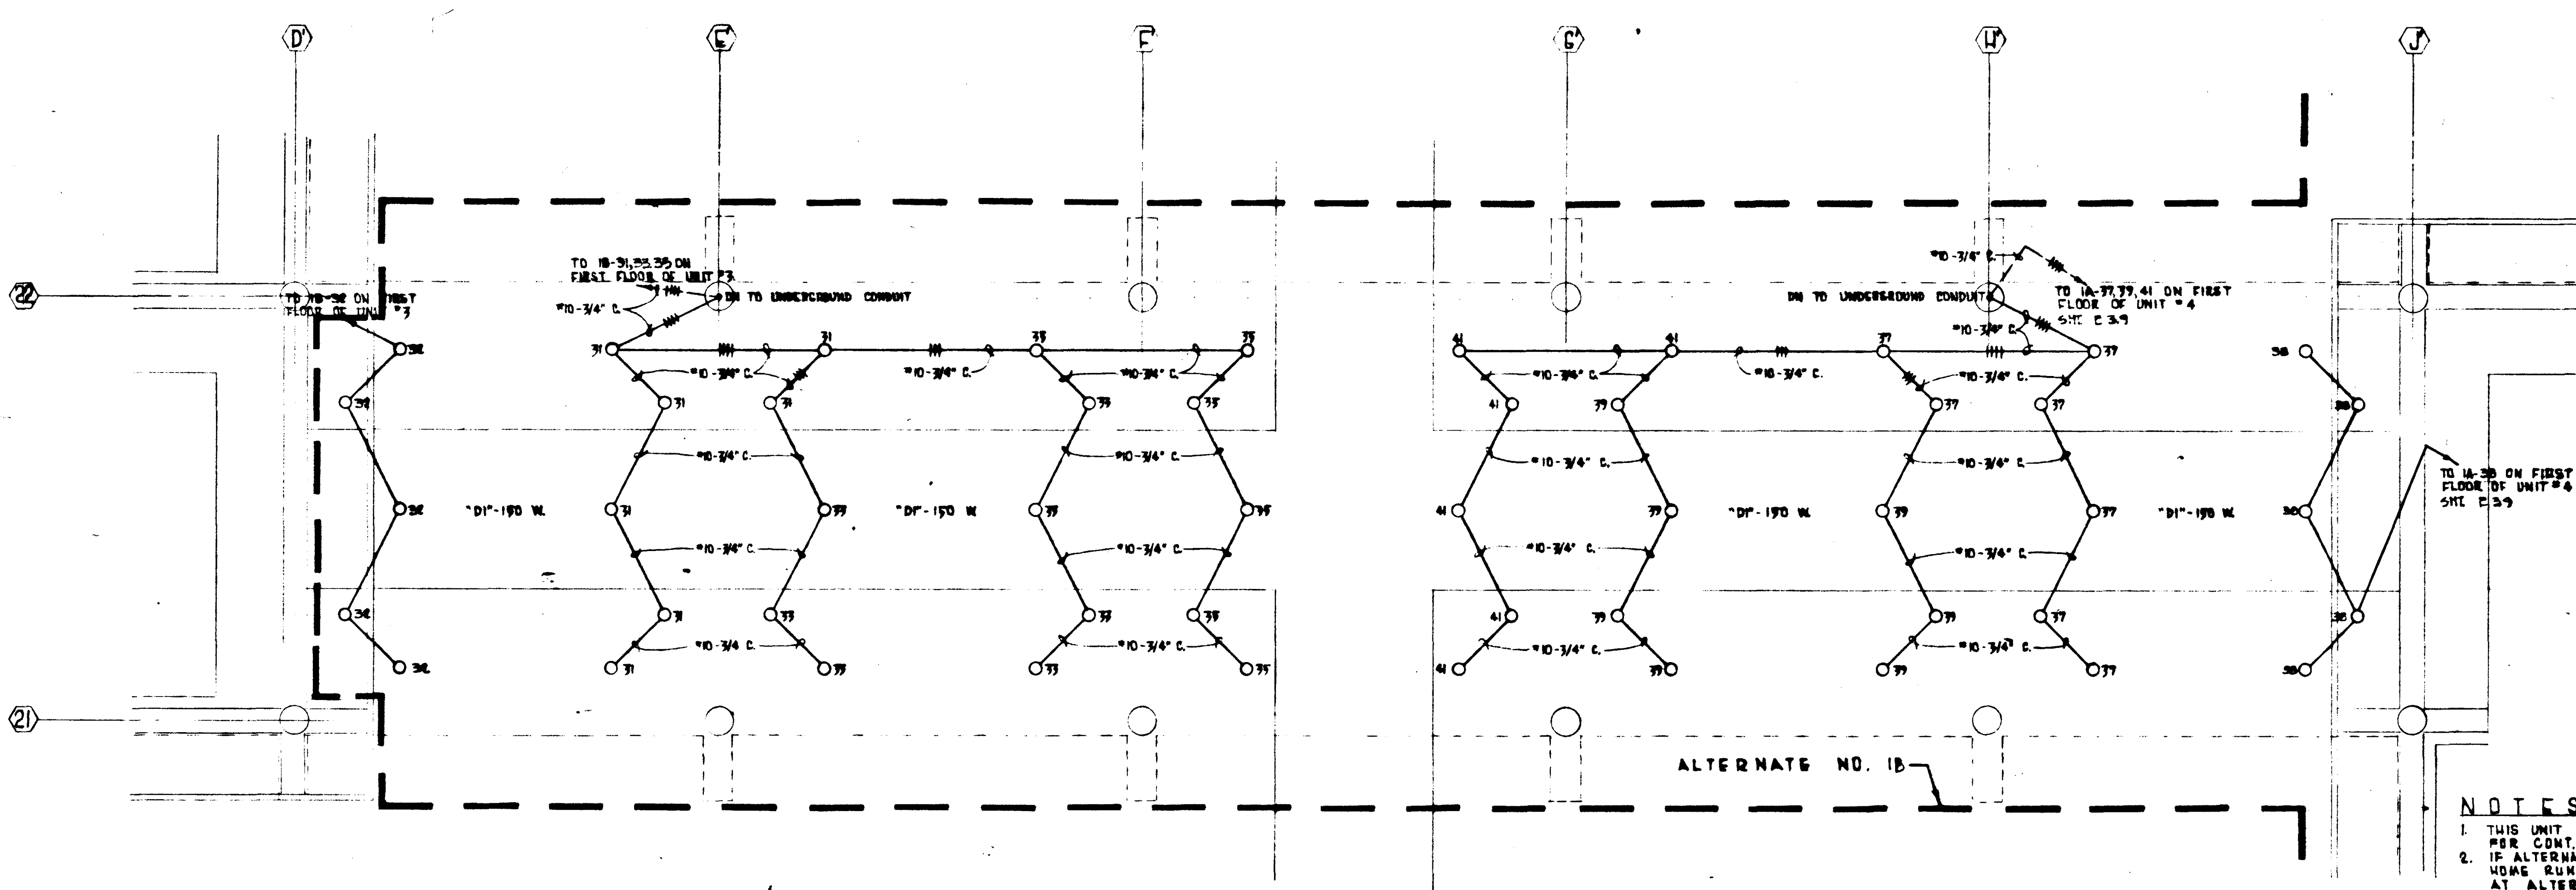


NOTES
 1. THIS UNIT IS PART OF ALTERNATE NO. 1B SEE SH. E 3.9 FOR CONT.
 2. IF ALTERNATE NO. 1B IS NOT ACCEPTED, TERMINATE ALL WIRE RUNS CONDUITS FROM PANEL 1B IN UNIT 13 AT ALTERNATE LINE WITH FLUSH COUPLING & PLUG.

UNIT 12 LIGHTING

SCALE 1/8"=1'-0" 1

STRUCTURAL ENGINEERS BRANDOW & JOHNSON J.A. MARTIN & ASSOCIATES		DESIGNED J.A. MARTIN	ARCHITECT WILLIAM L. PEREIRA & ASSOCIATES A. QUINCY JONES-FREDERICK R. EMMONS & ASSOCIATES BLUROCK ELLERBROOK & ASSOCIATES	APPROVED WILLIAM L. PEREIRA	GOLDEN WEST COLLEGE HUNTINGTON BEACH, CALIFORNIA ORANGE COAST JUNIOR COLLEGE DISTRICT	UNIT 12 & 13 FLOOR PLAN	JOB NO. 104 DATE 6-15-65 SHEET NO. 123-31
MECHANICAL ENGINEERS RALPH E. PHILLIPS, INC.		DRAWN BY RALPH E. PHILLIPS, INC.	APPROVED RALPH E. PHILLIPS, INC.	URBANUS SQUARE • MACARTHUR BOULEVARD AT FORD ROAD TELEPHONE 714/675-2640 • CORONA DEL MAR, CALIFORNIA			

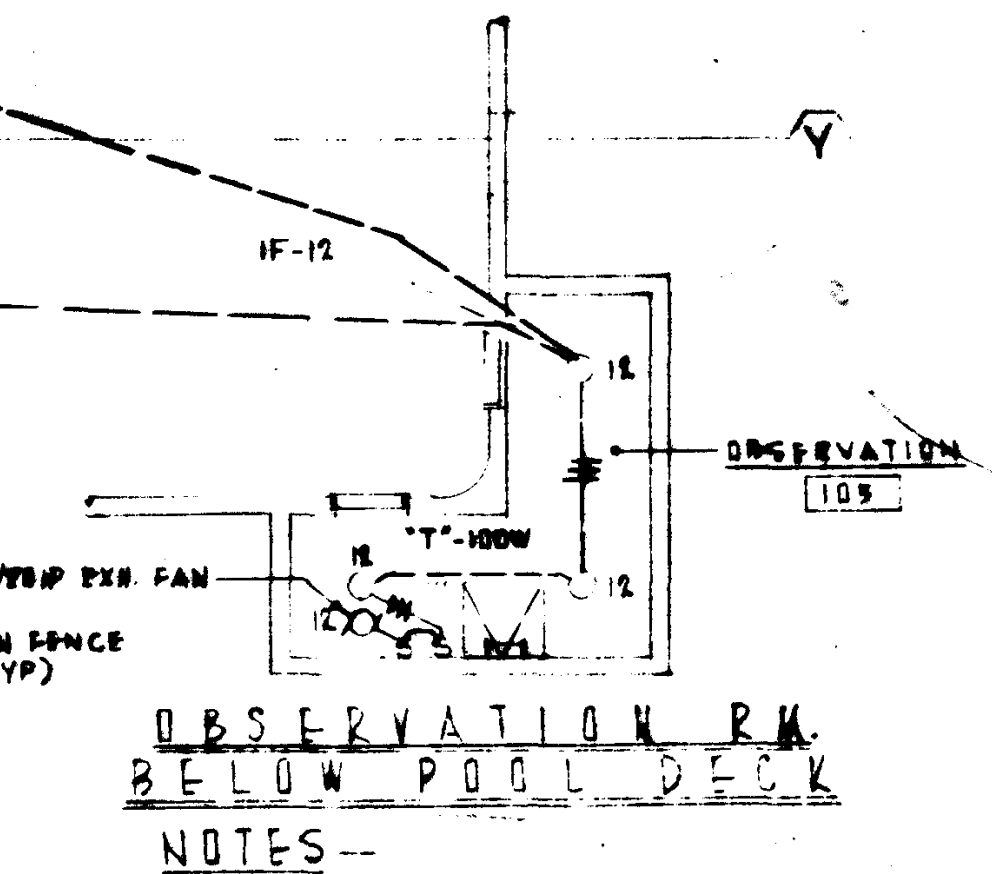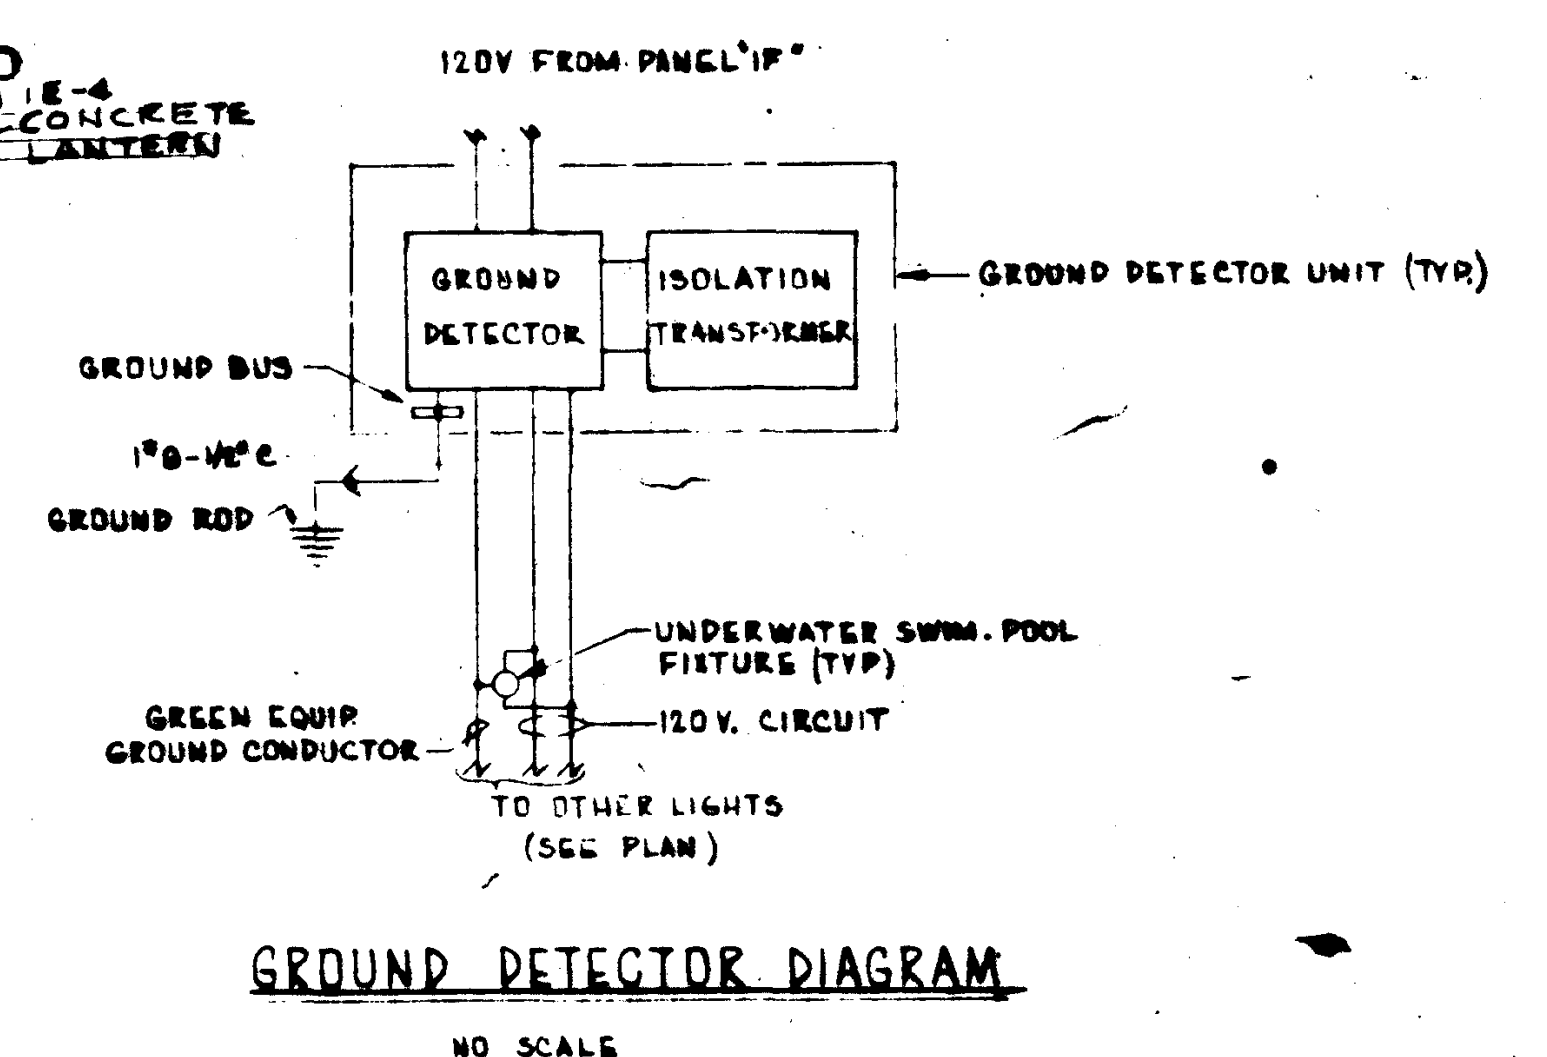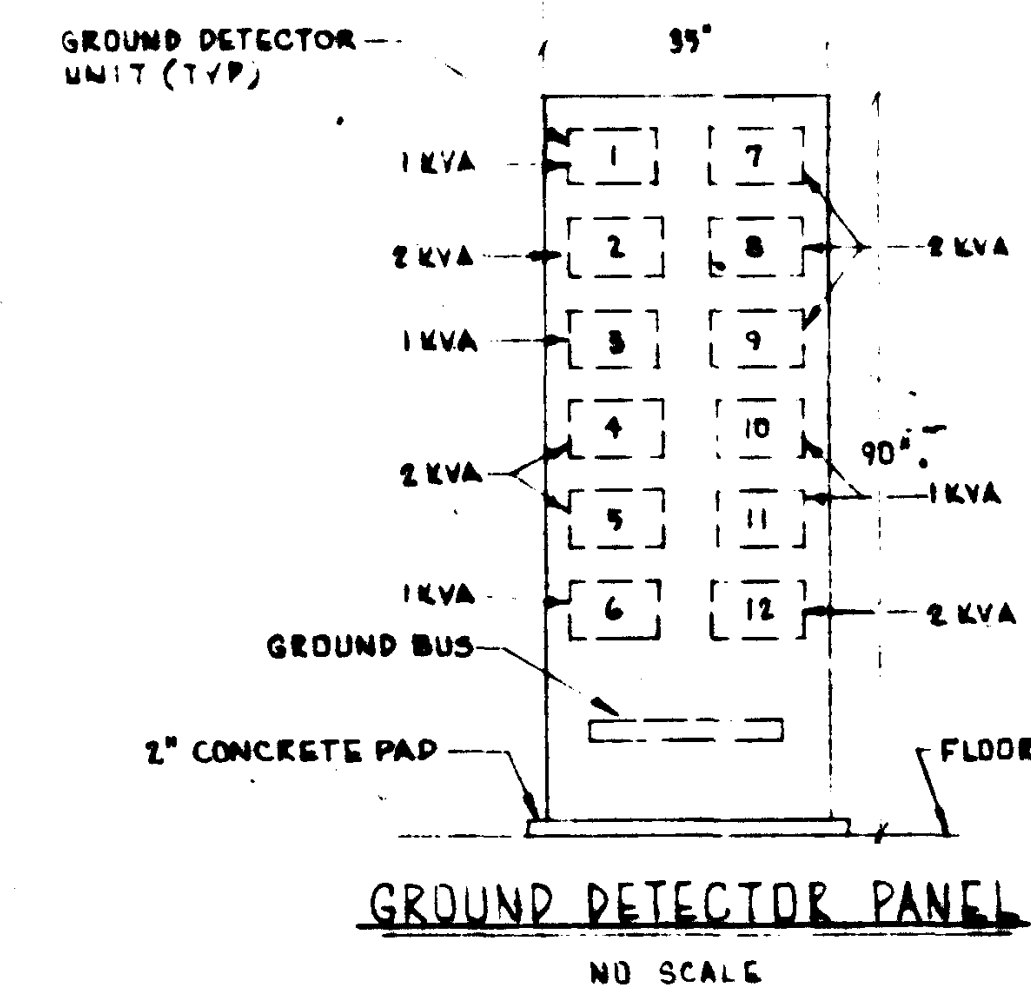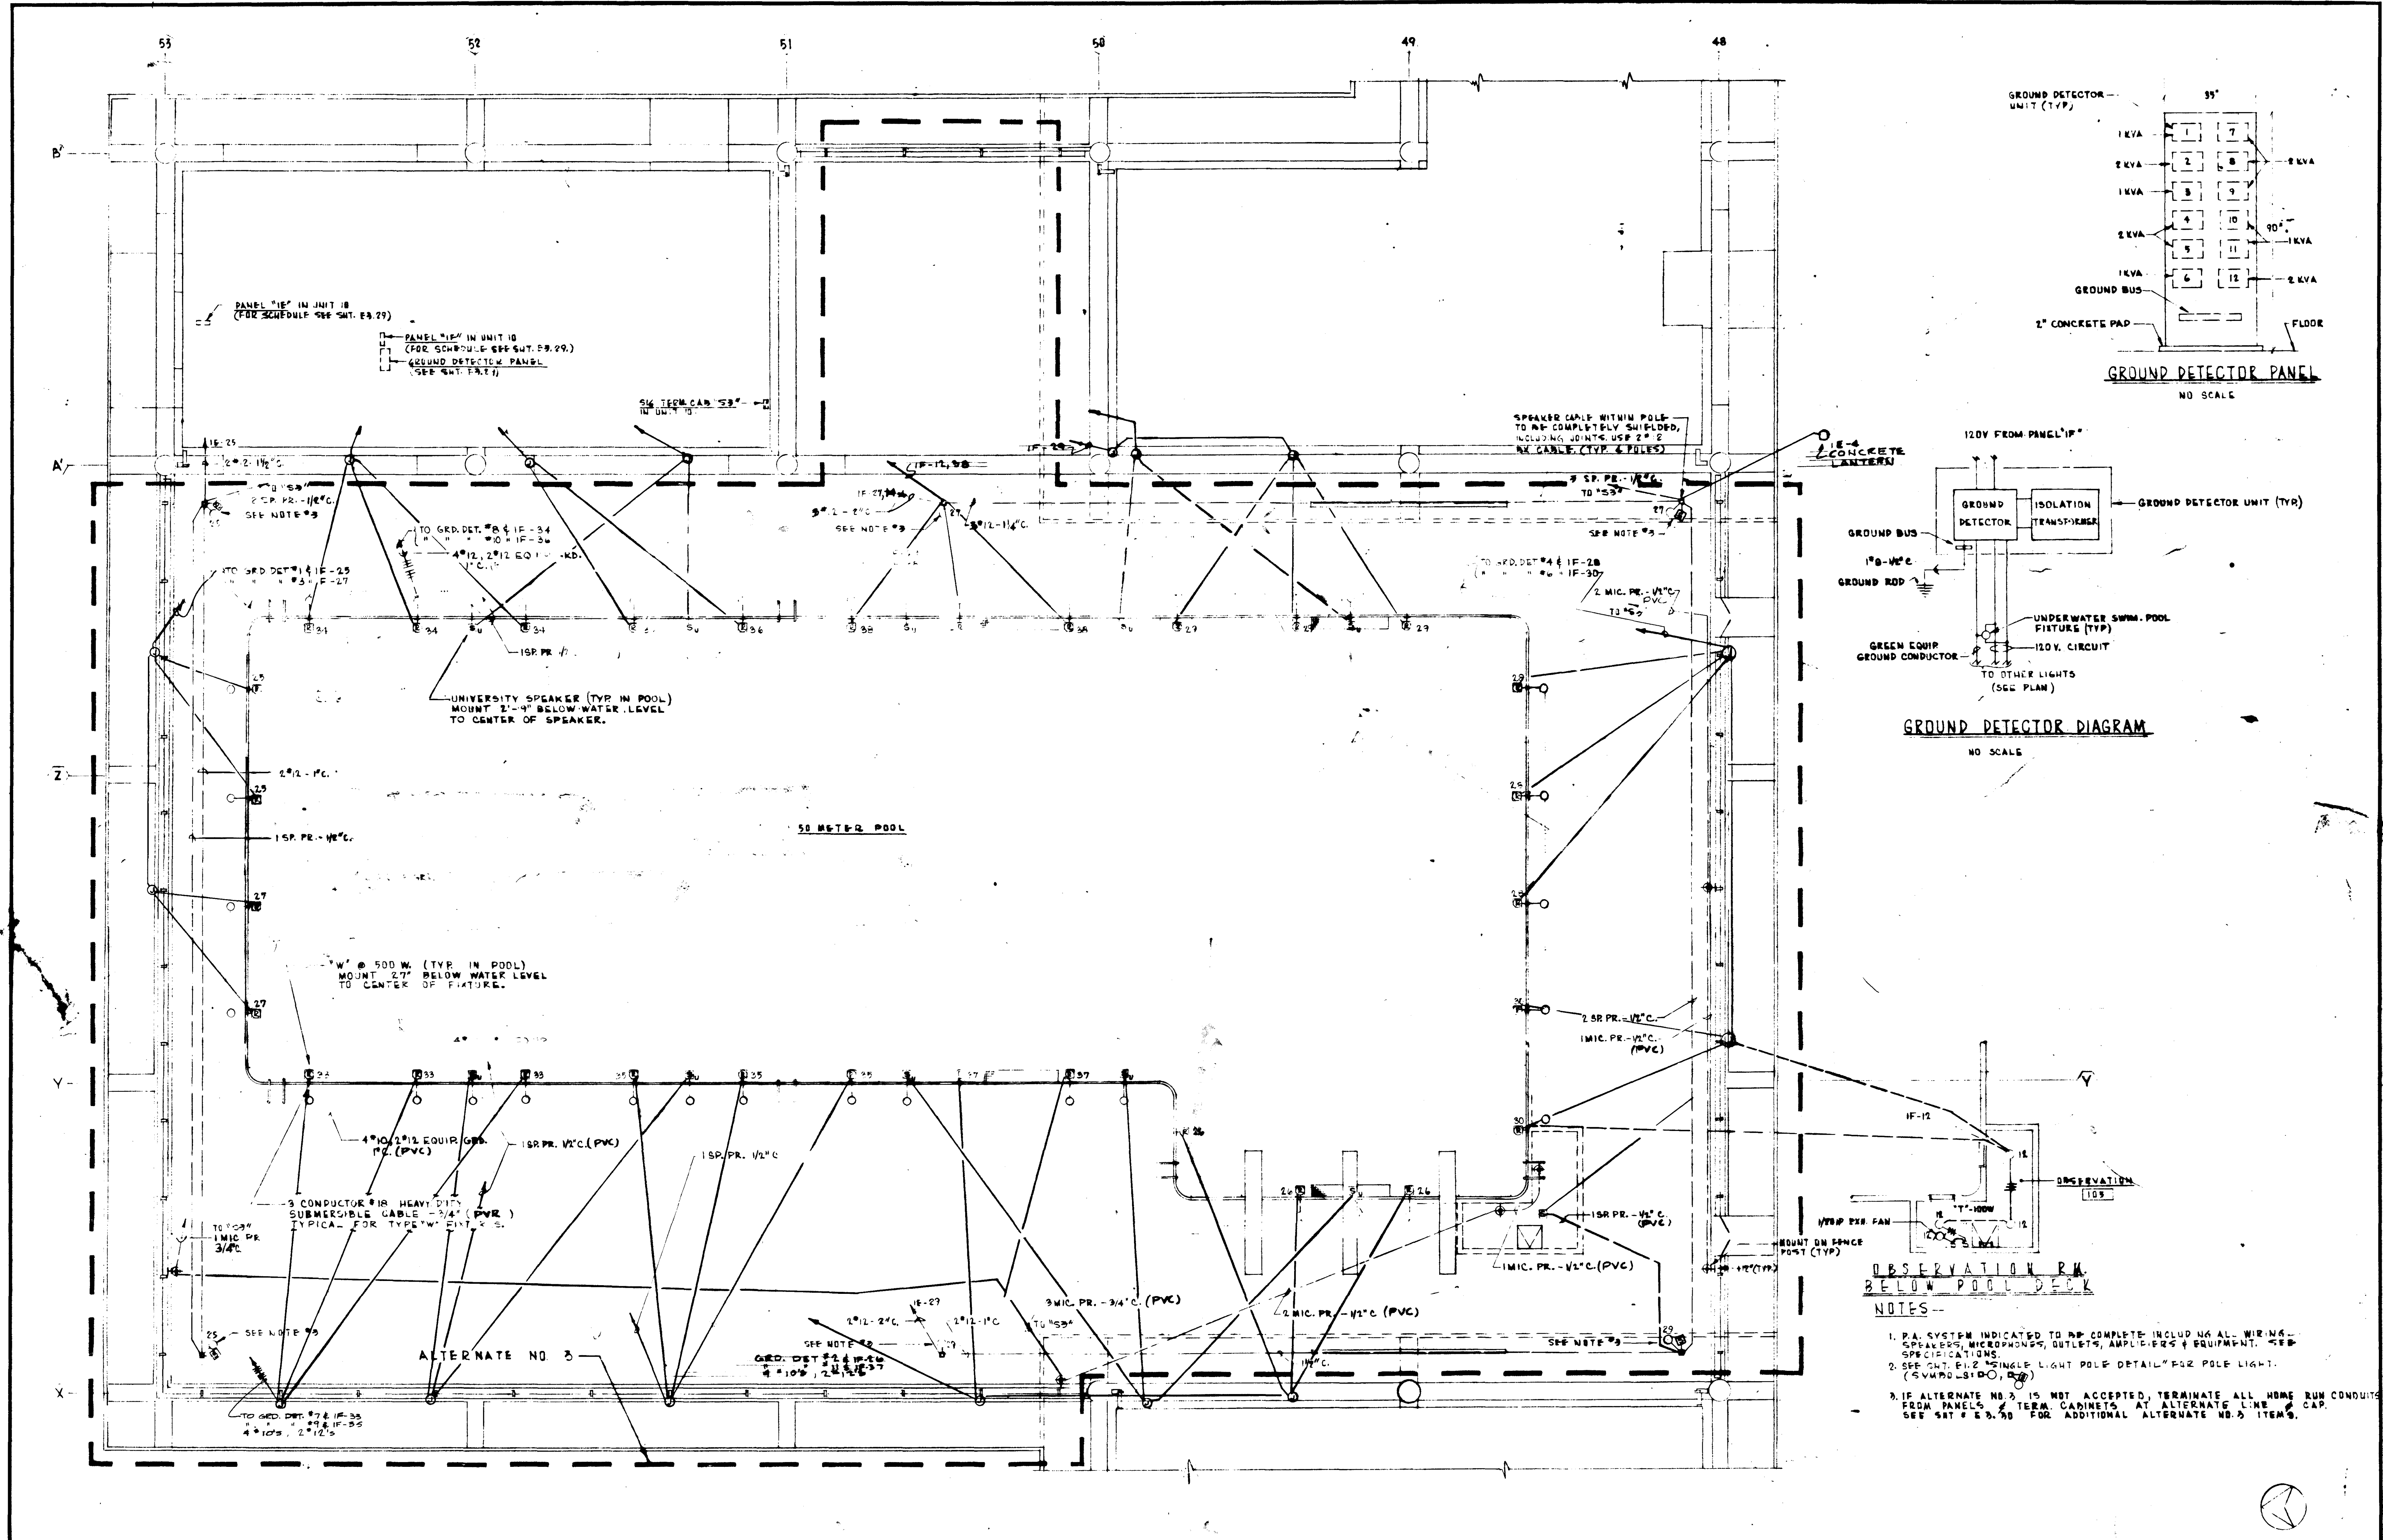

- NOTES**
1. P.A. SYSTEM INDICATED TO BE COMPLETE INCLUDE ALL WIRING, SPEAKERS, MICROPHONES, OUTLETS, AMPLIFIERS & EQUIPMENT. SEE SPECIFICATIONS.
 2. SEE CAT. #12 SINGLE LIGHT POLE DETAIL FOR POLE LIGHT. (SYMBOLED, 12)
 3. IF ALTERNATE NO. 3 IS NOT ACCEPTED, TERMINATE ALL HOME RUN CONDUITS FROM PANELS & TERM. CABINETS AT ALTERNATE LINE & CAP. SEE SET # E.S. 50 FOR ADDITIONAL ALTERNATE NO. 3 ITEMS.

SWIMMING POOL POWER & LIGHTING

		STRUCTURAL ENGINEERS BRANDOW & JOHNSON J.A. MARTIN & ASSOCIATES	DESIGNED	ARCHITECT WILLIAM L. PEREIRA & ASSOCIATES	APPROVED	ASSOCIATED ARCHITECTS: WILLIAM L. PEREIRA & ASSOCIATES A. QUINCY JONES-FREDERICK E. EMMONS & ASSOCIATES BLUROCK ELLERBROCK & ASSOCIATES	GOLDEN WEST COLLEGE HUNTINGTON BEACH, CALIFORNIA ORANGE COAST JUNIOR COLLEGE DISTRICT	FLOOR PLAN	JOB NO. 6-15-65
		MECHANICAL ENGINEERS RALPH E. PHILLIPS, INC.	DRAWN BY RALPH E. PHILLIPS, INC.	ENGINEER RALPH E. PHILLIPS, INC.	STATE OF CALIF. 664 DATE JUN 1965	URBANUS SQUARE • MACARTHUR BOULEVARD AT FORD ROAD TELEPHONE 714/675-2640 CORONA DEL MAR, CALIFORNIA			DATE 6-15-65
DATE DRAWN		REVISIONS		CIVIL ENGINEERS O. SHURMAN & ASSOCIATES MOFFATT & MICROL					